

THE GOLD STAR MEMORIAL HIGHWAY

MAINE TURNPIKE AUTHORITY

DANIEL E. WATHEN, CHAIR
DIANE M. DOYLE, VICE CHAIR
GERARD P. CONLEY, SR., MEMBER
JAMES F. CLOUTIER, MEMBER
JOHN E. DORITY, MEMBER
ROBERT D. STONE, MEMBER
BRUCE A. VAN NOTE, MEMBER EX-OFFICIO

S. PETER MILLS, EXECUTIVE DIRECTOR

CONTRACT 2013.10
BRIDGE REPAIR AND STRENGTHENING
ANDROSCOGGIN RIVER OVERPASS
MILE 78.9

LOCATION MAP

API PROVED

MAIN IE TURNPIKE AUTHORITY

Steps R. Tartes

3/15/13

CONTRACT 2013.10
BRIDGE REPAIR AND STRENGTHENING

ANDROSCOGGIN RIVER OVERPASS

INDEX OF SHEETS

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HNTB



VICE PRESIDENT
DIRECTOR OF OPERATIONS

3/13/13

ename: 401_MTATitle.dgii

SPECIFICATIONS

DESIGN

AASHTO LRFD BRIDGE DESIGN SPECIFICATIONS, 6TH EDITION, 2012.

STATE OF MAINE, DEPARTMENT OF TRANSPORTATION STANDARD SPECIFICATIONS, REVISION OF DECEMBER 2002.

STATE OF MAINE DEPARTMENT OF TRANSPORTATION STANDARD DETAILS, REVISION OF DECEMBER 2002, WITH ALL REVISIONS THERETO.

AASHTO LRFD BRIDGE CONSTRUCTION SPECIFICATIONS, 3RD EDITION WITH 2010 INTERIMS.

DESIGN LOADING

LIVE LOAD - HL-93

MATERIALS

STRUCTURAL STEEL

POST-TENSIONING STEEL ANCHOR BLOCKS SHALL BE AASHTO M270, GRADE 50.

ALL OTHER STRUCTURAL STEEL SHALL BE AASHTO M270, GRADE 36 OR 50.

HIGH STRENGTH BOLTS SHALL BE AASHTO MI64 (ASTM A490) FOR POST-TENSIONING ANCHOR BLOCK ZONE AND AASHTO MI64 (ASTM A325) FOR ALL OTHER LOCATIONS. ALL BOLTS AND HARDWARE SHALL BE HOT DIPPED GALVANIZED.

POST-TENSIONING

POST-TENSIONING STRANDS SHALL BE EXTERNAL UNBONDED STRANDS AASHTO M203, GRADE 270, THE STRANDS SHALL BE LOW-RELAXATION 7-WIRE STRANDS ENCASED IN HDPE CONDUIT.

PROTECTIVE COATING

FASCIA GIRDERS SHALL BE PAINTED AS OUTLINED IN PLANS IN ACCORDANCE WITH SPECIAL PROVISION, SECTION 506, PROTECTIVE COATING.

STEEL ANCHOR BLOCKS FOR POST-TENSIONING SHALL BE GALVANIZED (ASTM 123).

ALL OTHER STRUCTURAL STRUCTURAL STEEL SHALL BE PAINTED IN ACCORDANCE WITH SPECIAL PROVISION 506.

DECK AND JOINT REPAIRS - CLASS AAA MODIFIED

BASIC DESIGN STRESSES

STRUCTURAL STEEL

AASHTO M270 (ASTM 709) GRADE 50, Fy = 50,000 P.S.I. GRADE 36, Fy = 36,000 P.S.I.

POST-TENSIONING STRANDS

AASHTO M203, GRADE 270, Fu = 270 K.S.I.

CLASS AAA MODIFIED, f'c = 4,500 P.S.I.

LIST OF ABBREVIATIONS

ABUT. - ABUTMENT ADDL. - ADDITIONAL ALT. - ALTERNATE

APPROX. - APPROXIMATELY

BOT. - BOTTOM BRG. - BEARING CL. - CLEAR

Q - CENTERLINE CONC. - CONCRETE CONSTR. - CONSTRUCTION DEMO. - DEMOLITION

DIA. - DIAMETER EA. - EACH

EB - EASTBOUND E.F. - EACH FACE EL. - ELEVATION EQ. - EQUAL

EXIST. - EXISTING EXP. - EXPANSION F.F. - FAR FACE

JT. - JOINT MAX. - MAXIMUM

MIN. - MINIMUM MTA - MAINE TURNPIKE AUTHORITY

NB - NORTHBOUND N.F. - NEAR FACE N.T.S. - NOT TO SCALE PED. - PEDESTAL

PGL - PROFILE GRADE LINE P - PLATE

PROP. - PROPOSED P.S.I. - POUNDS per SQUARE INCH RDWY. - ROADWAY

SHLDR. - SHOULDER SB - SOUTHBOUND SP. - SPACES STA. - STATION

T.&B. - TOP & BOTTOM TPKE. - TURNPIKE TYP. - TYPICAL

U.O.N. - UNLESS OTHERWISE NOTED

VERT. - VERTICAL WB - WESTBOUND W.P. - WORKING POINT

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4	MAINTENANCE OF TRAFFIC DETAILS II	MT-02
5	MAINTENANCE OF TRAFFIC I	MT-03
6	MAINTENANCE OF TRAFFIC II	MT-04
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//	MAINTENANCE OF TRAFFIC VII CROSSOVER ALTERNATIVE	MT-09
12	BRIDGE GENERAL PLAN AND ELEVATION	S-0I
13	TYPICAL SECTION	S-02
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18	POST-TENSIONING DETAILS I	S-07
19	POST-TENSIONING DETAILS II	S-08
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	ORIGINAL CONSTRUCTION PLANS
PAGE NUMBER	TITLE
22 OF 39	AS-BUILT GENERAL PLAN
23 OF 39	AS-BUILT SUPERSTRUCTURE
24 OF 39	AS-BUILT TYPICAL SECTION
25-39 OF 39	AS-BUILT GIRDER FABRICATION PLANS

ITEM NO.	ITEM DESCRIPTION	UNIT	QUANTITY
202.202	Removing Pavement Surface	SY	70
202.2021	Removing Pavement Surface - Bridge Deck	SY	7170
203.22	Clearance Excavation	LS	1
403.210	Hot Mix Asphalt, 9.5mm Nominal Maximum Size	Ton	630
409.15	Bituminous Tack Coat, Applied	Gal	360
419.30	Sawing Bituminous Pavement	LF	1,850
504.7001	Transverse Steel Bracing, Fabrication and Delivery	EA	8
504.7002	Transverse Steel Bracing, Installation	EA	8
504.7101	Longitudinal Steel Stiffeners, Fabrication and Delivery	LF	2,355
504.7102	Longitudinal Steel Stiffeners, Installation	LF	2,355
504.81	Remove Rivet and Replace with High-Strength Bolt	EA	100
504.881	Post-Tensioning Steel Anchor Blocks - Fabricated and Delivered	EA	44
504.882	Post-Tensioning Steel Anchor Blocks - Installed	EA	44
504.883	Post-Tensioning Conduits and Hangers	LS	1
504.884	Post-Tensioning Tendons and Miscellaneous Hardware	LS	1
506.141	Field Painting of Existing Structural Steel Girders (71,600 SF)	LS	1
506.17	Surface Preparation of Existing Structural Steel Girders (71,600 SF)	LS	1
506.9108	Containment System and Pollution Control	LS	1
508.141	High Performance Waterproofing Membrane (7,170 SY)	LS	1
518.391	Repairing Granite Curb Joint and Bedding Mortar	LF	850
518.64	Rapid Set Mortar Bags for Temporary Deck Patching	EA	25
518.80	Partial Depth Concrete Deck Repairs	SF	1,050
518.81	Full Depth Concrete Deck Repairs	SF	50
518.86	Bridge Joint Header Concrete Replacement	SF	330
524.88	Scaffolding	LS	1
619.1202	Temporary Mulch	LS	1
629.05	Hand Labor, Straight Time	HR	20
631.36	Foreman	HR	10
652.361	Maintenance of Traffic Control Devices	LS	1
656.632	30 inch Temporary Silt Fence	LF	350
659.10	Mobilization	LS	1

ITEM DESCRIPTION

- THE ELEVATIONS SHOWN HEREIN ARE BASED ON THE NAVD 88 DATUM. THE AS-BUILT PLANS ARE BASED ON THE NGVD 29 DATUM.
- 2. FOR ADDITIONAL DETAILS REFERENCED OR NOT SHOWN IN THESE DRAWINGS, SEE THE STATE OF MAINE DEPARTMENT OF TRANSPORTATION STANDARD DETAILS, DECEMBER 2002 WITH UPDATES.
- 3. COPIES OF THE AS-BUILT PLANS ARE ON FILE AT THE MAINE TURNPIKE AUTHORITY. A PORTION OF THESE PLANS ARE INCLUDED IN THIS CONTRACT FOR THE CONTRACTOR'S CONVENIENCE. THE COMPLETENESS AND ACCURACY OF THESE PLANS IS NOT GUARANTEED.
- 4. CONTRACTOR SHALL FIELD VERIFY ALL NECESSARY INFORMATION AS SPECIFIED HEREIN PRIOR TO SHOP DRAWING SUBMITTAL.
- 5. CONTRACTOR SHALL PROVIDE RESIDENT ACCESS TO ALL AREAS UNDER CONSTRUCTION FOR INSPECTION PURPOSES. THIS SHALL BE INCIDENTAL TO PAY ITEM 524, SCAFFOLDING
- 6. SCAFFOLDING SHALL PROVIDE ACCESS TO FASCIA GIRDERS FOR EITHER PAINTING OR POST-TENSIONING CONSTRUCTION TASKS.

Scal	le:			Designed by:	:				
						HN	ITD		
No.	Revision	Ву	Date	_					
				CONSULTANT P	ROJECT	MANAGER:	Craig R. Morin	, P.E.	
					Ву	Date		Ву	Date
				Designed	AJF	03/13	Checked	CRM	03/13
				Drawn	MPC	03/13	In Charge of	RAL	03/13

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MTA PROJECT MANAGER: Kristi Van Ooyen, P.E.


BRIDGE REPAIR AND STRENGTHENING ANDROSCOGGIN RIVER OVERPASS


> INDEX, GENERAL NOTES AND QUANTITIES

> > SHEET NUMBER: GN-01

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ITEM NO




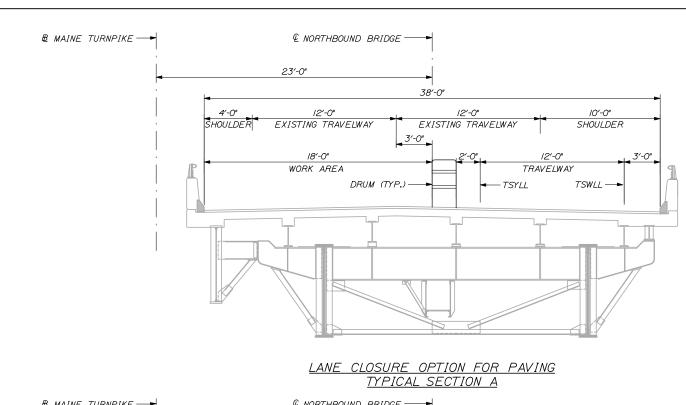

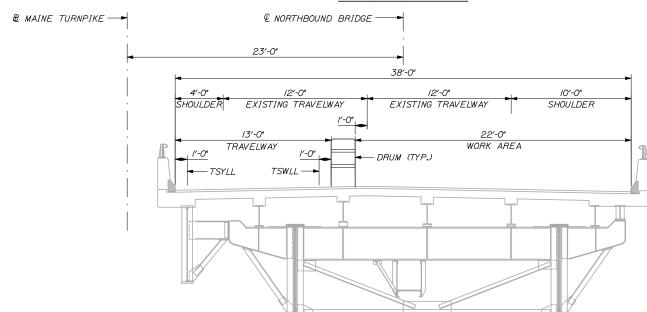
MAINTENACE OF TRAFFIC GENERAL NOTES
1. DRUM SPACING PER MAINTENANCE OF TRAFFIC DETAILS.

- 2. ALL TEMPORARY PAVEMENT MARKINGS PLACED ON NEW PAVEMENT SHALL BE TEMPORARY 6 INCH PAVEMENT MARKING
- 3. REMOVE ALL CONFLICTING PAVEMENT MARKINGS.
- 4. FINAL PAVEMENT MARKINGS WILL BE COMPLETED BY THE TURNPIKE AUTHORITY.
- 5. LANE CLOSURES WITH CONCRETE BARRIER ARE REQUIRED FOR MOST CONSTRUCTION OPERATIONS. LANE CLOSURES WITH DRUMS MAY BE USED FOR PAVING OPERATIONS AS SHOWN IN TYPICAL SECTIONS, LANE CLOSURES WITH DRUMS MAY BE ALLOWED FOR OTHER ACTIVITIES, AS APPROVED BY THE RESIDENT.

LANE CLOSURE OPTION FOR PAVING TYPICAL SECTION B LANE WIDTH RESTRICTION - NIGHT WORK SEE SPECIFICATIONS SECTION 652

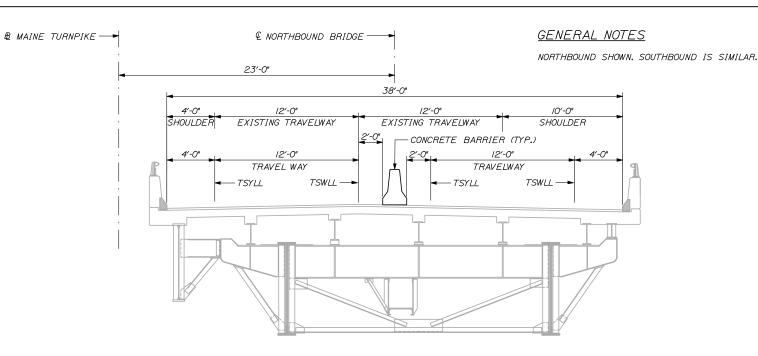

CROSSOVER TYPICAL SECTION

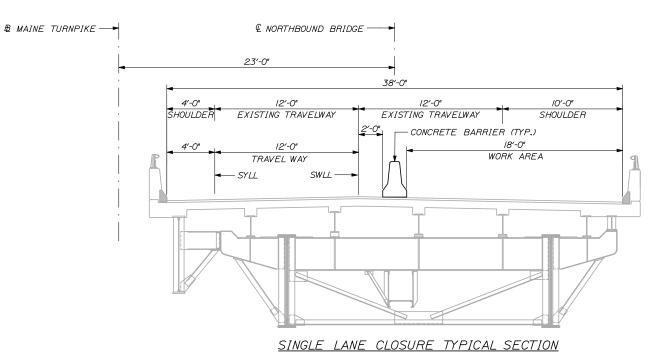

MAINTENANCE OF TRAFFIC - ALTERNATIVES

I.THE MAINTENANCE OF TRAFFIC COMPONENT TO THIS PROJECT SHALL BE COMPLETED USING ONE OF TWO ALTERNATIVES; SINGLE-LANE CLOSURES PER BRIDGE, OR THE CROSSOVER ALTERNATIVE WHICH REQUIRES MODIFICATION AND EXPANSION OF THE EXISTING CROSSOVERS.

2. THE SINGLE-LANE CLOSURE ALTERNATIVE IS ILLUSTRATED ON THE FOLLOWING SHEETS, AND THE ASSOCIATED SPECIAL PROVISIONS ARE FOUND IN THE BODY OF THE TECHNICAL SPECIFICATION PACKAGE.

3. THE CROSSOVER ALTERNATIVE COMPRISES MODIFICATION AND EXPANSION OF THE EXISTING CROSSOVER REGIONS IMMEDIATELY NORTH AND SOUTH OF THE ANDROSCOGGIN RIVER OVERPASS. THE CROSSOVER ALTERNATIVE IS ALSO ILLUSTRATED ON THE FOLLOWING SHEETS. THE ASSOCIATED SPECIAL PROVISIONS ARE FOUND IN APPENDIX B OF THE TECHNICAL SPECIFICATION PACKAGE AND SHALL BE IN ADDITION TO THE SPECIAL PROVISIONS LISTED IN THE BODY OF THE TECHNICAL SPECIFICATIONS. THE CONTRACTOR SHALL NOTE THAT THE SCHEDULE OF BID PRICES CONTAINS JUST ONE PAY ITEM FOR MAINTENANCE OF TRAFFIC, WHICH SHALL REFLECT THE CONTRACTOR'S PRICE TO PERFORM MAINTENANCE OF TRAFFIC THROUGHOUT THE ENTIRE PROJECT.

Scale: Designed by: Revision By Date CONSULTANT PROJECT MANAGER: Craig R. Morin, P.E Ву 03/13 Checked Designed In Charge of RAL


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BRIDGE REPAIR AND STRENGTHENING ANDROSCOGGIN RIVER OVERPASS MAINTENANCE OF TRAFFIC DETAILS I

SHEET NUMBER: MT-01

MTA PROJECT MANAGER: Kristi Van Ooyen, P.E.



SINGLE LANE CLOSURE SIGNS ON EASELS

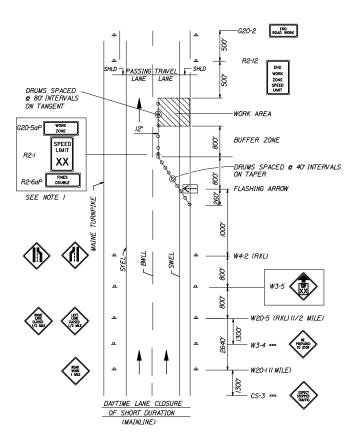I. FOR EASEL SET UP ONLY, THIS SIGN IS NOT BRACKETED. ONE SIGN ASSEMBLY IS PLACED AT THE END OF THE TAPER.


GENERAL NOTES:


I. FOR SIGN DETAILS, SEE MAINTENANCE OF TRAFFIC SIGN SUMMARY SHEETS.

2. TRUCKS ENTERING SIGN SHALL ALSO BE USED AT LOCATIONS WHERE TRUCKS ENTER THE WORK ZONE FROM THE TRAVEL LANE.

3. SIGNS DESIGNATED WITH *** SHALL BE USED DURING STOPPAGES OF TRAFFIC.


4. WHEN TRUCK MOUNTED ATTENUATORS ARE INCLUDED IN THE CONTRACT (INCIDENTAL OR PAY ITEM), THEY SHALL BE LOCATED WITHIN THE WORK ZONE, NOT THE BUFFER ZONE.

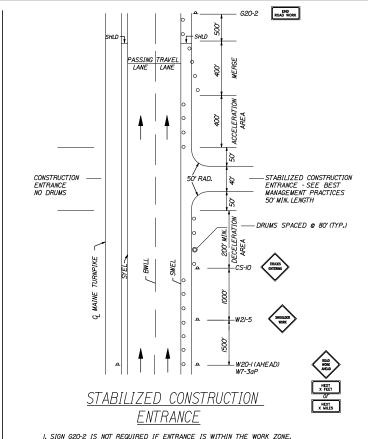

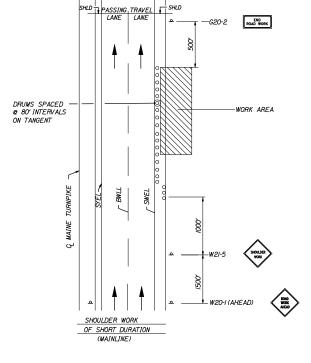

SHOULDER WORK

I.THE W20-I AND G20-2 SIGNS ARE NOT REQUIRED IF THE SHOULDER CLOSURE IS WITHIN A PREVIOUSLY ESTABLISHED WORK ZONE.

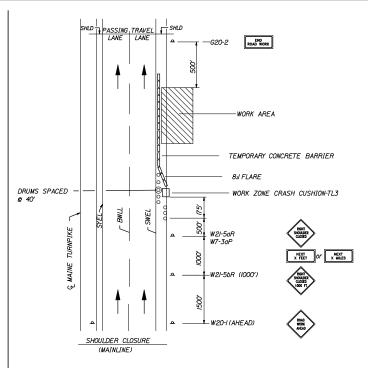

SHOULDER CLOSURE

I.THE W20-I AND G20-2 SIGNS ARE NOT REQUIRED IF THE SHOULDER CLOSURE IS WITHIN A PREVIOUSLY ESTABLISHED WORK ZONE.

GENERAL MAINTENANCE OF TRAFFIC NOTES:

- I. ALL WORK TO CONFORM TO MAINE DEPARTMENT OF TRANSPORTATION
 STANDARD SPECIFICATIONS FOR HIGHWAY AND BRIDGES, EXCEPT AS MODIFIED BY THE MAINE TURNPIKE AUTHORITY'S GENERAL AND SPECIAL PROVISIONS.
- 2. ALL PAVMENT STRIPING & SIGNING SHALL BE IN ACCORDANCE WITH THE "MANUAL ON UNIFORM TRAFFIC CONTROL DEVICES", U.S.D.O.T., F.H.W.A., LATEST EDITION. NOTE THERE IS A 2009 EDITION OF MUTCO.
- 3. THESE PLANS SHOW THE GENERAL CONDITION FOR TURNPIKE MAINLINE TRAFFIC CONTROL DURING CONSTRUCTION, SLIGHT MODIFICATIONS IN CONSTRUCTION PROCEDURE MAY OCCUR AND MAY REQUIRE SOME MINOR ADJUSTMENTS TO BE MADE IN THE FIELD, ALL PROCEDURES MUST BE APPROVED BY THE RESIDENT.
- 4. THE CONTRACTOR SHALL REMOVE ALL PAVEMENT MARKINGS THAT CONFLICT WITH PROPOSED PAVEMENT MARKINGS IN ACCORDANCE WITH THE SPECIFICATIONS AND MUTCD.
- 5. EXPOSED BARRIER ENDS SHALL BE PROTECTED BY A WORK ZONE CRASH CUSHION.
- 6. ALL GEOMETRIC INFORMATION FOR ALL PHASES OF TRAFFIC CONTROL WILL BE SUPPLIED TO THE CONTRACTOR AFTER AWARD.


ABBREVIATIONS FOR ALL M.O.T. PLANS BWLL = BROKEN WHITE LANE LINE

SWEL = SOLID WHITE EDGE LINE


SYEL = SOLID YELLOW EDGE LINE TBWLL - TEMPORARY BROKEN WHITE LANE LINE

TSWLL = TEMPORARY SOLID WHITE LANE LINE

TSYLL = TEMPORARY SOLID YELLOW LANE LINE

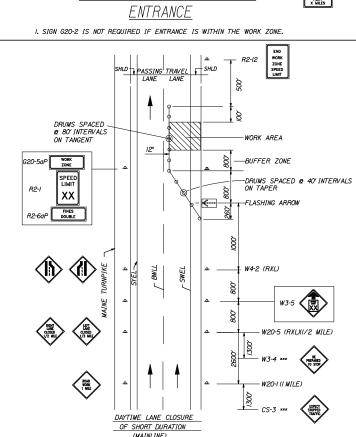

SINGLE LANE CLOSURE - POST MOUNTED SIGN SETUP

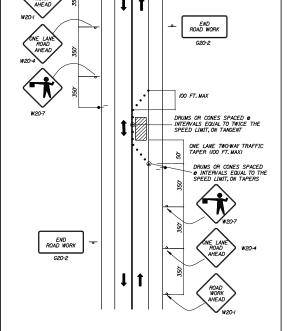

LOCAL ROAD SINGLE LANE CLOSURE

NOTES: I. ROAD WORK AHEAD & END ROAD WORK SIGNS MAY BE OMITTED FOR SHORT DURATION OPERATIONS (LESS THAN I HOUR). 2. FLAGGERS SHALL BE LOCATED SO THEY ARE CLEARLY VISIBLE TO APPROACHING DRIVERS.

3. SIGN SPACING ASSUMES LOCAL ROAD SPEED IS 40 MPH OR LESS.

Scale:

Designed by: AS NOTED By Date Revision CONSULTANT PROJECT MANAGER: Craig R. Morin, P.E. Ву Checked CRM 03/13 In Charge of RAL 03/13 03/13 Designed

HNTB CORPORATION


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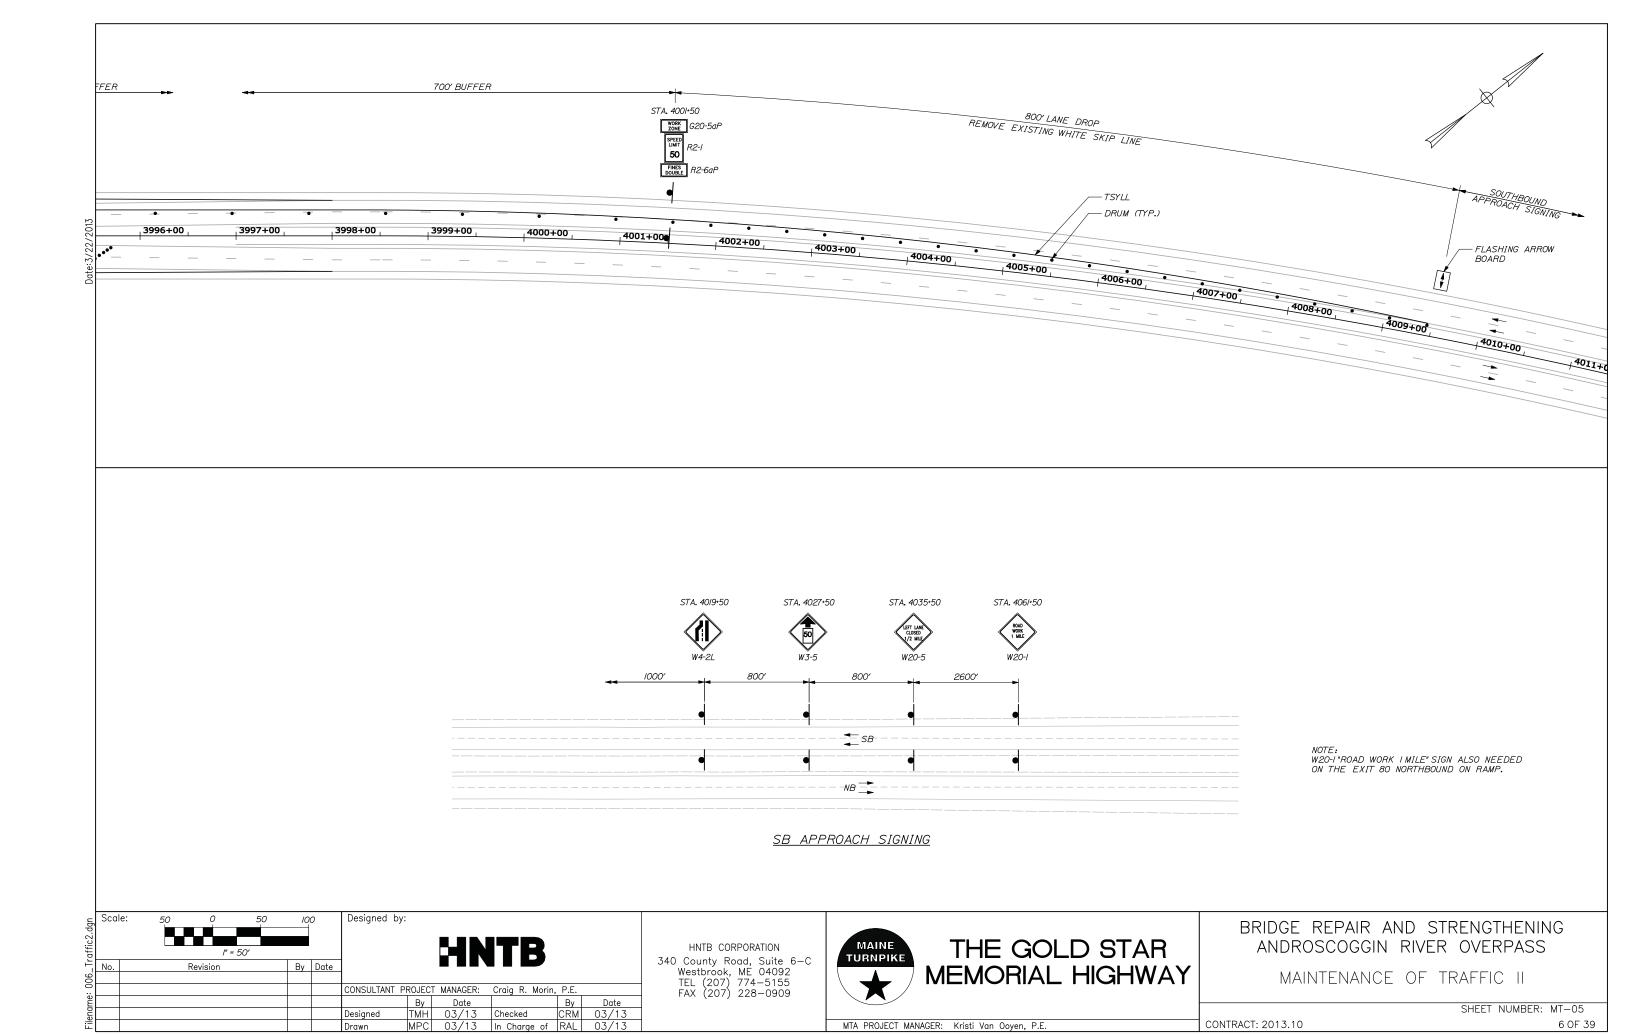


THE GOLD STAR MEMORIAL HIGHWAY BRIDGE REPAIR AND STRENGTHENING ANDROSCOGGIN RIVER OVERPASS MAINTENANCE OF TRAFFIC DETAILS II

SHEET NUMBER: MT-02

MTA PROJECT MANAGER: Kristi Van Ooyen, P.E.



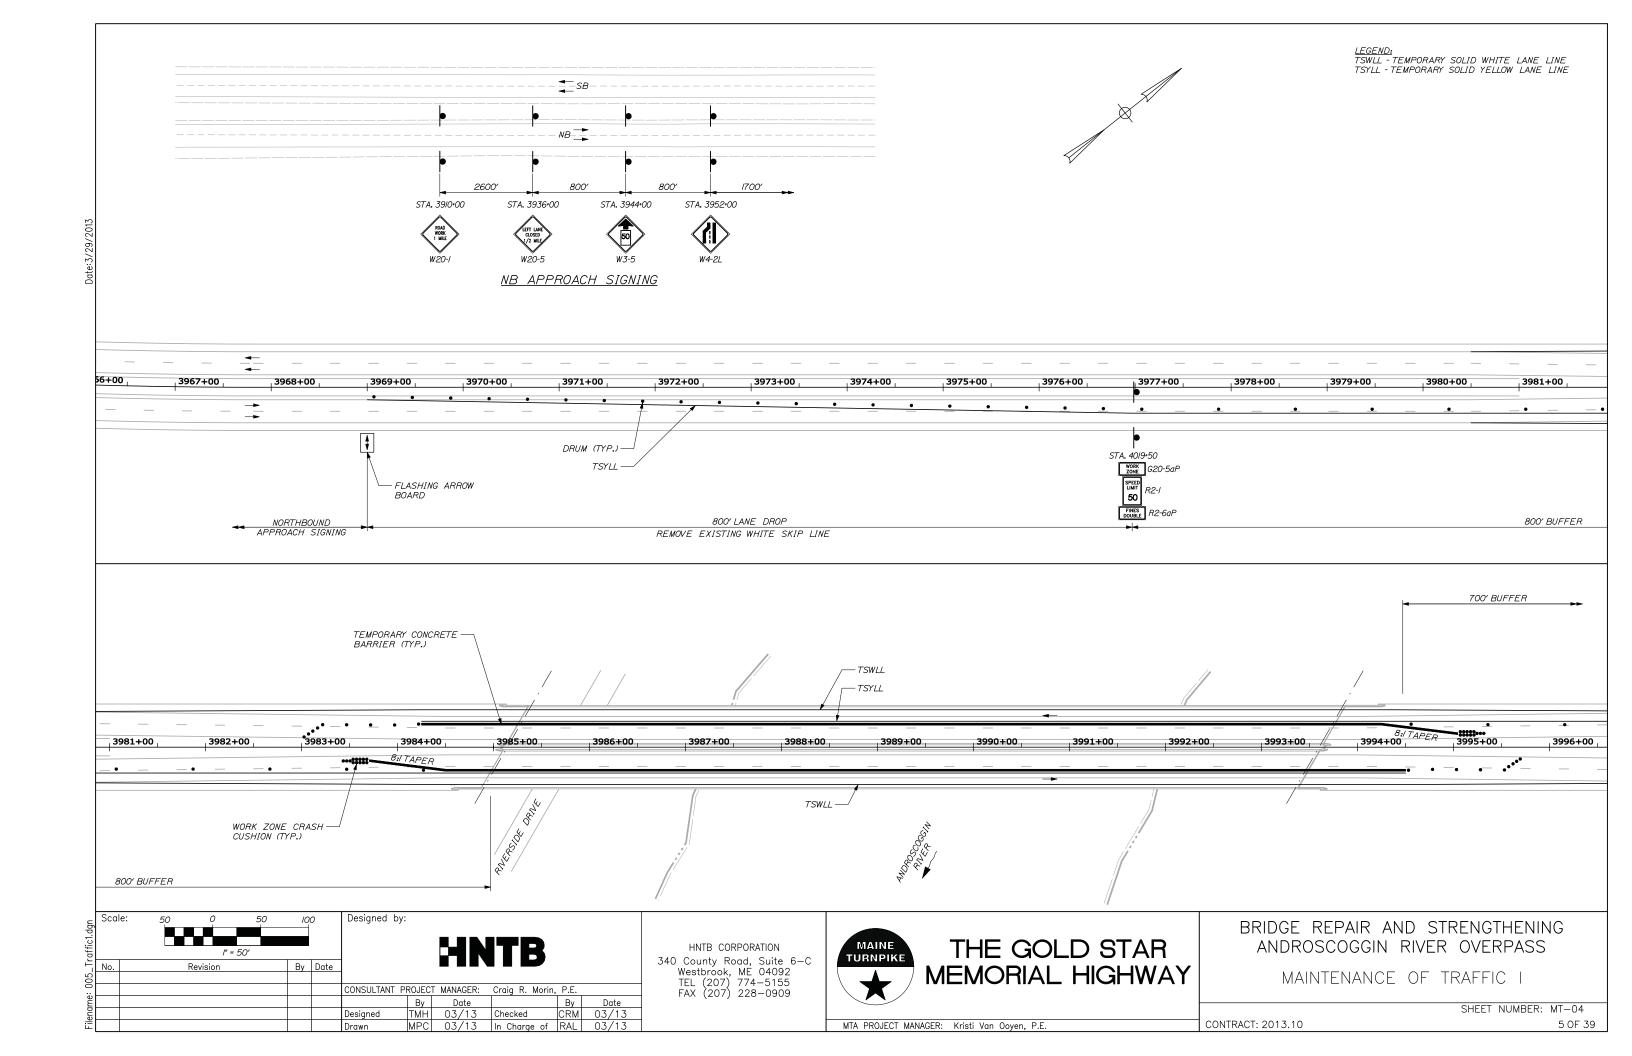

IDENTIFI- CATION	SIZE OF SIGN		TEXT	TEXT DI	MENSIONS	COLOR		
NUMBER	WIDTH	HEIGHT	1241	LETTER HEIGHT	VERTICAL SPACING	ARROW RTE. MKR.	BACK- GROUND	LEGEND BORDER
CS-3	48"	48°	EXPECT STOPPED TRAFFIC	6" 6" 6"	4° 4°		ORANGE	BLACK
G20-I (4)	48"	24"	BRIDGE WORK NEXT X MILES	CONF	DIMENSION DRM TO "ST WAY SIGNS"	ANDARD	ORANGE	BLACK
G20-2	48"	24"	END ROAD WORK				ORANGE	BLACK
G20-5aP	48"	24"	WORK ZONE				ORANGE	BLACK
R2-I (50)	48"	60"	SPEED LIMIT XX				WHITE	BLACK
R2-6aP	48"	24"	FINES DOUBLE				WHITE	BLACK
R2-12	36"	54"	END WORK ZONE SPEED LIMIT				WHITE	BLACK
RII-2	48"	30"	ROAD CLOSED				WHITE	BLACK
WI-4L	48"	48"	(ORANGE	BLACK
W3-4	48"	48"	BE PREPARED TO STOP				ORANGE	BLACK
W3-5 (50)	48"	<i>48</i> *	(XX)				ORANGE	BLACK
W4-2L	48"	48"					ORANGE	BLACK
W4-2R	48"	48"					ORANGE	BLACK

IDENTIFI-	SIZE OF SIGN		75.4	TEXT L	DIMENSIONS	(INCHES)	COLOR		
CATION NUMBER	WIDTH	HEIGHT	TEXT	LETTER HEIGHT	VERTICAL SPACING	ARROW RTE.MKR.	BACK- GROUND	LEGEND BORDER	
W7-3aP (1000)	36"	<i>30</i> "	NEXT XX FEET	CON	DIMENSION FORM TO "ST CHWAY SIGNS"	ANDARD	ORANGE	BLACK	
WI2-2	48"	48"	15'-0"				ORANGE	BLACK	
W2O-I (I MILE) (AHEAD)	48*	48"	ROAD WORK XXX				ORANGE ORANGE	BLACK BLACK	
W20-4	48*	48"	ONE LANE ROAD AHEAD				ORANGE	BLACK	
W20-5L (1/2 MILE)	48"	48"	LEFT LANE CLOSED XXX				ORANGE	BLACK	
W20-5R (1/2 MILE)	48"	48"	RIGHT LANE CLOSED XXX				ORANGE	BLACK	
W20-7a	48"	48"					ORANGE	BLACK	
W2I-5	48"	48"	SHOULDER				ORANGE	BLACK	
W2I-5aL	48"	48"	LEFT SHOULDER CLOSED				ORANGE	BLACK	
W2I-5aR	48"	48"	RIGHT SHOULDER CLOSED				ORANGE	BLACK	

IDENTIFI-	SIZE OF SIGN		TEVT	TEXT D.	IMENSIONS	COLOR		
CATION NUMBER	WIDTH	HEIGHT	TEXT	LETTER HEIGHT	VERTICAL SPACING	ARROW RTE.MKR.	BACK- GROUND	LEGEND BORDER
W2I-5aL (IOOO)	48*	48"	LEFT SHOULDER CLOSED XXX FT	CONF	DIMENSIONS ORM TO "ST WAY SIGNS"	ANDARD	ORANGE	BLACK
W2I-5aR (1000)	48"	48*	RIGHT SHOULDER CLOSED XXX FT				ORANGE	BLACK

NOTES:
I. PLACE WI2-2 1000' BEFORE THE BRIDGE ON ROUTE 136 PRIOR TO ANY CLEARANCE REDUCTION STAGING IS INSTALLED.

2. PLACE G20-I ON I-95 FOUR MILES NORTH AND 4 MILES SOUTH OF ANDROSCOGGIN RIVER BRIDGE.

Scale: Designed by: By Date Revision CONSULTANT PROJECT MANAGER: Craig R. Morin, P.E.
 By
 Date
 By
 Date

 TMH
 03/13
 Checked
 CRM
 03/13

 MPC
 03/13
 In Charge of RAL
 03/13

Designed Drawn

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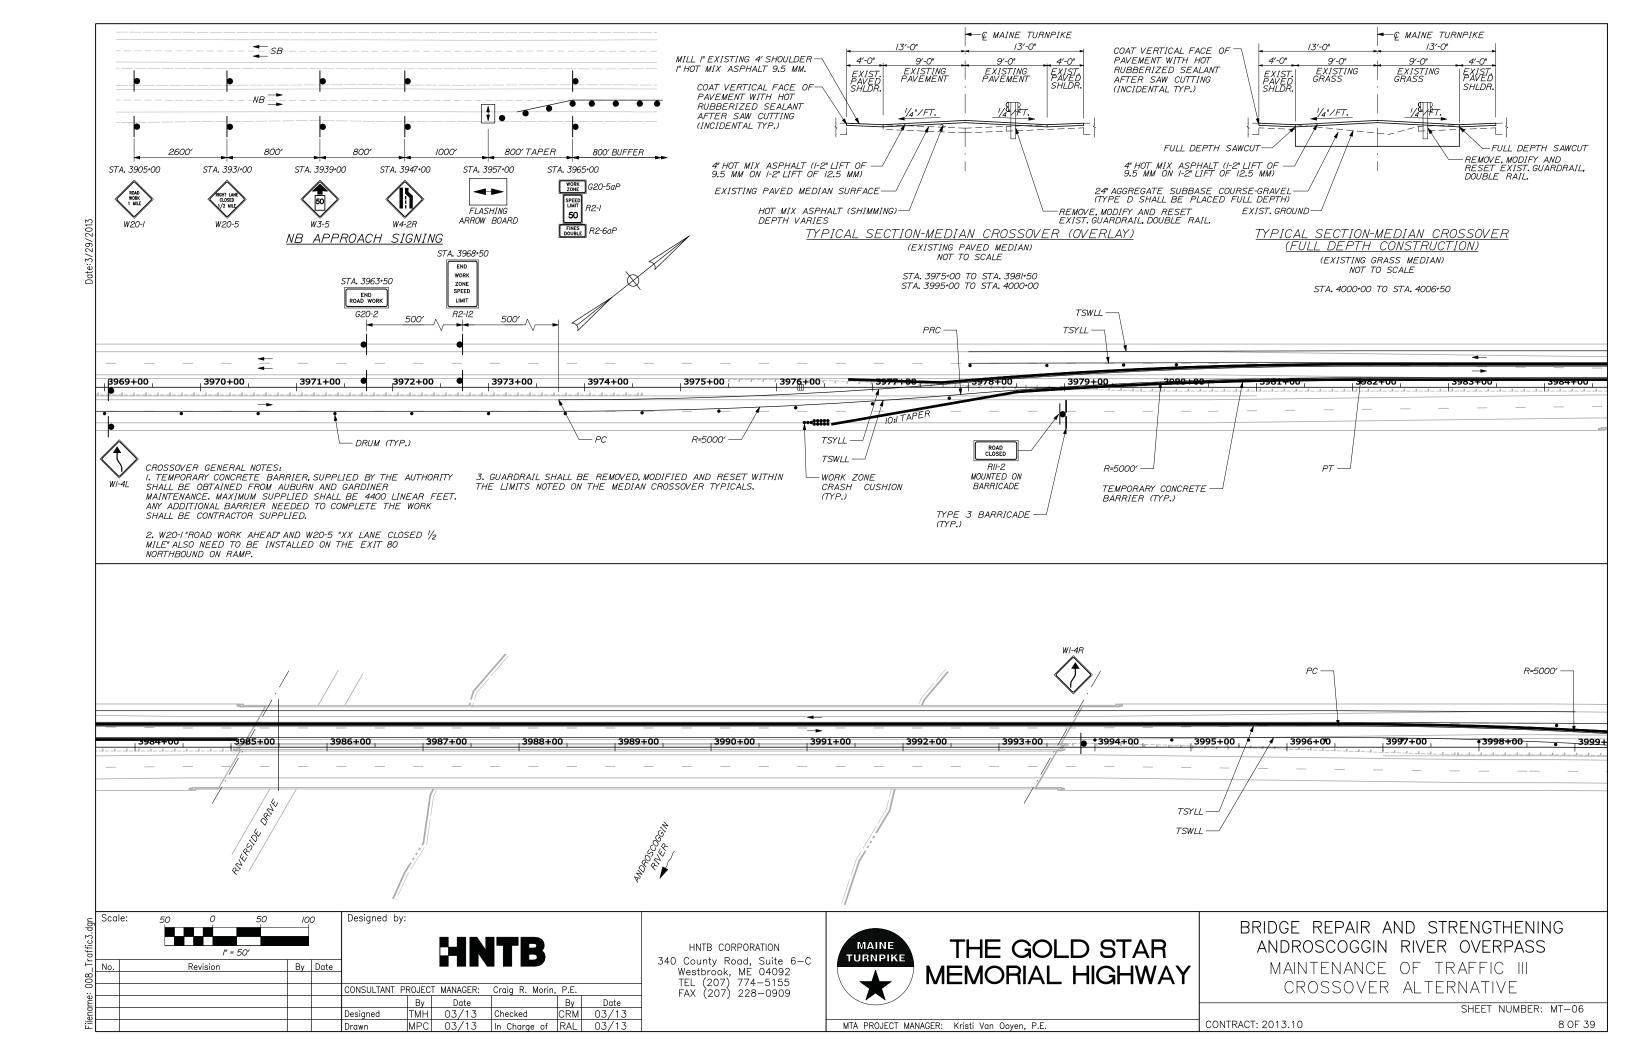
THE GOLD STAR MEMORIAL HIGHWAY


ANDROSCOGGIN RIVER OVERPASS MAINTENANCE OF TRAFFIC LANE CLOSURE OPTION & RT. 136 SIGNING

BRIDGE REPAIR AND STRENGTHENING


SHEET NUMBER: MT-03 CONTRACT: 2013.10

MTA PROJECT MANAGER: Kristi Van Ooyen, P.E.




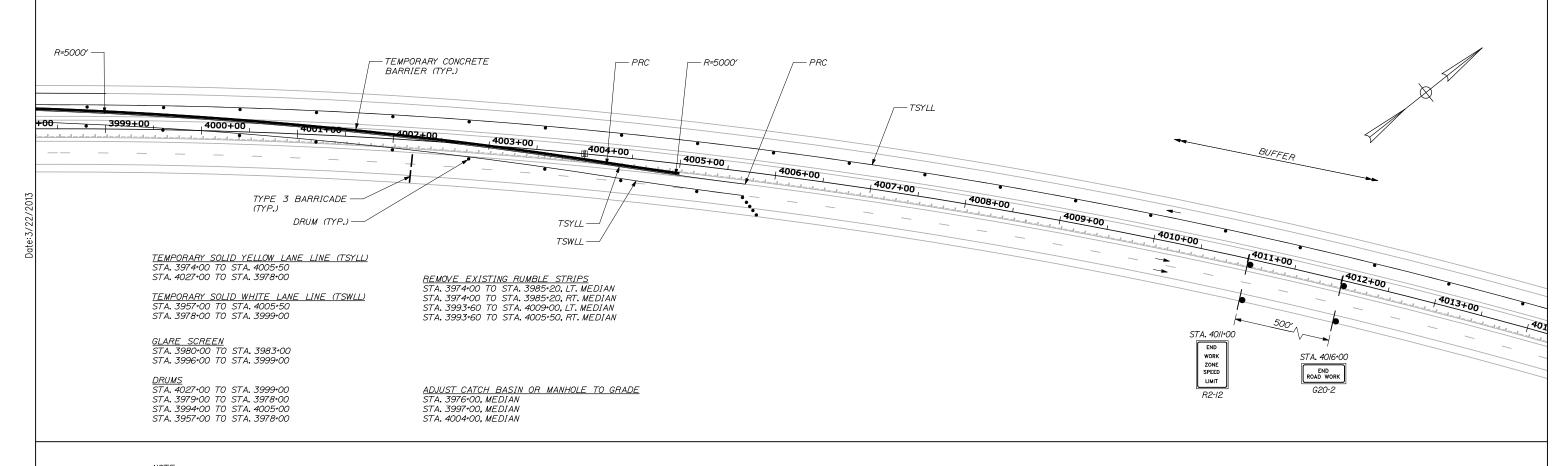


<u>NOTE:</u> STATIONS LISTED ARE FOR THE MAINTENANCE OF TRAFFIC SETUP SHOWN. CONTRACTORS MAINTENANCE OF TRAFFIC PLANS MAY DIFFER.

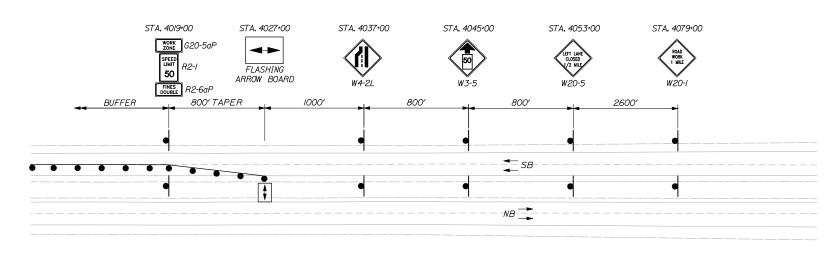

SB APPROACH SIGNING

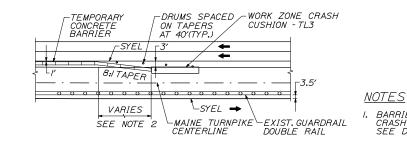

EXIST. GUARDRAIL ON FAR SIDE OF MEDIAN

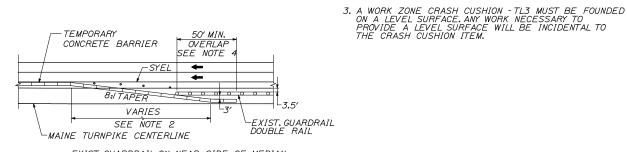

EXIST. GUARDRAIL ON NEAR SIDE OF MEDIAN

CONCRETE BARRIER / GUARDRAIL OVERLAP DETAIL

NOT TO SCALE

Scale:	50 0 50	10	0	Designed by	y:				
	J" = 50'					HN	ITB		
No.	Revision	By	Date						
				CONSULTANT	PROJECT	MANAGER:	Craig R. Morin,	. P.E.	
					Ву	Date		Ву	Date
				Designed	TMH	03/13	Checked	CRM	03/13
				Drawn	MPC	03/13	In Charge of	RAL	03/13
				Drawn	MPC	03/13	In Charge of	RAL	03/1

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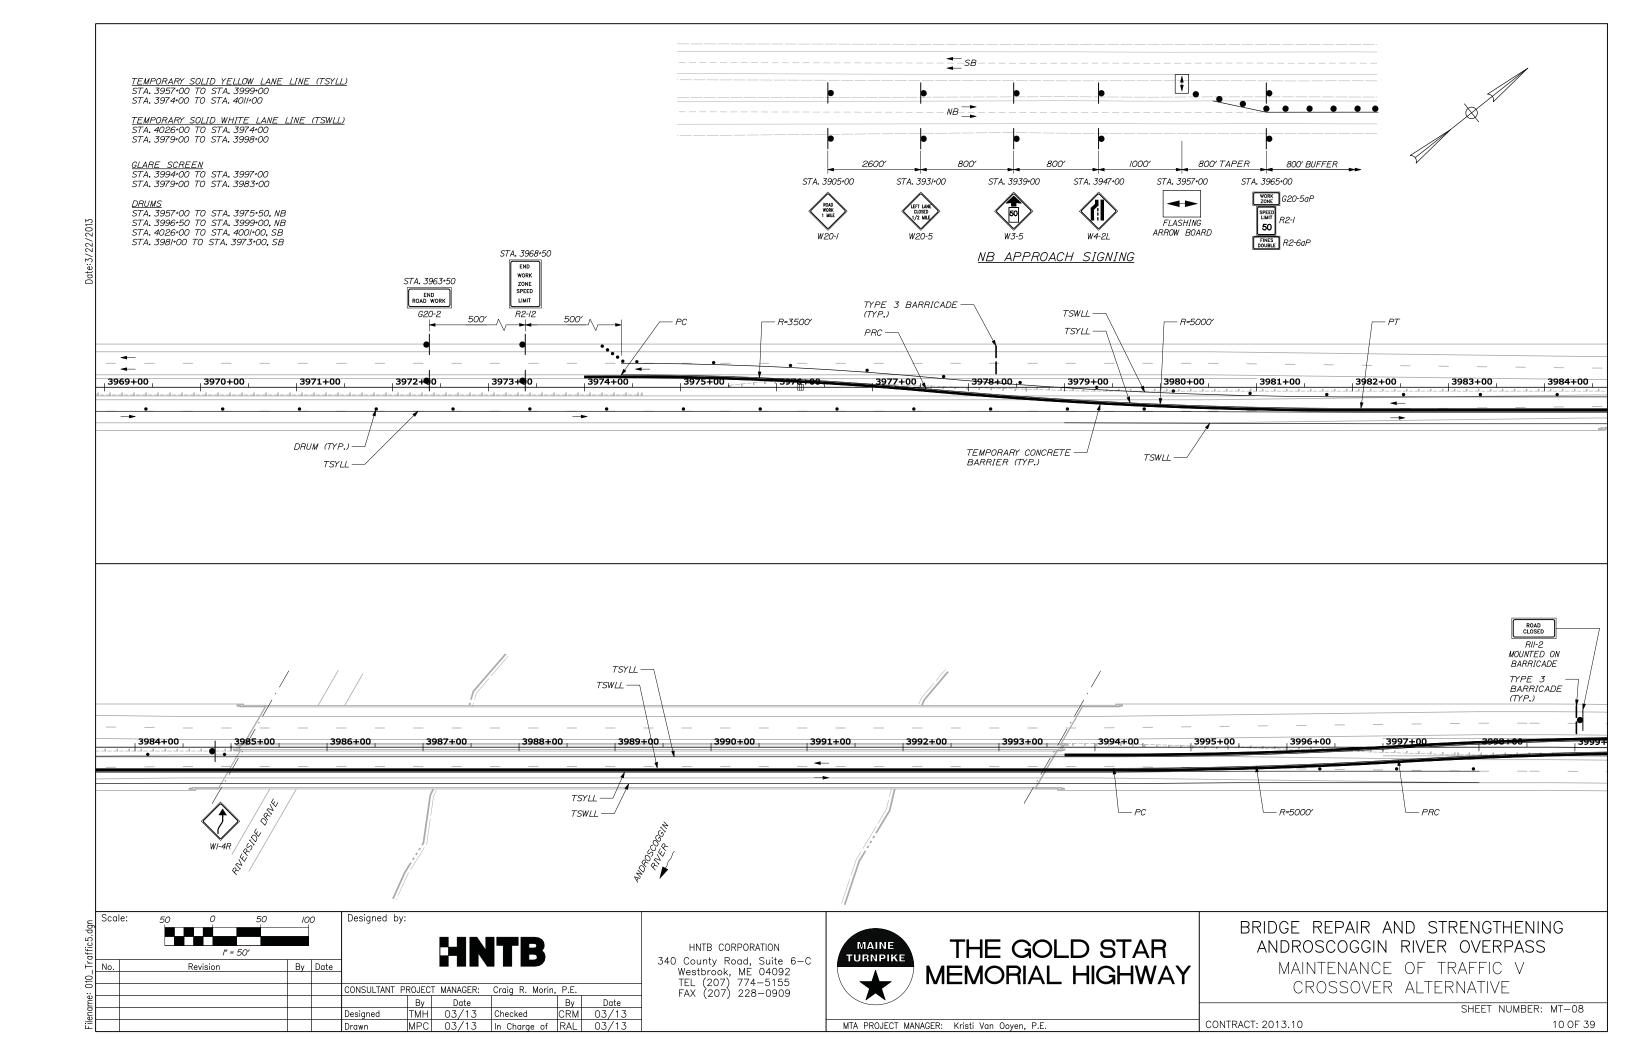
BRIDGE REPAIR AND STRENGTHENING ANDROSCOGGIN RIVER OVERPASS MAINTENANCE OF TRAFFIC IV CROSSOVER ALTERNATIVE


SHEET NUMBER: MT-07


BARRIER ENDS SHALL BE PROTECTED BY A WORK ZONE CRASH CUSHION (TL-3), OR LAPPED BEHIND GUARDRAIL. SEE DETAILS THIS SHEET.

2. 8:I MINIMUM TAPERED BARRIER LENGTH IS DEPENDENT ON LOCATION OF BARRIER RELATIVE TO MAINE TURNPIKE SHOULDERS OR LANES.


MTA PROJECT MANAGER: Kristi Van Ooyen, P.E.



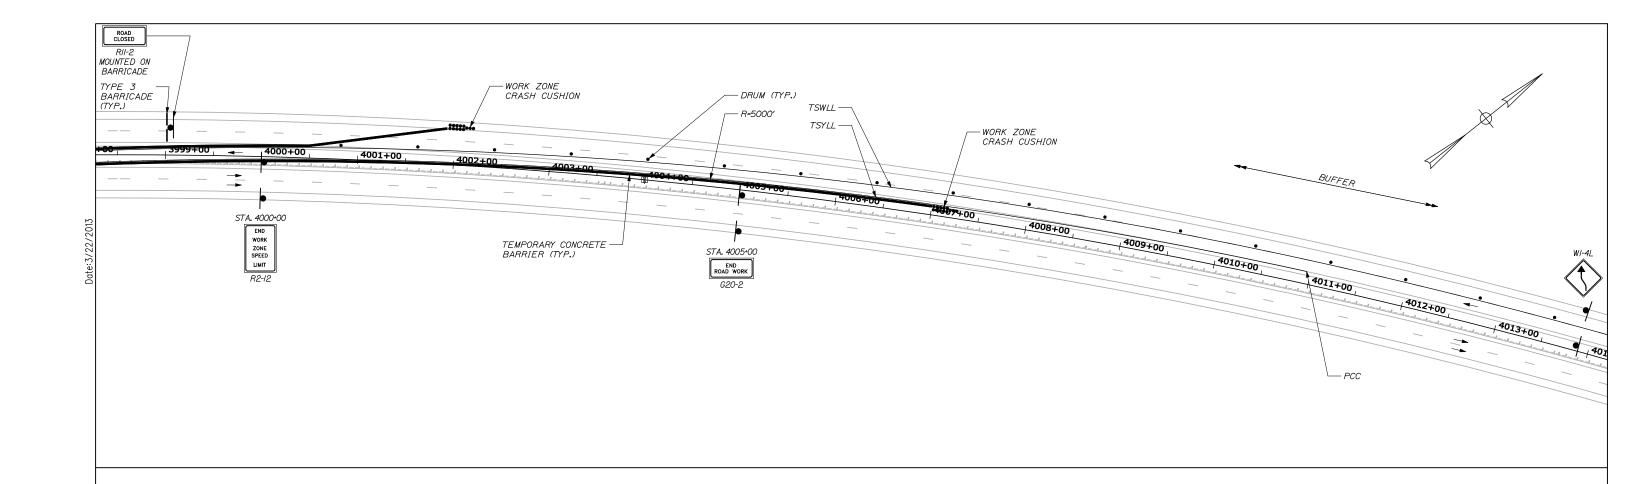

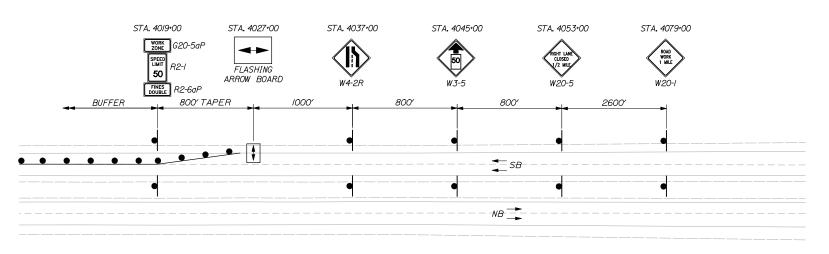

SB APPROACH SIGNING

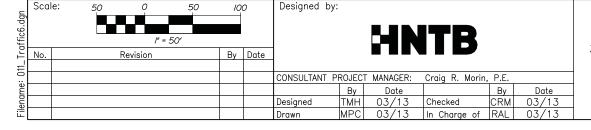


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BRIDGE REPAIR AND STRENGTHENING ANDROSCOGGIN RIVER OVERPASS MAINTENANCE OF TRAFFIC VI CROSSOVER ALTERNATIVE

SHEET NUMBER: MT-09

MTA PROJECT MANAGER: Kristi Van Ooyen, P.E.



No. Revision By Date

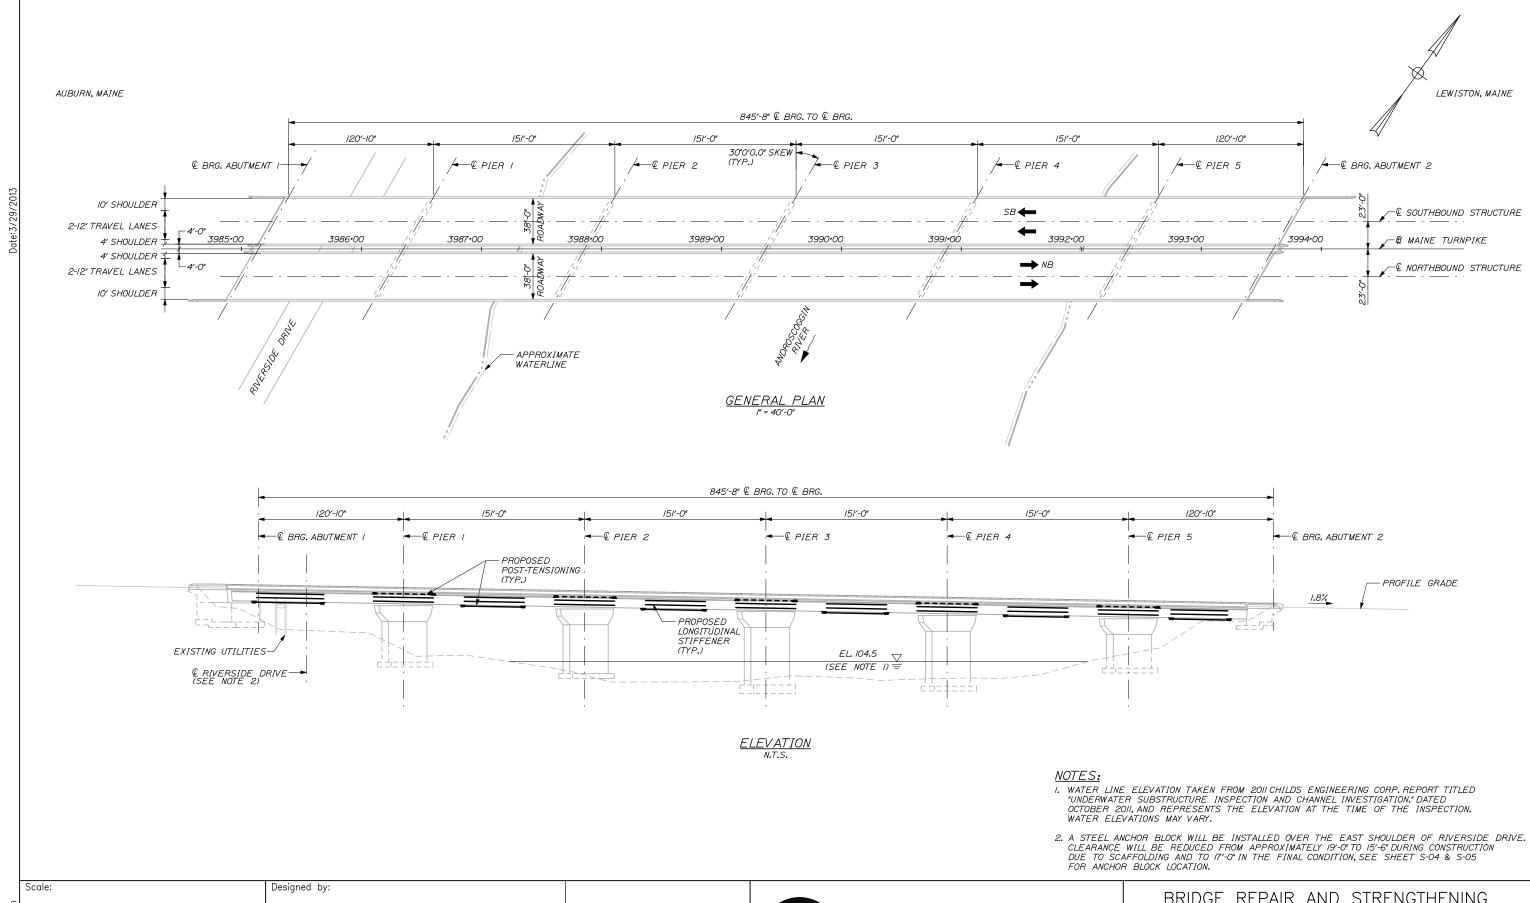CONSULTANT PROJECT MANAGER: Craig R. Morin, P.E.

By Date By Date

Designed AJF 03/13 Checked CRM 03/13

Drawn MPC 03/13 In Charge of RAL 03/13

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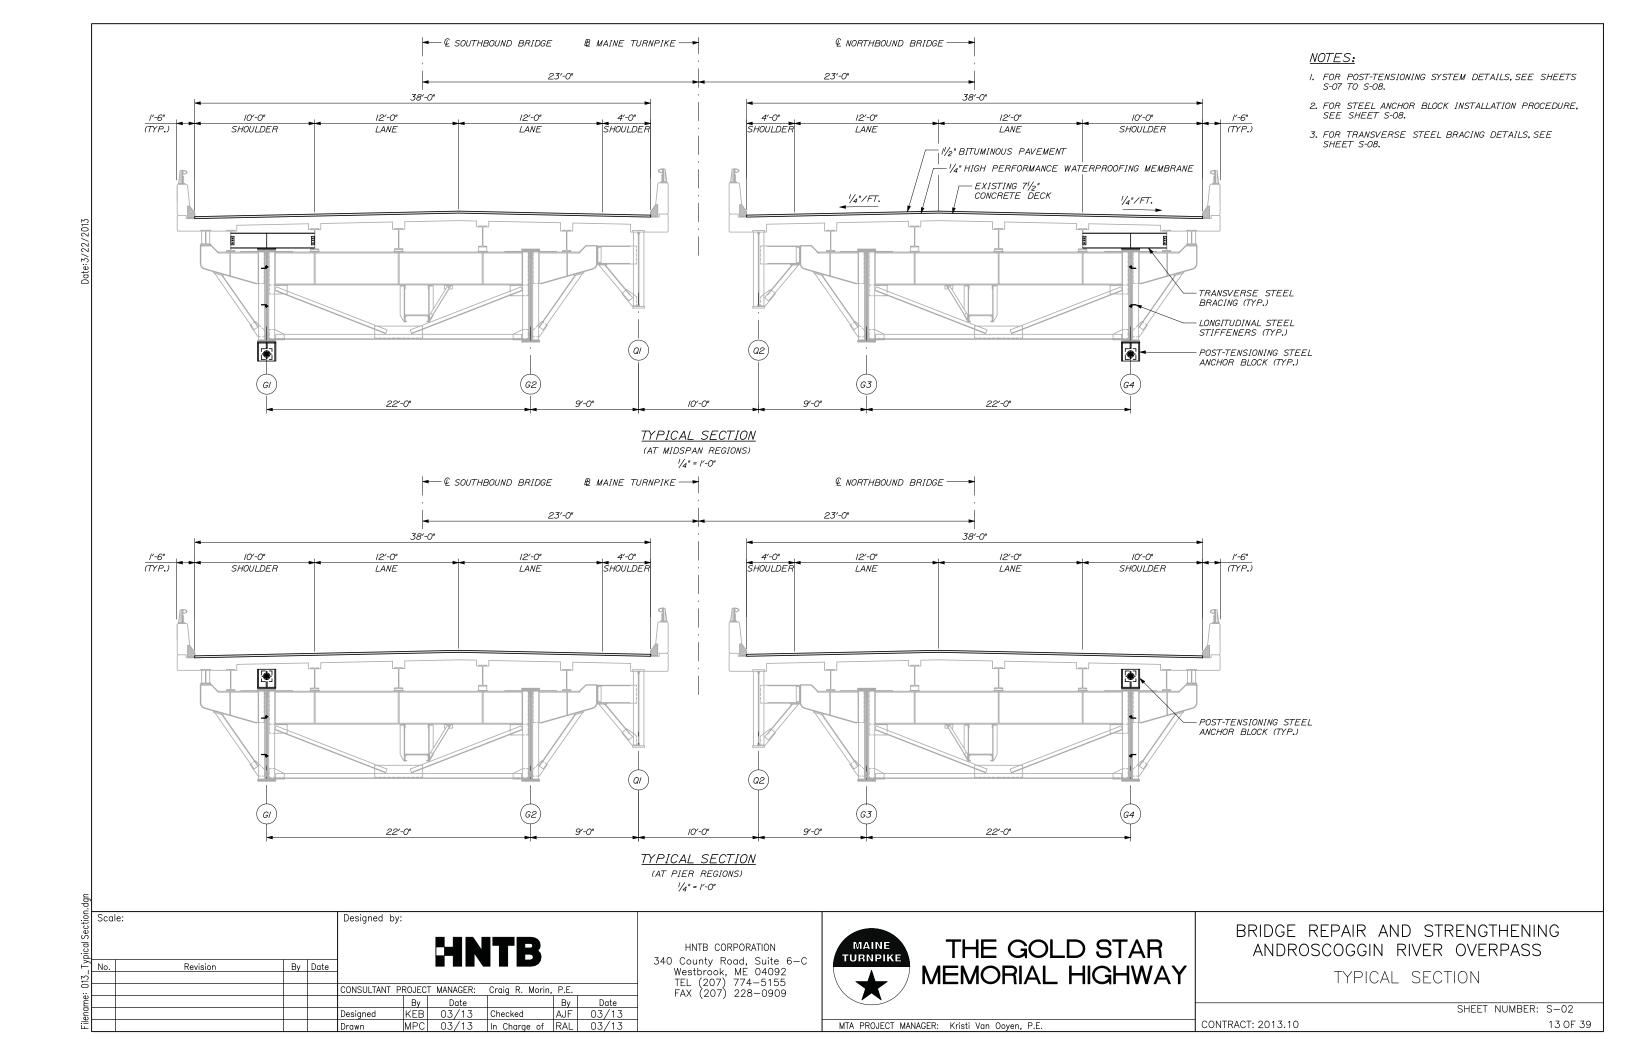



BRIDGE REPAIR AND STRENGTHENING ANDROSCOGGIN RIVER OVERPASS


BRIDGE GENERAL PLAN AND ELEVATION

SHEET NUMBER: S-01

MTA PROJECT MANAGER: Kristi Van Ooyen, P.E.



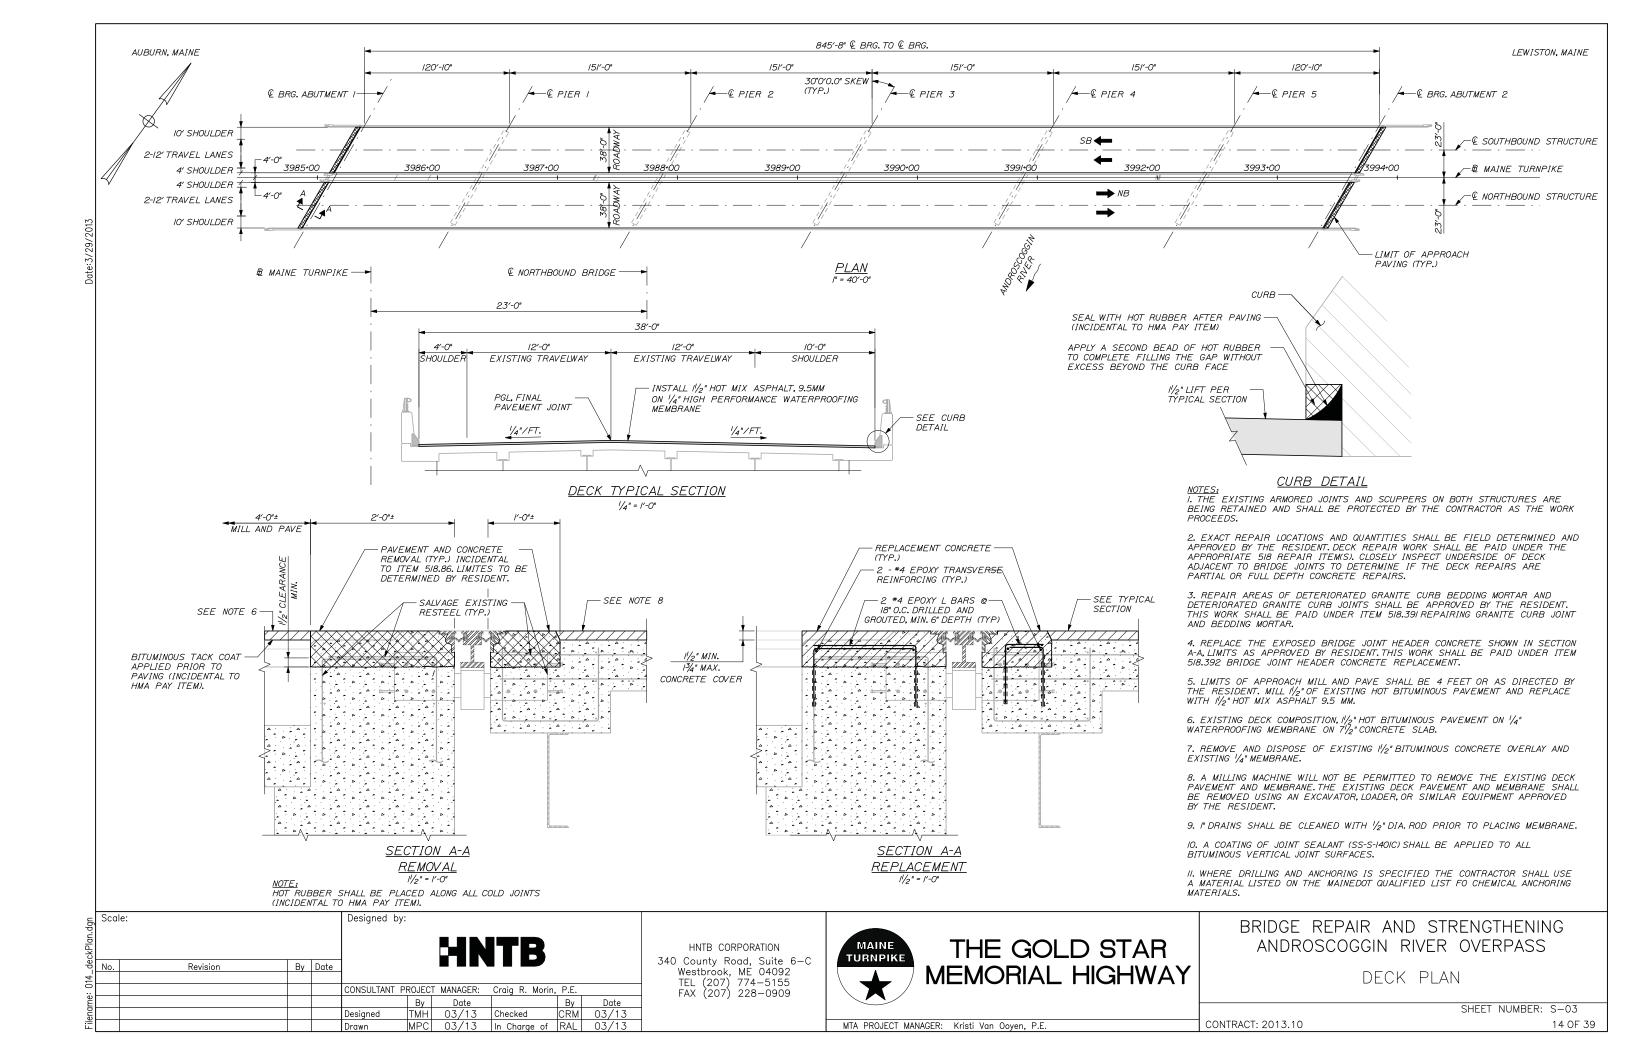

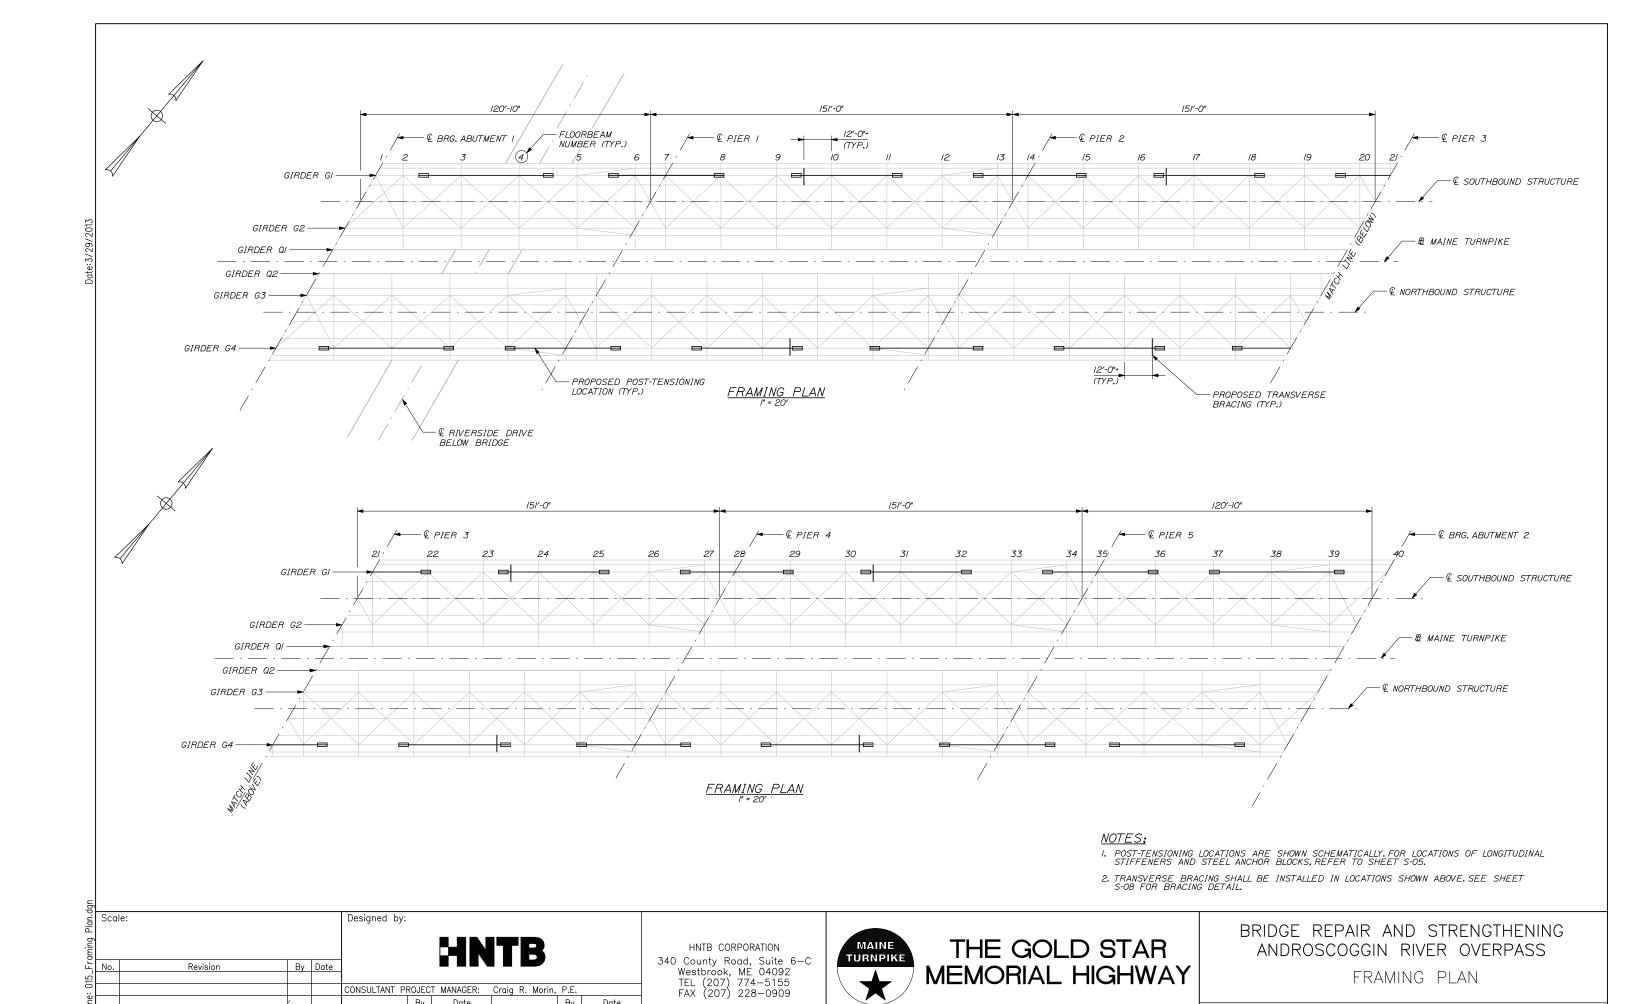

MTA PROJECT MANAGER: Kristi Van Ooyen, P.E.


CONSULTANT PROJECT MANAGER: Craig R. Morin, P.E.

Designed

FRAMING PLAN


CONTRACT: 2013.10

SHEET NUMBER: S-04

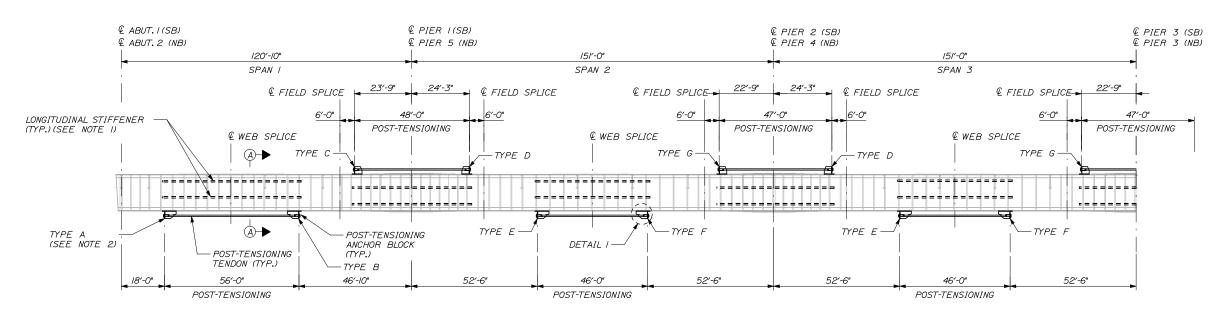

SOUTHBOUND GIRDER GI, LOOKING NORTHWEST


NORTHBOUND GIRDER G4 - OPPOSITE HAND (LOOKING SOUTHEAST)

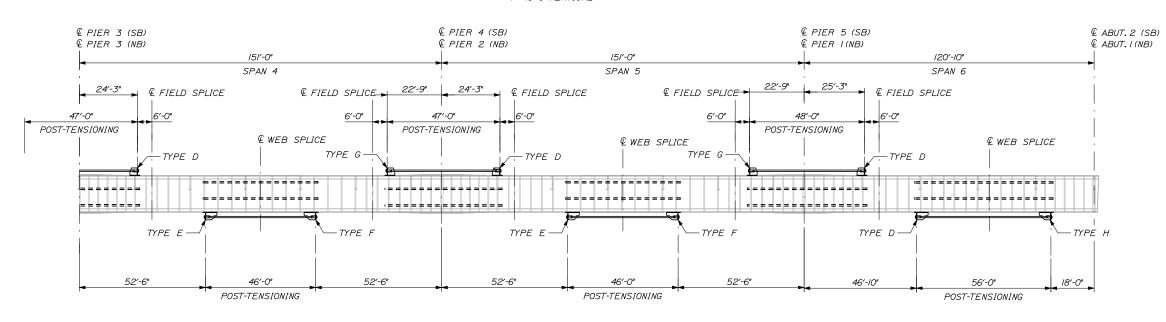

SUMMARY OF LONGITUDINAL STIFFENER SEGMENT LENGTHS (15x3x1/2)

	(L5X3XI/2	()
LOCATION	QUANTITY	APPROXIMATE SEGMENT LENGTH (FT)*
SPAN I	/ / /	18'-0" 8'-3" 12'-0" 14'-3"
PIER I	2	//'-6" 2/'-0"
SPAN 2,3,4,5	/ / /	16'-9" 5'-0" 15'-4" 7'-0"
PIER 2,3,4,5	/ /	10'-0" 11'-0" 22'-0"
SPAN 6	2 	3'-0" 23'-0" 17'-6" 7'-0"

* SEGMENT LENGTHS PERTAIN TO ONE ROW OF STIFFENERS FOR ONE GIRDER AND ARE APPROXIMATE TO PROVIDE A GENERAL MATRIX OF ANGLE LENGTHS. CONTRACTOR SHALL FIELD MEASURE ALL LOCATIONS BASED ON CLEARANCE VALUES GIVEN IN DETAIL ON

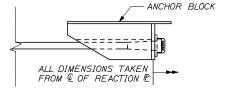

DETAIL I 1/2" = 1'-0"

SOUTHBOUND GIRDER GI, LOOKING NORTHWEST NORTHBOUND GIRDER G4 - OPPOSITE HAND (LOOKING SOUTHEAST)

/" = 20'-0" HORIZONTAL /" = 10'-0" VERTICAL

NOTES;

- I. LONGITUDINAL STIFFENERS SHALL BE MOUNTED ON THE FASCIA-SIDE OF THE WEB AND SHALL SPAN FROM ANCHOR BLOCK TO ANCHOR BLOCK IN EACH POST-TENSIONING ZONE. STIFFENERS MAY BE TERMINATED AT CONFLICTS, SUCH AS WEB SPLICES AND FLOORBEAMS. FOR ADDITIONAL INFORMATION SEE DETAILS ON SHEET S-07. LONGITUDINAL STIFFENERS SHALL BE INSTALLED ON BOTH GLAND G4 PRIOR TO POST-TENSIONING.
- 2. DESIGNATED PATTERN TYPES INDICATE THE EXPECTED RIVET PATTERN AT EACH ANCHOR BLOCK LOCATION. SEE SHEET S-08 FOR PATTERN DETAILS.THESE PATTERNS ARE TO BE FIELD VERIFIED BY THE CONTRACTOR PRIOR TO THE ANCHOR BLOCK DESIGN SUBMITTAL FIELD VERIFICATION IS REQUIRED DUE TO LIMITED DETAIL IN AS-BUILT SHOP DRAWINGS
- 3. POST-TENSIONING DIMENSIONS SHOWN ARE GENERAL DIMENSIONAL GUIDELINES. THE ANCHOR BLOCK MAY BE SHIFTED ±6" TO ACCOMMODATE EXISTING RIVET SPACING.

Scale: Designed by: By Date Revision CONSULTANT PROJECT MANAGER: Craig R. Morin, P.E. Ву AJF 03/13 MPC 03/13 Checked CRM 03/13
In Charge of RAL 03/13 Designed

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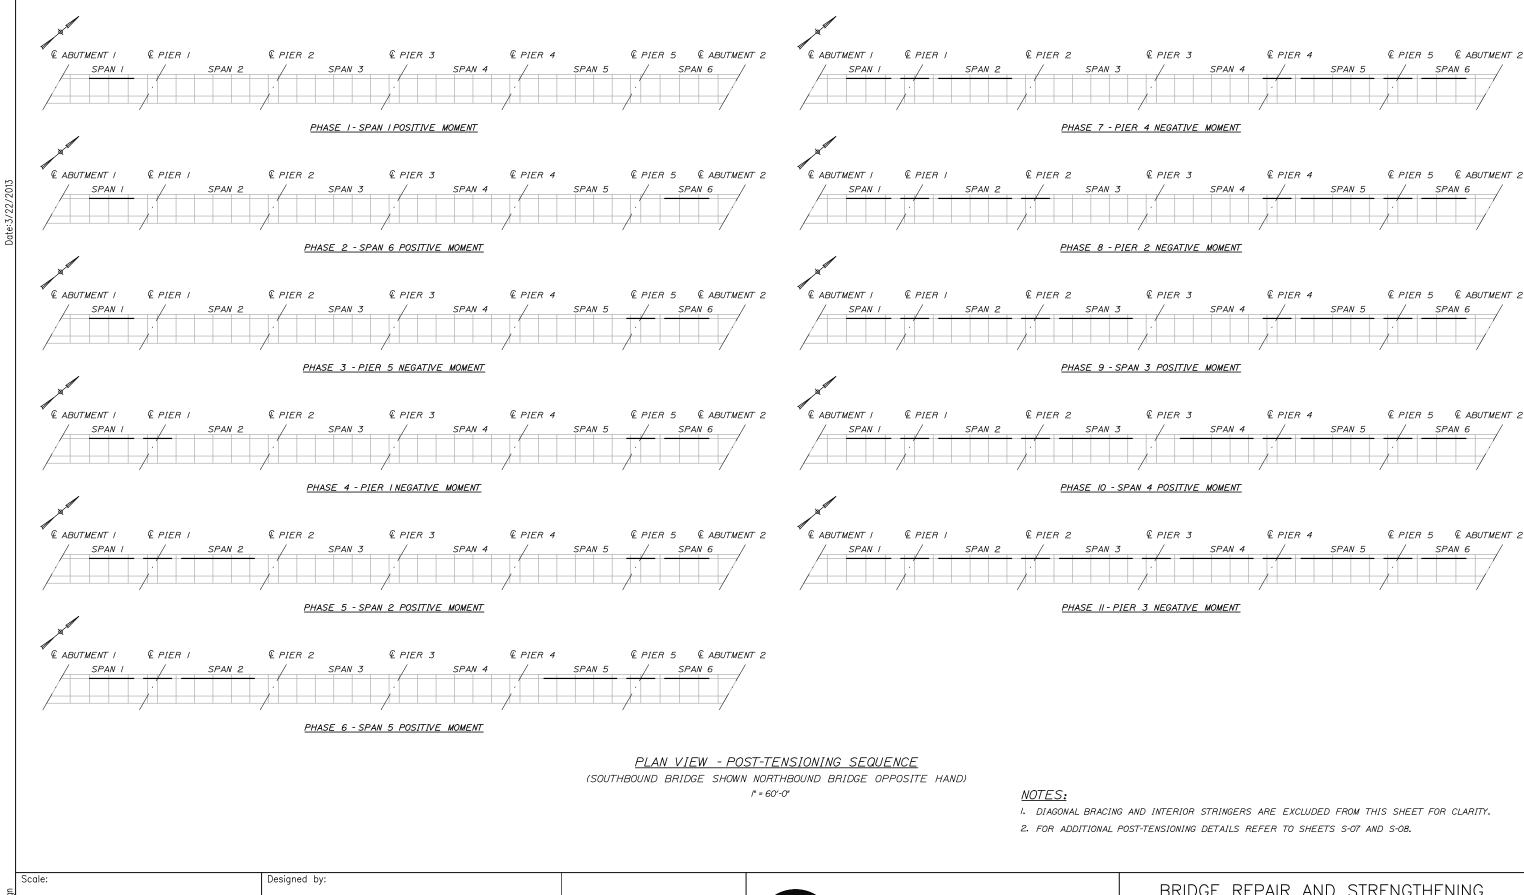


BRIDGE REPAIR AND STRENGTHENING ANDROSCOGGIN RIVER OVERPASS

POST-TENSIONING LAYOUT

SHEET NUMBER: S-05

MTA PROJECT MANAGER: Kristi Van Ooyen, P.E.



By Date Revision CONSULTANT PROJECT MANAGER: Craig R. Morin, P.E. Ву AJF 03/13 MPC 03/13 Checked CRM
In Charge of RAL 03/13 Designed

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BRIDGE REPAIR AND STRENGTHENING ANDROSCOGGIN RIVER OVERPASS


CONTRACT: 2013.10


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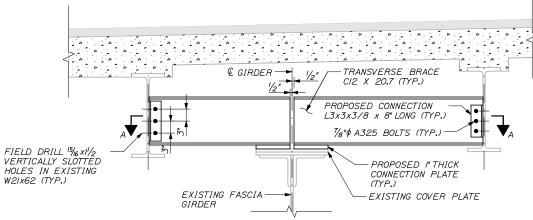
SHEET NUMBER: S-06

MTA PROJECT MANAGER: Kristi Van Ooyen, P.E.


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TRANSVERSE BRACING DETAIL

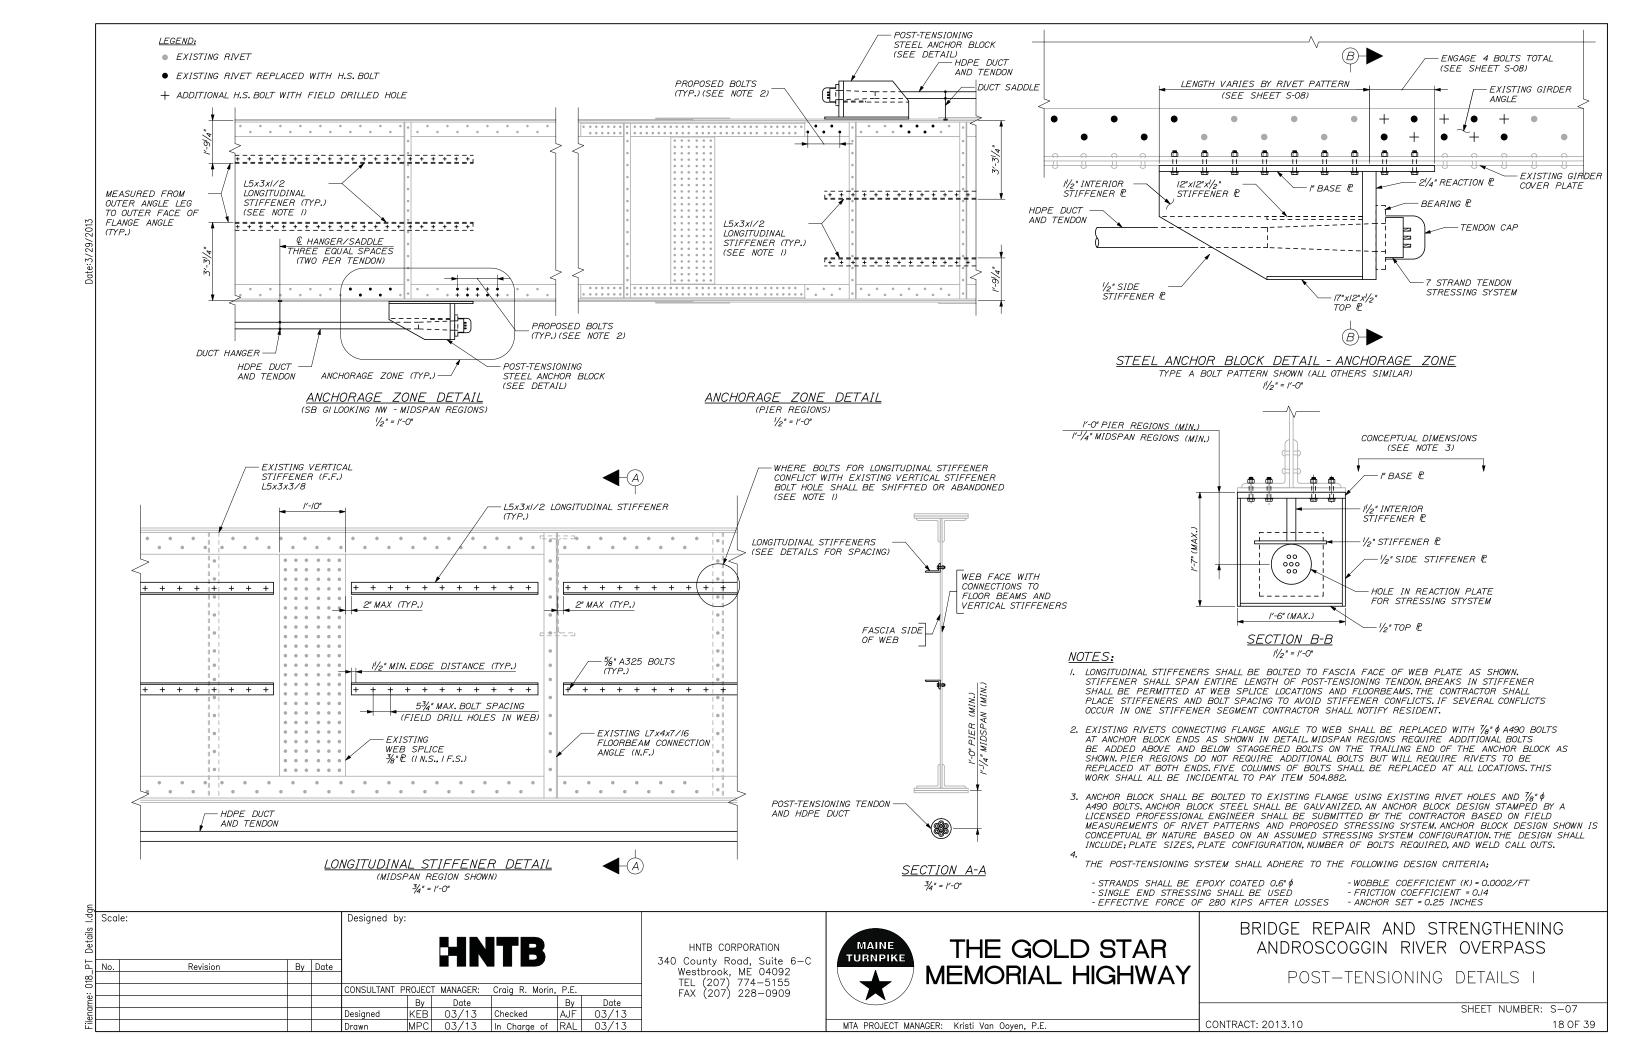

SECTION A-A

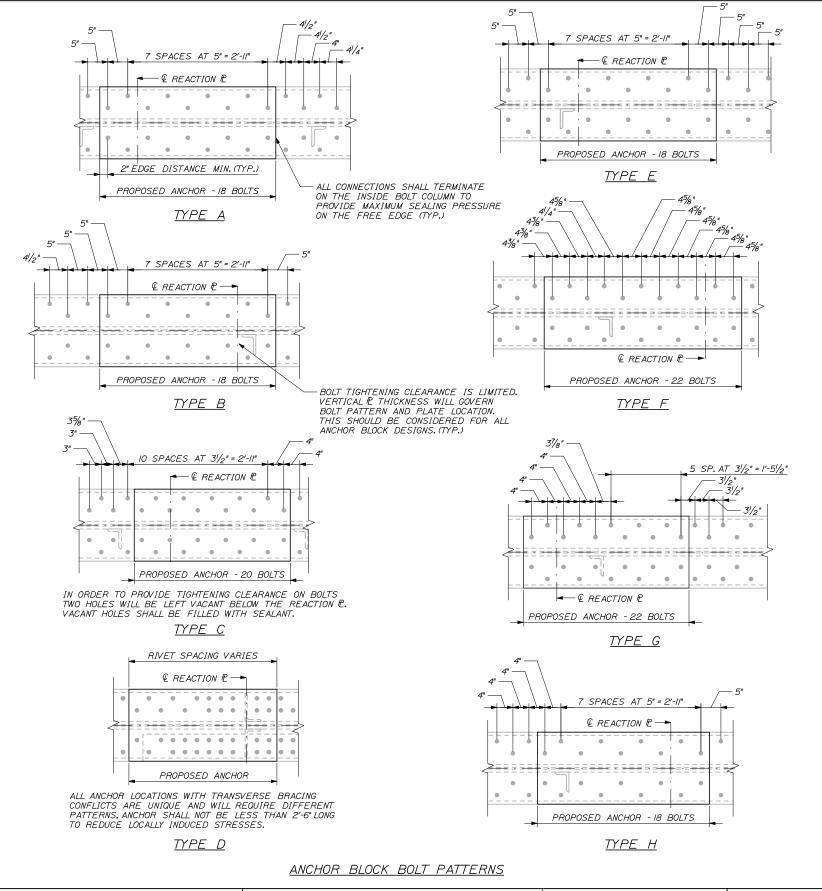ANCHOR BLOCK INSTALLATION PROCEDURE

- I. CONTRACTOR TO FIELD VERIFY EXISTING RIVET SPACING AT ANCHOR BLOCK LOCATIONS PRIOR TO SUBMITTING SHOP DRAWINGS OF ANCHOR BLOCK DESIGN. CONTRACTOR SHALL NOTIFY ENGINEER OF ANY SEVERE FLANGE DISTORTION AT ANCHOR BLOCK LOCATIONS.
- 2. ONCE ANCHOR BLOCK DESIGN IS APPROVED CONTRACTOR SHALL REMOVE HEADS AND SHANKS OF RIVETS THAT ARE TO BE REPLACED BY BOLTS. SEE SPECIAL PROVISION 504 FOR APPROVED REMOVAL METHODS.
- 3. DURING RIVET REMOVAL A MAXIMUM OF FOUR VACANT HOLES SHALL BE ALLOWED AT ONE TIME. BOLTS SHALL BE PLACED IN VACANT HOLES AND HAND TIGHTENED TEMPORARILY DURING THE RIVET REMOVAL PROCESS.
- 4. PREPARE THE FLANGE SURFACE FOR ANCHOR BLOCK INSTALLATION BY REMOVING ALL LOOSE RUST AND DIRT PER SPECIFICATION 506.
- 5. REMOVE HAND TIGHTENED NUTS AND POSITION ANCHOR BLOCK IN FINAL SEATED LOCATION. BOLTS SHALL REMAIN IN HOLES DURING ANCHOR POSITIONING AND INSTALLATION.
- 6. PREPARE AND PAINT NEW STEELWORK AND AREAS OF EXISTING STEELWORK TO THE LIMITS SPECIFIED. SEE SHEET S-10 FOR DETAILS. NEW STEEL WORK INCLUDES ANCHOR BLOCKS, LONGITUDINAL STIFFENERS, AND TRANSVERSE BRACING.
- 7. SEE SPECIAL PROVISION 504 AND 506 FOR ADDITIONAL INFORMATION.
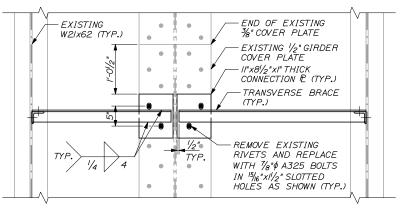
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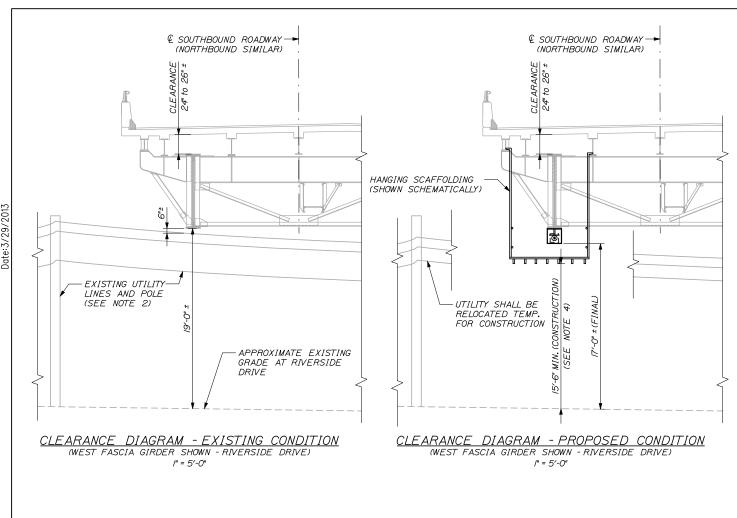



BRIDGE REPAIR AND STRENGTHENING ANDROSCOGGIN RIVER OVERPASS


POST-TENSIONING DETAILS II


SHEET NUMBER: S-08

MTA PROJECT MANAGER: Kristi Van Ooyen, P.E.



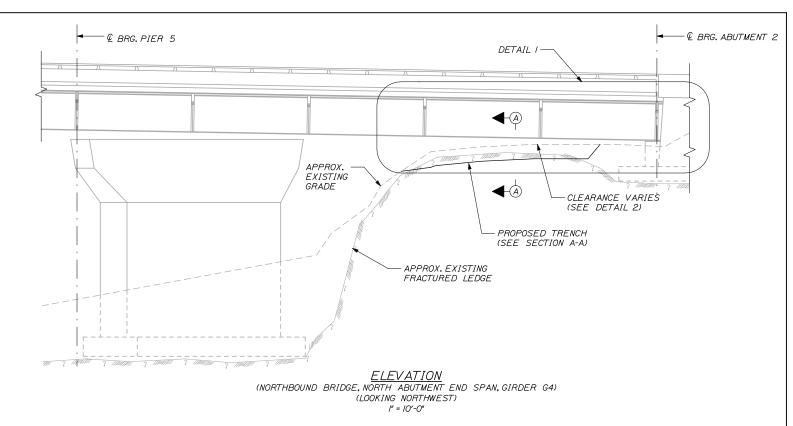

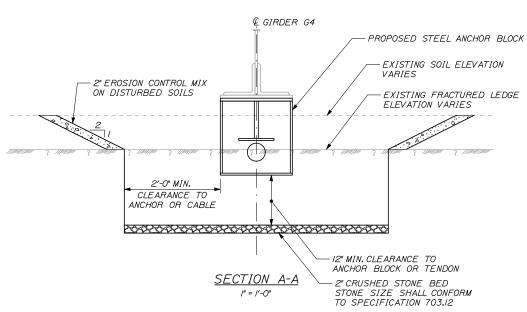

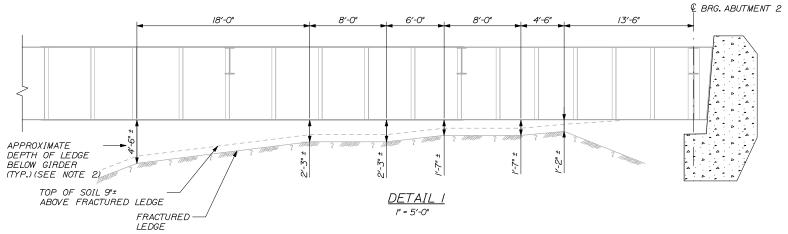

NOTES;

- 1. ALL ROCK AND COMMON EXCAVATION, CRUSHED STONE, AND EROSION CONTROL MIX SHALL BE PAID UNDER PAY ITEM 203.22 CLEARANCE EXCAVATION.
- 2. DURING CONSTRUCTION UTILITIES SHALL BE RELOCATED TEMPORARILY TO PROVIDE CLEARANCE FOR SCAFFOLDING AND POST-TENSIONING SYSTEM. FOR ADDITIONAL INFORMATION ON UTILITY COORDINATION SEE SPECIAL PROVISION 104.4.6.
- 3. FRACTURED LEDGE OUTCROP SHALL BE REMOVED TO FACILITATE CONSTRUCTION, PAINTING, AND POST-TENSIONING. CLEARANCE MAY BE LIMITED AT NORTHBOUND BRIDGE NEAR NORTH ABUTMENT. FOR ESTIMATING PURPOSES, A VOLUME OF 6 CY OF ROCK AND 5 CY COMMON EXCAVATION IS ASSUMED TO BE REMOVED FOR INSTALLATION OF ANCHOR BLOCK AND TENDON. A TRENCH SHALL BE INSTALLED WHERE EXCAVATION OCCURS, EXCAVATED TRENCH MUST SLOPE TO DRAIN.
- 4. DURING CONSTRUCTION SCAFFOLDING SHALL PROVIDE A MINIMUM OF 15-6 CLEARANCE AT RIVERSIDE DRIVE.

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BRIDGE REPAIR AND STRENGTHENING ANDROSCOGGIN RIVER OVERPASS


EXISTING STRUCTURE DETAILS


SHEET NUMBER: S-09

MTA PROJECT MANAGER: Kristi Van Ooyen, P.E.

CONTRACT: 2013.10

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RIVET REPLACEMENT CRITERIA

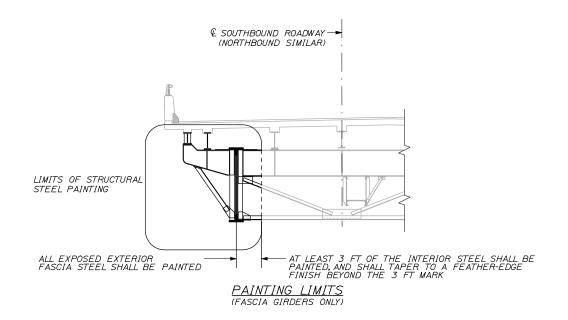N.T.S

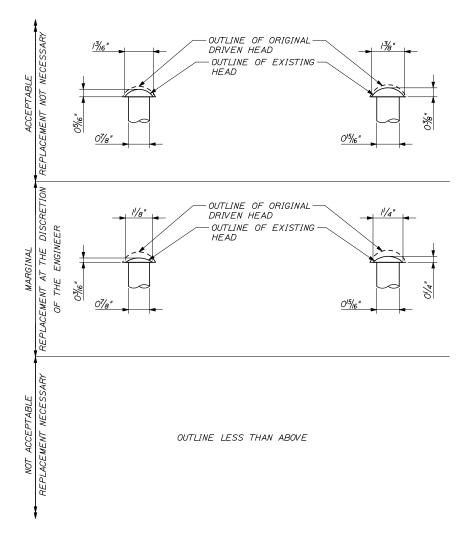NOTES:

- I. ALL STRUCTURAL STEEL LOCATED IN THE PAINTING LIMIT EWELOPED AREA SHALL BE PAINTED. THIS SHALL INCLUDE ALL TRANSVERSE BRACING STEEL AS WELL.
- 2. THE CONTRACTOR SHALL PERFORM SURFACE PREPARATION, CONTAINMENT, DISPOSAL AND PAINTING WORK IN CONFORMANCE WITH SPECIAL PROVISION 506, "LEAD ABATEMENT AND COATING APPLICATION". PAYMENT SHALL BE MADE UNDER THE APPLICABLE PAY ITEMS IN SPECIAL PROVISION 506.
- 3. THE RESIDENT SHALL INSPECT THE CONDITION OF ALL FASCIA GIRDER RIVETS FOR UNACCEPTABLE DETERIORATION. RIVET REMOVAL AND REPLACEMENT SHALL BE IN ACCORDANCE WITH THE "RIVET REPLACEMENT CRITERIA" DETAIL RIVETS REMOVED DUE TO UNACCEPTABLE DETERIORATION SHALL BE REPLACED WITH HOT DIP GALVANIZED HIGH STRENGTH BOLTS AND SHALL BE MEASURED FOR PAYMENT UNDER PAY ITEM 504.81.

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N	lo.	Revision	By	Date			`			
ı					CONSULTANT F	ROJECT	MANAGER:	Craig R. Morin,	, P.E.	
						Ву	Date		Ву	Date
					Designed	KEB	03/13	Checked	AJF	03/13
					Drawn	MPC	03/13	In Charge of	RAL	03/13

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BRIDGE REPAIR AND STRENGTHENING ANDROSCOGGIN RIVER OVERPASS

CONTRACT: 2013.10

PAINTING DETAILS

SHEET NUMBER: S-10

MTA PROJECT MANAGER: Kristi Van Ooyen, P.E.

210F 39

