2019.04

STANTEC

Michael F. Haux MICHAEL F. HAYS, R.A. - PRINCIPAL

GORRILL PALMER

SHEETS 172-205

DIRECTOR OF OPERATION HNTB

MAINLINE INT 86 FALMOUTH ATLANTIC **OCEAN** SCARBOROUGH BIDDEFORD KENNEBUNK GUNQUIT SANFORD BERWICK YORK BEACH KITTERY PORTSMOUTH

LOCATION MAP

APPROVED:

MAINE TURNPIKE AUTHORITY

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SHEETS 230-231 SHEETS 359-410

DAVID M. GLENNON No. 15976

INTERCHANGE 103

BARRIER TOLL PLAZA

MM 103.0

PEN ROAD TOLLING CONVERSION

Dail M. Glemn 3-20-2019

GREGORY EDWARDS P.E. - SENIOR PRINCIPAL STANTEC

DAVID GLENNON, P.E. - SENIOR ELECTRICAL ENGINEER DATE

3-20-2019

DATE

SHEETS 415-416 SHEETS 473-492

SHEETS 463-472

GRANT HAY/

A//OCIATE/

THE GOLD STAR **MEMORIAL HIGHWAY**

ALAIN HADDAD, P.E. - SR. MECHANICAL ENGINEER

THOMAS DENSFORD, P.E. - ASSOCIATE

DATE

3-20-2019

DATE

3-20-2019

3-20-2019

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BRANDON HAVU, P.E. - PROJECT MANAGER

3-20-2019 DATE

2019.04

CONTRAC

STEPHÉN R. TARTRE, P.E. - DIRECTOR OF ENGINEERING AND BUILDING MAINTENANCE

WILLIAM YATES III - DIRECTOR OF INFORMATION

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	ESTIMATED QUANTITIES		
ITEM NO.	DESCRIPTION	TOTAL QUANTITY	UNIT
201.11	CLEARING	4.0	AC
201.23 201.24	REMOVING SINGLE TREE TOP ONLY REMOVING STUMP	4	EA EA
202.071	REMOVING STOME REMOVING ASBESTOS CONTAINING MATERIALS, TOLL BOOTH LAB TOPS	/	LS
202.081	REMOVING EXISTING BUILDING	,	LS
202.15	REMOVING EXISTING MANHOLE OR CATCH BASIN	6	EΑ
202,17	REMOVING EXISTING STRUCTURAL CONCRETE	/	LS
202,202	REMOVING PAVEMENT SURFACE	27,850	SY
202,203	PAVEMENT BUTT JOINTS	1,910	SY
202.205 202.206	RUMBLE STRIPS REMOVING RUMBLE STRIPS	29,850 8,650	EA LF
203.20	COMMON EXCAVATION	88,000	CY
203.21	ROCK EXCAVATION	200	CY
203.2310	UNDERGROUND STORAGE TANK REMOVAL	1	LS
203.2312	DISPOSAL / TREATMENT OF SPECIAL EXCAVATION	50	TON
203.25	GRANULAR BORROW	28,325	CY
206.082	STRUCTURAL EARTH EXCAVATION - MAJOR STRUCTURES	2,350	CY
304.09 304.10	AGGREGATE BASE COURSE - CRUSHED AGGREGATE SUBBASE COURSE - GRAVEL	11 , 285 18 , 135	CY
403.207	HOT MIX ASPHALT, 19.0 MM NOMINAL MAXIMUM SIZE	16,150	TON
403.208	HOT MIX ASPHALT, 12.5 MM	900	TON
403.2081	HOT MIX ASPHALT, 12.5 MM (POLYMER MODIFIED) - RAP	9,110	TON
403.209	HOT MIX ASPHALT, 9.5 MM NOMINAL MAXIMUM SIZE (SIDEWALKS, DRIVES, ISLANDS & INCIDENTALS)	100	TON
403.211	HOT MIX ASPHALT, 9.5 MM NOMINAL MAXIMUM SIZE (SHIMMING)	1 , 658	TON
403.213	HOT MIX ASPHALT, 12.5 MM NOMINAL MAXIMUM SIZE (BASE AND INTERMEDIATE BASE COURSE)	7,570	TON
409.152 419.30	BITUMINOUS TACK COAT NTSS-IHM TRACKLESS - APPLIED	15,700	GAL
470.08	SAWING BITUMINOUS PAVEMENT BERM DROPOFF CORRECTION - GRINDINGS	5,760 248	LF TON
470.081	BERM CORRECTION GRINDINGS	4,500	LF
502.231	STRUCTURAL CONCRETE, SPACE FRAME PEDESTALS & FOOTINGS	96	CY
502.232	STRUCTURAL CONCRETE, UTILITY PITS	145	CY
502.261	STRUCTURAL CONCRETE, ORT SLABS	210	CY
502.262	STRUCTURAL CONCRETE, CASH SLABS	280	CY
502.263	STRUCTURAL CONCRETE, PLAZA ISLANDS, BUMPERS, AND CURTAIN WALLS	200	CY
503.14	EPOXY-COATED REINFORCING STEEL, FABRICATED & DELIVERED	43,700	LB
503./5 503./8/	EPOXY-COATED REINFORCING STEEL, PLACING GLASS FIBER REINFORCED POLYMER (GFRP) REINFORCING BARS (*5), FAB & DELIVERED	43,700 83,500	LB LF
503.182	GLASS FIBER REINFORCED POLYMER (GFRP) REINFORCING BARS (*12), FAB & DELIVERED	180	LF LF
503.191	GLASS FIBER REINFORCED POLYMER (GFRP) REINFORCING BARS (*5), PLACING	83,500	LF
503./92	GLASS FIBER REINFORCED POLYMER (GFRP) REINFORCING BARS (*12), PLACING	180	LF
503.90	SYNTHETIC FIBER REINFORCEMENT	2,450	LB
504.50	TOLL PLAZA CANOPIES	/	LS
504.80	SPACE FRAME CANOPIES, FABRICATED AND DELIVERED	/	LS
504.81	SPACE FRAME CANOPIES, ERECTION	/	LS
504.90 504.91	STEEL POST SUPPORT SYSTEMS MOUNTING BRACKET ASSEMBLIES	1	LS LS
504.96	METAL STAIRS	,	LS
508.14	HIGH PERFORMANCE WATERPROOFING MEMBRANE	,	LS
511.091	TEMPORARY EARTH SUPPORT SYSTEMS	1	LS
515.2011	PIGMENTED CONCRETE PROTECTIVE COATING - TUNNEL AND STAIRWAY WALLS & CEILING	750	SY
5/5,20/2	PIGMENTED CONCRETE PROTECTIVE COATING - TUNNEL FLOOR	270	SY
515.202	CLEAR PROTECTIVE COATING FOR CONCRETE SURFACES	2,500	SY
5/5 . 23 526 . 306	EPOXY OVERLAY TEMPORARY CONCRETE BARRIER TYPE I (9,100 LF)	225	SF LS
526.35 <i>l</i>	MEDIAN BARRIER TYPE I (9,100 LF)	450	LS LF
526.35//	MEDIAN BARRIER TYPE IA - PRECAST	2,806	LF
526.35/3	MEDIAN BARRIER TYPE IB - PRECAST	938	LF
526.3514	MEDIAN BARRIER TYPE IC - PRECAST	170	LF
526.35/5	MEDIAN BARRIER TYPE ID - PRECAST	107	LF
526.35/6	MEDIAN BARRIER TYPE IE - PRECAST	5/	LF
526.352 526.36//	MEDIAN BARRIER TYPE II	134 3	LF EA
	MEDIAN BARRIER TRANSITION TYPE IA - PRECAST		
526.3612	MEDIAN BARRIER TRANSITION TYPE IA - PRECAST MEDIAN BARRIER TRANSITION TYPE IB - PRECAST		
526.36 <i>l</i> 2 526.362	MEDIAN BARRIER TRANSITION TYPE IB - PRECAST	1 4	EA EA
		1	
526.362 526.371 527.306	MEDIAN BARRIER TRANSITION TYPE IB - PRECAST MEDIAN BARRIER TRANSITION TYPE II - PRECAST MEDIAN BARRIER WITH MOUNTED LIGHT POLE TYPE I CENTER BARRIER CRASH ATTENUATOR	/ 4 /7 3	EA EA
526.362 526.371 527.306 527.342	MEDIAN BARRIER TRANSITION TYPE IB - PRECAST MEDIAN BARRIER TRANSITION TYPE II - PRECAST MEDIAN BARRIER WITH MOUNTED LIGHT POLE TYPE I CENTER BARRIER CRASH ATTENUATOR WORK ZONE CRASH CUSHIONS - TL-2	/ 4 /7 3 5	EA EA EA UNIT
526.362 526.371 527.306 527.342 527.343	MEDIAN BARRIER TRANSITION TYPE IB - PRECAST MEDIAN BARRIER TRANSITION TYPE II - PRECAST MEDIAN BARRIER WITH MOUNTED LIGHT POLE TYPE I CENTER BARRIER CRASH ATTENUATOR WORK ZONE CRASH CUSHIONS - TL-2 WORK ZONE CRASH CUSHIONS - TL-3	1 4 17 3 5	EA EA EA UNIT UNIT
526.362 526.371 527.306 527.342 527.343 535.70	MEDIAN BARRIER TRANSITION TYPE IB - PRECAST MEDIAN BARRIER TRANSITION TYPE II - PRECAST MEDIAN BARRIER WITH MOUNTED LIGHT POLE TYPE I CENTER BARRIER CRASH ATTENUATOR WORK ZONE CRASH CUSHIONS - TL-2 WORK ZONE CRASH CUSHIONS - TL-3 PRECAST CONCRETE TUNNEL	/ 4 /7 3 5 7	EA EA EA UNIT UNIT LS
526.362 526.371 527.306 527.342 527.343 535.70 602.30	MEDIAN BARRIER TRANSITION TYPE IB - PRECAST MEDIAN BARRIER TRANSITION TYPE II - PRECAST MEDIAN BARRIER WITH MOUNTED LIGHT POLE TYPE I CENTER BARRIER CRASH ATTENUATOR WORK ZONE CRASH CUSHIONS - TL-2 WORK ZONE CRASH CUSHIONS - TL-3 PRECAST CONCRETE TUNNEL FLOWABLE CONCRETE FILL	/ 4 // // 3 // 5 // // // // 8	EA EA UNIT UNIT LS CY
526.362 526.371 527.306 527.342 527.343 535.70 602.30 603.155	MEDIAN BARRIER TRANSITION TYPE IB - PRECAST MEDIAN BARRIER TRANSITION TYPE II - PRECAST MEDIAN BARRIER WITH MOUNTED LIGHT POLE TYPE I CENTER BARRIER CRASH ATTENUATOR WORK ZONE CRASH CUSHIONS - TL-2 WORK ZONE CRASH CUSHIONS - TL-3 PRECAST CONCRETE TUNNEL FLOWABLE CONCRETE FILL 12 INCH REINFORCED CONCRETE PIPE - CLASS III	/ 4 // // 3 // 5 // // // 8 // 99	EA EA UNIT UNIT LS CY LF
526.362 526.371 527.306 527.342 527.343 535.70 602.30	MEDIAN BARRIER TRANSITION TYPE IB - PRECAST MEDIAN BARRIER TRANSITION TYPE II - PRECAST MEDIAN BARRIER WITH MOUNTED LIGHT POLE TYPE I CENTER BARRIER CRASH ATTENUATOR WORK ZONE CRASH CUSHIONS - TL-2 WORK ZONE CRASH CUSHIONS - TL-3 PRECAST CONCRETE TUNNEL FLOWABLE CONCRETE FILL	/ 4 // // 3 // 5 // // // // 8	EA EA UNIT UNIT LS CY

	CATCH BASIN TYPE BI	5,125	EA
604.097	60° CATCH BASIN TYPE B5-C	1.125	EA
604.15	MANHOLE	2,125	EΑ
604.18	ADJUSTING MANHOLE OR CATCH BASIN TO GRADE	5	EA
604.245	CATCH BASIN TYPE F4-C	1	EA
604.26	CATCH BASIN TYPE B5	40	EA
605.09	6 INCH UNDERDRAIN TYPE B	1,729	LF
605.//	12 INCH UNDERDRAIN TYPE C	236	LF
605.///	12 INCH UNDERDRAIN TYPE C - SDR	600	LF
605.12	15 INCH UNDERDRAIN TYPE C	236	LF
605./3	18 INCH UNDERDRAIN TYPE C	140	LF
606.13	3"W-BEAM GUARDRAIL-MIDWAY SPLICE (7'STEEL POSTS, 8" OFFSET BLOCKS, SINGLE FACED)	2,940.625	LF
606./306	3/"W-BEAM GUARDRAIL-MIDWAY SPLICE TANGENT TERMINAL	7	E/
606.131	3/"W-BEAM GUARDRAIL-MIDWAY SPLICE (8'STEEL POSTS, 8" OFFSET BLOCKS, SINGLE FACED)	662.5	LF
606./32	3"W-BEAM GUARDRAIL-MIDWAY SPLICE (7' STEEL POSTS, 8" OFFSET BLOCKS, DOUBLE FACED)	1,612.5	LF
606.1351	3/" W-BEAM GUARDRAIL - MIDWAY SPLICE TERMINAL END - ANCHORED END	12	E/
606.1724	BRIDGE TRANSITION - TYPE III, MODIFIED	2	EA
606.2651	TERMINAL END - REMOVE AND RESET	7	EA
606.2652	TERMINAL END - REMOVE AND STACK	9	EA
606.275		2	EA
	TERMINAL END - DOUBLE RAIL - GALVANIZED STEEL		_
606.352	REFLECTORIZED BEAM GUARDRAIL DELINEATOR	/30	EA
606.353	DELINEATOR POST	94	EA
606.3561	DELINEATOR POST - REMOVE AND RESET	102	EA
606.3605	GUARDRAIL - REMOVE, MODIFY, AND RESET SINGLE RAIL	950	LF
606.3621	GUARDRAIL ADJUST, SINGLE RAIL	3,400	LF
606.82	GUARDRAIL - REMOVE AND STACK EXISTING CRASH END	1	EA
607.2326	AUTOMATIC ENTRY GATE	1	E/
607 .4 0	CHAIN LINK FENCE - 3' HIGH	510	LF
607.41	POST ASSEMBLY FOR SIGN OR CHAIN LINK FENCE	66	EA
607 . 4211	DUMPSTER ENCLOSURE	1	LS
608.08	REINFORCED CONCRETE SIDEWALK	110	SY
608.26	CURB RAMP DETECTABLE WARNING FIELD	36	SF
609.//	VERTICAL CURB TYPE I	1,000	LF
609.12	VERTICAL CURB TYPE I - CIRCULAR	200	LF
609.234	TERMINAL CURB TYPE I - 4 FT	4	E/
609.238	TERMINAL CURB TYPE I-8 FT	2	EA
610.08	PLAIN RIPRAP	34	CY
610.18	STONE DITCH PROTECTION	27	CY
610.181	TEMPORARY STONE CHECK DAM	325	CY
613.319	EROSION CONTROL BLANKET	13.750	SY
614.30	GEOCELL CONFINEMENT SYSTEM FOR SLOPE PROTECTION	16,000	SF
615.07	LOAM	7,690	CY
618.13	SEEDING METHOD NUMBER I	45	UNI
618.14	SEEDING METHOD NUMBER 2	584	UNI
		629	_
619,1201	MULCH - PLAN QUANTITY		UNI
619.1202	TEMPORARY MULCH	/	LS
619.1401	EROSION CONTROL MIX	50	CY
620.58	EROSION CONTROL GEOTEXTILE	910	SY
621.043	EVERGREEN TREE (6' - 8') GROUP A	2	EA
621.396	DWARF EVERGREEN (18" - 24") GROUP B	8	EA
621,512	HYBRID RHODODENDRON (2' - 2.5')	3	EA
621 . 553	DECIDUOUS SHRUB (3' - 4') GROUP B	4	E/
625,106	WATER SERVICE SUPPLY LINE (<3 IN)	2,400	LF
626.121	QUAZITE JUNCTION BOX (36X24)	//	EA
626,122	QUAZITE JUNCTION BOX (IBXII)	75	EA
626.13	4' X 6' SPLICE BOX WITH ACCESS DOOR	5	EA
626 . 21	METALLIC CONDUIT	310	LF
526,22	NON-METALLIC CONDUIT	35,500	LF
626.223	HORIZONTAL DIRECTIONAL DRILLED CONDUIT	530	LF
626.31	18 INCH DIAMETER FOUNDATION	33	EA
626 . 32	24 INCH DIAMETER FOUNDATION	94	E
626.333	30 INCH DIAMETER FOUNDATION, 8 FEET OR LESS	8	EA
526 . 36	REMOVE OR MODIFY CONCRETE FOUNDATION	66	EA
520.30 527.18	12 INCH SOLID WHITE PAVEMENT MARKING LINE	9,100	LF
527.681	TEMPORARY 6 INCH PAINTED PAVEMENT MARKING LINE -YELLOW OR WHITE	97,400	LF
527 . 73	TEMPORARY 6 INCH PAVEMENT MARKING LINE - TELLOW OR WHITE	7,050	LF
			_
627 . 731	TEMPORARY 6 INCH BLACK PAVEMENT MARKING TAPE	7,050	LF
	4" WHITE OR YELLOW PAINTED PAVEMENT MARKING LINE	1,520	LF
627.733	CONTROL OF VELLOW PAINTED PAVENENT MARKING LINE	51,900	LF
627.733 627.744	6"WHITE OR YELLOW PAINTED PAVEMENT MARKING LINE		
627.733 627.744 627.75 627.77	WHITE OR TELLOW PAINTED FAVEMENT MARKING LINE WHITE OR YELLOW PAVEMENT & CURB MARKING REMOVING EXISTING PAVEMENT MARKING	1,220 37,650	SF SF

CONTRACT:2019.04

ESTIMATED QUANTITIES

DESCRIPTION

Scale: **Stantec** Revision By Date CONSULTANT PROJECT MANAGER: LAUREN MEEK, PE
 By
 Date
 By
 Date

 PLP 3\20\19
 Checked
 LEM 3\20\19

 EJB 3\20\19
 In Charge of GAE 3\20\19
 Designed

STANTEC CONSULTING SERVICES INC 482 PAYNE ROAD SCARBOROUGH, ME 04074 TEL (207) 887-3448 FAX (207) 883-3376



THE GOLD STAR MEMORIAL HIGHWAY

ORI CONVERSION ESTIMATED QUANTITIES 1

SHEET NUMBER: QN-01

TOTAL

QUANTITY

2 EA 2.125 EA 5.125 EA

UNIT

MTA PROJECT MANAGER: RALPH NORWOOD, IV, PE, PTOE

ITEM NO.

603.205 30 INCH REINFORCED CONCRETE PIPE - CLASS III

604.072 CATCH BASIN TYPE AI-C 604.09 CATCH BASIN TYPE BI

603.280 CONCRETE COLLAR FOR REINFORCED CONCRETE PIPE

	ESTIMATED QUANTITIES		
ITEM NO.	DESCRIPTION	TOTAL QUANTITY	UNIT
627.812	TEMPORARY RAISED PAVEMENT MARKERS	2,000	EA
627.94 627.941	PERMANENT PAVEMENT MARKING TAPE PAVEMENT MARKING TAPE - DOTTED WHITE LANE LINE, 6-INCH WIDE	335 820	LF LF
627.944	PAVEMENT MARKING TALE BOTTED WITTE EARL LINE, O THEIR WIDE PAVEMENT MARKING - RECESSED TAPE - WORDS, ARROWS AND STOP BARS	170	SF
629.05	HAND LABOR, STRAIGHT TIME	70	HR
631.10	AIR COMPRESSOR (INCLUDING OPERATOR)	70	HR
631.11	AIR TOOL (INCLUDING OPERATOR)	70	HR
631.12	ALL PURPOSE EXCAVATOR (INCLUDING OPERATOR)	70	HR
631.14 631.171	GRADER (INCLUDING OPERATOR) TRUCK - SMALL (INCLUDING OPERATOR)	70 70	HR HR
631.18	CHAIN SAW RENTAL (INCLUDING OPERATOR)	30	HR
631.21	ROAD BROOM (INCLUDING OPERATORS AND HAULER)	10	HR
631.22	FRONT END LOADER (INCLUDING OPERATOR)	70	HR
631.32	CULVERT CLEANER (INCLUDING OPERATOR)	20	HR
631.36	FOREMAN	70	HR
631.50	JACKHAMMER (AIR TOOL INCLUDING OPERATOR)	60	HR
631.51 631.52	BUCKET TRUCK SCISSOR LIFT	60 60	HR HR
631.53	ELECTRICIAN	100	HR
631.54	ELECTRICIAN'S APPRENTICE	100	HR
631.55	PLUMBER	60	HR
632.01	OVER HEIGHT VEHICLE DETECTION SYSTEM: EXIT 103 AREA	1	LS
633.01	PROPANE SERVICE TRENCH	66	LF
633.21	PROPANE TANK SUPPORTS	2	EA
633.31	PROPANE TANK PAD	27	SY
634.051	REMOVE AND STACK LIGHT STANDARD REMOVE HIGH MAST LIGHT STANDARD	9 2	EA
634.052 634.208	REMOVE AND RESET LIGHT STANDARD	1	EA
634.231	CONVENTIONAL LIGHT STANDARD WITH LED FIXTURE	81	EA
639.18	FIELD OFFICE, TYPE A	1	EA
643.711	LANE USE SIGNAL INSTALLATION	6	EA
643.712	FLASHING BEACON - SOLAR POWERED	2	EΑ
645.105	REMOVE AND STACK SIGN	1//	EA
645,107	REMOVE AND STACK CANOPY MOUNTED SIGN	10	EA
645.109 645.1092	REMOVE AND RESET SIGN CANOPY MOUNTED DYNAMIC MESSAGE SIGN	7 4	EA EA
645,121	OVERHEAD GUIDE SIGN NB 2 (STA.7450.00)	1	LS
645,122	OVERHEAD GUIDE SIGN NB 3 (STA, 7463+00)	1	LS
645.123	OVERHEAD GUIDE SIGN NB 5 (STA. 7477+25)	1	LS
645.124	OVERHEAD GUIDE SIGN SB I (STA 4491.00)	1	LS
645,125	OVERHEAD GUIDE SIGN SB 2 (STA 4508+75)	1	LS
645.126	OVERHEAD GUIDE SIGN SB 3 (STA. 27+00)		LS
645,127	OVERHEAD GUIDE SIGN SB 4 (STA. 43.00)	/	LS
645.14 645.151	CANOPY MOUNTED SIGN CANTILEVER GUIDE SIGN NB I (STA. 7427-25)	4	LS
645,152	CANTILEVER GUIDE SIGN NB 4 (STA. 7471-75)		LS
645./55	VARIABLE SPEED LIMIT SIGN	2	EA
645,161	BREAKAWAY DEVICE SINGLE POLE	51	EA
645.162	BREAKAWAY DEVICE MULTI POLE	24	EA
645.251	ROADSIDE GUIDE SIGNS, TYPE I	1,065	SF
645,271	REGULATORY, WARNING, CONFIRMATION AND ROUTE ASSEMBLY SIGN, TYPE I	1,440	SF
645 . 289	STEEL H-BEAM POLES REMOVE AND RESET MAINLINE SIGN STA. 7401-23 (2 SIGNS)	24,020	LB LS
645.502	REMOVE AND RESET MAINLINE SIGN STA. 7440.50 (ISIGN)	1	LS
645.503	REMOVE AND RESET MAINLINE SIGN STA. 7467+00 (I SIGN)	1	LS
645.504	REMOVE AND RESET MAINLINE SIGN STA. 7470-29 (I SIGN)	1	LS
645.505	REMOVE AND RESET MAINLINE SIGN STA. 3488+27 (I SIGN)	1	LS
645.506	REMOVE AND RESET MAINLINE SIGN STA. 4474.00 (I SIGN)	1	LS
645.507	REMOVE AND RESET MAINLINE SIGN STA. 789.50 (I SIGN)	1	LS
645 . 508	REMOVE AND RESET MAINLINE SIGN STA. 8492.00 (I SIGN) REMOVE AND RESET MAINLINE SIGN STA. 7515.00 (I SIGN)	1	LS LS
645,601	REMOVE AND STACK OVERHEAD SIGN STALTSISTOU (1516N)	/	LS
645.602	REMOVE AND STACK OVERHEAD SIGN STRUCTURE (NB ORT)	1	LS
648.00	INSTALL FLAGPOLE	1	EA
652.30	FLASHING ARROW	1	EA
652.312	TYPE III BARRICADES	21	EΑ
652.33	DRUM	200	EA
652.34	CONCEDUCTION CLONG	50	EA
652.35 652.36 <i>l</i>	CONSTRUCTION SIGNS MAINTENANCE OF TRAFFIC CONTROL DEVICES	4,100	SF LS
002.001	FLAGGERS	100	HR
652.38		1 100	. ///
652.38 652.41		4	EΑ
	PORTABLE-CHANGEABLE MESSAGE SIGN TRUCK MOUNTED ATTENUATOR	4 540	EA CD

652.46		QUANTITY	1
	TEMPORARY PORTABLE RUMBLE STRIP	50	UNIT
655 . 0/	INSTALLATION OF ORT LANE CONTROLLER CABINET	2	EA
55.012	INSTALLATION OF CASH LANE CONTROLLER CABINET	6	EA
55.02	DVAS MOUNT INSTALLATION	10	EA
55 . 03	VCARS MOUNT INSTALLATION	16	EA
55 . 04	INSTALLATION OF SENSOR LOOPS	//	LS
			_
55.05	INSTALLATION OF AVI ANTENNAS	20	EA
55.06	INSTALLATION OF AVI READERS	4	EA
55.07	TRAFFIC CONTROL PEDESTAL PREPARATION WORK	6	EA
55.08	OPUS MOUNT INSTALLATION	18	ΕA
55 . 09	ARMORED CABLE - 10/3	300	LF
555.1004	#4/O AWG WIRE	2,000	LF
555.100	#2/O AWG WIRE	2,900	LF
55,1001	*I/O AWG WIRE	1,600	LF
555.101	#I AWG WIRE	1,600	LF
55.102	#2 AWG WIRE	1,000	LF
555.104	#4 AWG WIRE	1,400	LF
55 . 106	#6 AWG WIRE	1,200	LF
55 . 108	#8 AWG WIRE	600	LF
	#/O AWG WIRE		LF
555.//		2,400	_
555.12	#/2 AWG WIRE	45,600	LF
555.14	4PR/24 (CATEGORY 5E) CABLE	31,200	LF
655 . /5	LMR 400 CABLE	2,040	LF
555.161	MULTIMODE FIBER OPTIC CABLE - 6 FIBER	2,000	LF
555.162	SINGLE MODE FIBER OPTIC CABLE - 6 FIBER	3,500	LF
655 . 17	IVIS HOMERUN LOOP CABLE (IMSA 50-2 #14)	7,/40	LF
655 . 200	11/2" SCHEDULE 40 PVC CONDUIT	300	LF
55.2001	3/4" SCHEDULE 40 PVC CONDUIT	300	LF
555.2002	I" SCHEDULE 40 PVC CONDUIT	300	LF
55.2003	2" SCHEDULE 40 PVC CONDUIT	300	LF
655 . 201	3" SCHEDULE 40 PVC CONDUIT	240	LF
55 . 202	4" SCHEDULE 40 PVC CONDUIT	360	LF
55 . 2021	"SCHEDULE 80 PVC CONDUIT	420	LF
655 . 2021	11/2" SCHEDULE 80 PVC CONDUIT	840	LF
			_
55.2031	2" SCHEDULE 80 PVC CONDUIT	480	LF
55.204	3" SCHEDULE 80 PVC CONDUIT	2,550	LF
555.205	4" SCHEDULE 80 PVC CONDUIT	360	LF
555 . 2051	6" SCHEDULE 80 PVC CONDUIT	240	LF
555 . 2052	5" SCHEDULE 80 PVC CONDUIT	240	LF
555 . 206	"GALVANIZED RIGID METAL CONDUIT	720	LF
655 . 2061	3/4" GALVANIZED RIGID METAL CONDUIT	720	LF
655.207	11/2" GALVANIZED RIGID METAL CONDUIT	420	LF
655.2071	2" GALVANIZED RIGID METAL CONDUIT	660	LF
555.208	3" GALVANIZED RIGID METAL CONDUIT	720	LF
555.209	1/2" LIQUID TIGHT METALLIC FLEXIBLE CONDUIT	480	LF
555 . 210	3/4" LIQUID TIGHT METALLIC FLEXIBLE CONDUIT	360	LF
			LF
555 . 2101	11/2" LIQUID TIGHT METALLIC FLEXIBLE CONDUIT	120	
555,2102	2" LIQUID TIGHT METALLIC FLEXIBLE CONDUIT	120	LF
555.211	11/2" ELECTRICAL METALLIC TUBING CONDUIT	120	LF
555 . 212	2" ELECTRICAL METALLIC TUBING CONDUIT	120	LF
555 . 213	3" ELECTRICAL METALLIC TUBING CONDUIT	120	LF
655 . 214	4" ELECTRICAL METALLIC TUBING CONDUIT	120	LF
655 . 215	3/4" ELECTRICAL METALLIC TUBING CONDUIT	120	LF
555 . 221	TYPE A PULL BOX INSIDE	20	ΕA
555.222	TYPE C PULL BOX IN TUNNEL/BOOTH PIT	24	EΑ
555.223	TYPE D PULL BOX OUTDOOR CANOPY	6	ΕA
555.224	TYPE E PULL BOX STEEL IN BOOTH	12	EA
555 . 225	TYPE F PULL BOX OUTSIDE	24	EA
555 . 30	12" X 12" X 6" GALVANIZED JUNCTION BOX	90	EA
55 . 31	18" X 18" X 6" GALVANIZED JUNCTION BOX	6	EA
55 . 40		8	_
	18" X 24" X 12" JUNCTION BOX		EA
55.42	36" X 30" X 20" NEMA 4X CABINET	6	EA
55.43	60 AMP 3 PHASE PANELBOARD CABINET	8	EA
555.44	100 AMP 3 PHASE PANELBOARD CABINET	2	EA
555.45	150 AMP 3 PHASE PANELBOARD CABINET	2	EA
55.50	2" SCHEDULE 80 PVC CONDUIT CONDULETS	10	EA
55.5/	4" SCHEDULE 80 PVC CONDUIT CONDULETS	10	ΕA
55.511	3/4" RIGID METAL CONDUIT CONDULETS	10	ΕA
55.52	" RIGID METAL CONDUIT CONDULETS	20	EA
55.53	1/2" RIGID METAL CONDUIT CONDULETS	50	EA
55.54	2" RIGID METAL CONDUIT CONDULETS	50	EA
	3" ELECTRICAL METAL TUBING CONDULETS	40	EA
			EA
555.55			· - Λ
	2" ELECTRICAL METAL TUBING CONDULETS 1/2" ELECTRICAL METAL TUBING CONDULETS	40	EA

CONTRACT:2019.04

ESTIMATED QUANTITIES

DESCRIPTION

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	No.	Revision	Ву	Date			•			
3										
					CONSULTANT P	ROJE	I MANAGER:	LAUREN MEEK,	PE	
Ĕ						Ву	Date		Ву	Date
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Ĭ					Drawn	EJB	3\20\19	In Charge of	GAE	3\20\19

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THE GOLD STAR MEMORIAL HIGHWAY

ORT CONVERSION ESTIMATED QUANTITIES 2

SHEET NUMBER: QN-02

ITEM NO.

TOTAL QUANTITY

UNIT

MTA PROJECT MANAGER: RALPH NORWOOD, IV, PE, PTOE

	ESTIMATED QUANTITIES		
ITEM NO.	DESCRIPTION	TOTAL QUANTITY	UNIT
655.58	3/4" ELECTRICAL METAL TUBING CONDULETS	40	EA
655,59	" ELECTRICAL METAL TUBING CONDULETS	40	EA
655.63	4-INCH X 4-INCH PVC NEMA 3R WIREWAY	540	LF
655,64	6-INCH X 6-INCH PVC NEMA 3R WIREWAY	500	LF
655.65	8-INCH X 8-INCH PVC NEMA 3R WIREWAY	300	LF
655,65	12-INCH X 12-INCH PVC NEMA 3R WIREWAY	300	LF
655.75	CONCRETE ENCASED CONDUIT	/35	CY
655.80	LIGHTNING SUPPRESSION SYSTEM	/	LS
655.8/	KEY SWITCH	10	EA
655.82	DUPLEX RECEPTACLE	20	EA
655.83	NEMA L5-20R RECEPTACLE	10	EA
655.84	QUADPLEX RECEPTACLE	10	EA
655.90	SPACE FRAME LIGHTING	/	LS
655.92	LED CANOPY LIGHT FIXTURE	12	EA
655.99	LED BUMPER BEACON	6	EA
656.41	GRAVEL WETLAND FILTER I	/	LS
656.42	GRAVEL WETLAND FILTER 2	/	LS
656.50	BALED HAY, IN-PLACE	140	EA
656.60	TEMPORARY BERMS	3,000	LF
656.62	TEMPORARY SLOPE DRAINS	500	LF
656.632	30" TEMPORARY SILT FENCE	26,000	LF
659.10	MOBILIZATION	/	LS
670.01	SEWAGE DISPOSAL SYSTEM	/	LS
800.01	TOLL ADMINISTRATION BUILDING	/	LS
800.10	ELECTRICAL DEMOLITION	/	LS
800.20	MECHANICAL DEMOLITION	/	LS
800.22	HVAC AND ELECTRICAL TUNNEL AND BOOTHS	/	LS
800.30	TOLL PLAZA & BRIDGE DEMOLITION	/	LS
800.40	NEW TOLL BOOTH INSTALLATION	1	LS
800.41	STAIR ENCLOSURE & INSTALLATION	1	LS
800.90	GENERATOR PAD	1	LS
800.91	TRANSFORMER PAD	1	LS
803.01	TEST PITS	3	EA
832.41	TYPE A STEEL SITE BOLLARD	8	EA

EARTHWORK SUMMARY

COMMON EXCAVATION FOR ESTIMATE

COMMON EXCAVATION (FROM CROSS SECTIONS) GRUBBING IN FILL MUCK EXCAVATION (FROM CROSS SECTIONS) PAVEMENT SALVAGE IN FILL TOTAL COMMON EXCAVATION	80,749 4,206 2,542 0	87 . 497_
ITEM 203.20 - COMMON EXCAVATION		88,000
FILL FOR BORROW CALCULATIONS		
COMMON FILL (FROM CROSS SECTIONS) GRUBBING IN FILL EXISTING TUNNEL VOID EXISTING BUILDING FOUNDATION VOID BACKFILL CATCH BASIN REMOVAL MUCK EXCAVATION TOTAL FILL	41,965 4,026 300 275 33 2,542	49,141
AVAILABLE COMMON EXCAVATION FOR BORROW CALC (I) TOTAL COMMON EXCAVATION DEDUCTIONS: GRUBBING IN CUT GRUBBING IN FILL		87 , 497
PAVEMENT REMOVAL (2) TOTAL DEDUCTIONS	726_	
TOTAL AVAILABLE COMMON EXCAVATION (I) MINU TOTAL AVAILABLE STRUCTURAL EXCAVATIONS (F TOTAL AVAILABLE STRUCTURAL EXCAVATIONS (E TOTAL AVAILABLE NON-ROCK EXCAVATION	PLAZA)	75.806 2.350 815 78,971
COMPUTATION FOR GRANULAR BORROW FOR ESTIMA	TE	
GRANULAR BORROW TO REPLACE MUCK GRANULAR BORROW IN LOW WET AREAS GRANULAR BORROW TO UPGRADE EXCAVATION GRANULAR BORROW TO MAINTAIN TRAFFIC GRANULAR BORROW FOR UNDERCUTTING GRANULAR BORROW =		1.00 = 2,542
COMPUTATION FOR COMMON BORROW FOR ESTIMATE		1,00 2,5 12
(3) TOTAL FILL		49,141
TOTAL AVAILABLE NON-ROCK EXCAVATION _ (4) TOTAL AVAILABLE EXCAVATION	78.971 × 0.90 <u>= 71.074</u>	71,074
(4)	-(3)SURPLUS MATERIAL =	21.933

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THE GOLD STAR MEMORIAL HIGHWAY

INTERCHANGE 103 ORT CONVERSION ESTIMATED QUANTITIES 3 & EARTHWORKS SUMMARY

SHEET NUMBER: QN-03

- 3. THE CONTRACTOR SHALL SUBMIT THE PROPOSED STAGING AREA(S) AND FIELD TRAILER LOCATION TO THE RESIDENT FOR APPROVAL PRIOR TO STARTING WORK.
- 4. CONTRACTOR IS REQUIRED TO MAINTAIN SAFE ACCESS TO PARKING AREAS FOR MTA EMPLOYEES AT ALL TIMES DURING CONSTRUCTION.
- 5. A COPY OF THE "GEOTECHNICAL REPORT" AND ENVIRONMENTAL PERMITS ARE AVAILABLE FOR DOWNLOAD AT MAINETURNPIKE.COM.
- 6. DUST CONTROL IS INCIDENTAL TO CONTRACT.
- 7. WASTE MATERIALS SHALL BE DISPOSED OF OFF THE PROJECT SITE, IN ACCORDANCE WITH CHAPTER 404, DEPARTMENT OF ENVIRONMENTAL PROTECTION SOLID WASTE MANAGEMENT RULES.
- 8. CLEARING LIMITS ARE AS SHOWN ON THE PLANS UNLESS OTHERWISE AUTHORIZED BY THE RESIDENT. THE ACTUAL CLEARING LINES SHALL BE ESTABLISHED BY THE CONTRACTOR AND APPROVED BY THE RESIDENT PRIOR TO ANY CLEARING TAKING PLACE. NOTE ACTUAL TREE LINE MAY VARY DUE TO CLEARING EFFORTS BY THE AUTHORITY. TREE CLEARING MAY NOT OCCUR IN JUNE AND JULY.
- 9. GEOTECHNICAL INFORMATION FURNISHED OR REFERRED TO IN THIS PLAN SET IS FOR THE USE OF THE BIDDERS AND THE CONTRACTOR. NO ASSURANCE IS GIVEN THAT THE INFORMATION OR INTERPRETATIONS WILL BE REPRESENTATIVE OF ACTUAL SUBSURFACE CONDITIONS OF THE CONSTRUCTION SITE. THE MTA WILL NOT BE RESPONSIBLE FOR THE BIDDERS' OR CONTRACTOR'S INTERPRETATIONS OF, OR CONCLUSIONS DRAWN FROM, THE GEOTECHNICAL INFORMATION.
- IO. THE CONTRACTOR WILL BE REQUIRED TO SUBMIT AS BUILT PLANS.
- II. BASELINE IS BASED ON FIELD SURVEY AND DOES NOT MATCH ORIGINAL I-95 CONSTRUCTION BASELINE FROM THE 1940'S. THE FIELD SURVEY BASELINE IS A BEST FIT CENTERLINE.
- 12. THE CONTRACTOR SHALL NOTE THAT THE TOLL PLAZA AREA WITHIN THE PROJECT LIMITS RECEIVED A PAVEMENT OVERLAY IN 2018. THE WORK LIKELY INCLUDED PAVEMENT MILLING AND SHIMMING NECESSARY FOR TRADITIONAL PAVEMENT PRESERVATION WORK. PLEASE NOTE THAT THE TOPOGRAPHIC FIELD SURVEY WAS COLLECTED PRIOR TO THE PAVEMENT OVERLAY AND THEREFORE THE OVERLAY IS NOT REFLECTIVE IN THE EXISTING PAVEMENT CONDITIONS SURVEY. CONTRACTOR SHALL PLAN HIS WORK ACCORDINGLY.

EARTHWORK

- I. EXCAVATIONS ACCOMPLISHED AS PART OF THIS PROJECT SHALL BE CONSTRUCTED IN ACCORDANCE WITH OSHA SUBPART P OF 29 CFR PART 1926.650-652 (CONSTRUCTION STANDARDS FOR EXCAVATION).
- 2. THE NORMAL GRUBBING WIDTH IN THE FILLS SHALL BE VARIABLE WHEN SUBGRADE IS LESS THAN 5' ABOVE OLD GROUND. THE GRUBBING DEPTH HAS BEEN ESTIMATED AS 6" IN FIELD AREAS AND 12" IN WOODED AREAS.
- 3. EXISTING INSLOPES STEEPER THAN 2: IN PROPOSED FILL AREAS SHALL BE BENCHED AS SHOWN IN THE DETAILS OR AS DIRECTED BY THE RESIDENT.
- 4. GRANULAR BORROW USED TO BACKFILL MUCK EXCAVATION OR IN LOW WET AREAS, TO I'ABOVE WATER OR OLD GROUND SHALL MEET REQUIREMENTS FOR GRANULAR BORROW UNDERWATER BACKFILL.

UTILITY

- I. EXISTING UTILITIES ON THESE PLANS WERE COMPILED FROM FIELD SURVEY AND VARIOUS OTHER SOURCES. LOCATIONS ARE NOT GUARANTEED TO BE ACCURATE NOR IS IT GUARANTEED THAT ALL UTILITIES ARE SHOWN. NO SEPARATE OR ADDITIONAL COMPENSATION WILL BE ALLOWED TO THE CONTRACTOR DUE TO ANY VARIANCE BETWEEN THE DATA SHOWN ON THE PLANS AND THE ACTUAL FIELD CONDITIONS ENCOUNTERED. NO WORK SHALL BE STARTED UNTIL THE OWNERS OF THE VARIOUS UTILITIES ARE NOTIFIED BY THE CONTRACTOR OF THE PROPOSED CONSTRUCTION. THE CONTRACTOR IS ALSO REQUIRED TO CALL DIG SAFE AT 1-888-344-7233 PRIOR TO THE START OF THE WORK.
- 2. THE UTILITIES INVOLVED IN THIS CONTRACT ARE:
 MAINE TURNPIKE AUTHORITY
 CENTRAL MAINE POWER
 FAIRPOINT/CONSOLIDATED COMMUNICATIONS
 GARDINER WATER DISTRICT
 MAINEDOT
 SPECTRUM/CHARTER COMMUNICATIONS
- 3. THE CONTRACTOR SHALL NOTIFY THE RESIDENT IO DAYS PRIOR TO CONSTRUCTION SO THE RESIDENT CAN ARRANGE FOR MAINE TURNPIKE UNDERGROUND UTILITY LOCATION. ALL PROPOSED SIGN LOCATIONS AND EXCAVATION LOCATIONS SHALL BE MARKED AT THE NOTIFICATION TIME. EXCAVATION WILL NOT BE PERMITTED UNTIL THE AUTHORITY HAS LOCATED AND MARKED ITS' UNDERGROUND UTILITIES, OR NOTIFIED THE RESIDENT THERE ARE NO UNDERGROUND UTILITIES IN THE MARKED AREAS. THE AUTHORITY HAS PROGRAMMED TWO FIELD VISITS FOR MAINE TURNPIKE UTILITY COORDINATION ON THIS PROJECT. SHOULD THE CONTRACTOR NEED ADDITIONAL SIGN LOCATIONS AND/OR ADDITIONAL EXCAVATION LOCATIONS MARKED, OR SHOULD THE CONTRACTOR FAIL TO MAINTAIN THE AUTHORITY SPREVIOUSLY ESTABLISHED DIG SAFE MARKS, THE AUTHORITY SHALL DEDUCT THE ADDED MARKING COSTS FROM THE CONTRACTOR'S PAYMENTS.

EROSION CONTROL

- I. THE ANTICIPATED EROSION CONTROL DEVICES ARE SHOWN ON THE PLANS. THE CONTRACTOR SHALL PROPOSE ACTUAL TYPE AND LOCATION OF DEVICES FOR APPROVAL BY THE RESIDENT. ADDITIONAL MEASURES MAY BE PROPOSED BY THE CONTRACTOR DUE TO SITE OR WEATHER CONDITIONS. THE RESIDENT MAY DIRECT THE CONTRACTOR TO IMPLEMENT ADDITIONAL MEASURES. ANY ADDITIONAL MEASURES APPROVED BY THE RESIDENT WILL BE MEASURED FOR PAYMENT.
- 2. 4° LOAM HAS BEEN ESTIMATED FOR 100% OF THE DISTURBED SLOPE AREA UNLESS OTHERWISE SPECIFIED ON THE PLANS. ACTUAL PLACEMENT OF THE LOAM SHALL BE AS DESIGNATED BY THE RESIDENT.
- 3. NEWLY DISTURBED EARTH SHALL BE MULCHED PRIOR TO A RAIN EVENT.THIS WORK SHALL BE PAID FOR UNDER ITEM 619.1202 TEMPORARY MULCH.
- 4. ALL TEMPORARY AND PERMANENT EROSION CONTROL DEVICES SHALL BE INSTALLED IN ACCORDANCE WITH THE MAINE DEPARTMENT OF TRANSPORTATION BEST MANAGEMENT PRACTICES.
- 5. TEMPORARY SEED SHALL BE APPLIED TO ALL DISTURBED AREAS THAT WILL NOT BE COMPLETED WITHIN 30 DAYS. TEMPORARY SEED SHALL BE INCIDENTAL TO THE 618 ITEMS.
- 6. TEMPORARY EROSION CONTROL BLANKET, ITEM 613.319 SHALL BE INSTALLED IN ALL DITCHES AND 2: SLOPES FROM TOP TO TOE OF SLOPE, LOAM AND SEED SHALL BE PLACED PRIOR TO THE INSTALLATION OF THE EROSION CONTROL BLANKET. LIMITS OF THE EROSION CONTROL BLANKET IN DITCHES SHALL BE 8' WIDE OR AS DESIGNATED BY THE RESIDENT, SEEDING METHOD NO. 2 SHALL BE USED BEHIND GUARDRAIL AND SEEDING METHOD NO. I SHALL BE USED AT AND AROUND THE PLAZA BUILDING, TEMPORARY SIDESLOPES AND ALL OTHER AREAS.

SIGN STRUCTURES / FOUNDATIONS

- I. THESE NOTES APPLY ONLY TO OVERHEAD SIGN STRUCTURES. FOR ORT SPACE FRAME NOTES, SEE PLAZA STRUCTURAL PLANS. FOR ADDITIONAL OVERHEAD SIGN SUPPORT STRUCTURE FOUNDATIONS NOTES. SEE ADDENDUM.
- 2. AT LOCATIONS WHERE A MEDIAN FOUNDATION IS REQUIRED, THE FOOTPRINT OF THE DESIGNED FOUNDATION SHALL FIT ENTIRELY WITHIN THE EXISTING MEDIAN THE CONSTRUCTION OF THE MEDIAN FOUNDATION(S) SHALL NOT EXTEND INTO THE SHOULDER OF THE ROADWAY AND SHALL INCLUDE APPROPRIATE SUPPORT OF EXCAVATION TO PROTECT THE PAYEMENT SURFACE.
- 3. IF TEMPORARY SHEETING IS REQUIRED, IT SHALL BE INCIDENTAL TO THE SIGN SUPPORT STRUCTURE ITEM, AND SHALL MEET THE REQUIREMENTS UNDER SECTION SIGN STRUCTURE SECTION SIGN SECTION SECTION SHALL BE ALLOWED, CONTRACTOR SHALL SUBMIT WORKING DRAWINGS FOR THE SUPPORT OF EXCAVATION TO THE AUTHORITY FOR REVIEW AND APPROVAL.
- 4. THE TOP OF SIGN STRUCTURE FOUNDATIONS SHALL BE AT LEAST 3 INCHES BUT NO MORE THAN 18 INCHES ABOVE THE GRADE. MEASUREMENT SHALL BE MADE FROM THE HORIZONTAL FOUNDATION FACE LEAST EXPOSED ON A SLOPE.
- 5. NEW FOUNDATIONS SHALL BE INSTALLED SUCH THAT THE MINIMUM VERTICAL CLEARANCE TO THE BOTTOM OF THE LOWEST SIGN IS AT LEAST 18'-0' FROM THE HIGH POINT OF THE ROADWAY INCLUDING SHOULDERS. THE MAXIMUM VERTICAL CLEARANCE TO THE BOTTOM OF THE LOWEST SIGN SHALL NOT EXCEED 20'-6'.
- 6. SOIL AND ROCK EXCAVATION, DEWATERING AND FINE GRADING AROUND SIGN STRUCTURE FOUNDATIONS SHALL NOT BE PAID FOR DIRECTLY BUT SHALL BE INCIDENTAL TO THE SECTION 645 SIGN SUPPORT PAY ITEMS.
- 7. IF SOIL CONDITIONS DIFFER MATERIALLY FROM THOSE SHOWN ON THE GEOTECHNICAL BORING LOGS, THE CONTRACTOR SHALL STOP WORK ON THAT STRUCTURE'S FOUNDATIONS AND CONTACT THE RESIDENT.

PAVING

- I. WHERE PROPOSED PAVEMENT JOINS EXISTING PAVEMENT, THE EXISTING PAVEMENT SHALL BE SAW CUT ALONG A SMOOTH LINE TO A NEAT, EVEN AND VERTICAL JOINT, AS DIRECTED BY THE RESIDENT. SAWCUTTING SHALL BE PAID FOR UNDER ITEM 419.30. ALL WORK NECESSARY FOR THE PREPARATION OF THE JOINT SHALL BE CONSIDERED INCIDENTAL TO THE RELATED CONTRACT ITEMS.
- 2. ALL JOINTS BETWEEN EXISTING AND PROPOSED HOT BITUMINOUS PAVEMENT SHALL BE BUTTED.
- 3. ANY NECESSARY CLEANING OF EXISTING PAVEMENT PRIOR TO PAVING SHALL BE CONSIDERED INCIDENTAL TO THE RELATED PAVING ITEMS.
- 4. A COATING OF HOT RUBBERIZED ASPHALT (SS-S-140IC) SHALL BE APPLIED TO ALL TRANSVERSE BUTT JOINTS AND LONGITUDINAL JOINTS IN THE TOP LIFT OF PAVEMENT ALONG THE MAINE TURNPIKE AND RAMPS.
- 5. A BITUMINOUS TACK COAT IS REQUIRED BETWEEN ALL PAVEMENT LIFTS.
- 6. PLACEMENT OF THE FINAL LIFTS OF PAVEMENT SHALL BE DONE IN A MANNER TO LIMIT PAVEMENT JOINTS. CONTRACTOR SHALL COORDINATE WITH RESIDENT.

DRAINAGE

- I. NO EXISTING DRAINAGE SHALL BE ABANDONED, REMOVED OR PLUGGED WITHOUT PRIOR APPROVAL OF THE RESIDENT.
- 2. INLETS AND OUTLETS OF ALL CULVERTS SHALL BE RIPRAPPED UNLESS OTHERWISE NOTED ON THE PLANS OR DIRECTED BY THE RESIDENT
- 3. ALL DITCH ELEVATIONS AND OFFSETS SHOWN ON THE CROSS SECTIONS ARE FOR THE FINISHED DITCH FLOW LINE.
- 4. ANY NECESSARY CUTTING OF EXISTING PIPES TO FIT IN AREAS OF PROPOSED CATCH BASINS AND MANHOLES WILL NOT BE PAID FOR SEPARATELY, BUT SHALL BE CONSIDERED INCIDENTAL TO THE PROPOSED CATCH BASIN AND MANHOLE ITEMS.
- 5. ANY NECESSARY CUTTING OF EXISTING CATCH BASINS TO TAKE A PROPOSED PIPE WILL NOT BE PAID FOR SEPARATELY AND SHALL BE CONSIDERED INCIDENTAL TO THE PROPOSED CULVERT ITEMS.
- 6. EXISTING CULVERTS TO REMAIN SHALL BE CLEANED AS DIRECTED BY THE RESIDENT. PAYMENT WILL BE MADE UNDER ITEM 631.32 CULVERT CLEANER (INCLUDING OPERATORS).
- 7. ONE GREEN DELINEATOR POST SHALL BE INSTALLED AT ALL UNDERDRAIN AND STORM DRAIN OUTLETS.

GUARDRAIL

- I. AT THE END OF THE WORK DAY, EVERYDAY, THE CONTRACTOR IS REQUIRED TO HAVE AN APPROVED CRASHWORTHY END TREATMENT ON ALL GUARDRAIL WITHIN ALL WORK AREAS THAT ARE ACCESSIBLE TO TRAFFIC.
- 2. CONNECTIONS FOR PROPOSED GUARDRAIL TO EXISTING GUARDRAIL SHALL BE INCIDENTAL TO THE PROPOSED GUARDRAIL ITEMS.
- 3. ALL PROPOSED AND RESET GUARDRAIL SHALL BE INSTALLED IN A MANNER TO AVOID ALL EXISTING OR PROPOSED SUBSURFACE FEATURES.
- 4. CONTRACTOR SHALL STOCKPILE ALL GUARDRAIL TO BE REMOVED, MODIFIED AND RESET UNTIL GUARDRAIL INSTALLATION HAS BEEN COMPLETE. STOCKPILING THE GUARDRAIL SHALL BE INCIDENTAL TO ITEM 606.3605. GUARDRAIL REMOVE, MODIFY, AND RESET SINGLE RAIL. ALL USABLE EXISTING GUARDRAIL SHALL BE MODIFIED AND RESET PRIOR TO BEING PAID TO INSTALL NEW GUARDRAIL.
- 5. GUARDRAIL WHICH IS REMOVED AND NOT REUSED ON THE PROJECT SHALL BECOME PROPERTY OF THE CONTRACTOR. REMOVAL AND DISPOSAL SHALL BE CONSIDERED INCIDENTAL TO THE GUARDRAIL ITEMS
- 6. DAMAGE TO EXISTING PAVEMENT OR NEW PAVEMENT DUE TO THE INSTALLATION OF NEW OR RESET GUARDRAIL SHALL BE REPAIRED WITH NO ADDITIONAL COMPENSATION TO THE CONTRACTOR.
- ONE GUARDRAIL DELINEATOR POST SHALL BE INSTALLED AT EACH GUARDRAIL TERMINAL. TWO GUARDRAIL DELINEATOR POSTS SHALL BE INSTALLED AT EACH LEADING GUARDRAIL END.
- 3. IN NON-GUARDRAIL AREAS, DELINEATORS SHALL BE SPACED AT 264'ON MAINLINE AND AT 50'ON RAMPS AND ACCESS ROAD, THE CONTRACTOR SHALL CONFIRM THE DELINEATOR LAYOUT WITH THE RESIDENT.


STANTEC CONSULTING SERVICES INC.
482 PAYNE ROAD
SCARBOROUGH, ME 04074
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THE GOLD STAR
MEMORIAL HIGHWAY

INTERCHANGE 103
ORT CONVERSION
GENERAL
NOTES

SHEET NUMBER: GN-01



- I. THE PAVEMENT, BASE AND SUBBASE DEPTHS AS SHOWN ON THE PLANS ARE INTENDED TO BE NOMINAL.
- 2. CROWNS FOR ALL COURSES OF SUBBASE AND PAVEMENT SHALL BE STRAIGHT.
- 3. ALL NECESSARY PAVEMENT CUTTING SHALL BE SAWCUT AND DONE IN SUCH A MANNER AS TO LEAVE A CLEAN, VERTICAL FACE.
- 4. BITUMINOUS TACK COAT IS REQUIRED BETWEEN ALL LIFTS OF PAVEMENT, OR AS DIRECTED BY RESIDENT. BITUMINOUS TACK COAT IS REQUIRED ON ALL EXISTING PAVED OR MILLED SURFACES PRIOR TO PLACING PROPOSED PAVEMENT.
- 5. A COATING OF HOT RUBBERIZED ASPHALT SHALL BE APPLIED TO SURFACE LAYER OF ALL SAWCUT AND PAVEMENT JOINTS AND PAVEMENT AND CONCRETE JOINTS PRIOR TO PAVING. REMAINDER OF SAWCUT TO BE BITUMINOUS TACK COAT. PAYMENT SHALL BE INCIDENTAL TO THE PAVEMENT ITEMS.
- 6. THE CONTRACTOR WILL NOT BE PERMITTED TO GRIND OUT OR PLACE TEMPORARY PAINTED PAVEMENT MARKINGS ON FINAL SURFACE LIFT OF PAVEMENT. THE SURFACE LIFT SHALL BE PLACED AS THE FINAL CONSTRUCTION PHASE ONCE CONCRETE MEDIAN BARRIER HAS BEEN INSTALLED.
- 7. SEE GENERAL PLANS FOR THE TYPE AND LIMITS OF BARRIER.
- 8. WHEN SUPERELEVATION EXCEEDS 4%, LOW SIDE SHOULDER SHALL HAVE THE SAME SLOPE AS THE TRAVEL LANE.
- 9. "ROLLOVER" ALGEBRAIC DIFFERENCE IN RATES OF CROSS SLOPE SHALL NOT EXCEED 8%.
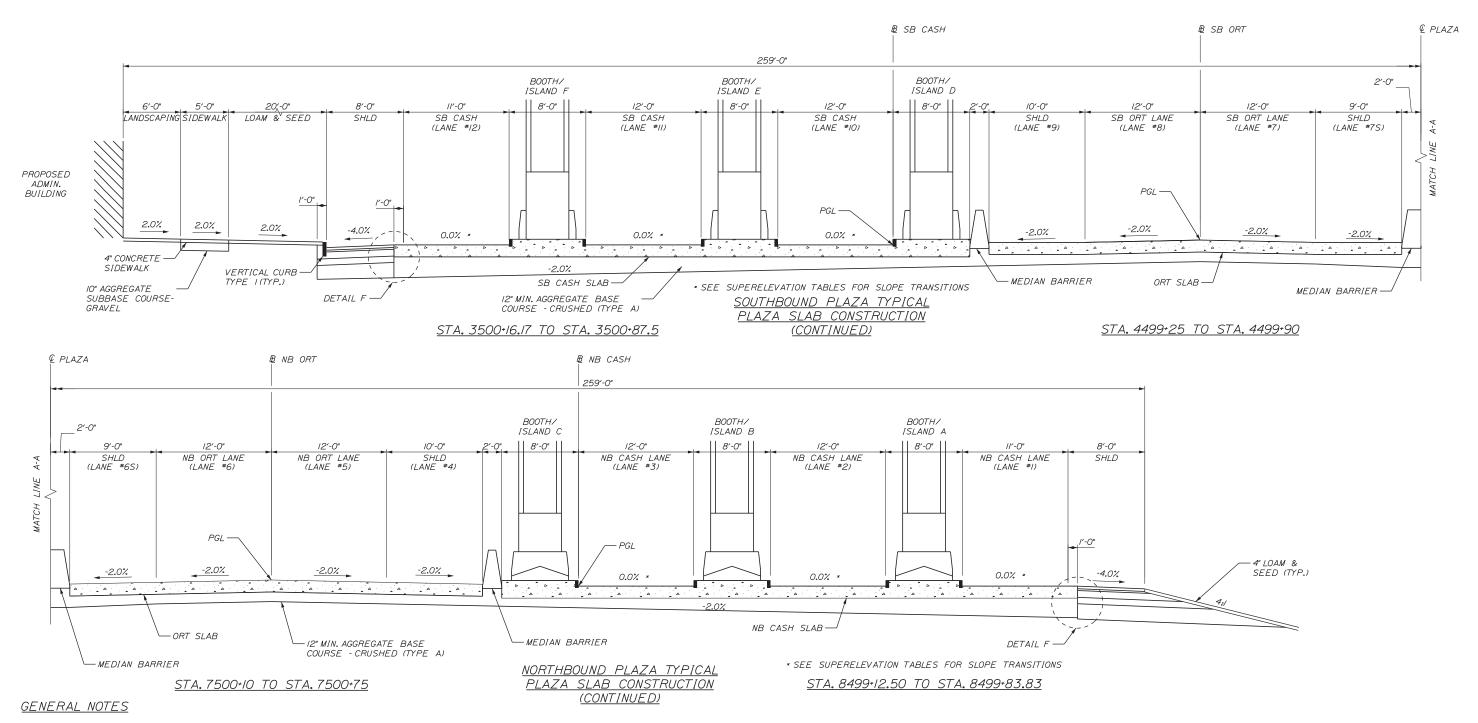
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					Drawn	EJB	3\20\19	In Charge of	GAE	3\20\19	1

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THE GOLD STAR
MEMORIAL HIGHWAY


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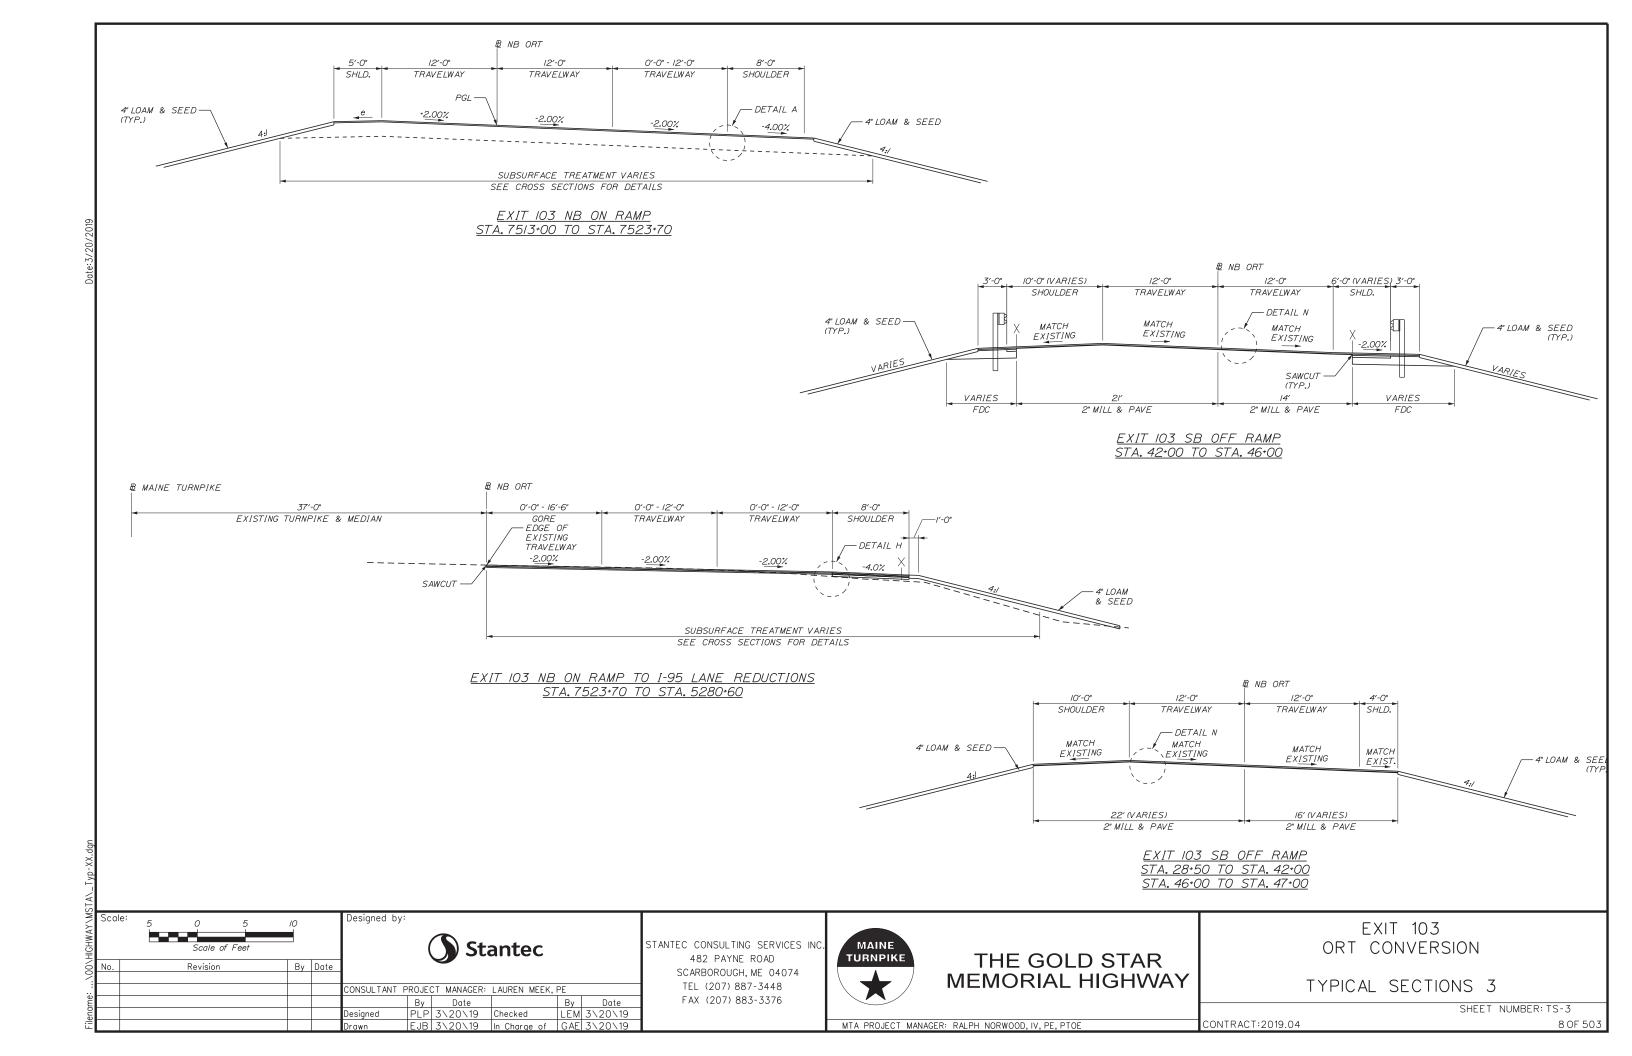
TYPICAL SECTIONS 1


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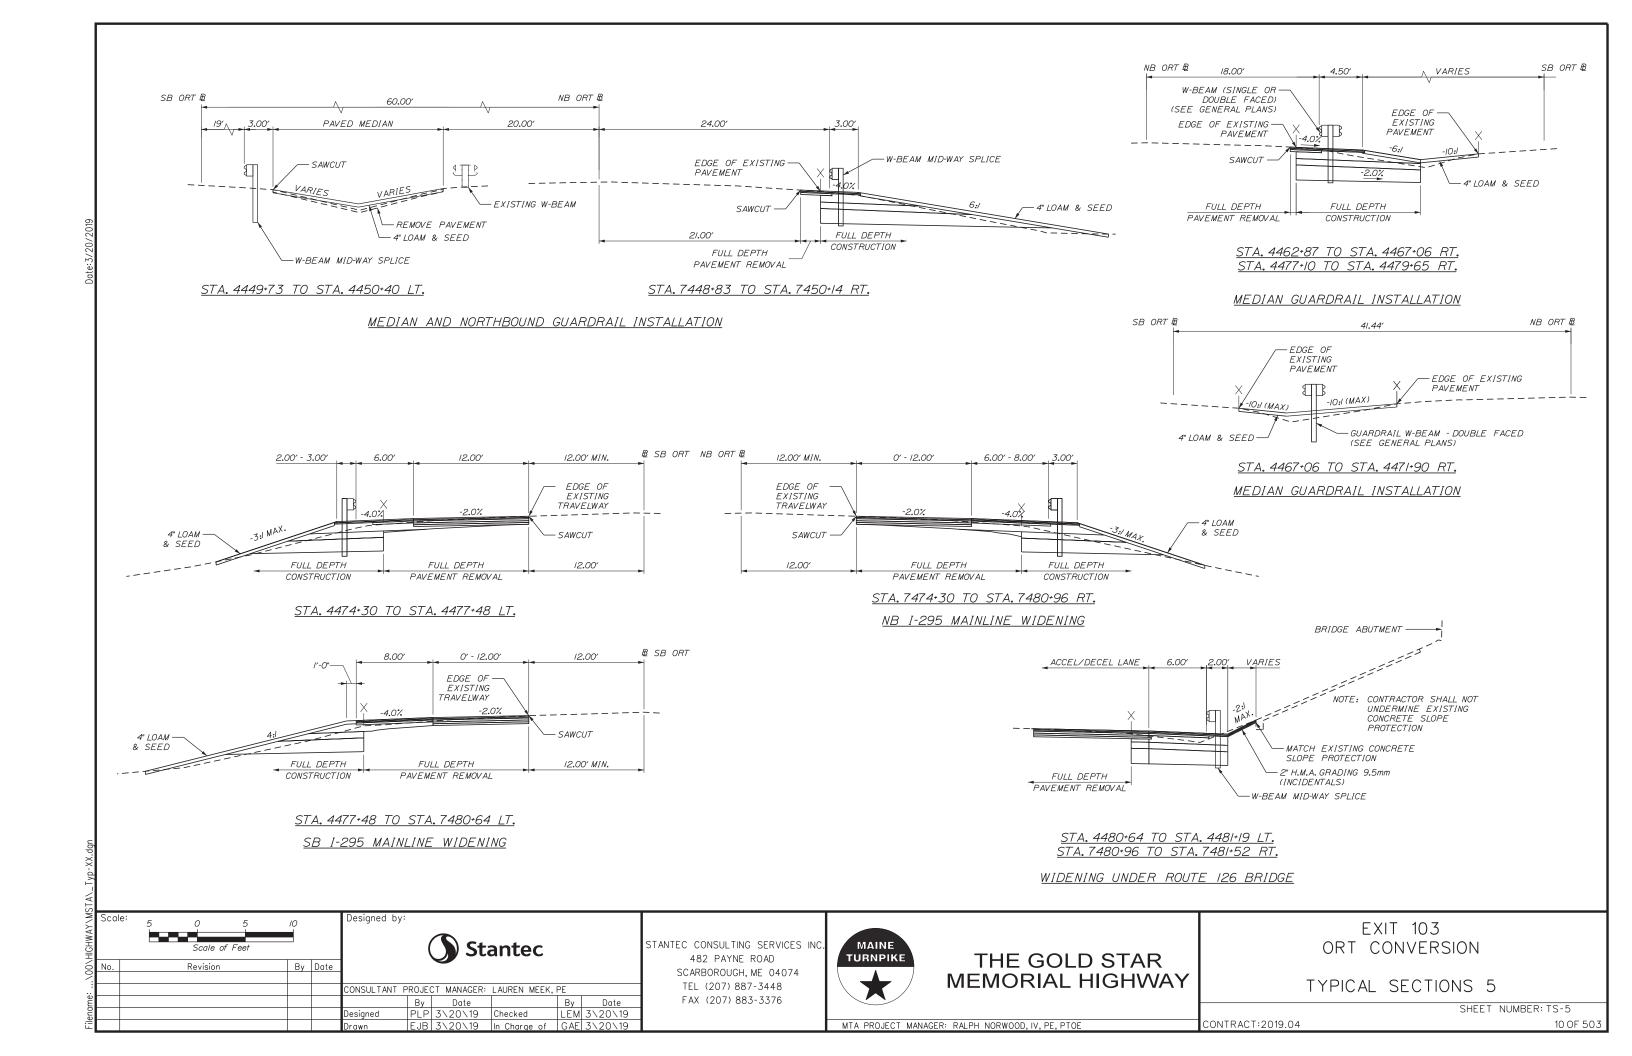
MTA PROJECT MANAGER: RALPH NORWOOD, IV, PE, PTOE

CONTRACT: 2019.04





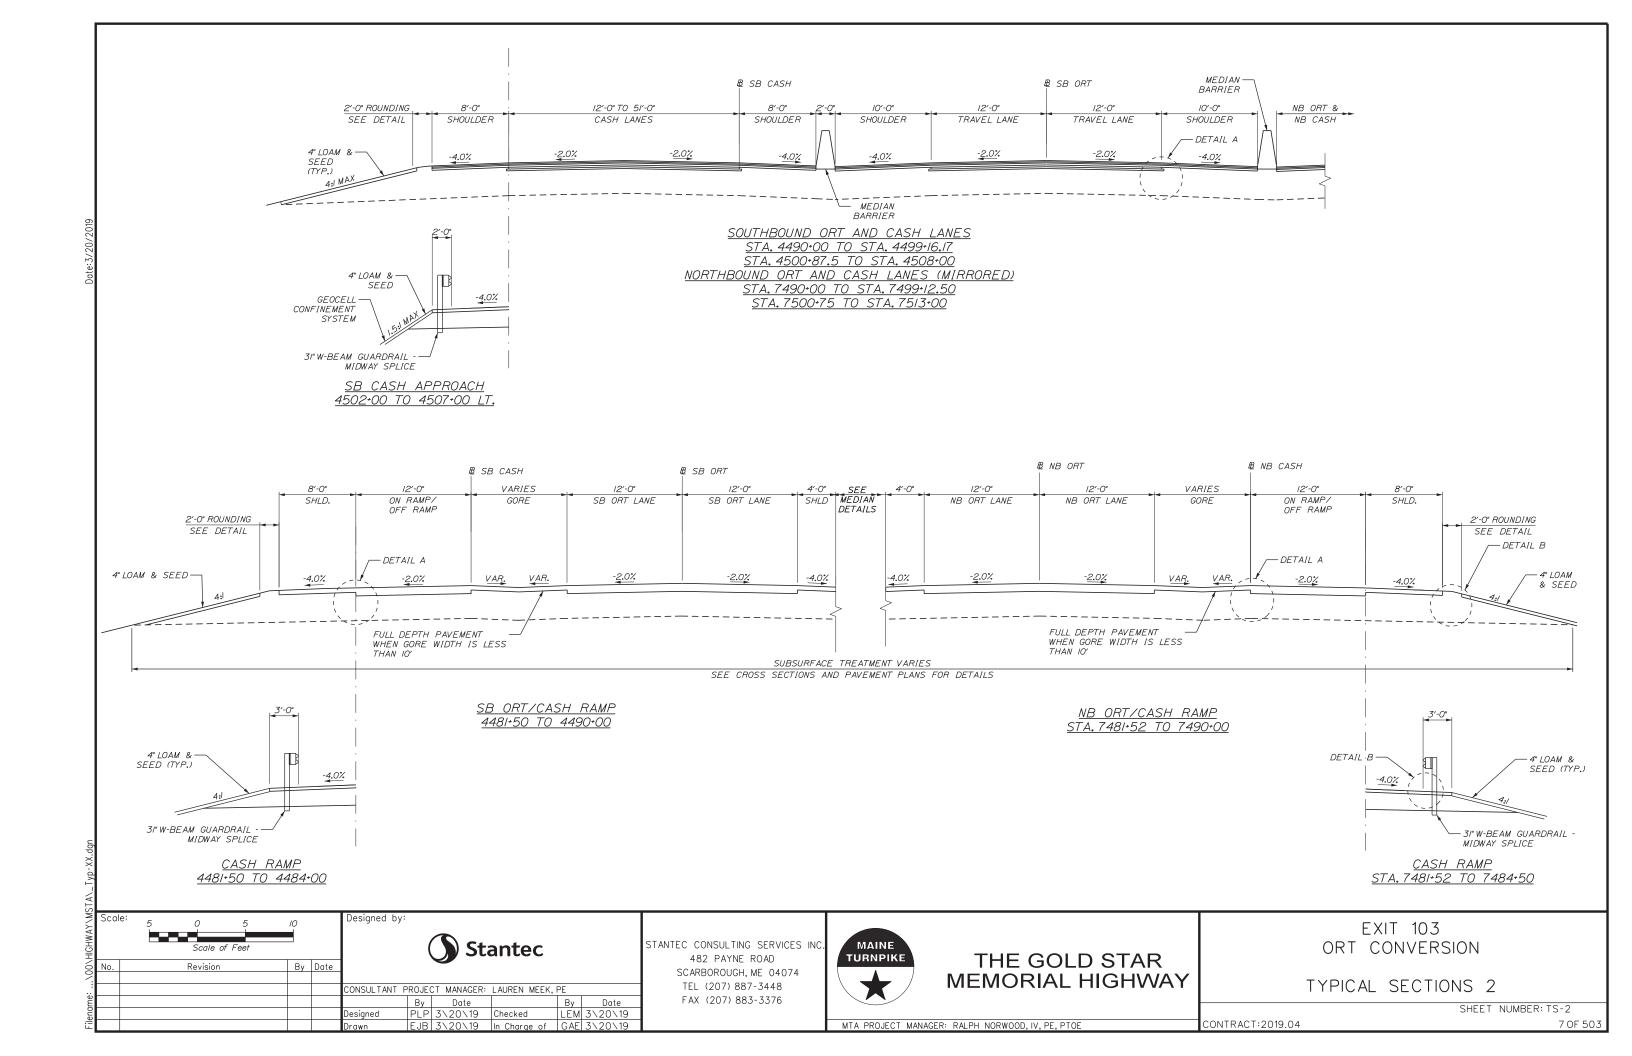

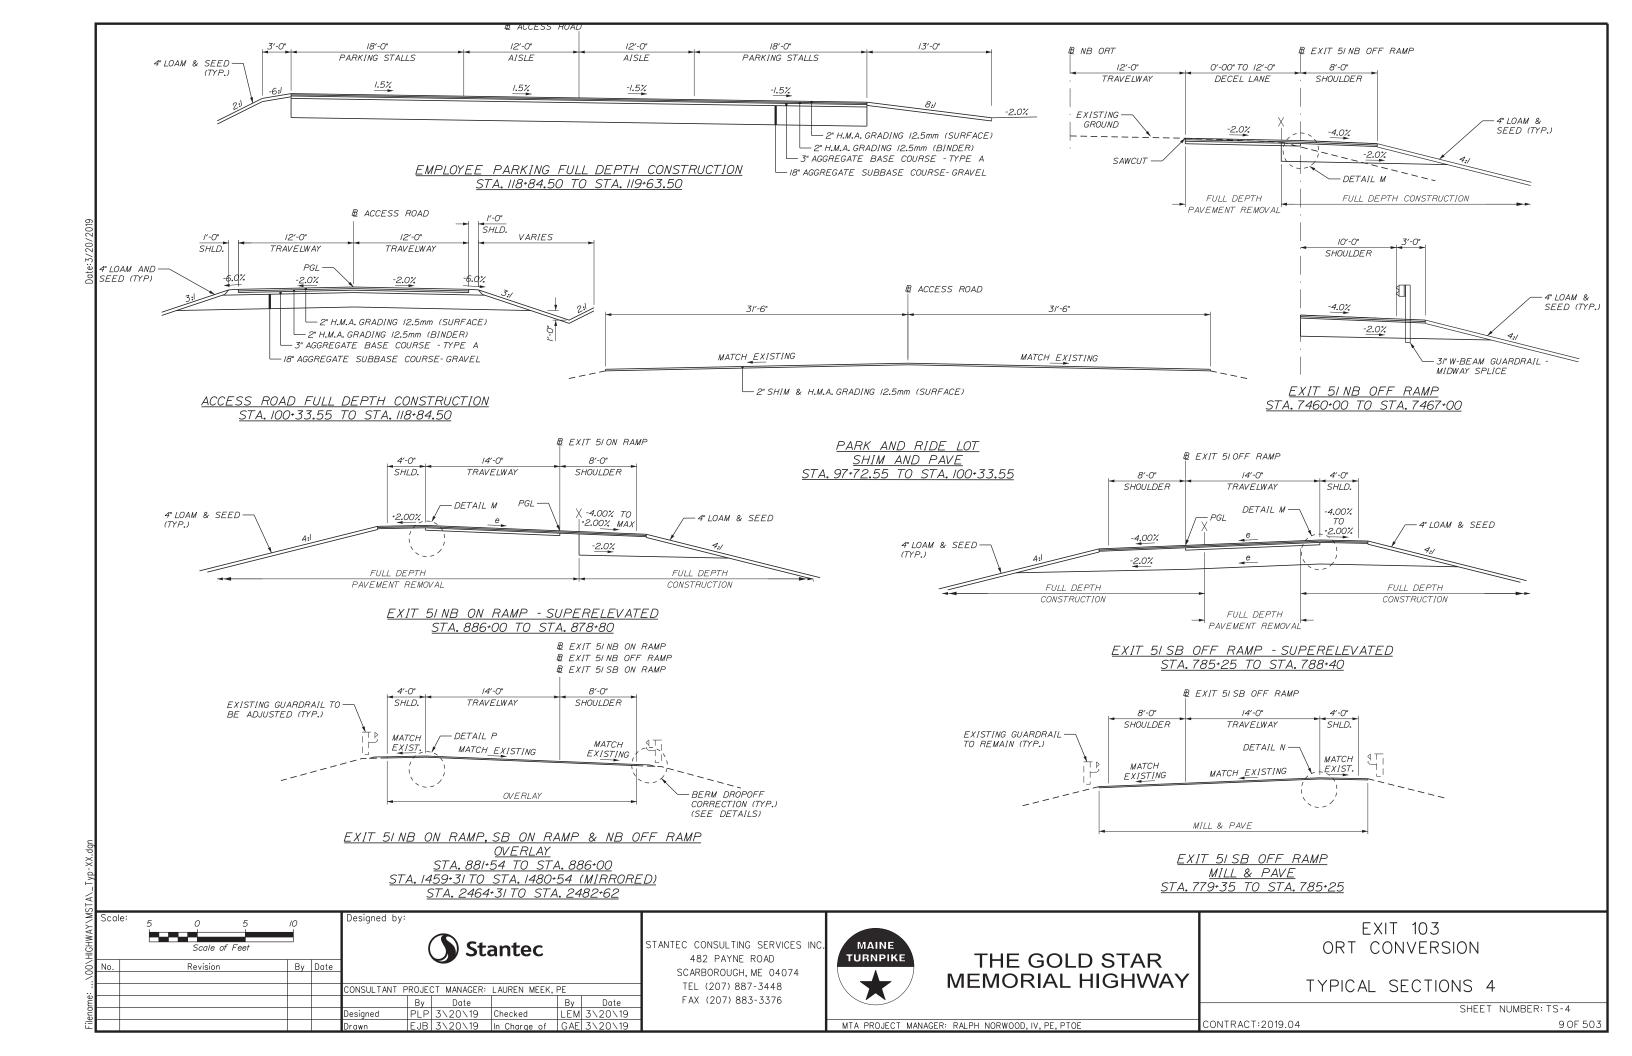

LEFT	LEFT	LEFT	STATION	RIGHT	RIGHT
SHOULDER	TRAVELWAY	GORE		TRAVELWAY	SHOULDER
		MATCH E	XISTING		
-4.00%	-2.00%	-	4482+00	-1.60%	-4.00%
-4.00%	-2.00%	-	4482+50	-2.00%	-4.00%
-4.00%	-2.00%	-2.00%	<i>4483+00</i>	-2.00%	-4.00%
		NORMAL			
-4.00%	-2.00%	-2.00%	4488+00	-2.00%	-4.00%
-3.00%	-	-	<i>4488+50</i>	-2.00%	-4.00%
-4.00%	-	-	4489+00	-2.00%	-4.00%
		NORMAL			
-4.00%	-	-	4498+50	-2.00%	-4.00%
-2.00%	-	-	4499+00	-2.00%	-2.00%
-2.00%	-	-	4500+00	-2.00%	-2.00%
-4.00%	-	-	4500+50	-2.00%	-4.00%
		NORMAL			
-4.00%	-	-	4504+65	-2.00%	-4.00%
-3.30%	-	-	<i>4505+00</i>	-2.00%	-4.00%
-3.00%	-	-	4505+15	-2.00%	-4.00%
-2.30%	-	-	<i>4505+50</i>	-2.00%	-4.00%
-4.00%	-2.00%	-2.00%	<i>4505+65</i>	-2.00%	-4.00%
		NORMAL			
-4.00%	-2.00%	-2.00%	<i>4507+00</i>	-2.00%	-4.00%
-4.00%	-3.80%	-2.00%	<i>4507+50</i>	-2.00%	-4.00%
		FULL S			
-4.00%	-3.80%	-2.00%	4507+50	-2.00%	-4.00%
-4.00%	-2.00%	-2.00%	<i>4508+00</i>	-2.00%	-4.00%
		NORMAL			
-4.00%	-2.00%	-2.00%	4509+00	-2.00%	-4.00%
		MATCH EXIT IC	03 SB BRIDGE	•	

SOUTHBOUND CASH B SUPERELEVATION TABLE

	LEFT SHOULDER	LEFT TRAVELWAY	STATION	RIGHT SHOULDER
ı	-4.00%	-2.00%	3499+50	2.00%
	-4.00%	0.00%	3500+00	0.00%
	-4.00%	0.00%	350/+00	0.00%
	-4.00%	-2.00%	3501+50	2.00%

EXIT 51 SB OFF RAMP B SUPERELEVATION TABLE

LEFT	STATION	RIGHT	RIGHT							
SHOULDER		TRAVELWAY	SHOULDER							
MATCH EXISTING										
-4.00%	785+24 . 65	3.70%	-5.80%							
-4.00%	<i>785+50</i>	3.80%	-4.00%							
FULL SUPER										
-4.00%	<i>-4.00%</i> 787 <i>+</i> 00		-4.00%							
-4.00%	787+50	3.80%	-2.00%							
-4.00%	<i>788</i> +00	3.80%	0.00%							
-4.00%	<i>788</i> +50	3.80%	2.00%							
	FULL S	SUPER								
-4.00%	790+50	3.80%	-							
-4.00%	4491+00*	2.90%	-							
-4.00%	4491+50*	2.00%	-							

^{*} SB ORT BASELINE

NORTHBOUND ORT B SUPERELEVATION TABLE

LEFT	LEFT	STATION	RIGHT	RIGHT	RIGHT		
SHOULDER	TRAVELWAY		GORE	TRAVELWAY	SHOULDER		
MATCH EXISTING							
-2.30%	-1.30%	7484+50	-2.00%	-2.00%	-4.00%		
-4.00%	-2.00%	7485+00	-2.00%	-2.00%	-4.00%		
	•	NORMAL	CROWN				
-4.00%	-2.00%	7487+80	-2.00%	-2.00%	-4.00%		
-4.00%	-2.00%	7488+00	-	-	-2.40%		
-4.00%	-2.00%	7488+30	-	-	-3.00%		
-4.00%	-2.00%	7488+50	-	-	-3.40%		
-4.00%	-2.00%	7 <i>488</i> +80	-	-	-4.00%		
NORMAL CROWN							
-4.00%	-2.00%	7499+50	-	-	-4.00%		
-2.00%	-2.00%	7500+00	-	-	-2.00%		
-2.00%	-2.00%	7501+00	-	-	-2.00%		
-4.00%	-0.30%	7501+50	-	-	-4.00%		
-4.00%	1.40%	7502+00	-	-	-4.00%		
-4.00%	2.00%	7502+17 . 65	-	-	-4.00%		
-2.90%	3.10%	7502+50	-	-	-4.00%		
-2.00%	4.00%	7502+76 . 47	-	-	-4.00%		
-2.00%	4.80%	7503+00	-	-	-4.00%		
FULL SUPER							
-2.00%	4.80%	7510+50	-	-	-4.80%		
-2.00%	4.10%	7511+00	-	-	-4.10%		
-2.00%	4.00%	7511+07.14	-	-	-4.00%		
-4.00%	3.40%	75//•50	-	-	-4.00%		
-4.00%	2.70%	7512+00	-	-	-4.00%		
-4.00%	2.00%	7512+50	-	-	-4.00%		
REMOVE CROWN							
-4.00%	2.00%	752I+00	-	-	-4.00%		
-2.00%	2.00%	752I+50	-	-	-4.00%		
0.00%	2.00%	7522+00	-	-	-4.00%		
2.00%	2.00%	7522+50	-	-	-4.00%		
	2.00%	7538+87 . 61	-	-	-4.00%		


NORTHBOUND CASH B SUPERELEVATION TABLE

LEFT	STATION	RIGHT	RIGHT
SHOULDER		TRAVELWAY	SHOULDER
2.00%	8498+50	-2.00%	-4.00%
0.00%	8499+00	0.00%	-4.00%
0.00%	8500+00	0.00%	-4.00%
2.00%	8500+50	-2.00%	-4.00%


EXIT 51 NB ON RAMP B SUPERELEVATION TABLE

LEFT	STATION	RIGHT	RIGHT				
SHOULDER		TRAVELWAY	SHOULDER				
MATCH EXISTING							
-1.90%	3.00%	886+00	-5.00%				
-2.00%	3.80%	886+50	-4.60%				
-2.00%	4.60%	887+00	-4.60%				
FULL SUPER							
-2.00%	4.60%	888+50	-4.60%				
0.00%	4.60%	889+00	-4.60%				
-	4.60%	889+50	4.60%				
-	3.30%	7490+00×	-4.00%				
-	2.00%	7490+50*	-4.00%				


^{*} NB ORT BASELINE

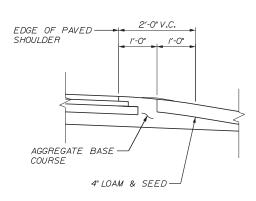


2'-0" ROUNDING DETAIL N.T.S.

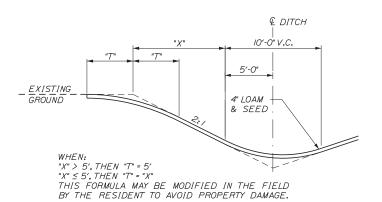

BACKSLOPE ROUNDING DETAIL

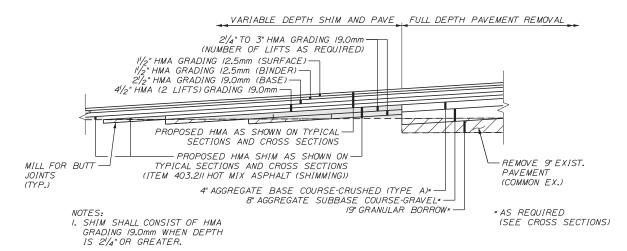

PAVEMENT SHIM TRANSITION DETAIL *N.T.S.*

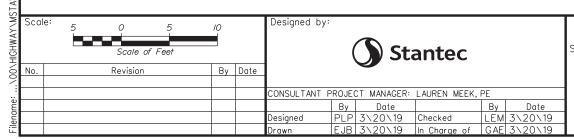

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THE GOLD STAR **MEMORIAL HIGHWAY** ORT CONVERSION


EXIT 103

TYPICAL SECTIONS 6

SHEET NUMBER: TS-6

MTA PROJECT MANAGER: RALPH NORWOOD, IV. PE, PTOE


CONTRACT:2019.04

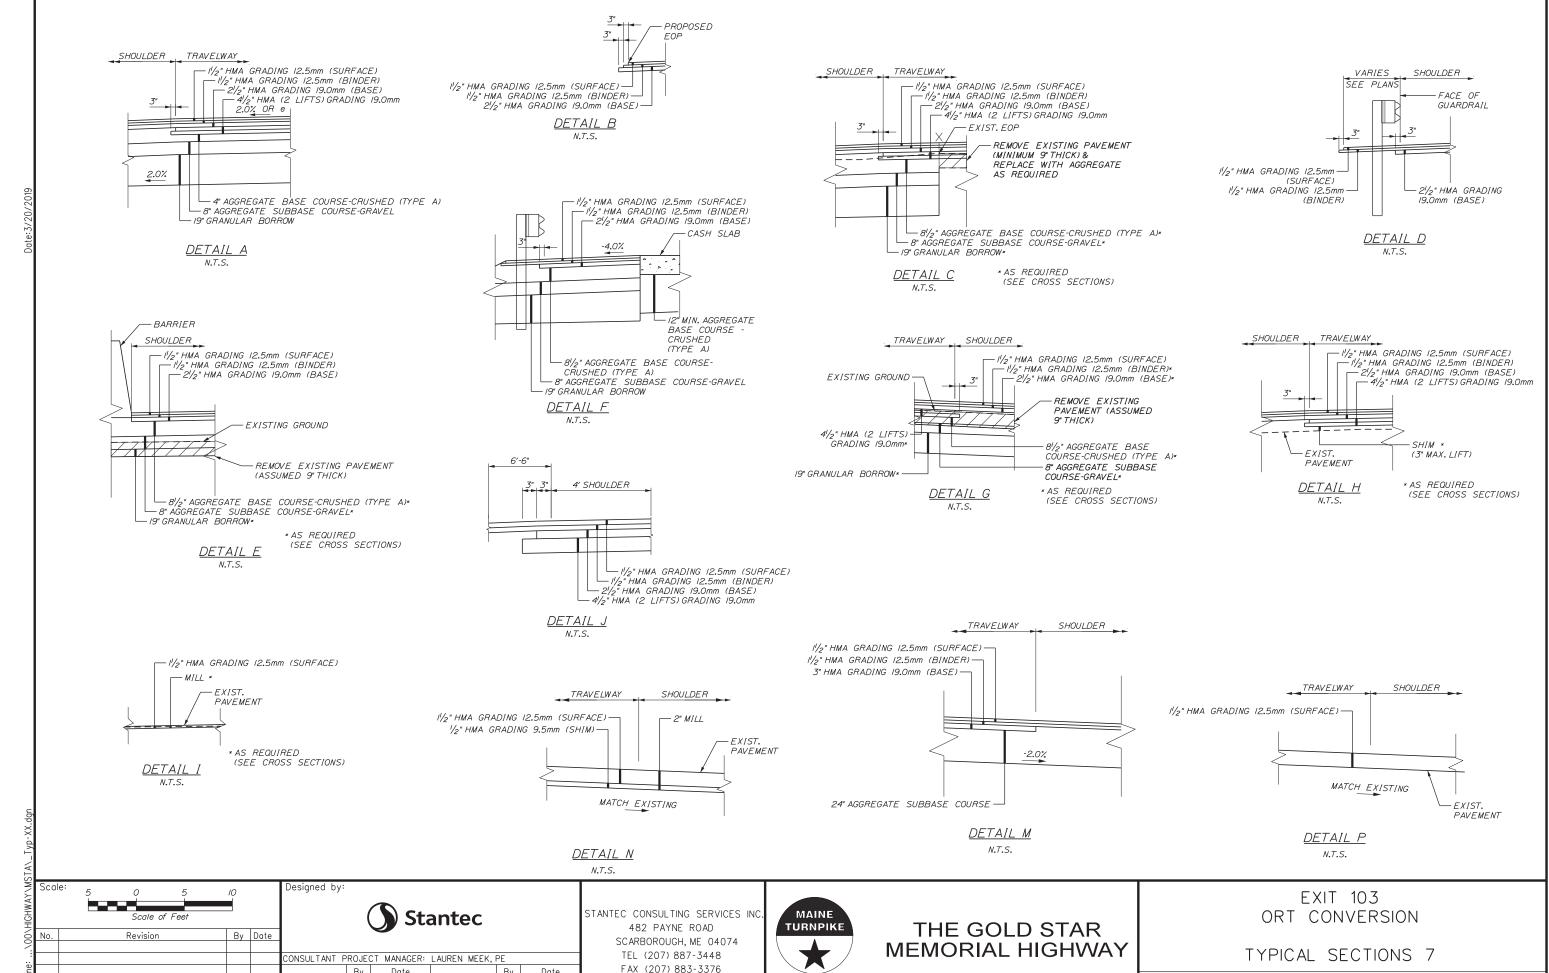



SHEET NUMBER: TS-7


MTA PROJECT MANAGER: RALPH NORWOOD, IV. PE, PTOE


CONTRACT:2019.04

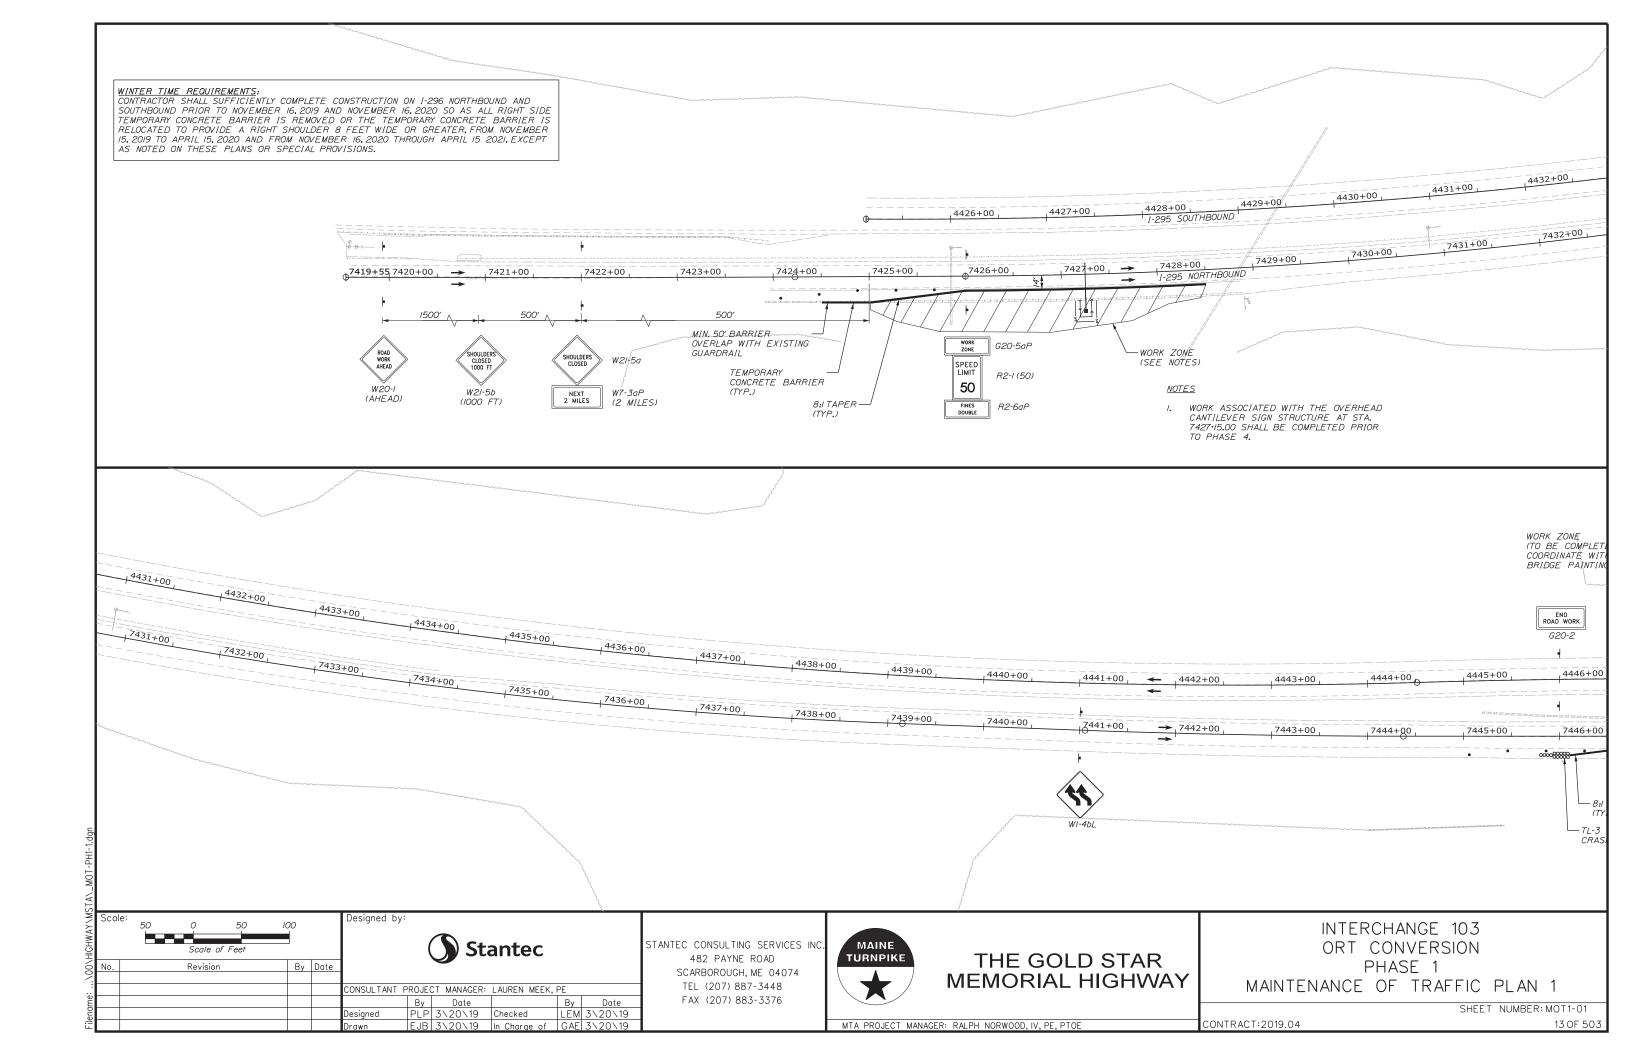


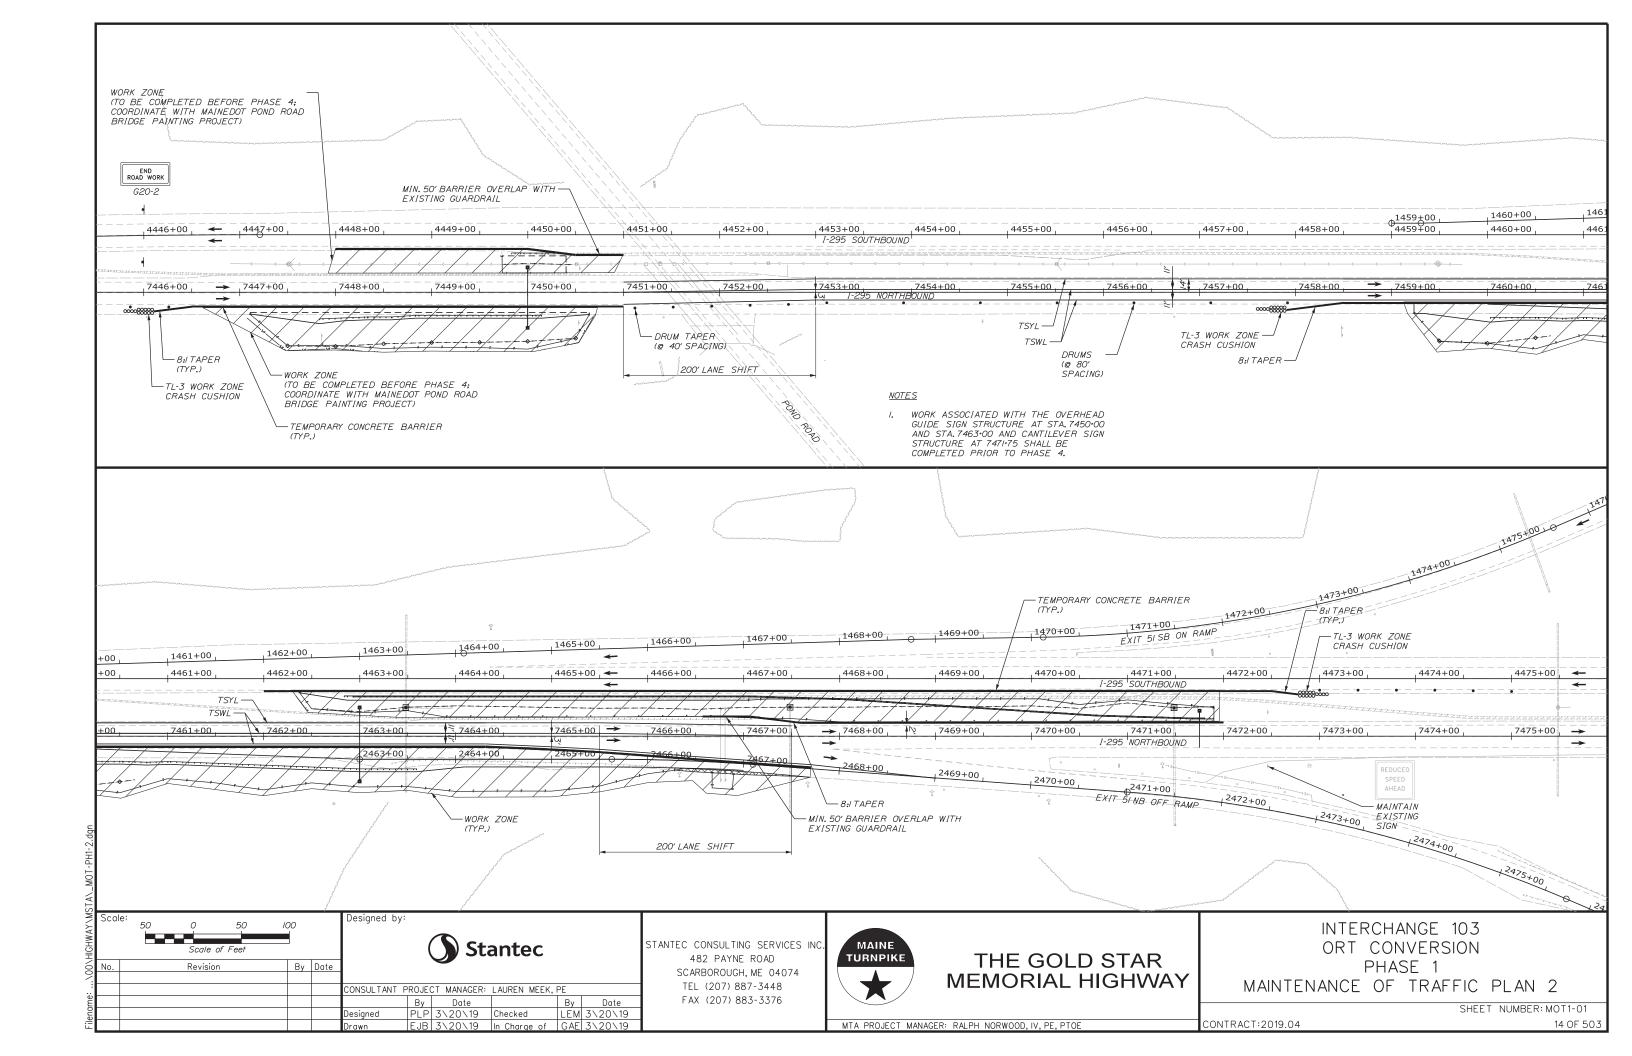


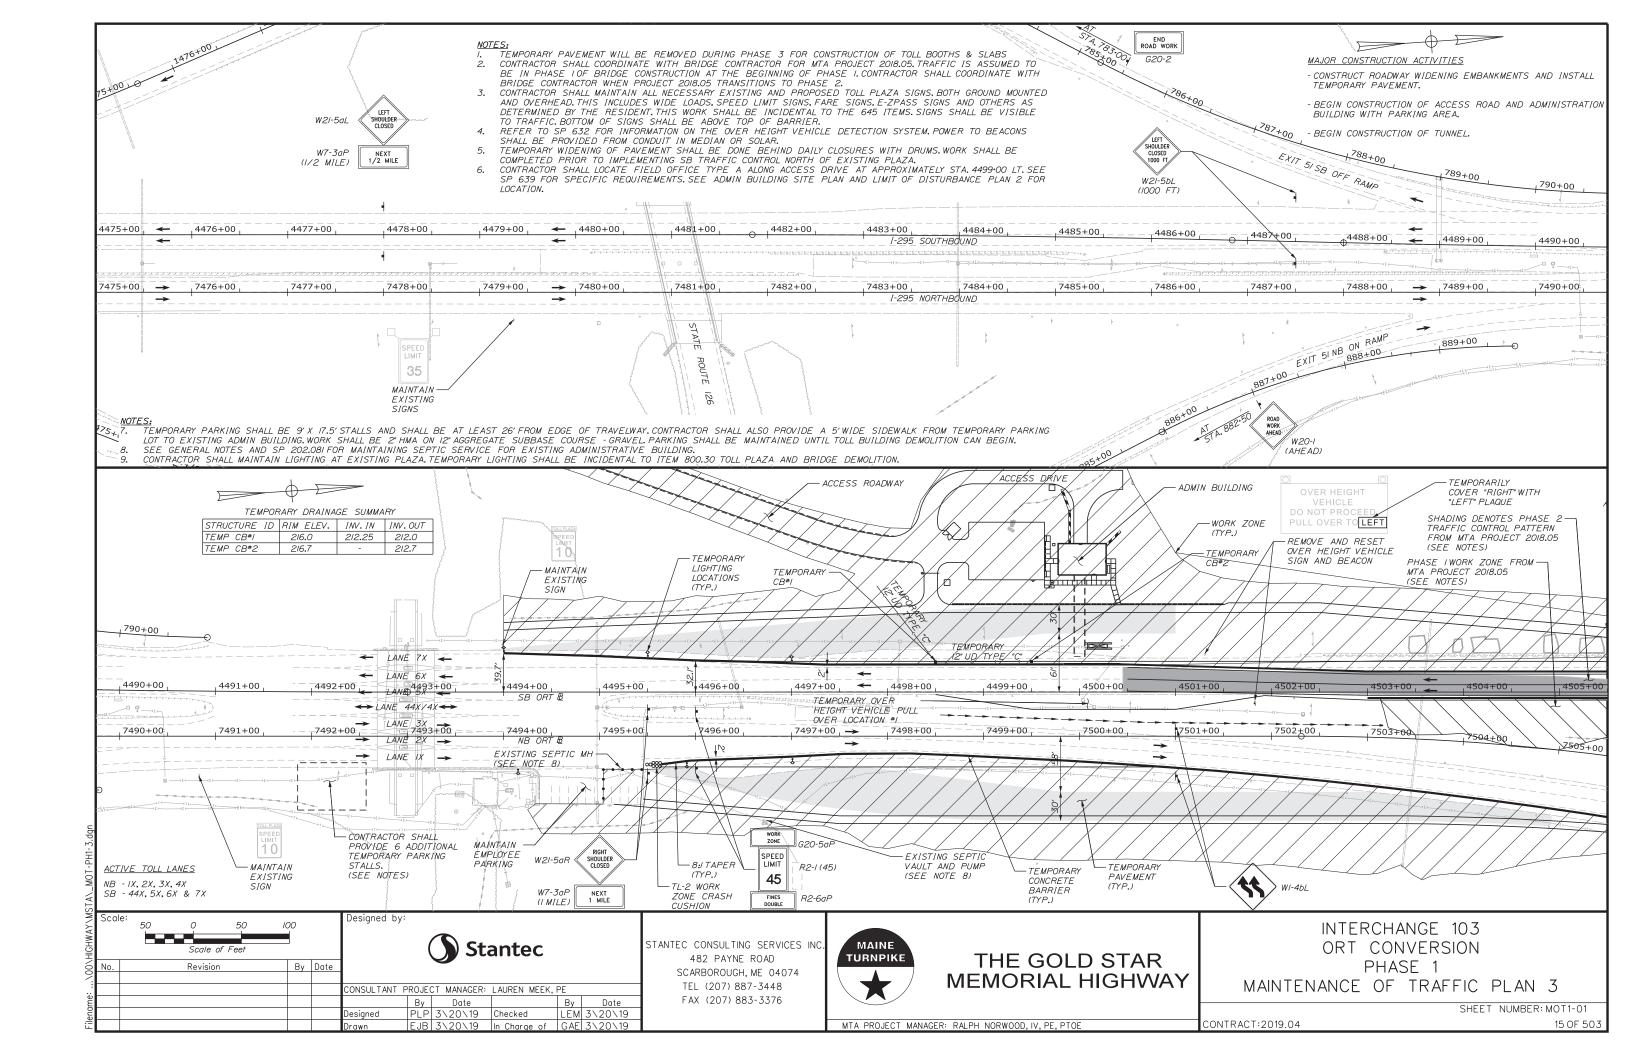


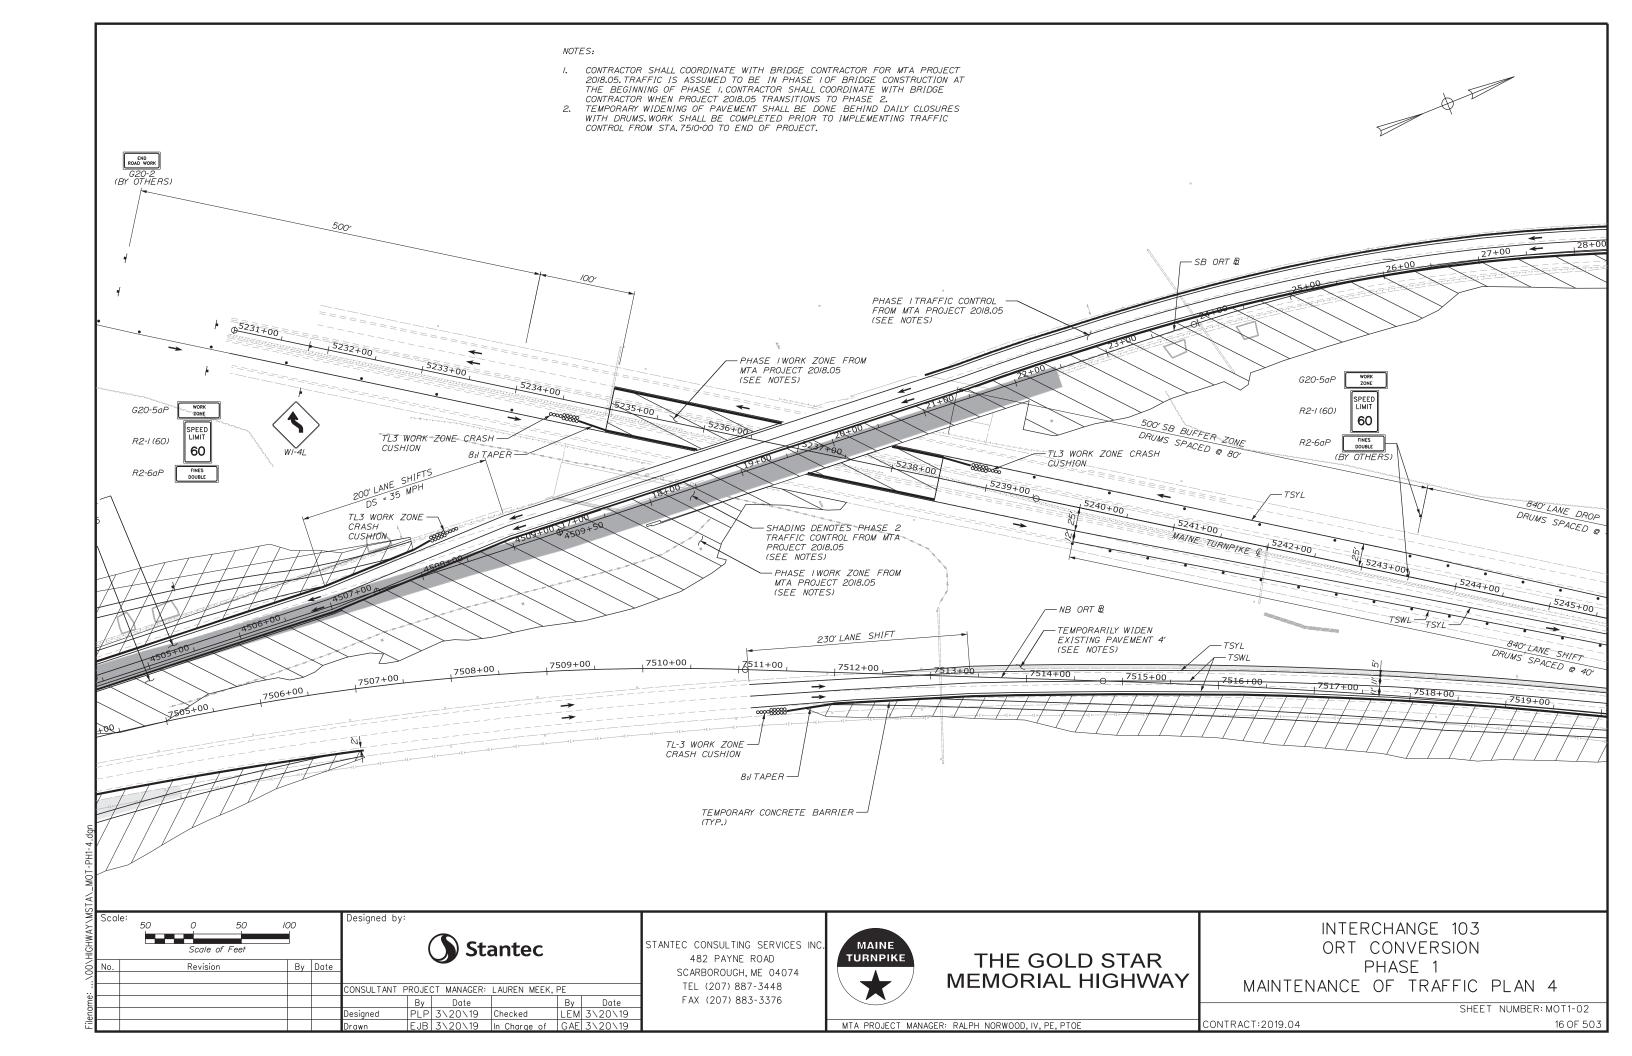


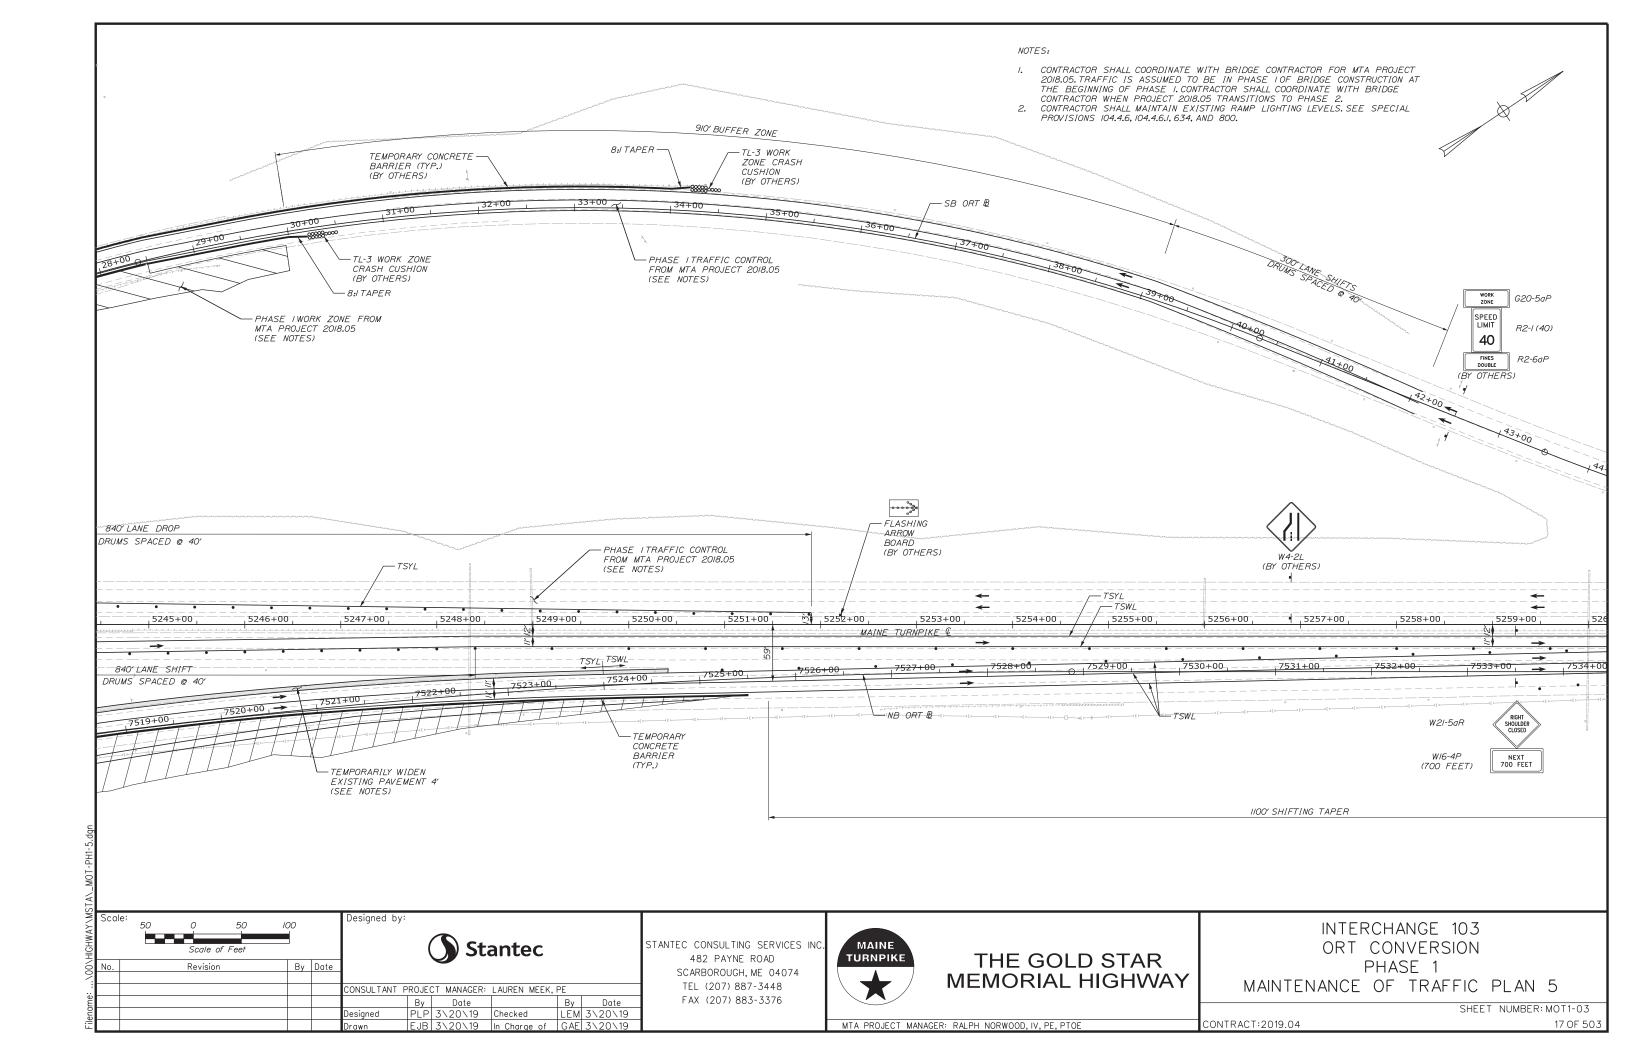


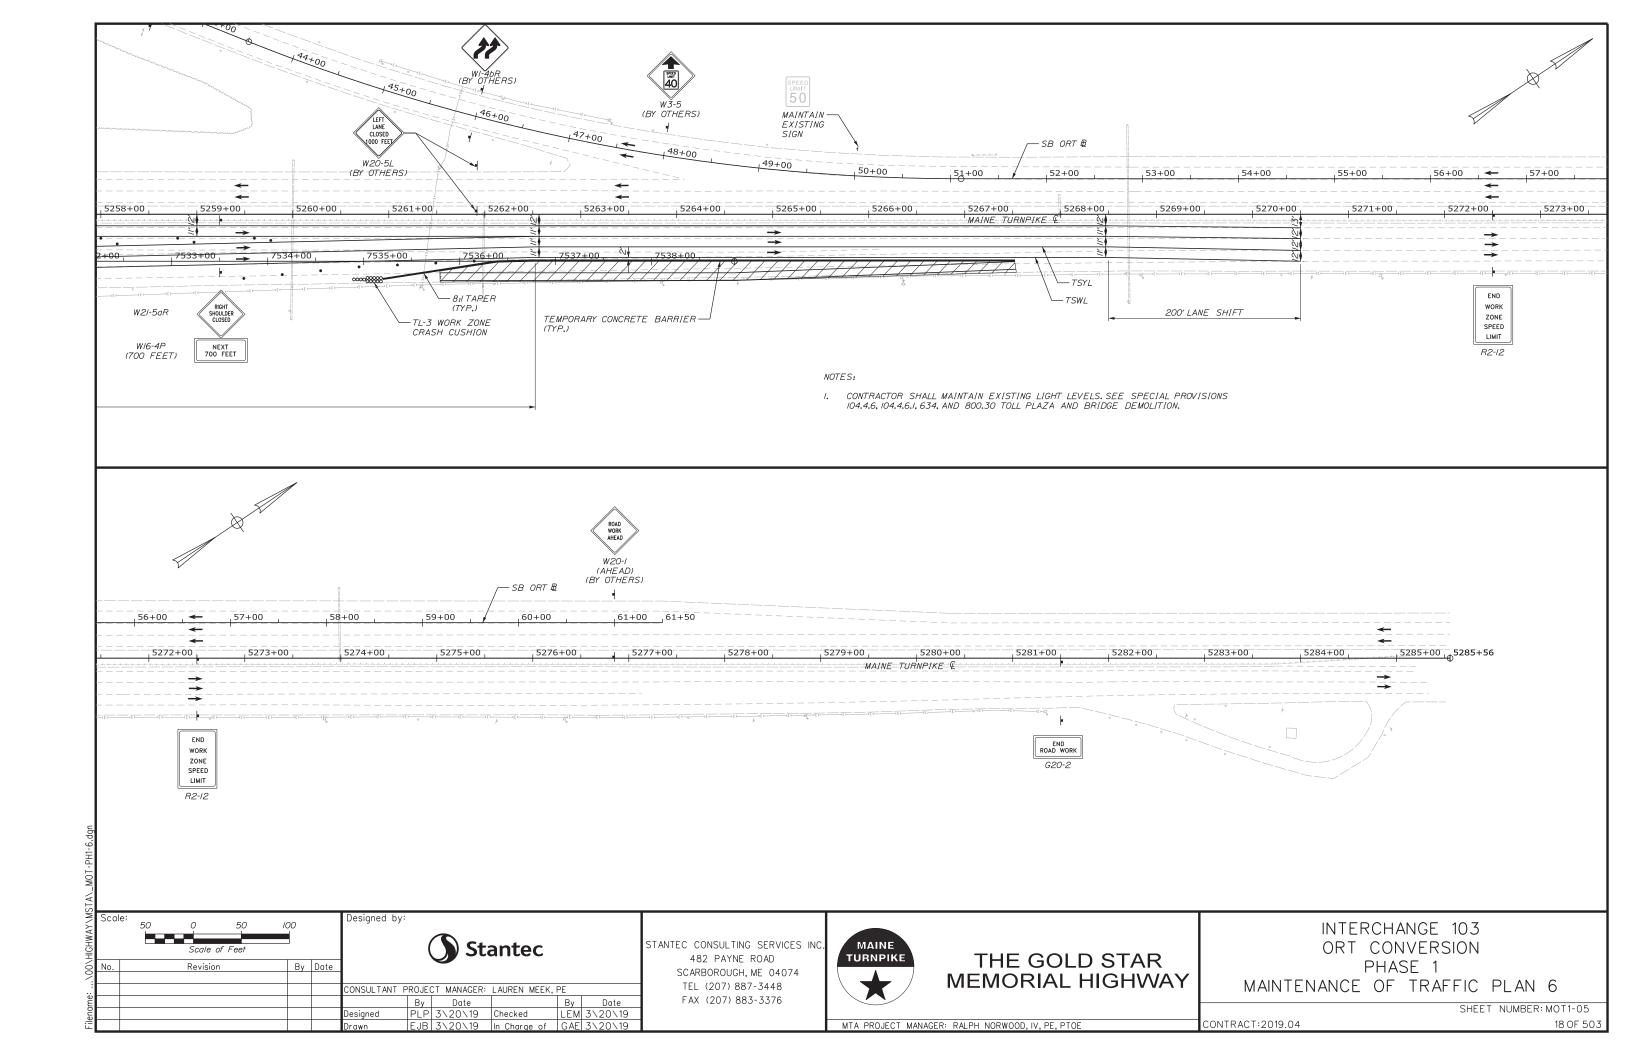


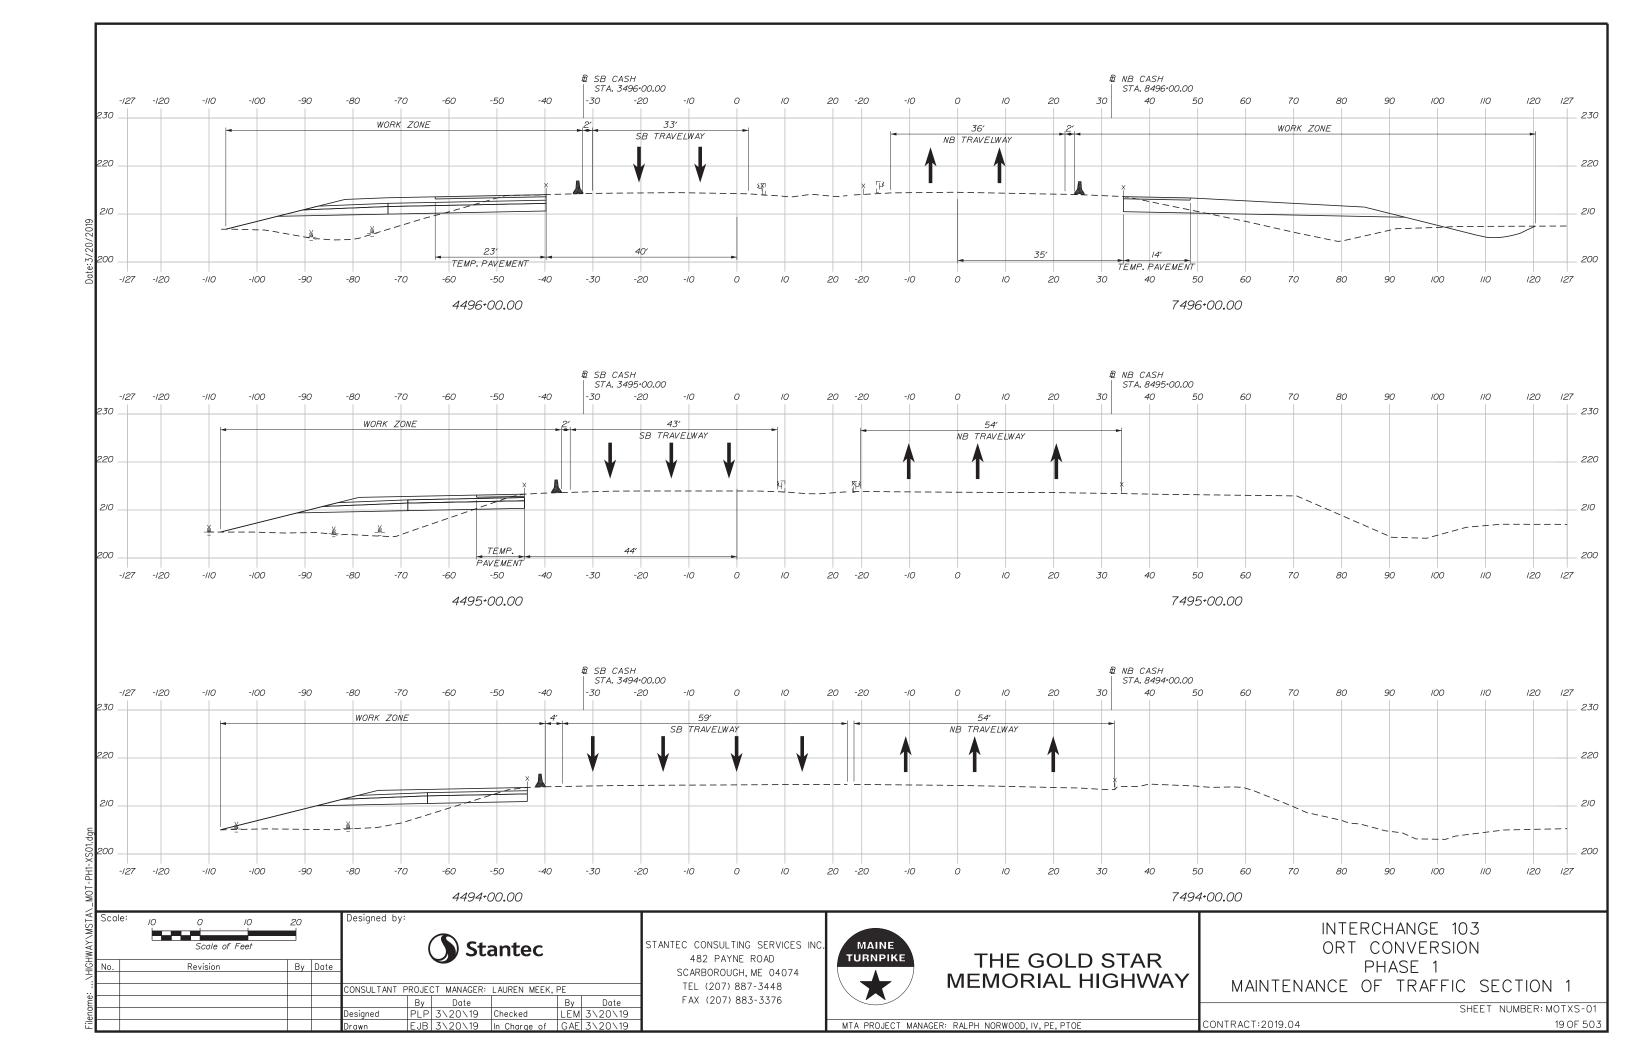


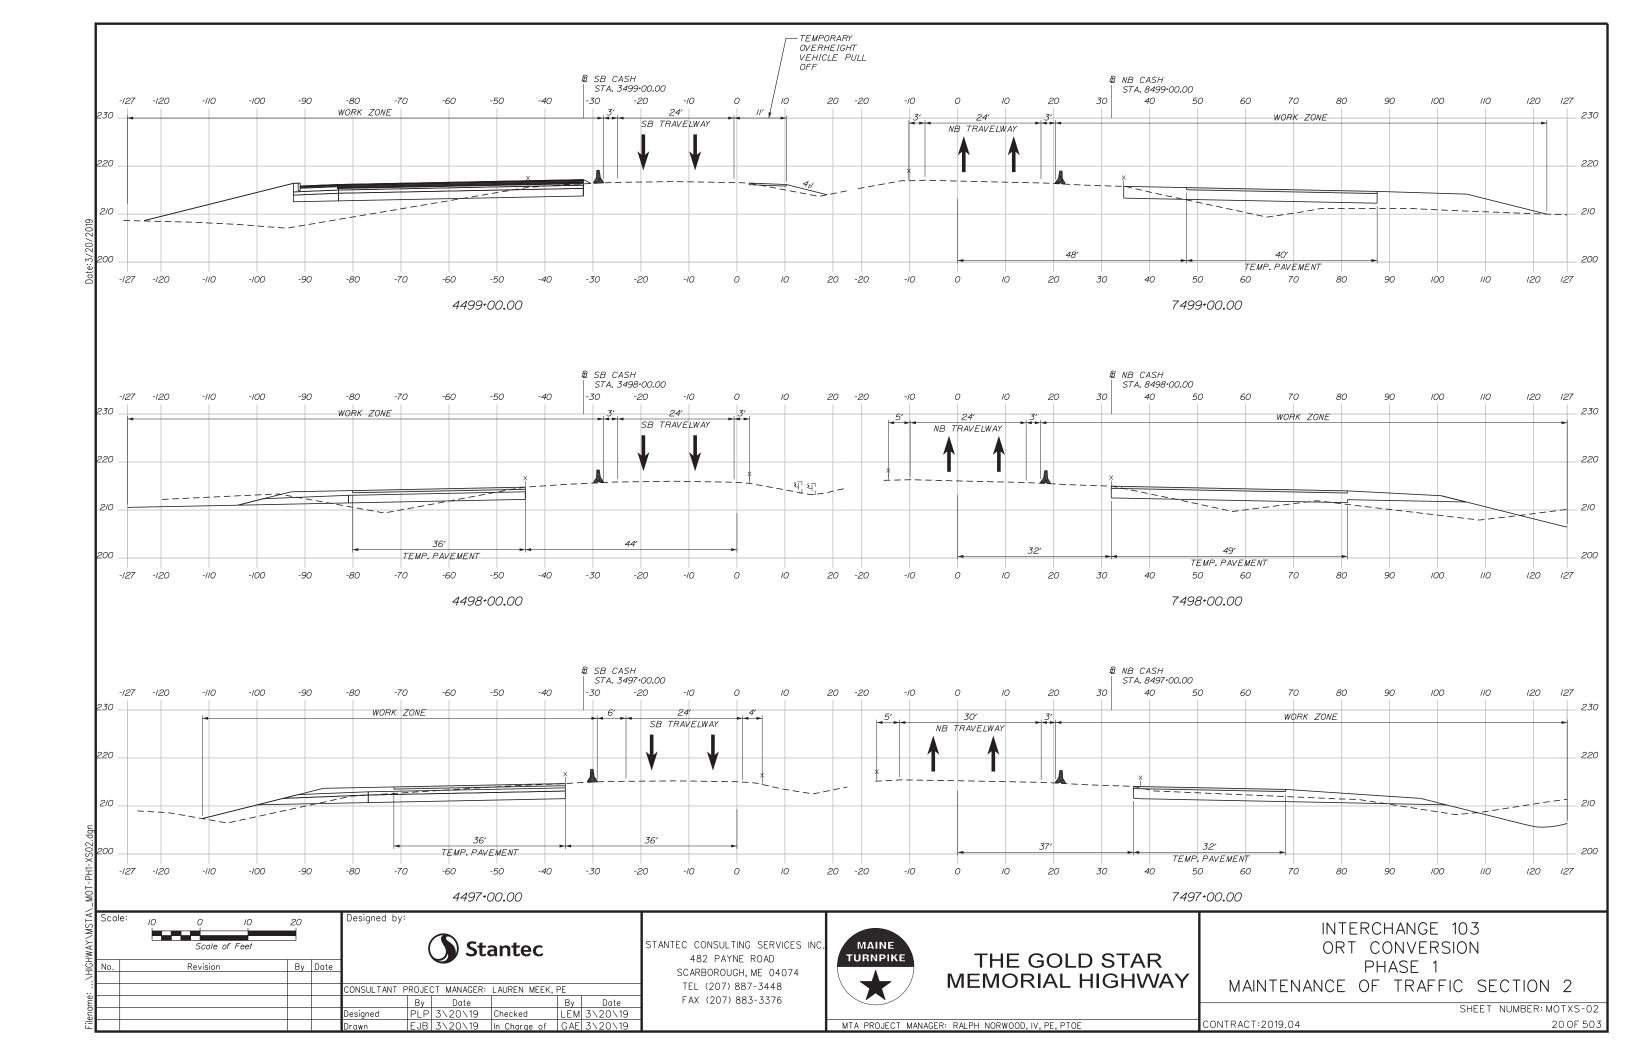


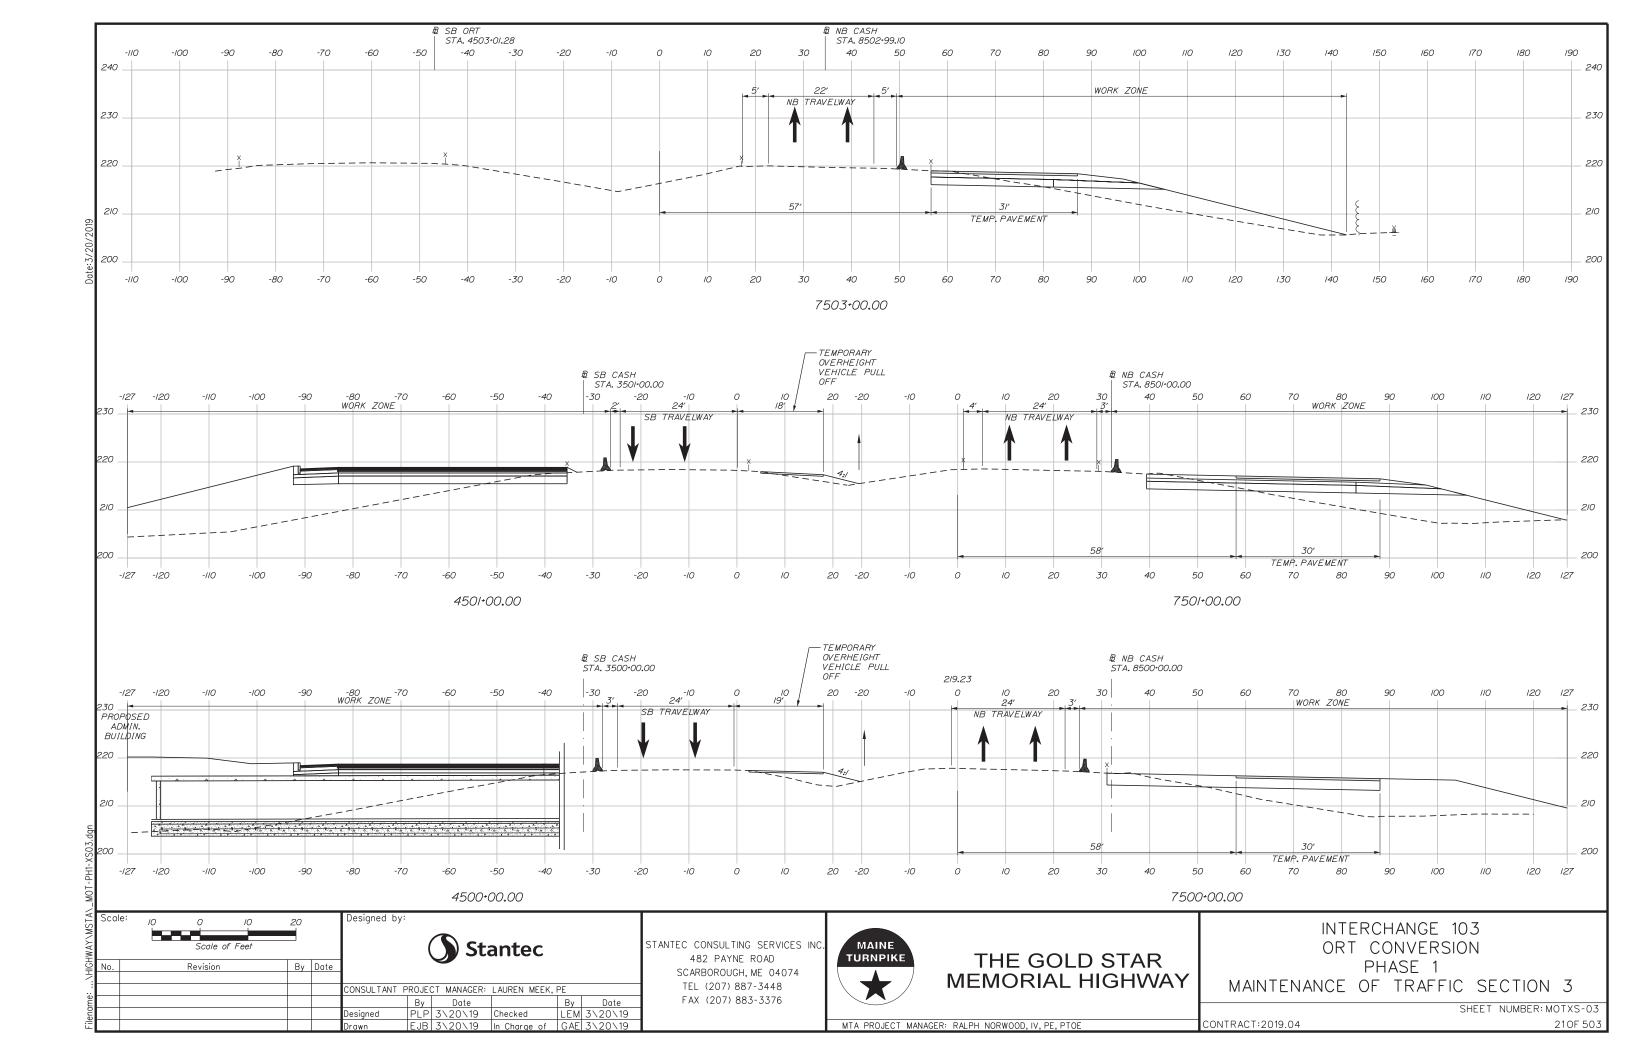


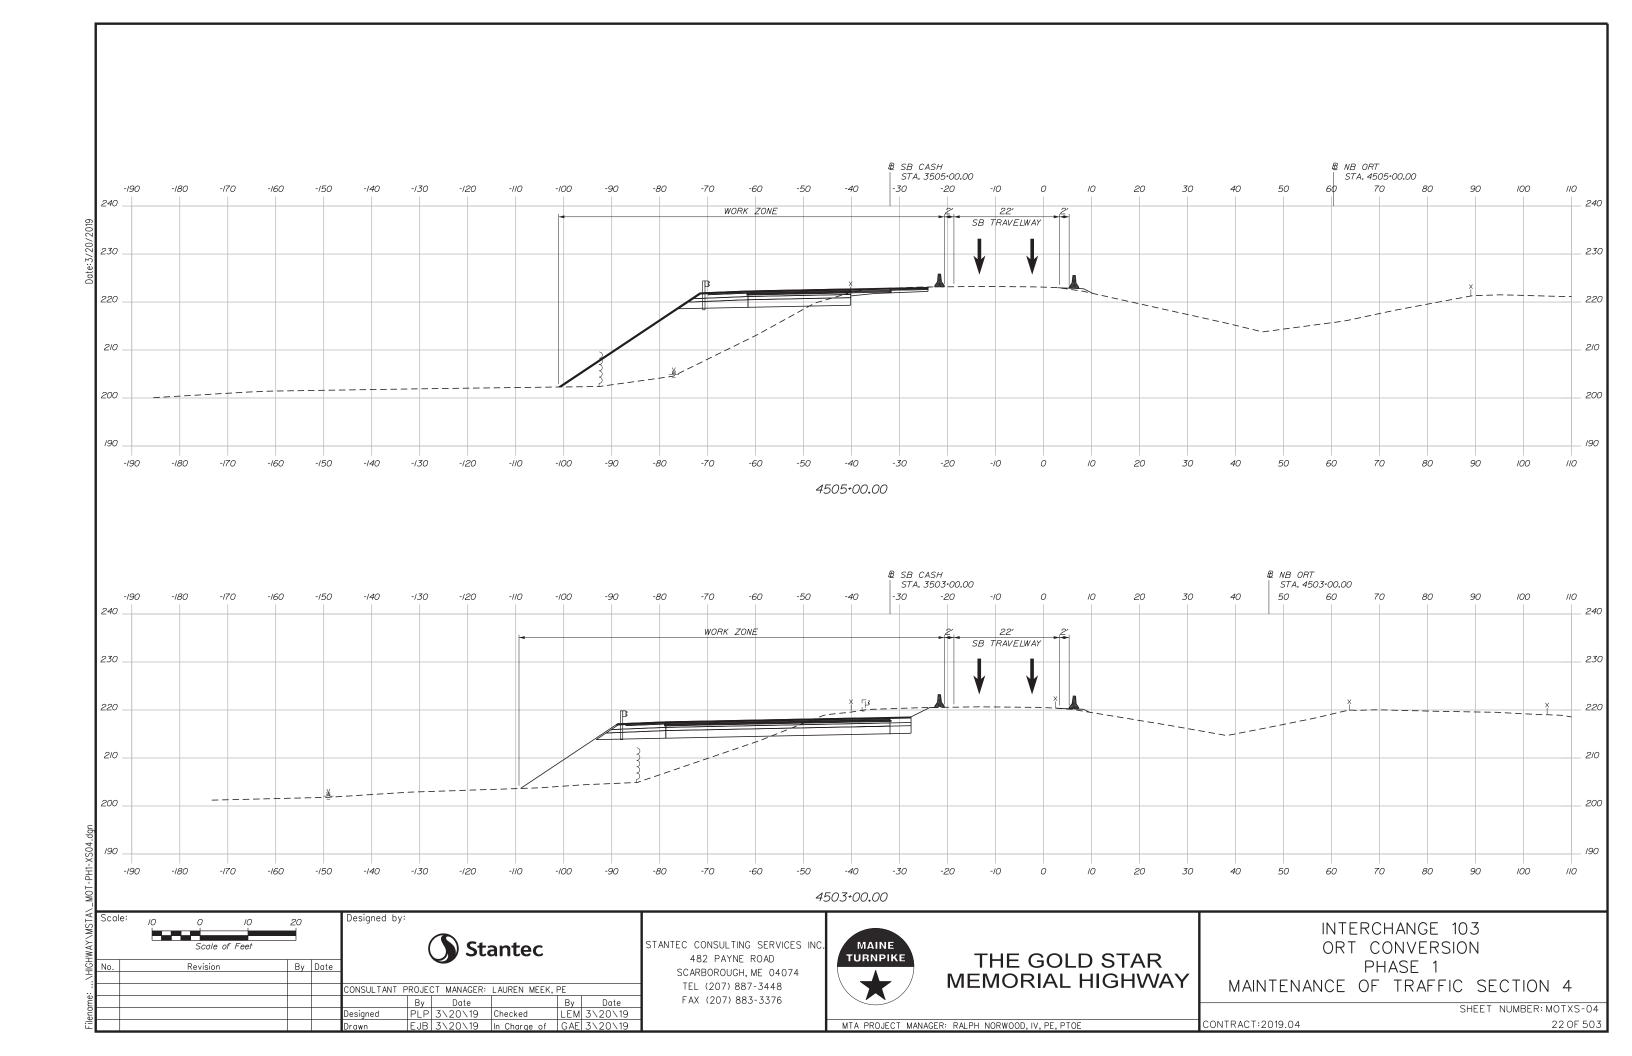


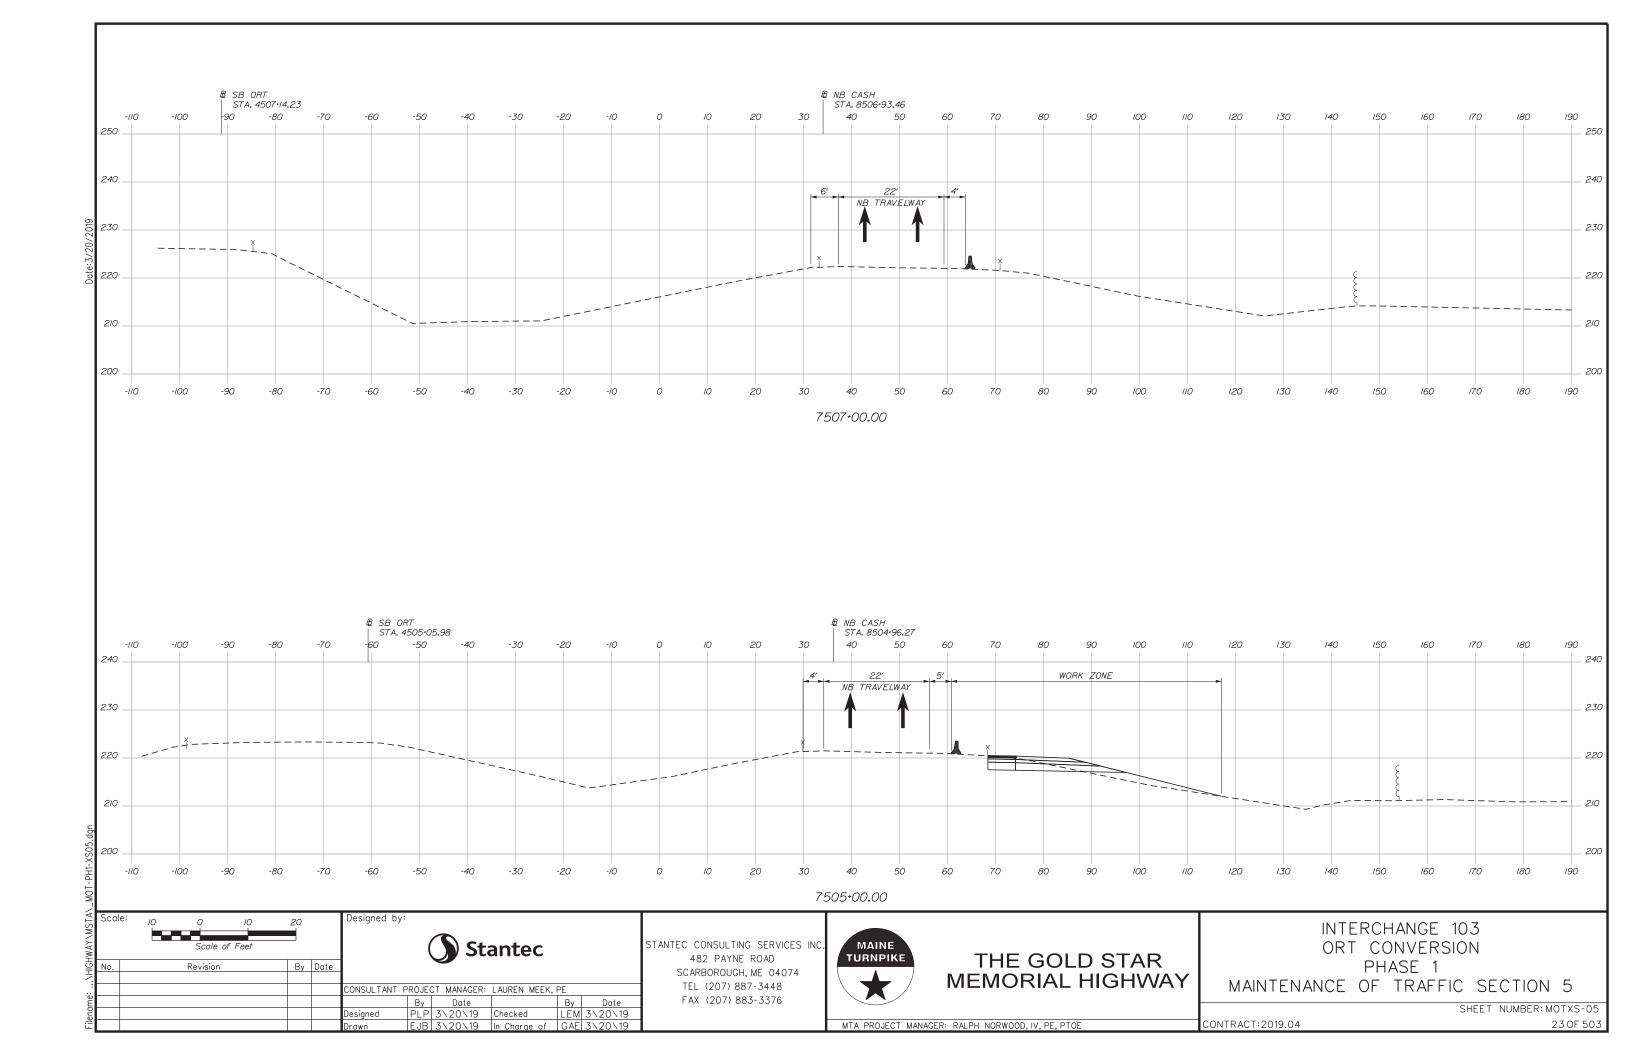


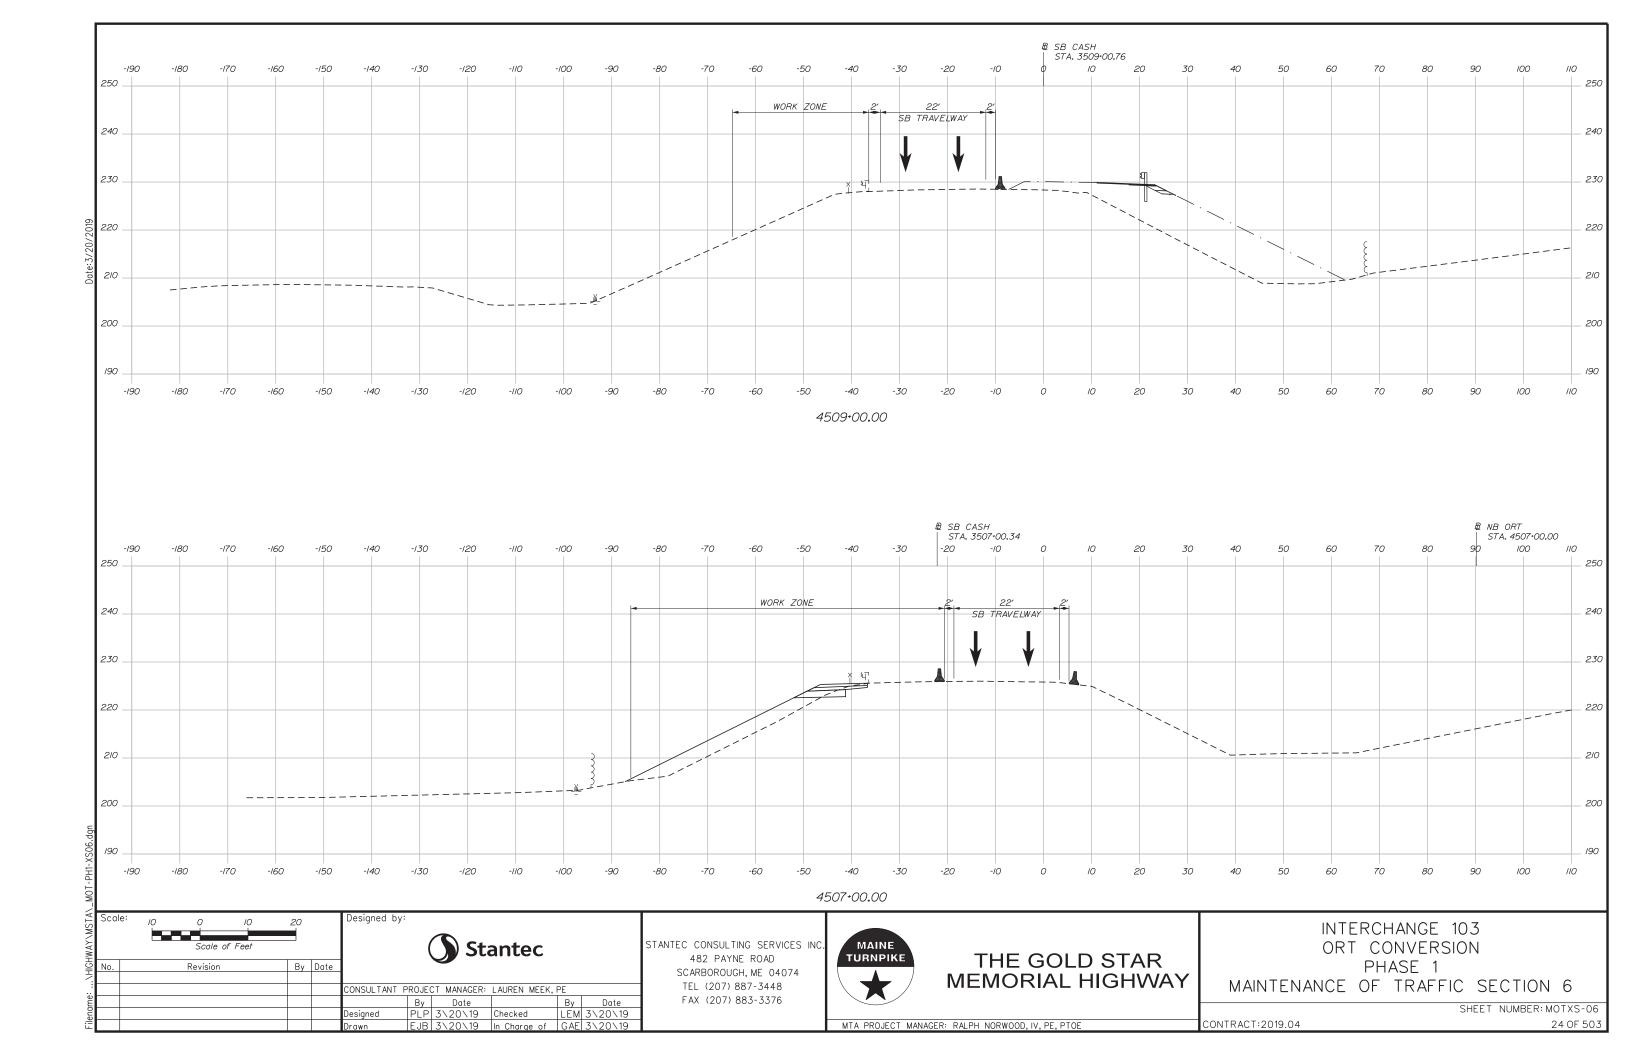


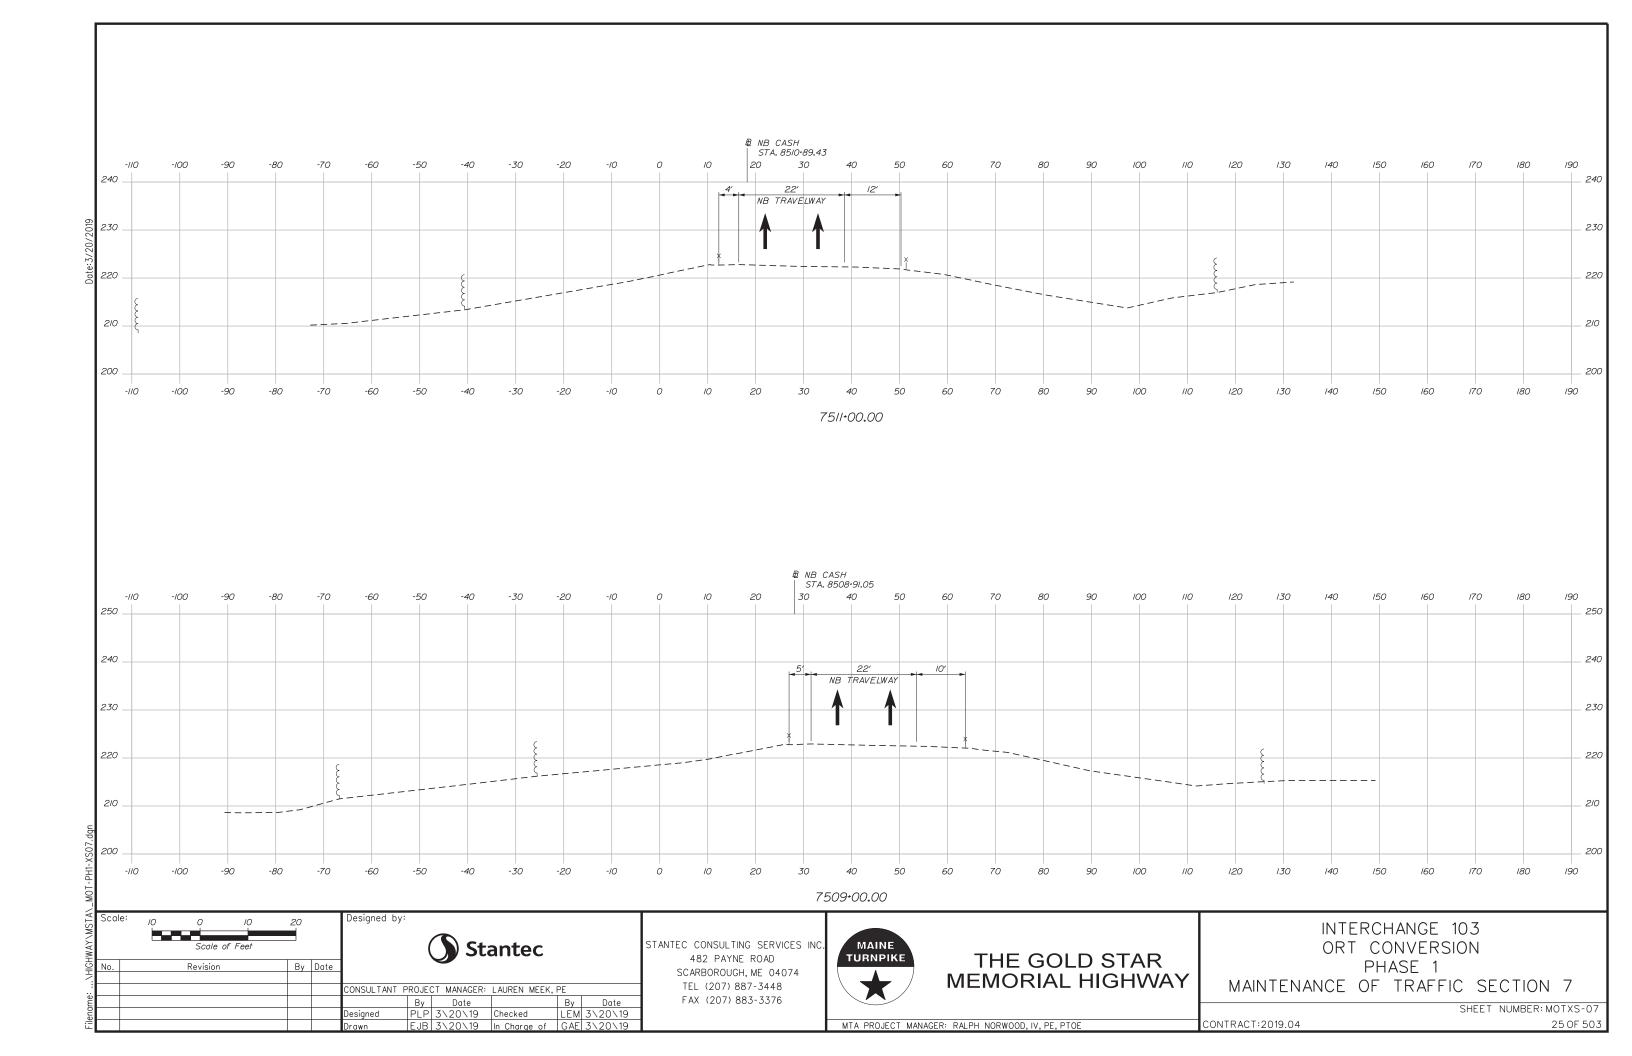


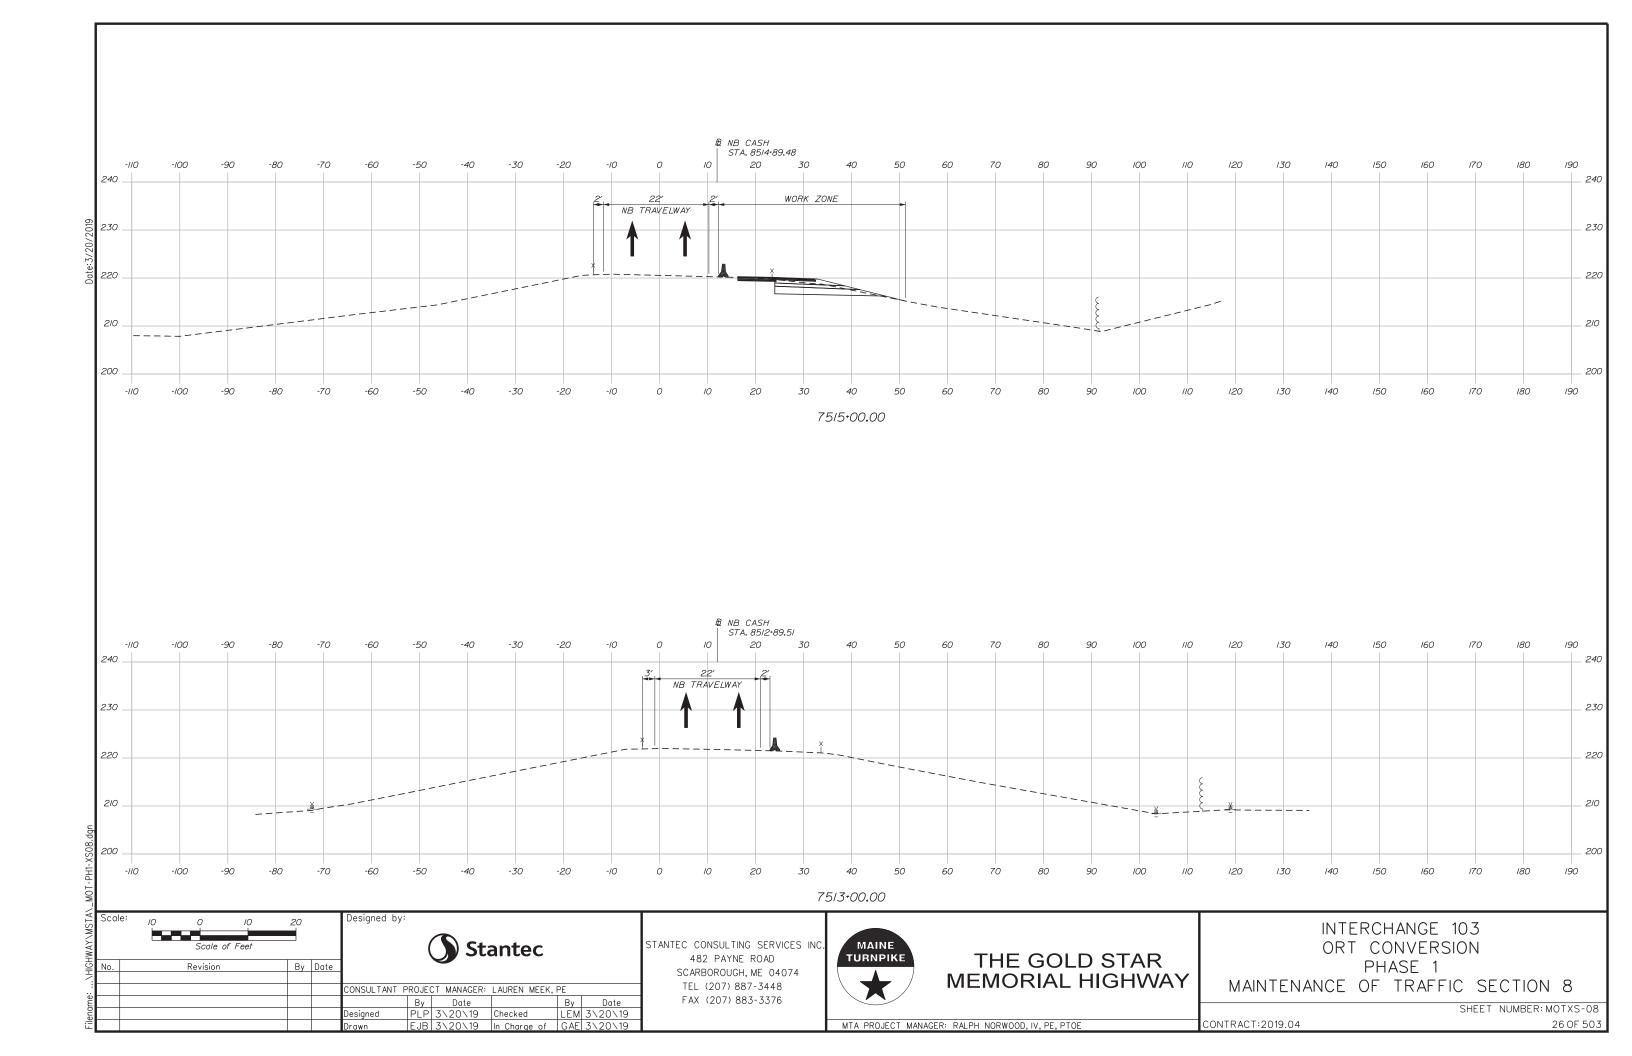


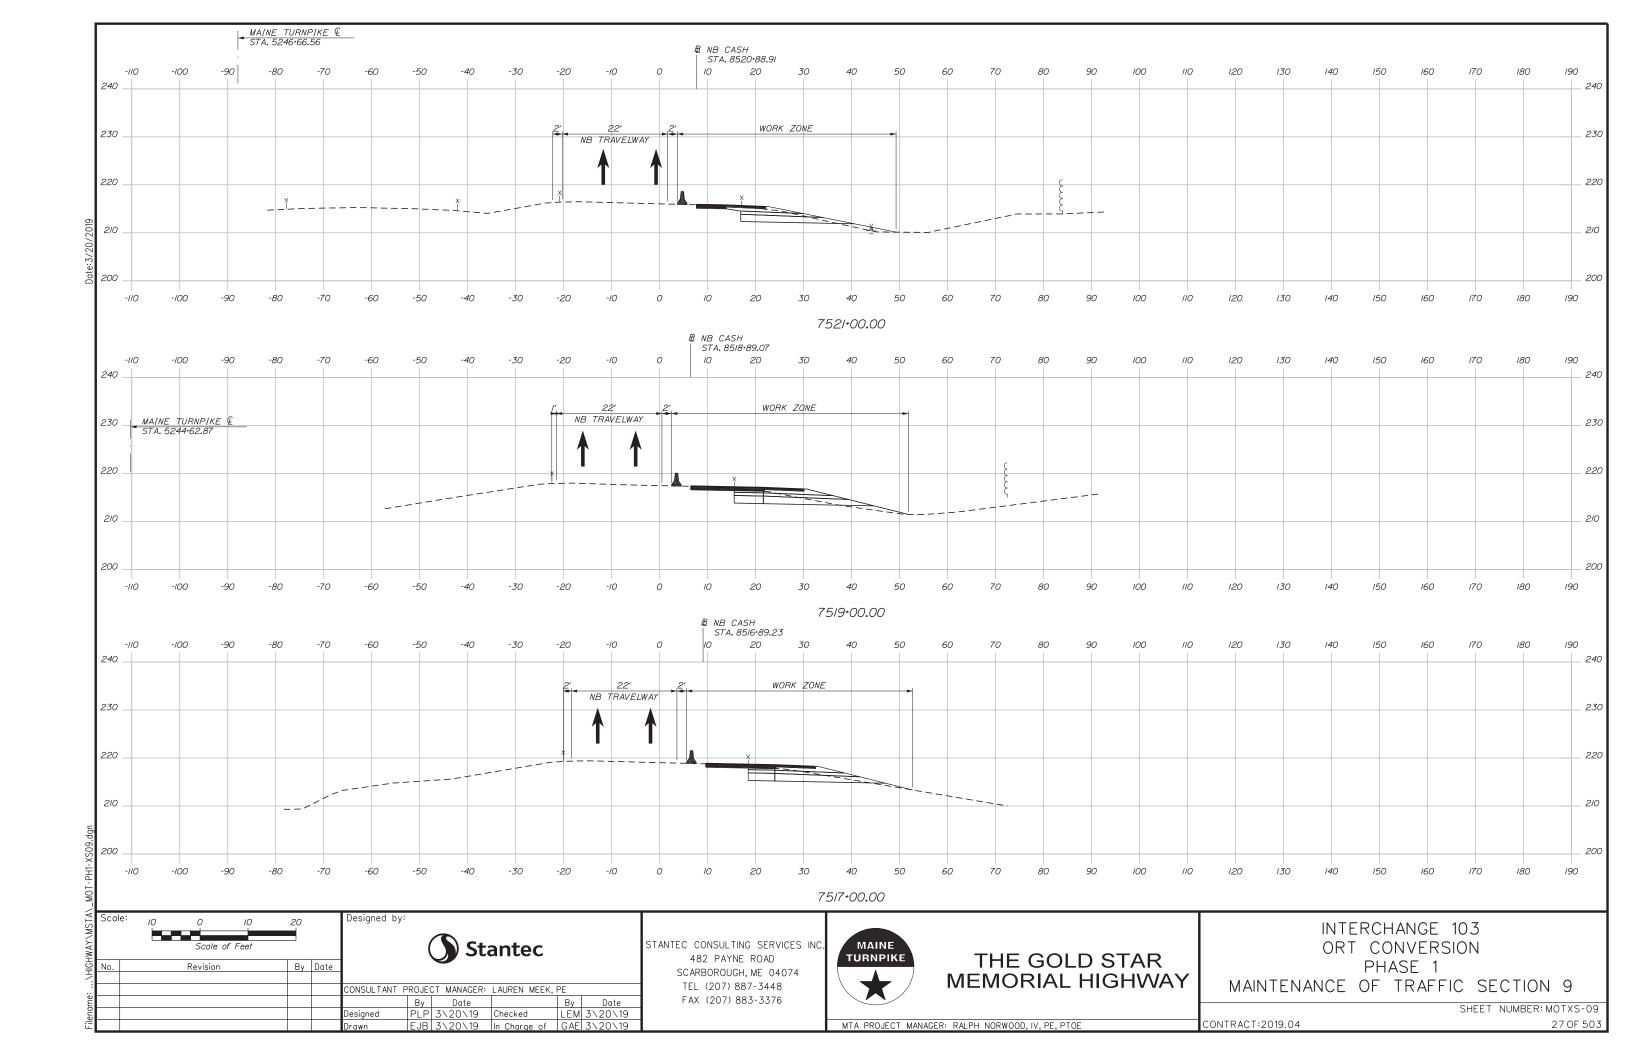


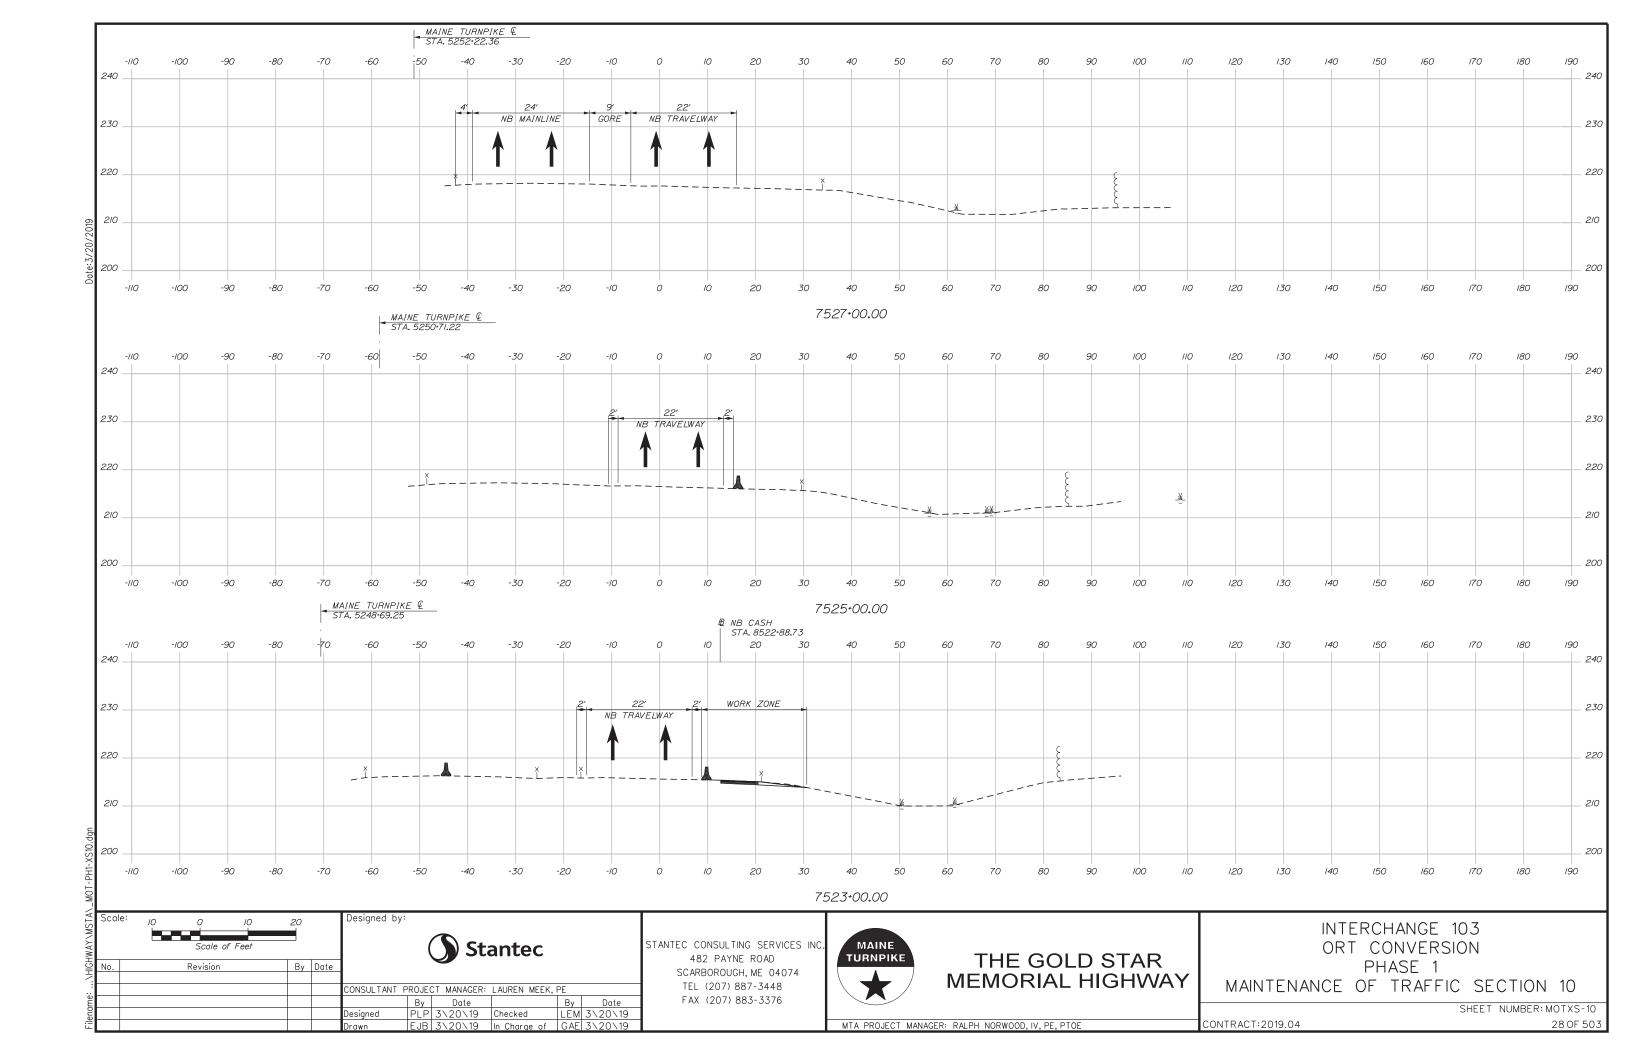


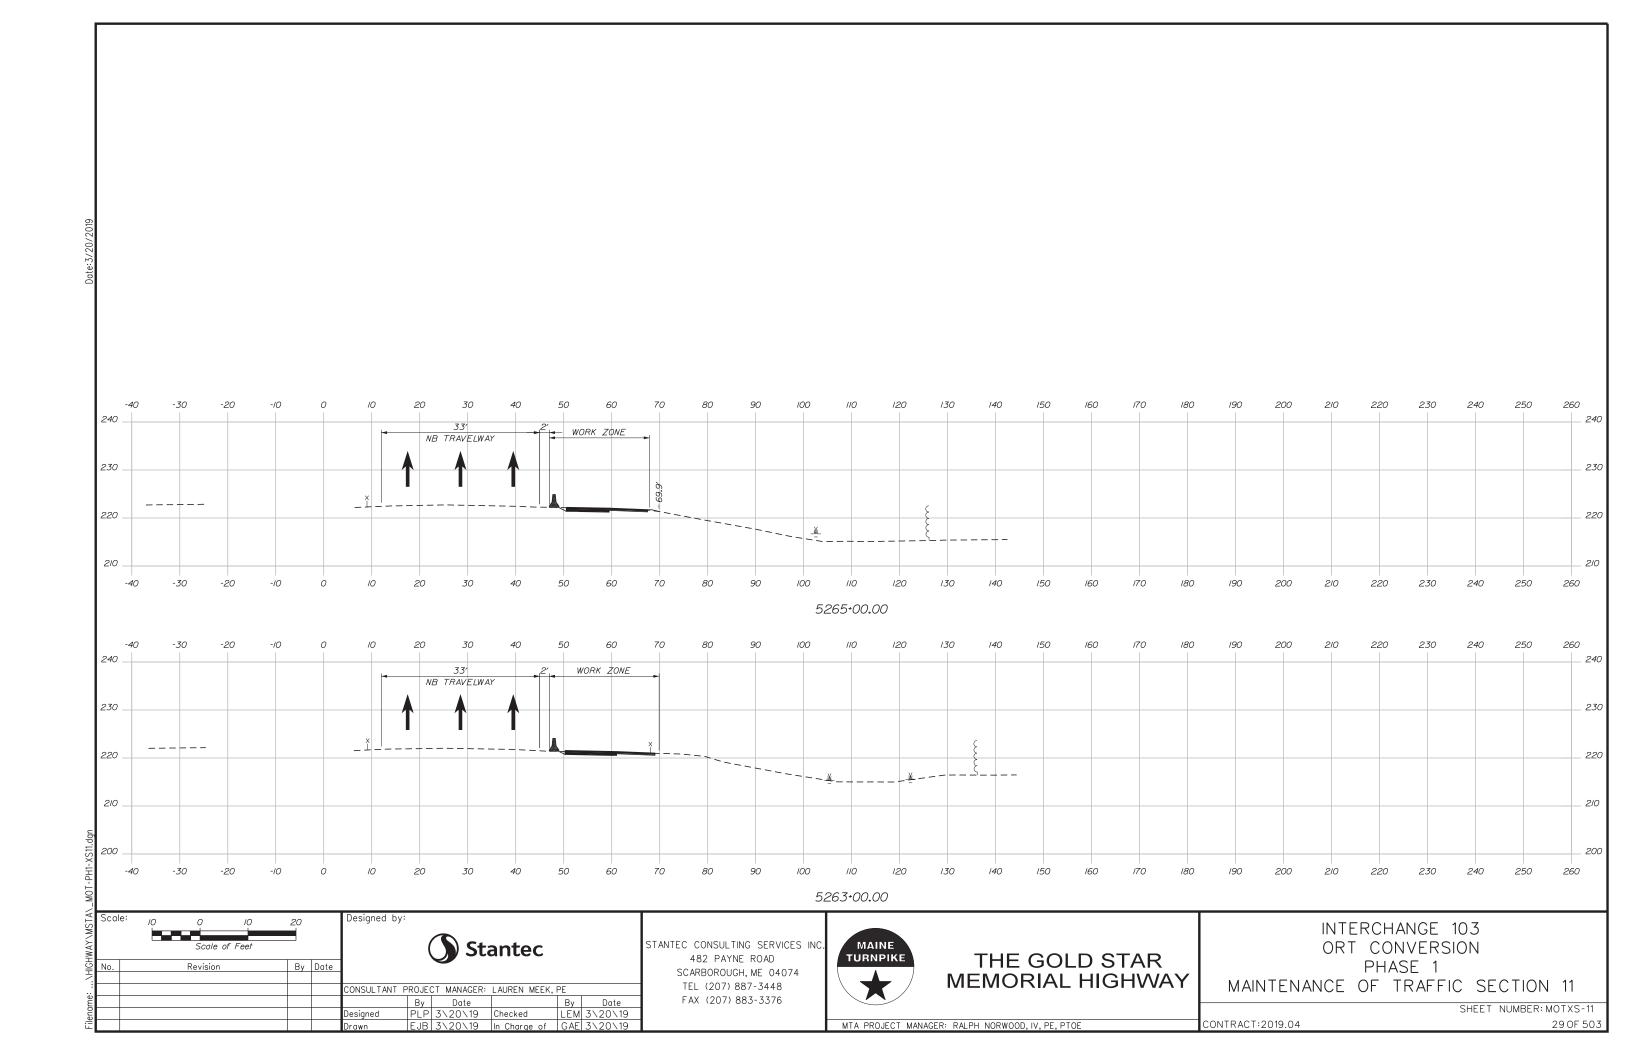


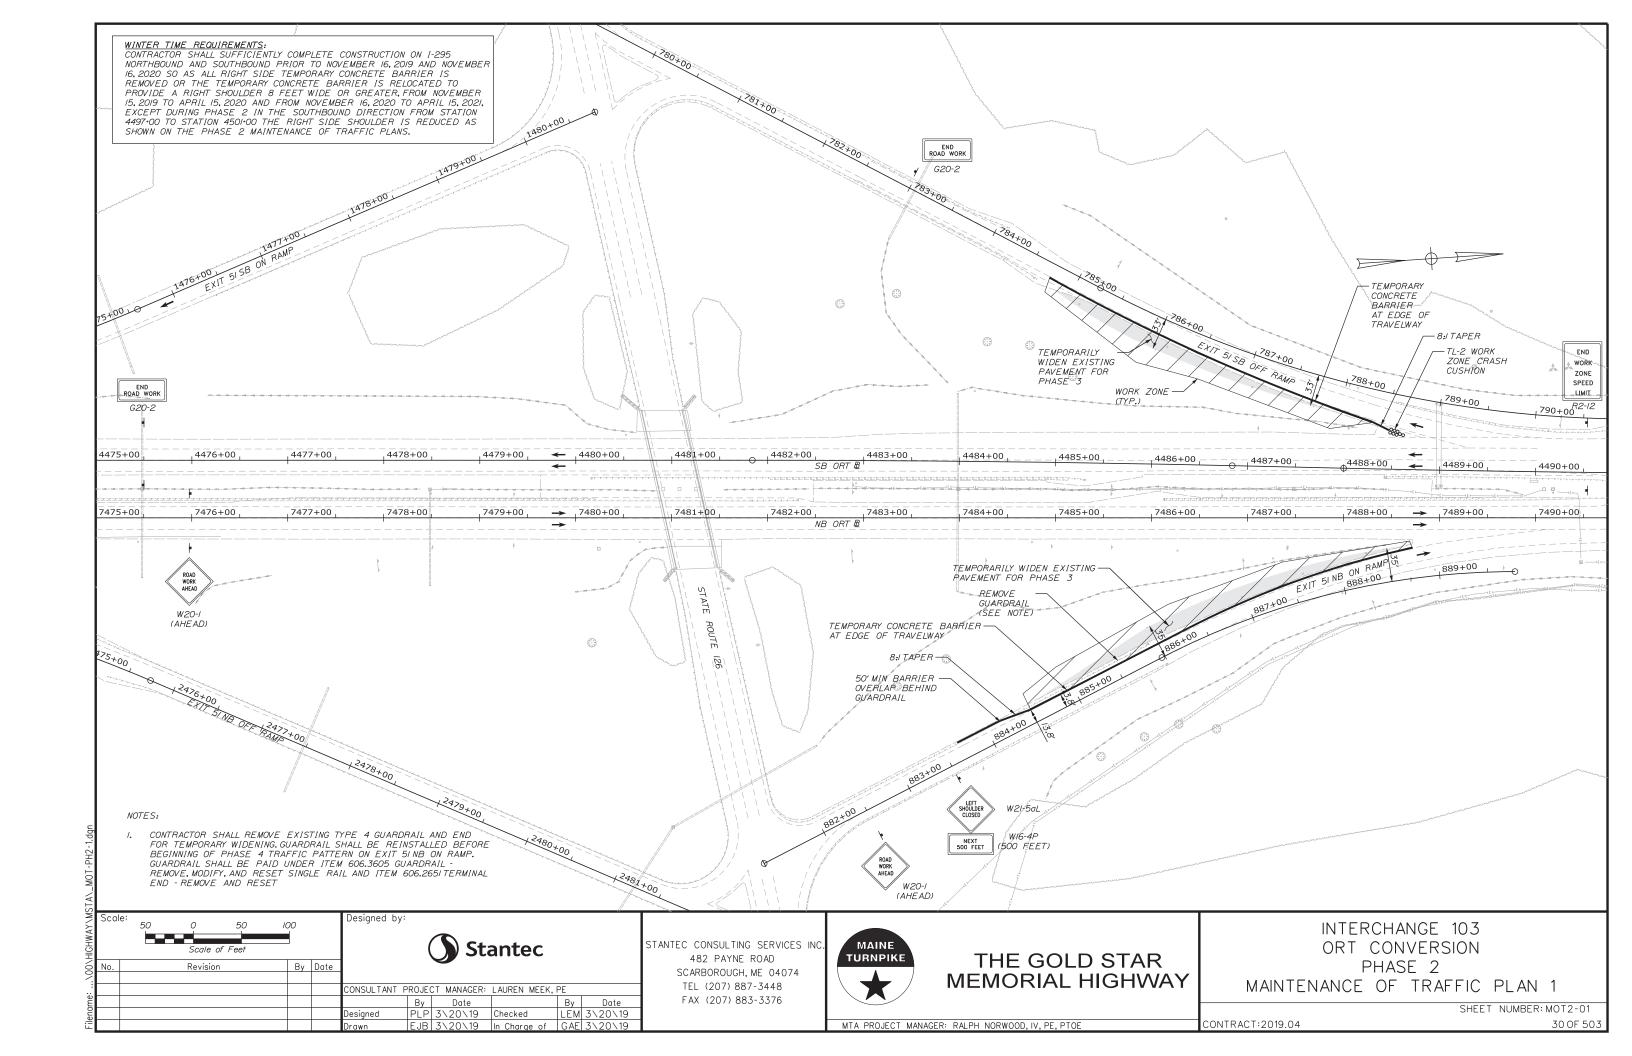


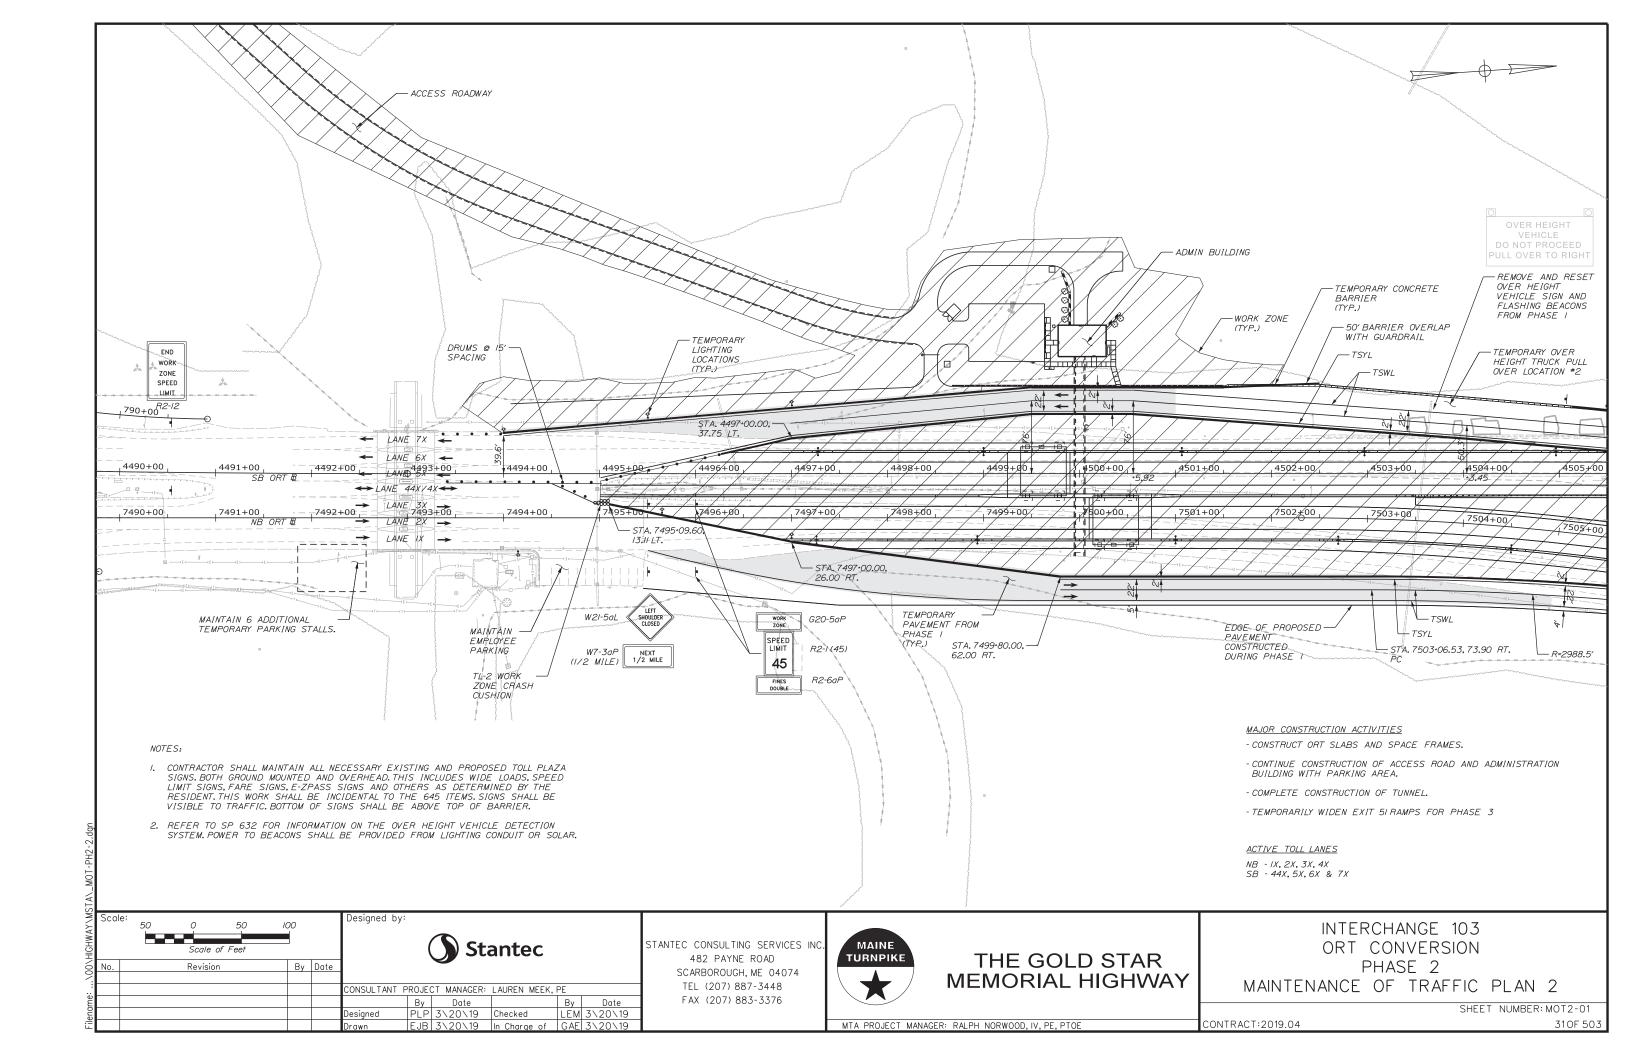


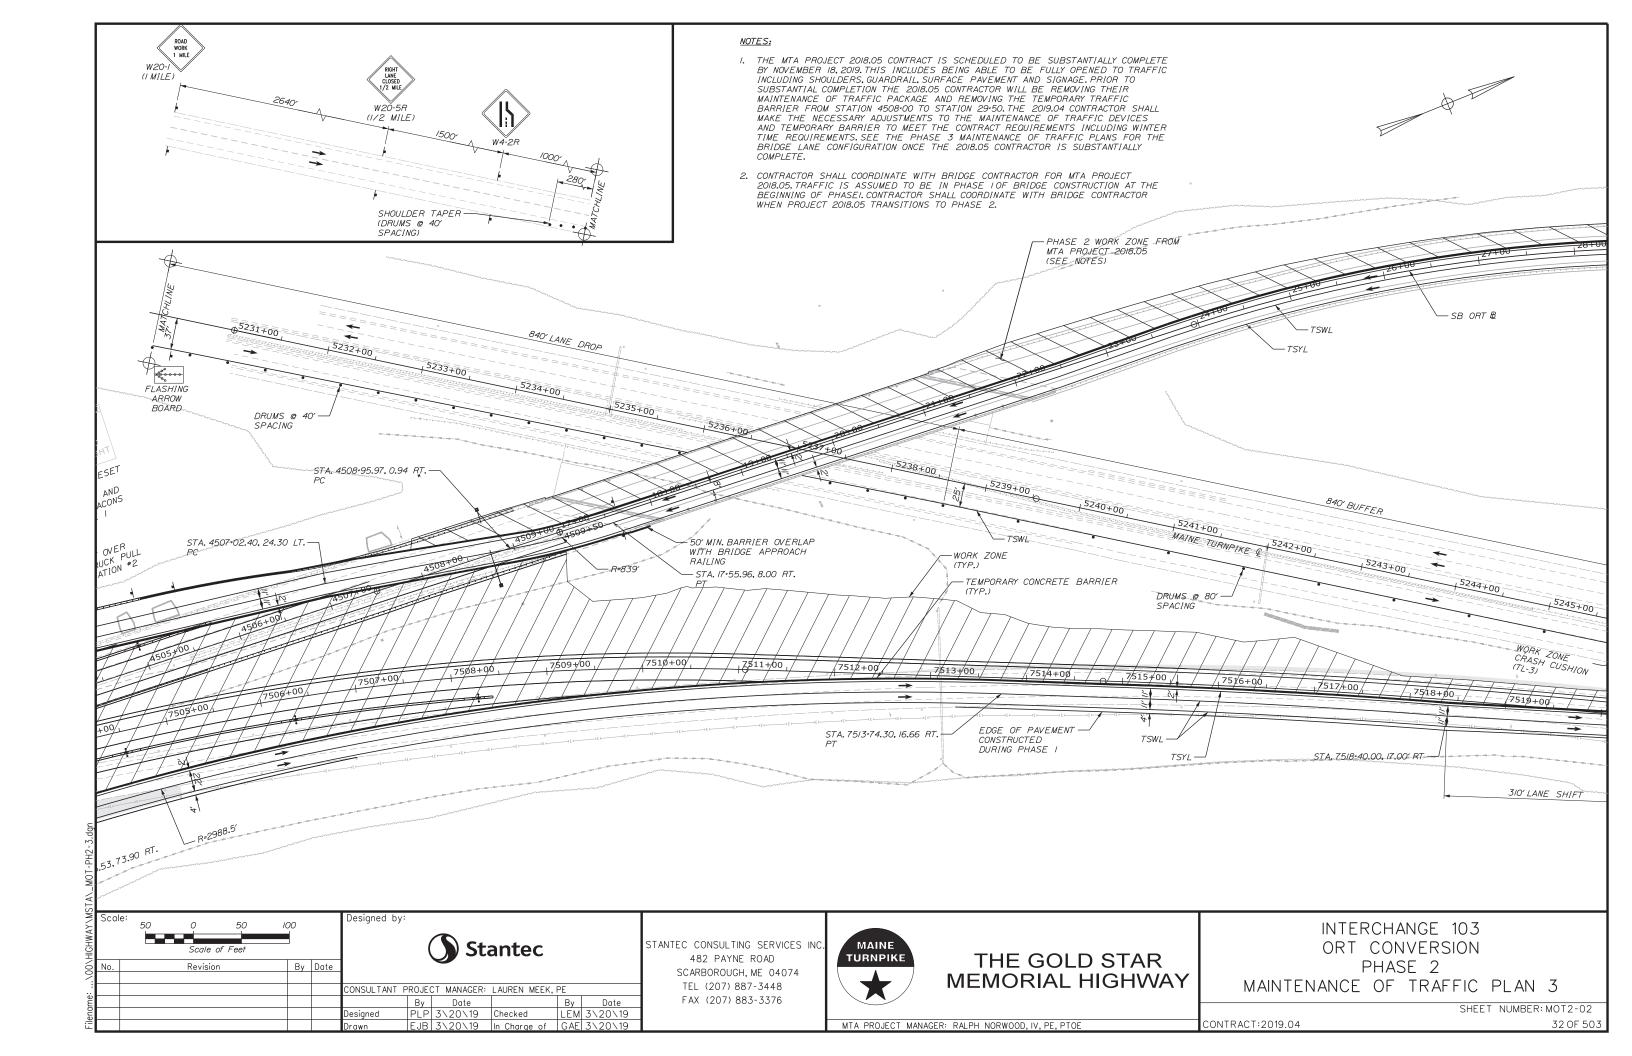


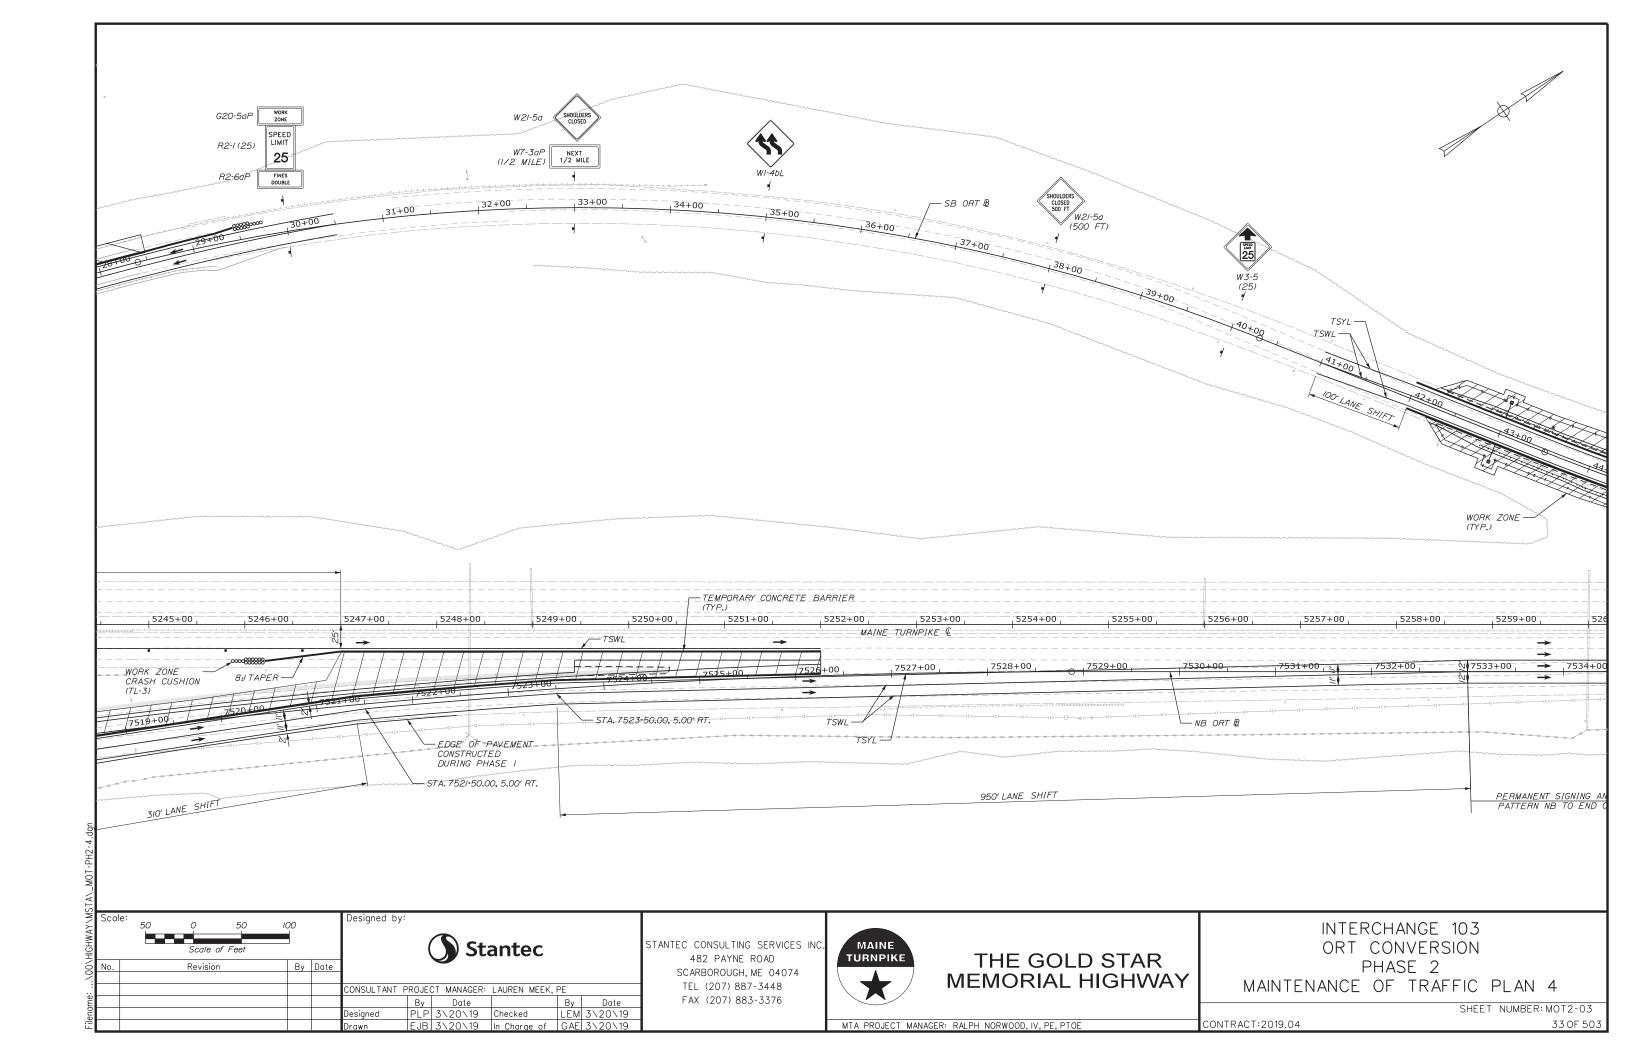


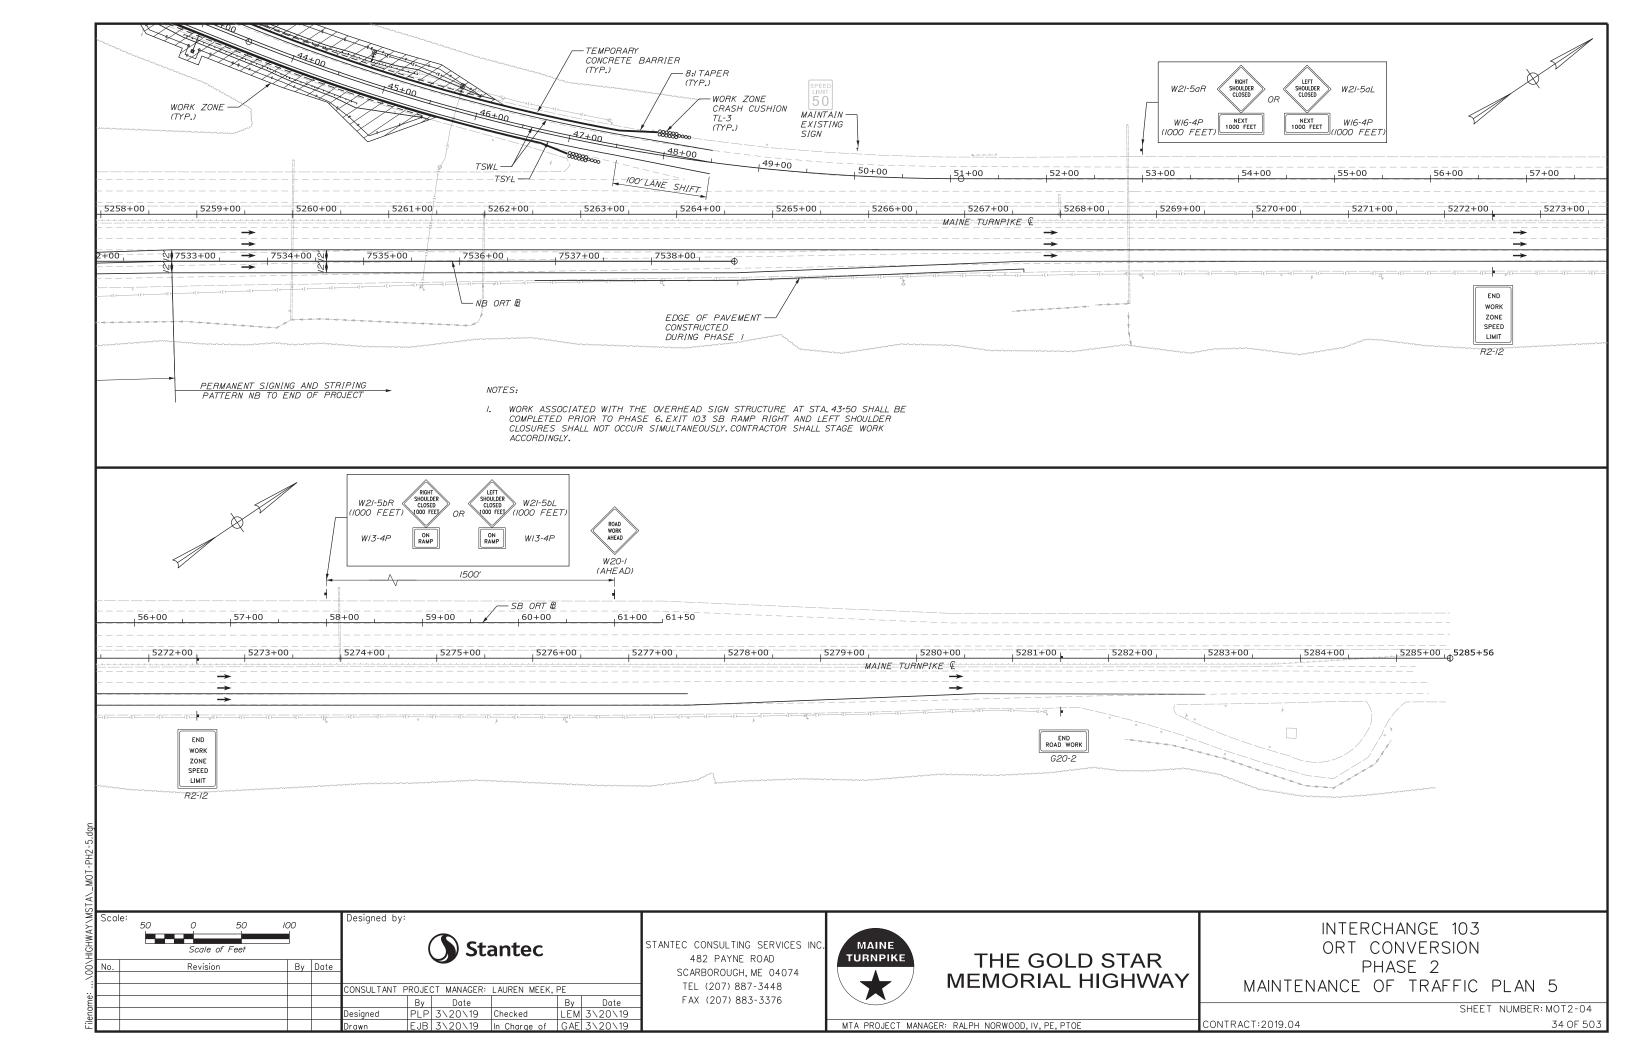


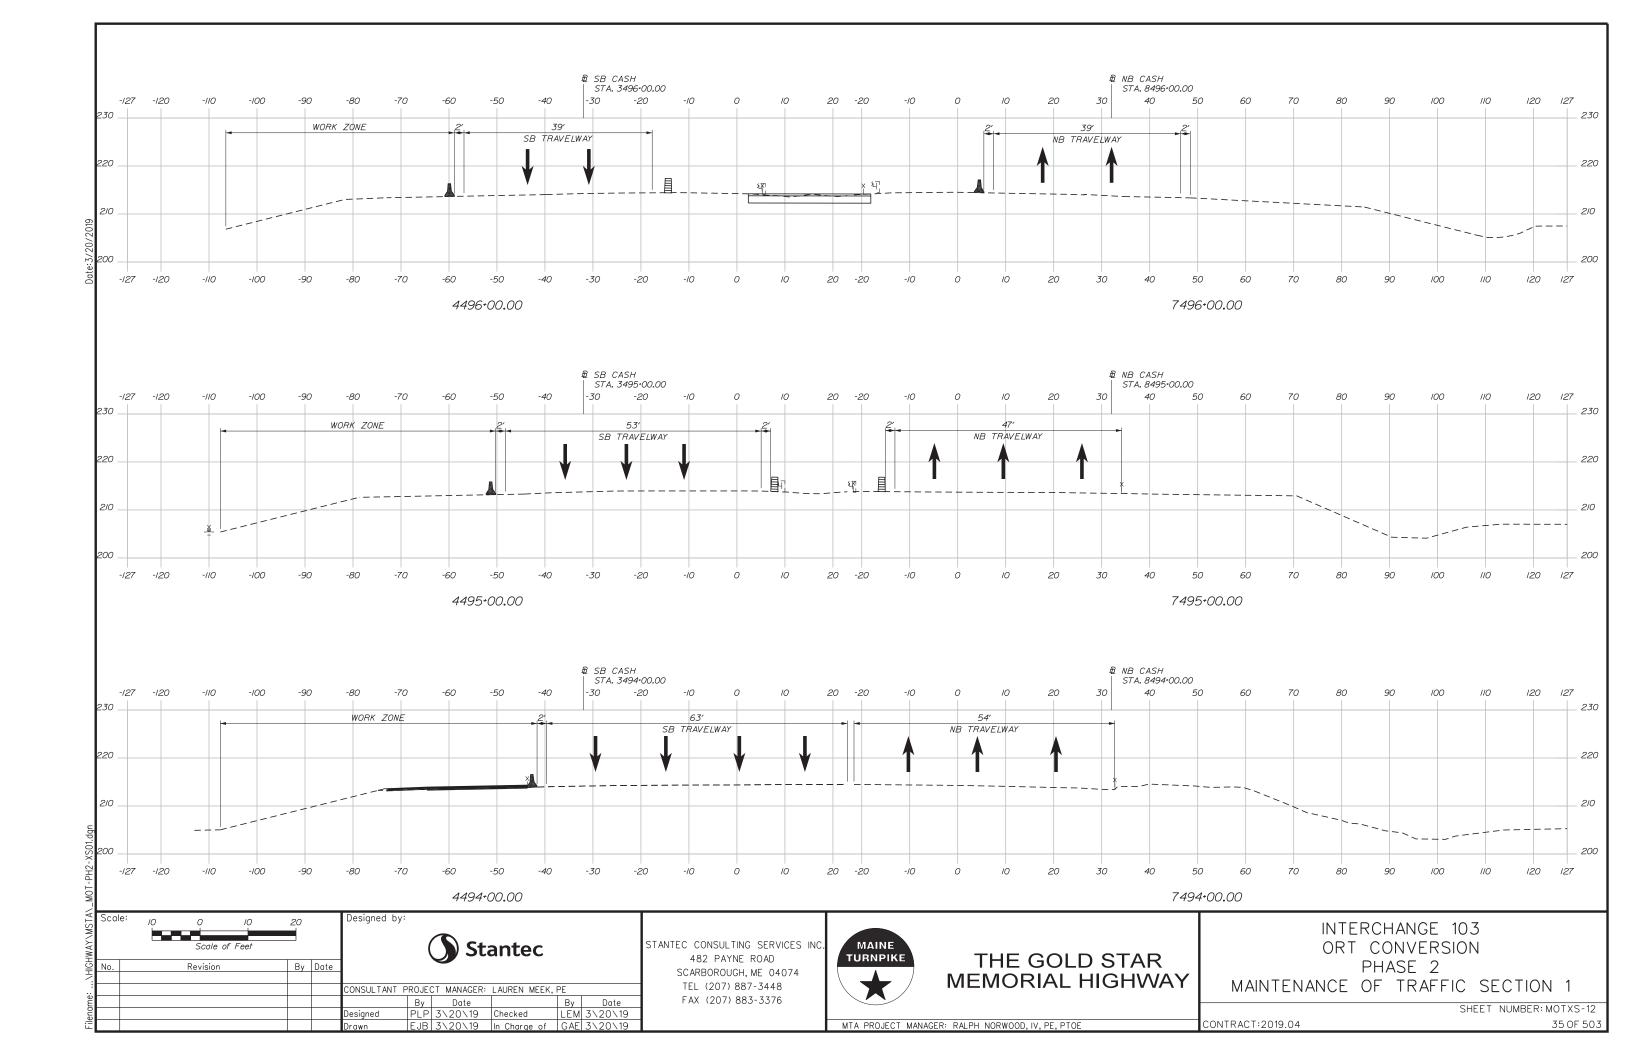


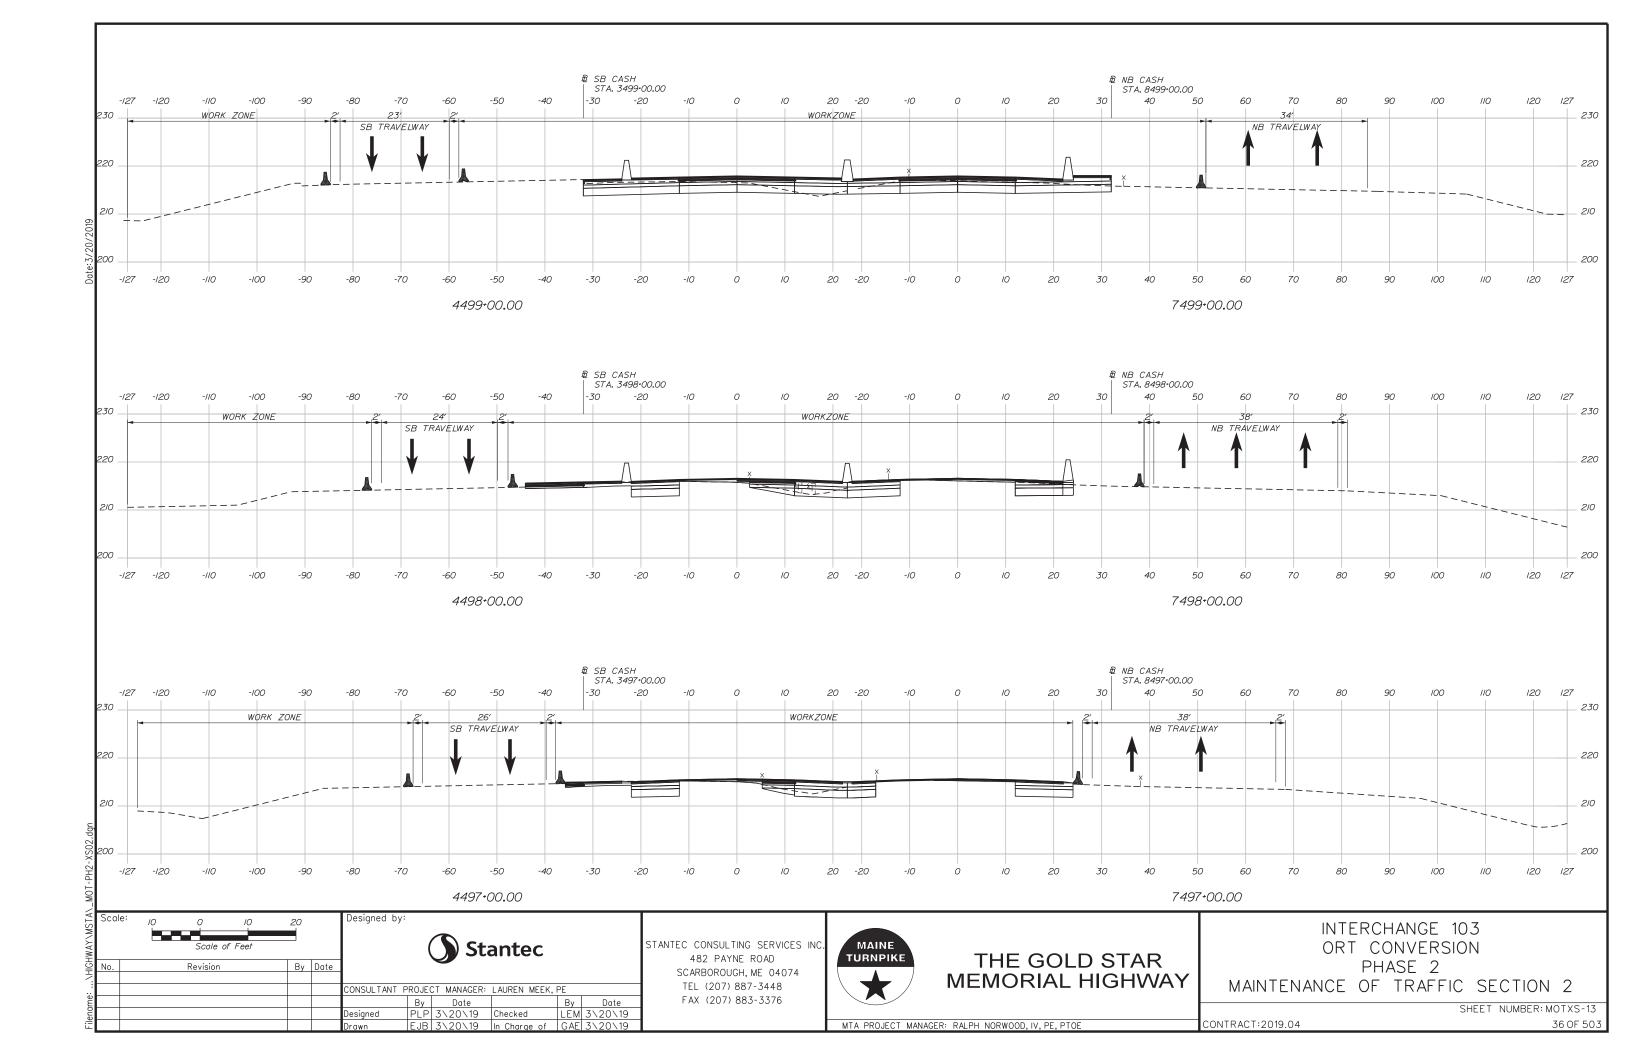


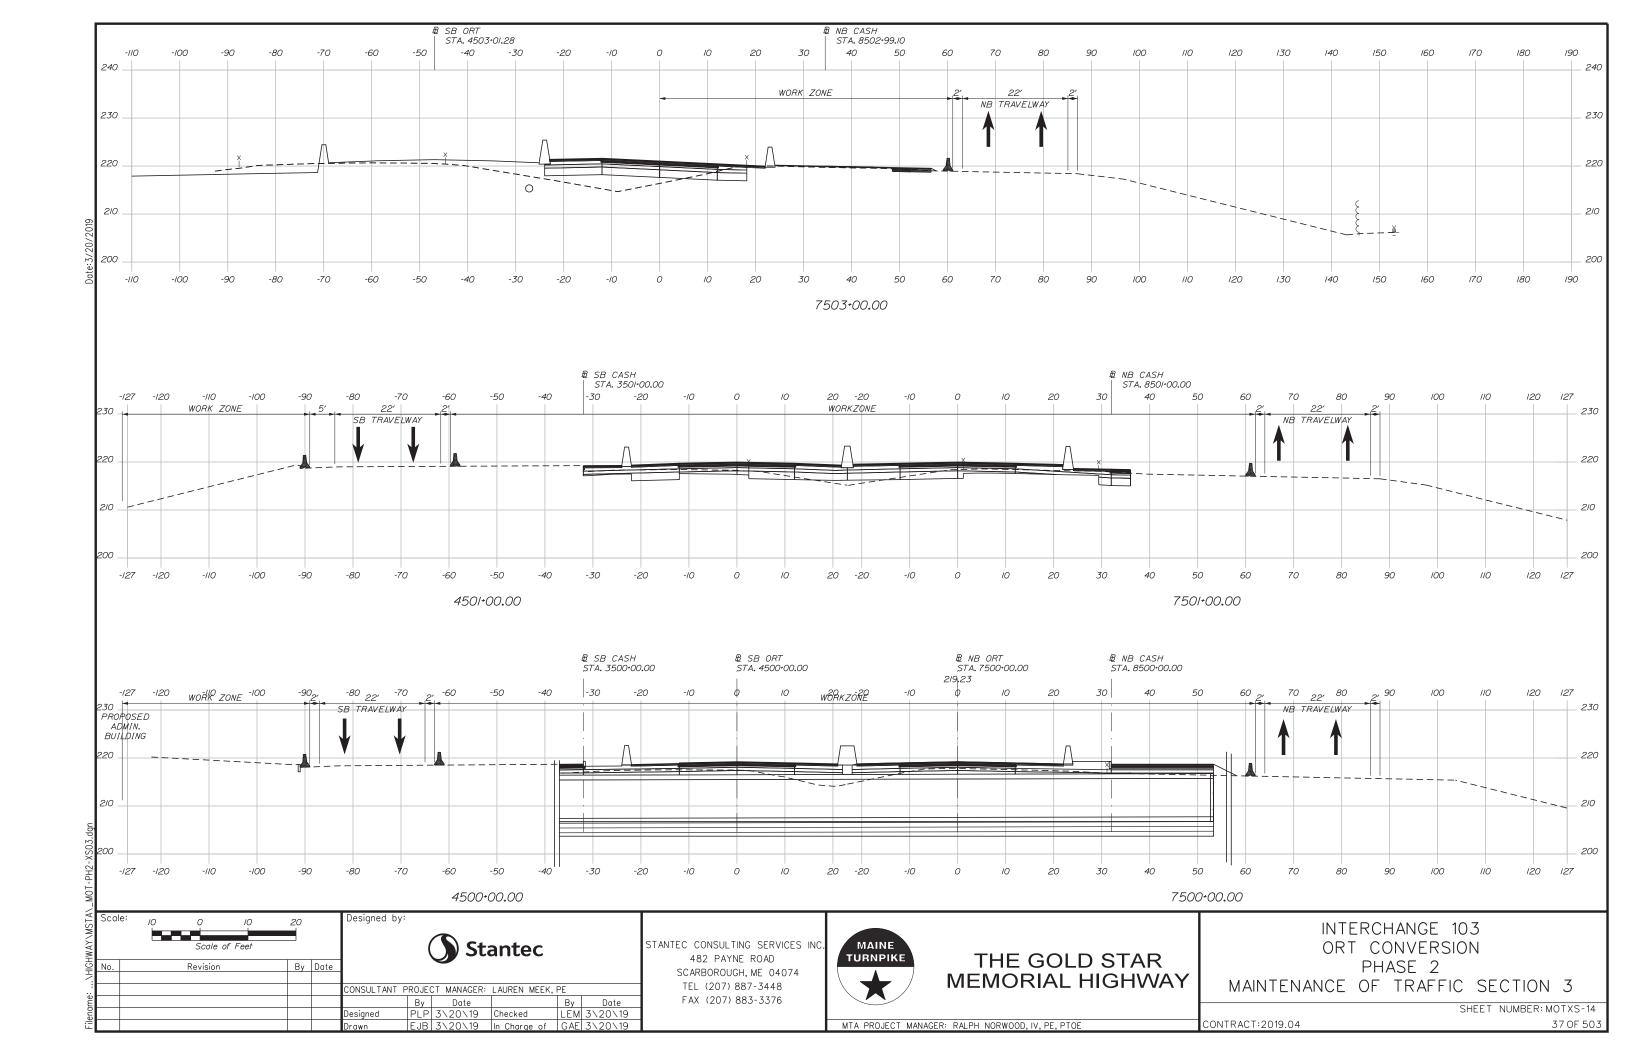


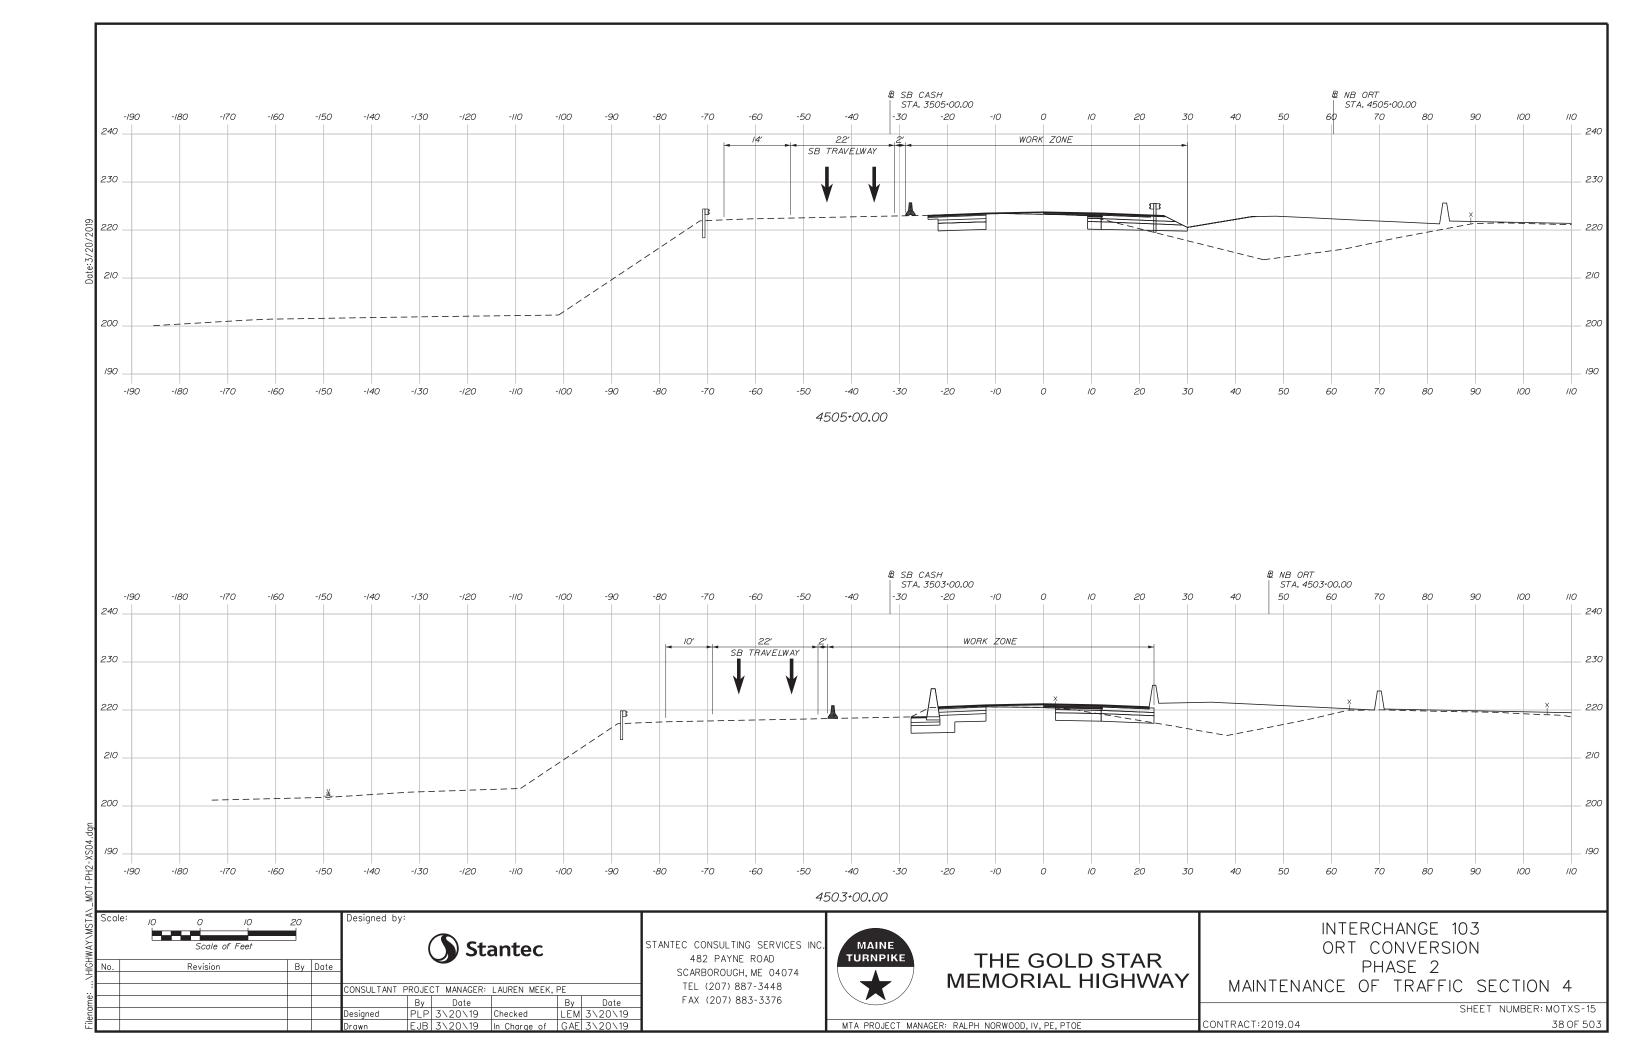


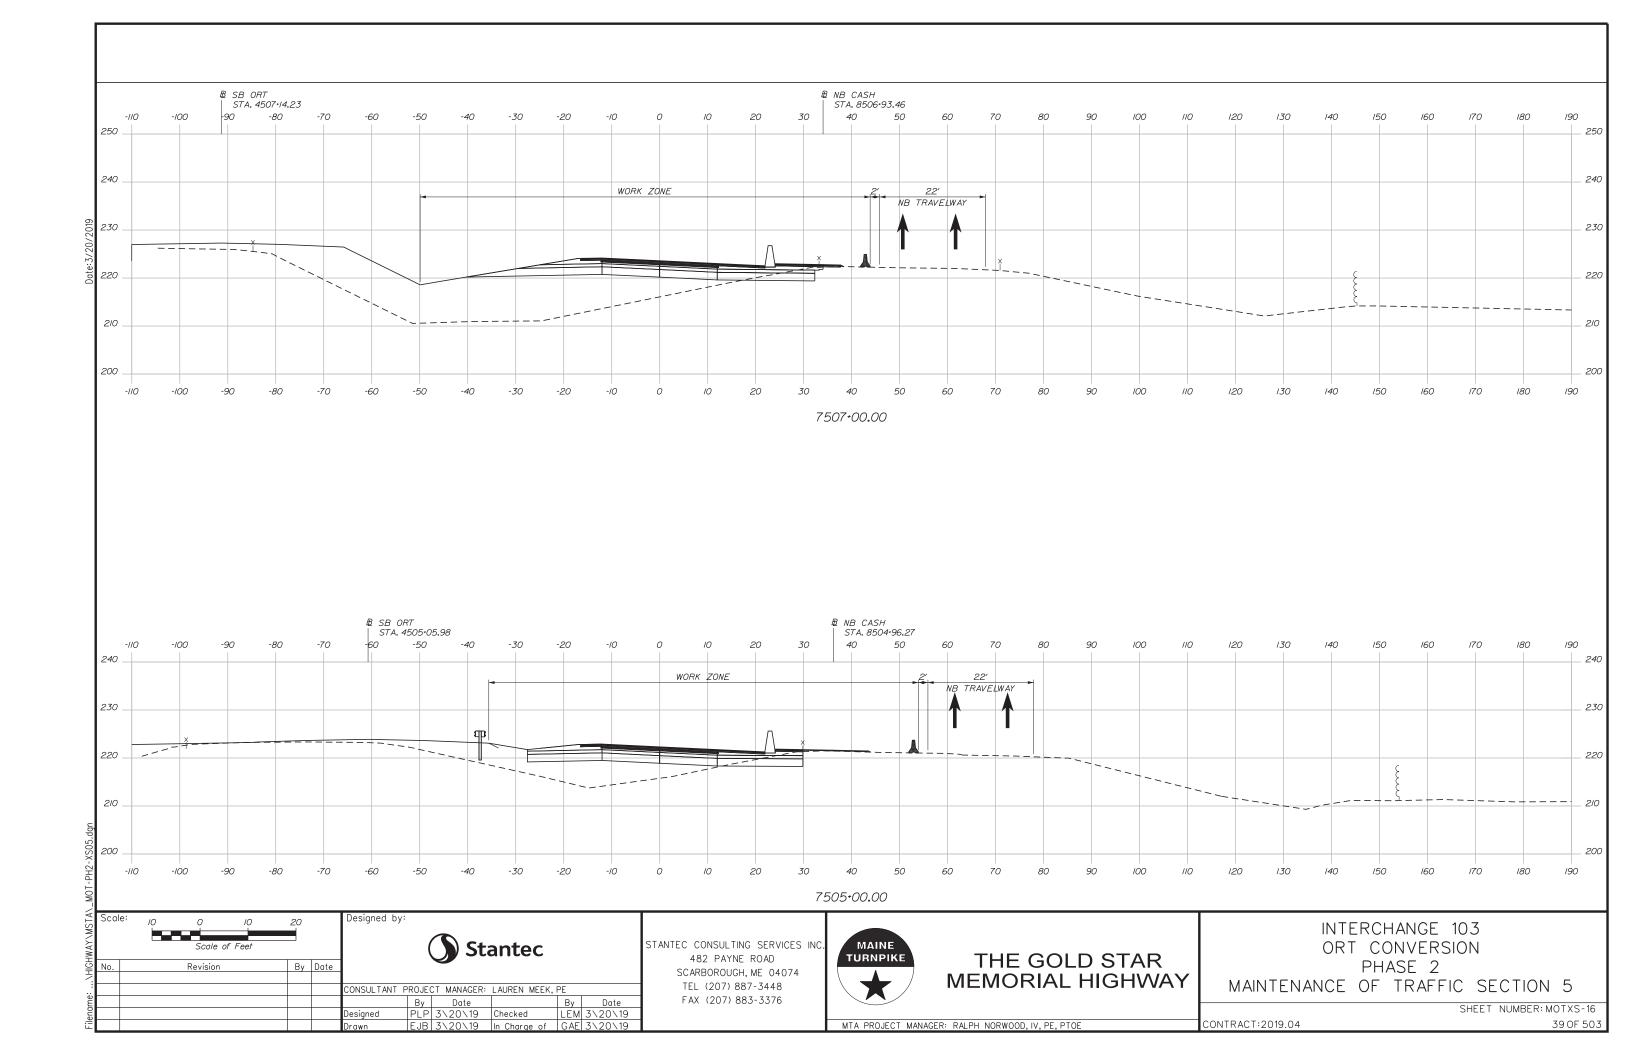


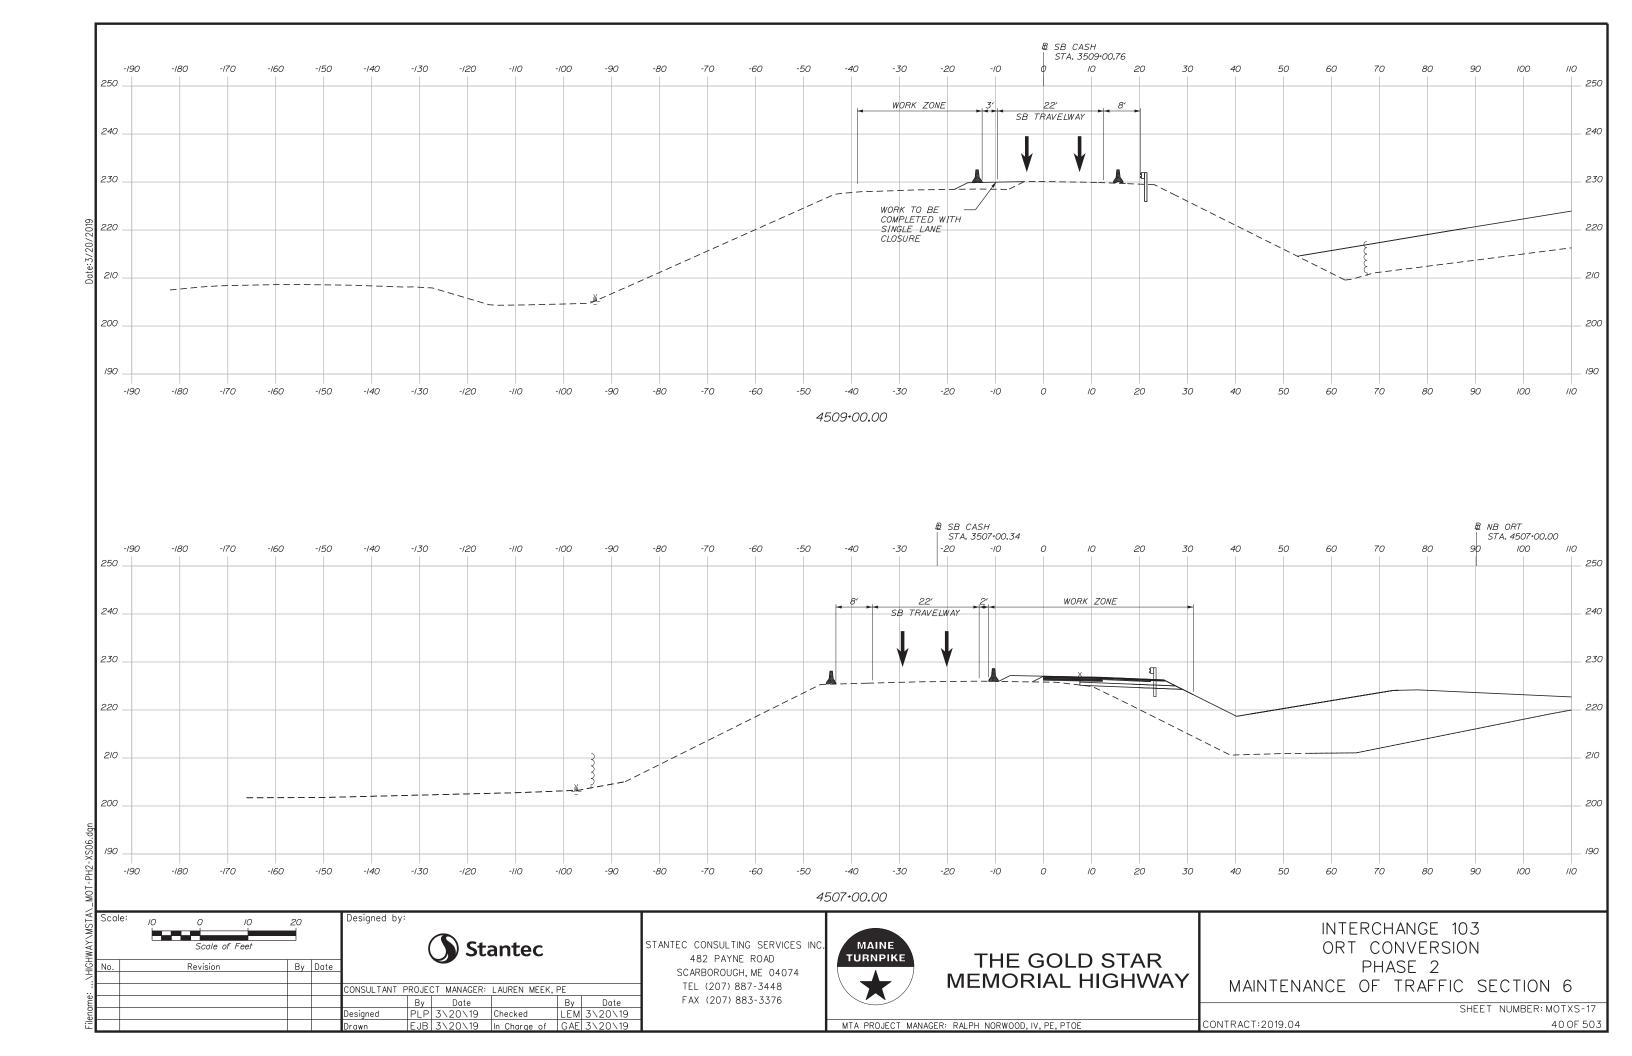


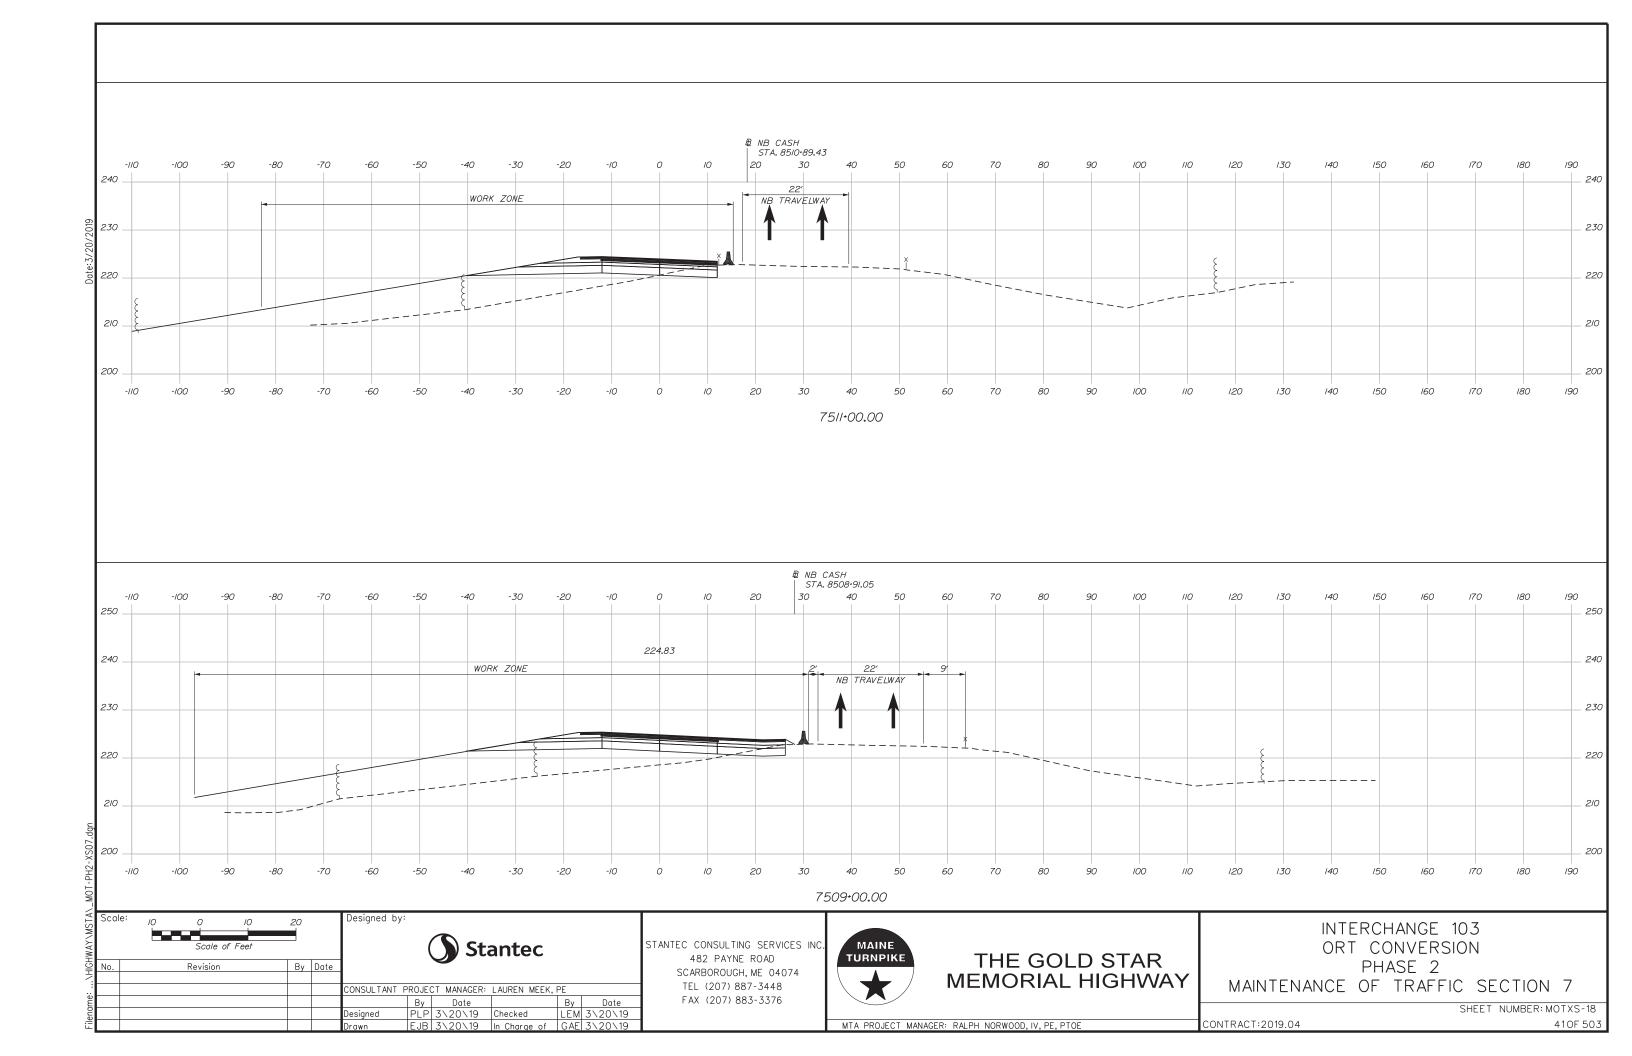


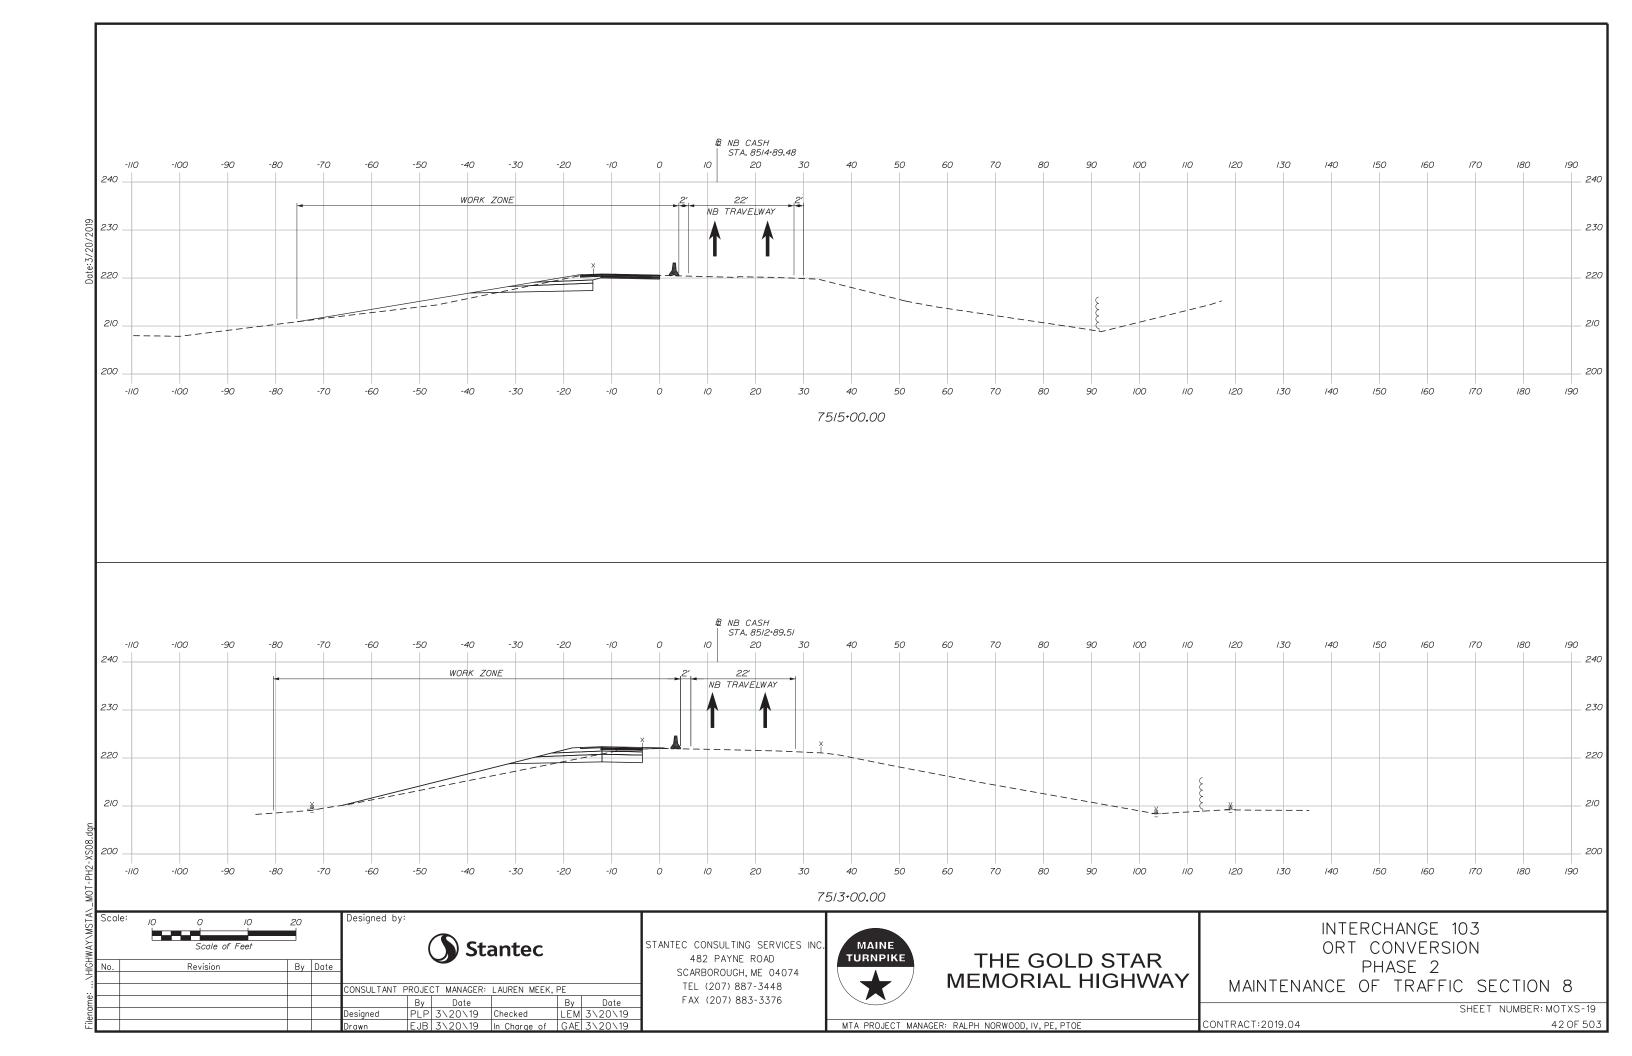


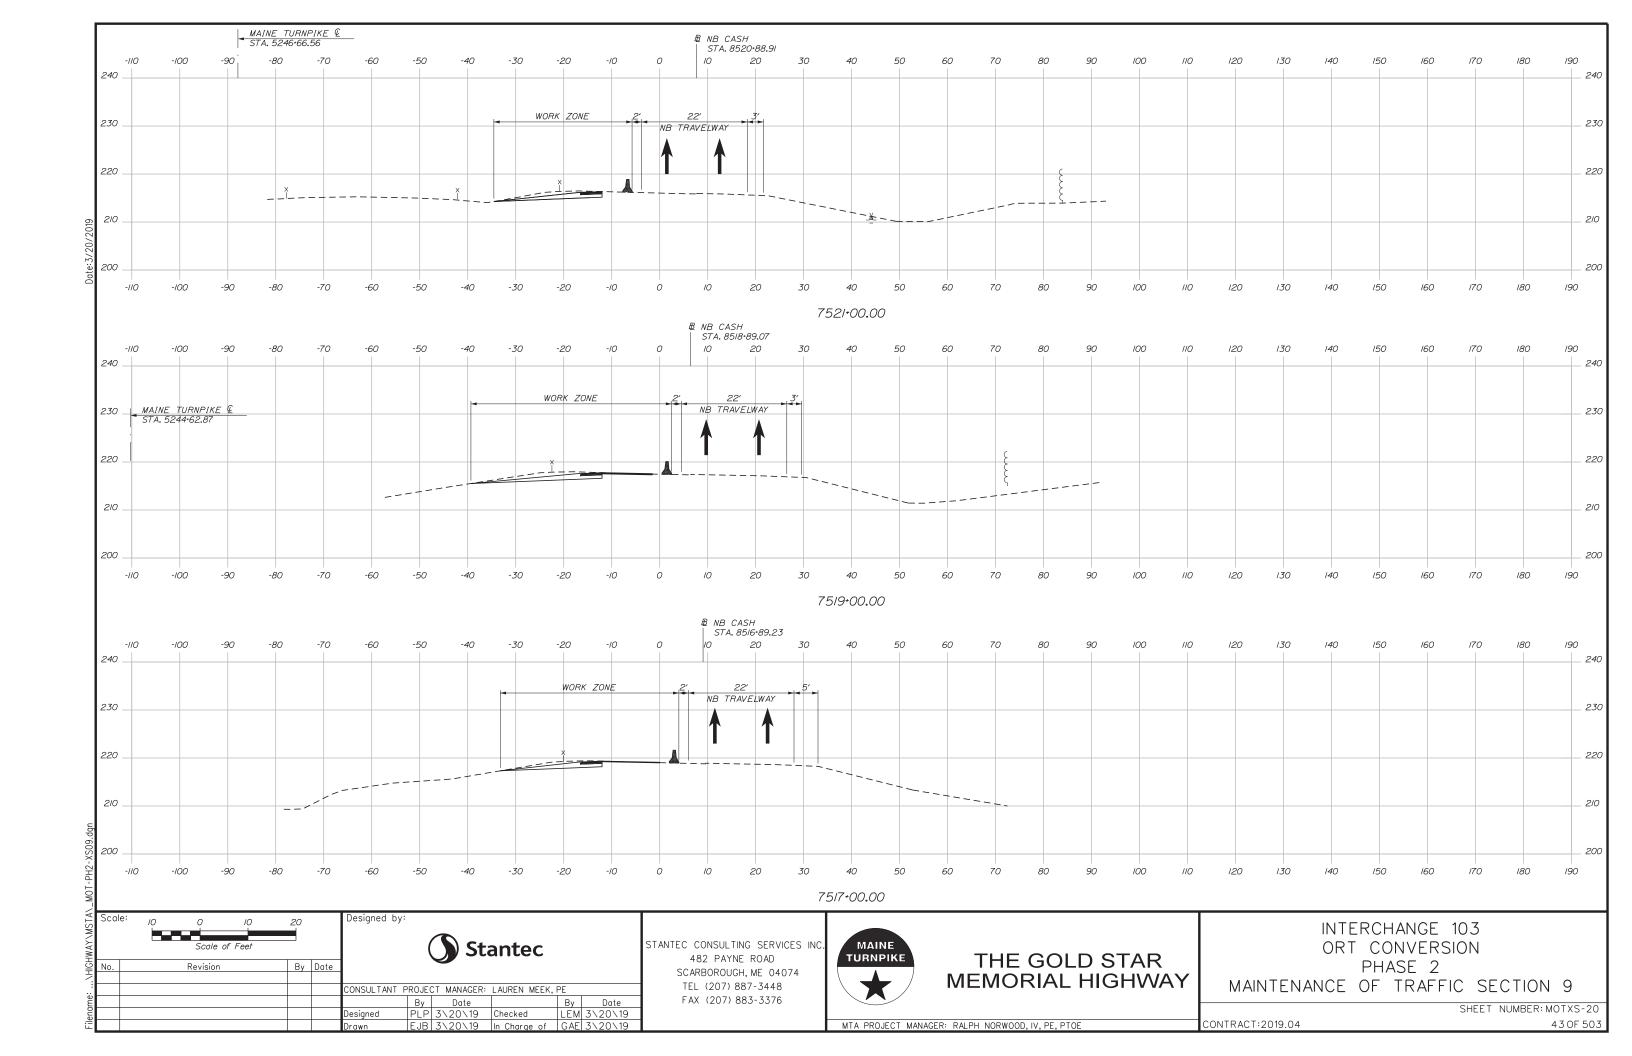


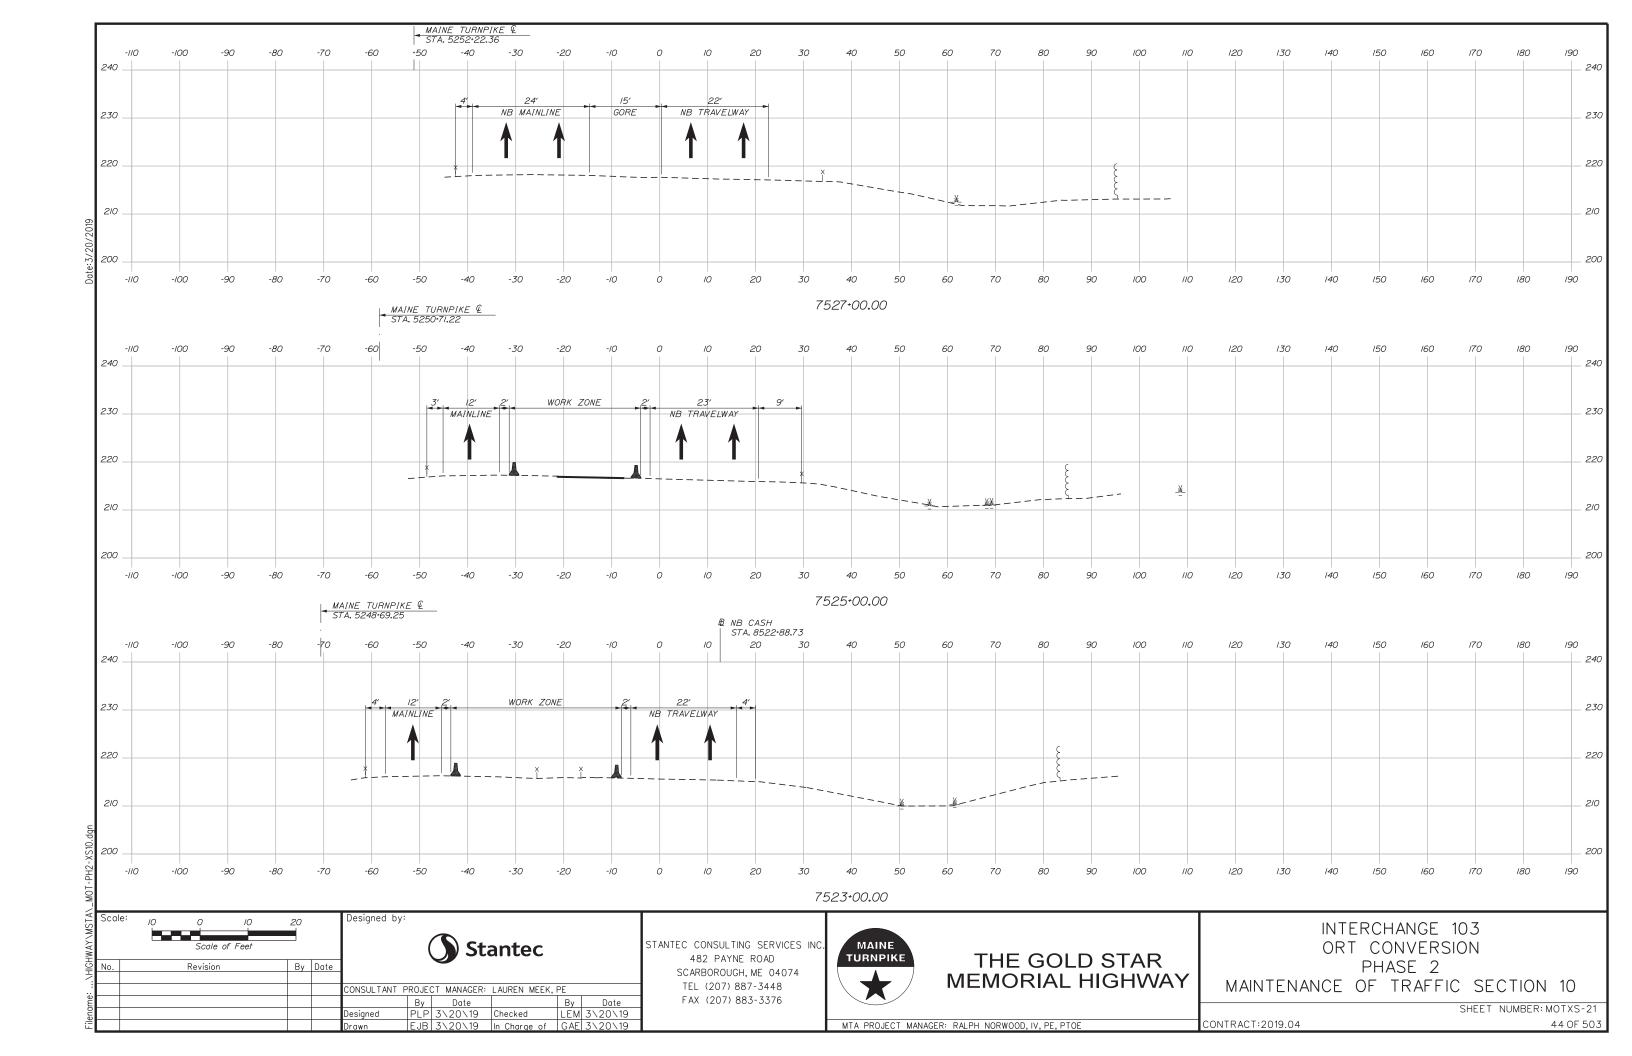


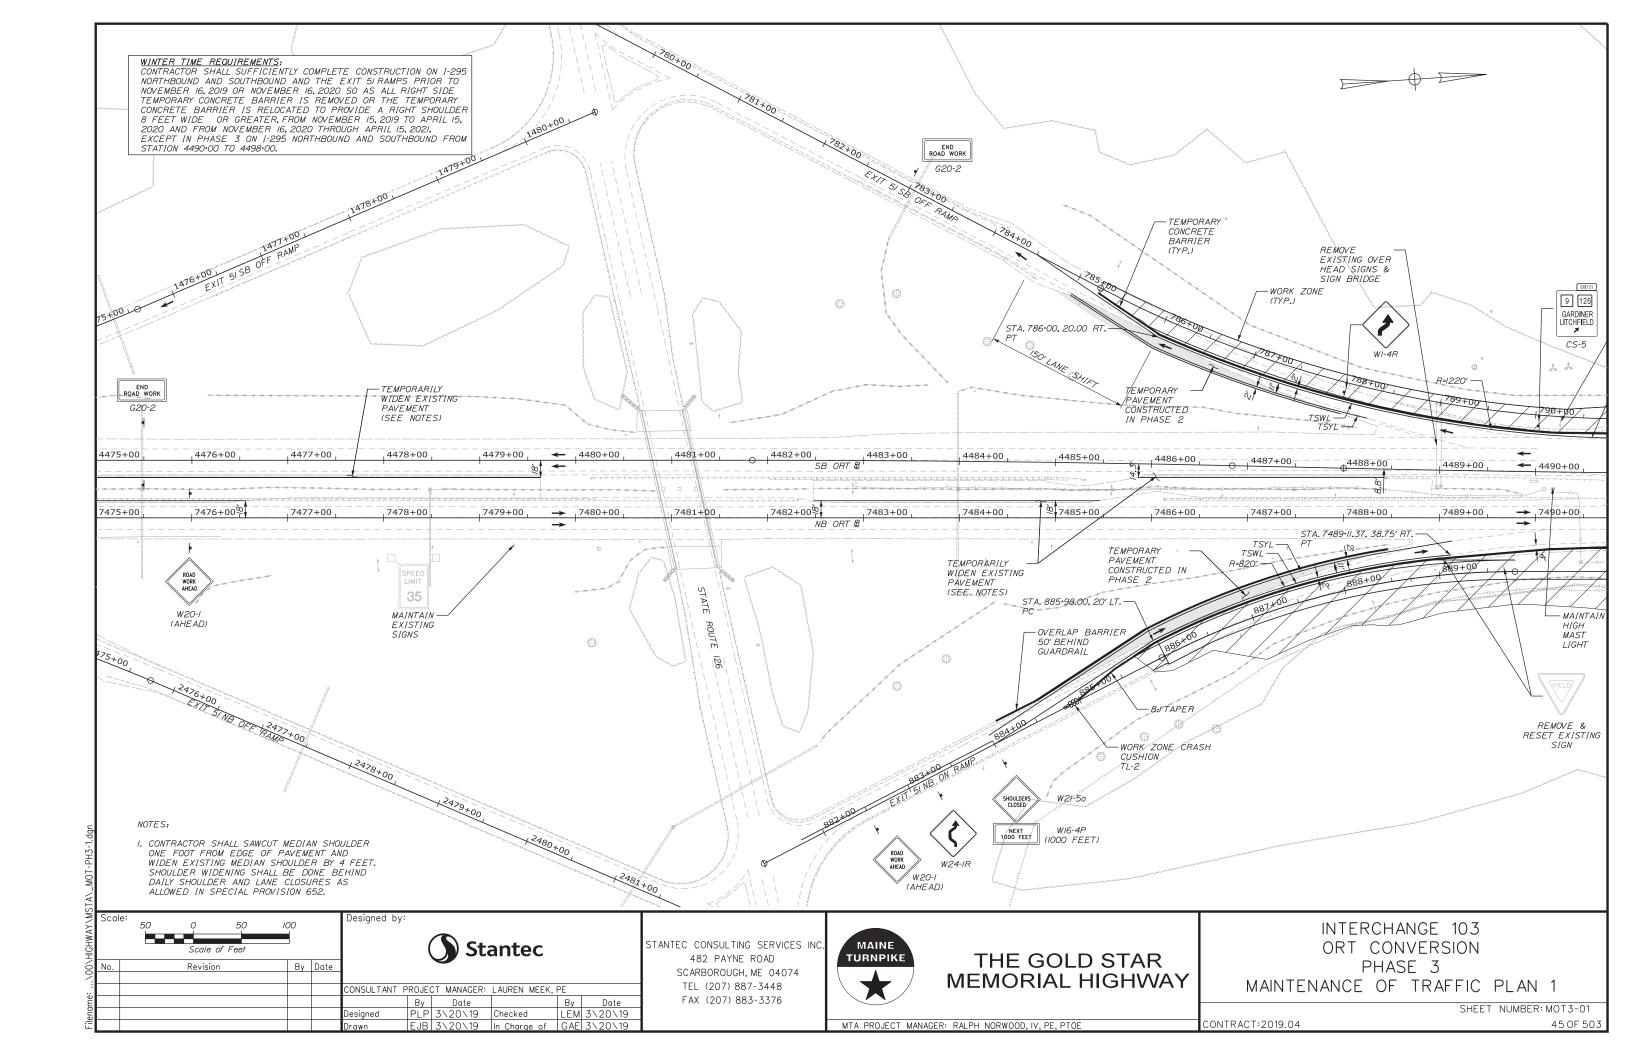


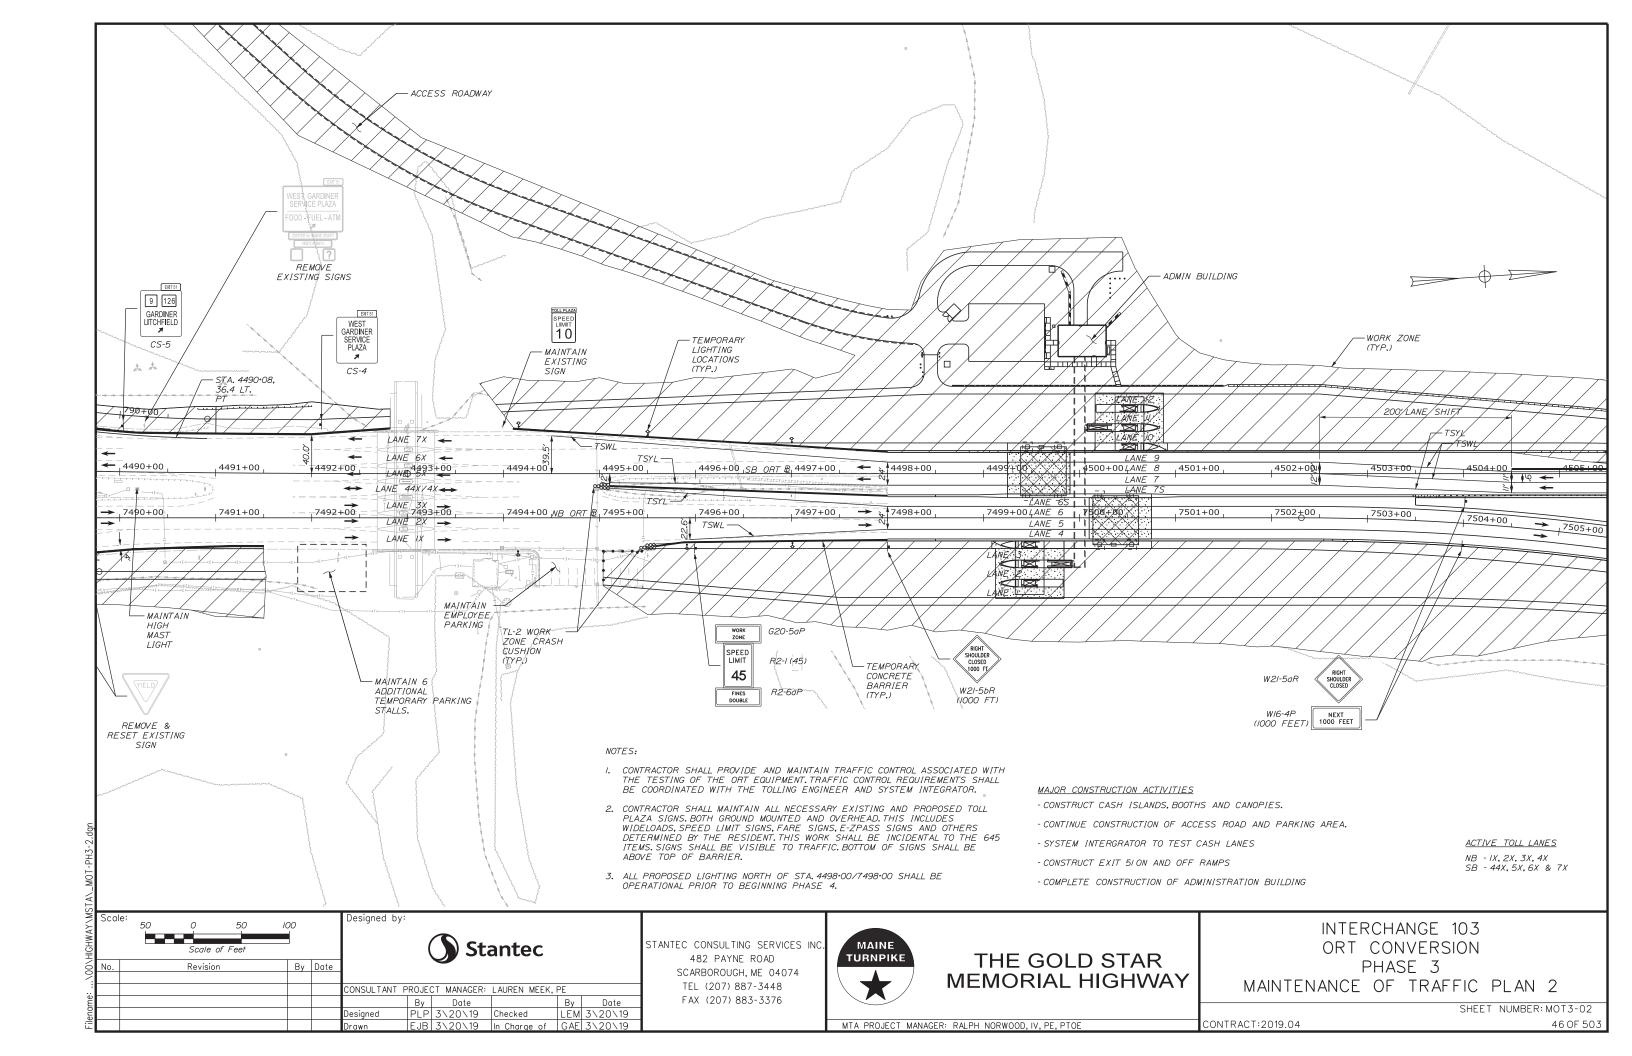


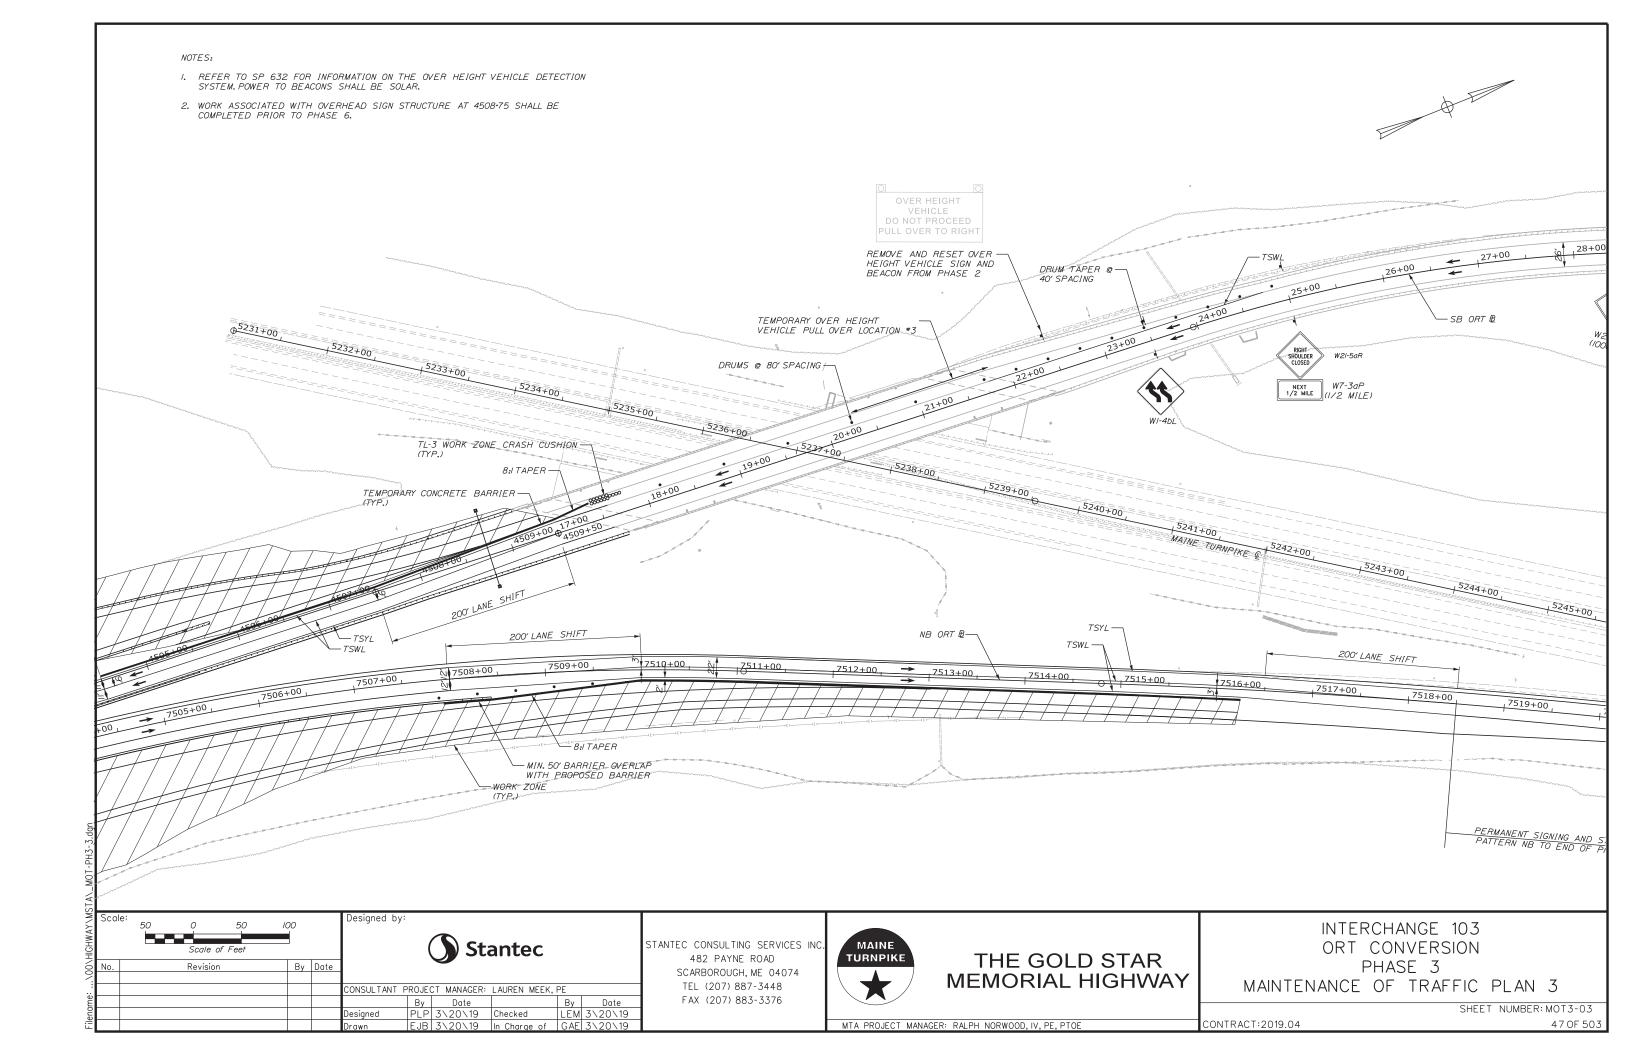


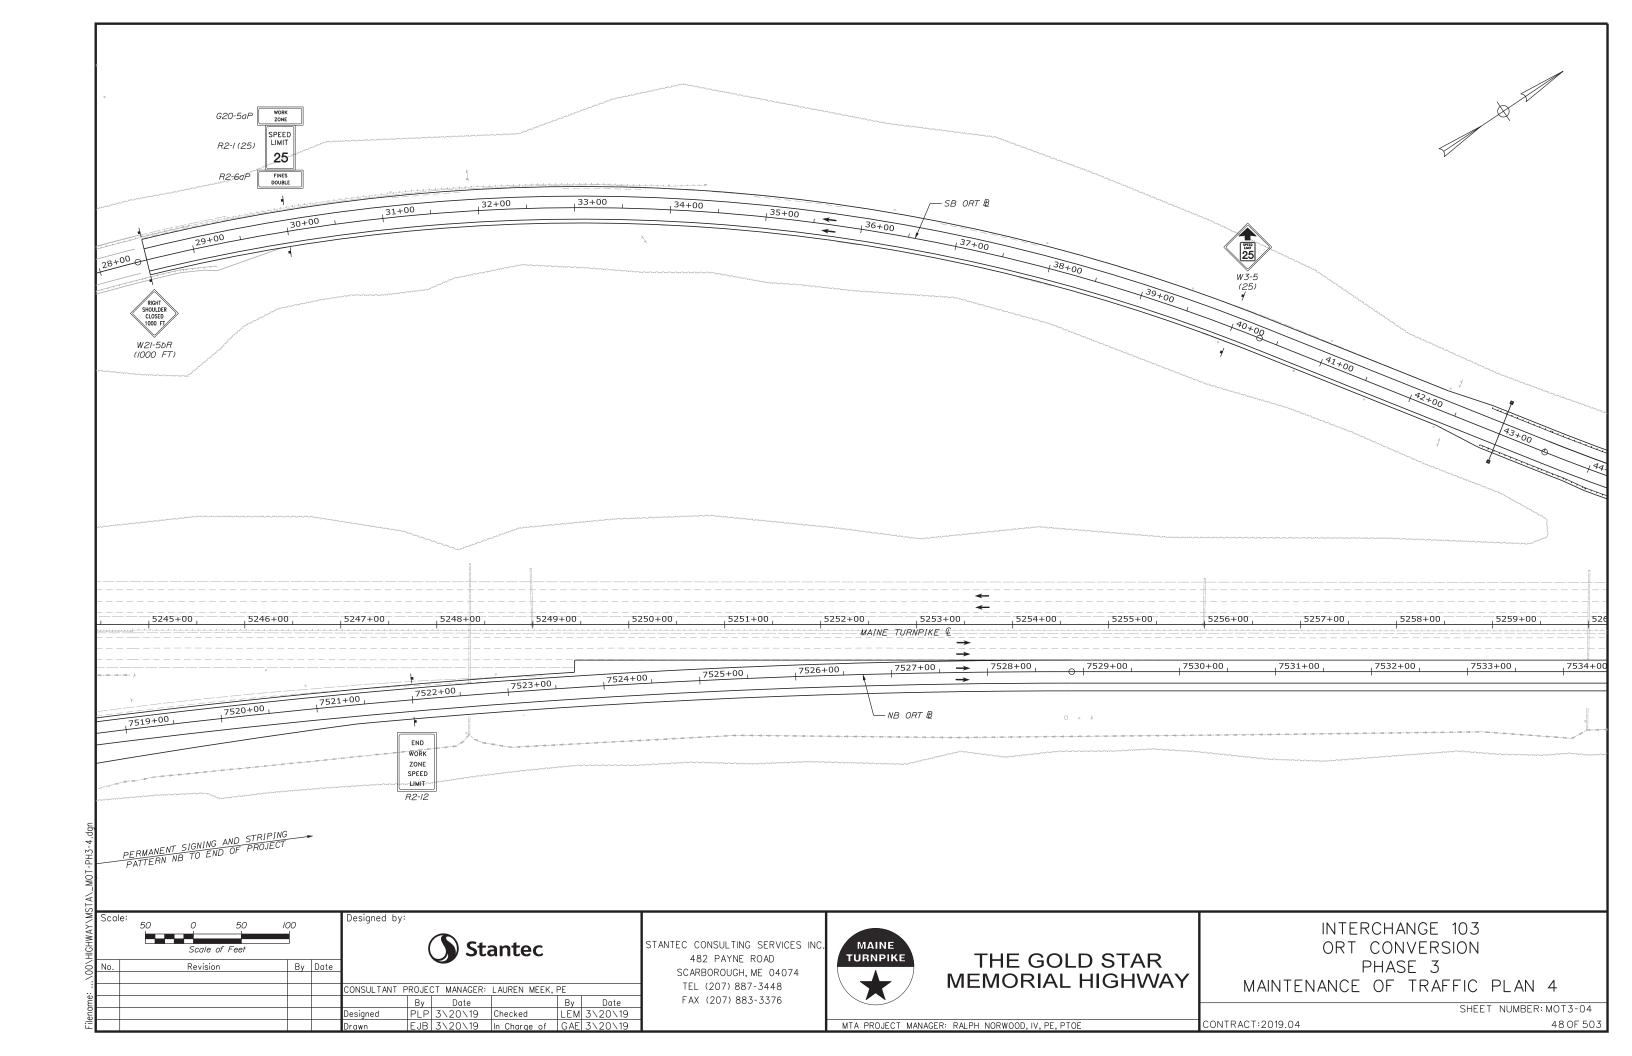


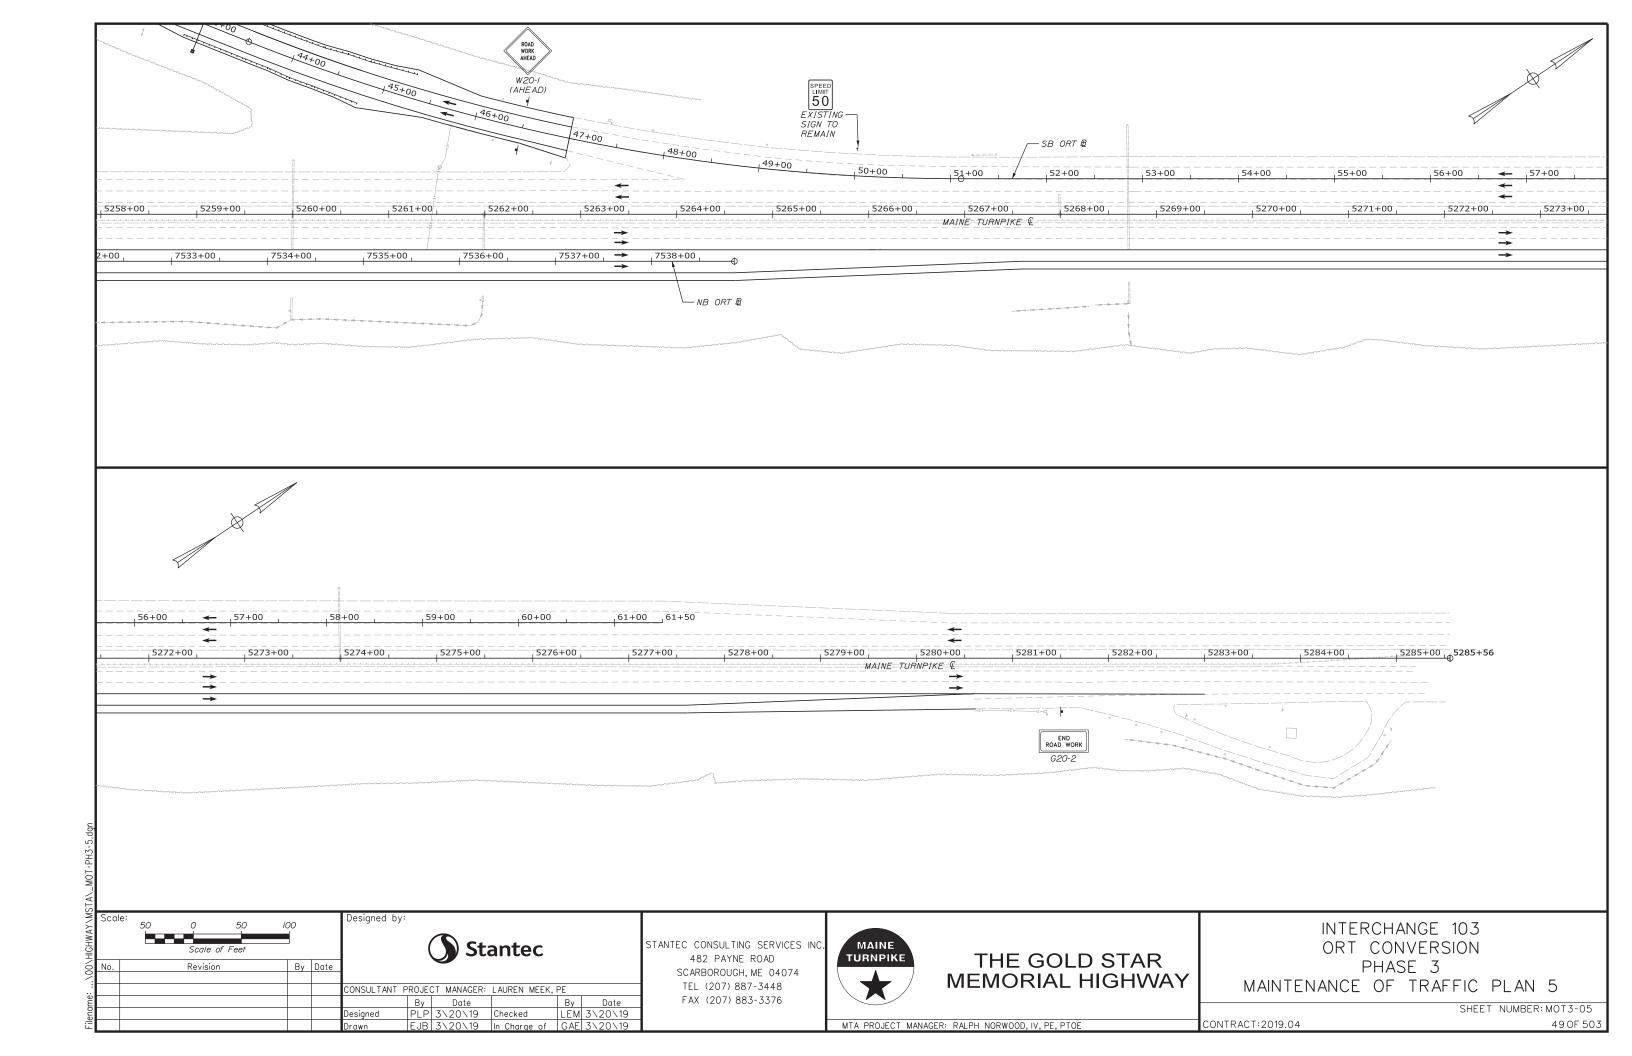


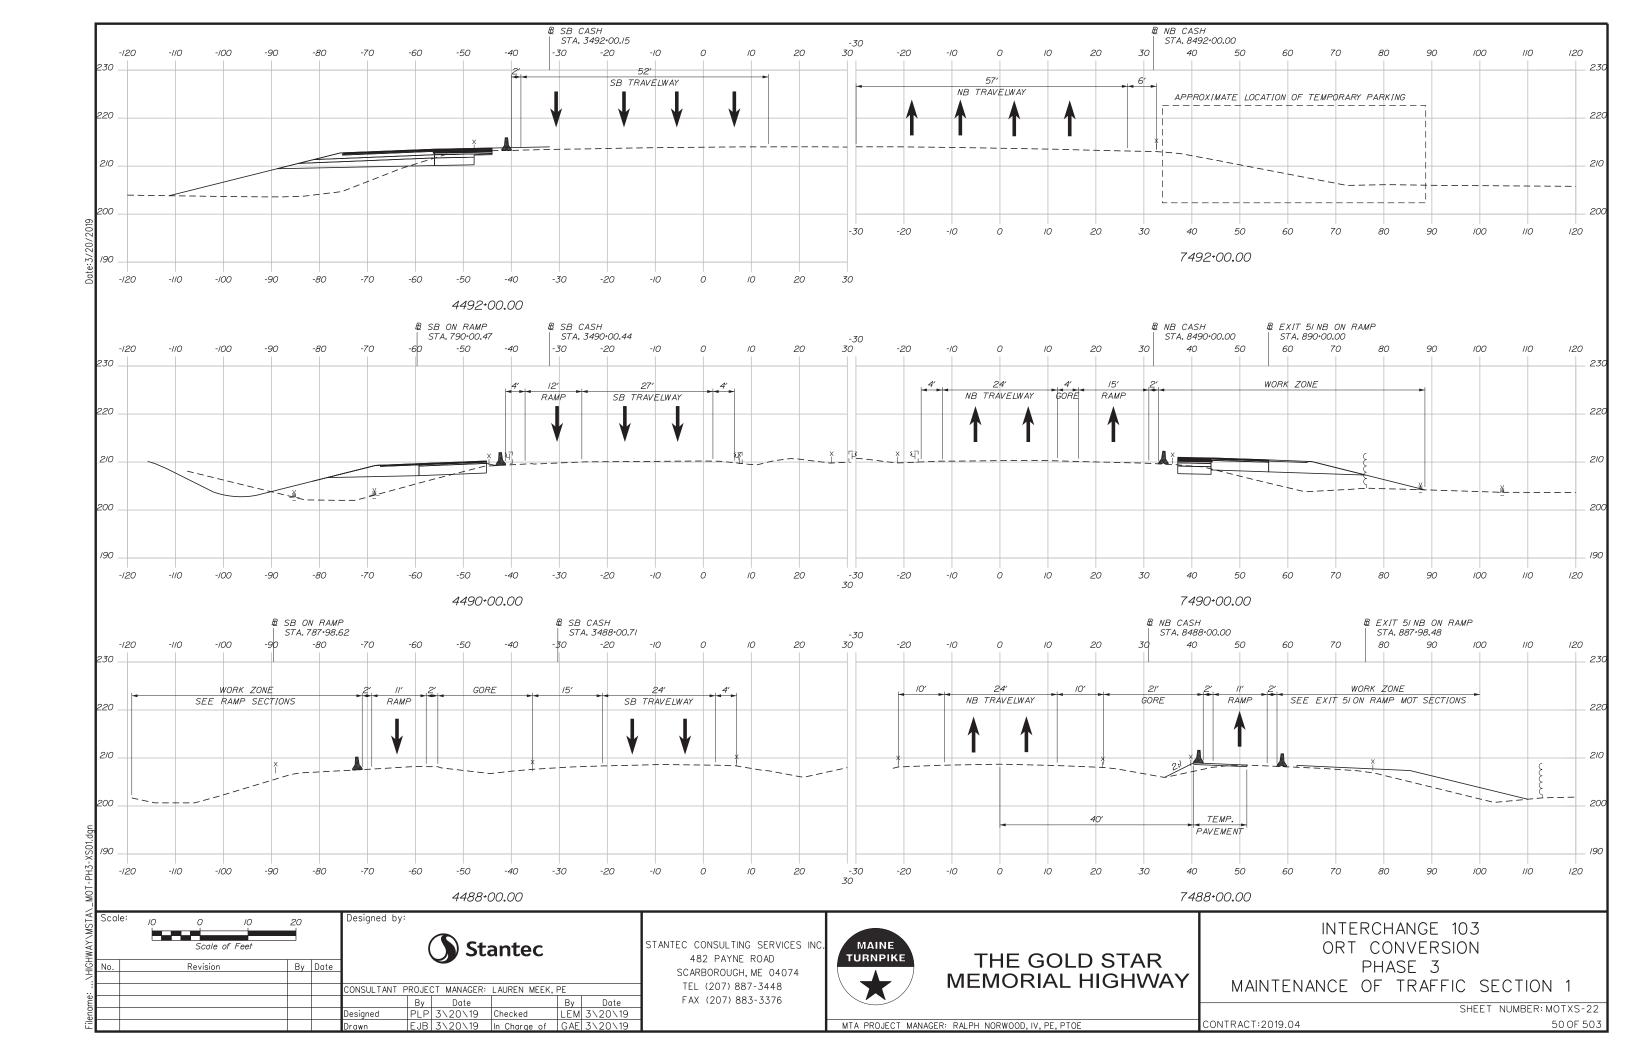


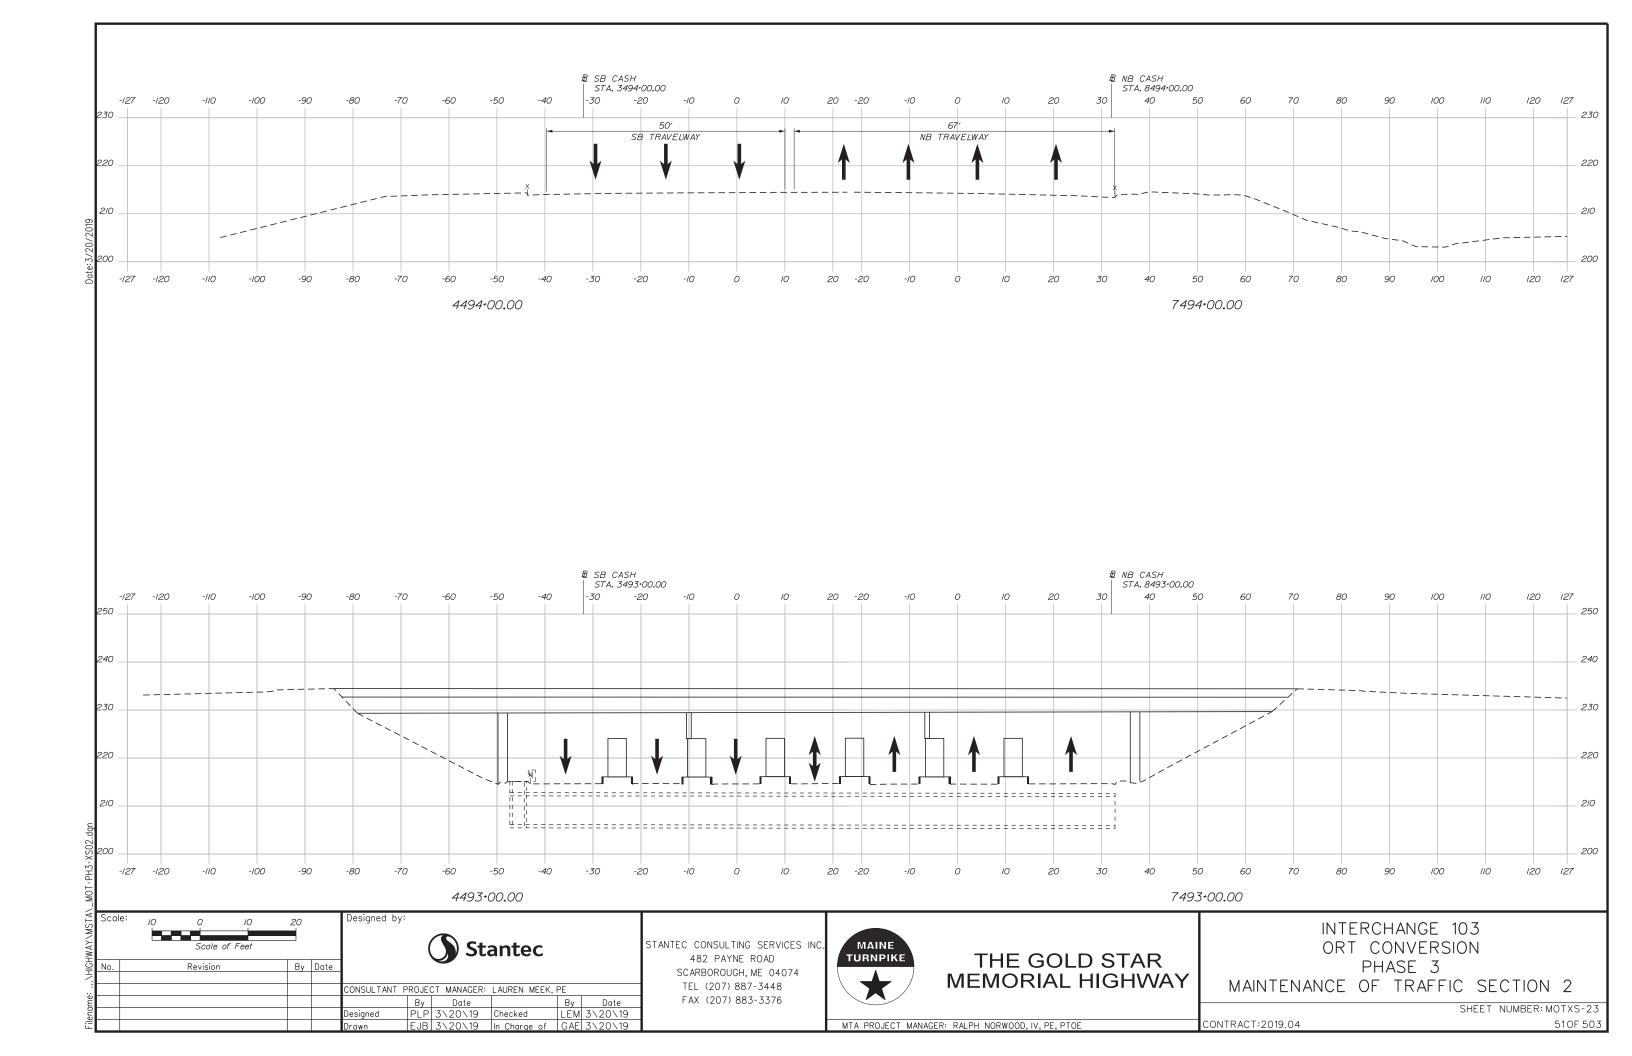


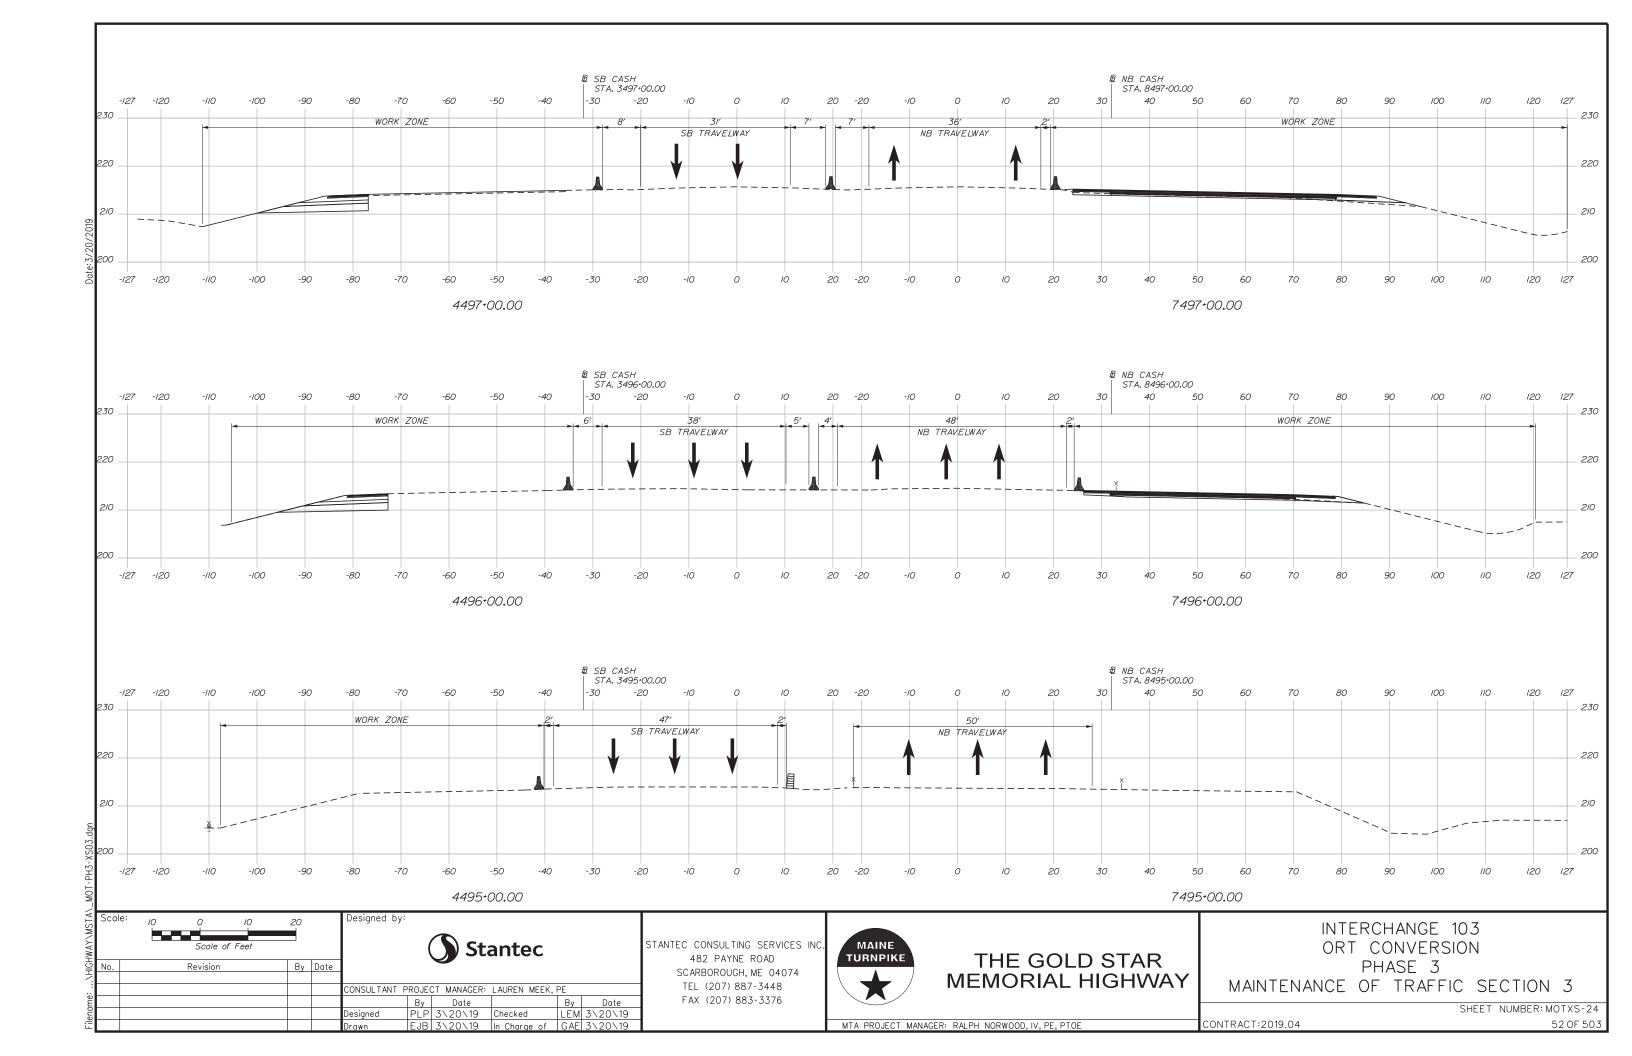


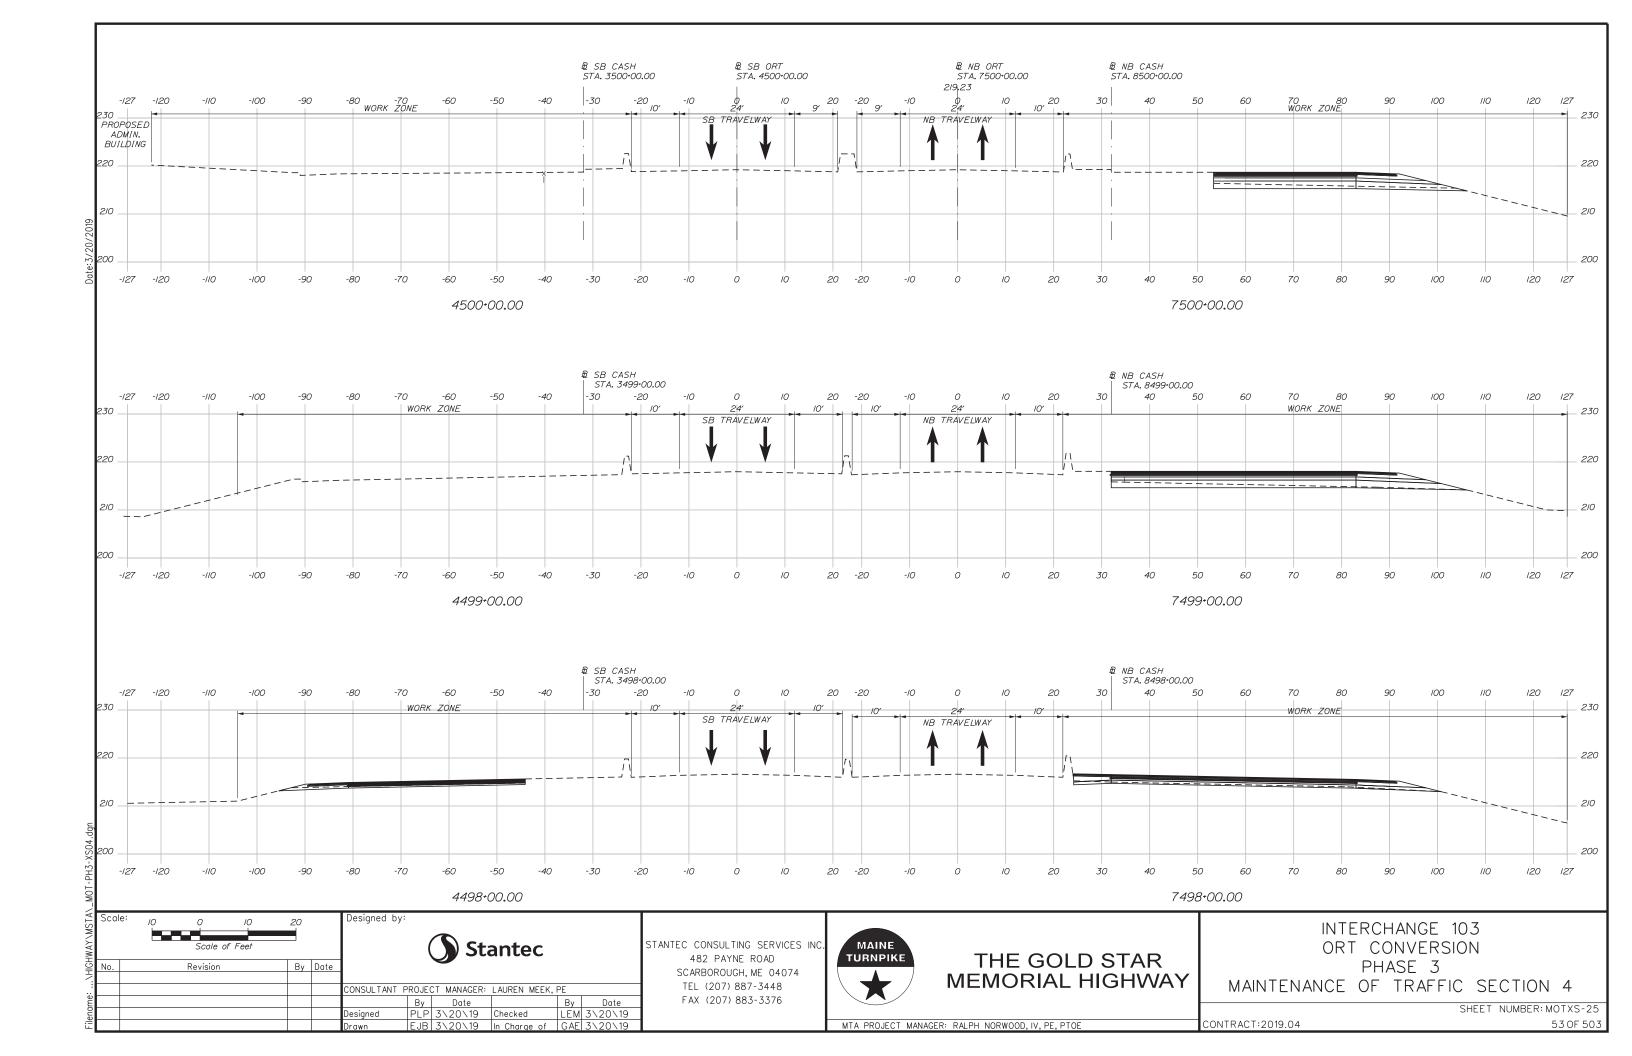


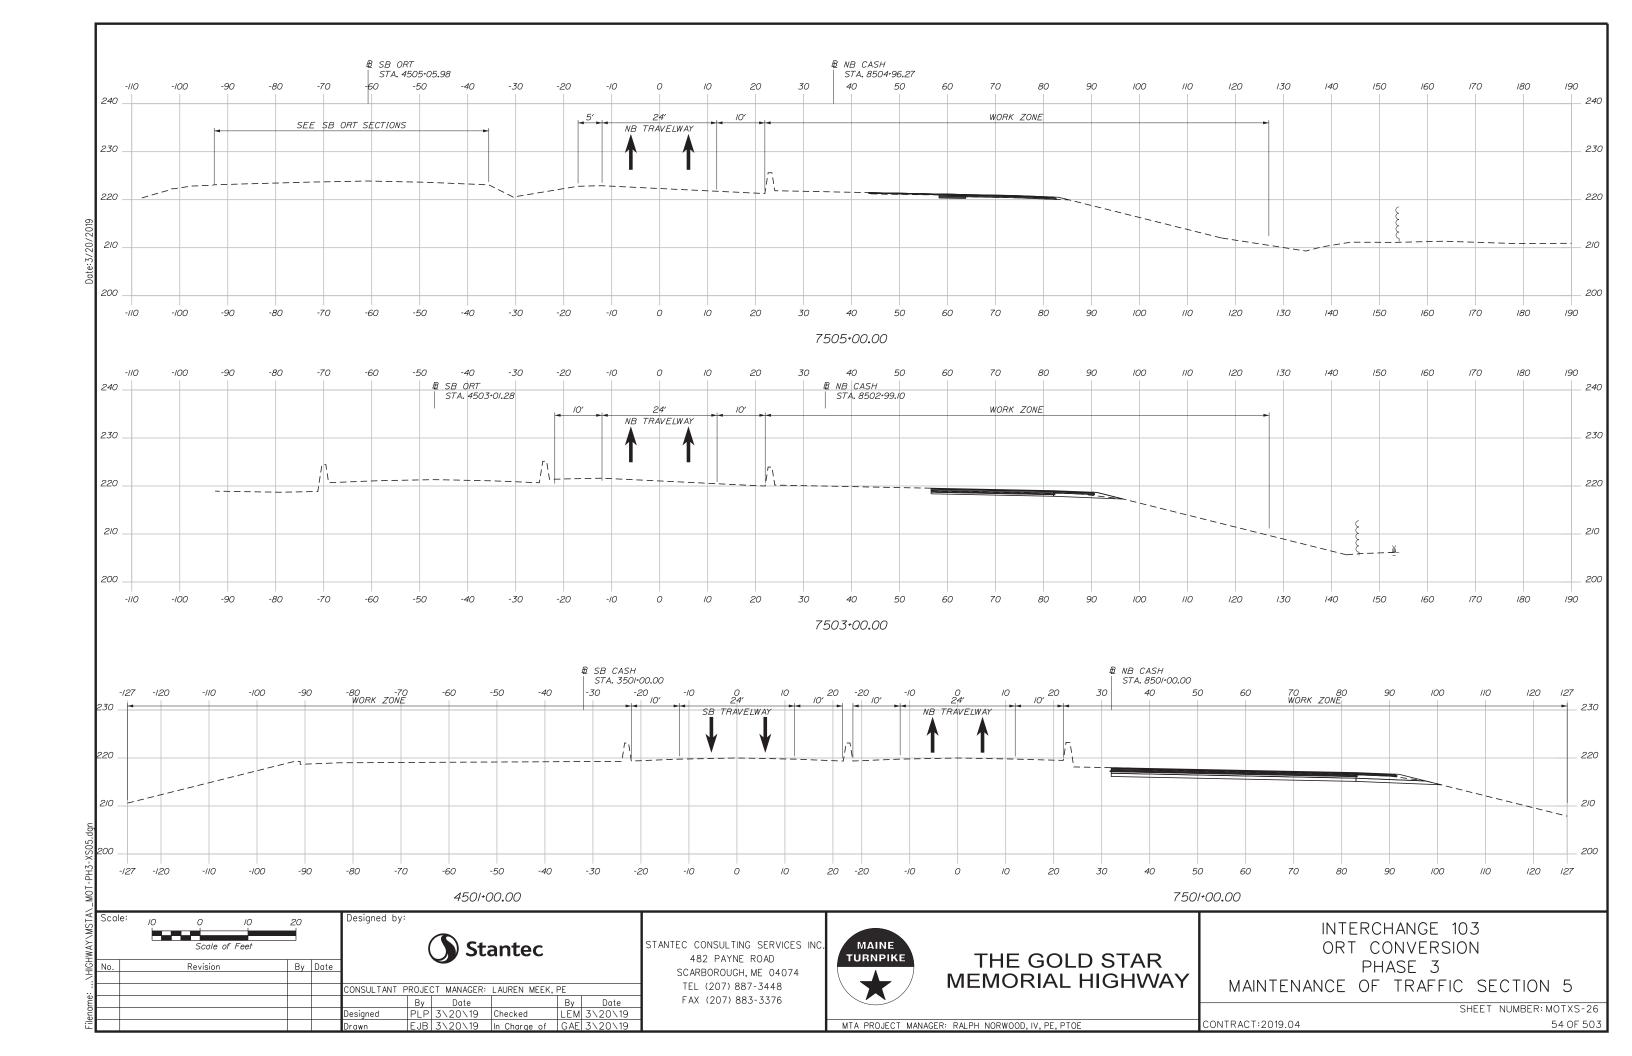


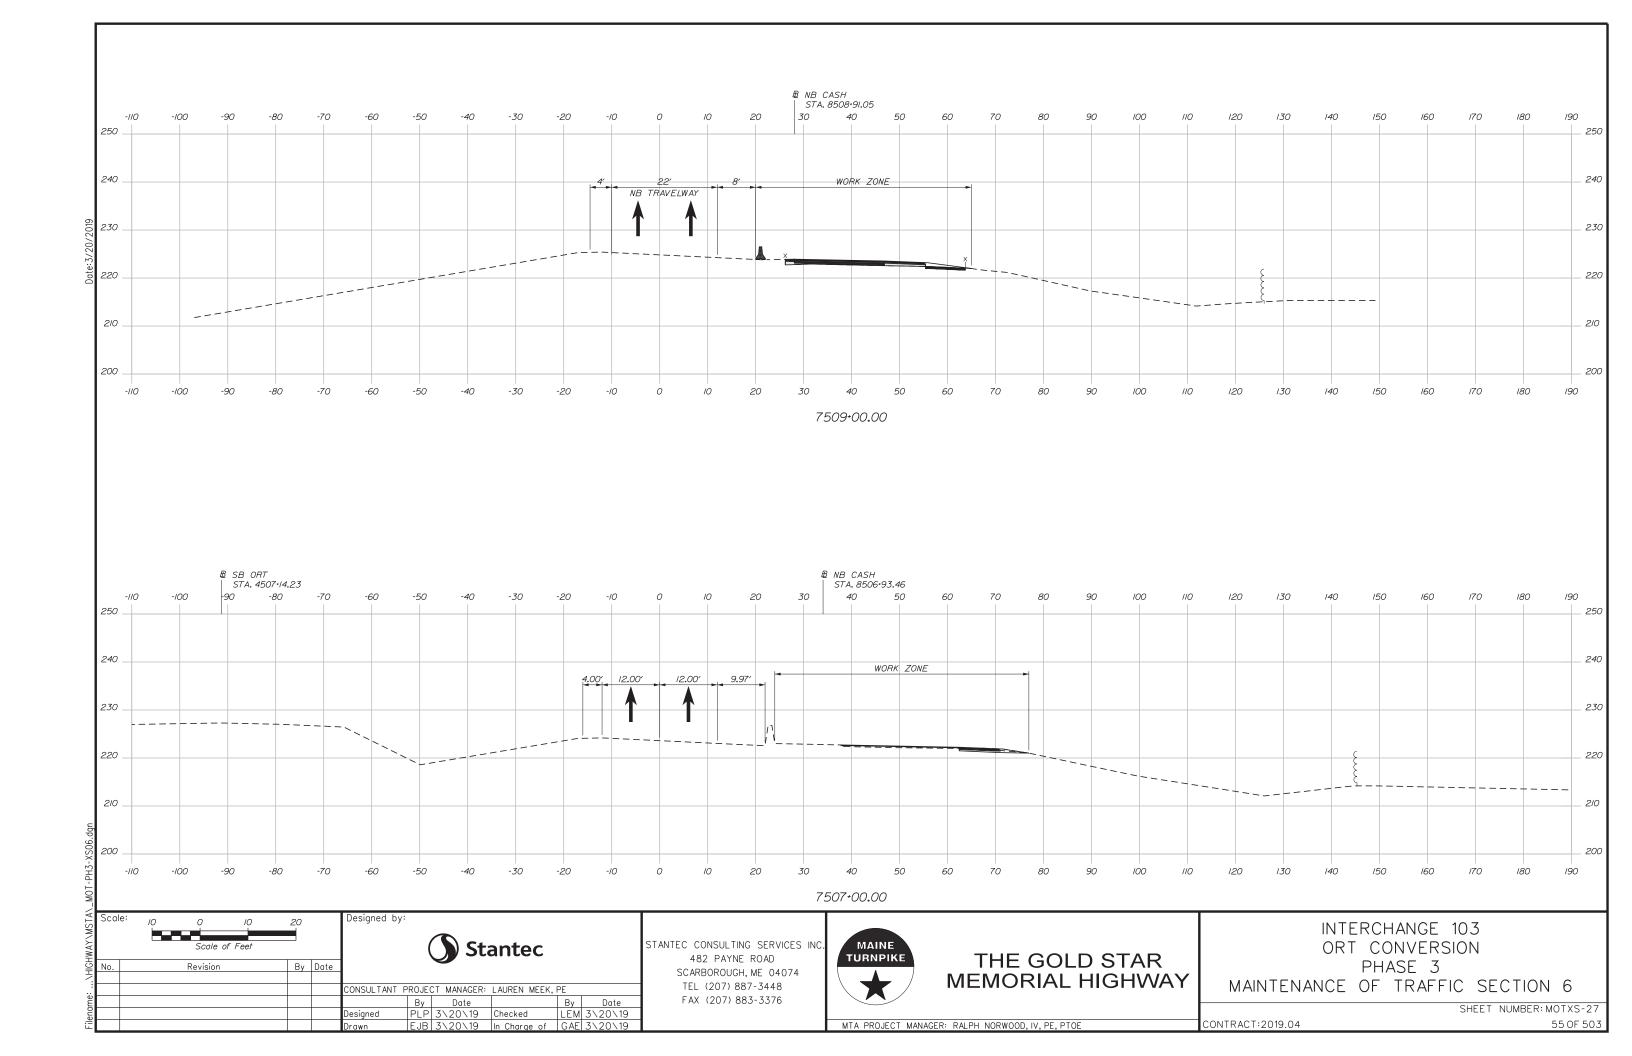


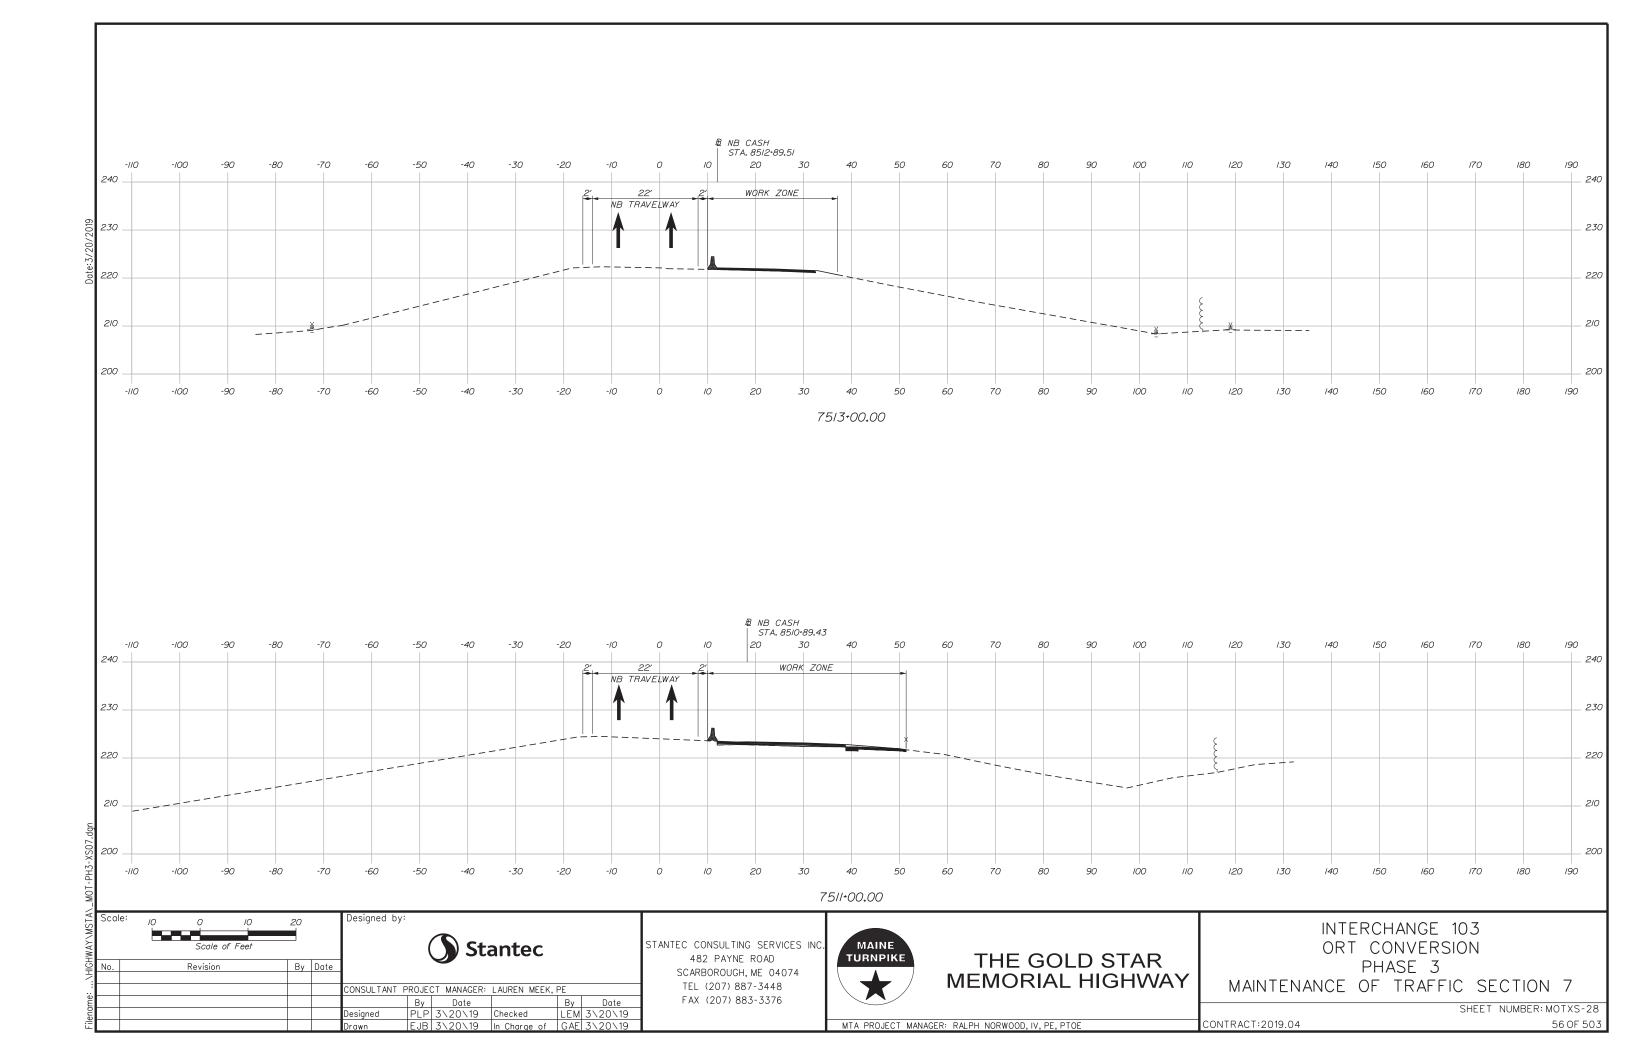


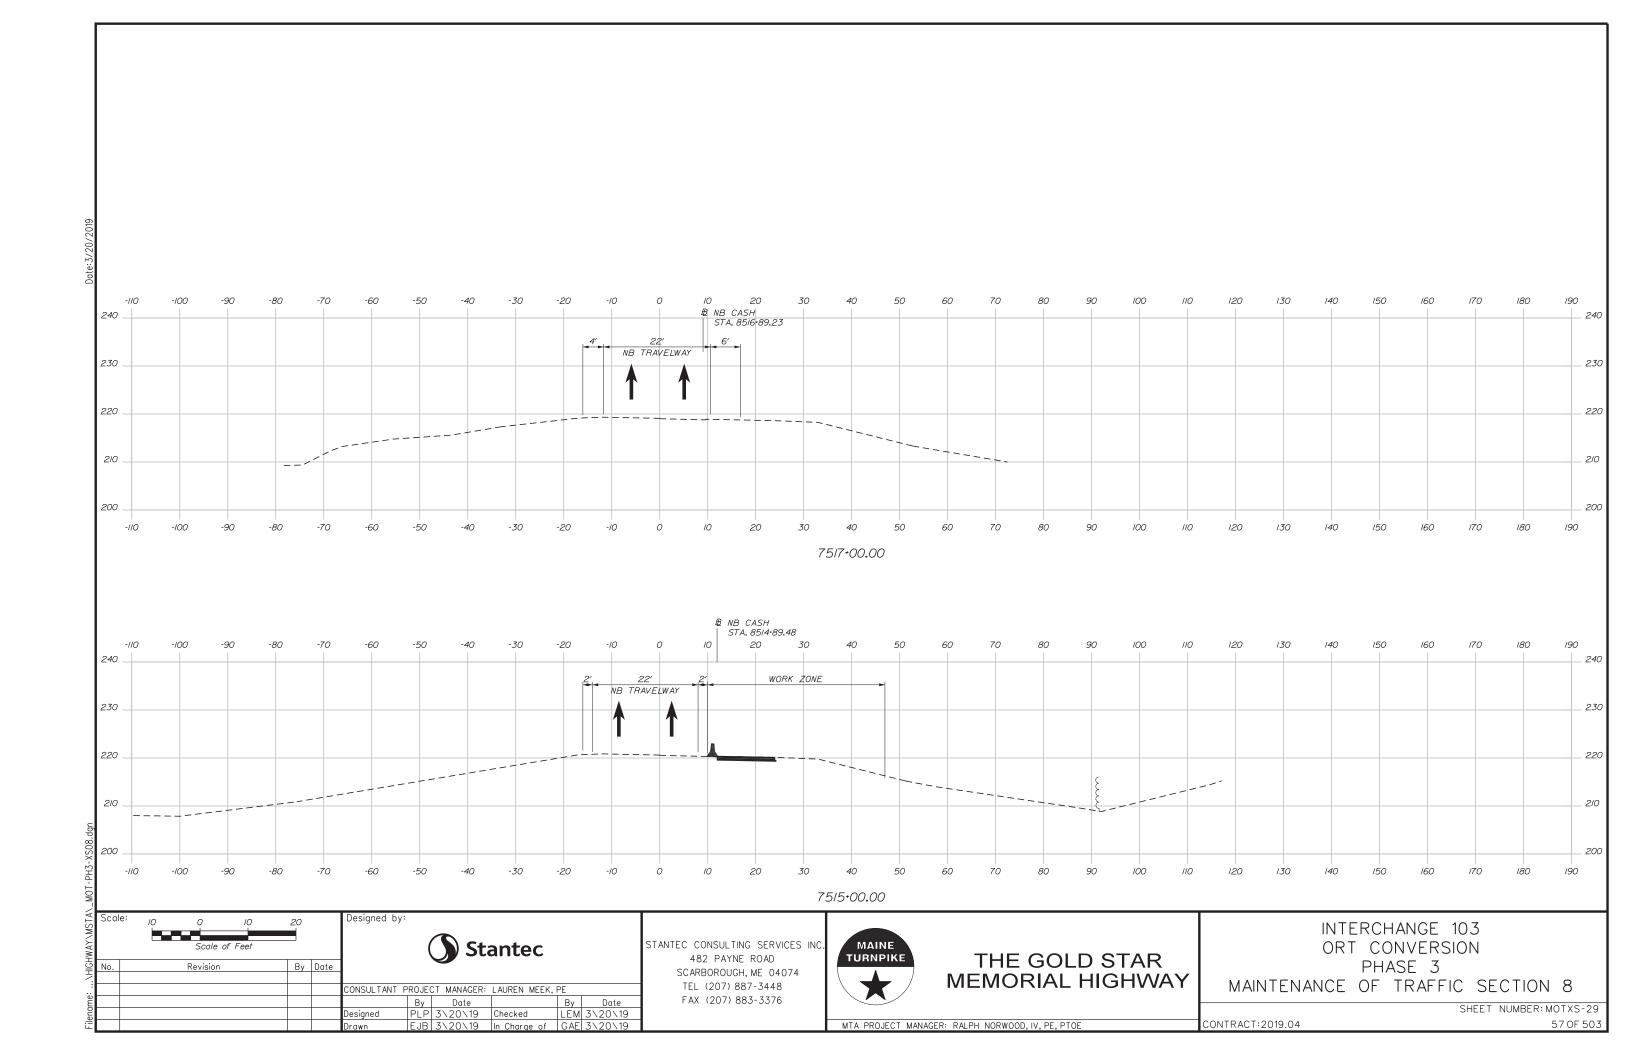

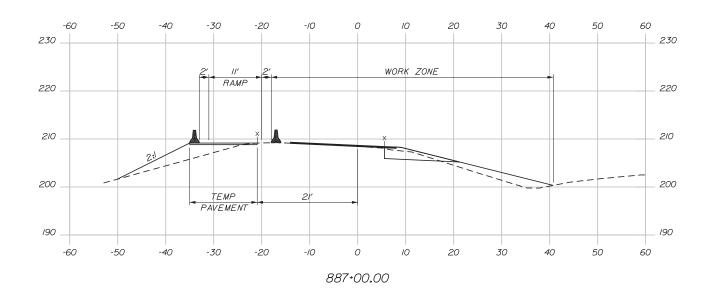


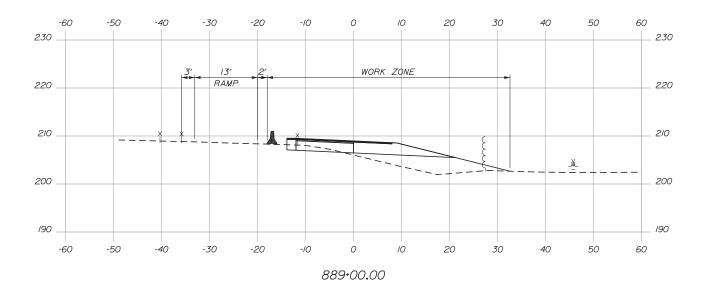

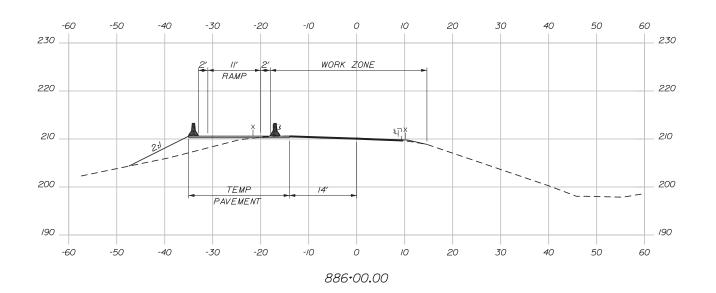

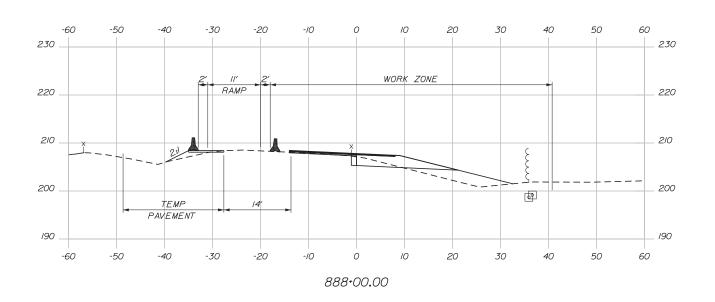

CONTRACT:2019.04

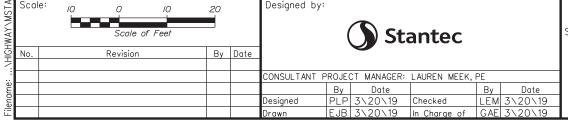

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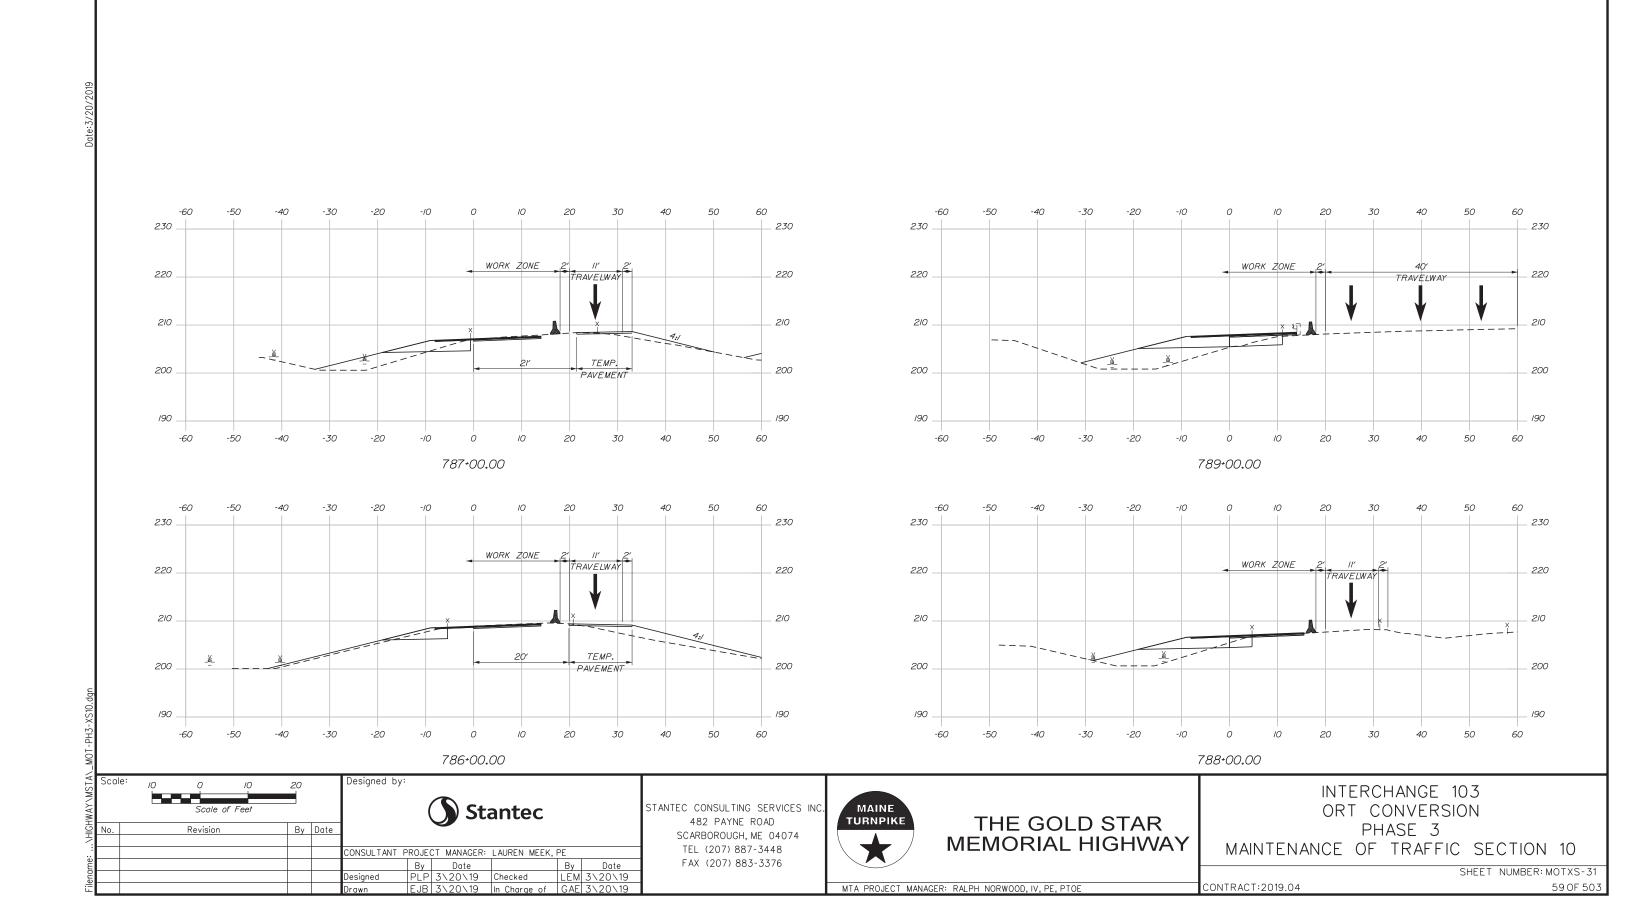


THE GOLD STAR **MEMORIAL HIGHWAY**


INTERCHANGE 103 ORT CONVERSION PHASE 3 MAINTENANCE OF TRAFFIC SECTION 9


SHEET NUMBER: MOTXS-30


MTA PROJECT MANAGER: RALPH NORWOOD, IV, PE, PTOE





WINTER TIME REQUIREMENTS:
CONTRACTOR SHALL SUFFICIENTLY COMPLETE CONSTRUCTION ON 1-295
NORTHBOUND AND SOUTHBOUND PRIOR TO NOVEMBER 16, 2019, OR NOVEMBER 16,
2020 SO ALL RIGHT SIDE TEMPORARY CONCRETE BARRIER IS REMOVED OR
THE TEMPORARY CONCRETE BARRIER IS RELOCATED TO PROVIDE A RIGHT
SHOULDER 8 FEET WIDE OR GREATER, FROM NOVEMBER 15, 2019 TO APRIL 15,
2020 AND FROM NOVEMBER 16, 2020 THROUGH APRIL 15, 2021, EXCEPT DURING
PHASE 4 IN THE SOUTHBOUND DIRECTION FROM STATION 4506-00 TO STATION
4509-00 THE RIGHT SIDE SHOULDER IS REDUCED AS SHOWN ON THE PHASE 4
MAINTENANCE OF TRAFFIC PLANS.

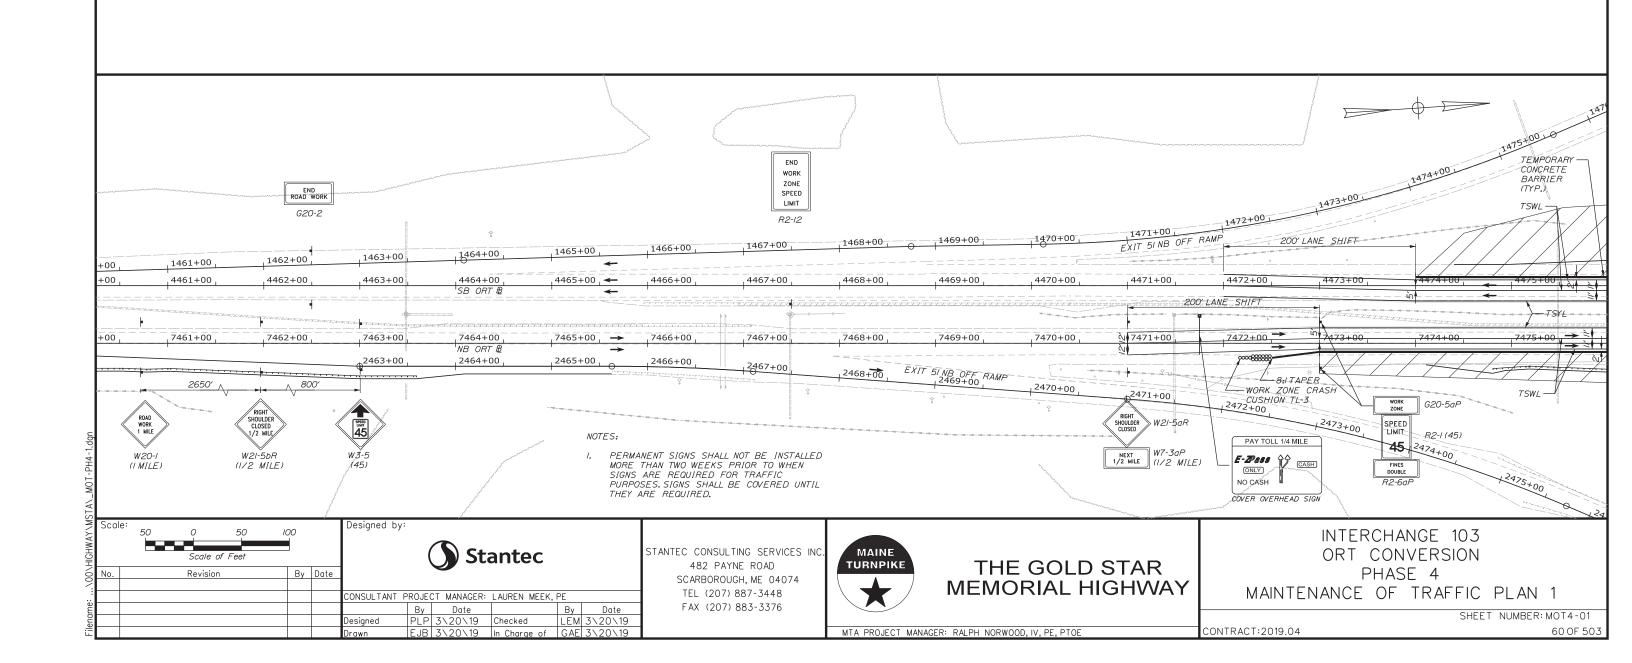


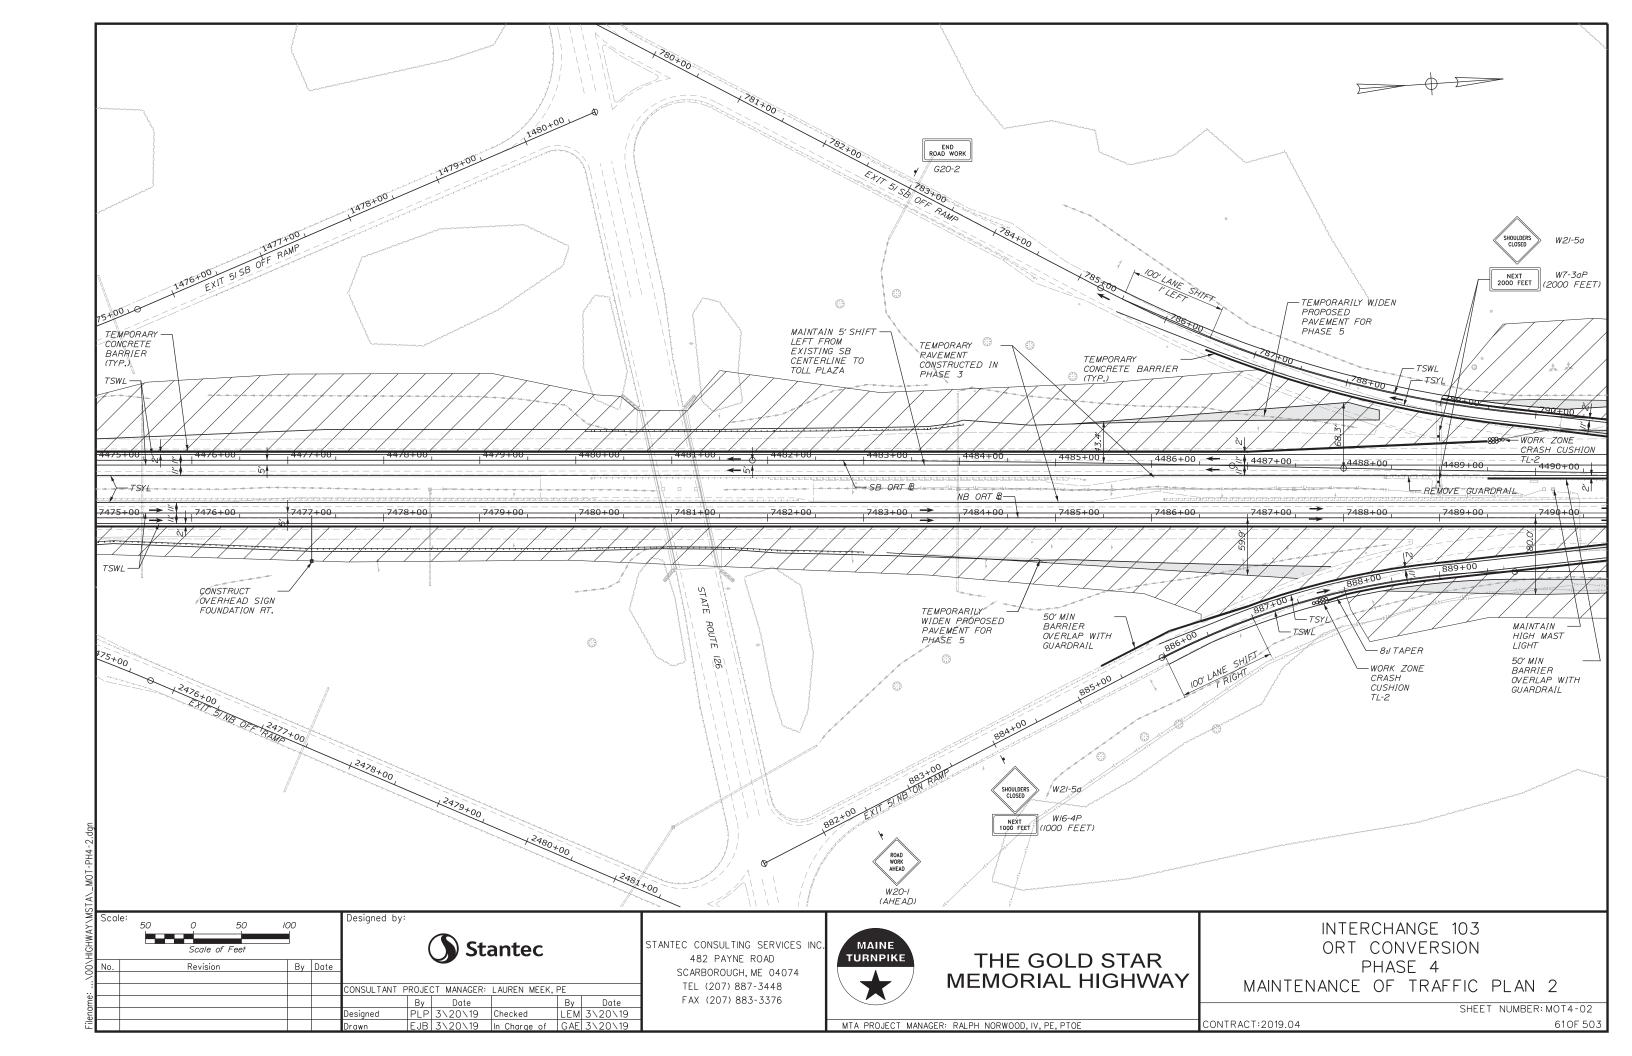


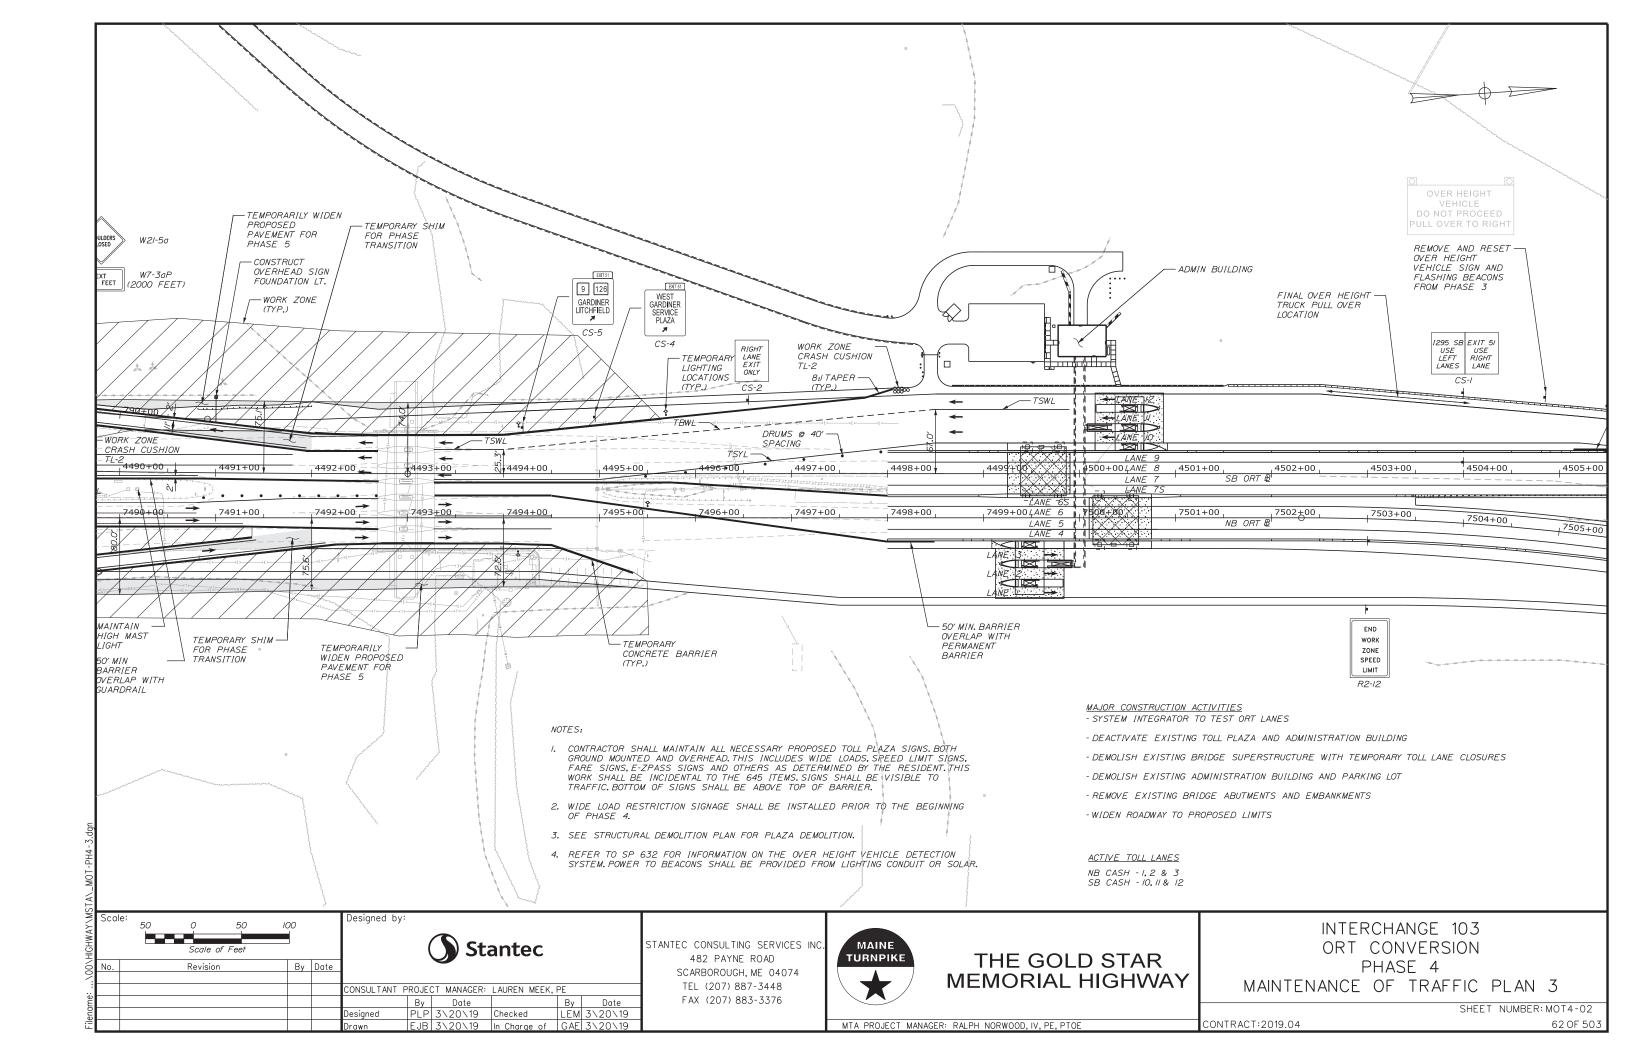


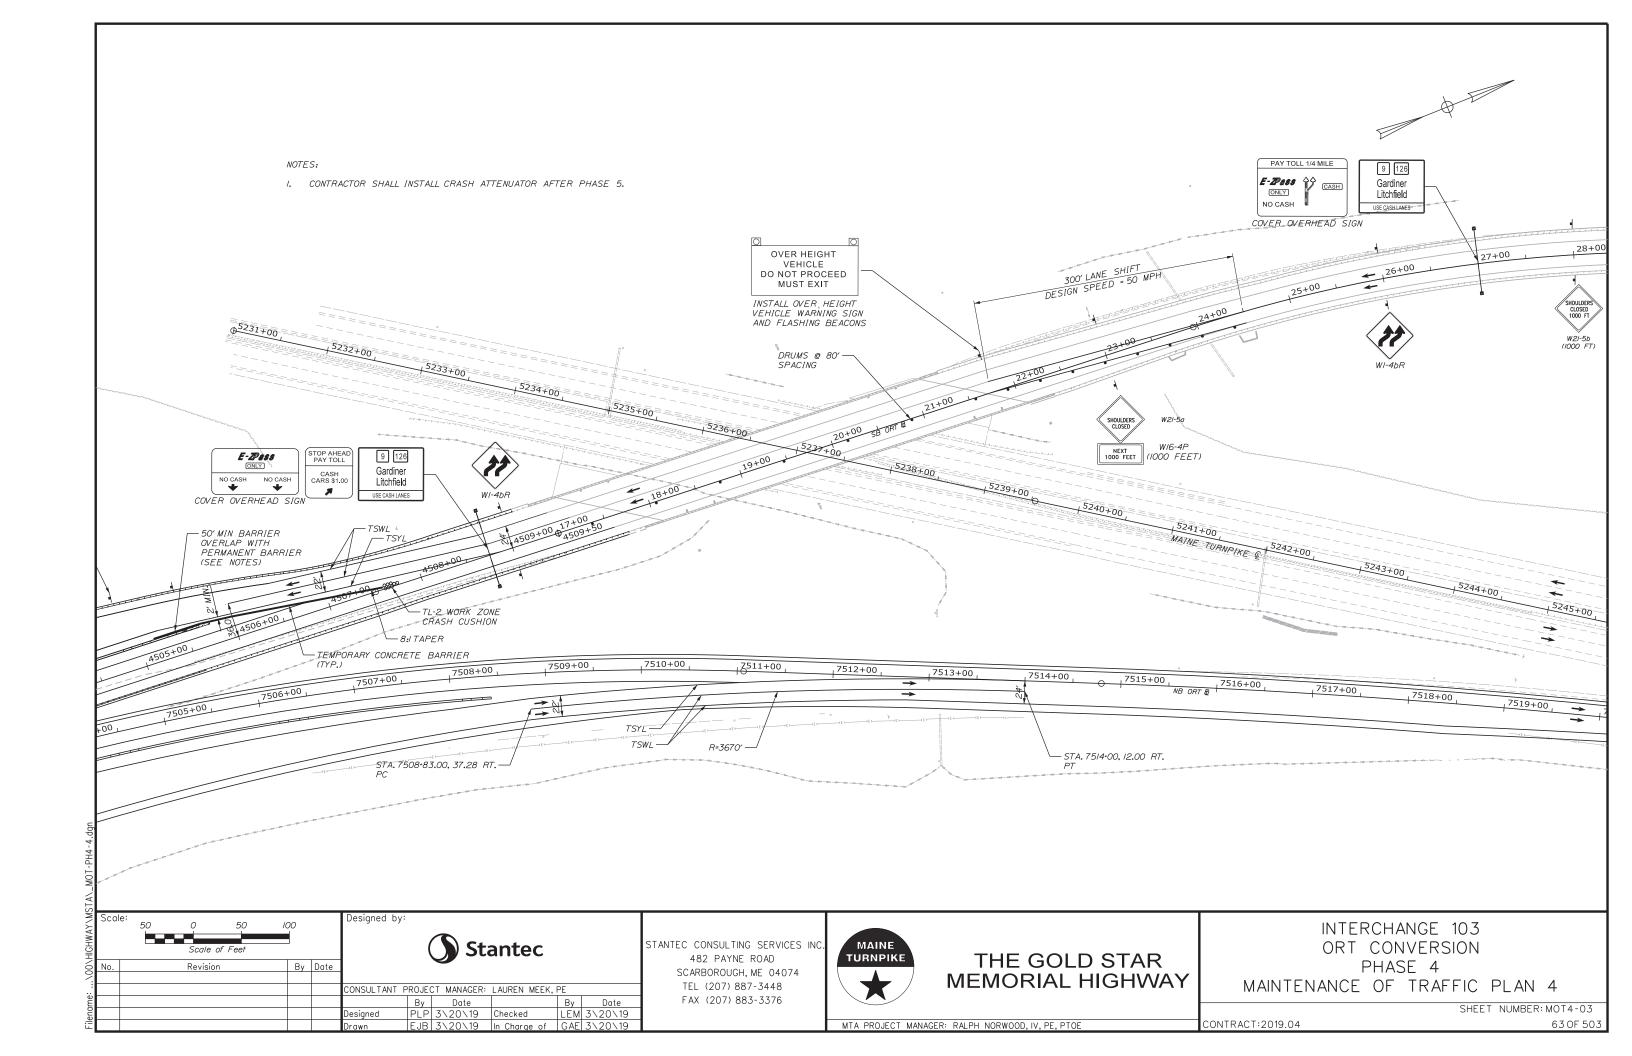


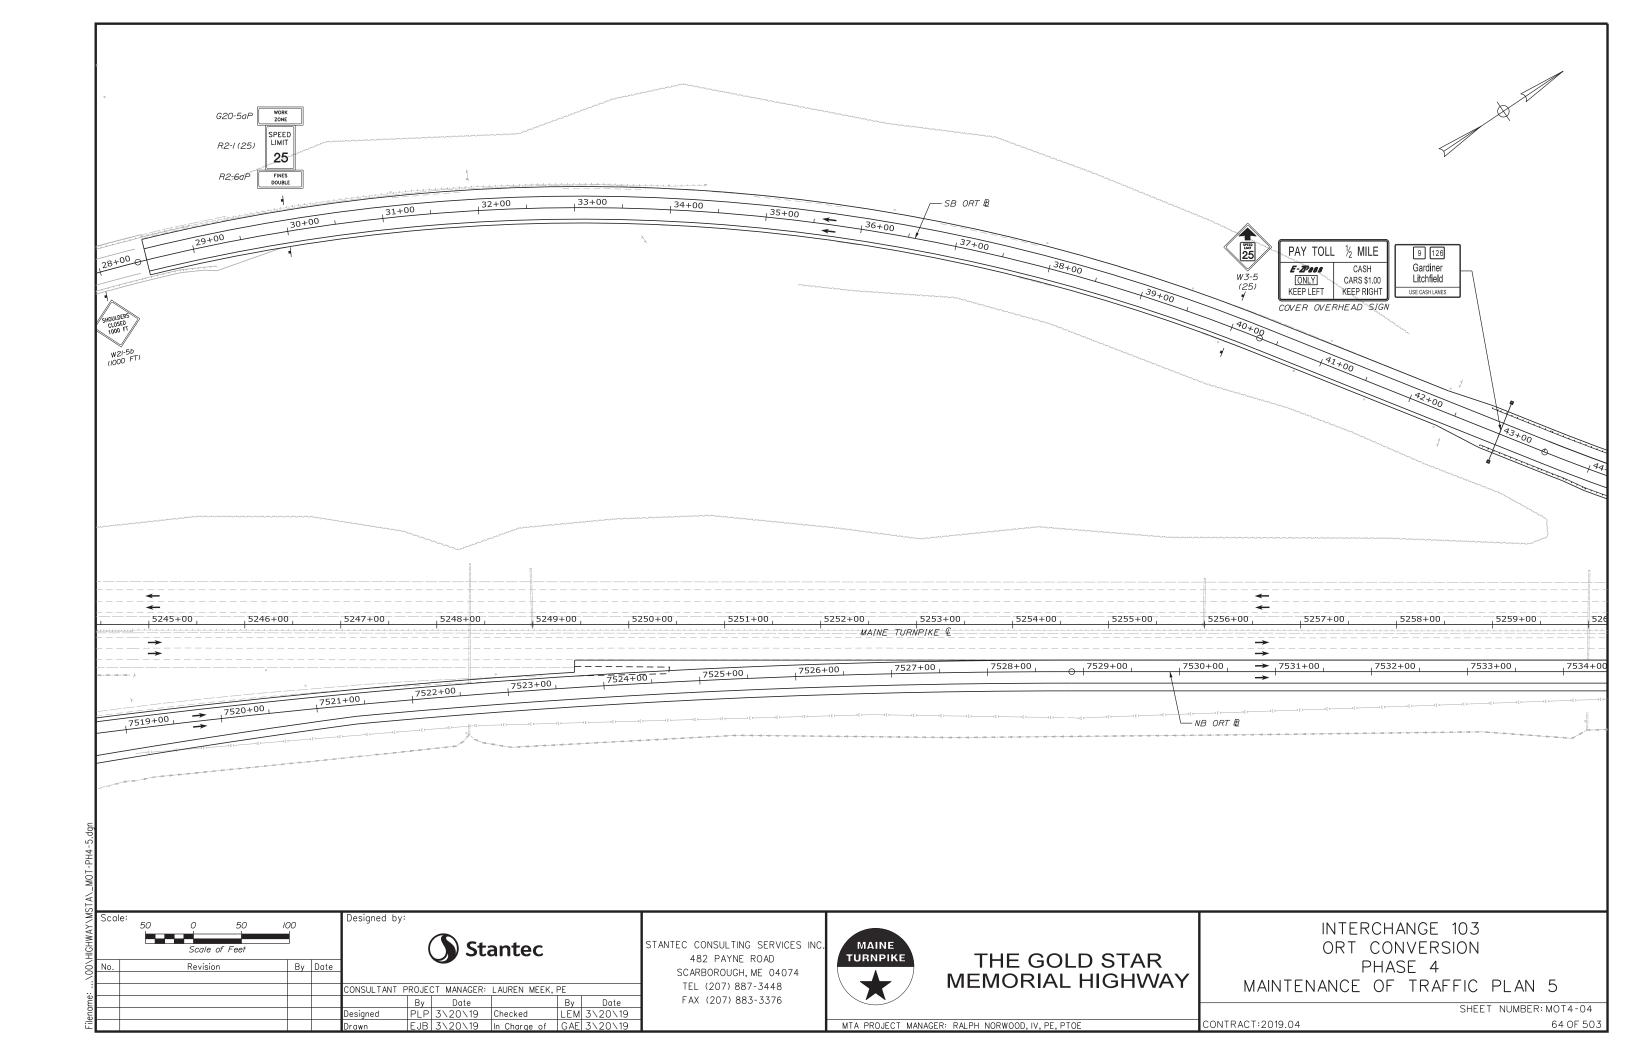


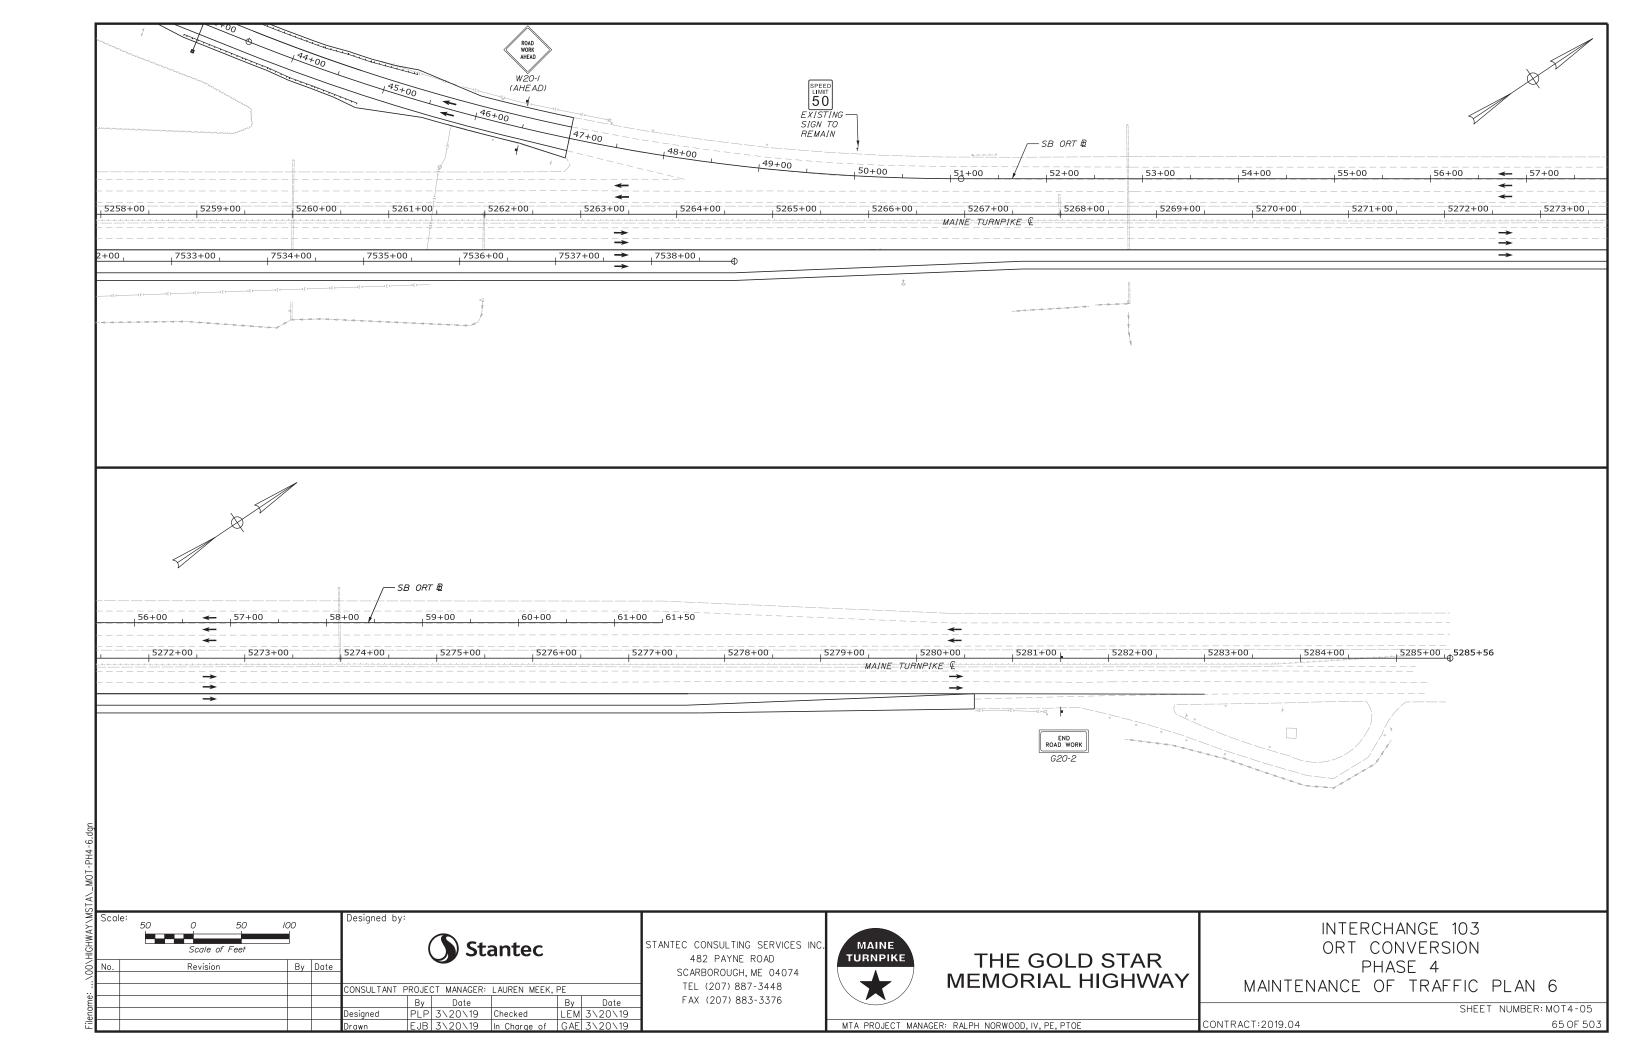


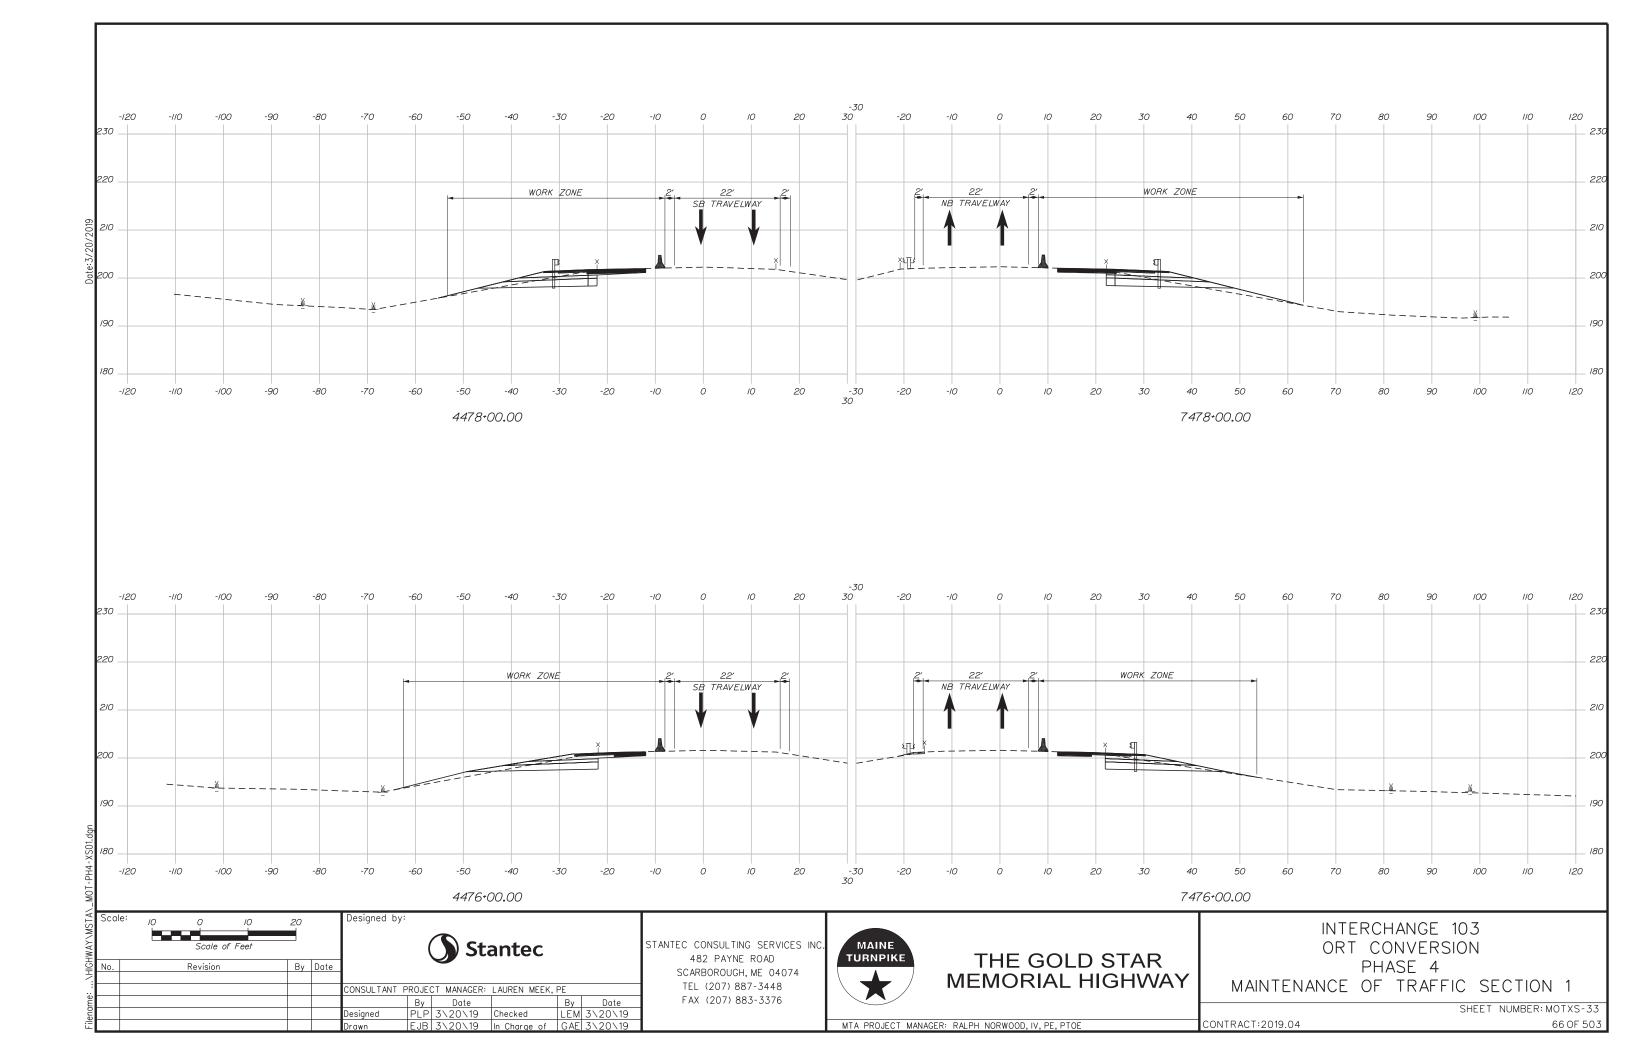


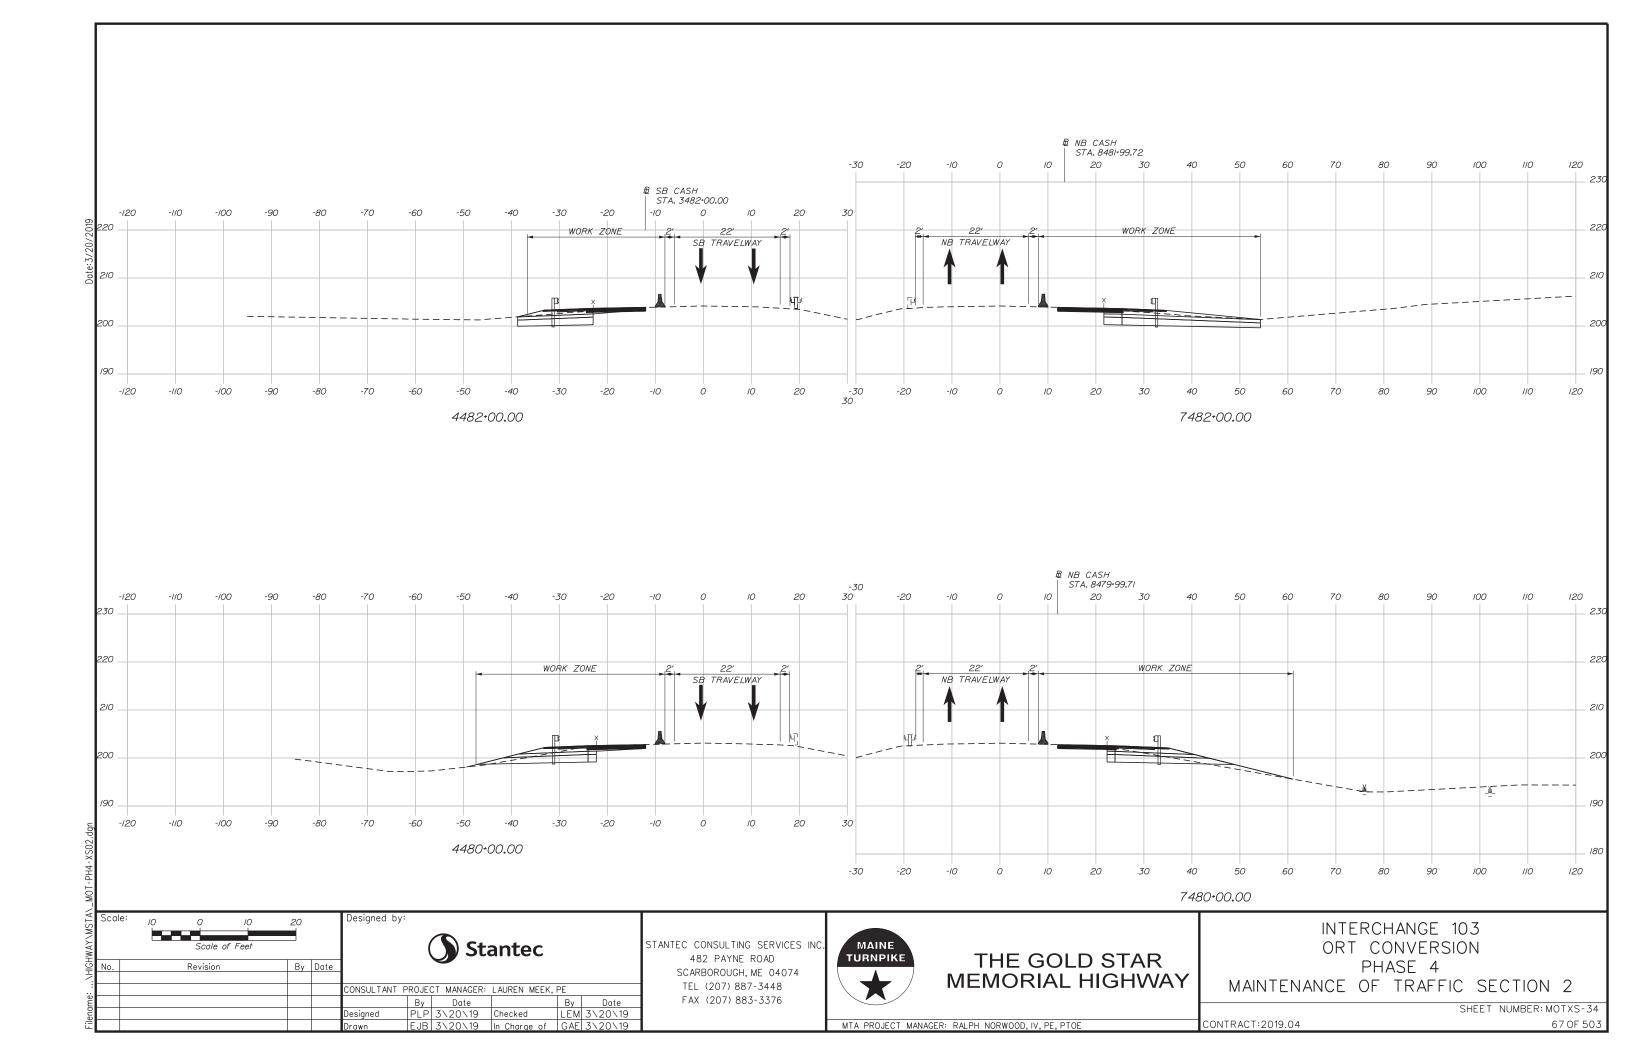


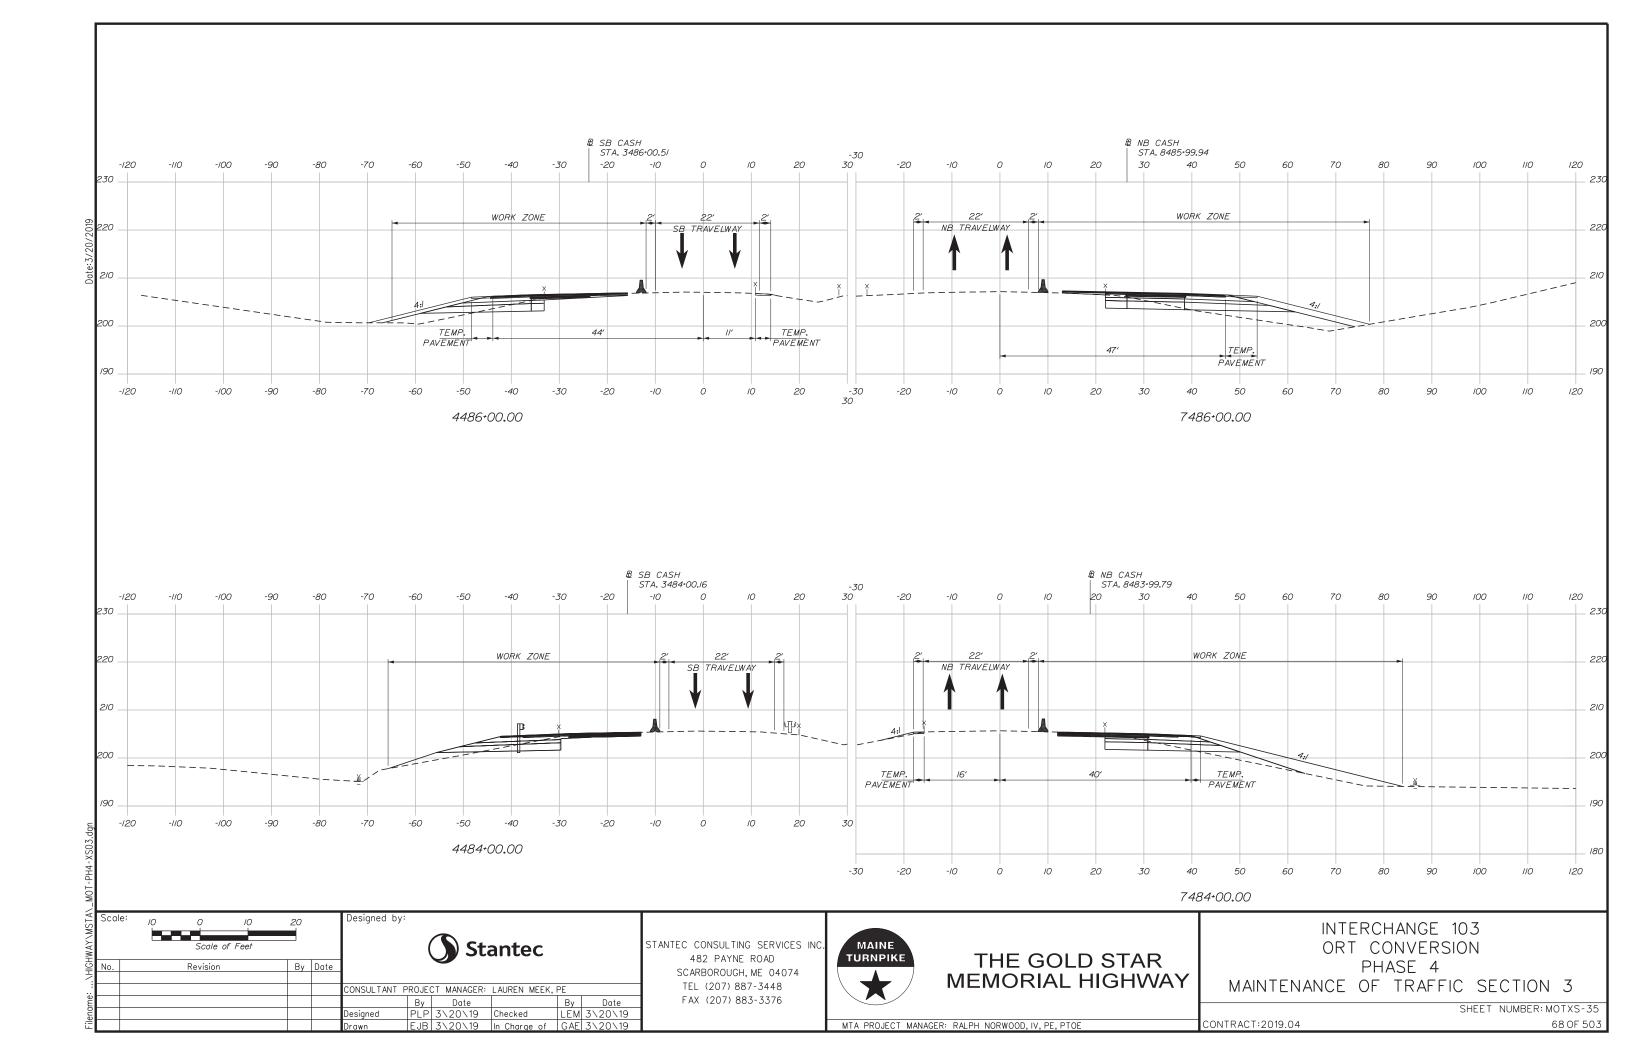


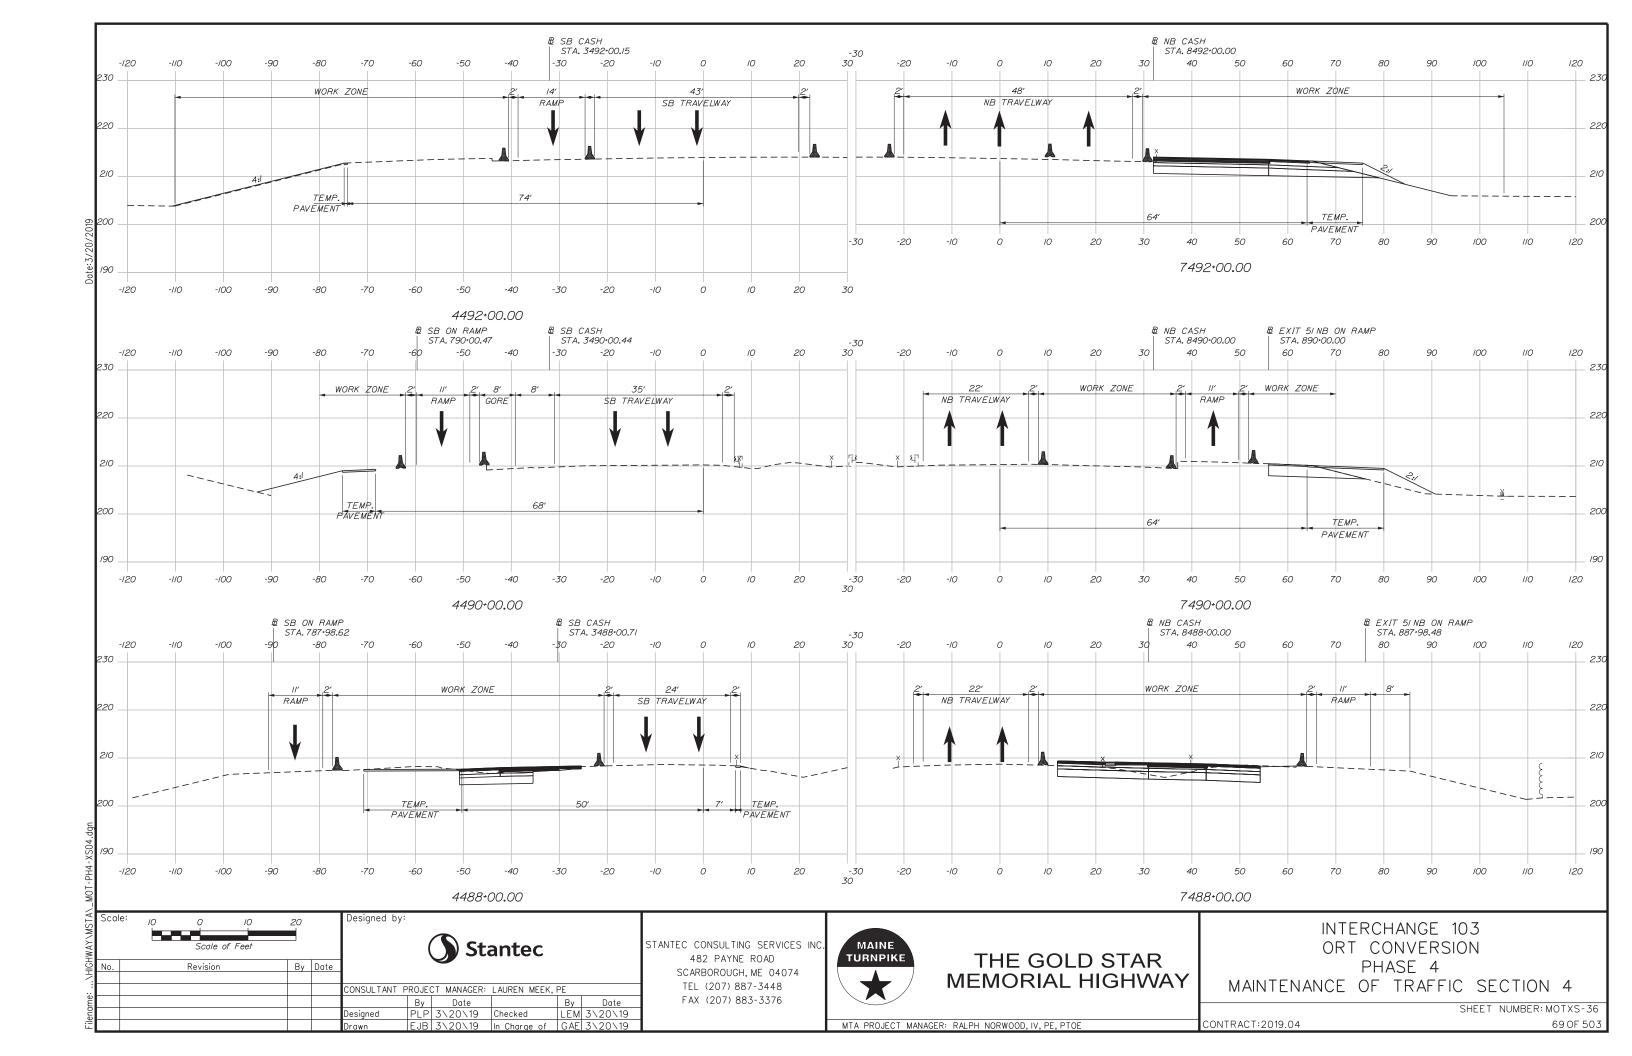


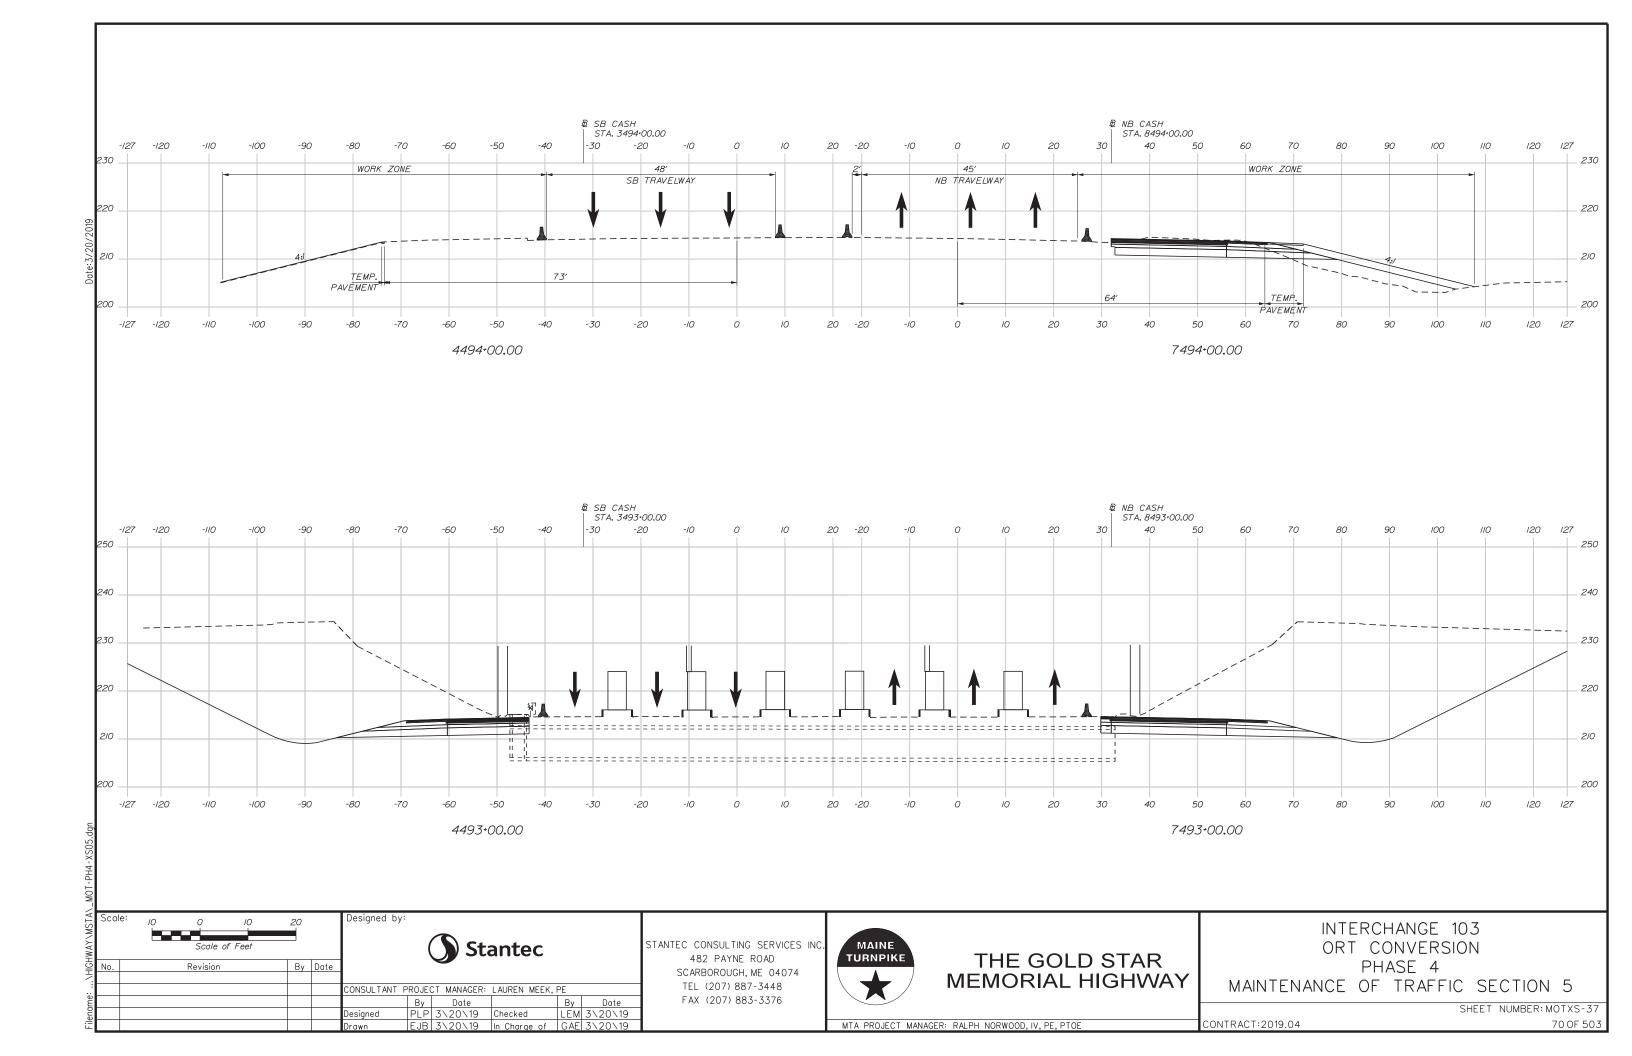

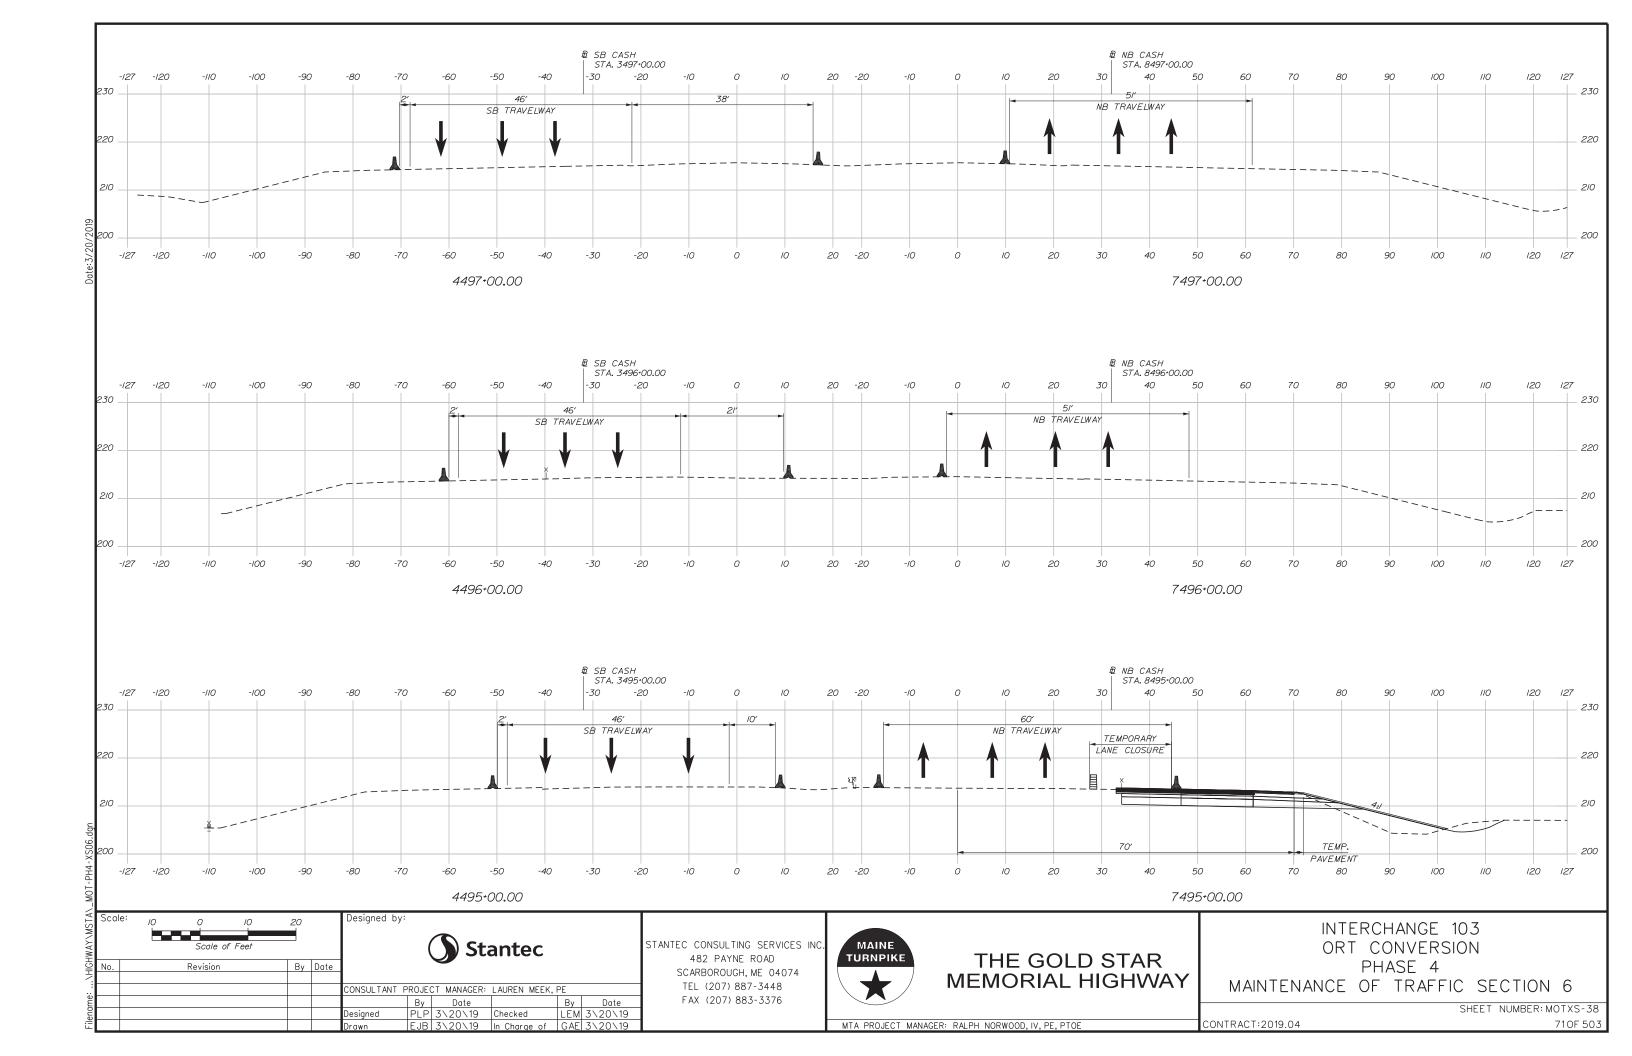

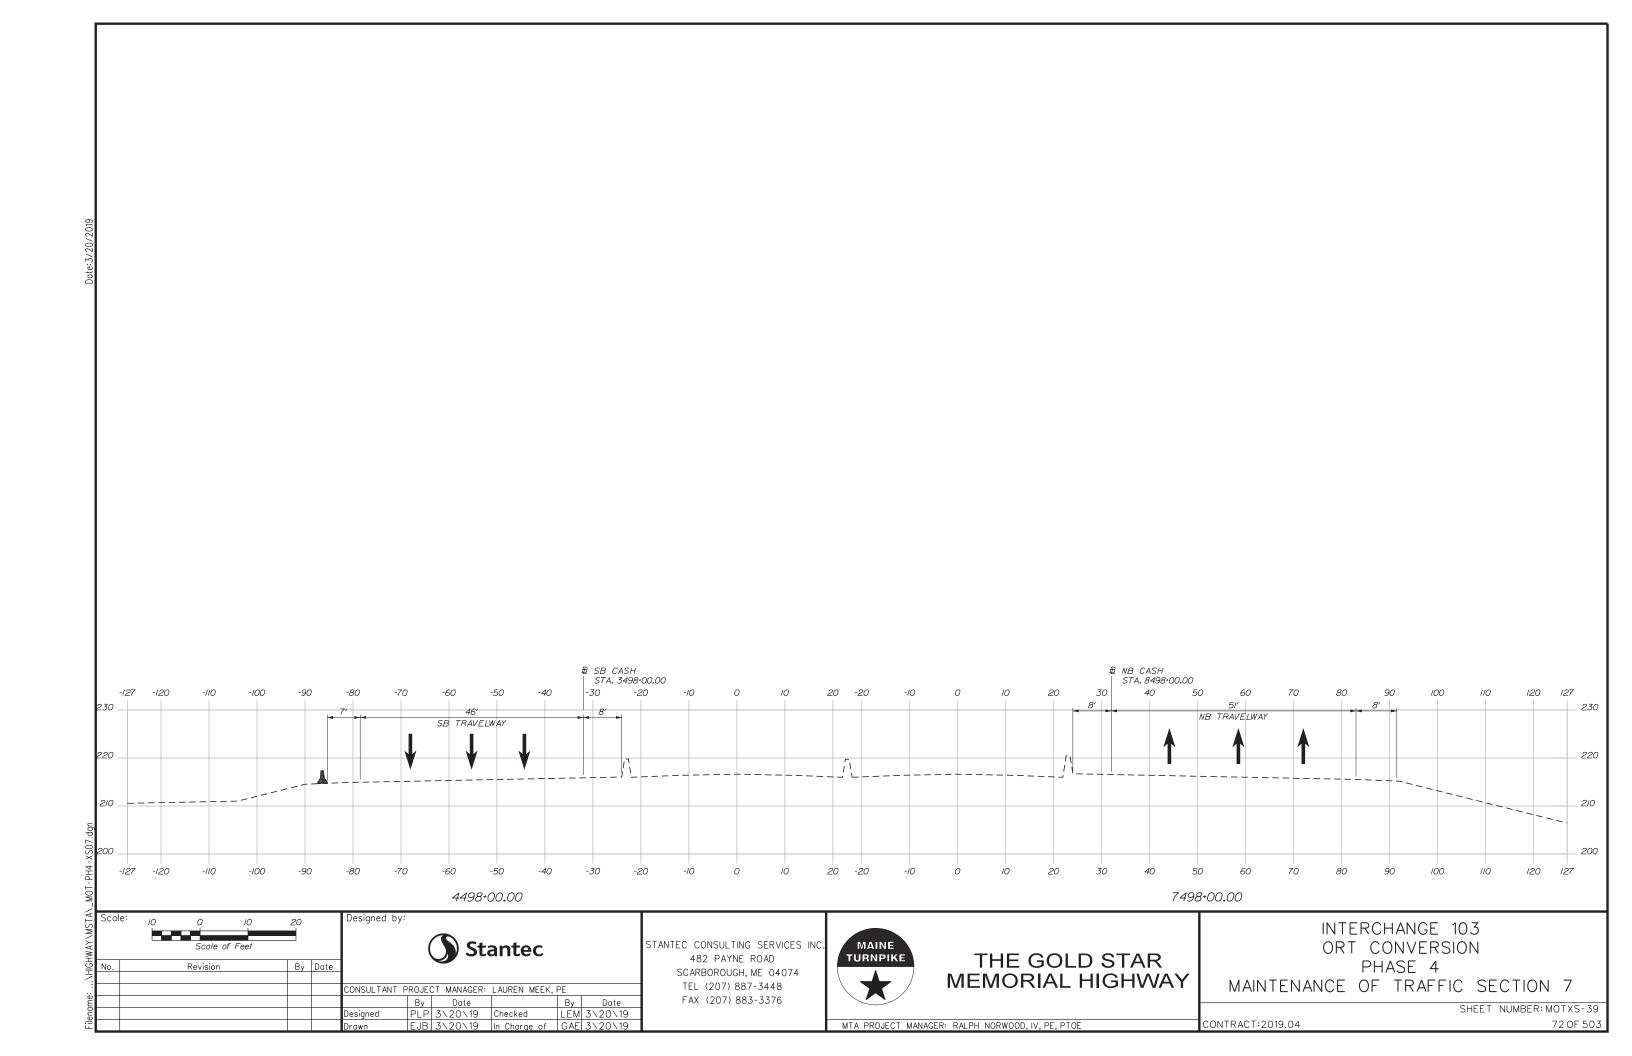

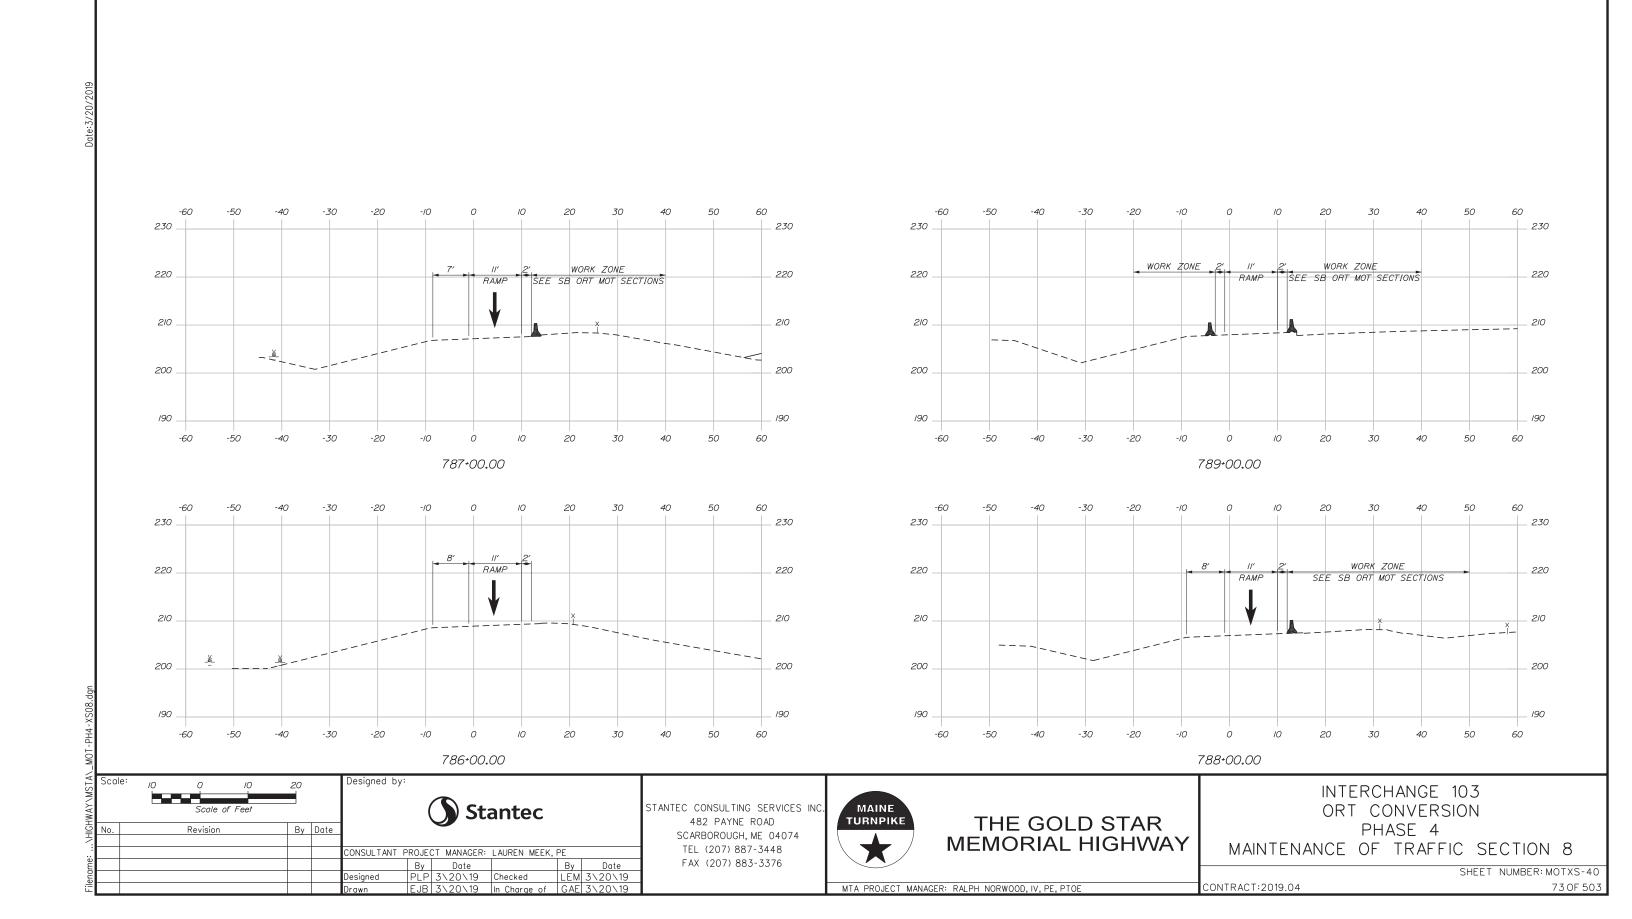


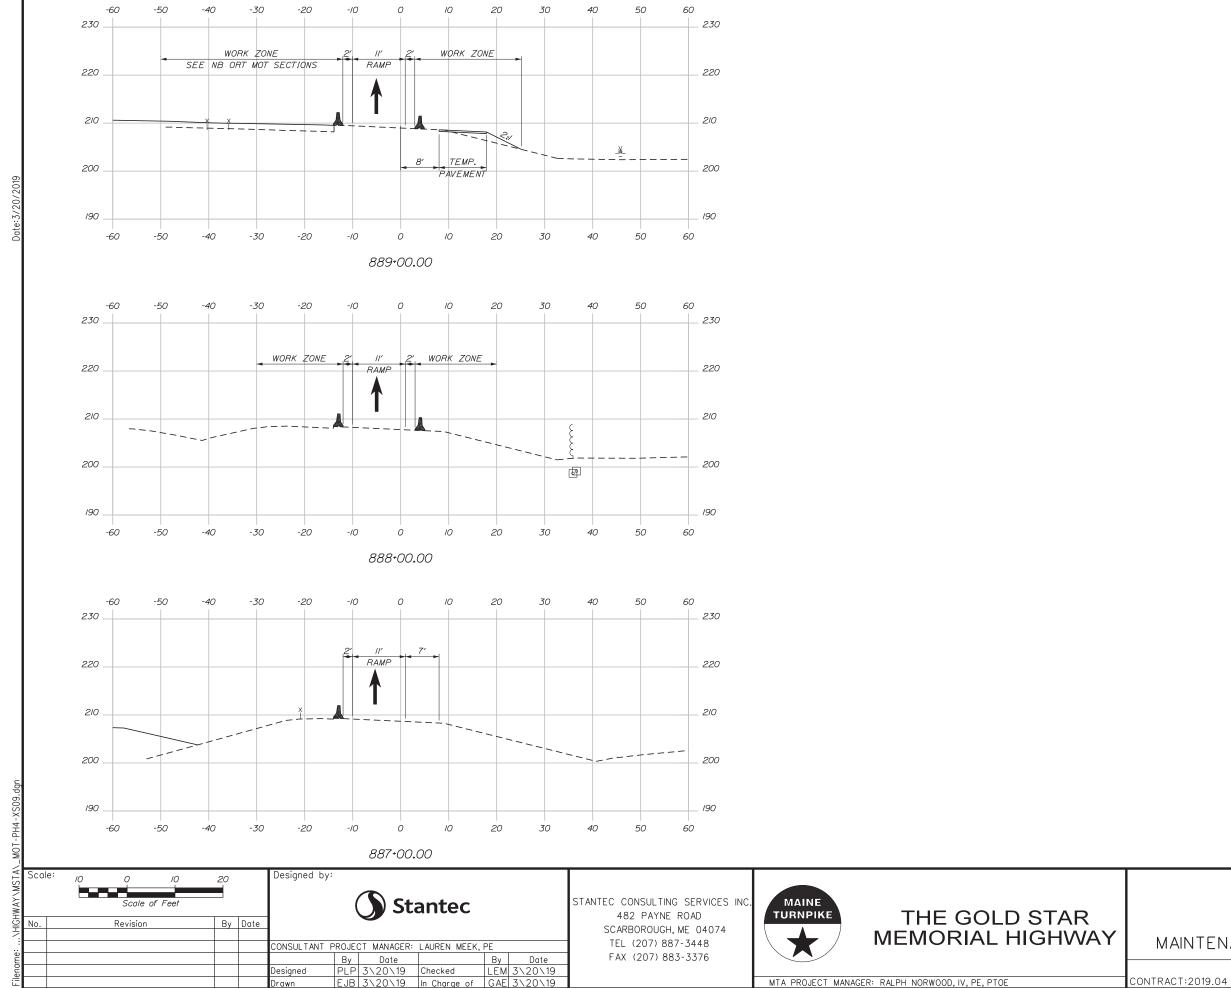



INTERCHANGE 103
ORT CONVERSION
PHASE 4


MAINTENANCE OF TRAFFIC SECTION 9


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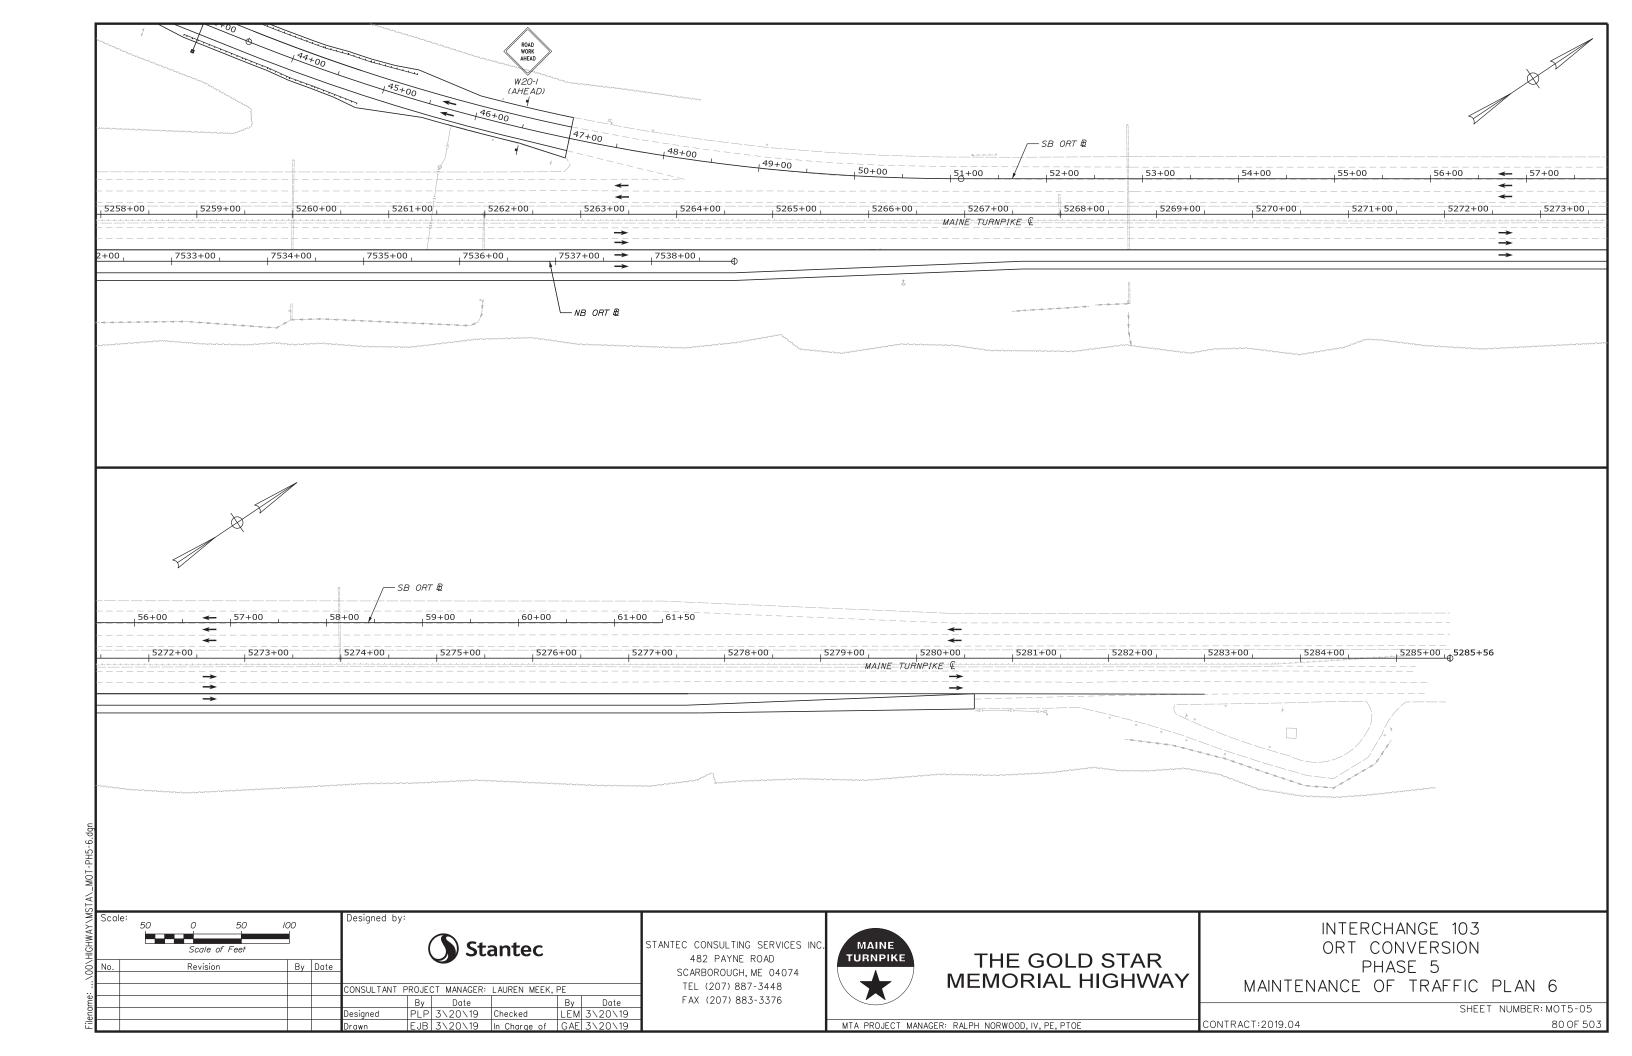


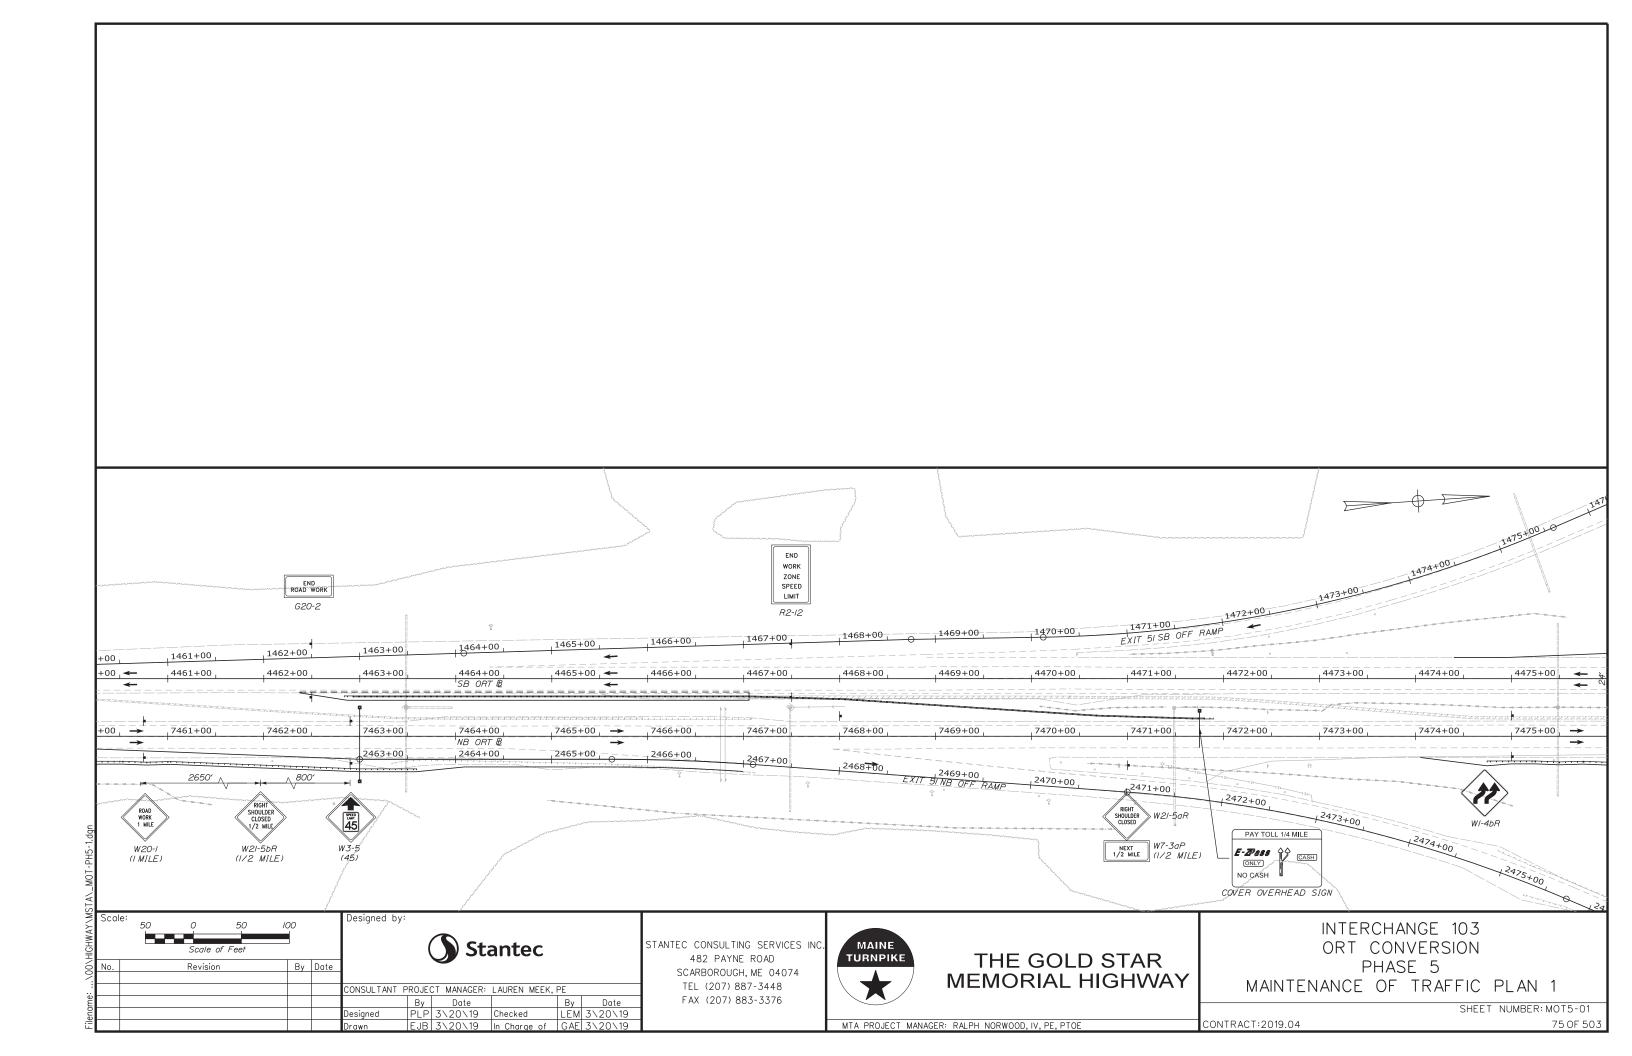


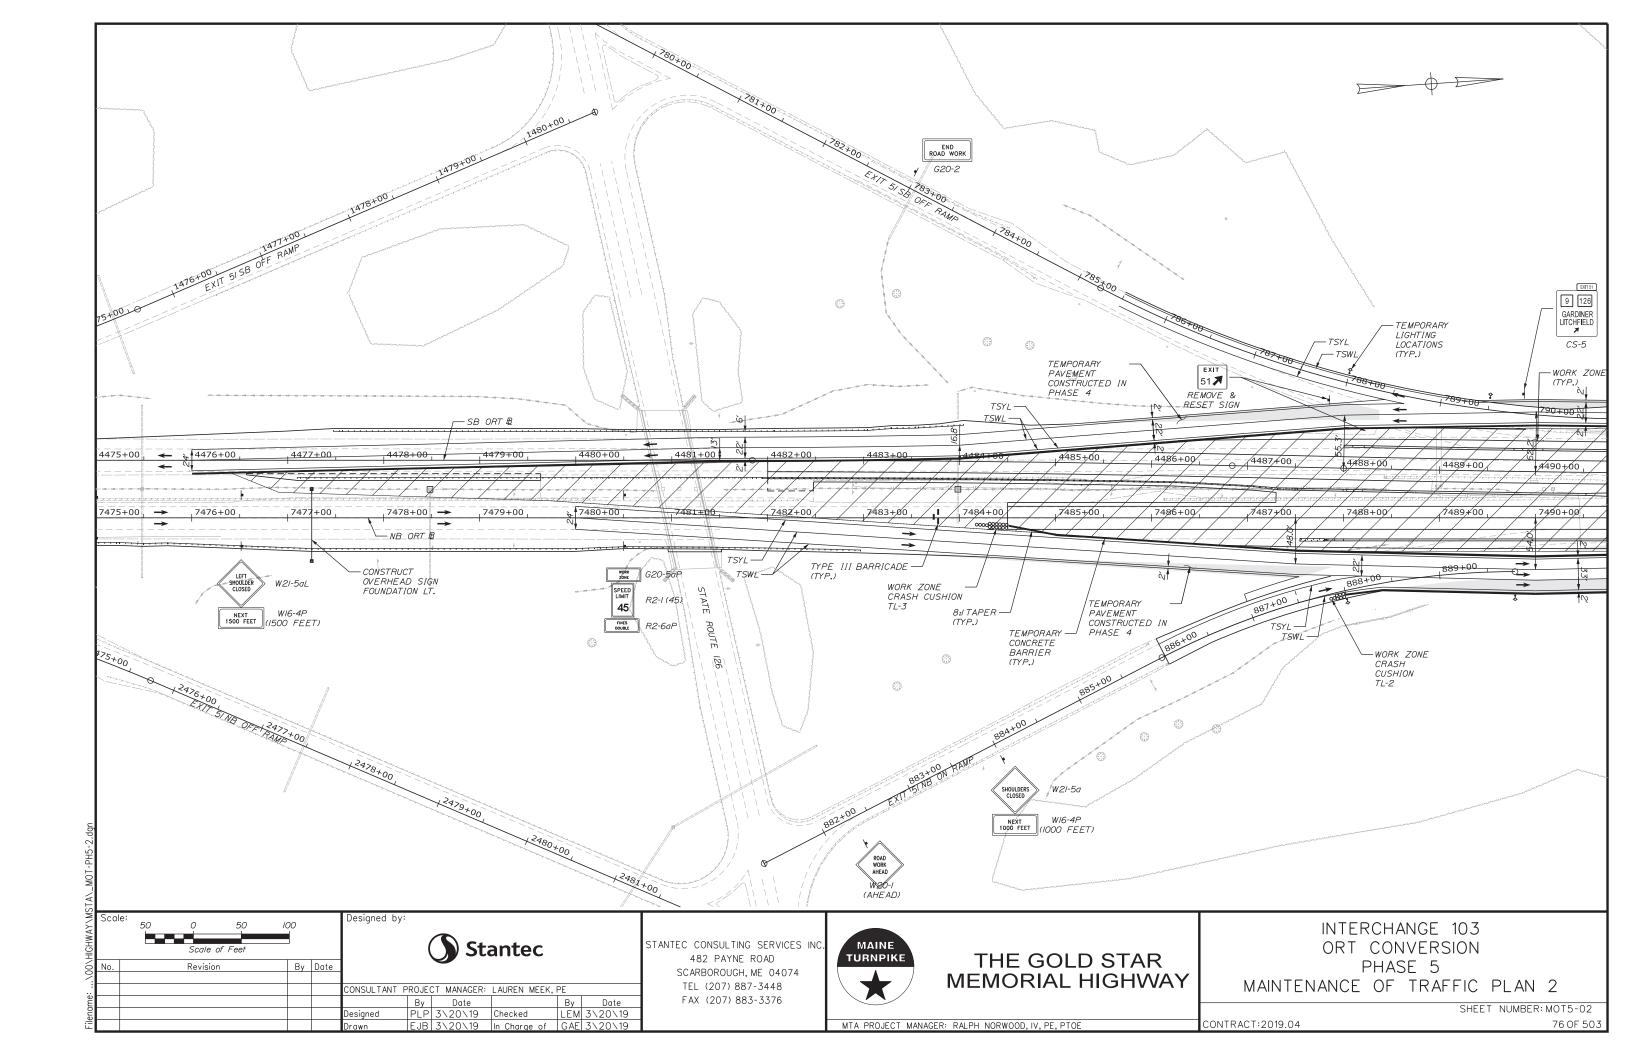


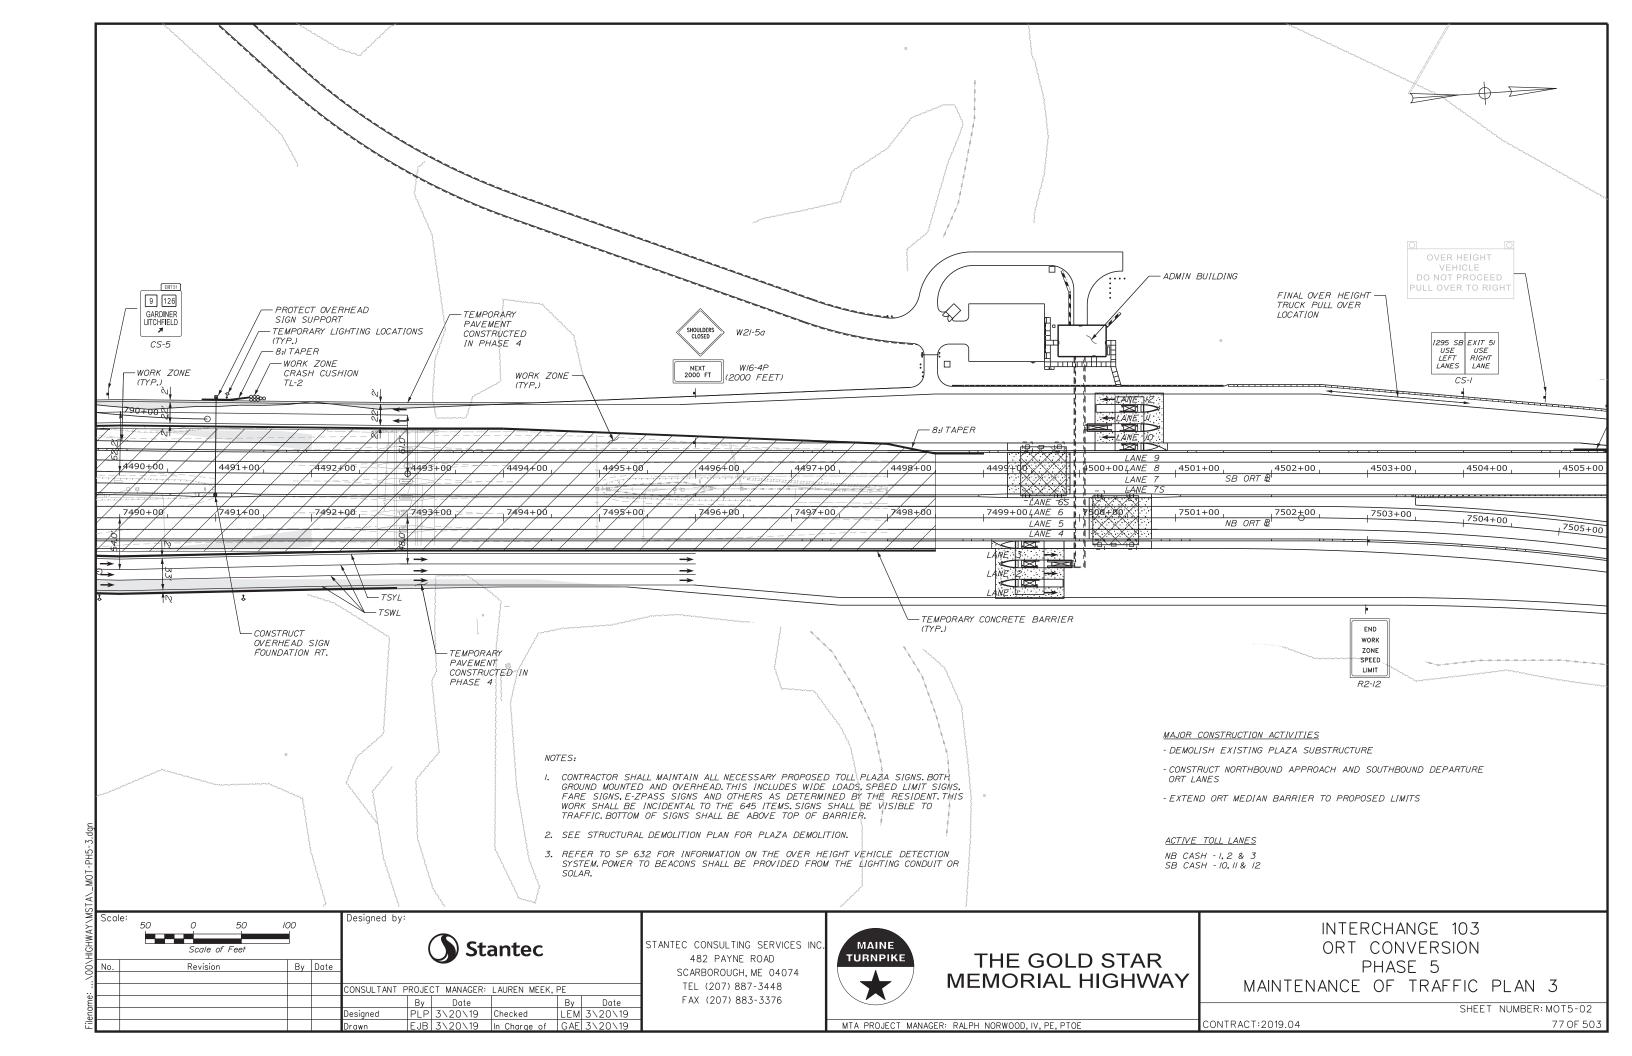


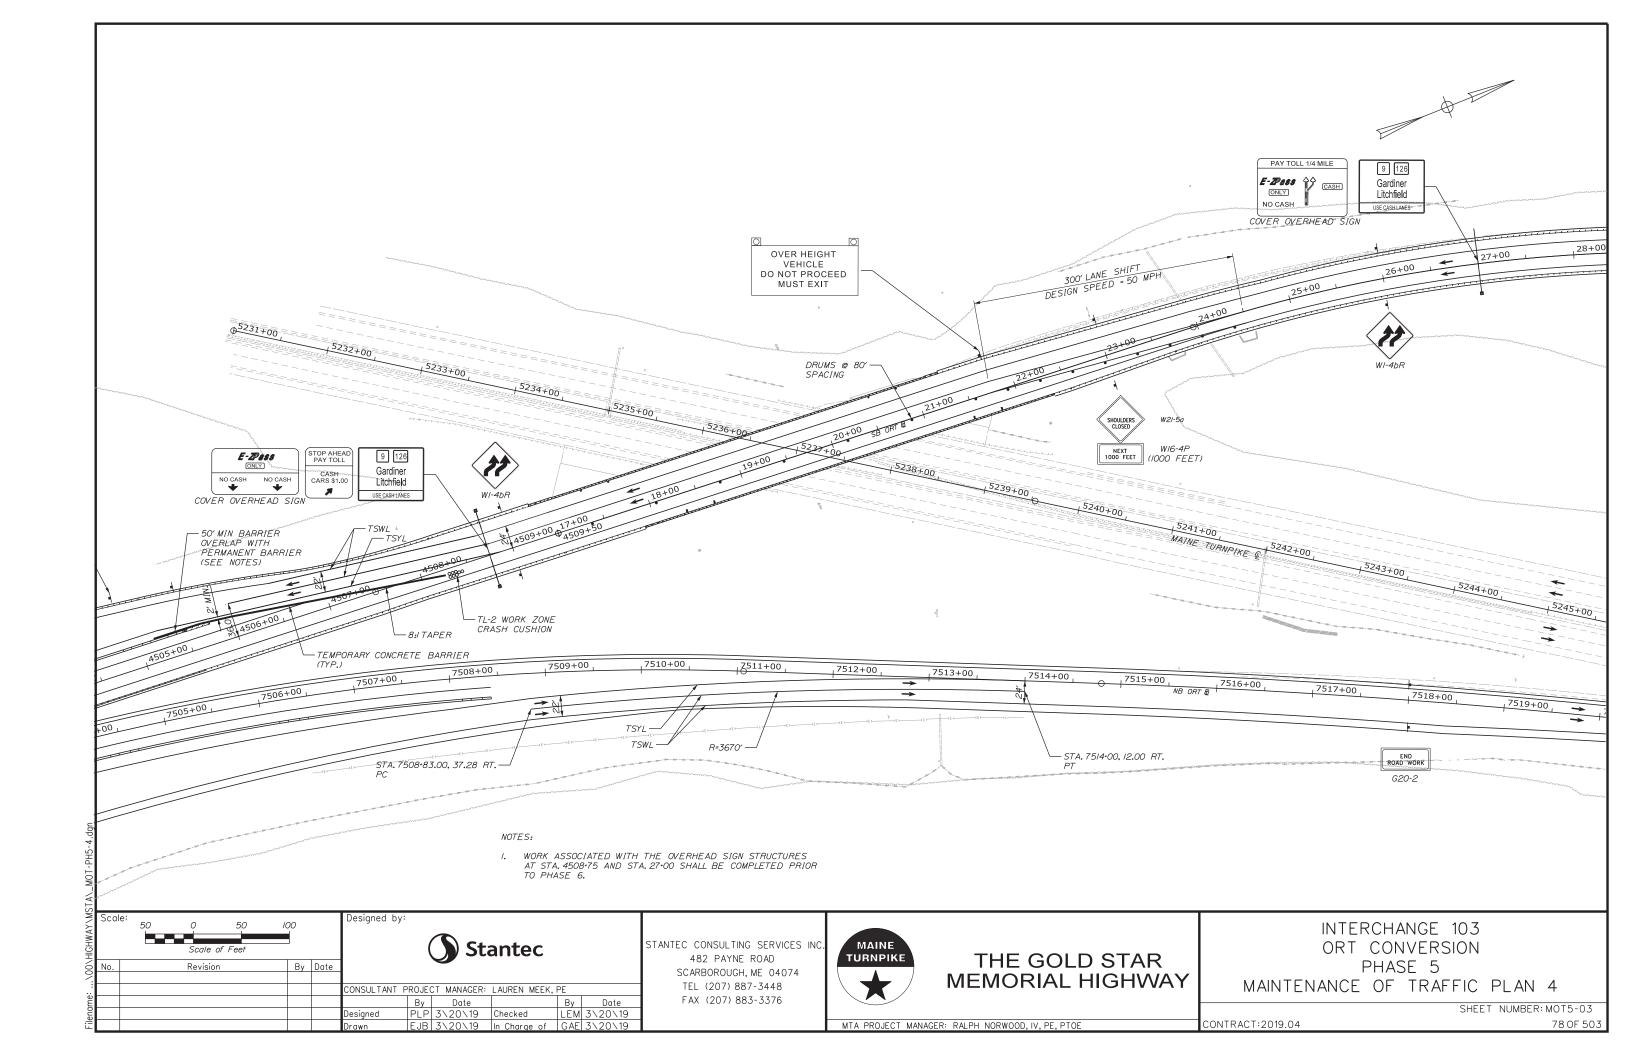


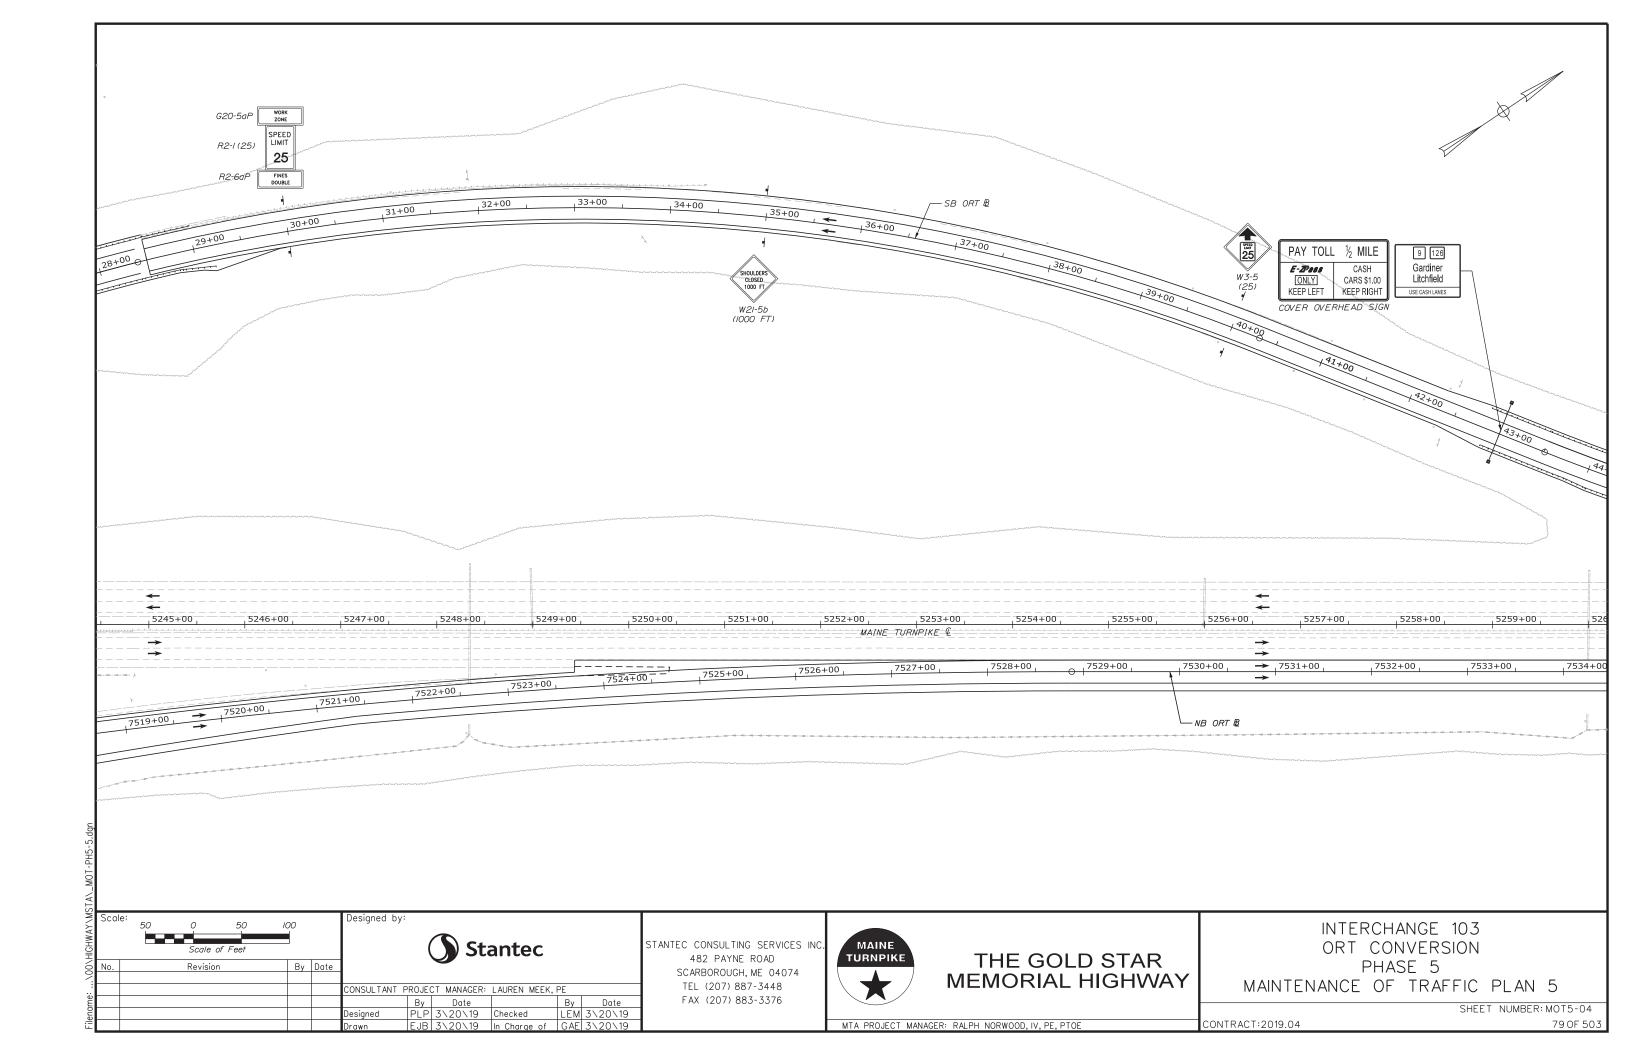


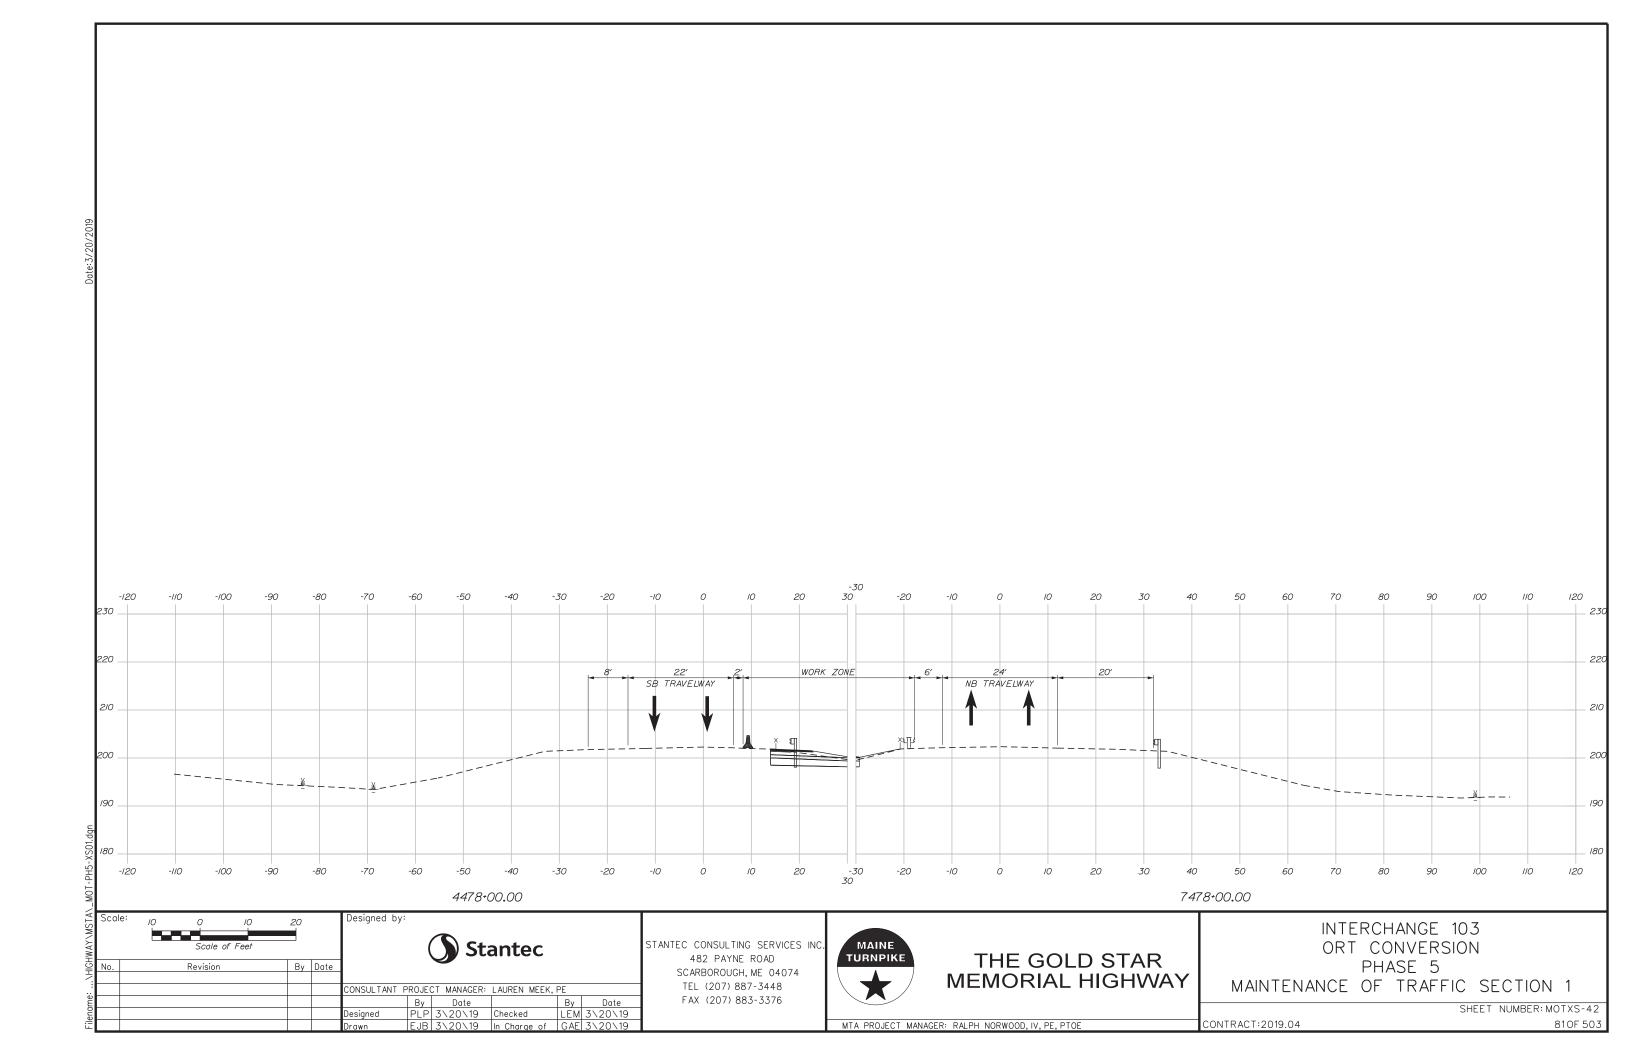


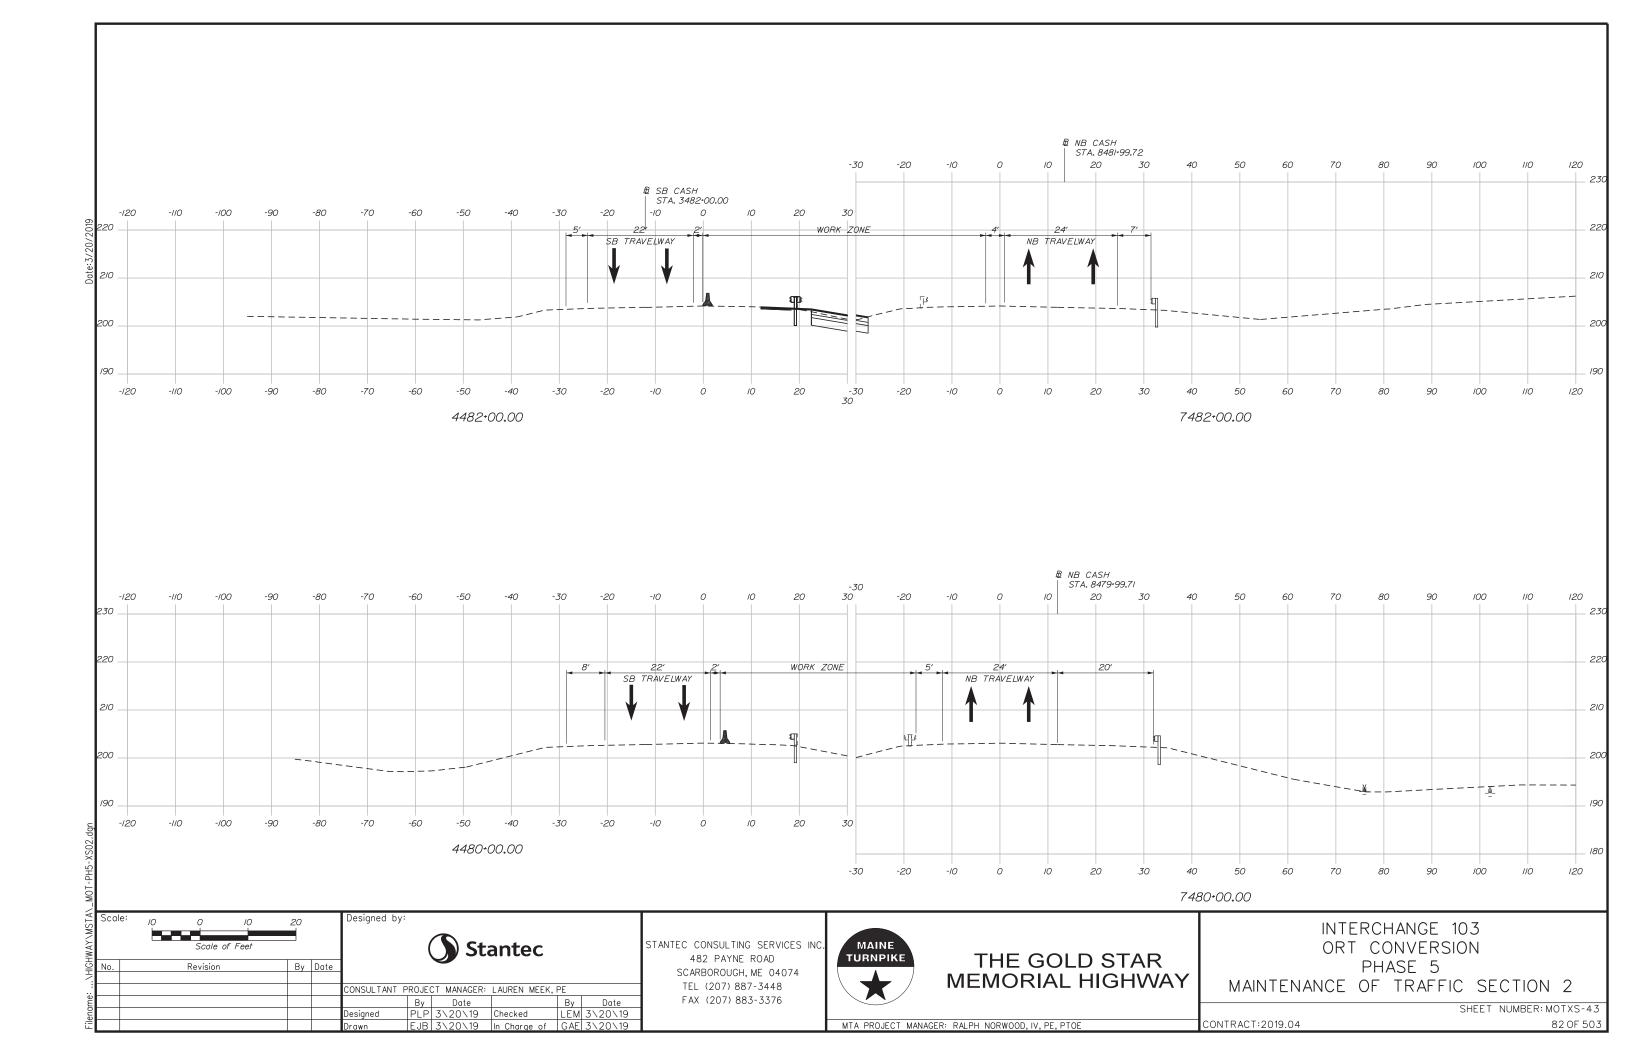


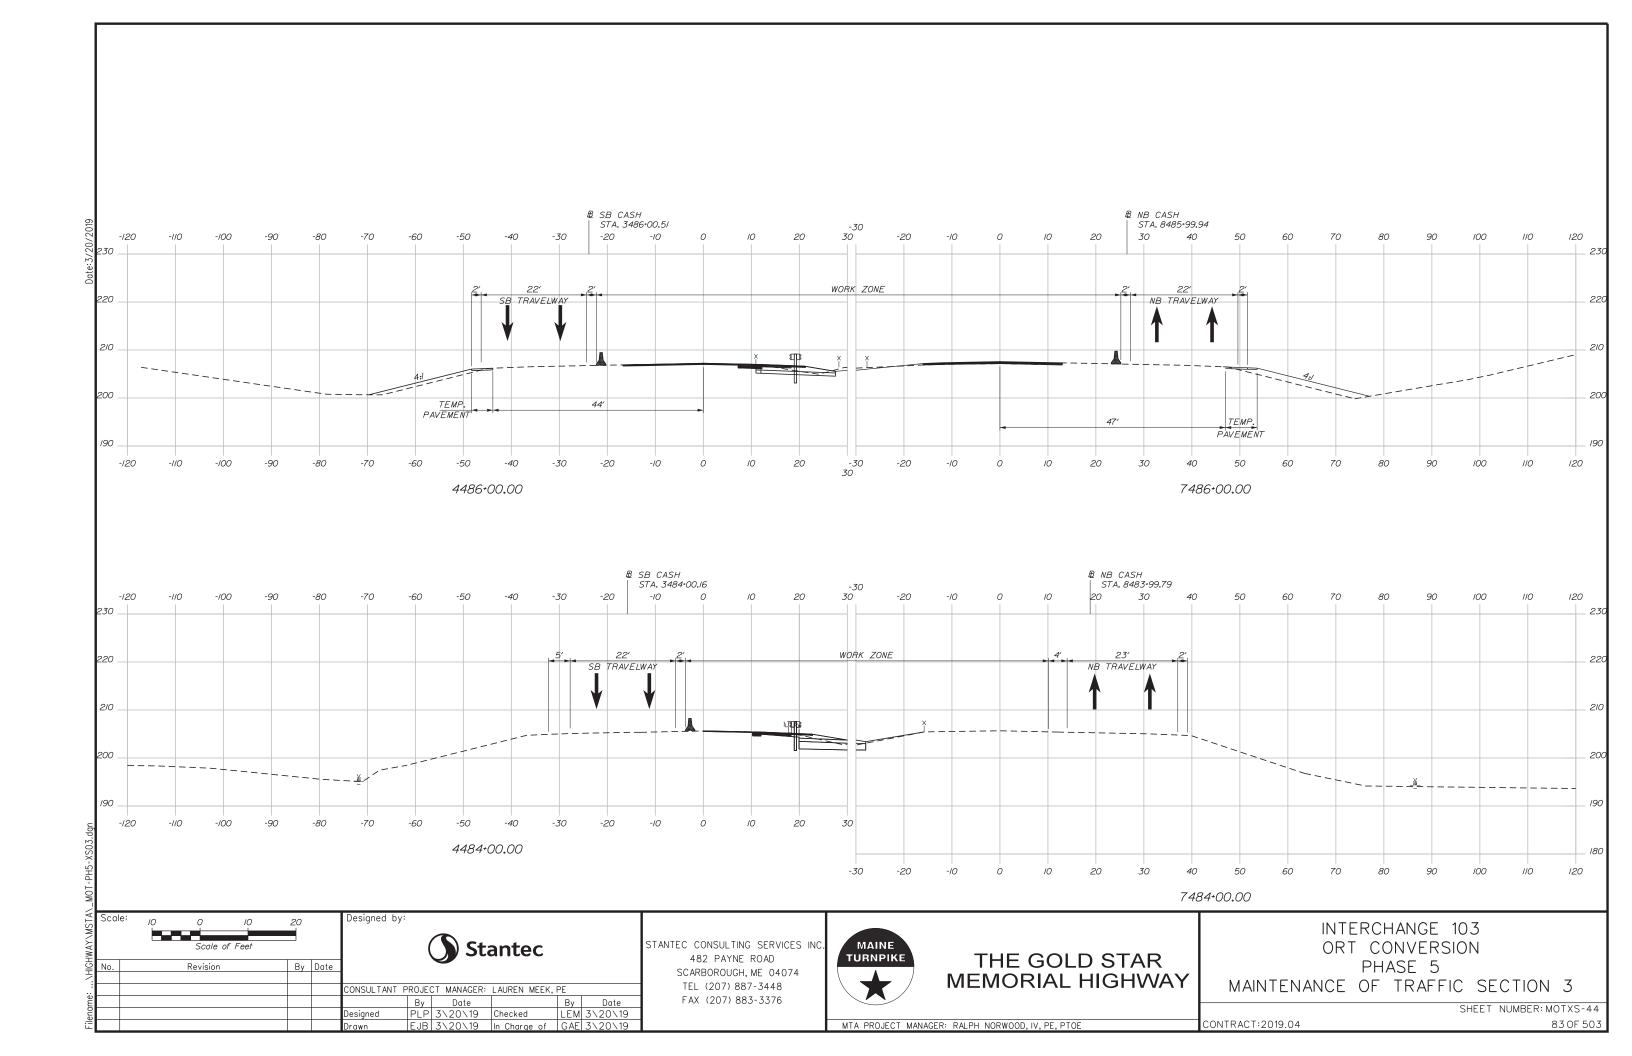


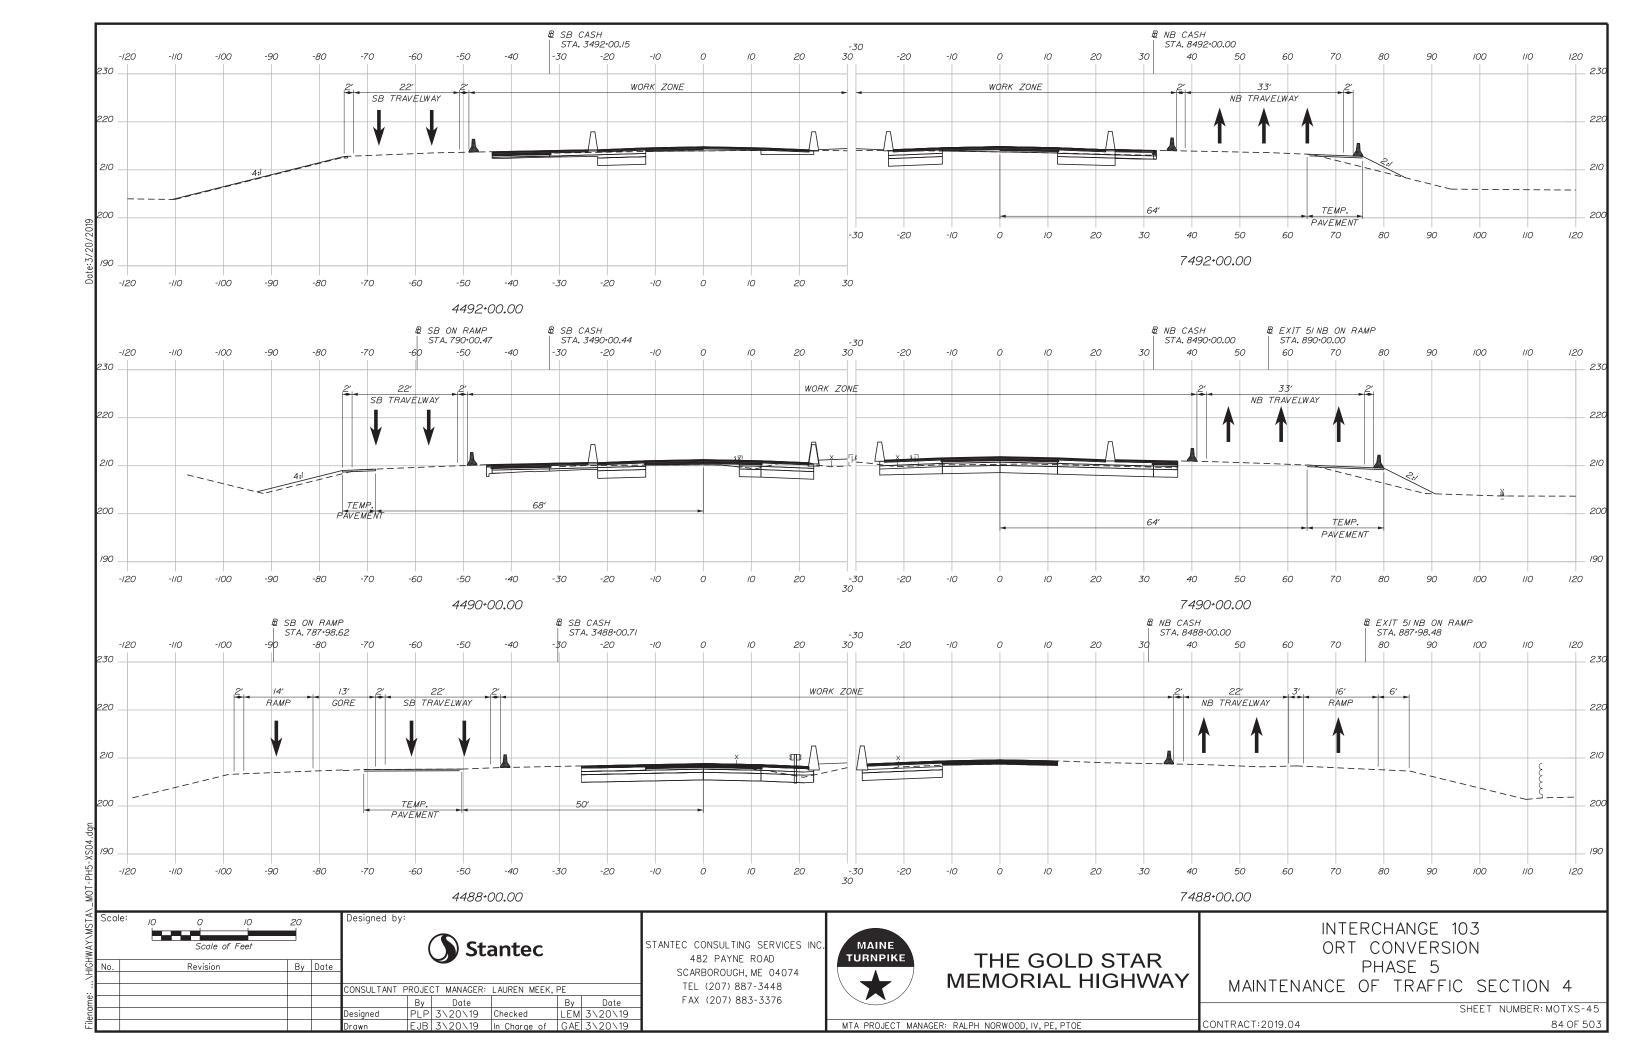


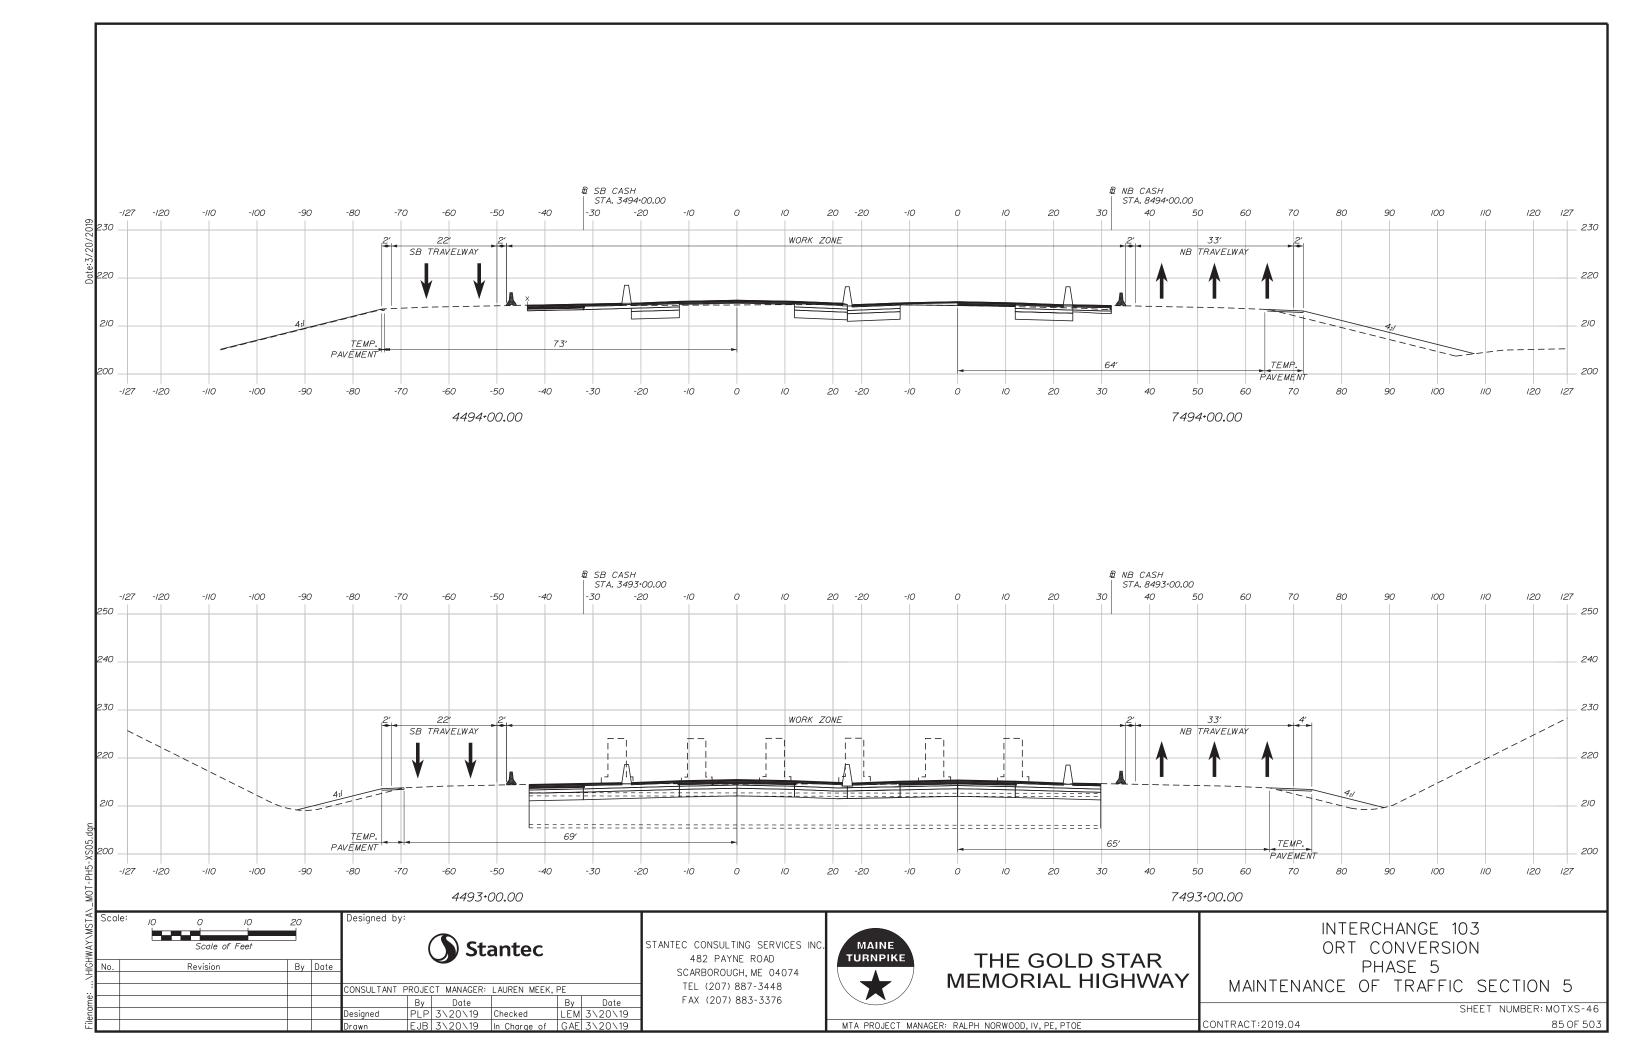

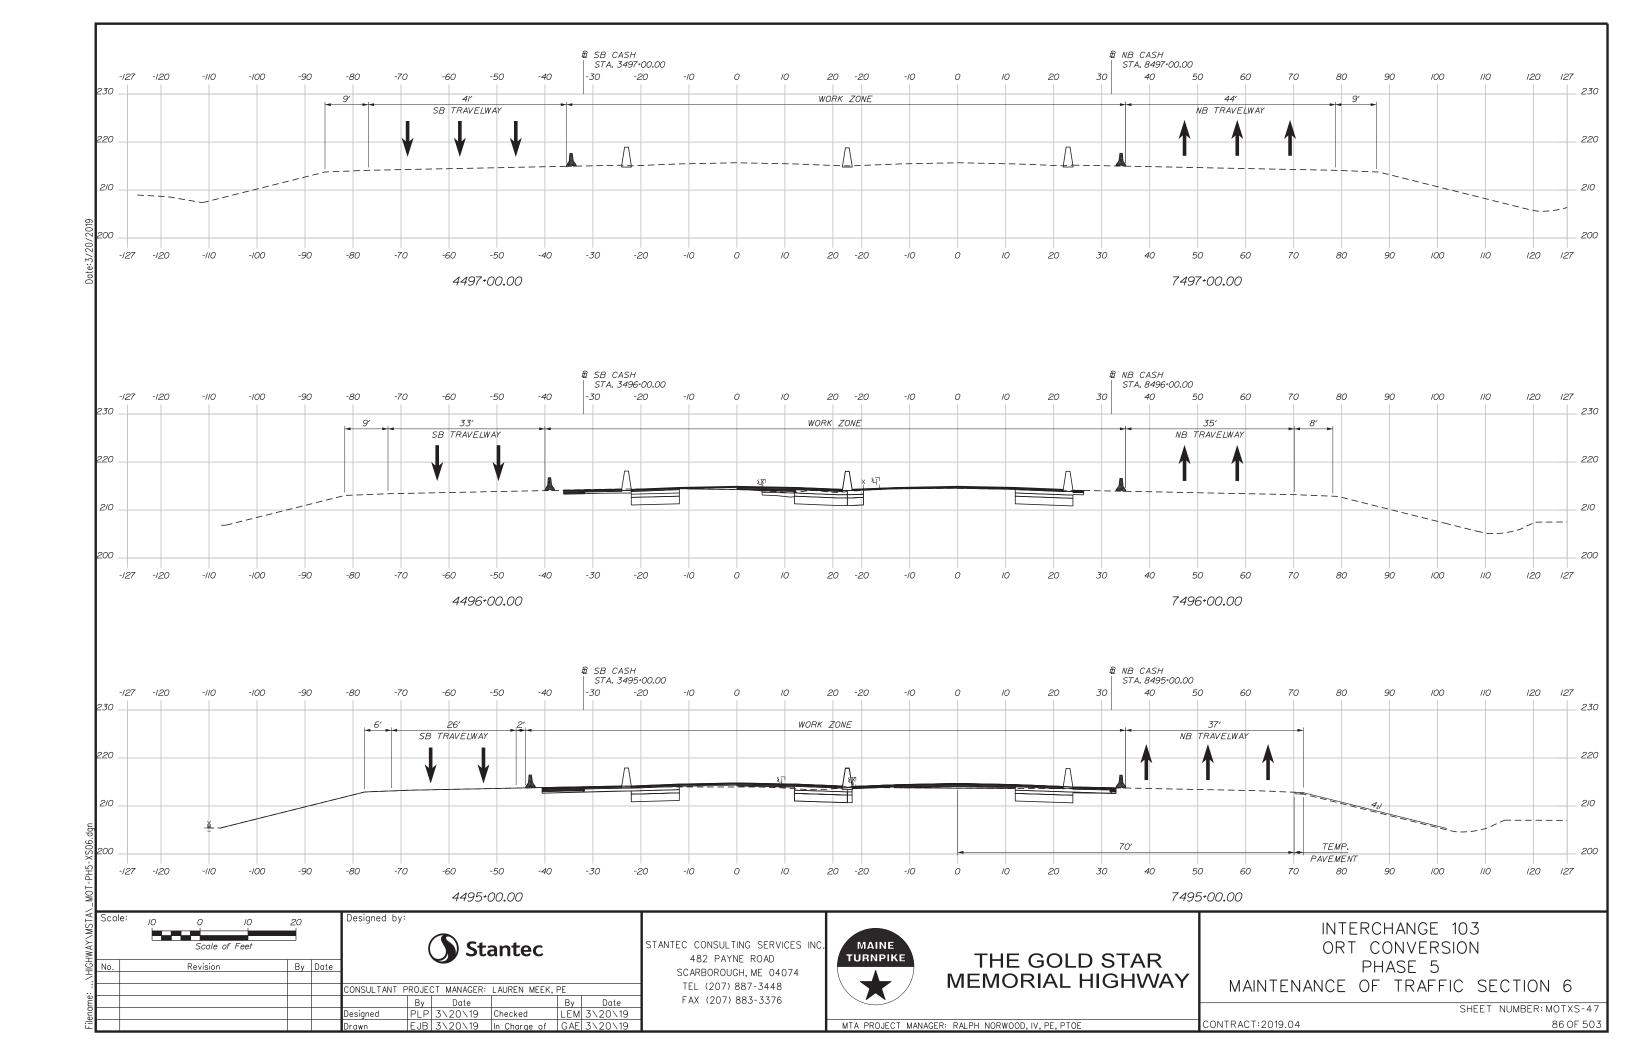

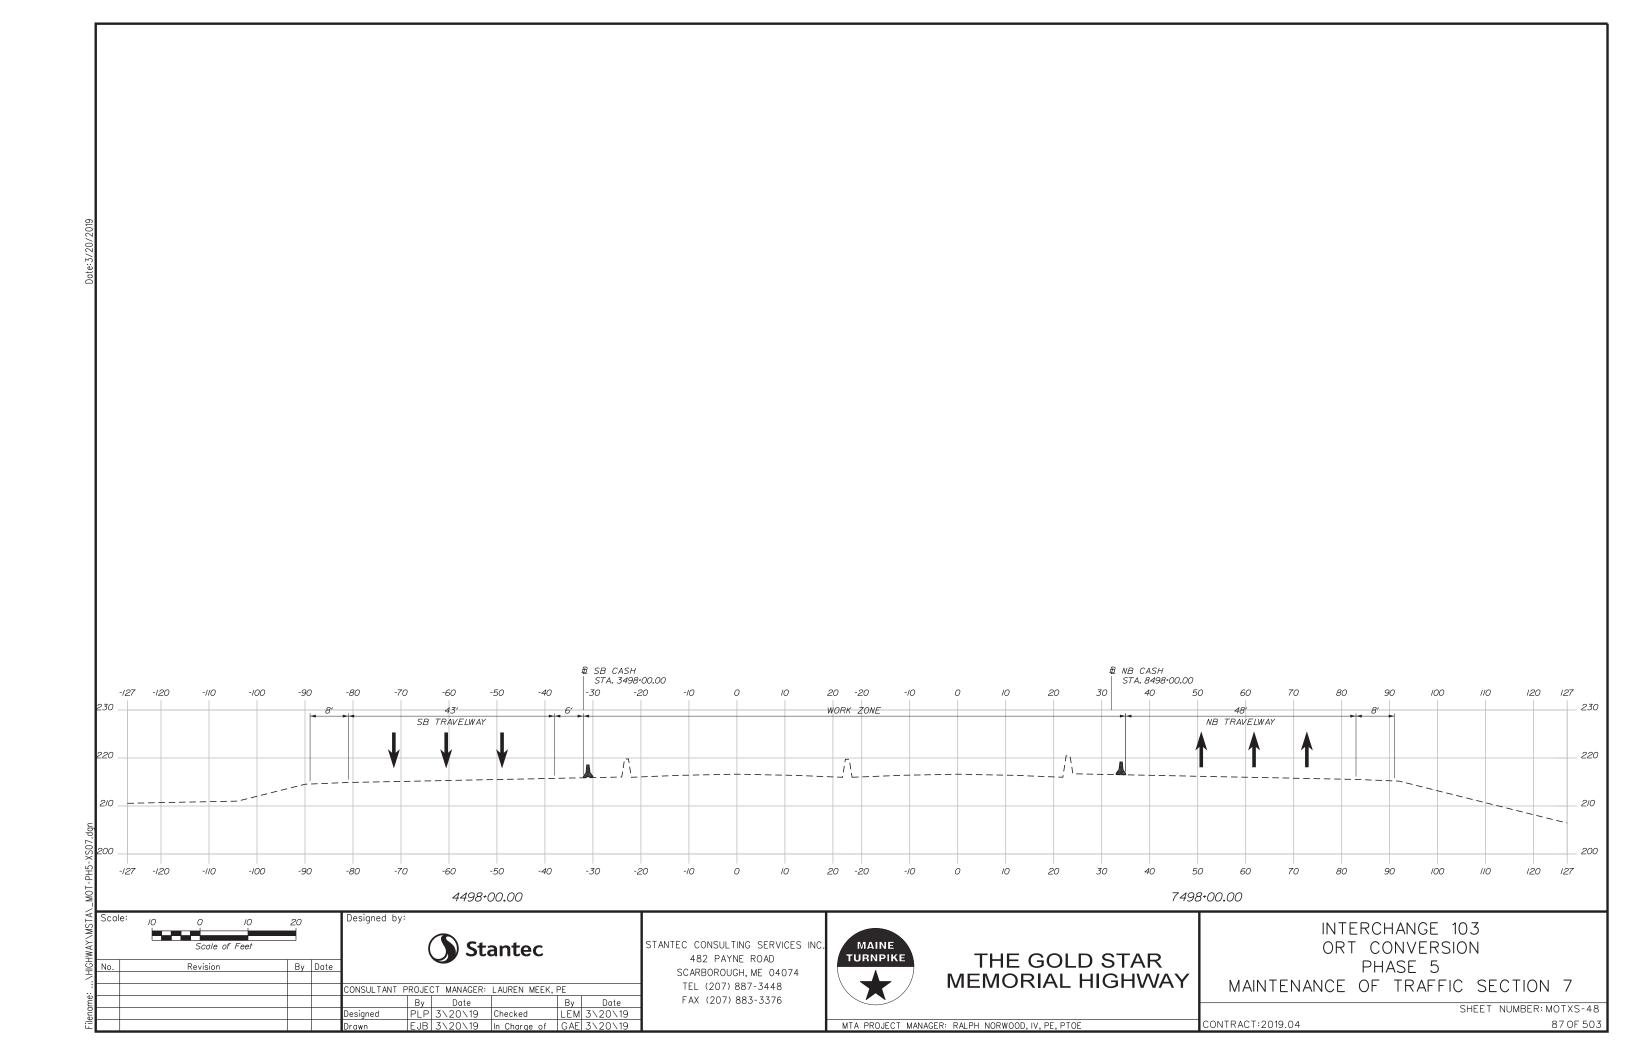


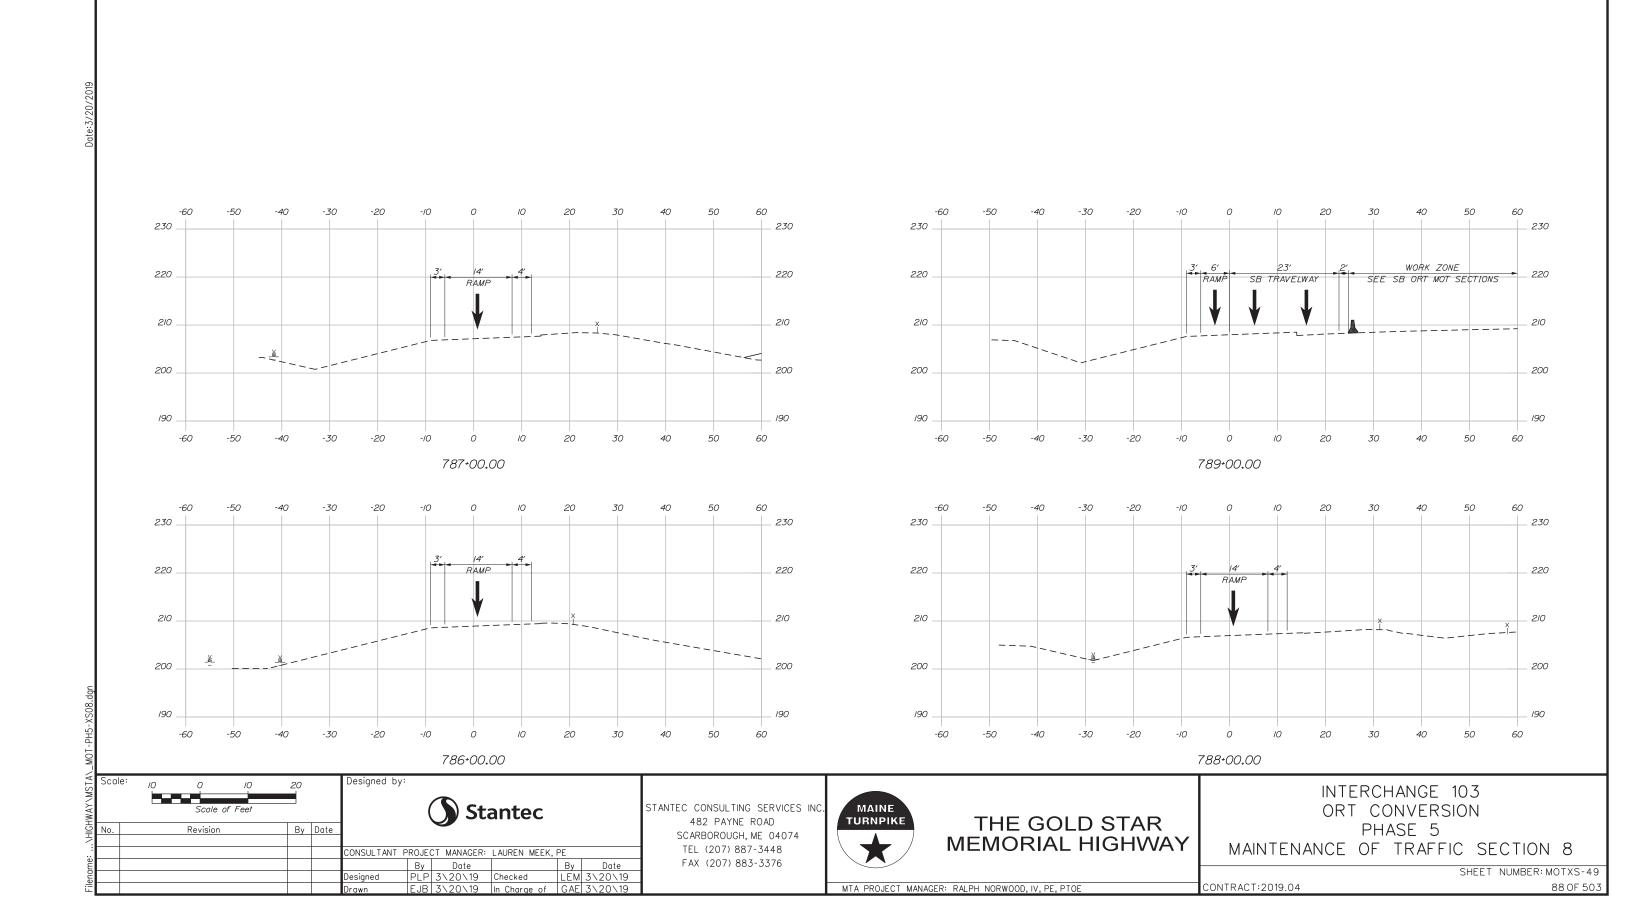


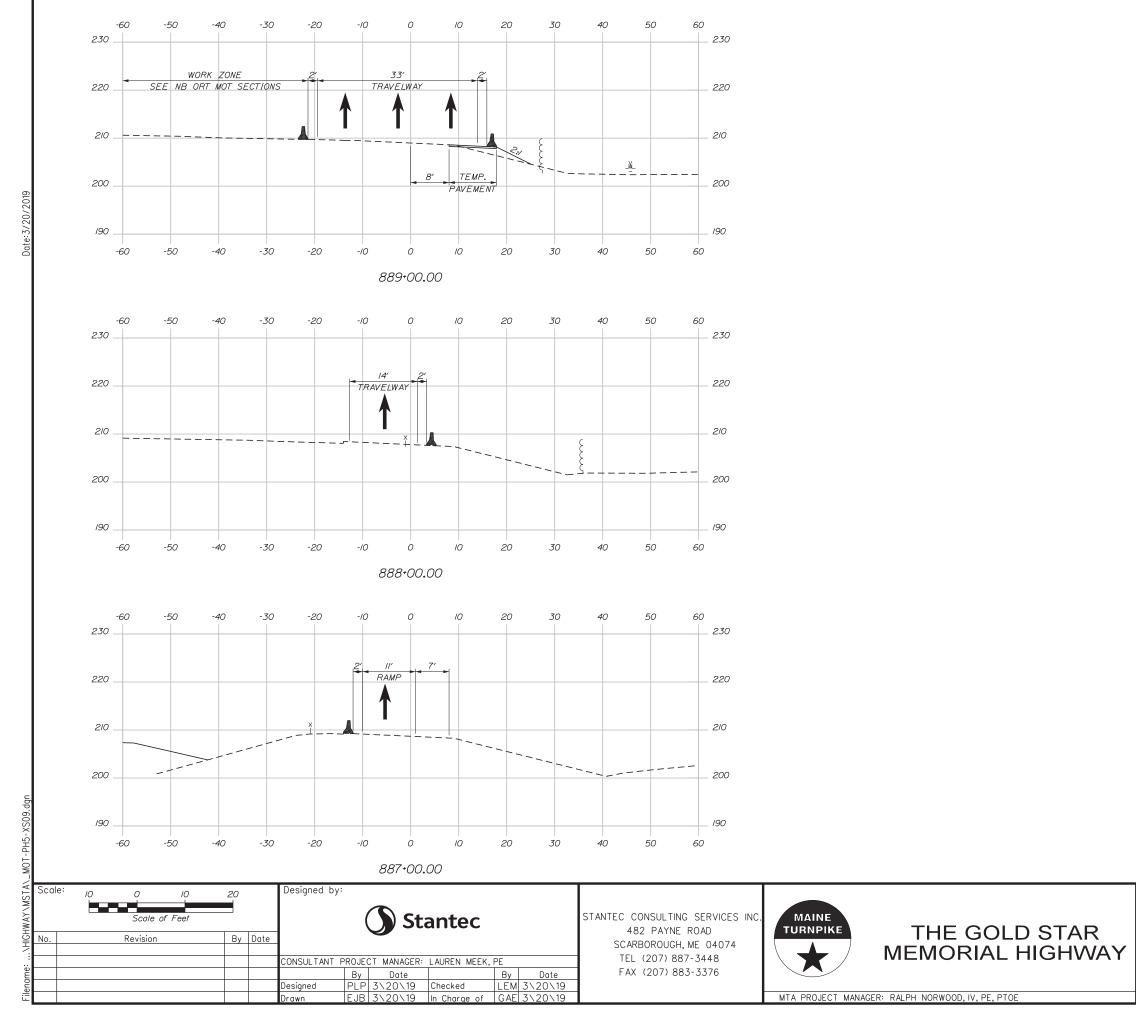


INTERCHANGE 103
ORT CONVERSION
PHASE 5
MAINTENANCE OF TRAFFIC SECTION 9

SHEET NUMBER: MOTXS-50

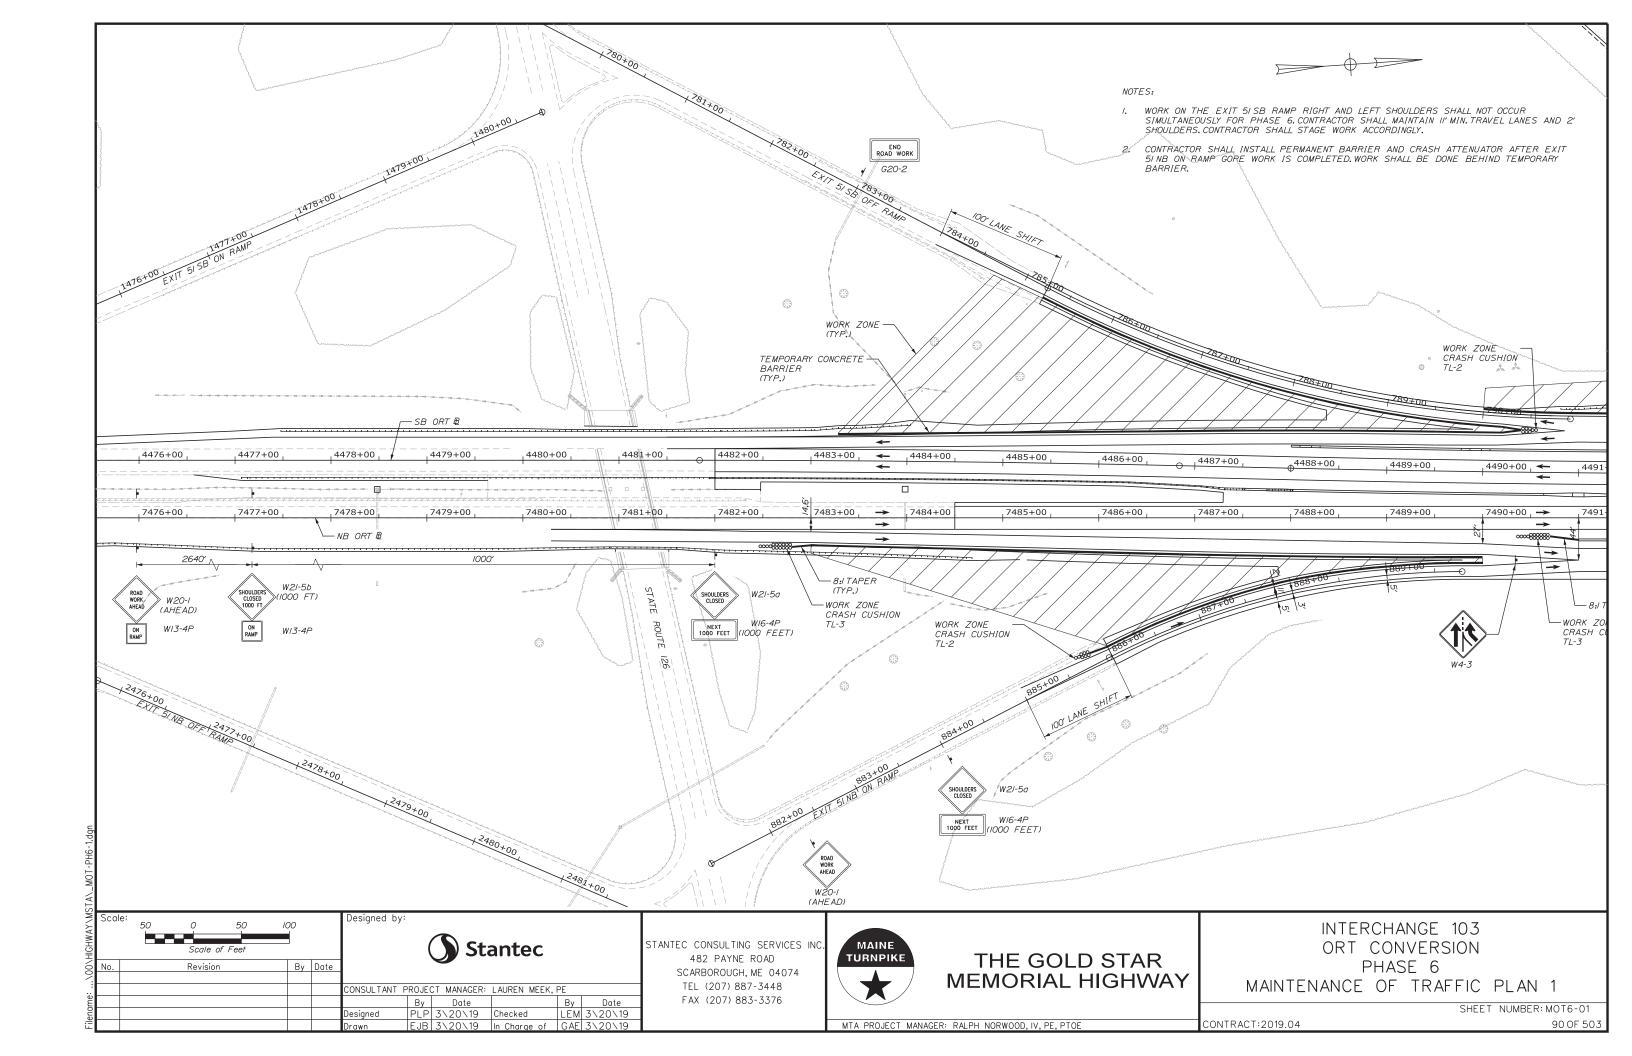

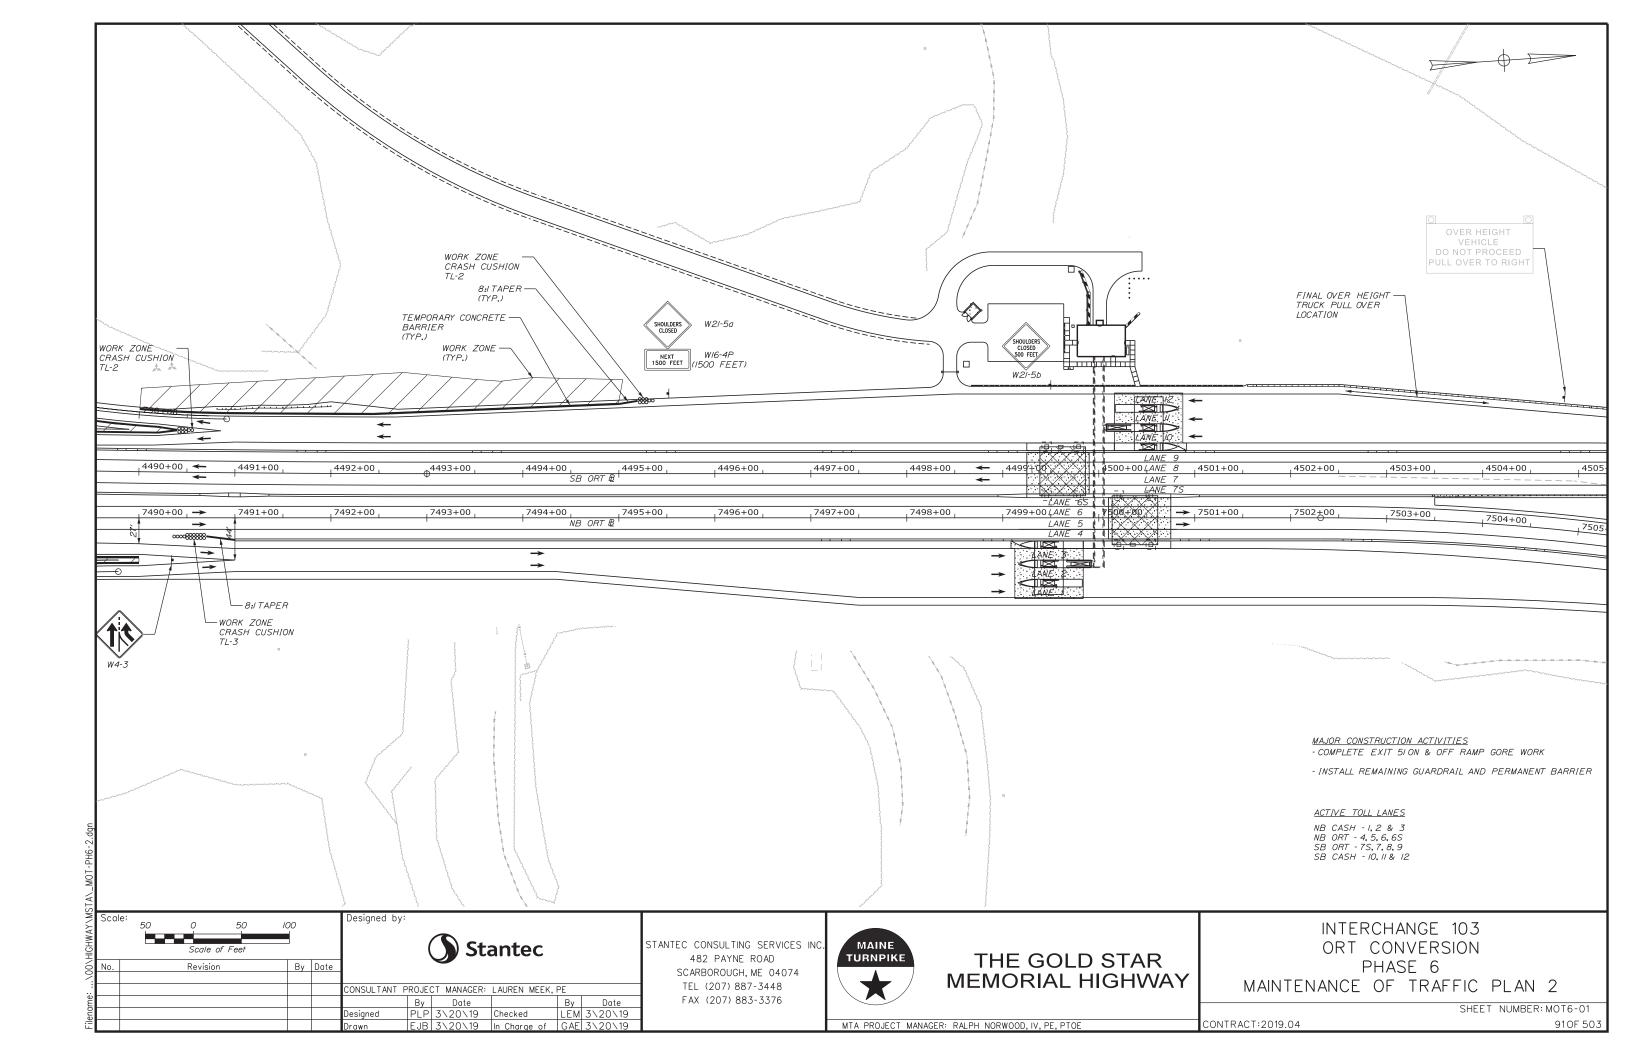

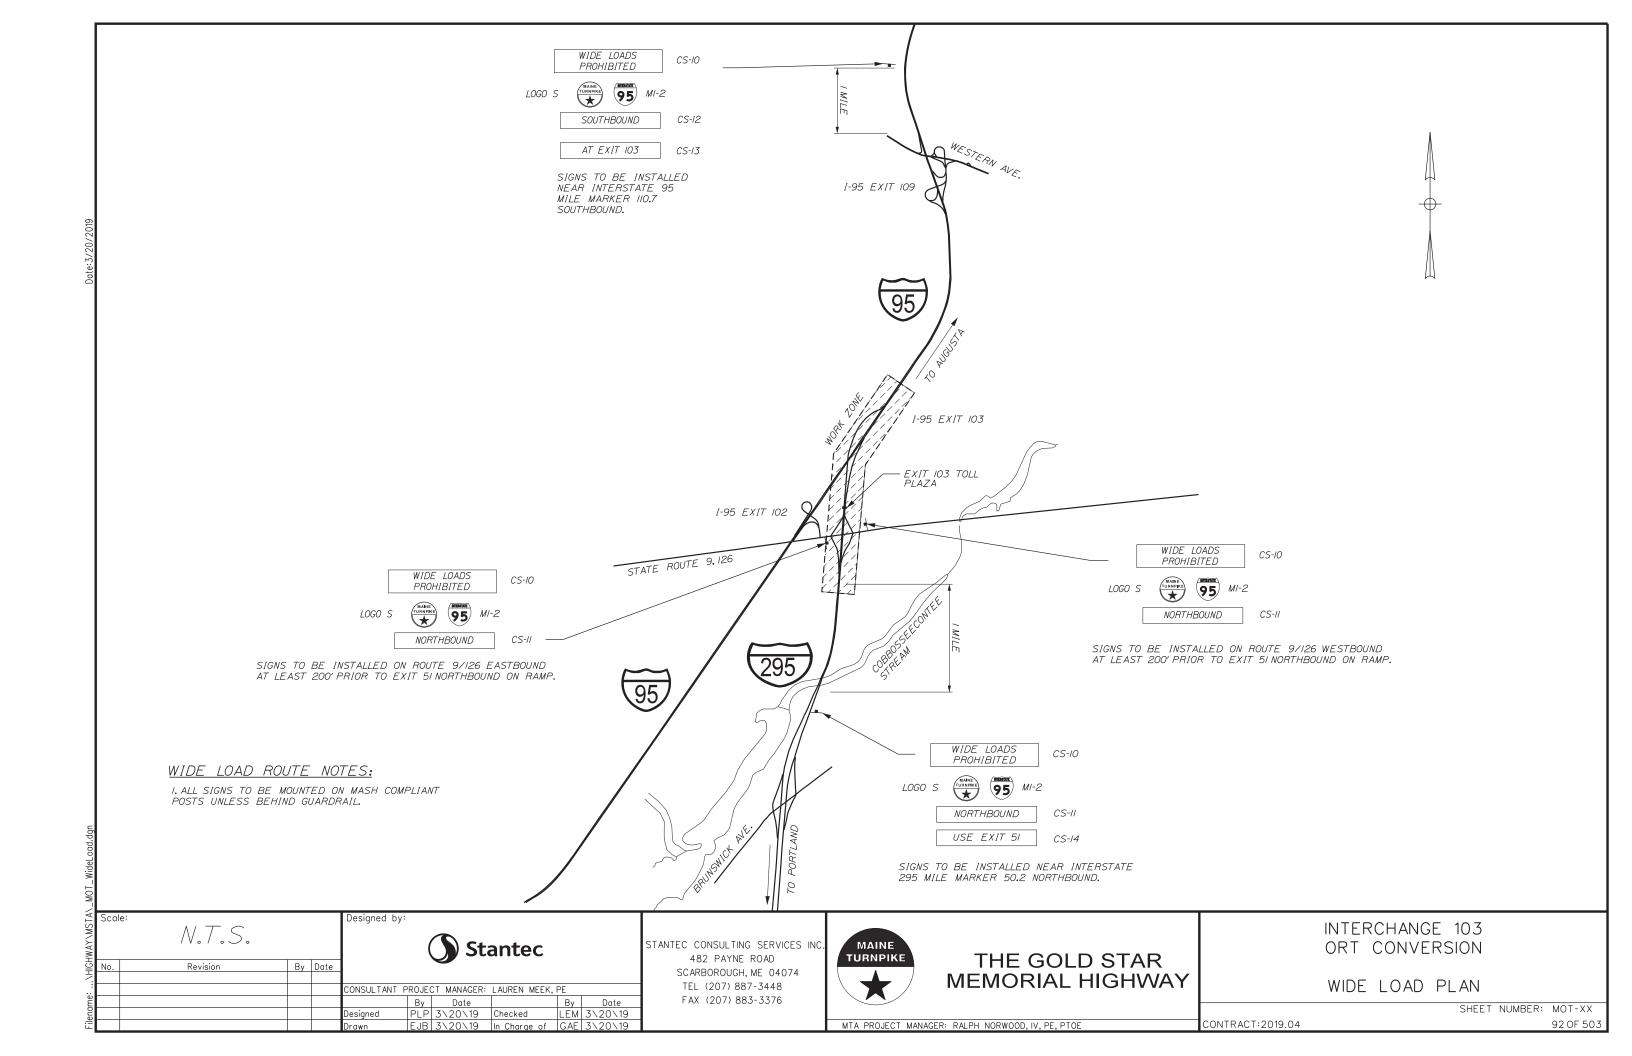

Scale

Revision

GENERAL MAINTENANCE OF TRAFFIC NOTES:

- I. ALL WORK TO CONFORM TO MAINE DEPARTMENT OF TRANSPORTATION STANDARD SPECIFICATIONS FOR HIGHWAY AND BRIDGES, EXCEPT AS MODIFIED BY THE MAINE TURNPIKE AUTHORITY'S SUPPLEMENTAL SPECIFICATIONS AND SPECIAL PROVISIONS.
- 2. ALL PAVEMENT STRIPING & SIGNING SHALL BE IN ACCORDANCE WITH THE "MANUAL ON UNIFORM TRAFFIC CONTROL DEVICES", U.S.D.O.T., F.H.W.A., LATEST EDITION. NOTE THERE IS A 2009 EDITION OF MUTCD.
- 3. THESE PLANS SHOW THE GENERAL CONDITION FOR TURNPIKE MAINLINE TRAFFIC CONTROL DURING CONSTRUCTION, SLIGHT MODIFICATIONS IN CONSTRUCTION PROCEDURE MAY OCCUR AND MAY REQUIRE SOME MINOR ADJUSTMENTS TO BE MADE IN THE FIELD, ALL PROCEDURES MUST BE APPROVED BY THE
- 4. THE CONTRACTOR SHALL REMOVE ALL PAVEMENT MARKINGS THAT CONFLICT WITH PROPOSED PAVEMENT MARKINGS IN ACCORDANCE WITH THE SPECIFICATIONS AND MUTCD. PAYMENT SHALL BE MADE UNDER ITEM 627.77 - REMOVING PAVEMENT MARKINGS.
- 5. TEMPORARY PAVEMENT MARKINGS SHALL BE PAINTED, UNLESS OTHERWISE NOTED. PAYMENT FOR MARKINGS SHALL BE UNDER ITEM 627.681-TEMPORARY 6 INCH PAINTED PAVEMENT MARKING LINES, YELLOW OR
- 6. TEMPORARY PAINTED PAVEMENT MARKINGS SHALL NOT BE INSTALLED ON NEW SURFACE PAVEMENT, TEMPORARY PAVEMENT MARKING TAPE SHALL BE USED. NEW SURFACE PAVEMENT INCLUDES PAVEMENT FROM ADJACENT BRIDGE PROJECT 2018.05.
- 7. EXPOSED BARRIER ENDS SHALL BE PROTECTED BY A WORK ZONE CRASH CUSHION, PAYMENT WILL BE UNDER ITEM 527.342 - WORK ZONE CRASH CUSHION - TL-2 OR ITEM 527.343 - WORK ZONE CRASH CUSHION
- 8. ALL TEMPORARY BARRIER SHALL BE SET WITH A MINIMUM 8: TAPER. THE 8: TAPER BARRIER LENGTH IS DEPENDENT ON THE LOCATION OF THE BARRIER RELATIVE TO THE MAINE TURNPIKE SHOULDERS OR
- 9. REMOVAL OF TEMPORARY PAVEMENT MARKING TAPE ON FINAL PAVEMENT SURFACE SHALL BE DONE IN SUCH A MANNER TO REMOVE AS LITTLE PAVEMENT AS POSSIBLE.
- 10. TWO COMPLETE LANE CLOSURE EASEL MOUNTED SIGN PACKAGES (LEFT OR RIGHT LANE TURNPIKE), INCLUDING WORK ZONE SPEED SIGNS, HAVE BEEN INCLUDED IN THE CONTRACT TO PERMIT SETUP AND REMOVAL OF THE PERMANENT WORK ZONE MAINTENANCE OF TRAFFIC CONTROL DEVICES.
- II. IF THE FINAL LIFT OF PAVEMENT IS NOT IN PLACE DURING THE TESTING OF THE ORT LANES, THE CONTRACTOR SHALL PROVIDE TEMPORARY RAMPS AT THE TRANSITION FROM THE ASPHALT BASE COURSE TO THE ORT CONCRETE SLABS AND FROM THE ASPHALT BASE COURSE TO THE EXISTING PAVEMENT. THESE SHALL BE 100 FEET IN LENGTH THE ENTIRE WIDTH OF PAVEMENT. TEMPORARY RAMPS SHALL BE CONSTRUCTED USING THE SAME MATERIAL AS BEING PLACED ON THAT DAY OR AS APPROVED BY THE RESIDENT. ALL TEMPORARY RAMPS ARE TO BE CONSTRUCTED ON A SAND JOINT. THE CONTRACTOR SHALL BE RESPONSIBLE FOR ALL REPAIRS AND MAINTENANCE REQUIRED FOR THE TEMPORARY RAMPS. ALL WORK ASSOCIATED WITH THE RAMPS SHALL BE INCIDENTAL TO THE PAVEMENT ITEMS.
- 12. THESE PLANS SHOW THE GENERAL LAYOUT OF CONSTRUCTION ZONE SIGNING; ALL LOCATIONS REQUIRING SIGNS MAY NOT BE SHOWN. FINAL CONTENT AND LAYOUT OF SIGNS MUST BE SUBMITTED TO AND APPROVED BY THE RESIDENT.

Designed by:

esigned

By Date

- 13. CANOPY LIGHT ABOVE CLOSED LANES SHALL BE RED.
- 14. CANOPY SIGNAGE ABOVE CLOSED LANES SHALL BE COVERED.
- IS. CONTRACTOR SHALL MAINTAIN A 5'WIDE PATHWAY FOR MTA EMPLOYEES TO ACCESS PLAZA BUILDING AND TOLL BOOTHS TO CROSS WORK ZONES SAFELY DURING ALL PHASES OF WORK. THIS MAY REQUIRE BREAKS IN BARRIER, USE OF BARRELS, SAFETY TAPE DELINEATING PATHS AND TEMPORARY SIGNAGE. THE PATH SHALL BE LIGHTED FROM DUSK TO DAWN AND FREE FROM TRIP HAZARDS. LIGHTING, SIGNAGE AND SAFETY TAPE SHALL BE INCIDENTAL TO ITEM 659.10 MOBILIZATION.
- 16. REFER TO APPENDIX G OF SPECIFICATIONS FOR PLAZA SAFETY REQUIREMENTS.
- IT. LANE CLOSURES BOTH NORTHBOUND AND SOUTHBOUND AND TEMPORARY CONCRETE BARRIER IN MEDIAN SHOULDERS ARE REQUIRED PRIOR TO REMOVING AND RESETTING EXISTING MEDIAN GUARDRAIL AND INSTALLING PROPOSED GUARDRAIL ITEMS AND SIGN BRIDGES.
- 18. NO CONSTRUCTION WORK ALLOWED IN PROPOSED TOLLING LANES DURING TOLL COMMISSIONING. COMMISSIONING REQUIRES ACCESS TO ALLOW TESTING VEHICLES AT HIGHWAY SPEEDS.
- 19. SPEED LIMIT, STOP, YIELD AND EXIT SIGNS SHALL BE A MINIMUM OF 5' ABOVE THE PAVEMENT.
- 20. FOR TRAFFIC CONTROL NOT COVERED IN THESE PLANS, REFERENCE MAINE TURNPIKE AUTHORITY TRAFFIC CONTROL PLANS DATED JANUARY 2018 ON MTA WEBSITE.
- 21. CONTRACTOR SHALL NOT USE EXISTING BRIDGE OVER TOLL PLAZA FOR VEHICULAR OR EQUIPMENT ACCESS.

ABBREVIATIONS FOR ALL M.O.T. PLANS

BWLL = BROKEN WHITE LANE LINE

SWEL = SOLID WHITE EDGE LINE

SYEL = SOLID YELLOW EDGE LINE

TBWL = TEMPORARY BROKEN WHITE LINE

TSWL = TEMPORARY SOLID WHITE LINE TSYL = TEMPORARY SOLID YELLOW LINE

DYCL = DOUBLE YELLOW CENTER LINE

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THE GOLD STAR MEMORIAL HIGHWAY INTERCHANGE 103 ORT CONVERSION

MOT DETAILS 1

CONTRACT:2019.04


SHEET NUMBER: DET-01


MTA PROJECT MANAGER: RALPH NORWOOD, IV. PE, PTOE


ONSULTANT PROJECT MANAGER: LAUREN MEEK, PE Date PLP 3\20\19 Checked

F IB 3\20\19 In Charge of GAE 3\20\19

Stantec

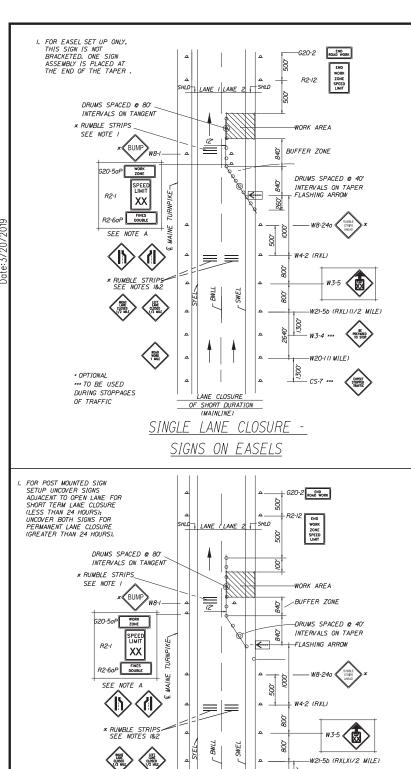

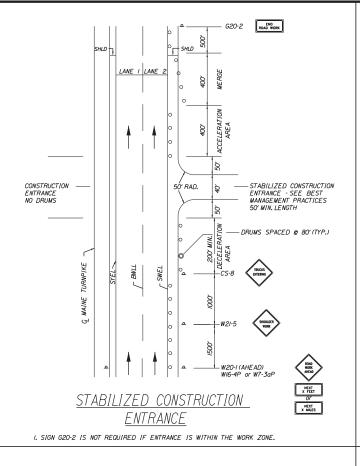


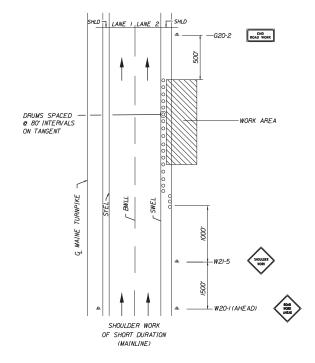

SHOULDER WORK


I.THE W20-I AND G20-2 SIGNS ARE NOT REQUIRED IF THE SHOULDER CLOSURE IS WITHIN A PREVIOUSLY ESTABLISHED WORK ZONE.


ONE LANE ROAD MEAD

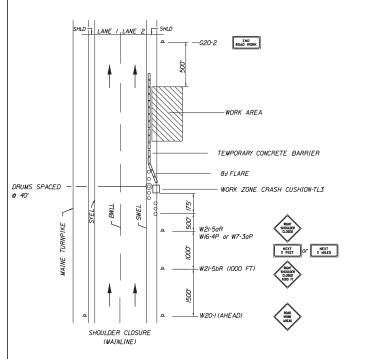

SHOULDER CLOSURE

- I. THE W20-I AND G20-2 SIGNS ARE NOT REQUIRED I THE SHOULDER CLOSURE IS WITHIN A PREVIOUSLY ESTABLISHED WORK ZONE.
- 2. ONLY ONE SHOULDER CLOSURE PERMITTED PER BOUND AT ONE TIME UNLESS OTHERWISE NOTED.

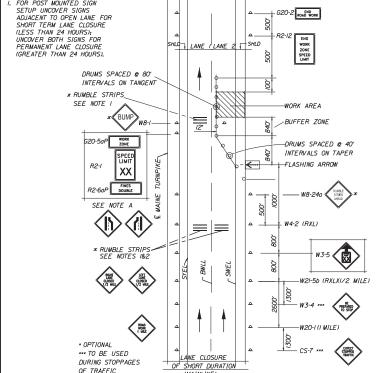

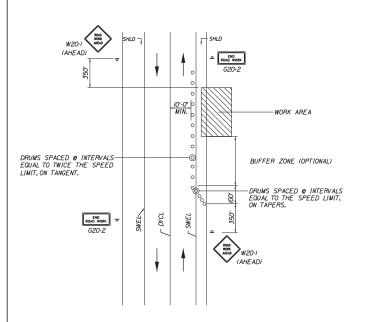

TEMP. LOCAL ROAD SHOULDER CLOSURE

I. FOR SHORT DURATION WORK (I HOUR), THE TAPER AND CHANNELIZATION DEVICES MAY BE OMITTED IF SHADOW VEHICLE IS PRESENT WITH ACTIVATED HIGH-HIVENSITY POTATION, FLASING, OSCILLATING OR STROBE LIGHTS.

W2O-/ ROAD WORK AHEAD ROAD WORK w20-7 DRUMS OR CONES SPACED & INTERVALS EQUAL TO TWICE THE SPEED LIMIT, ON TANGENT. - DRUMS OR CONES SPACED @ INTERVALS EQUAL TO THE SPEED LIMIT, ON TAPERS. W20-7

LOCAL ROAD SINGLE LANE CLOSURE

I, ROAD WORK AHEAD & END ROAD WORK SIGNS MAY BE OMITTED FOR SHORT DURATION OPERATIONS (LESS THAN I HOUR). 2. FLAGGERS SHALL BE LOCATED SO THEY ARE CLEARLY VISIBLE TO ABBROADLY ORDIVERS 3. SIGN SPACING ASSUMES LOCAL ROAD SPEED IS 40 MPH OR LESS.

- FOR SIGN DETAILS. SEE MAINTENANCE OF TRAFFIC SIGN SUMMARY SHEETS.
- "TRUCKS ENTERING" SIGN SHALL ALSO BE USED AT LOCATIONS WHERE TRUCKS ENTER TE WORK ZONE FROM THE TRAVEL
- SIGNS DESIGNATED *** SHALL BE USED DURING STOPPAGES
- TRUCK MOUNTED ATTENUATOR SHALL NOT BE LOCATED WITHIN THE RUFFER ZONE.
- SPEED LIMIT, STOP, YIELD AND EXIT SIGNS SHALL BE A MINIMUM OF 5' ABOVE THE PAVEMENT.

TEMPORARY RUMBLE STRIP NOTES:

- IF RUMBLE STRIPS ARE USED THEY SHALL BE PLACED IN ONE OF THE FOLLOWING CONFIGURATIONS: *ADJACENT TO THE WORK ZONE (IUNIT)
 - *UPSTREAM FROM THE TAPER FOR THE WORKZONE (2 UNITS) *BOTH ADJACENT TO THE WORKZONE AND PRIOR TO THE TAPER (3 UNITS)
 - W8-ISIGNS SHALL BE PLACED ADJACENT TO THE FIRST RUMBLE STRIP AT ANY LOCATION. ONLY ONE SET OF W8-24a SIGNS ARE REQUIRED FOR ANY OF THE ABOVE CONFIGURATIONS.
- RUMBLE STRIPS MAY BE PLACED UPSTREAM OF THE TAPER BETWEEN THE W3-5 SIGNS AND THE W4-2 SIGNS. IF RUMBLE STRIPS ARE INSTALLED PRIOR TO TAPER, W8-I SIGNS SHALL BE PLACED ADJACENT TO THE FIRST STRIP AND THE W8-240 SIGNS SHALL BE MOVED TO 400' AFTER THE W20-5 SIGNS.

Scale Stantec Revision By Date ONSULTANT PROJECT MANAGER: LAUREN MEEK, PE Ву Date 3\20\19

SINGLE LANE CLOSURE - POST MOUNTED SIGN SETUP

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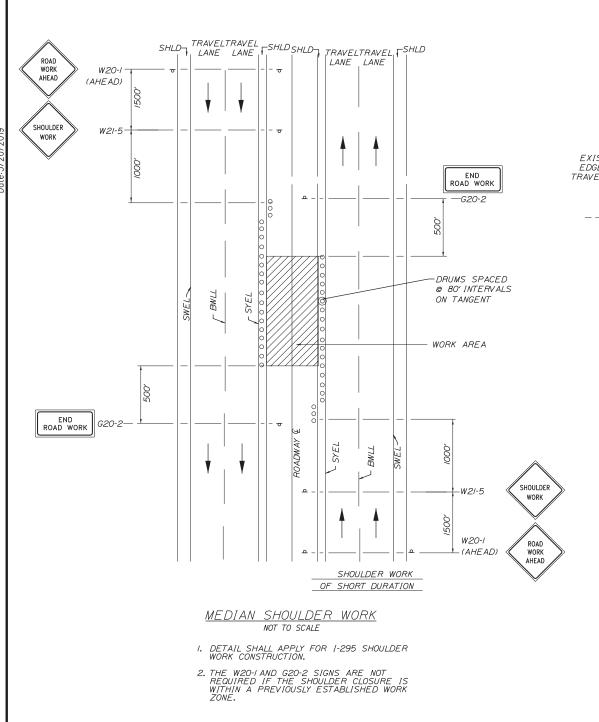
THE GOLD STAR **MEMORIAL HIGHWAY** INTERCHANGE 103 ORT CONVERSION

MOT DETAILS 2

SHEET NUMBER: DET-02

MTA PROJECT MANAGER: RALPH NORWOOD, IV. PE, PTOE

ROAD WORK



EXISTING
EDGE OF PAVEMENT

EXISTING EDGE
TRAVELWAY

SAWCUT

EXISTING EDGE
OF PAVEMENT

SAWCUT

I//2" HMA GRADING I2.5 MM (SURFACE)

I//2" HMA GRADING I2.5MM (BINDER)

24" AGGREGATE SUBBASE COURSE - GRAVEL

TEMPORARY OVER HEIGHT VEHICLE PULL OFF PAVEMENT


NOT TO SCALE

SAWCUT REQUIRED FOR WIDENING EXISTING PAVEMENT 2.0 % 4" LOAM AND SEED PAVEMENT 4" LOAM AND SEED 1/2" HMA GRADING 12.5 MM (SURFACE) 1/2" HMA GRADING 12.5 MM (BINDER) 2/2" HMA GRADING 19.0MM (BASE) 24" AGGREGATE SUBBASE COURSE - GRAVEL

NOTES:

- I. TEMPORARY PAVEMENT SHALL BE PLACED ON A MINIMUM OF 24" AGGREGATE SUBBASE COURSE-GRAVEL. 24" OF AGGREGATE SUBBASE COURSE-GRAVEL HAS BEEN ESTIMATED UNDER THE TEMPORARY PAVEMENT; HOWEVER, IN FULL DEPTH CONSTRUCTION AREAS, THE CONTRACTOR CAN BUILD FINAL SUBGRADE AND EXTEND GRAVEL UNDER TEMPORARY PAVEMENT.
- 2. REMOVAL OF THE TEMPORARY PAVEMENT AND GRAVEL WILL BE PAID FOR AS COMMON EXCAVATION.
- 3. SIDESLOPES AT TEMPORARY WIDENED PAVEMENT SHALL BE AS NOTED ON THE PHASING CROSS SECTIONS. SIDESLOPES SHALL HAVE 4 LOAM AND SEED WHICH SHALL BE PAID FOR UNDER THE APPROPRIATE ITEMS.

TEMPORARY WIDENED PAVEMENT

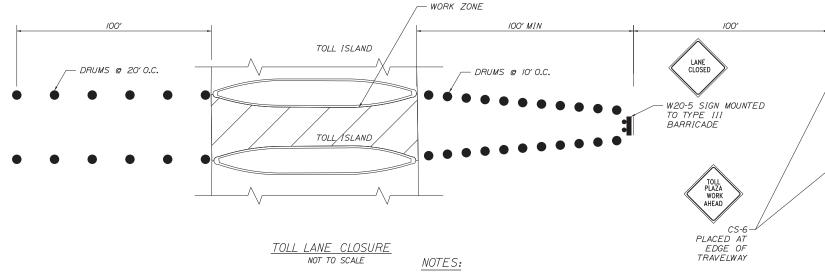

I. CONTRACTOR SHALL MAINTAIN ACCESS AT ALL ACTIVE TOLL BOOTHS FOR MTA EMPLOYEES AND PLACE DRUMS TO BLOCK MTA EMPLOYEES FROM ACCESSING THE WORK ZONE.

2. CANOPY LIGHT ABOVE CLOSED LANE SHALL BE RED.

CONTRACT:2019.04

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.HIGHW,	No.	Revision	Ву	Date]		•				ı
<u></u>			+		CONSULTANT F	PROJE	CT MANAGER:	LAUREN MEEK,	PE		1
ilename						Ву	Date		Ву	Date	1
bue					Designed	PLP	3\20\19	Checked	LEM	3\20\19	1
Ë					Drawn	EJB	3\20\19	In Charge of	GAE	3\20\19	

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THE GOLD STAR MEMORIAL HIGHWAY

MOT DETAILS 7


MOT DETAILS 3

INTERCHANGE 103


ORT CONVERSION

SHEET NUMBER: DET-03 95 OF 503


MTA PROJECT MANAGER: RALPH NORWOOD, IV, PE, PTOE

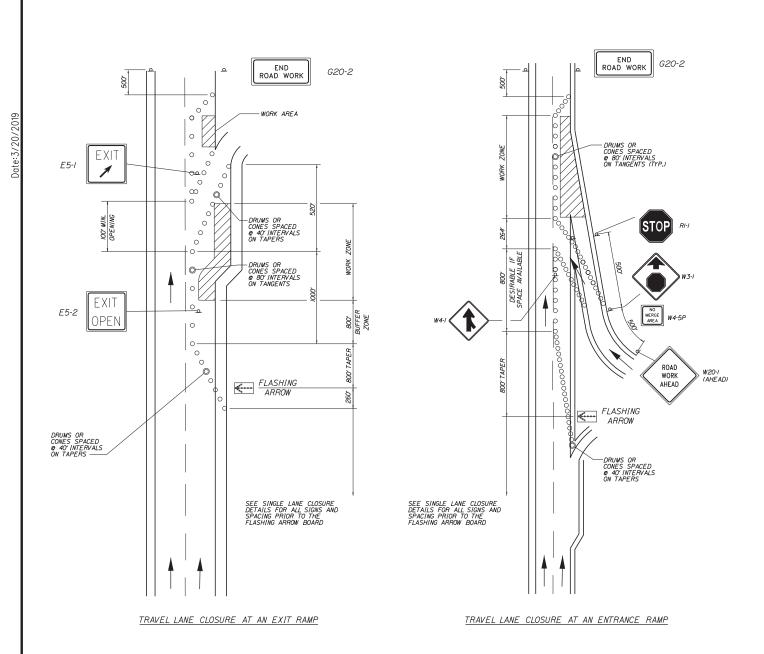

TEMPORARY LANE CLOSURES AT RAMPS (MAINLINE) NOT TO SCALE

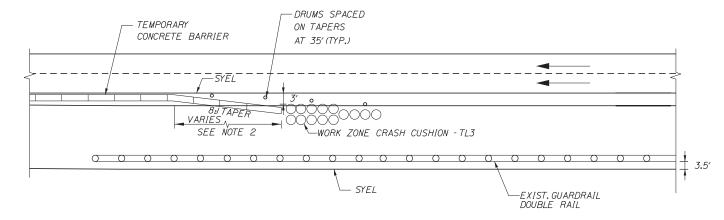

EXIST, GUARDRAIL ON FAR SIDE OF MEDIAN

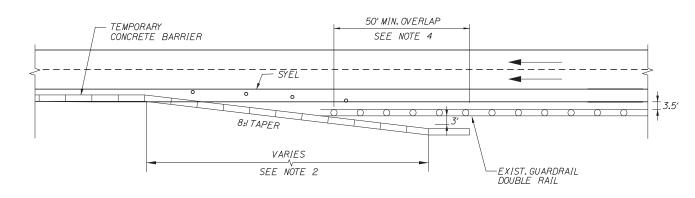


EXIST. GUARDRAIL ON NEAR SIDE OF MEDIAN

CONCRETE BARRIER / GUARDRAIL OVERLAP DETAIL

NOTES:

- I. BARRIER ENDS SHALL BE PROTECTED BY A TEMPORARY WORK ZONE CRASH CUSHION OR LAPPED BEHIND GUARDRAIL.
- 2. 8: TAPERED BARRIER LENGTH IS DEPENDANT ON THE LOCATION OF THE BARRIER RELATIVE TO
- 3. IF A TEMPORARY WORK ZONE CRASH CUSHION IS USED, THE WORK ZONE CRASH CUSHION SYSTEM MUST BE FOUNDED ON A LEVEL SURFACE. ANY WORK NECESSARY TO PROVIDE A LEVEL SURFACE WILL BE INCIDENTAL TO THE WORK ZONE CRASH CUSHION ITEM.
- 4. IF THE 50' MIN. LENGTH OF OVERLAP CAN NOT BE MET THEN THE EXISTING GUARDRAIL END MUST BE ANCHORED IN ACCORDANCE WITH DRAWING SEWO20 IN THE AASHTO-AGC-ARBTA JOINT COMMITTEE TASK FORCE 13 REPORT, DRAFTED MAY 1995.

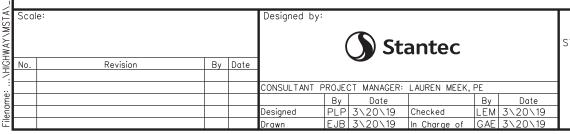

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THE GOLD STAR **MEMORIAL HIGHWAY** INTERCHANGE 103 ORT CONVERSION

MOT DETAILS 4

SHEET NUMBER: DET-04

MTA PROJECT MANAGER: RALPH NORWOOD, IV, PE, PTOE

MAINLINE CONSTRUCTION SIGN SUMMARY

ID	SIZE C	OF SIGN	TEVE	TEXT L	DIMENSIONS (I	NCHES)	NUMBER OF SIGNS	COL	_OR	AREA_IN
NUMBER	WIDTH	HEIGHT	TEXT	LETTER HEIGHT	VERTICAL SPACING	ARROW RTE.MKR.	SIGNS REQUIRED	BACK- GROUND	LEGEND BORDER	SQUARE FEET
CS-I	108"	96"	1295 SB EXIT 51 USE USE LEFT RIGHT LANES LANE	IO" D	-	-	2	ORANGE	BLACK	72.00 (144.00)
CS-2	48"	72"	RIGHT LANE EXIT ONLY	IO" D	-	-	,	ORANGE	BLACK	24.00 (24.00)
CS-4	72" 96"	24" 96"	WEST GARDINER SERVICE PLAZA	8" C 10" D		-	1	BLUE BLUE	WHITE WHITE	12.00 (12.00) 64.00 (64.00)
CS-5	72" 96"	24" 96"	9 126 GARDINER LITCHFIELD	8" C 10" D		-	1	GREEN GREEN	WHITE WHITE	12.00 (12.00) 64.00 (64.00)
CS-6	48"	48"	TOLL PLAZA WORK AHEAD	8" D 8" D	6"	-	4	ORANGE	BLACK	/6.00 (64.00)
CS-7	48"	48"	EXPECT STOPPED TRAFFIC	8" D 8" D	6"	-	6	ORANGE	BLACK	/6.00 (96.00)
CS-8	48"	48"	TRUCKS ENTERING	8" D 8" D	6"	-	2	ORANGE	BLACK	16.00 (32.00)
CS-10	84"	36"	WIDE LOADS PROHIBITED	8" D 8" D	6"	-	4	ORANGE	BLACK	21.00 (84.00)
CS-II	84"	/8"	NORTHBOUND	8" D	-	-	3	ORANGE	BLACK	(0.50 (31.50)

MAINLINE CONSTRUCTION SIGN SUMMARY

ID	SIZE C	OF SIGN	TEXT	TEXT	DIMENSIONS (II	VCHES)	NUMBER OF SIGNS	COL	LOR	AREA IN
NUMBER	WIDTH	HEIGHT		LETTER HEIGHT	VERTICAL SPACING	ARROW RTE.MKR.	REQUIRED	BACK- GROUND	LEGEND BORDER	SQUARE FEET
CS-12	84"	18"	SOUTHBOUND	8" D	-	-	/	ORANGE	BLACK	10.50 (10.50)
CS-13	84"	18"	AT EXIT 103	8" D	-	-	1	ORANGE	BLACK	10.50 (10.50)
CS-14	84"	18"	USE EXIT 51	8" D	-	-	,	ORANGE	BLACK	10.50 (10.50)
E5-I	48"	36"	EXIT	TEXT CONFORM T "STAND. 20	DIMENSIONS S O "MUTCD" - 200 ARD HIGHWAY S DI2 SUPPLEMEI	SHALL 19 EDITION- SIGNS" - VT	1	ORANGE	BLACK	12.00 (12.00)
E5-2	48"	36"	EXIT OPEN				1	ORANGE	BLACK	12.00 (12.00)
G20-2	48"	24"	END ROAD WORK				25	ORANGE	BLACK	8.00 (200.00)
G20-5aP	36	24"	WORK ZONE	V	•	•	9	ORANGE	BLACK	6.00 (54.00)
LOGO S	36"	-	MANE TURNPIKE	-	-	-	4	-	-	7.07 (28.28)
MI-2	36"	36"	INTERSTATE 95	CONFORM T "STAND	DIMENSIONS S O "MUTCD" - 200 ARD HIGHWAY D DI2 SUPPLEMEI	09 EDITION- SIGNS"-	4	-	-	9.00 (36.00)

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HIGHWAY\MST		N.T.S.				(Sta	antec		
\00\	No.	Revision	Ву	Date						
					CONSULTANT F	PROJE	CT MANAGER:	LAUREN MEEK,	PE	
me						Ву	Date		Ву	Date
ilename:					Designed	TFD	3\20\19	Checked	LEM	3\20\19
Ě					Drawn	PLP	3\20\19	In Charge of	GAE	3\20\19

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THE GOLD STAR MEMORIAL HIGHWAY

INTERCHANGE 103 ORT CONVERSION

MOT SIGN SUMMARY-1

SHEET NUMBER: S-18

MTA PROJECT MANAGER: RALPH NORWOOD, IV, PE, PTOE

CONTRACT: 2019.04 97 OF 503

MAINLINE CONSTRUCTION SIGN SUMMARY

In	SIZE C	OF SIGN	TEVT	TEXT DIMENSIONS (THETTES)				NUMBER OF SIGNS	COL	_OR	AREA IN SQUARE		
ID NUMBER	WIDTH	HEIGHT	TEXT	LETT HE IG	ER GHT	VER7 SPA	TICAL CING	ARI RTE.	ROW MKR.	SIGNS REQUIRED	BACK- GROUND	LEGEND BORDER	SQUARE FEET
RI-I	36"	36"	STOP	CONFO	TEXT DRM T STAND, 20	DIMEN. O "MUTO ARD HI DI2 SUF	SIONS S CD" - 200 GHWAY . PPLEME!	SHALL D9 EDI SIGNS" VT	TION- -	/	RED	WHITE	9.00 (9.00)
R2-I (25) (45) (50) (60)	48*	60"	SPEED LIMIT XX							2252	WHITE	BLACK	20.00 (40.00) (40.00) (100.00) (40.00)
R2-6aP	36"	24"	FINES DOUBLE							9	WHITE	BLACK	6.00 (54.00)
R2-12	36"	54"	END WORK ZONE SPEED LIMIT							10	WHITE	BLACK	13.50 (135.00)
WI-4L	48"	48"	(\$)							2	ORANGE	BLACK	16.00 (32.00)
WI-4R	48"	48"	(/	ORANGE	BLACK	16.00 (16.00)
WI-4bL	48"	48"	(\$\$)							4	ORANGE	BLACK	16.00 (64.00)
WI-4bR	48"	48"	(1)							6	ORANGE	BLACK	16.00 (96.00)
W3-/	48"	48"			1			,		1	ORANGE	BLACK	16.00 (16.00)

MAINLINE CONSTRUCTION SIGN SUMMARY

ID	SIZE (OF SIGN	TEXT		TEXT DIMENSIONS (IN LETTER VERTICAL HEIGHT SPACING			NCHES)	NUMBER OF SIGNS	COL	.OR	AREA IN SQUARE
NUMBER	WIDTH	HEIGHT	/EX/	LET: HE I	TER GHT	VERT SPA	TICAL CING	AR. RTE.	ROW MKR.	REQUIRED	BACK- GROUND	LEGEND BORDER	SQUARE FEET
W3-4	48"	48"	BE PREPARED TO STOP	CONF	TEXT ORM T STAND. 20	DIMEN O "MUTO ARD HI DI2 SUF	SIONS : CD" - 200 GHWAY PPLEME!	SHALL 09 ED! SIGNS" NT	T10N- -	6	ORANGE	BLACK	/6.00 (96.00)
W3-5 (25) (45)	48"	48"	SPEED							2 8	ORANGE	BLACK	16,00 (32,00) (128,00)
W4-I	48"	48"	(/	ORANGE	BLACK	16.00 (16.00)
W4-2L	48"	48"								6	ORANGE	BLACK	16.00 (96.00)
W4-2R	48"	48"								8	ORANGE	BLACK	16.00 (128.00)
W4-3	48"	48"	13							/	ORANGE	BLACK	16.00 (16.00)
W4-5P	24"	30"	NO MERGE AREA							/	ORANGE	BLACK	5.00 (5.00)
W7-3aP (1/2) (1) (2)	36"	30"	NEXT X MILES							4 8 2	ORANGE	BLACK	7,50 (30,00) (60,00) (15,00)
W8-I	48"	48"	BUMP						1	6	ORANGE	BLACK	16.00 (96.00)

\\MST	Scal	le:			Designed by:					
HIGHWAY		N.T.S.				(Sta	antec		
\00\	No.	Revision	Ву	Date						
					CONSULTANT F	PROJE	CT MANAGER:	LAUREN MEEK,	PE	
ilename						Ву	Date		Ву	Date
end					Designed	TFD	3\20\19	Checked	LEM	3\20\19
Ē					Drawn	PLP	3\20\19	In Charge of	GAE	3\20\19

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THE GOLD STAR MEMORIAL HIGHWAY

INTERCHANGE 103 ORT CONVERSION

MOT SIGN SUMMARY-2

SHEET NUMBER: S-18 98 OF 503

MTA PROJECT MANAGER: RALPH NORWOOD, IV, PE, PTOE

SIZE OF SIGN ID NUMBER WIDTH HEIGHT				7	TEXT I	DIMENS.	IONS (I	NCHES.		NUMBER OF SIGNS	COL	.OR	AREA IN
NUMBER	WIDTH	HEIGHT	IEXI	LETT HE IC	TER GHT	VERT SPA	TICAL CING	ARI RTE.	ROW MKR.	REQUIRED	BACK- GROUND	LEGEND BORDER	SQUARE FEET
W8-24a	48"	<i>48</i> ″	RUMBLE STRIPS AHEAD	CONFO	ORM TO STAND	DIMEN. D''MUTC ARD HI DI2 SUF	D" - 200 GHWAY	19 EDIT SIGNS"	-ION - -	6	ORANGE	BLACK	/6.00 (96.00)
WI3-4P	36"	36"	ON RAMP							4	ORANGE	BLACK	9.00 (36.00)
W16-4P (500) (700) (1000) (1500) (2000)	36"	30"	NEXT X FEET							। 23 22	ORANGE	BLACK	7.50 (7.50) (15.00) (22.50) (15.00) (15.00)
W20-I (AHEAD) (I MILE)	48"	48"	ROAD WORK XX							30 6	ORANGE	BLACK	16.00 (480.00) (128.00)
W20-4	48"	<i>48</i> "	ONE LANE ROAD AHEAD							/	ORANGE	BLACK	/6.00 (/6.00)
W20-5	48"	48"	LANE							2	ORANGE	BLACK	16.00 (32.00)
W20-5R (I/2 MILE)	48"	48"	RIGHT LANE CLOSED XX							8	ORANGE	BLACK	16.00 (128.00)
W20-5L (I/2 MILE)	48"	48"	LEFT LANE CLOSED XX							6	ORANGE	BLACK	16.00 (96.00)
W20-7	48"	48"								2	ORANGE	BLACK	16.00 (32.00)
W2I-5	48"	48"	SHOULDER						•	8	ORANGE	BLACK	16.00 (128.00)

	ID	SIZE C	F SIGN	TEVT	-	TEXT L	DIMENS	IONS (I	NCHES.)	NUMBER OF SIGNS	COL	.OR	AREA IN SQUARE
,	NUMBER	WIDTH	HEIGHT	TEXT	LETTI HE I (TER GHT	VERT SPA	TICAL CING	ARI RTE.	ROW MKR.	REQUIRED	BACK- GROUND	LEGEND BORDER	SQUARE FEET
	W2I-5a	48"	48"	SHOULDERS	CONFO	ORM TO STAND	DIMEN D''MUTC ARD HI DI2 SUF	D" - 200 GHWAY	9 EDIT SIGNS"	- -	5	ORANGE	BLACK	16.00 (80.00)
	W2I-5aR	48"	48"	RIGHT SHOULDER CLOSED							6	ORANGE	BLACK	16.00 (96.00)
	W2I-5aL	48"	48"	LEFT SHOULDER CLOSED							4	ORANGE	BLACK	16.00 (64.00)
	W2I-5b (500) (1000)	48"	48"	SHOULDERS							2 4	ORANGE	BLACK	16.00 (32.00) (64.00)
d.	W2I-5bR 1000 FT) /2 MILE)	48"	48"	RIGHT SHOULDER CLOSED XX							3 2	ORANGE	BLACK	16.00 (48.00) (32.00)
(,	W2I-5bL 1000 FT)	48"	48"	LEFT SHOULDER CLOSED XX							2	ORANGE	BLACK	16.00 (32.00)
	W24-IR	48"	48"	(,		,		,	Ī	1	ORANGE	BLACK	16.00 (16.00)

N.T.S.

Revision

Stantec

CONSULTANT PROJECT MANAGER: LAUREN MEEK, PE

 By
 Date
 By
 Date

 TFD 3\20\19
 Checked
 LEM 3\20\19

 PLP 3\20\19
 In Charge of GAE 3\20\19

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THE GOLD STAR MEMORIAL HIGHWAY


INTERCHANGE 103 ORT CONVERSION

MOT SIGN SUMMARY-3


SHEET NUMBER: S-18

CONTRACT:2019.04

MTA PROJECT MANAGER: RALPH NORWOOD, IV, PE, PTOE

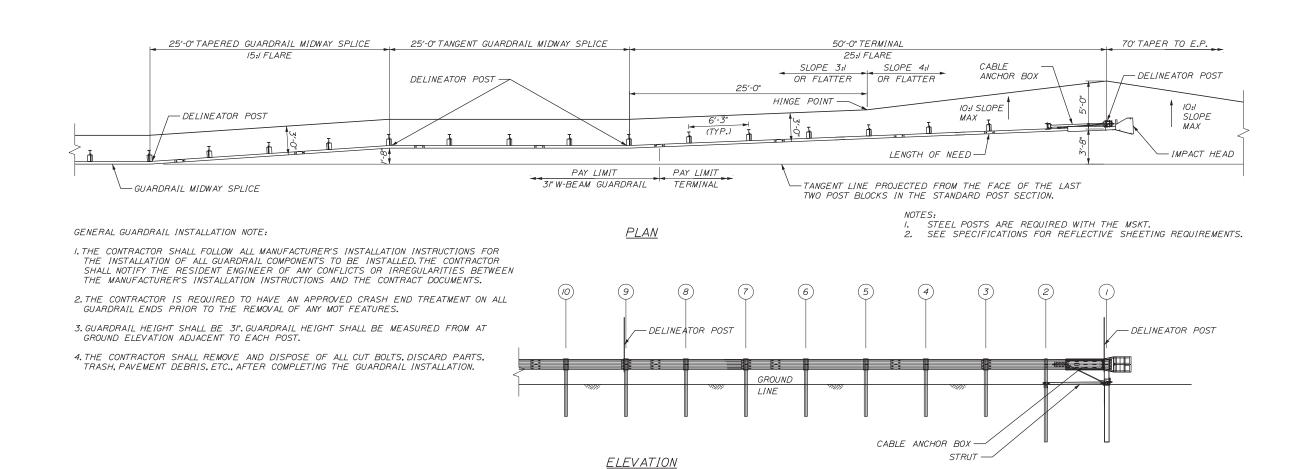

GUARDRAIL TANGENT TERMINAL - 31" W-BEAM GUARDRAIL NOT TO SCALE

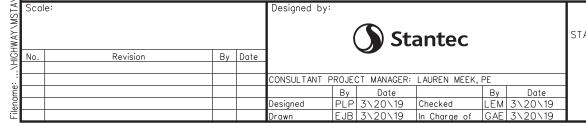

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THE GOLD STAR **MEMORIAL HIGHWAY**

INTERCHANGE 103 ORT CONVERSION


GUARDRAIL DETAILS 1

SHEET NUMBER: DET-01

MTA PROJECT MANAGER: RALPH NORWOOD, IV, PE, PTOE

NOTES:
I. THIS DETAIL MODIFIES
THE SEW31 DRAWING SUCH THAT W-BEAM DOES NOT EXTEND BEYOND THE LAST GUARDRAIL POST. THE RWMI4a W-BEAM PANEL SHALL HAVE A LENGTH OF 9'-41/2" MEASURED FROM THE CENTER OF THE MIDWAY SPLICE TO THE CENTER OF THE LAST GUARDRAIL


TERMINAL END - ANCHORED END - 31" W-BEAM GUARDRAIL (ITEM_606.1351) NOT TO SCALE

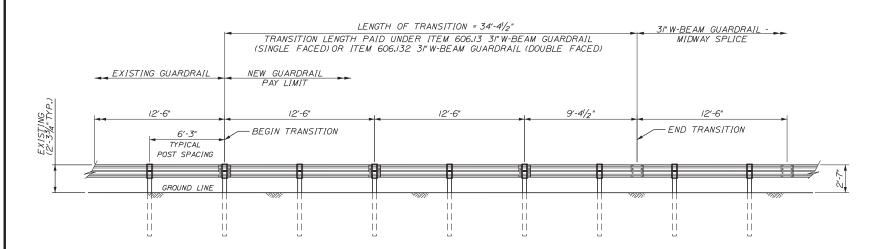


TRANSITION FROM EXISTING GUARDRAIL TO 31" MID-WAY SPLICED GUARDRAIL NOT TO SCALE

NOTES:


- MAINTAIN STANDARD I" CLEARANCE OF POST ABOVE PANEL THROUGHOUT THE ENTIRE LENGTH OF
- A MINIMUM OF ONE (1) 12'-6" PANEL SHALL BE PLACED BETWEEN THIS TRANSITION AND THE START OF ANY END TREATMENT OR ANCHORAGE.
- 3. ALL NEW POST SHALL BE 84" IN LENGTH UNLESS OTHERWISE SPECIFIED BY THE ENGINEER.
- 4. ALL NEW POSTS AND OFFSET BLOCK MATERIALS SHALL MATCH EXISTING UNLESS OTHERWISE SPECIFIED BY

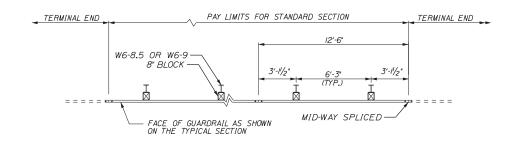

PLAN - SINGLE FACED

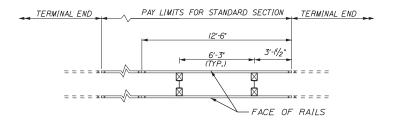

PLAN - DOUBLE FACED

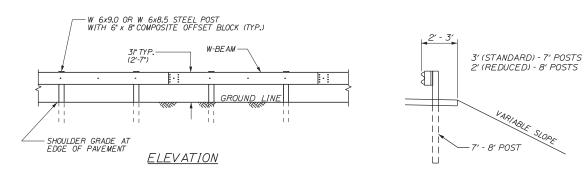

31" W-BEAM GUARDRAIL - MID-WAY SPLICE (8" OFFSET BLOCKS) (ITEMS 606.13, 606.132) NOT TO SCALE

GENERAL GUARDRAIL INSTALLATION NOTE:

- THE CONTRACTOR SHALL FOLLOW ALL MANUFACTURER'S INSTALLATION INSTRUCTIONS FOR THE INSTALLATION OF ALL GUARDRAIL COMPONENTS TO BE INSTALLED. THE CONTRACTOR SHALL NOTIFY THE RESIDENT ENGINEER
 OF ANY CONFLICTS OR IRREGULARITIES BETWEEN THE
 MANUFACTURER'S INSTALLATION INSTRUCTIONS AND THE
- 2. THE CONTRACTOR IS REQUIRED TO HAVE AN APPROVED CRASH END TREATMENT ON ALL GUARDRAIL ENDS PRIOR TO THE REMOVAL OF ANY MOT FEATURES.
- 3. GUARDRAIL HEIGHT SHALL BE 31",-1/2".GUARDRAIL HEIGHT SHALL BE MEASURED FROM AT GROUND ELEVATION ADJACENT TO EACH POST.

THE CONTRACTOR SHALL REMOVE AND DISPOSE OF ALL CUT BOLTS, DISCARD PARTS, TRASH, PAVEMENT DEBRIS, ETC., AFTER COMPLETING THE GUARDRAIL INSTALLATION.

CROSS-SECTION

CONNECTION FOR PROPOSED RAIL TO EXISTING RAIL SHALL BE INCIDENTAL TO THE PROPOSED GUARDRAIL

Scale: Designed by: Stantec Revision By Date ONSULTANT PROJECT MANAGER: LAUREN MEEK, PE 3\20\19

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THE GOLD STAR MEMORIAL HIGHWAY

ORT CONVERSION


INTERCHANGE 103

GUARDRAIL DETAILS 2


SHEET NUMBER: DET-02

MTA PROJECT MANAGER: RALPH NORWOOD, IV. PE, PTOE

PLAN

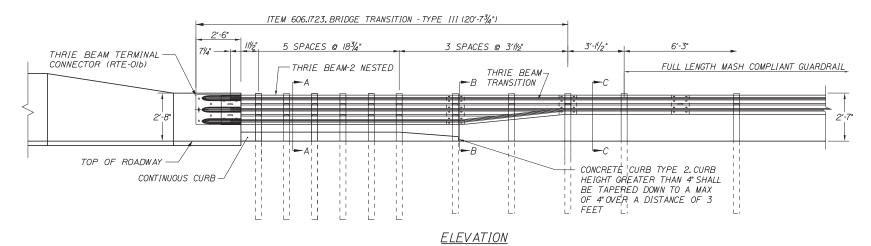


BRIDGE TRANSITION - TYPE III (ITEM 606,1723) 3/8" = 1'-0"

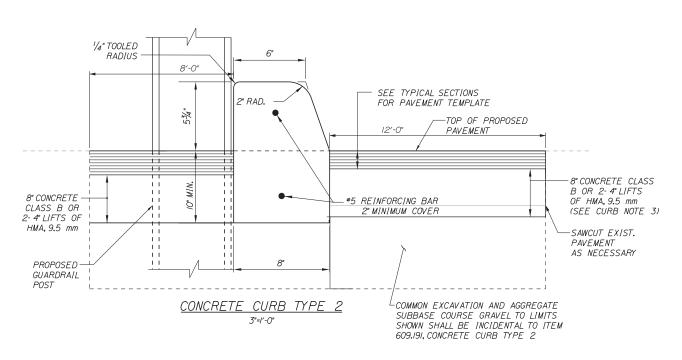

Designed by:

By Date

- I. CURBING SHALL BE EITHER PRECAST CONCRETE, CAST-IN-PLACE CONCRETE OR GRANITE TO MEET DIMENSIONS SHOWN ON THE PLANS.
- 2. CONCRETE CURBS USED IN CONJUNCTION WITH THRIE-BEAM BRIDGE ATTACHMENT SHALL BE TYPE 2, SEE DETAILS THIS SHEET. CONCRETE CURBS SHALL BE CONTINOUS WITHOUT DRAINAGE CUTS.
- 3. CURB TRANSITION SHALL NOT BE PAID FOR DIRECTLY BUT SHALL BE INCIDENTAL TO THE BRIDGE TRANSITION PAY ITEM.
- 4. SAWCUTTING EXISTING PAVEMENT, CONCRETE FILL, AND PAVEMENT TO LIMITS SHOWN SHALL BE INCIDENTAL TO THE BRIDGE TRANSITION PAY ITEM.

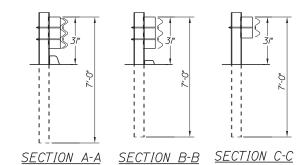

GENERAL NOTES:

- I. ADDITIONAL HOLES MAY BE MADE IN THE THRIE-BEAM PANELS BY DRILLING, PUNCHING, OR OTHER MEANS THAT PRODUCE A NEAT, CLEAN HOLE. BURNING HOLES WILL NOT BE ALLOWED.
- 2. THRIE BEAM SHALL BE PLACED WITH THE COMPOSITE BLOCKOUT FACE IN FRONT OF OR DIRECTLY ABOVE THE CURB FACE.
- 3. RAIL ELEMENT SHALL MEET ALL REQUIREMENTS OF AASHTO M-180 EXCEPT AS MODIFIED ON THE PLANS.THE THRIE BEAM TRANSITION TO W-BEAM SHALL BE OF THE SAME MATERIAL, BUT SHALL NOT BE LESS THAN IO GAUGE.
- 4. AFTER INSTALLATION IS COMPLETE, UPSET THE THREAD ON THE ANCHOR BOLTS IN THREE PLACES AROUND EACH BOLT, AT THE JUNCTION OF THE NUT AND THE EXPOSED THREAD, WITH A CENTER PUNCH OR SIMILAR TOOL.
- 5. STANDARD BARRIER HARDWARE HAS BEEN USED TO DEVELOP THESE GUARDRAIL ATTACHMENTS. DESIGNATIONS PROVIDED IN PARENTHESIS RELATE TO STANDARD ELEMENTS DETAILED IN "A GUIDE TO STANDARDIZED BARRIER RAIL HARDWARE." 1979. AASHTO-AGC-ARTBA JOINT COOPERATE COMMITTEE.
- 6. I" HOLE IN CONCRETE SHALL BE FORMED BY A I" I.D. PVC SLEEVE AS APPROVED BY THE ENGINEER.
- 7. GUARDRAIL HEIGHT SHALL BE ADJUSTED UNIFORMLY BETWEEN SECTION CALLOUTS.



INTERCHANGE 103 ORT CONVERSION

GUARDRAIL DETAILS 3

SHEET NUMBER: DET-03

MTA PROJECT MANAGER: RALPH NORWOOD, IV. PE, PTOE


CONTRACT:2019.04


Scale

Revision


Stantec ONSULTANT PROJECT MANAGER: LAUREN MEEK, PE 3\20\19

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PERSPECTIVE VIEW

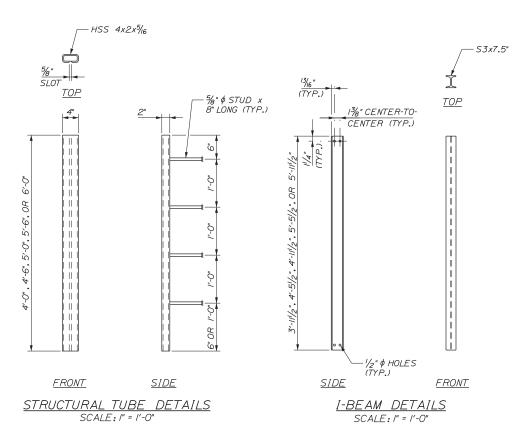

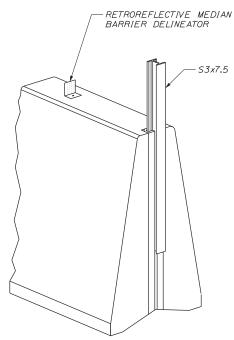
BARRIER CONNECTION DETAIL SCALE: 11/2" = 1'-0"

HSS $4x2x\frac{5}{16}$ (TYP.)

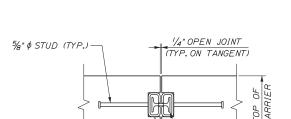53x75

BARRIER NOTES

- I. THE CONCRETE BARRIER DETAILS, AS SHOWN, ARE IN COMPLIANCE WITH THE REQUIREMENTS OF NCHRP REPORT 350, TL-4,
- 2. I-BEAMS AND STRUCTURAL TUBES SHALL BE GALVANIZED AFTER FABRICATION.
- 3. SHOP DRAWINGS SHALL INCLUDE REINFORCING SCHEDULE. CONTRACTOR SHALL PROVIDE SHOP DRAWINGS FOR ANGLE POINTS IN BARRIER.
- 4. MEDIAN BARRIER SHALL BE PAID FOR UNDER APPROPRIATE 526 ITEMS.
- 5. BARRIERS SHALL BE LIGHT COLORED CLASS 'P' CONCRETE HAVING A MINIMUM 28 DAY COMPRESSION STRENGTH OF 4,500 PSI. BARRIERS SHALL HAVE A SMOOTH UNIFORM SURFACE FREE OF DEFECTS AND IRREGULARITIES. CASTING DATE SHALL BE SHOWN ON THE BARRIER, ALL EXPOSED EDGES OF CONCRETE SHALL BE CHAMFERED I UNLESS OTHER
- 6. ALL REINFORCING STEEL SHALL BE ASSHTO M31 (ASTM-A615) GRADE 60, EPOXY COATED. REINFORCEMENT SHOWN IS THE MINIMUM REQUIRED.
- 7. CLEAR PROTECTIVE COATING FOR CONCRETE SURFACES SHALL BE APPLIED ON-SITE AND APPROVED BY THE RESIDENT. COATING SHALL BE INCIDENTAL TO BARRIER.

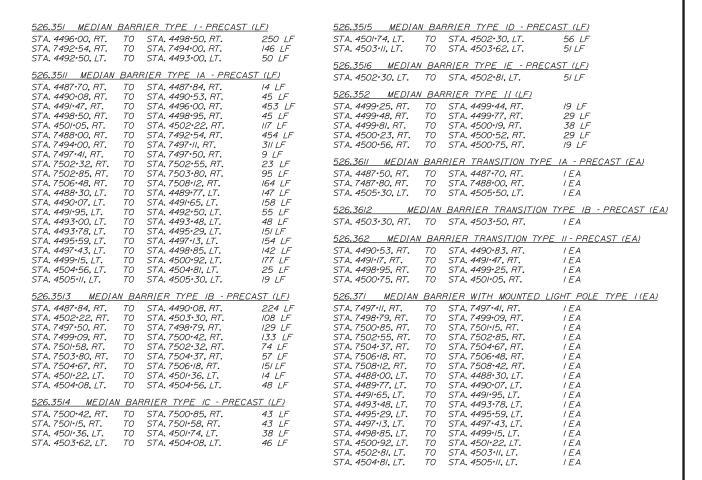

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					Drawn	EJB	3\20\19	In Charge of	GAE	3\20\19

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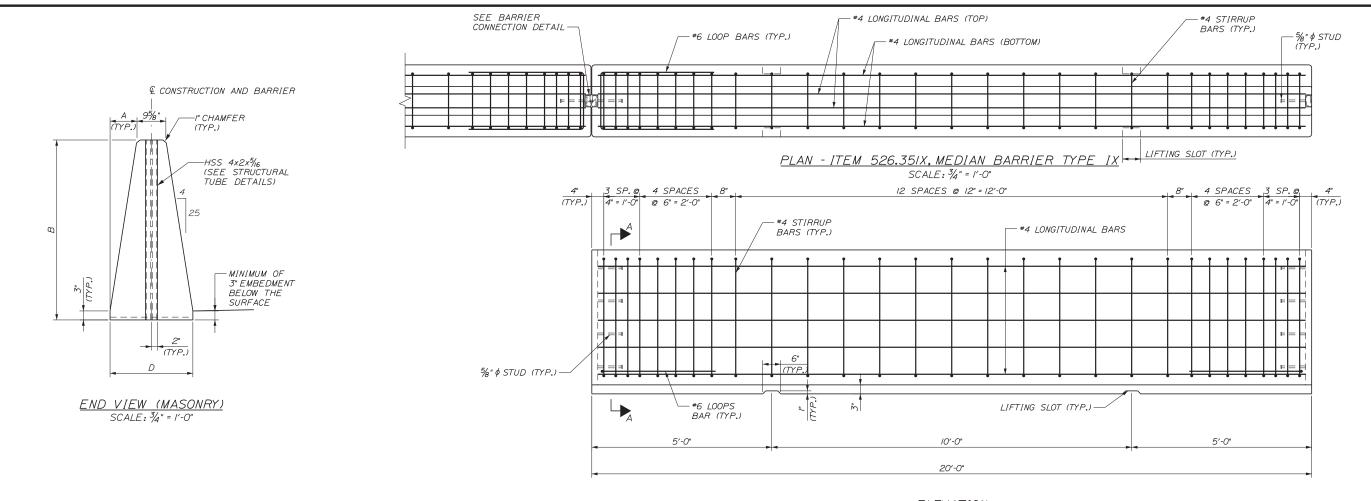



THE GOLD STAR MEMORIAL HIGHWAY INTERCHANGE 103 ORT CONVERSION

BARRIER DETAILS 1


SHEET NUMBER: DET-04

MTA PROJECT MANAGER: RALPH NORWOOD, IV. PE, PTOE




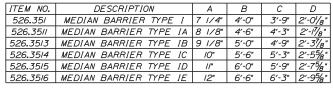

VARIABLE HEIGHT MEDIAN BARRIER SCALE: 3/4" = 1'-0"

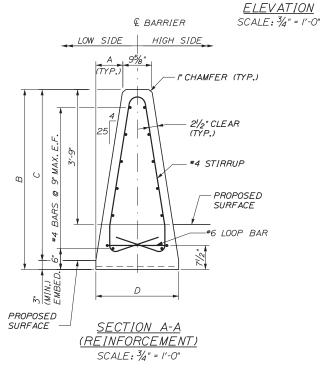

CONCRE	CONCRETE BARRIER REINFORCING SCHEDULE														
DESCRIPTION	BARRIER HEIGHT	SIZE	NO.	UNBENT LENGTH	TYPE	Α	В	С							
ONGITUDINAL EACH FACE)	N/A	#4	VARIES	19′-8"											
STIRRUP	4'-0"	#4	29	8'-11"		2′-6"	9"	1'-23/4"							
STIRRUP	4′-6"	#4	29	10'-1"		3′-0"	10"	1'-41/2"							
STIRRUP	5′-0"	#4	29	11′-3"		3′-6″	//"	1'-61/2"							
STIRRUP	5′-6"	#4	29	12'-5"		4'-0"	/'-O"	1'-81/4"							
STIRRUP	6′-0"	#4	29	/3′-7"		4'-6"	/'-/"	1'-101/4"							
STIRRUP	6′-6"	#4	29	14'-9"		5′-0"	l'-2"	2'-01/4"							
LOOP BAR	N/A	#6	2	7'-11"		3′-3″	l'-5"	3′-3"							

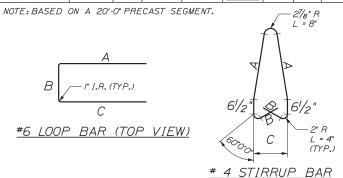

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Œ					Drawn	EJB	3\20\19	In Charge of	GAE	3\20\19

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THE GOLD STAR **MEMORIAL HIGHWAY**


INTERCHANGE 103 ORT CONVERSION


BARRIER DETAILS 2

CONTRACT:2019.04

SHEET NUMBER: DET-05


MTA PROJECT MANAGER: RALPH NORWOOD, IV. PE, PTOE

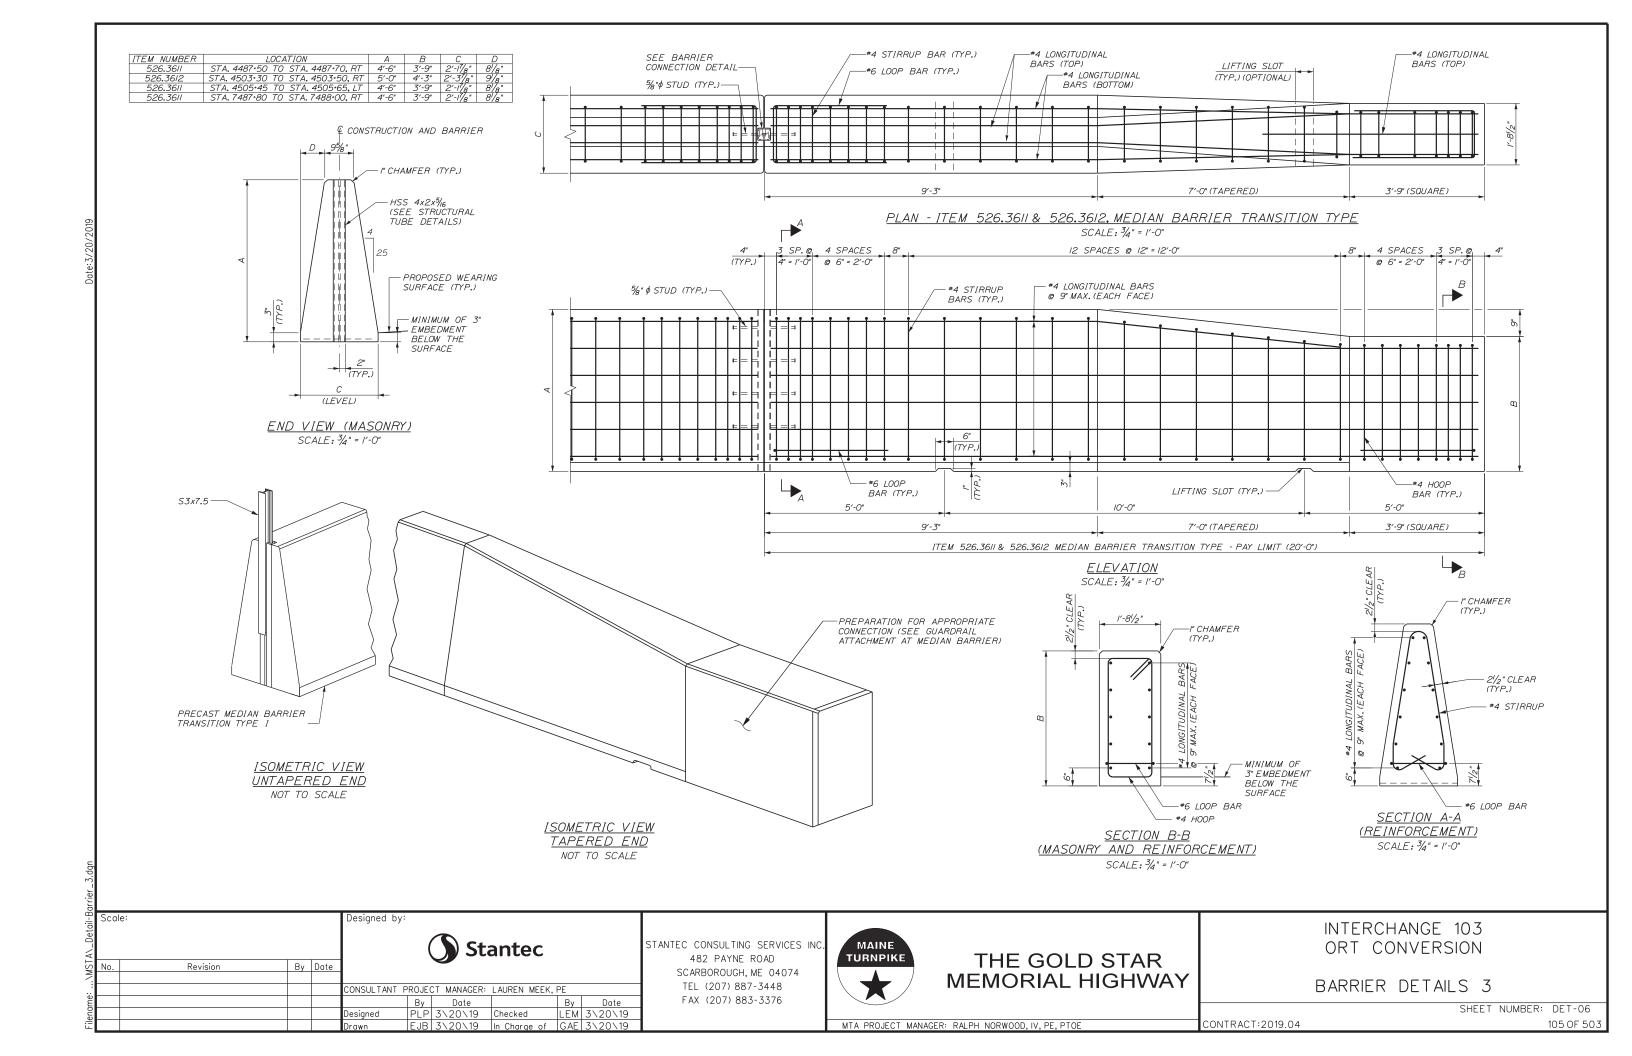

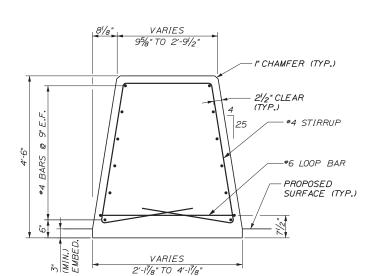

SECTION A-A

SCALE: 3/4" = 1'-0"

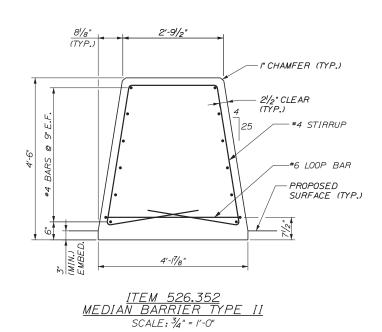

<u>NOTES</u>

- I. BARRIER FROM STA 4490·83.00, RT. TO STA, 4491·17.00, RT. SHALL BE INCIDENTAL TO ITEM 645.125. THE BARRIER SHALL HAVE THE SHAPE OF MEDIAN BARRIER TYPE II.
- 2. BARRIER FROM STA 4499+43.75 RT.TO STA.4499+47.75 RT., STA 4499-77.00 RT.TO STA.4499+81.00 RT., STA 4500+19.00 RT.TO STA.4500+23.00 RT., AND STA 4500+52.25 RT.TO STA.4500+56.25 RT. IS PART OF THE ORT SPACE FRAME PEDESTAL AND SHALL BE PAID FOR UNDER ITEM 502.231. THE BARRIER SHALL HAVE THE SHAPE OF MEDIAN BARRIER TYPE II.

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No.	Revision	Ву	Date	1					
				CONSULTANT	PROJE	CT MANAGER:	LAUREN MEEK	, PE	
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				Drawn	EJB	3\20\19	In Charge of	GAE	3\20\19

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THE GOLD STAR **MEMORIAL HIGHWAY**


INTERCHANGE 103 ORT CONVERSION

BARRIER DETAILS 4

SHEET NUMBER: DET-07

MTA PROJECT MANAGER: RALPH NORWOOD, IV, PE, PTOE

CONTRACT:2019.04

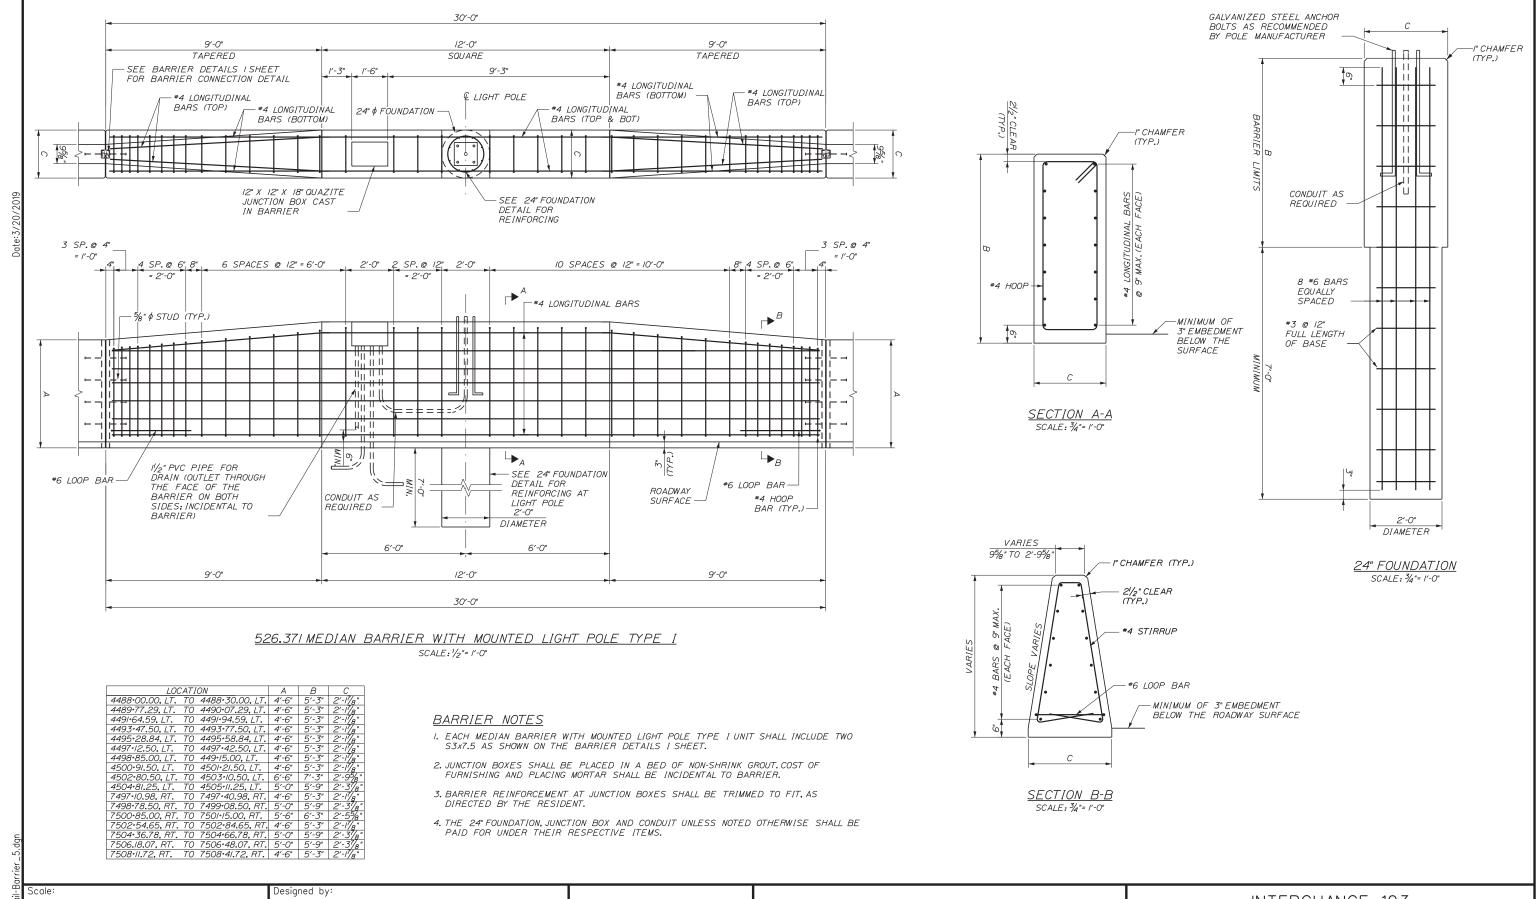

Revision By Date ONSULTANT PROJECT MANAGER: LAUREN MEEK, PE Designed

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THE GOLD STAR **MEMORIAL HIGHWAY**


INTERCHANGE 103 ORT CONVERSION


BARRIER DETAILS 5

SHEET NUMBER: DET-08

MTA PROJECT MANAGER: RALPH NORWOOD, IV. PE, PTOE


CONTRACT:2019.04

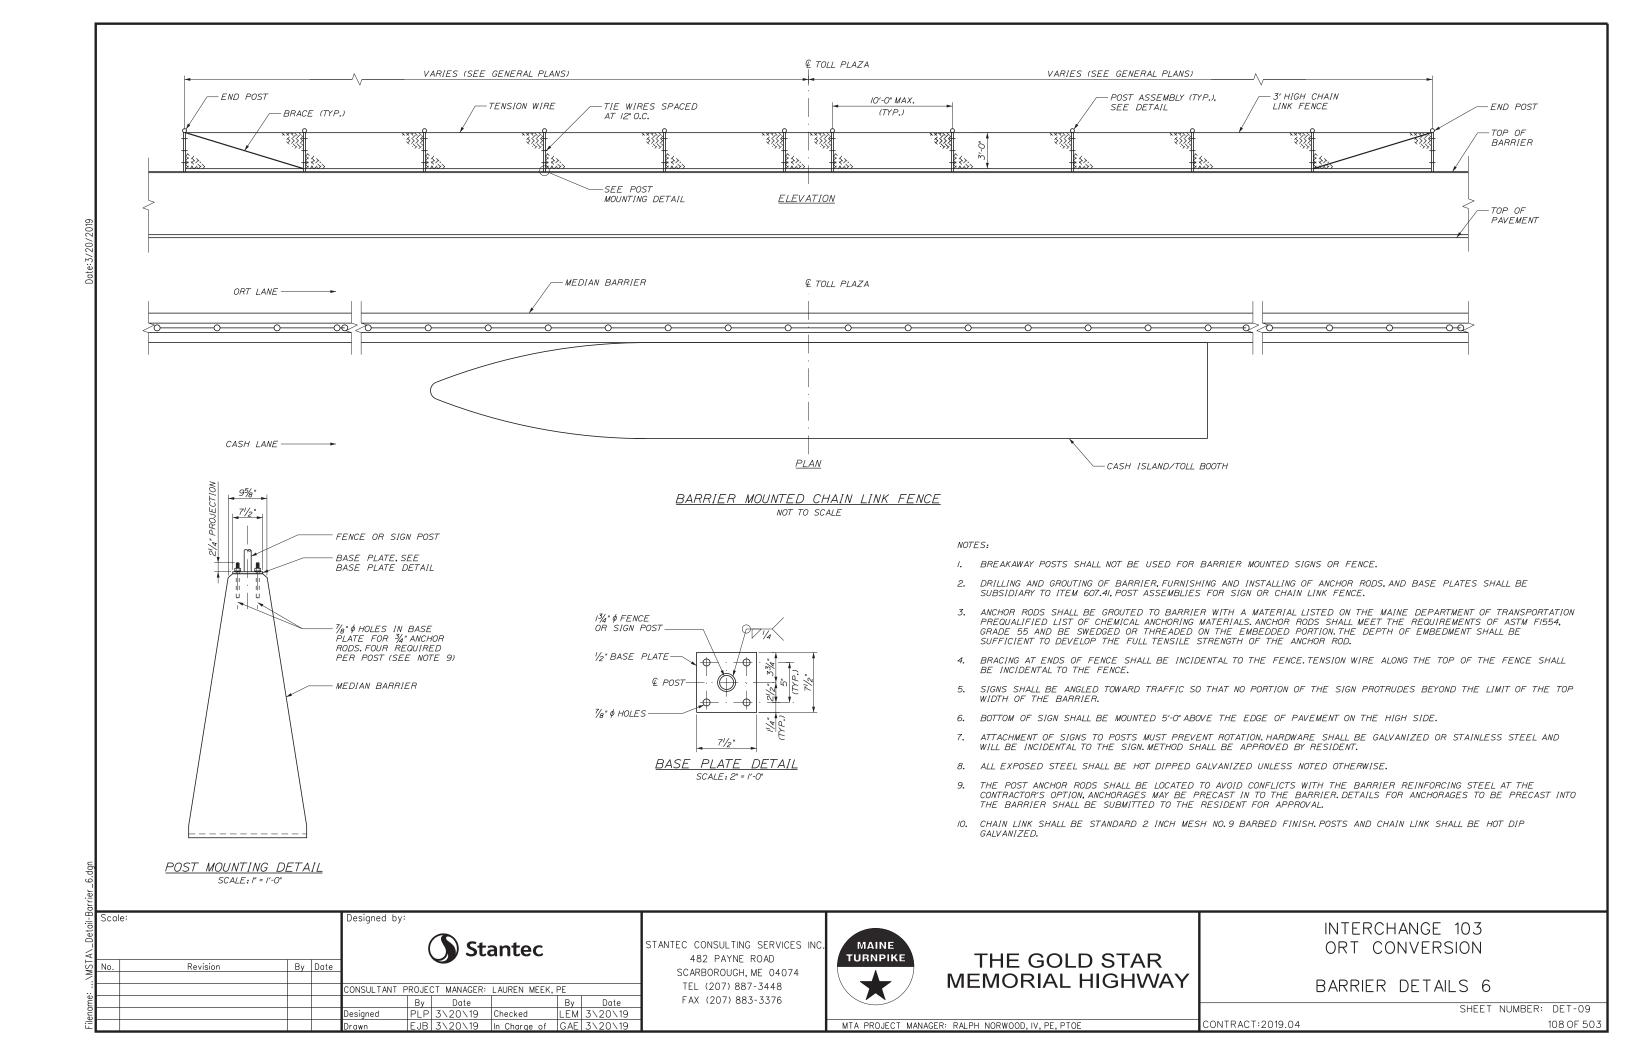

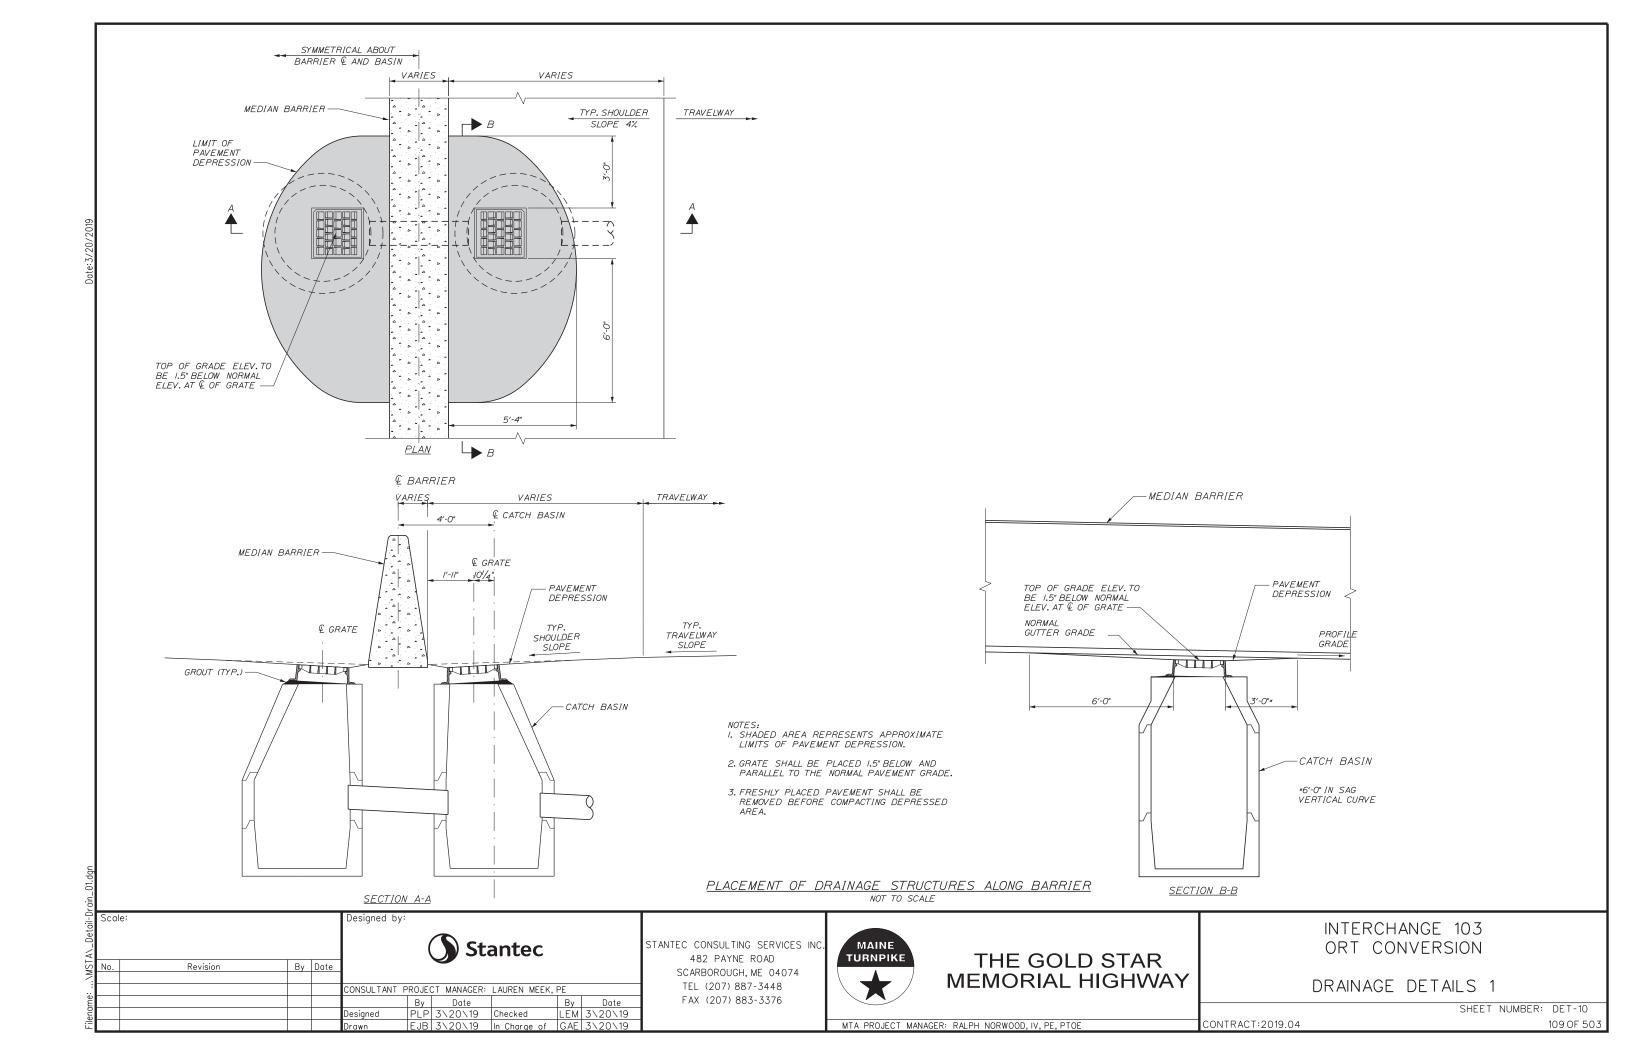



ILF OF DOWNSPOUT = .33 CY OF STONE DITCH PROTECTION
ILF OF DOWNSPOUT = 1.04 SY OF EROSION CONTROL GEOTEXTILE FABRIC


SECTION A-A NOT TO SCALE

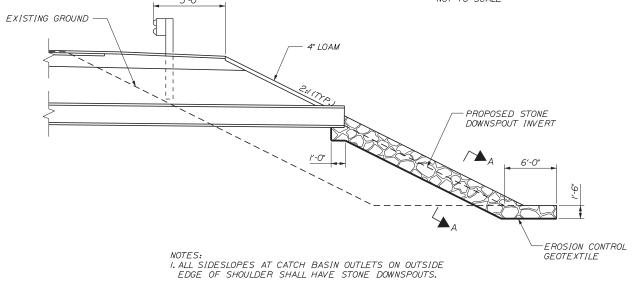


CATCH BASIN OUTLET ON OUTSIDE EDGE OF SHOULDER

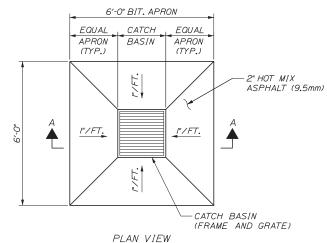

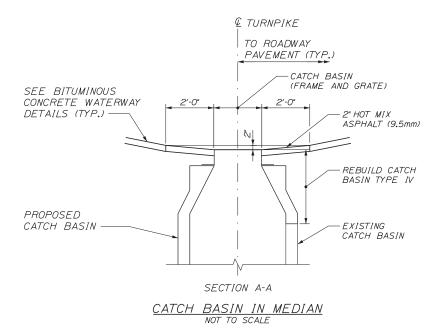

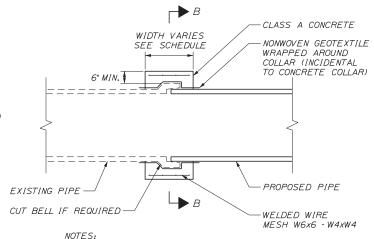

- I. CONNECTION AND PIPE TO BE BACKFILLED PER ASTM D232I(CRUSHED STONE).
- 2. CONCRETE SHALL BE CLASS A FIBER REINFORCED.
- 3. SEE CONCRETE COLLAR WIDTH SCHEDULE FOR DIMENSIONS.

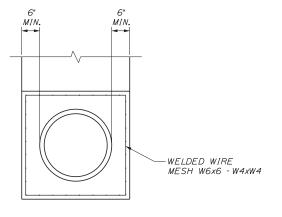

SECTION B-B

<u>CAST IN PLACE CONCRETE</u> <u>COLLAR FOR DRAINAGE PIPES</u>

Scale:				Designed b	/ :				
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No.	Revision	Ву	Date	1					
				CONSULTANT	PROJE	CT MANAGER:	LAUREN MEEK,	PE	
					Ву	Date		Ву	Date
				Designed	PLP	3\20\19	Checked	LEM	3\20\19
				Drawn	EJB	3\20\19	In Charge of	GAE	3\20\19

STANTEC CONSULTING SERVICES INC.
482 PAYNE ROAD
SCARBOROUGH, ME 04074
TEL (207) 887-3448
FAX (207) 883-3376



MTA PROJECT MANAGER: RALPH NORWOOD, IV. PE, PTOE

THE GOLD STAR
MEMORIAL HIGHWAY

DRIAL HIGHWAY DRAINAGE DETAILS 2

SHEET NUMBER: DET-11

CONTRACT:2019.04 110 OF 503

INTERCHANGE 103

ORT CONVERSION

DIMENSIONS FOR SLOPE OF 2:1

							STONE	STONE
D	a	b	С	е	f	g	DEPTH	(CY)
	(FT)	(FT)	(FT)	(FT)	(FT)	(FT)	(FT)	
12"	1.00	4.00	3.00	2.00	6.00	1.00	1.50	1.30
15"	1.00	4.50	3.37	2.25	6.75	1.63	1.50	1.70
18"	1.00	5.00	3.75	2.50	7.50	2.25	1.50	2.09
21"	1.00	5.50	4.13	2.75	8.25	2.88	1.50	2.58
24"	1.00	6.00	4.50	3.00	9.00	3.50	1.50	3.12
30"	1.00	7.00	5.25	3.50	10.50	4.75	1.50	4.33
36"	1.00	8.00	6.00	4.00	12.00	6.00	1.50	5.75
42"	1.00	9.00	6.75	4.50	13.50	7.25	1.50	7.37
48"	1.00	10.00	7.50	5.00	15.00	8.50	1.50	9.18
54"	1.00	11.00	8.25	5.50	16.50	9.75	1.50	11.19
60"	1.00	12.00	9.00	6.00	18.00	11.00	1.50	13.40
66"	1.00	13.00	9.75	6.50	19.50	12.25	1.50	15.81
72"	1.00	14.00	10.50	7.00	21.00	13.50	1.50	18.41
84"	1.00	16.00	12.00	8.00	24.00	16.00	1.50	24.22

PLAIN RIPRAP (ITEM 610.08)

10'-0" V.C. 5′-0" 5′-0" TOP OF STONE CHECK DAM SECTION

DIMENSIONS FOR SLOPE OF 4:1

							STONE	STONE
D	a	b	С	е	f	g	DEPTH	(CY)
	(FT)	(FT)	(FT)	(FT)	(FT)	(FT)	(FT)	
12"	1.00	8.00	6.00	2.00	6.00	0.00	1.50	2.20
15"	1.00	9.00	6.75	2.25	6.75	0.00	1.50	2.80
18"	1.00	10.00	7.50	2.50	7.50	0.00	1.50	3.40
21"	1.00	11.00	8.25	2.75	8.25	0.00	1.50	4.10
24"	1.00	12.00	9.00	3.00	9.00	0.00	1.50	4.86
30"	1.00	14.00	10.50	3.50	10.50	0.00	1.50	6.58
36"	1.00	16.00	12.00	4.00	12.00	0.00	1.50	8.56
42"	1.00	18.00	13.50	4.50	13.50	0.50	1.50	10.92
48"	1.00	20.00	15.00	5.00	15.00	1.00	1.50	13.57
54"	1.00	22.00	16.50	5.50	16.50	1.50	1.50	16.50
60"	1.00	24.00	18.00	6.00	18.00	2.00	1.50	19.72
66"	1.00	26.00	19.50	6.50	19.50	2.50	1.50	23.22
72"	1.00	28.00	21.00	7.00	21.00	3.00	1.50	27.01
84"	1.00	32.00	24.00	8.00	24.00	4.00	1.50	35.45

DIMENSIONS FOR SLOPE OF 6:1

(FT)

2 00

2.25

2.50

3.00

3.50

4.00

4.50

5.00

5.50

6.00

6.50

7.50

1.50

(FT)

4.50

5.50

6.50

7.25

8.00

9.50

11.00

12.50

14.00

15.50

17.00

18.50

20.00

23.00

0.00

0.00

(FT)

9.00

12.00

13.50

15.00

18.00

21.00

24.00

27.00

30.00

33.00

36.00

39.00

45.00

0.50

0.50

21"

24'

30'

36"

42'

48"

54"

60"

66'

84"

(FT)

7.50

10.00

11.25

12.50

15.00

17.50

20.00

22.50

25.00

27.50

30.00

32.50

37.50

STONE

DEPTH

(FT)

1.50

1.50

STONE

(CY)

2.30

2.93

3.57

4.46

5.44

10.37

13.42

16.87


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24.93


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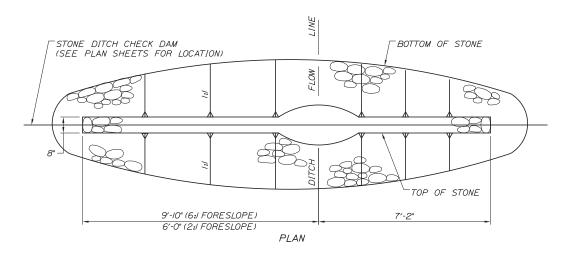
45.76



SECTION B-B

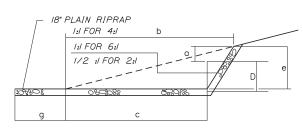

SECTION A-A

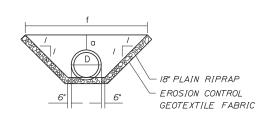

QUANTITY C.Y. STONE NOTES:
I. STONE FOR TEMPORARY AND PERMANENT
STONE CHECK DAMS SHALL MEET THE
REQUIREMENTS OF MDOT SPECIFICATION 703.29, STONE DITCH PROTECTION. 2. TEMPORARY STONE CHECK DAMS WILL BE PAID FOR UNDER ITEM 610.181.

ROADWAY CULVERT END

SLOPE TREATMENT NOT TO SCALE

NOTES:

I. THE DIMENSIONS SHOWN ARE APPROXIMATE AND MAY BE MODIFIED BY THE RESIDENT.

2. STONE QUANTITIES ARE FOR ONE END OF THE PIPE.

STONE CHECK DAM NOT TO SCALE

2.5

2.0

Scale:				Designed by:					
					(Sta	antec		
No.	Revision	Ву	Date						
				CONSULTANT F	PROJE	CT MANAGER:	LAUREN MEEK,	PE	
					Ву	Date		Ву	Date
				Designed	PLP	3\20\19	Checked	LEM	3\20\1
				Drawn	F.IR	3\20\19	In Charge of	GAF	3\20\1

STANTEC CONSULTING SERVICES INC 482 PAYNE ROAD SCARBOROUGH, ME 04074 TEL (207) 887-3448 FAX (207) 883-3376



THE GOLD STAR **MEMORIAL HIGHWAY**

FORESLOPE

6:1

2:1

BACKSLOPE

3:1

EROSION DETAILS 1


INTERCHANGE 103

ORT CONVERSION

SHEET NUMBER: DET-12


CONTRACT:2019.04


MTA PROJECT MANAGER: RALPH NORWOOD, IV. PE, PTOE

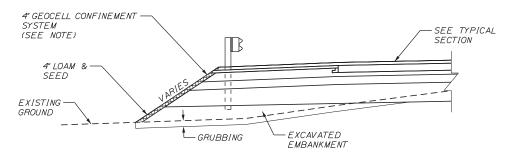

GEOCELL CONFINEMENT SYSTEM NOT TO SCALE


GEOCELL CONFINEMENT SYSTEM SHALL BE INSTALLED ON ALL SLOPES STEEPER THAN 2:1. SLOPES SHALL
BE GRUBBED, BACKFILLED AND COMPACTED PRIOR TO
GEOCELL CONFINEMENT SYSTEM INSTALLATION. SEE MAINEDOT STANDARD SPECIFICATIONS SECTION 614 FOR ADDITIONAL INFORMATION.

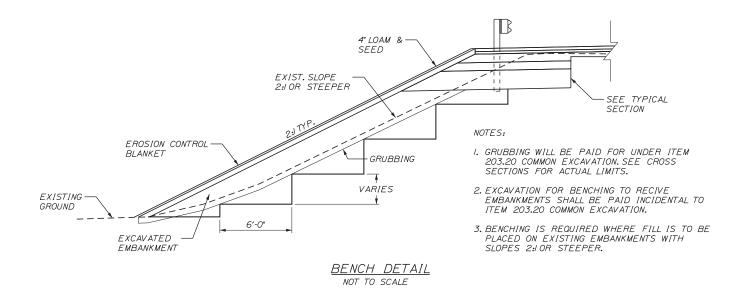

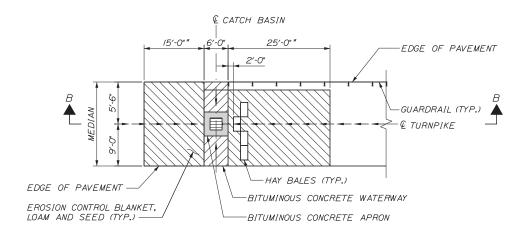

PLAN VIEW

* EXACT DIMENSION TO BE DETERMINED IN FIELD BY RESIDENT

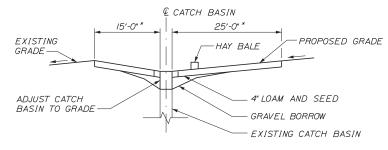


SECTION B-B

- I. INSTALL MINIMUM OF IO HAY BALES (5 EACH SIDE OF
- CATCH BASIN AT LOW POINTS.

 2. INSTALL MINIMUM OF 5 HAY BALES UP STREAM OF CATCH BASIN ON GRADE.
- 3. THE EXACT LOCATION AND NUMBER OF BALES SHALL BE AS DIRECTED BY THE RESIDENT
- 4. LOAM AND SEEDING METHOD NUMBER 2 WILL NOT BE MEASURED SEPARATELY FOR PAYMENT, BUT SHALL BE CONSIDERED INCIDENTAL TO ITEMS 615.07 OR 618.14.

PROPOSED EROSION CONTROL AT MEDIAN

NOT TO SCALE

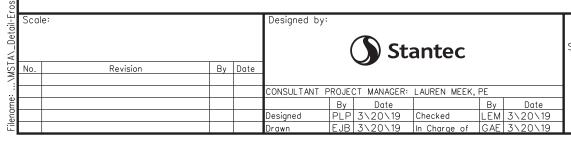

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THE GOLD STAR **MEMORIAL HIGHWAY** INTERCHANGE 103 ORT CONVERSION


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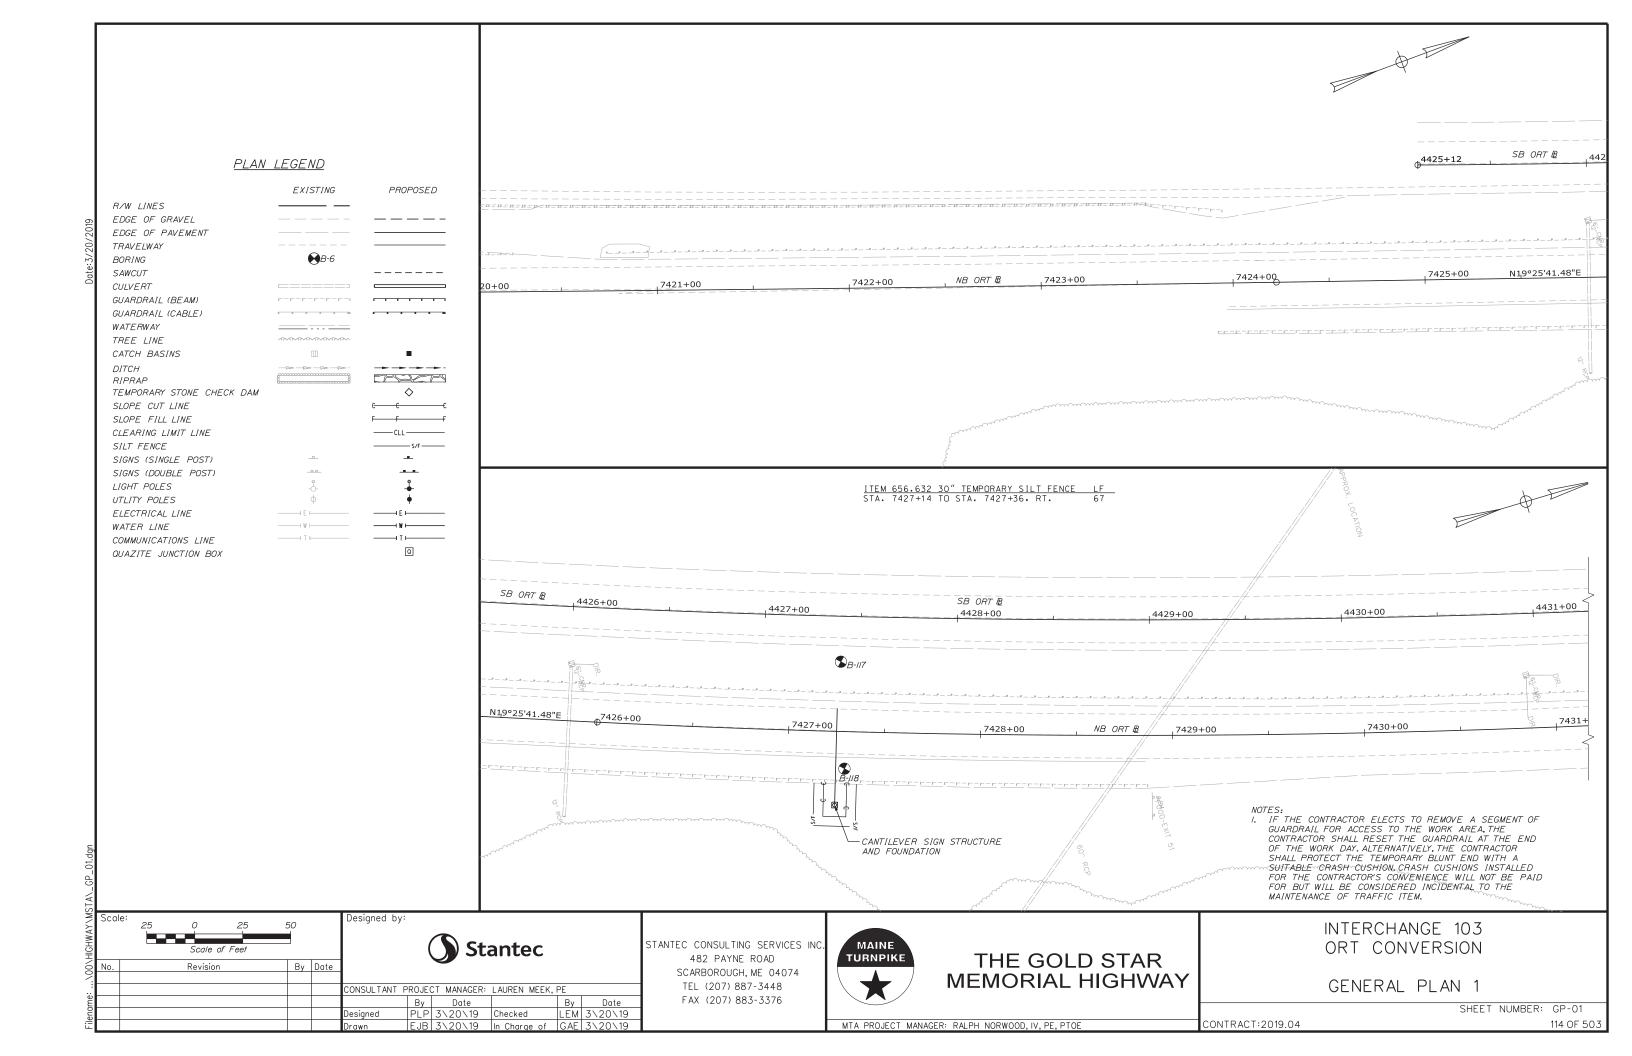
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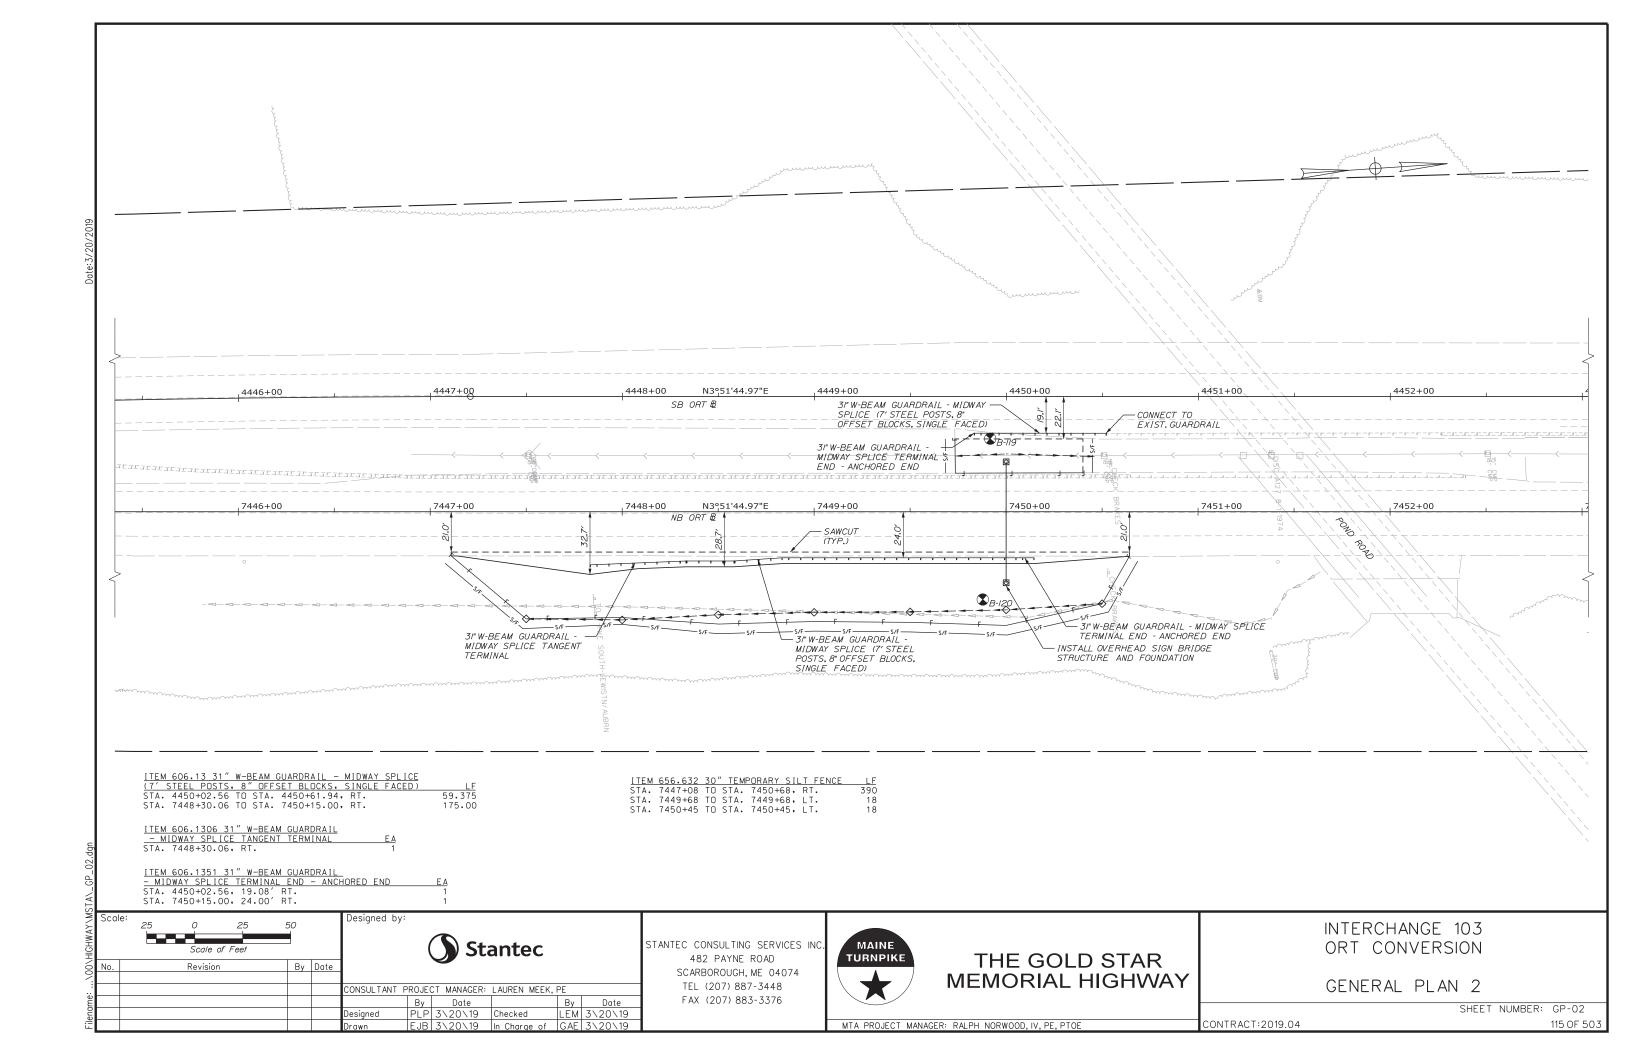
MTA PROJECT MANAGER: RALPH NORWOOD, IV. PE, PTOE


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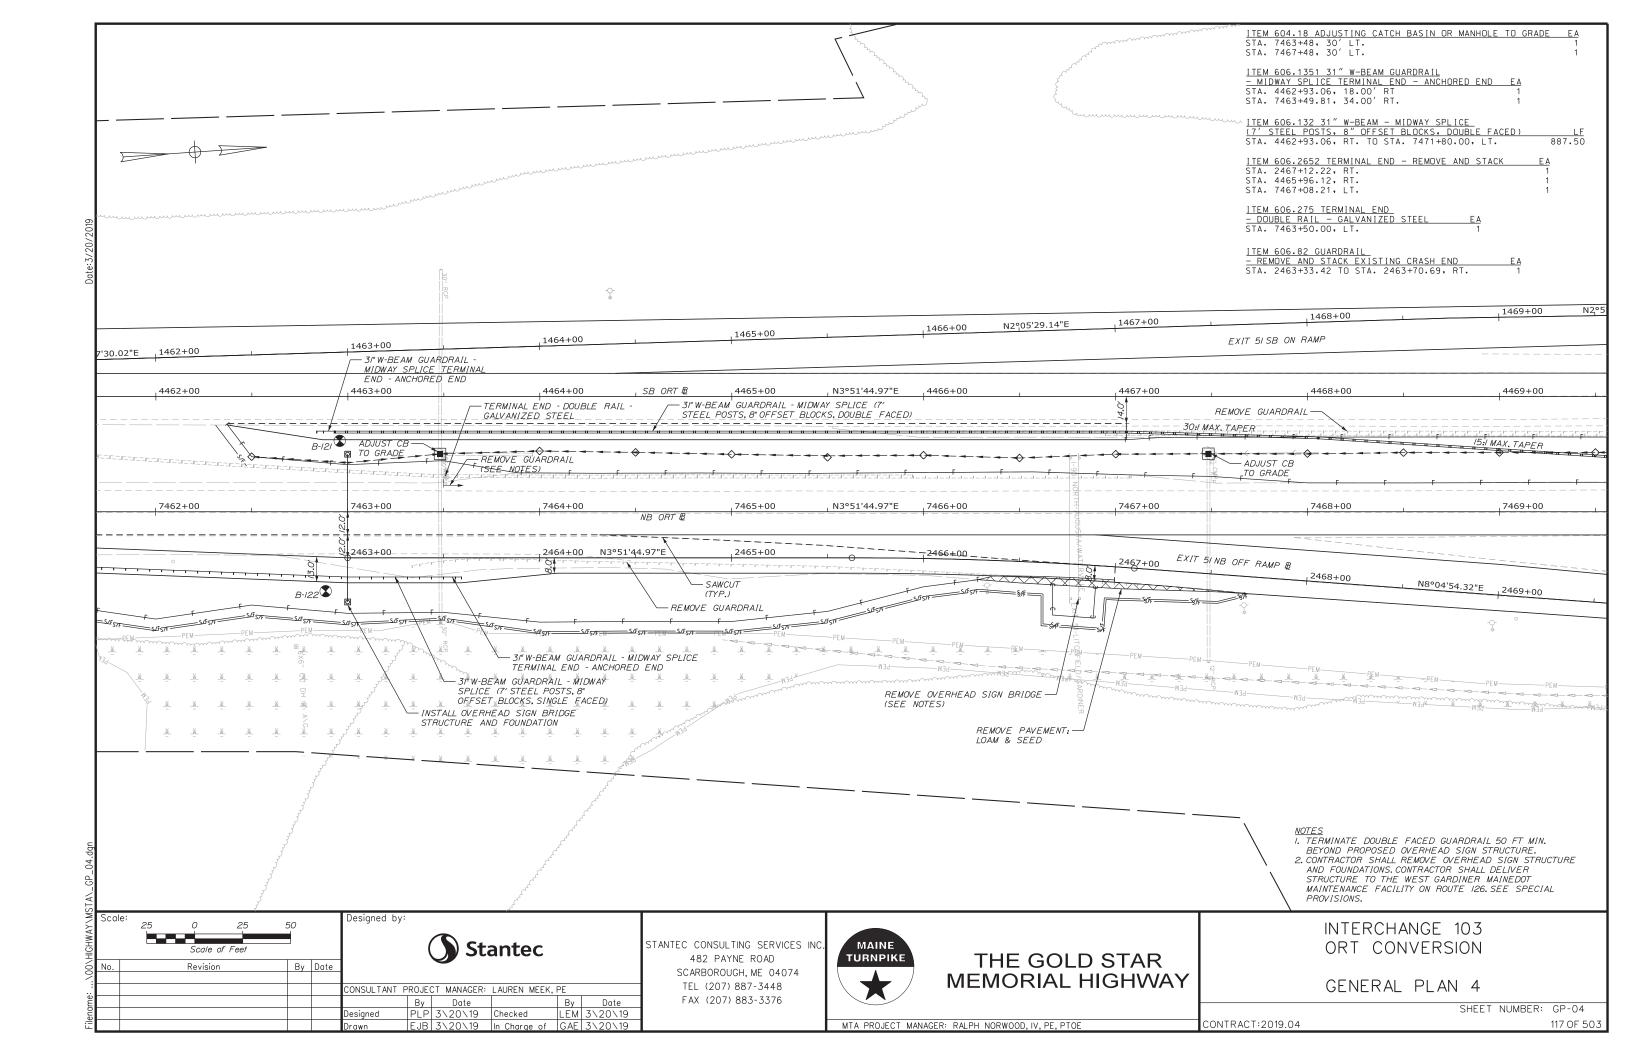
112 OF 503










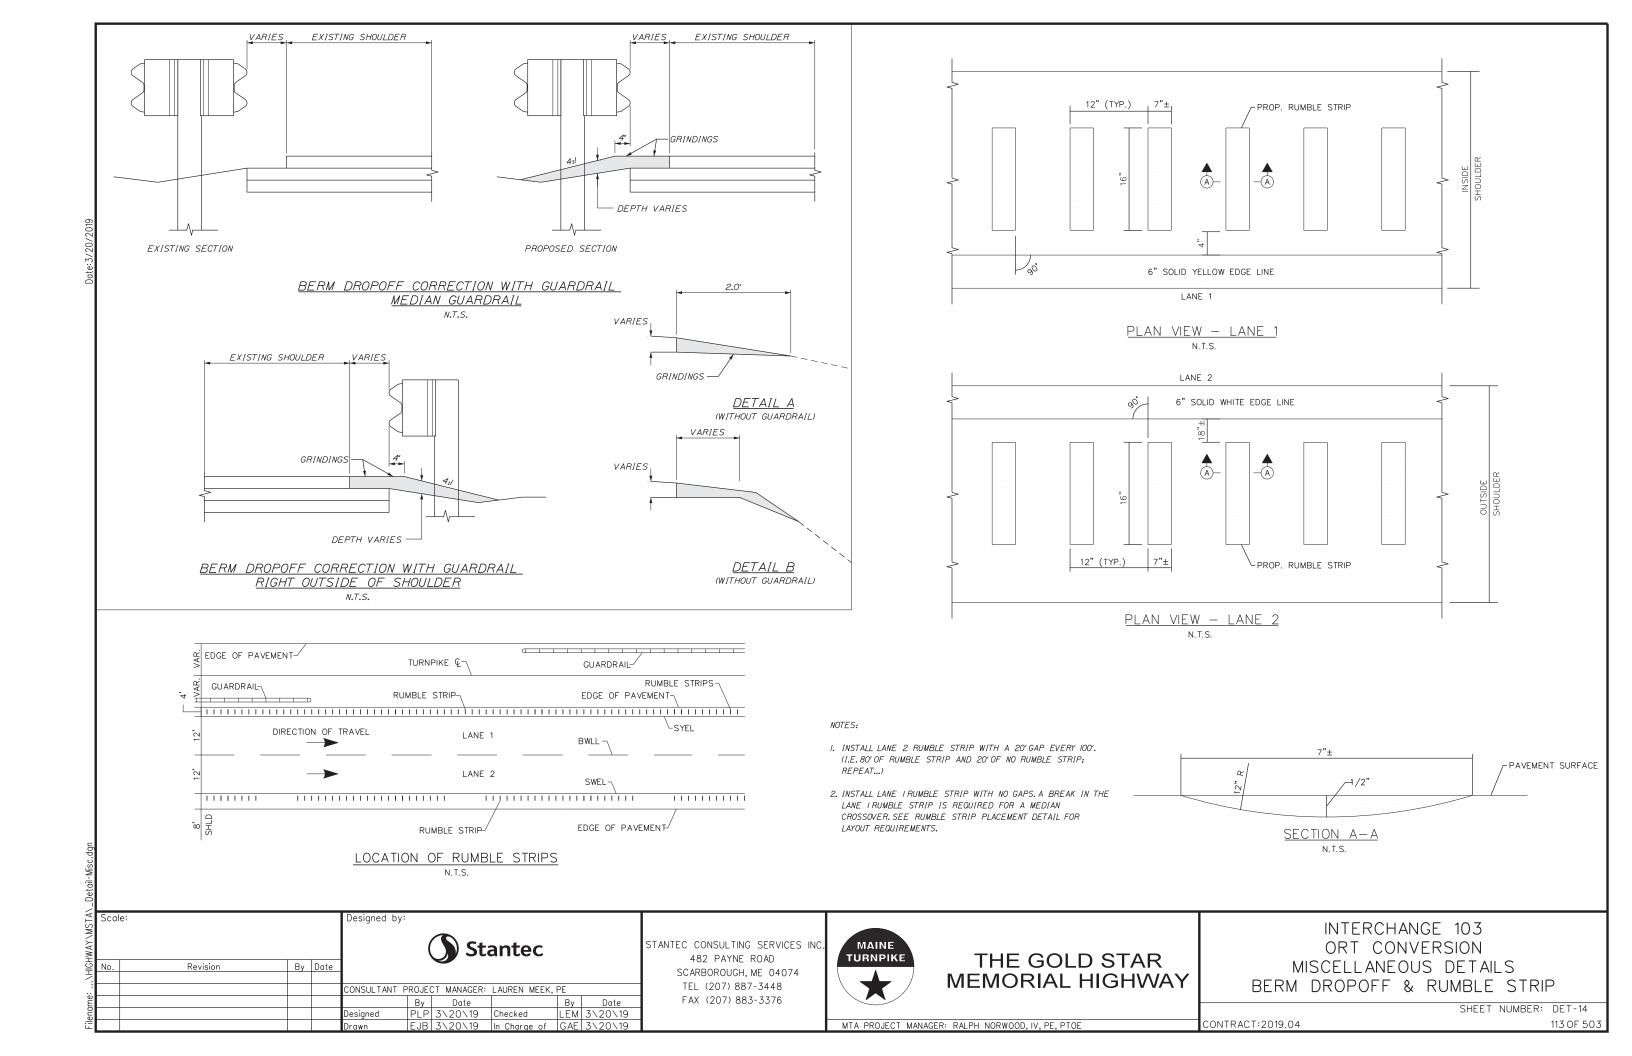


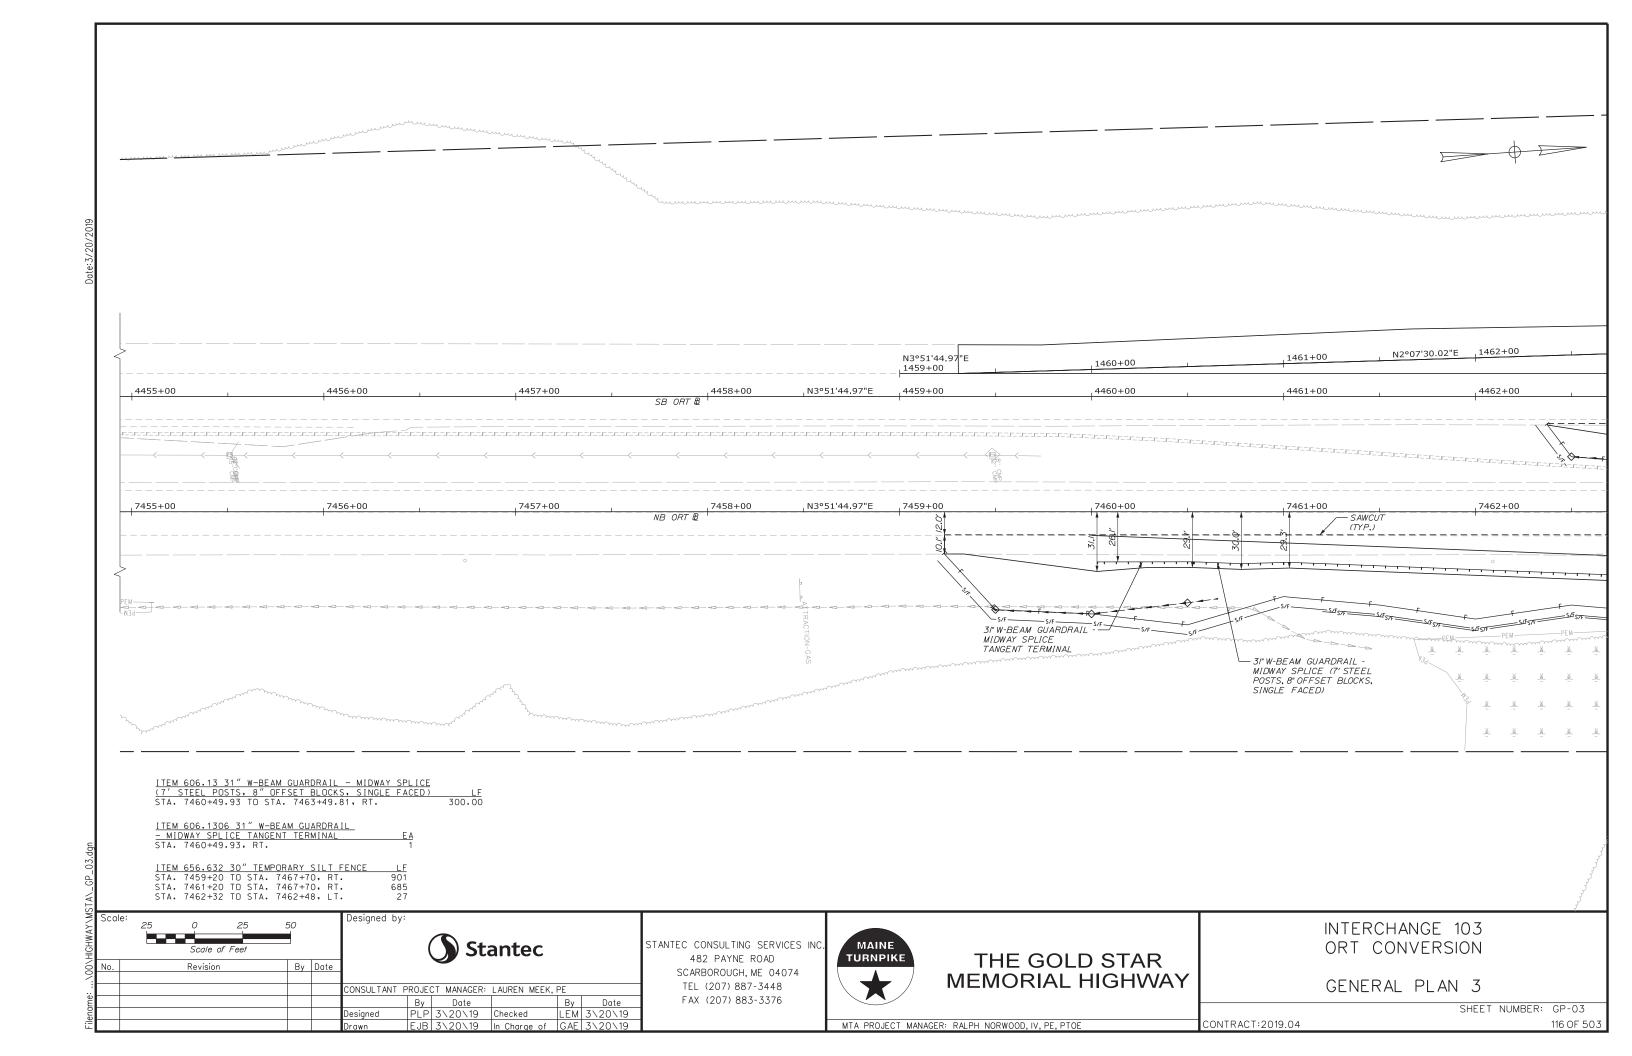


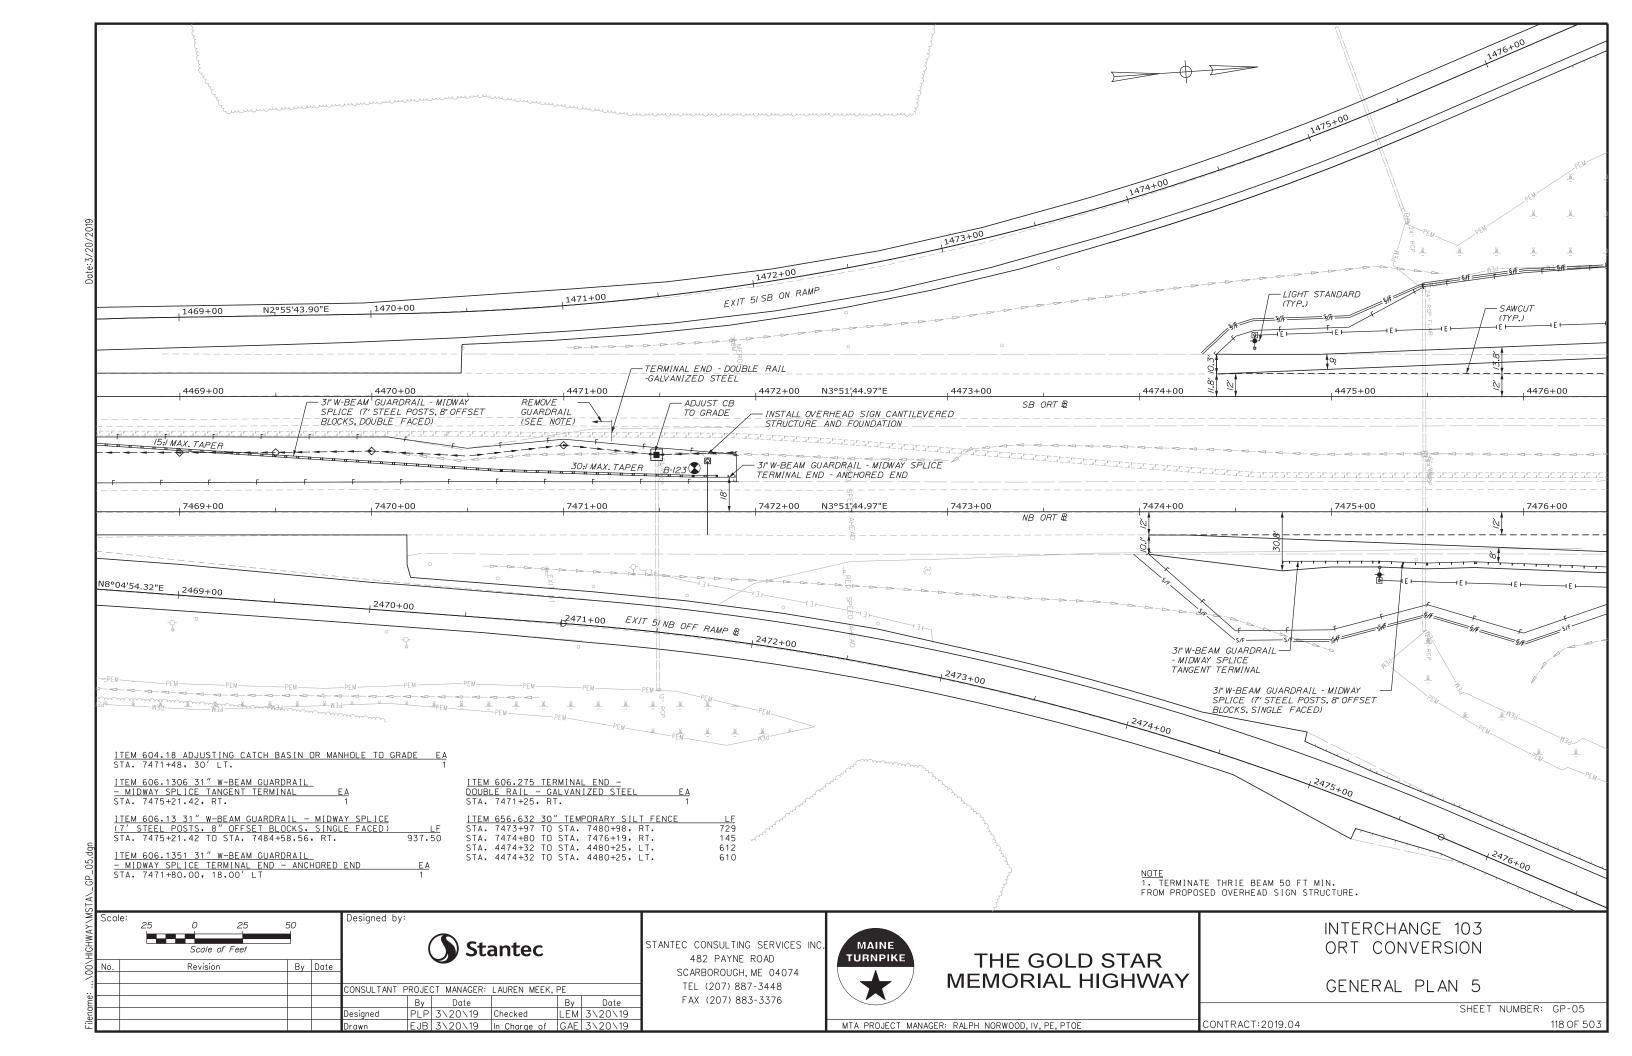


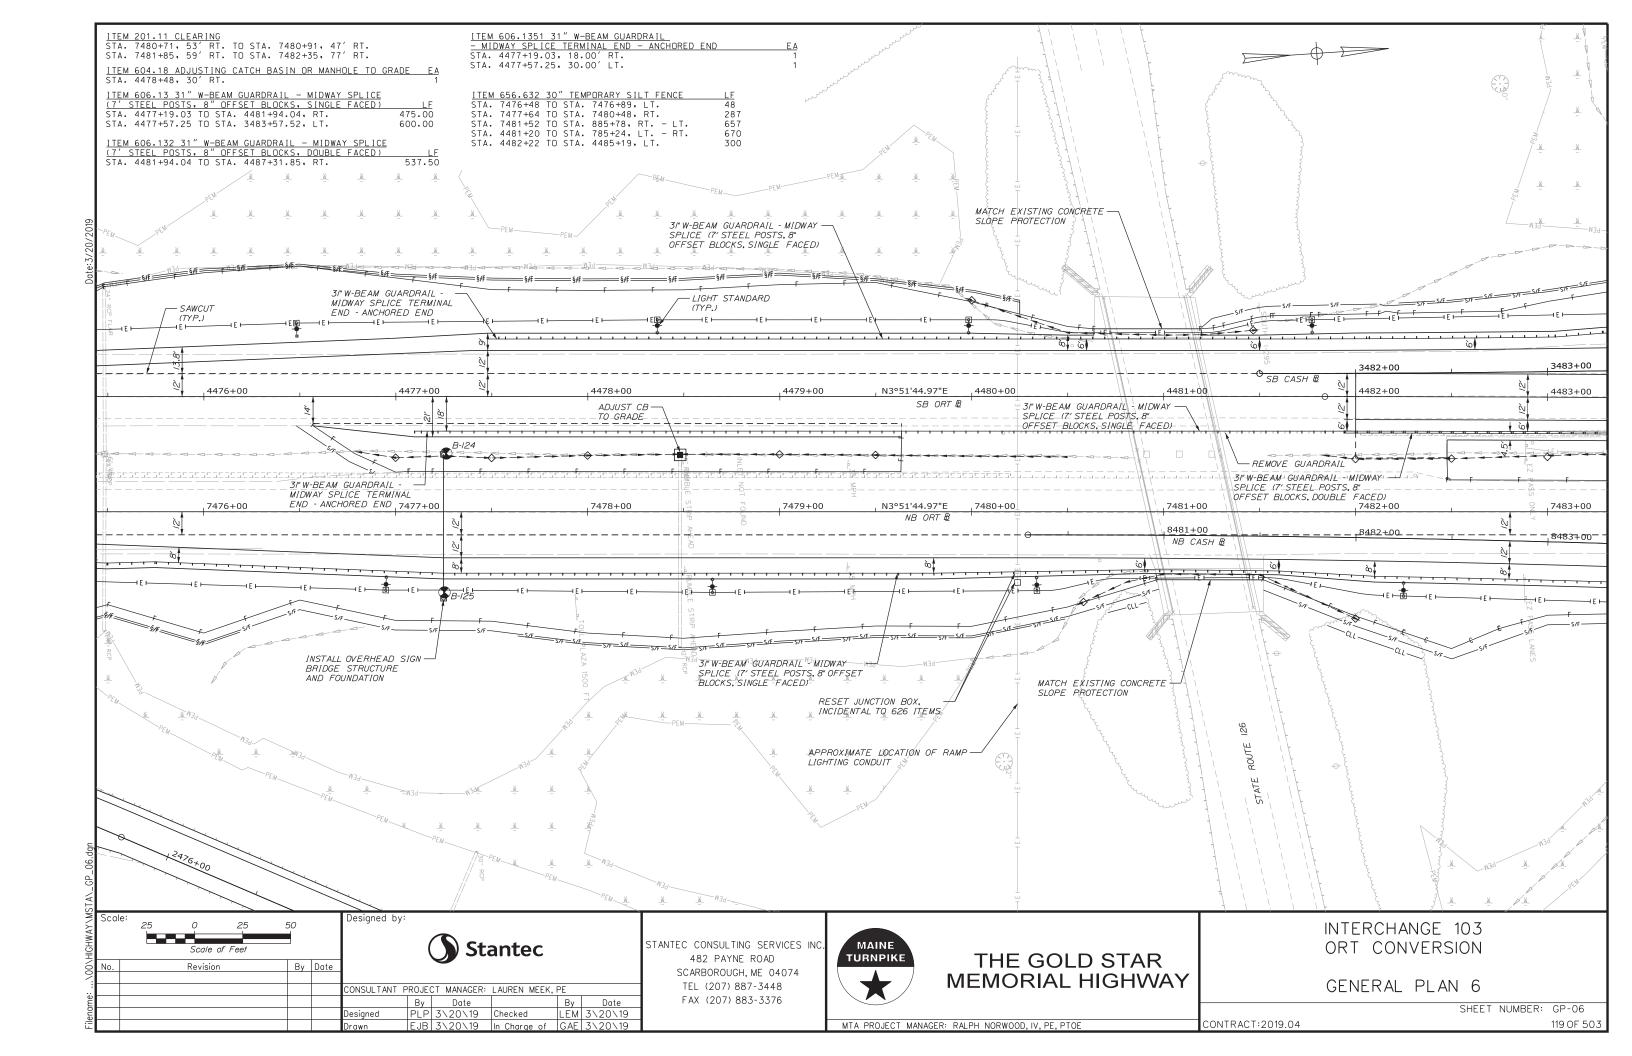


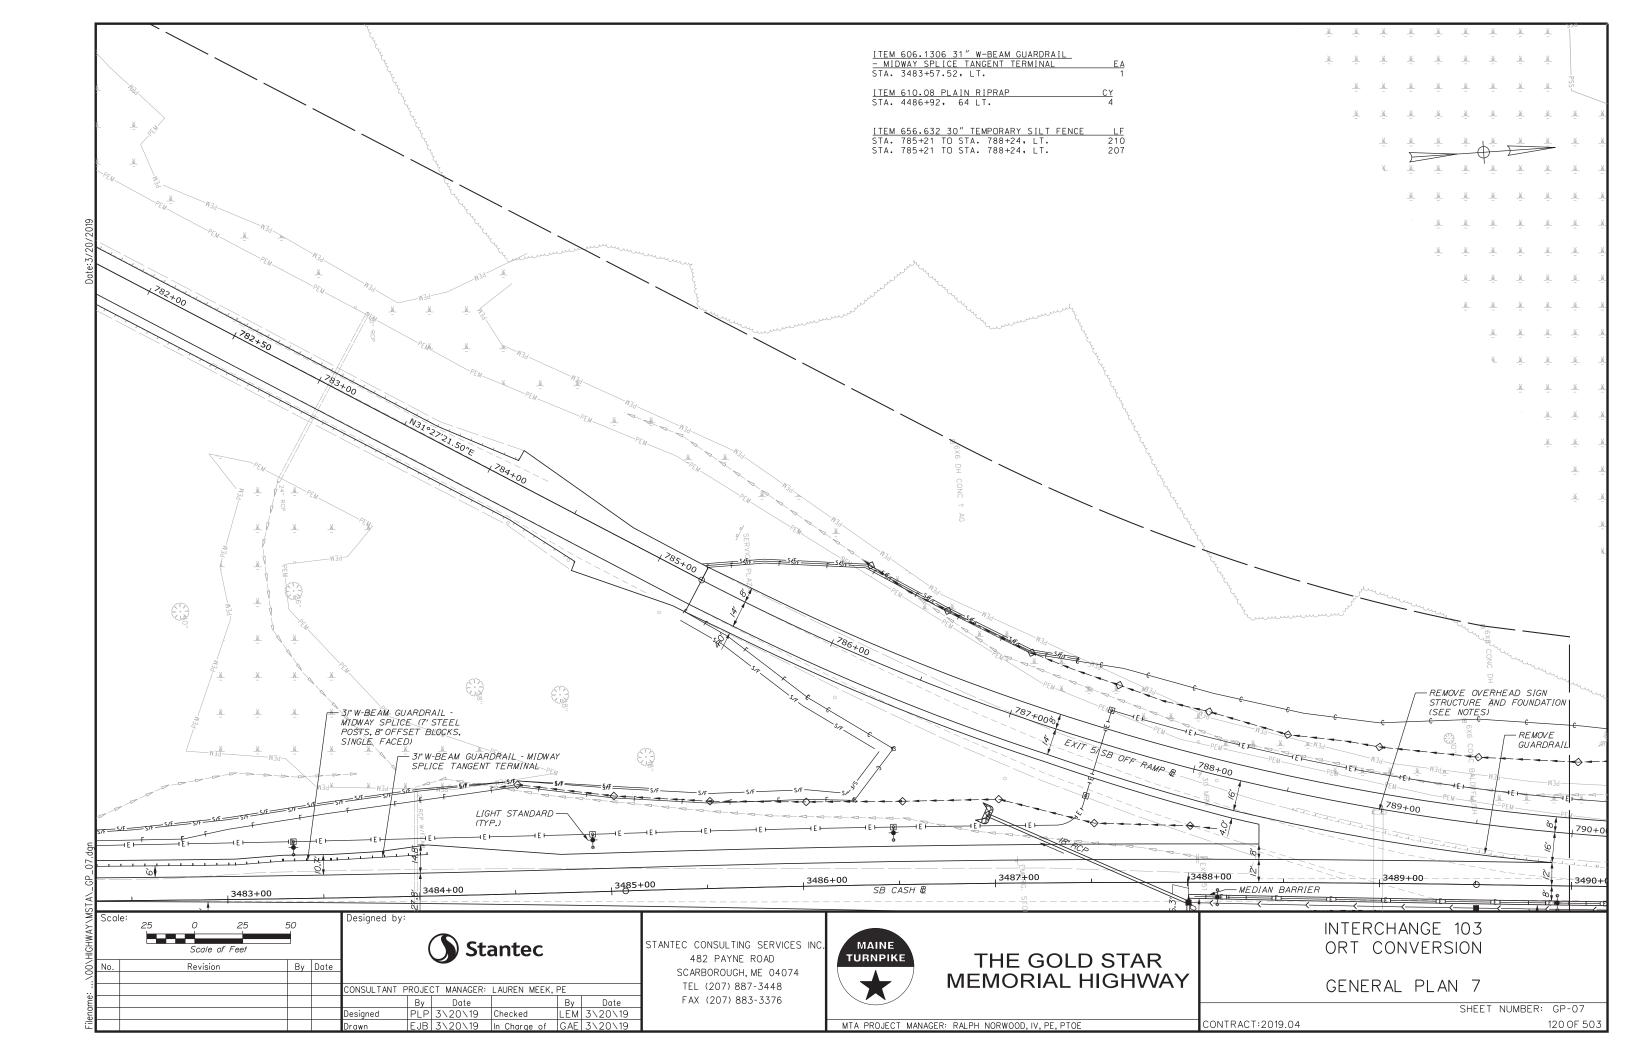


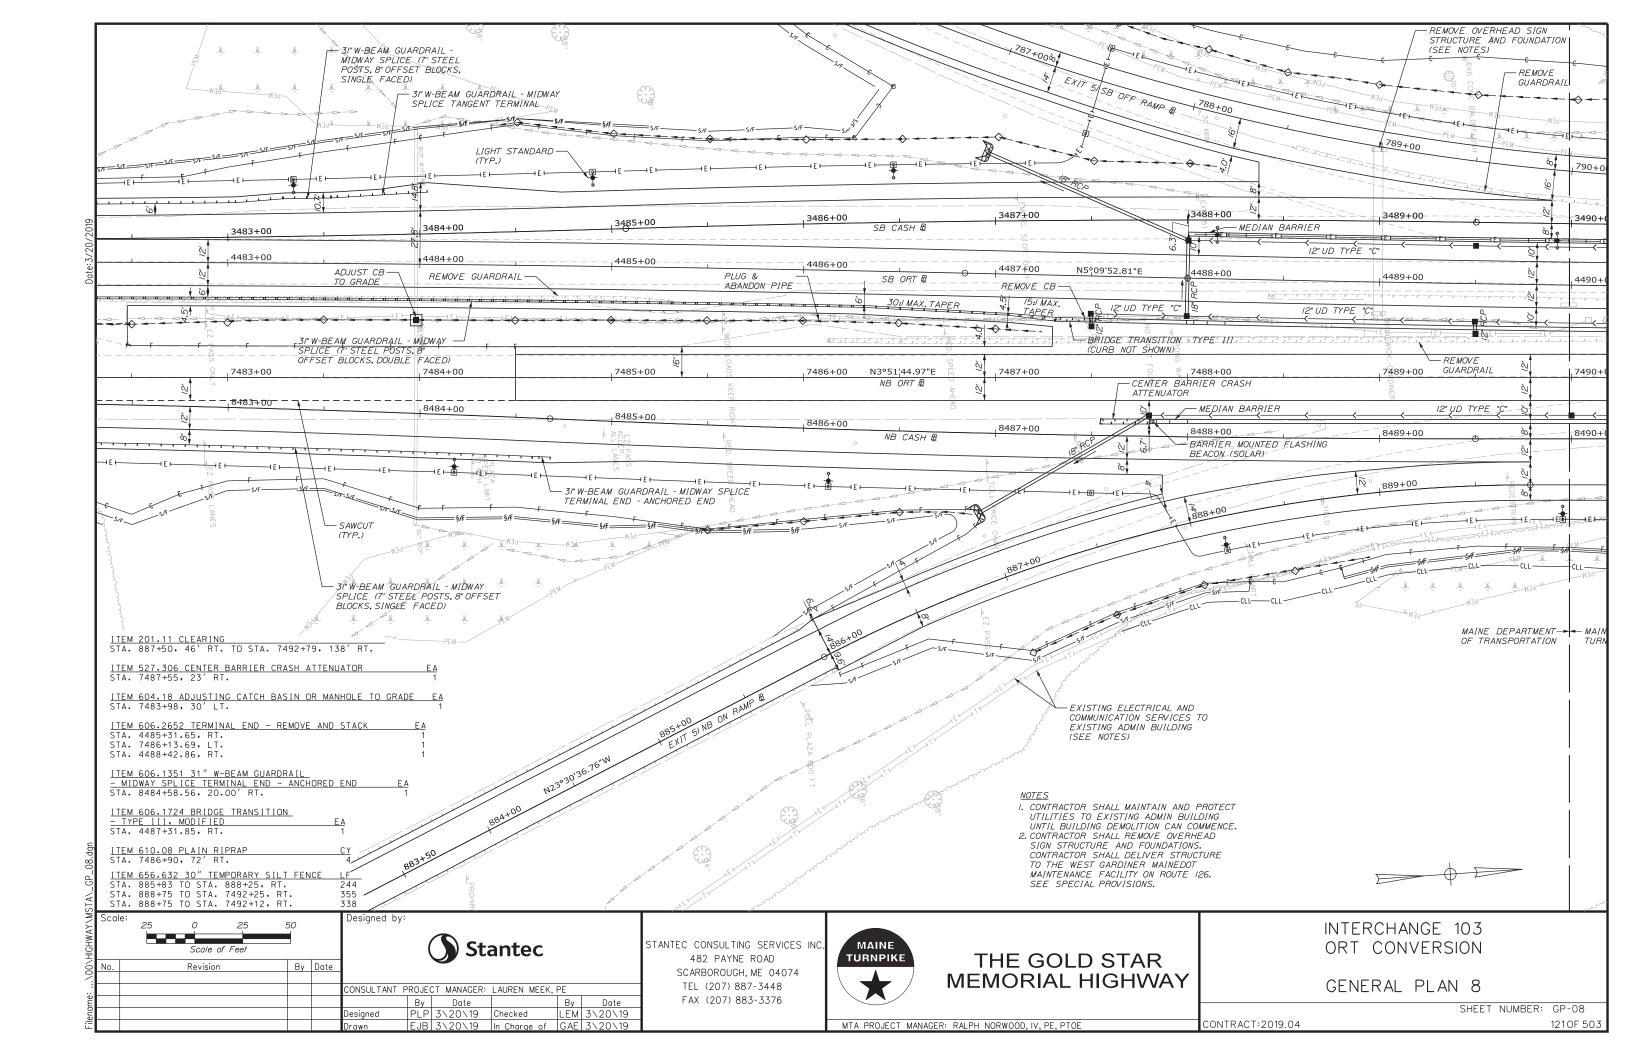


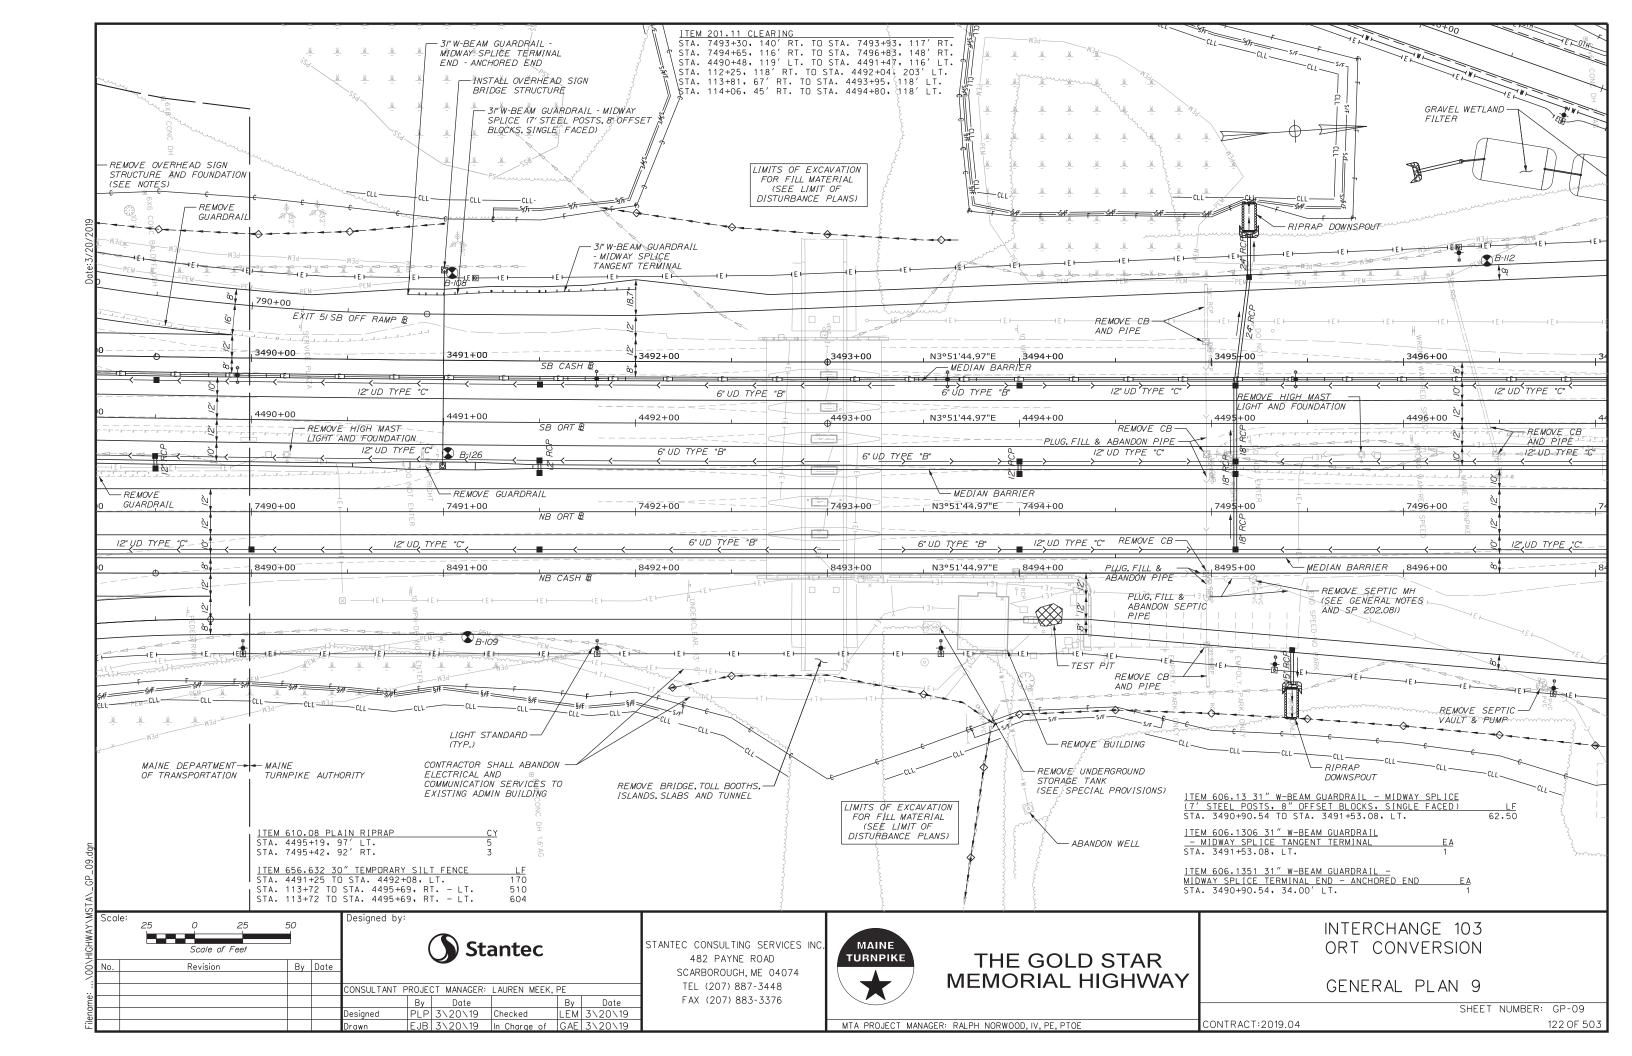


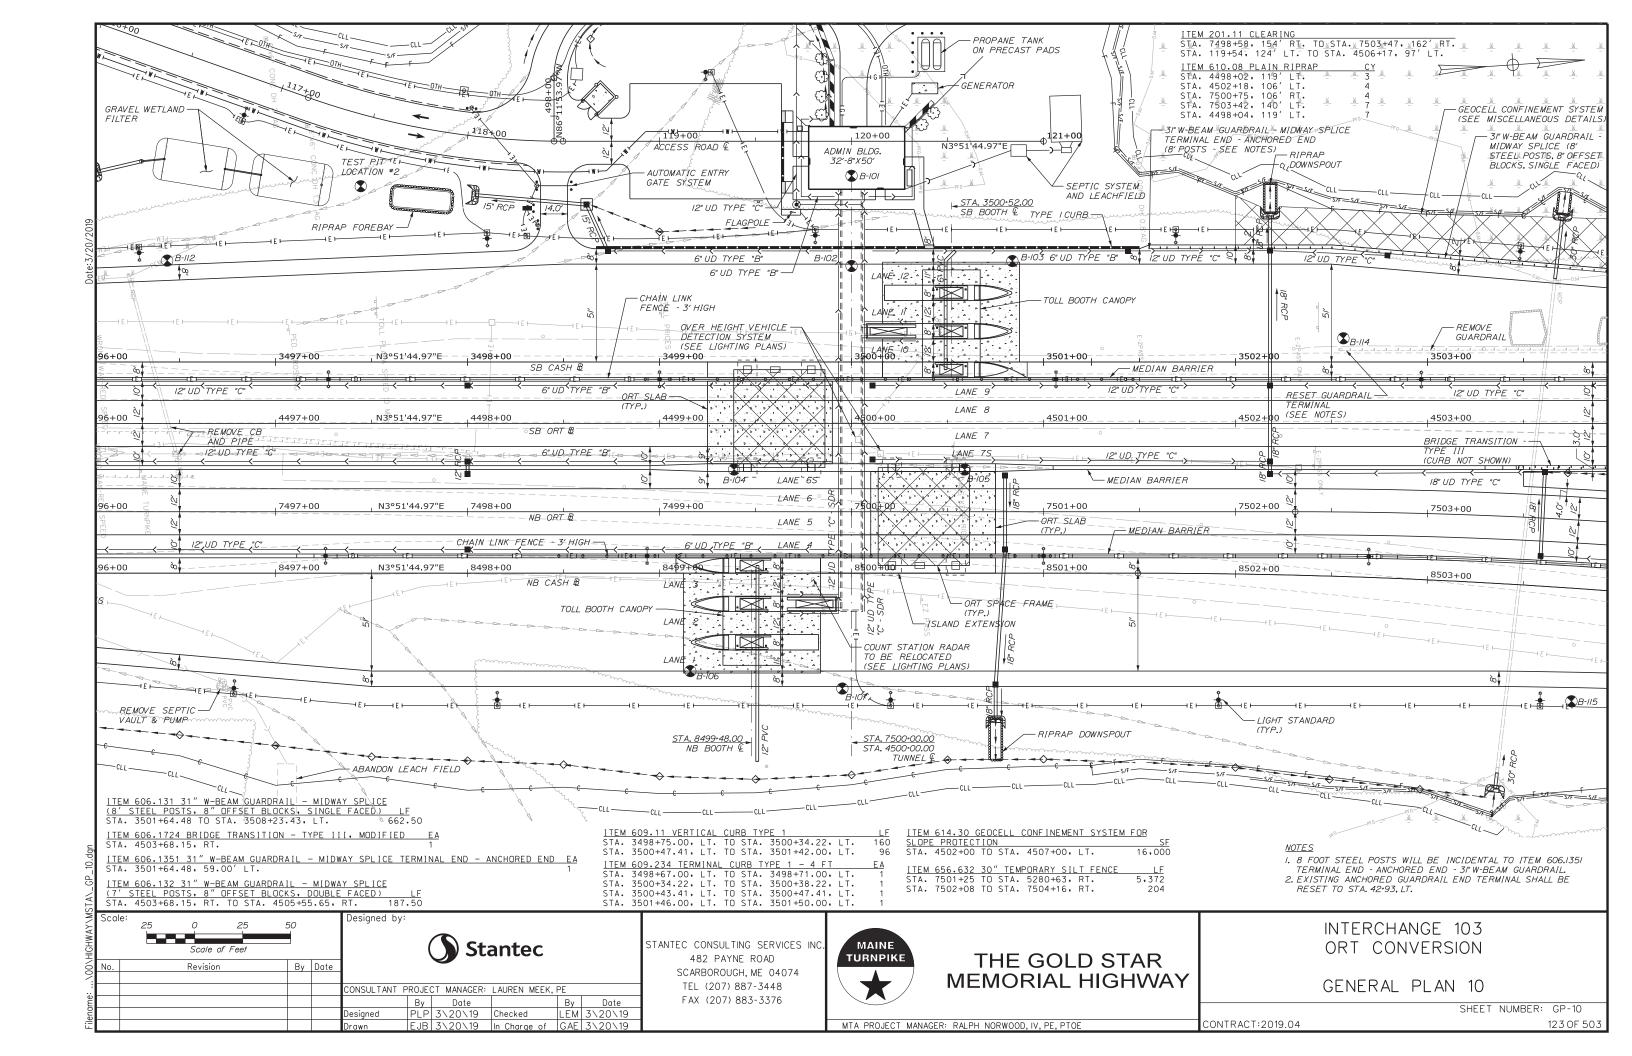


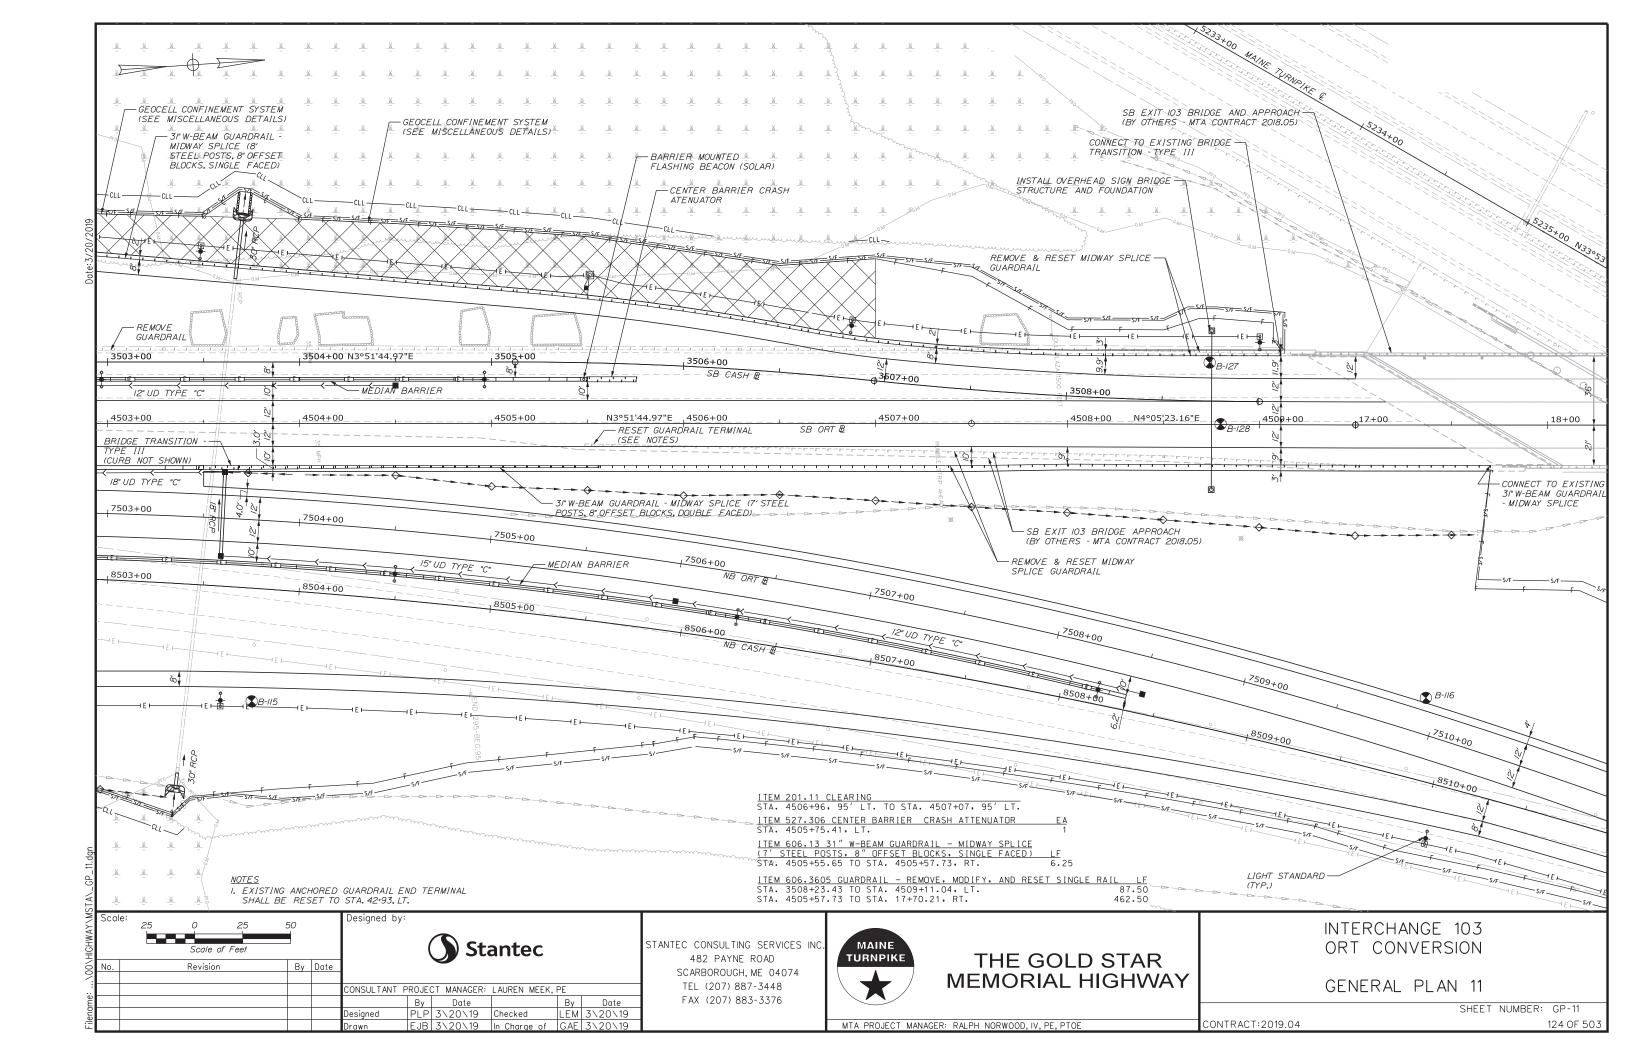


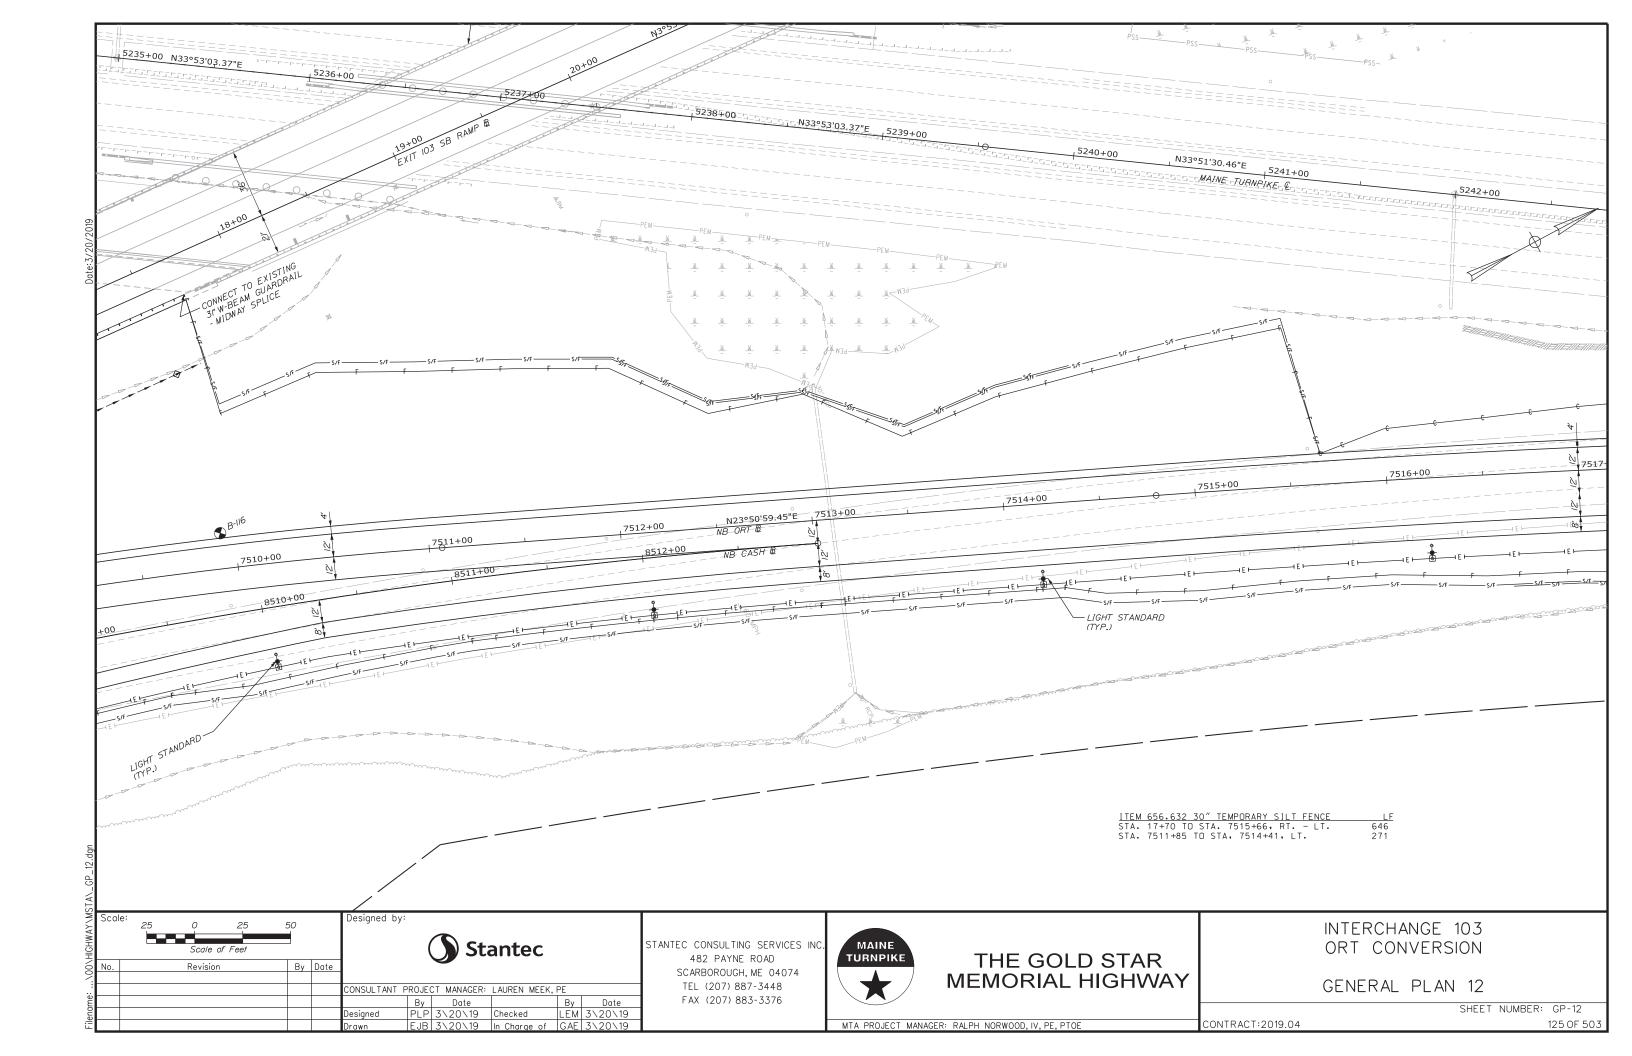


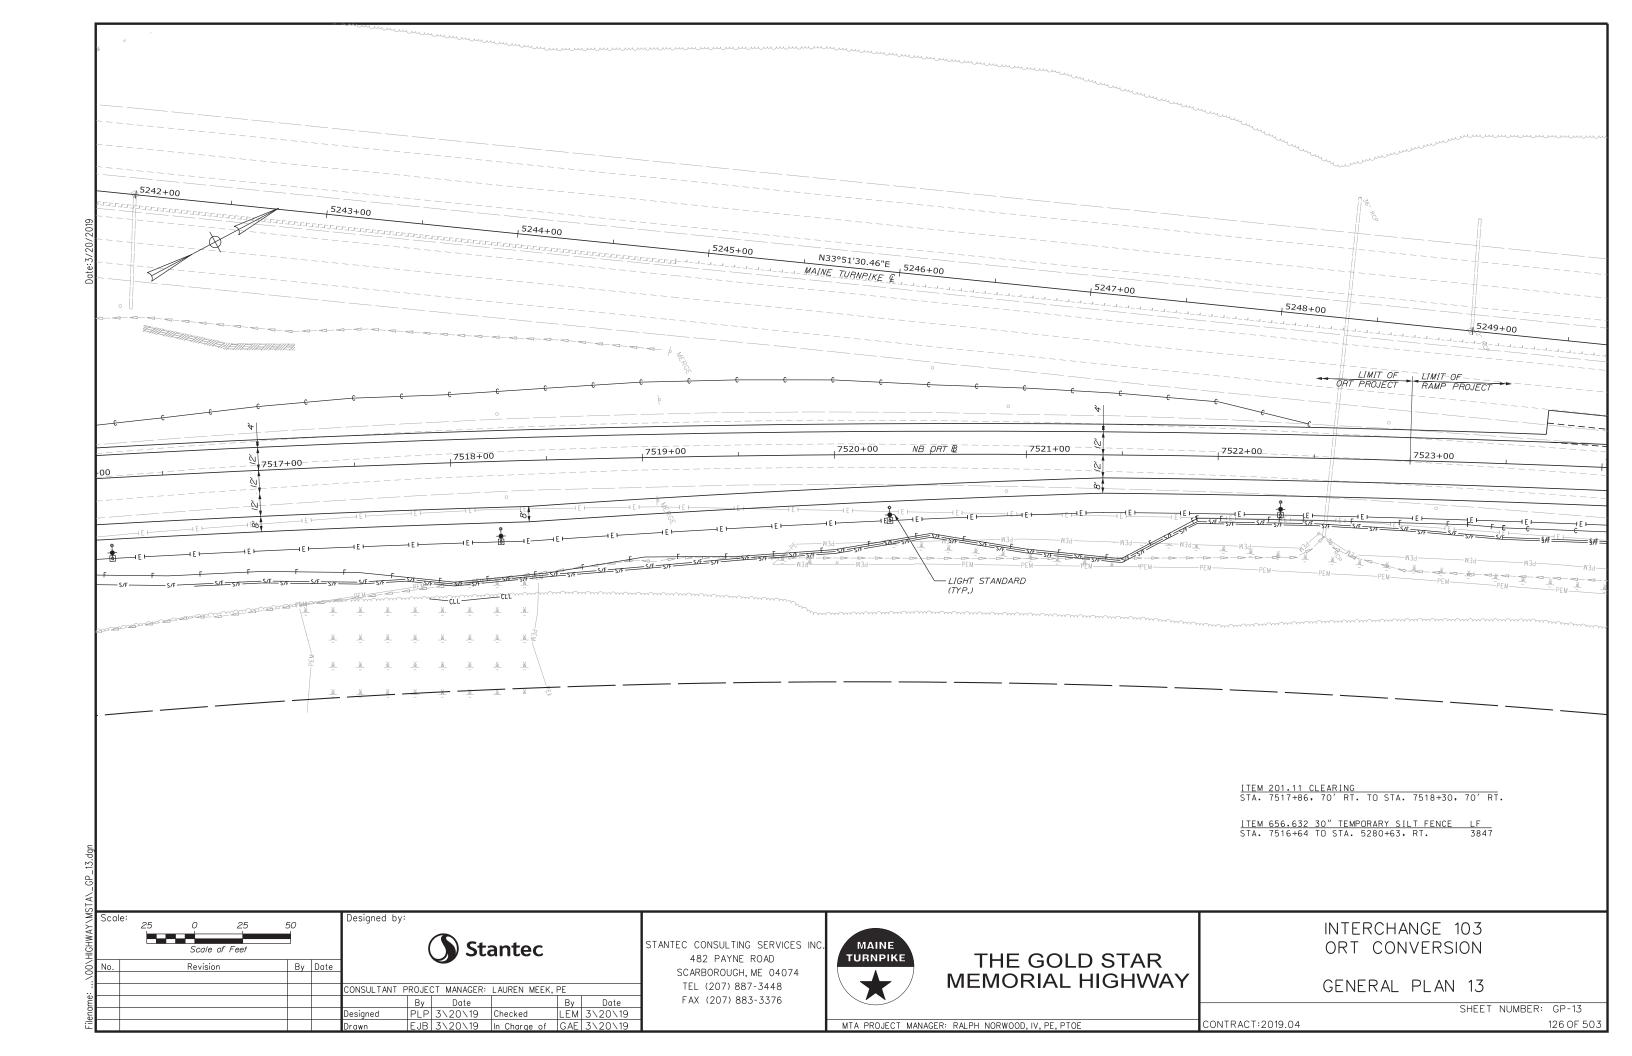


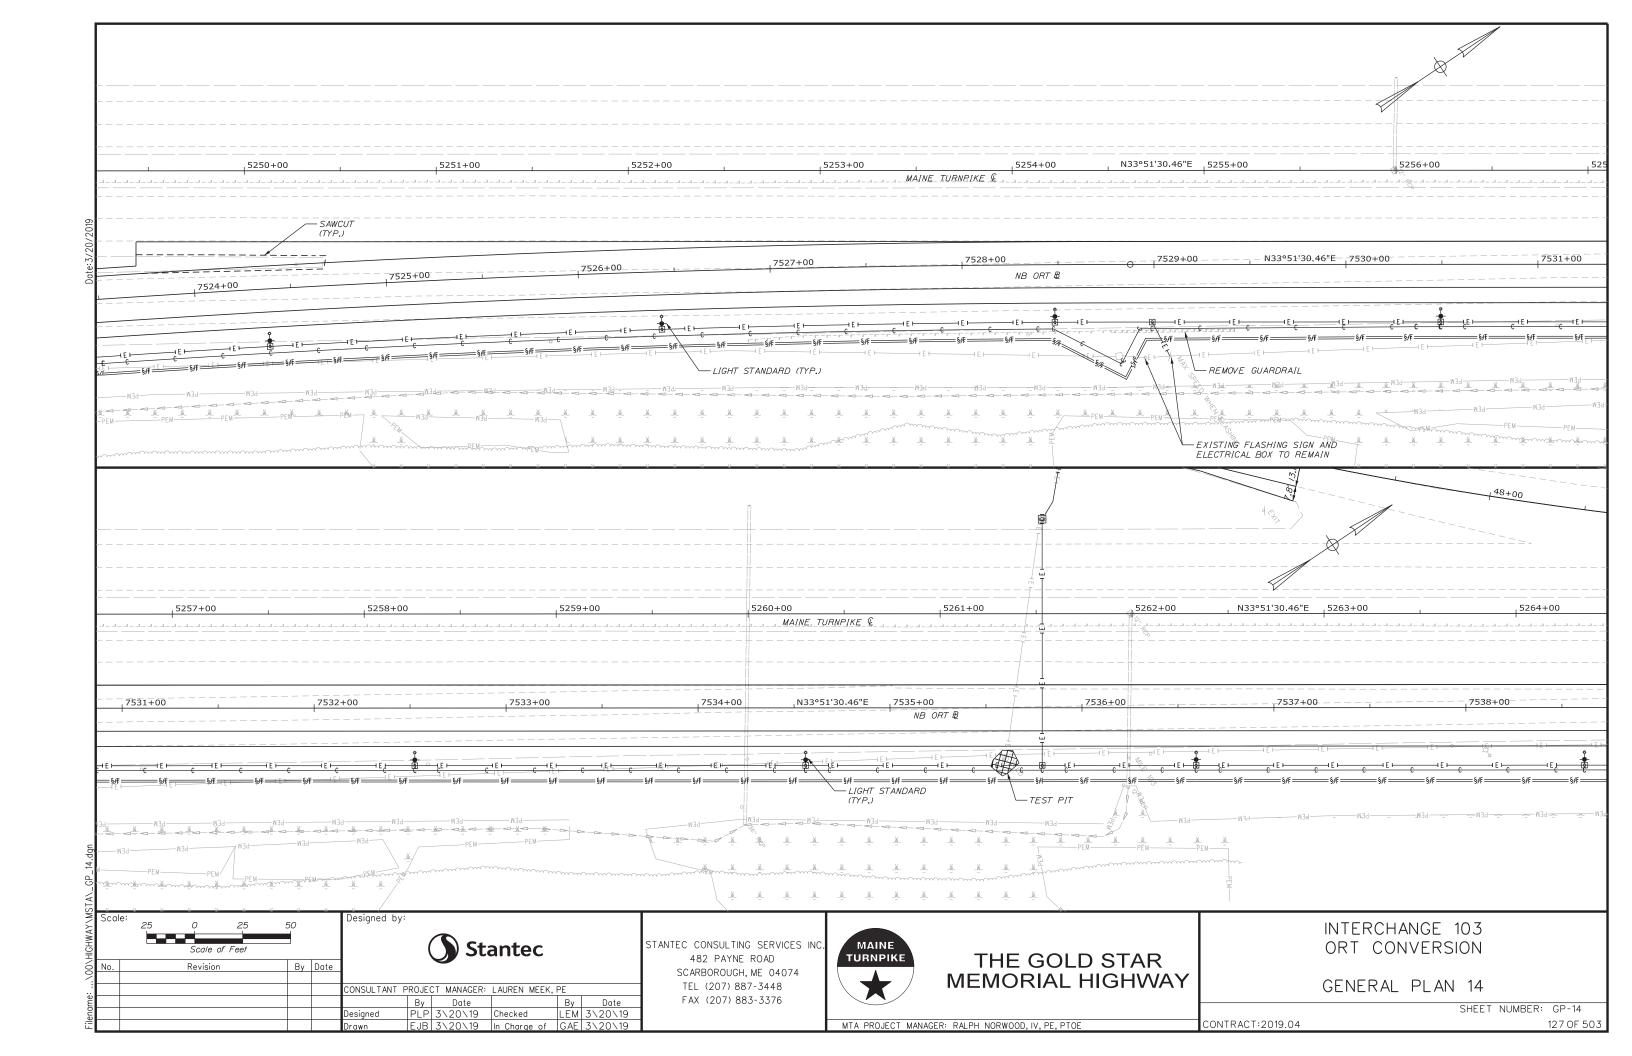


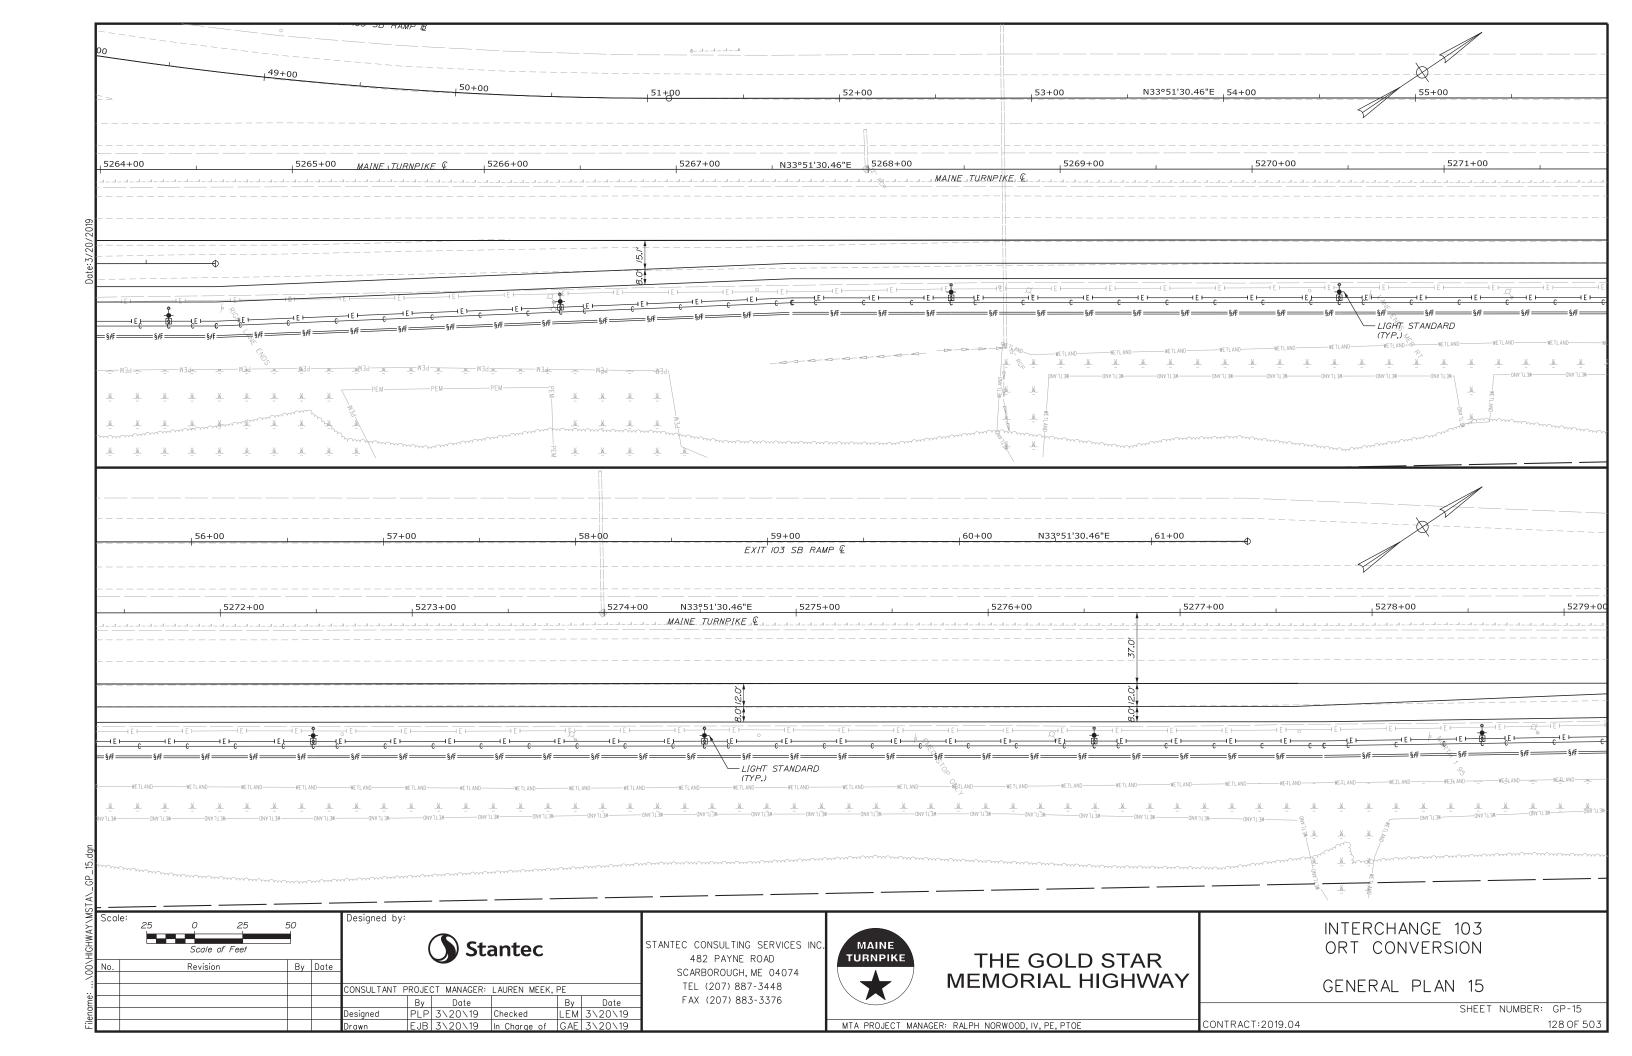


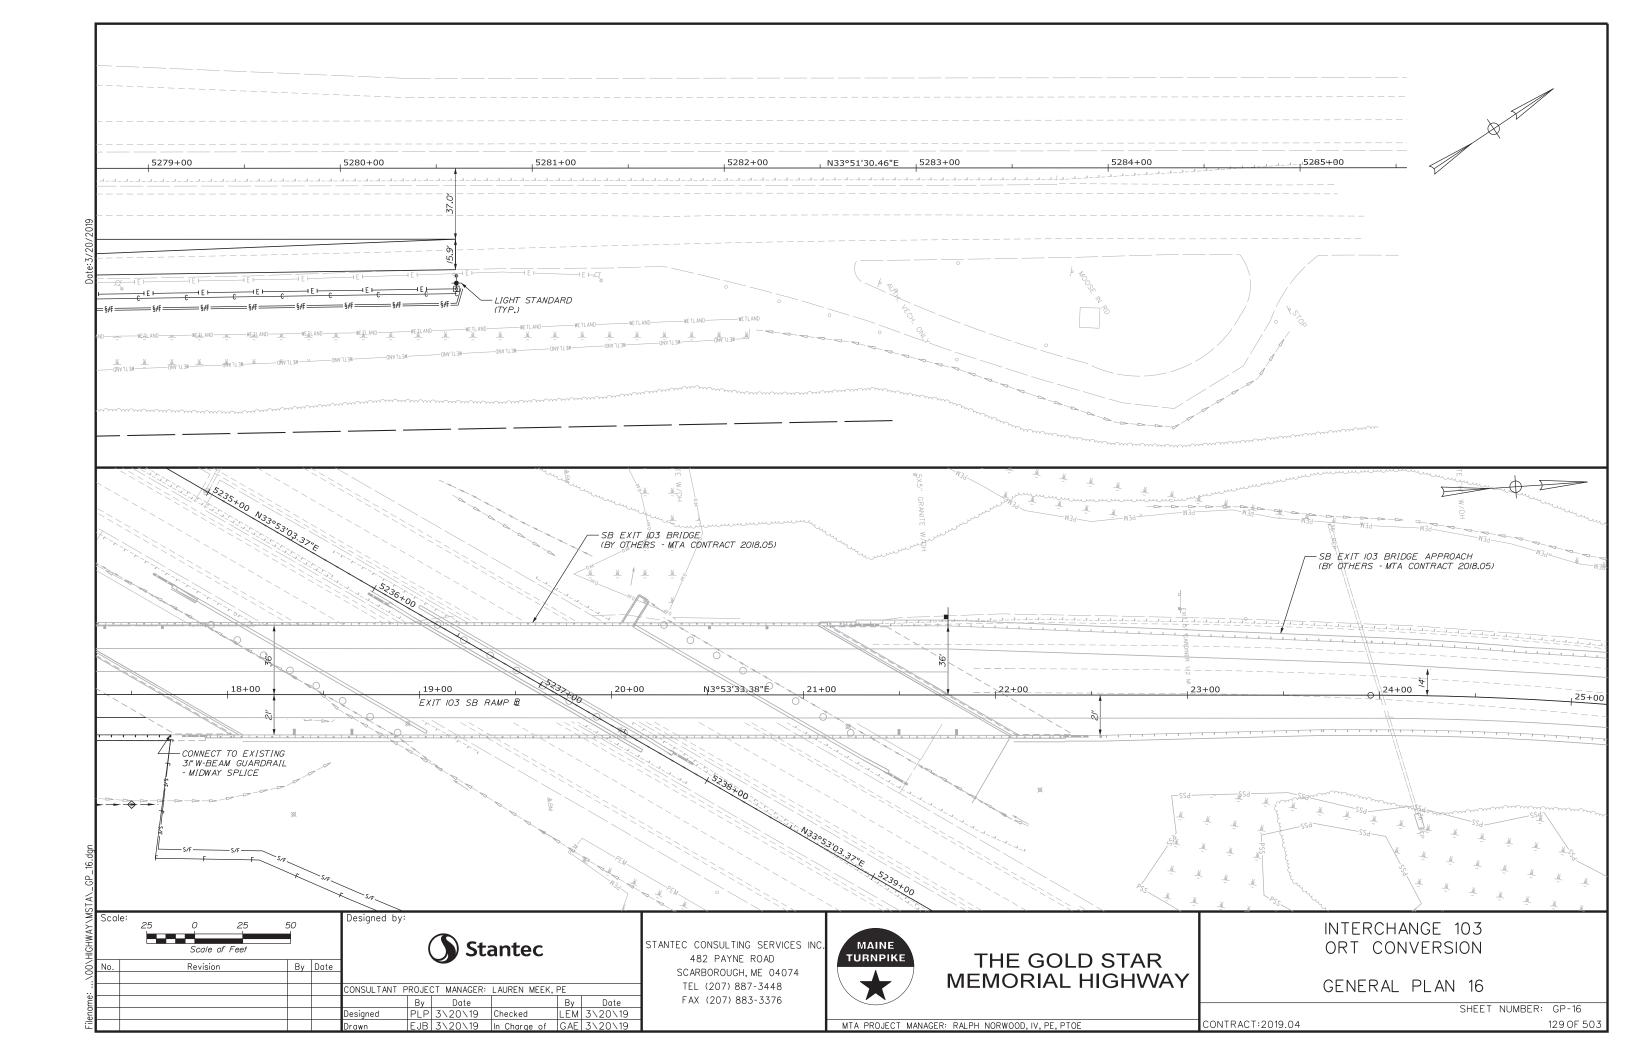


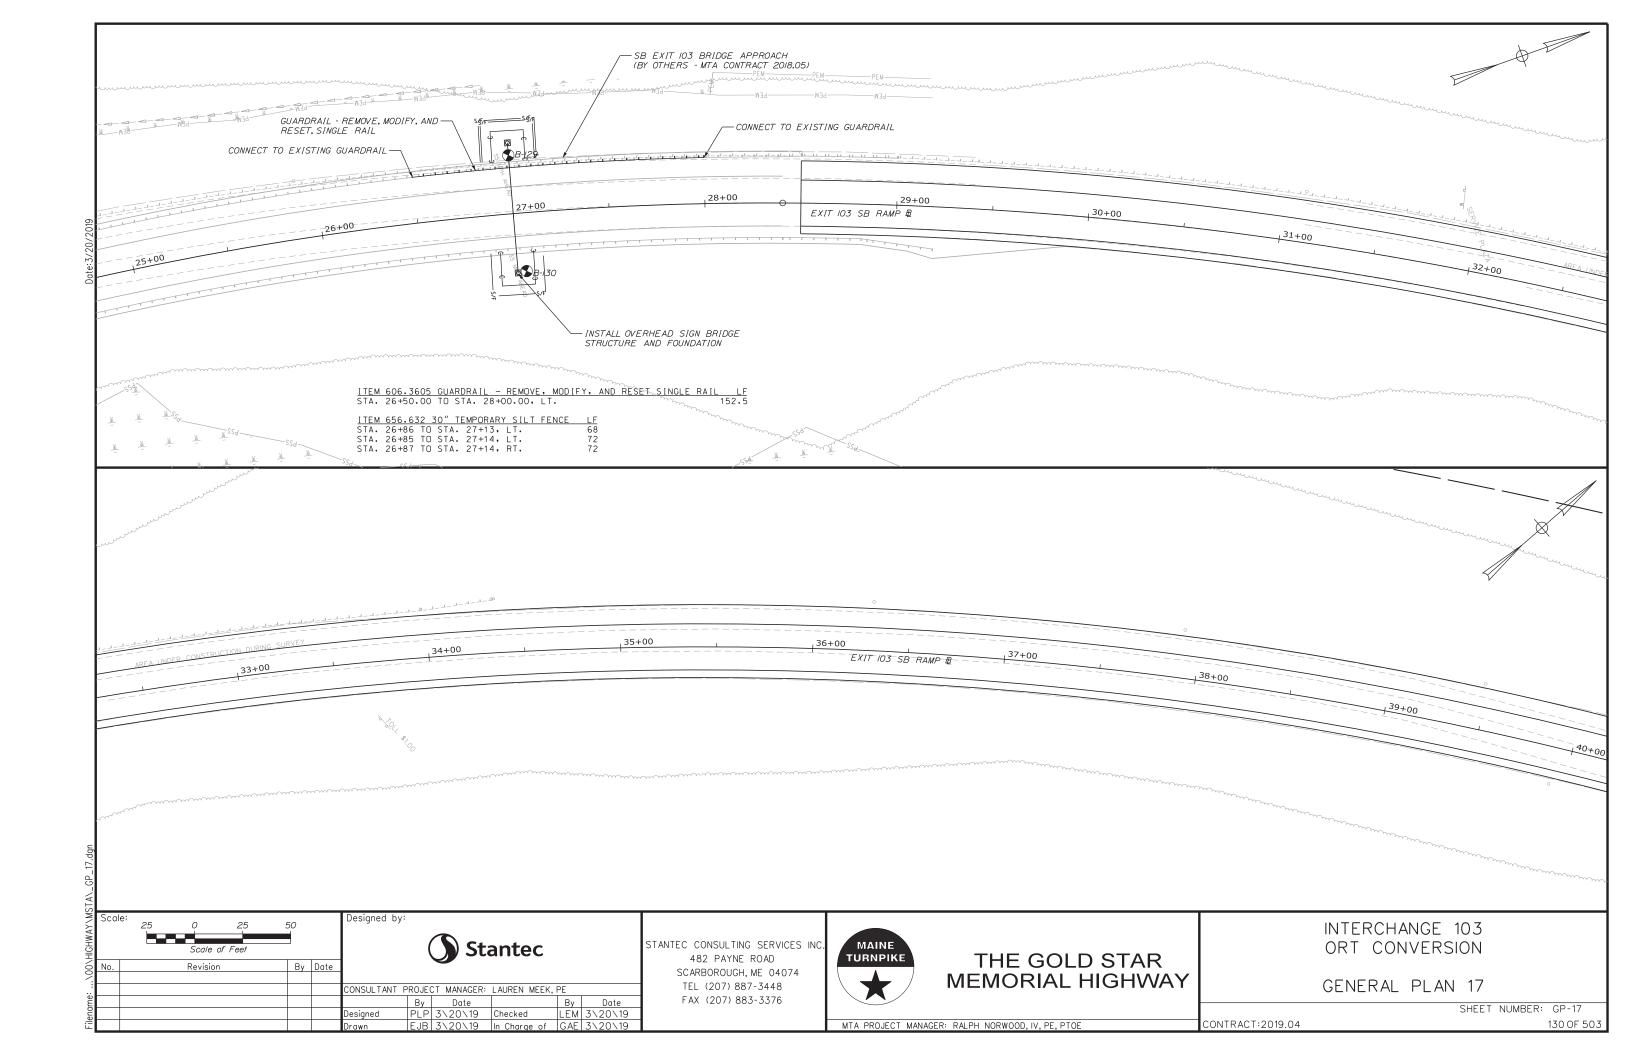


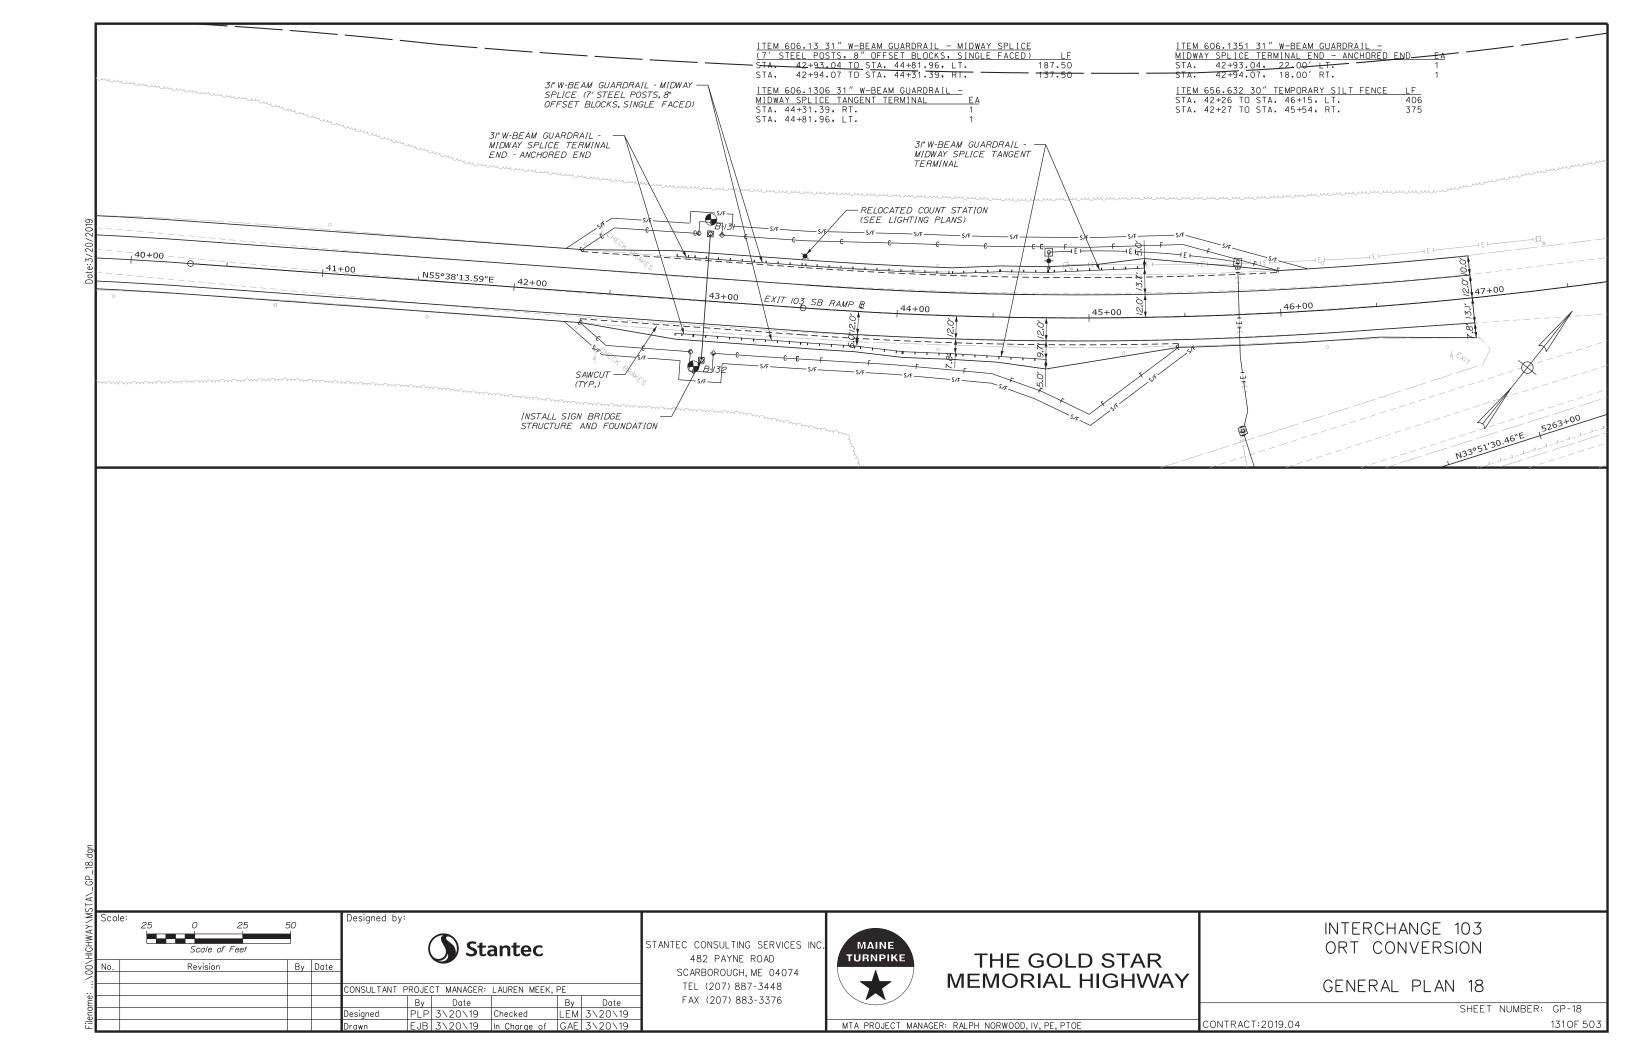

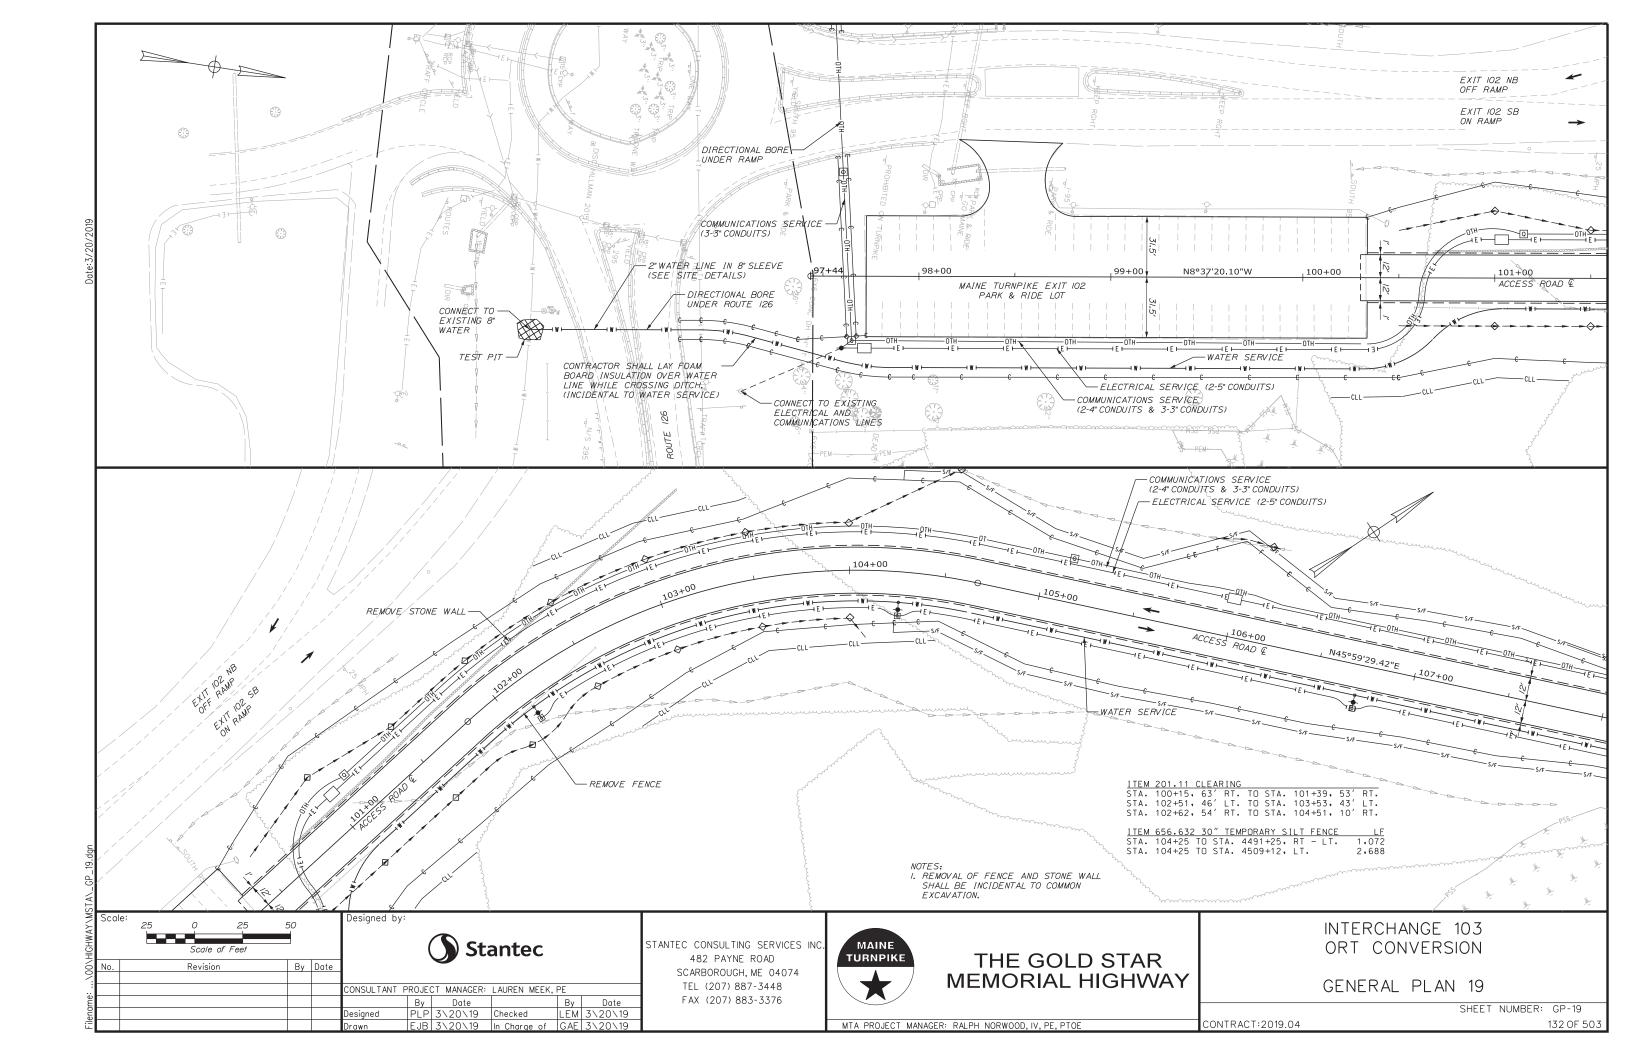


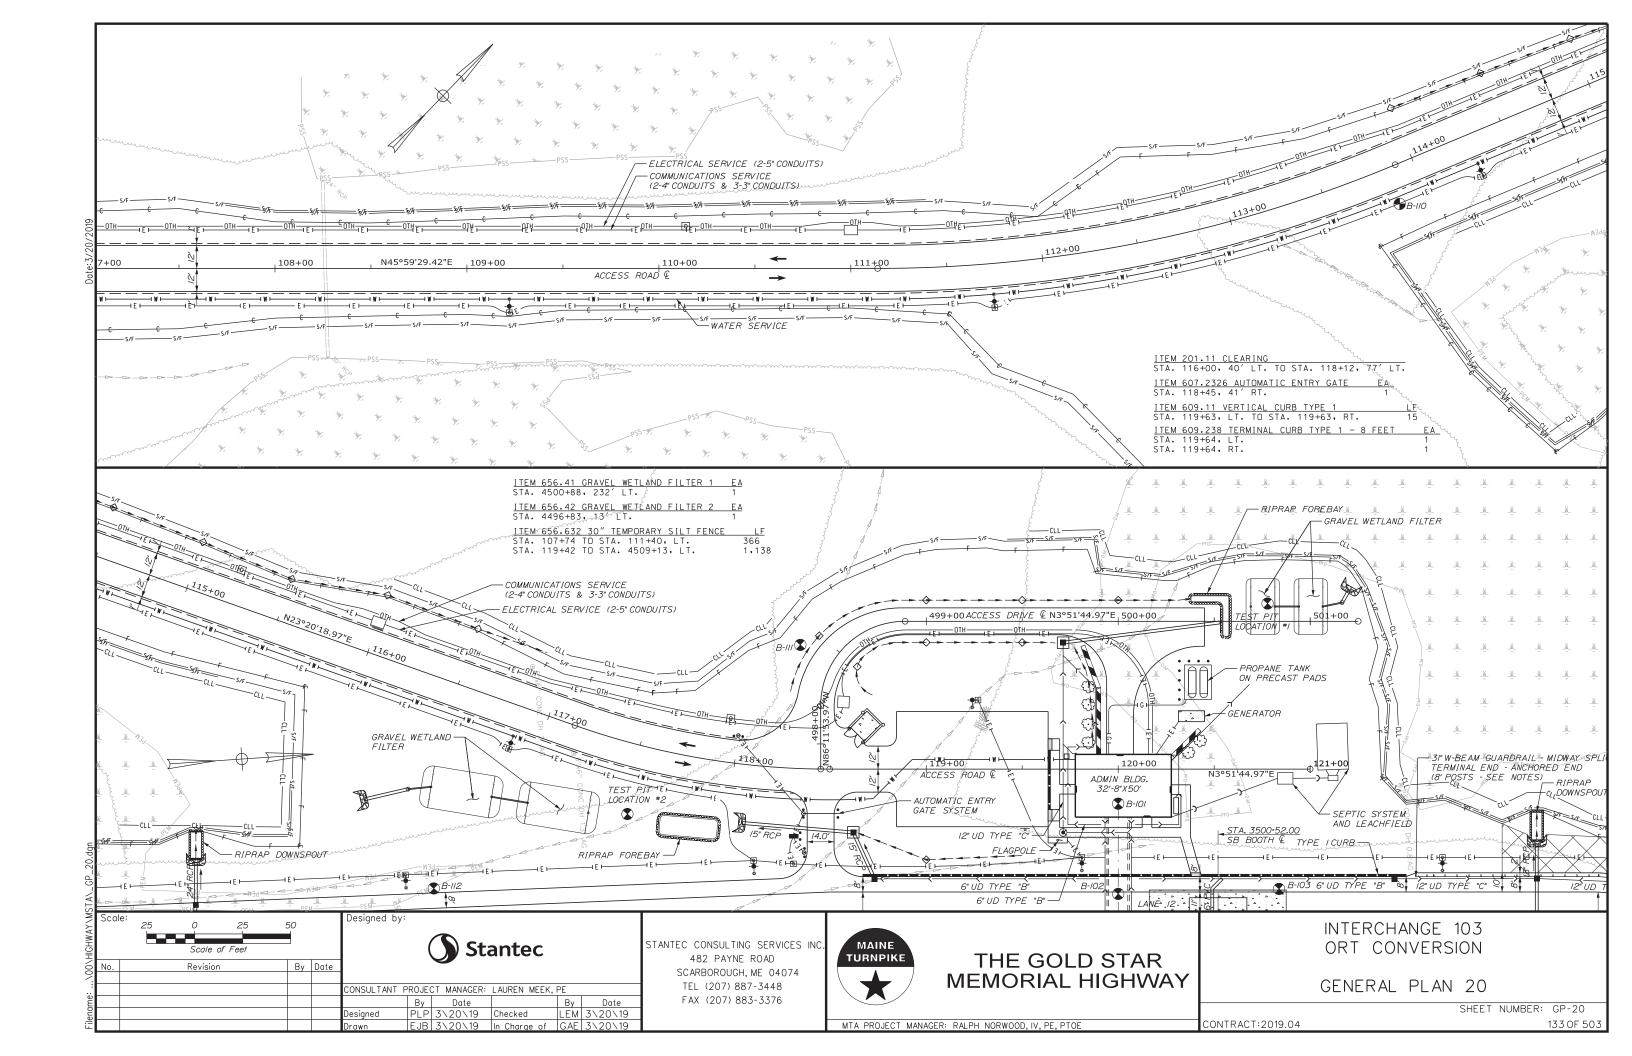

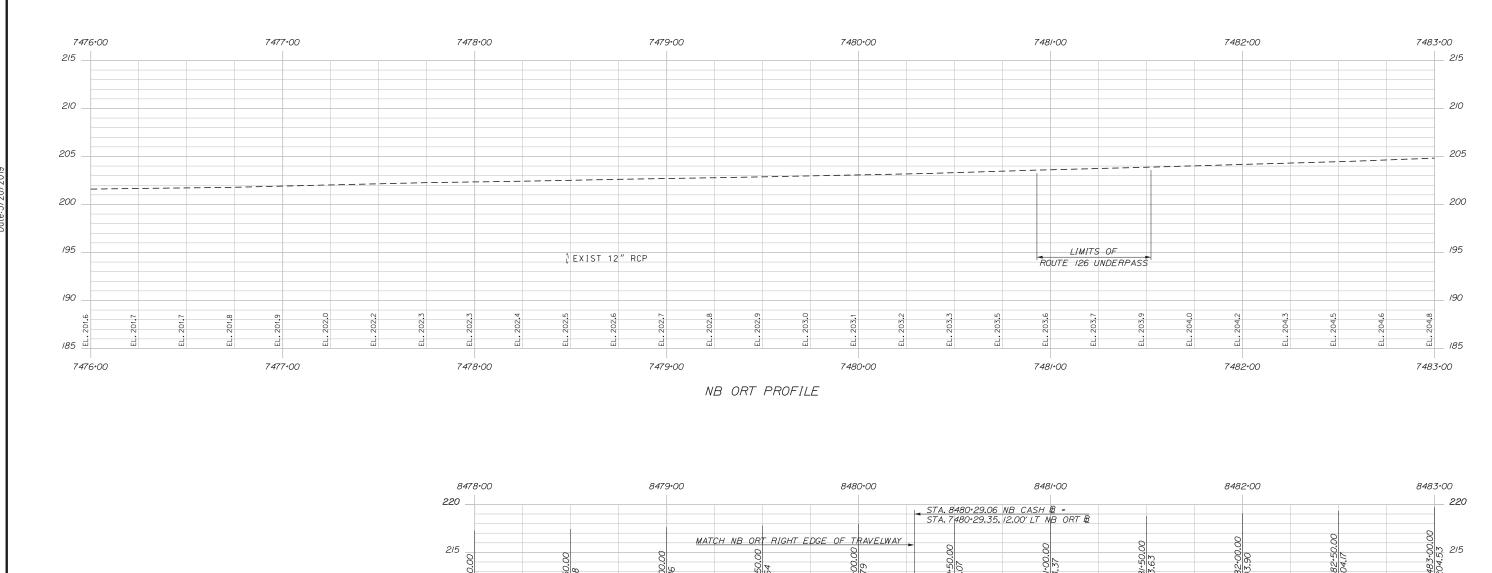

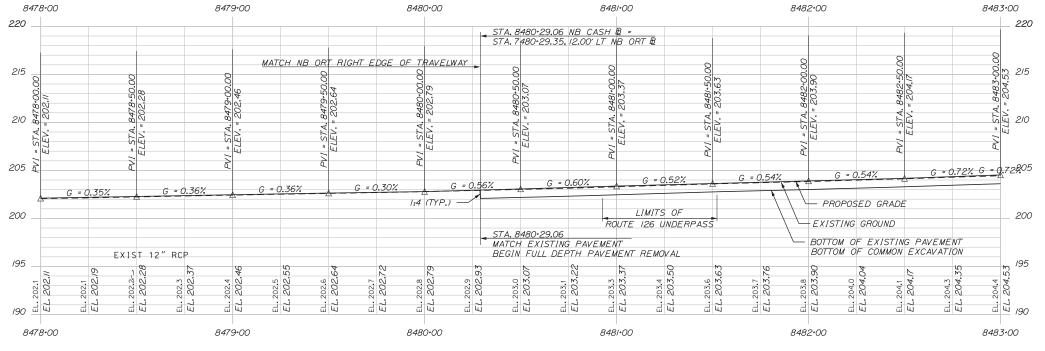

NB CASH PROFILE

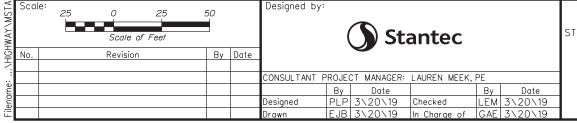

STANTEC CONSULTING SERVICES INC 482 PAYNE ROAD SCARBOROUGH, ME 04074 TEL (207) 887-3448 FAX (207) 883-3376



THE GOLD STAR **MEMORIAL HIGHWAY**


NORTHBOUND PROFILE 1


SHEET NUMBER: PR-1 CONTRACT:2019.04 134 OF 503


INTERCHANGE 103


ORT CONVERSION


MTA PROJECT MANAGER: RALPH NORWOOD, IV. PE, PTOE

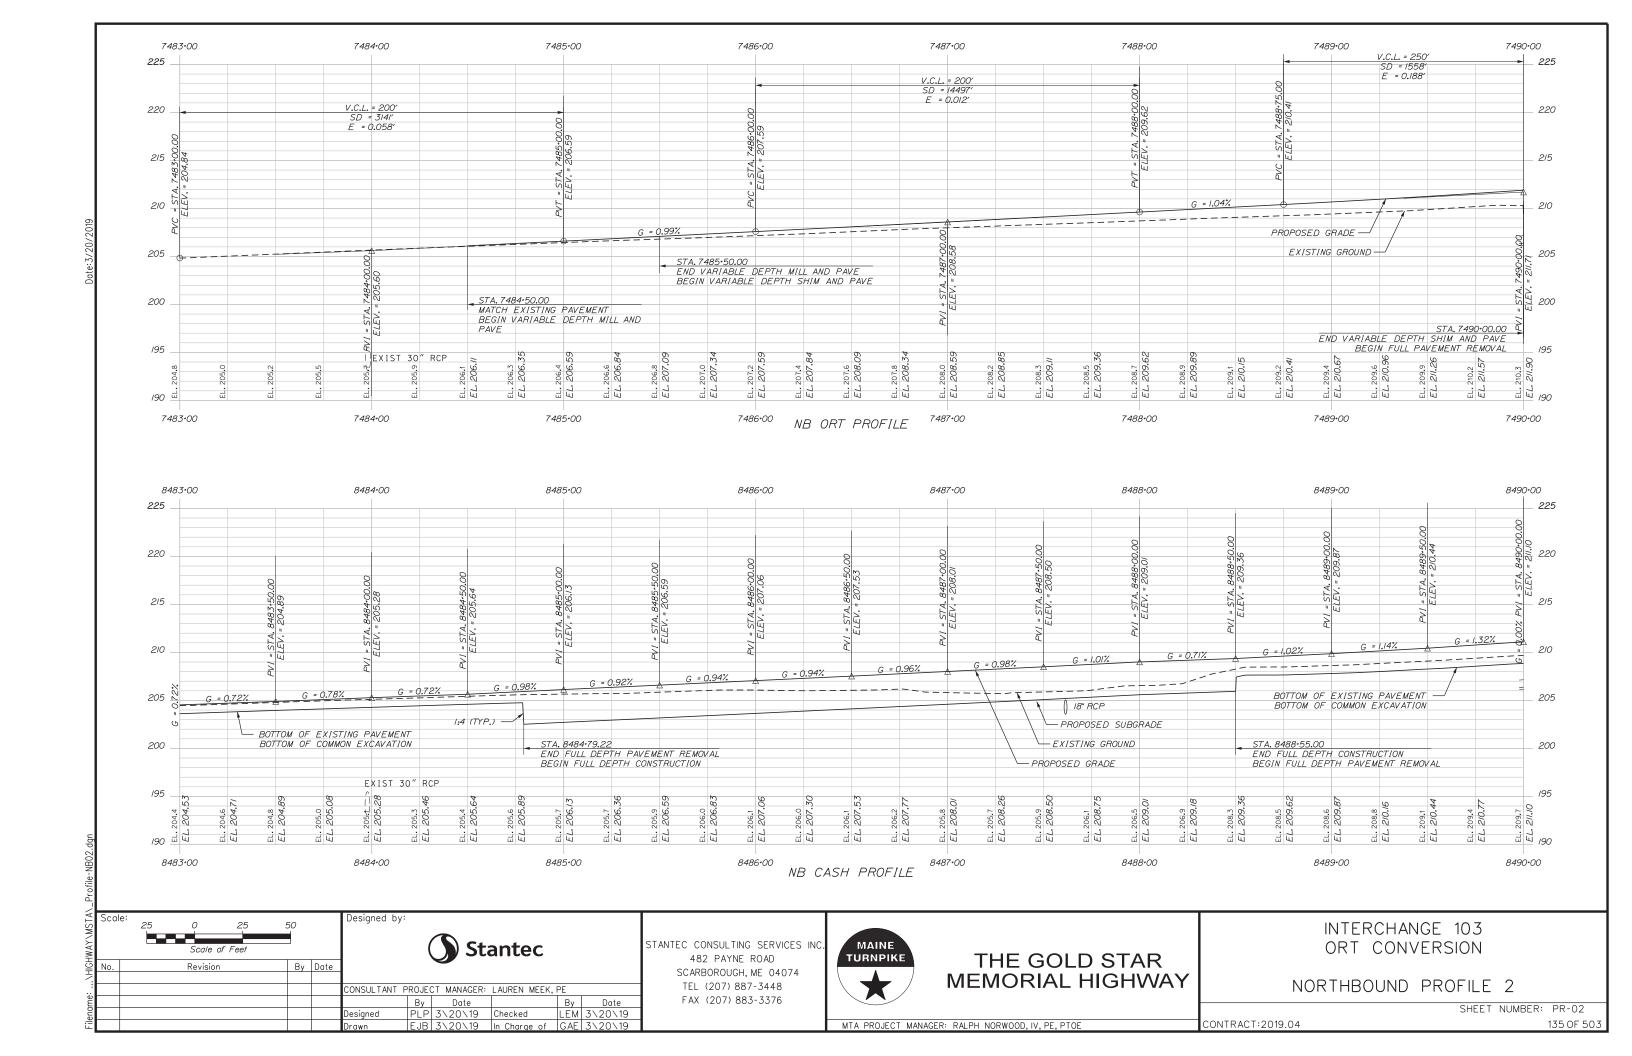


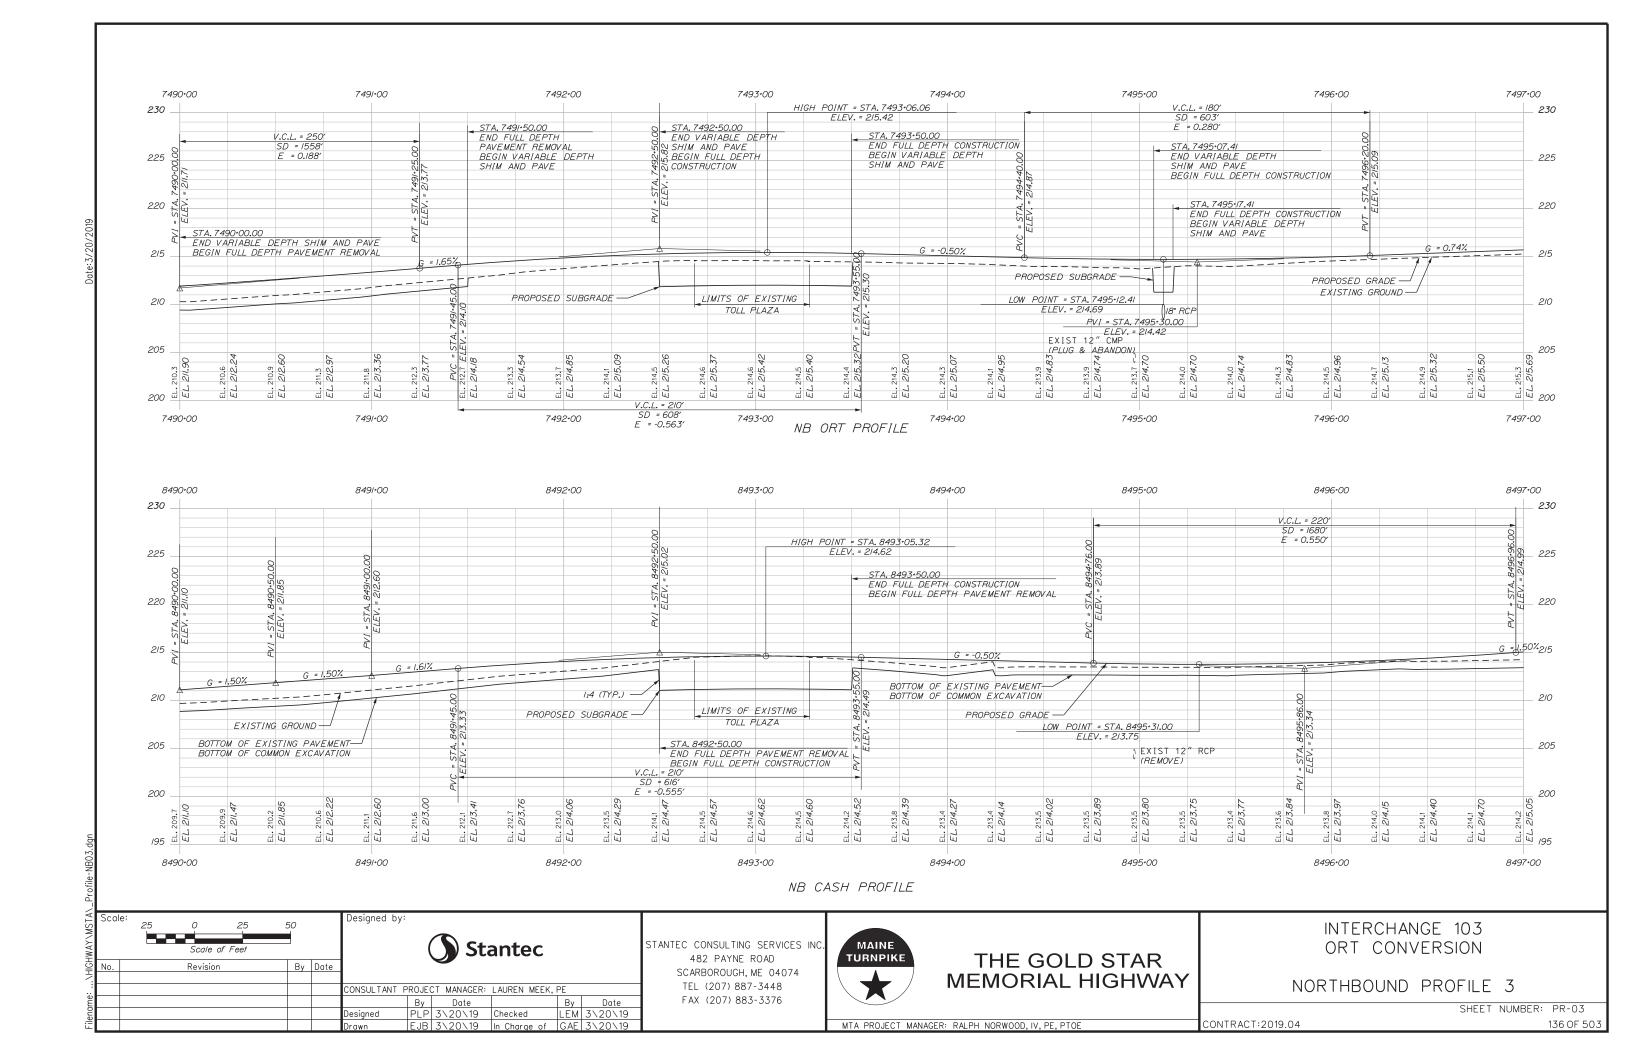


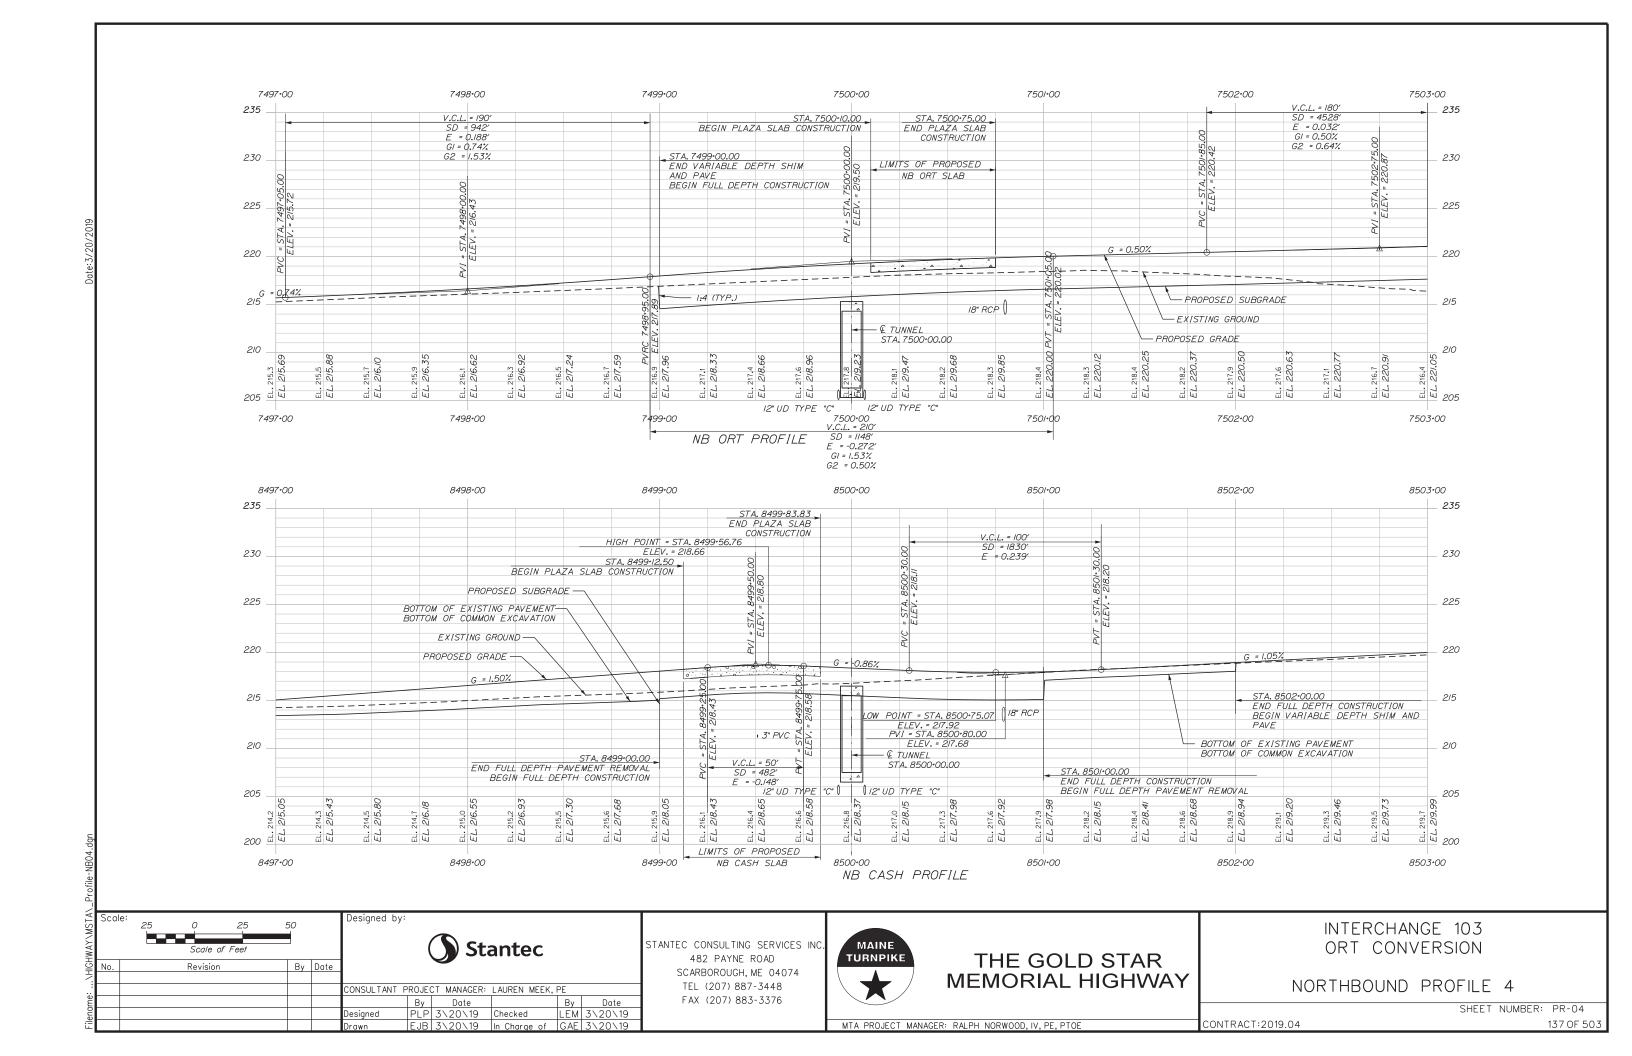

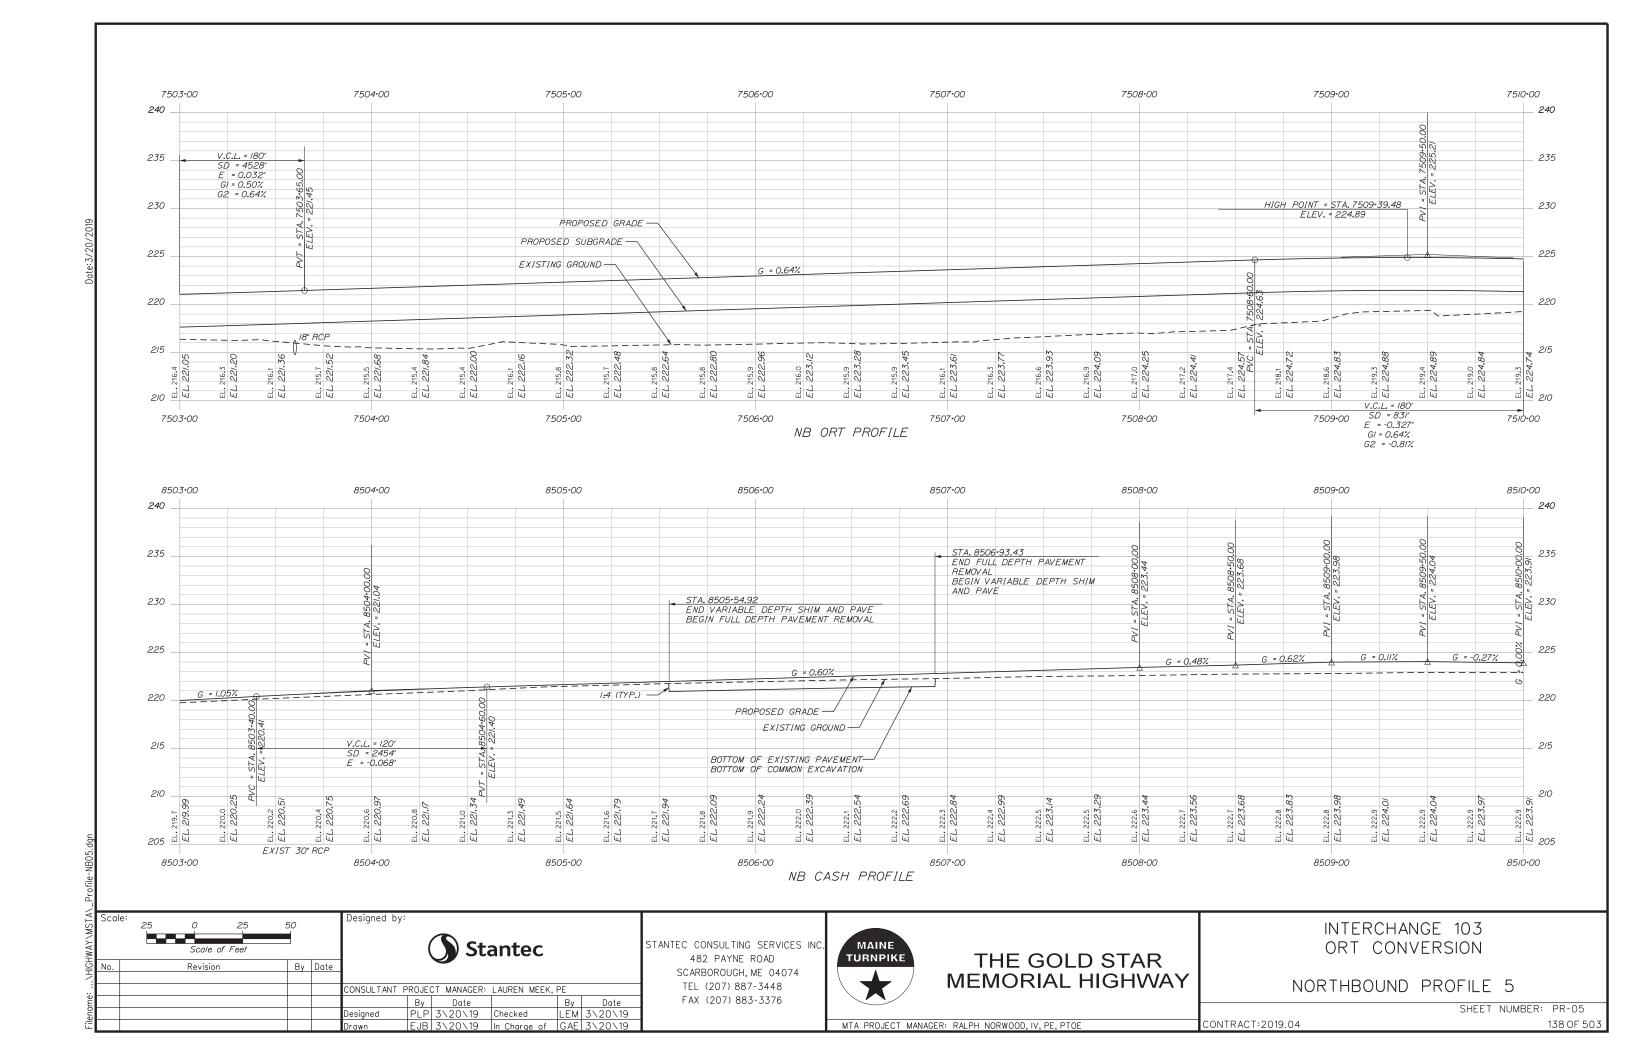

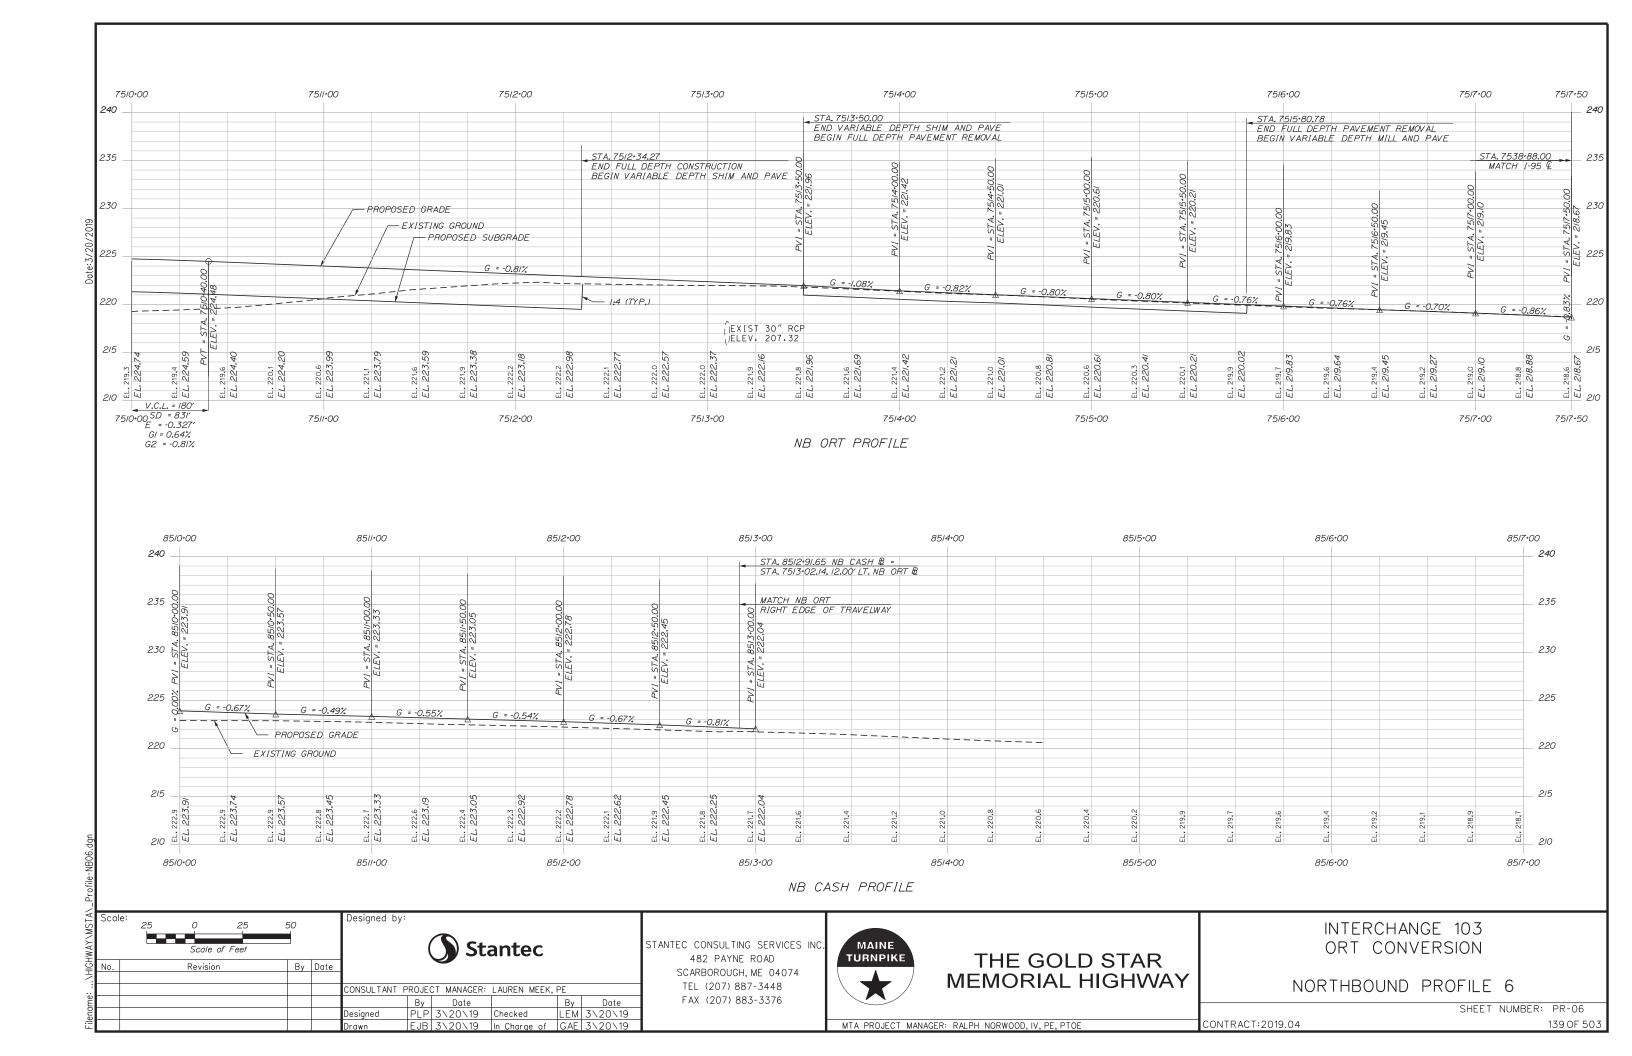

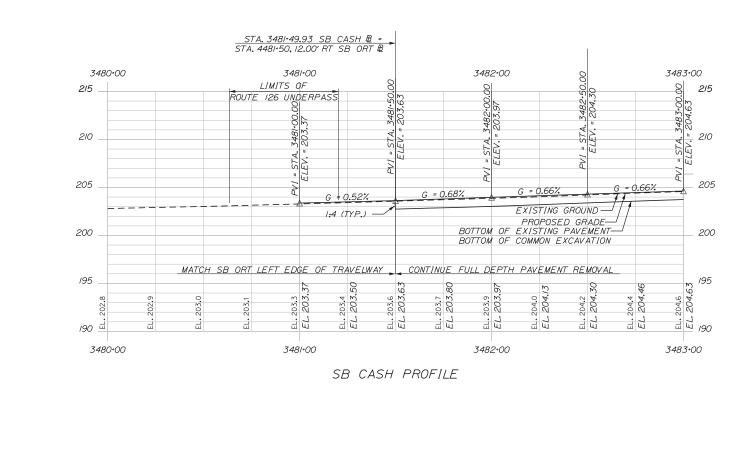

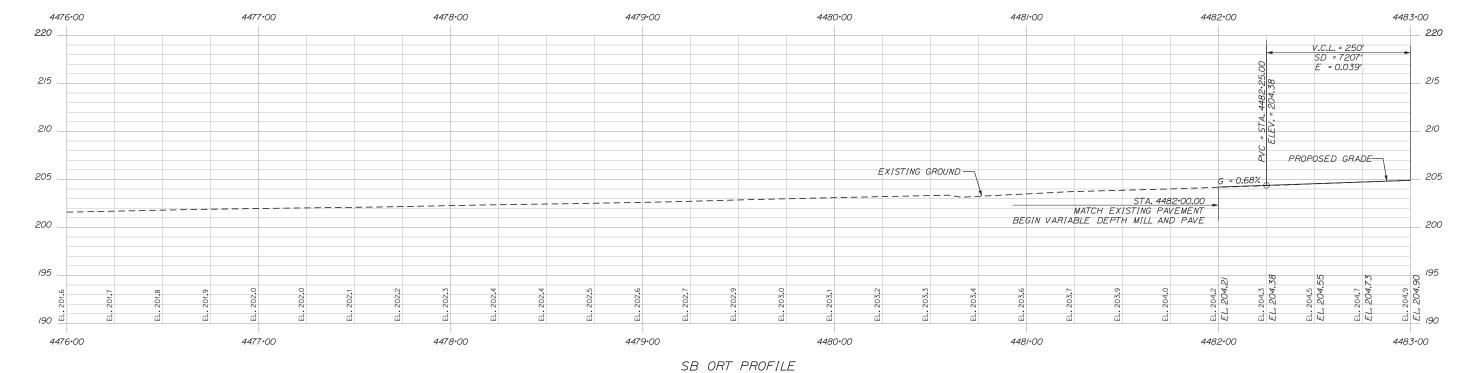

Designed by: Stantec ONSULTANT PROJECT MANAGER: LAUREN MEEK, PE
 By
 Date
 By
 Date

 PLP 3\20\19
 Checked
 LEM 3\20\19

 EJB 3\20\19
 In Charge of GAE 3\20\19

STANTEC CONSULTING SERVICES INC 482 PAYNE ROAD SCARBOROUGH, ME 04074 TEL (207) 887-3448 FAX (207) 883-3376



THE GOLD STAR **MEMORIAL HIGHWAY**


INTERCHANGE 103 ORT CONVERSION


SOUTHBOUND PROFILE 1


SHEET NUMBER: PR-07


MTA PROJECT MANAGER: RALPH NORWOOD, IV, PE, PTOE


CONTRACT:2019.04

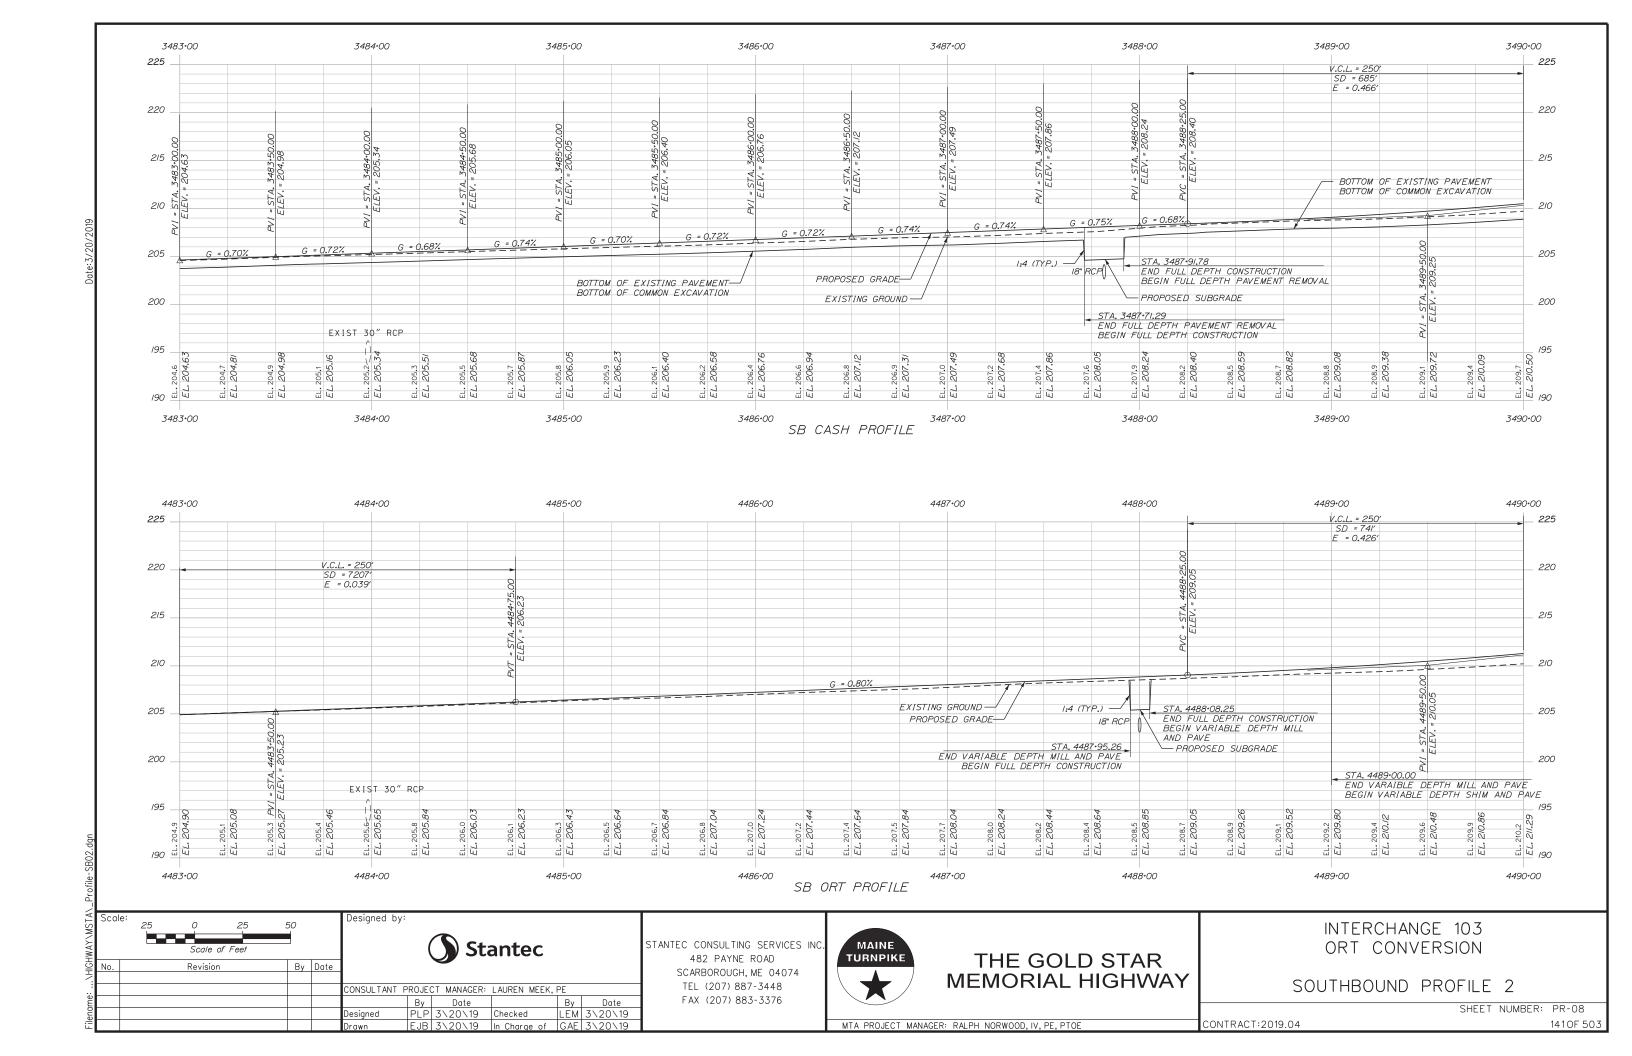

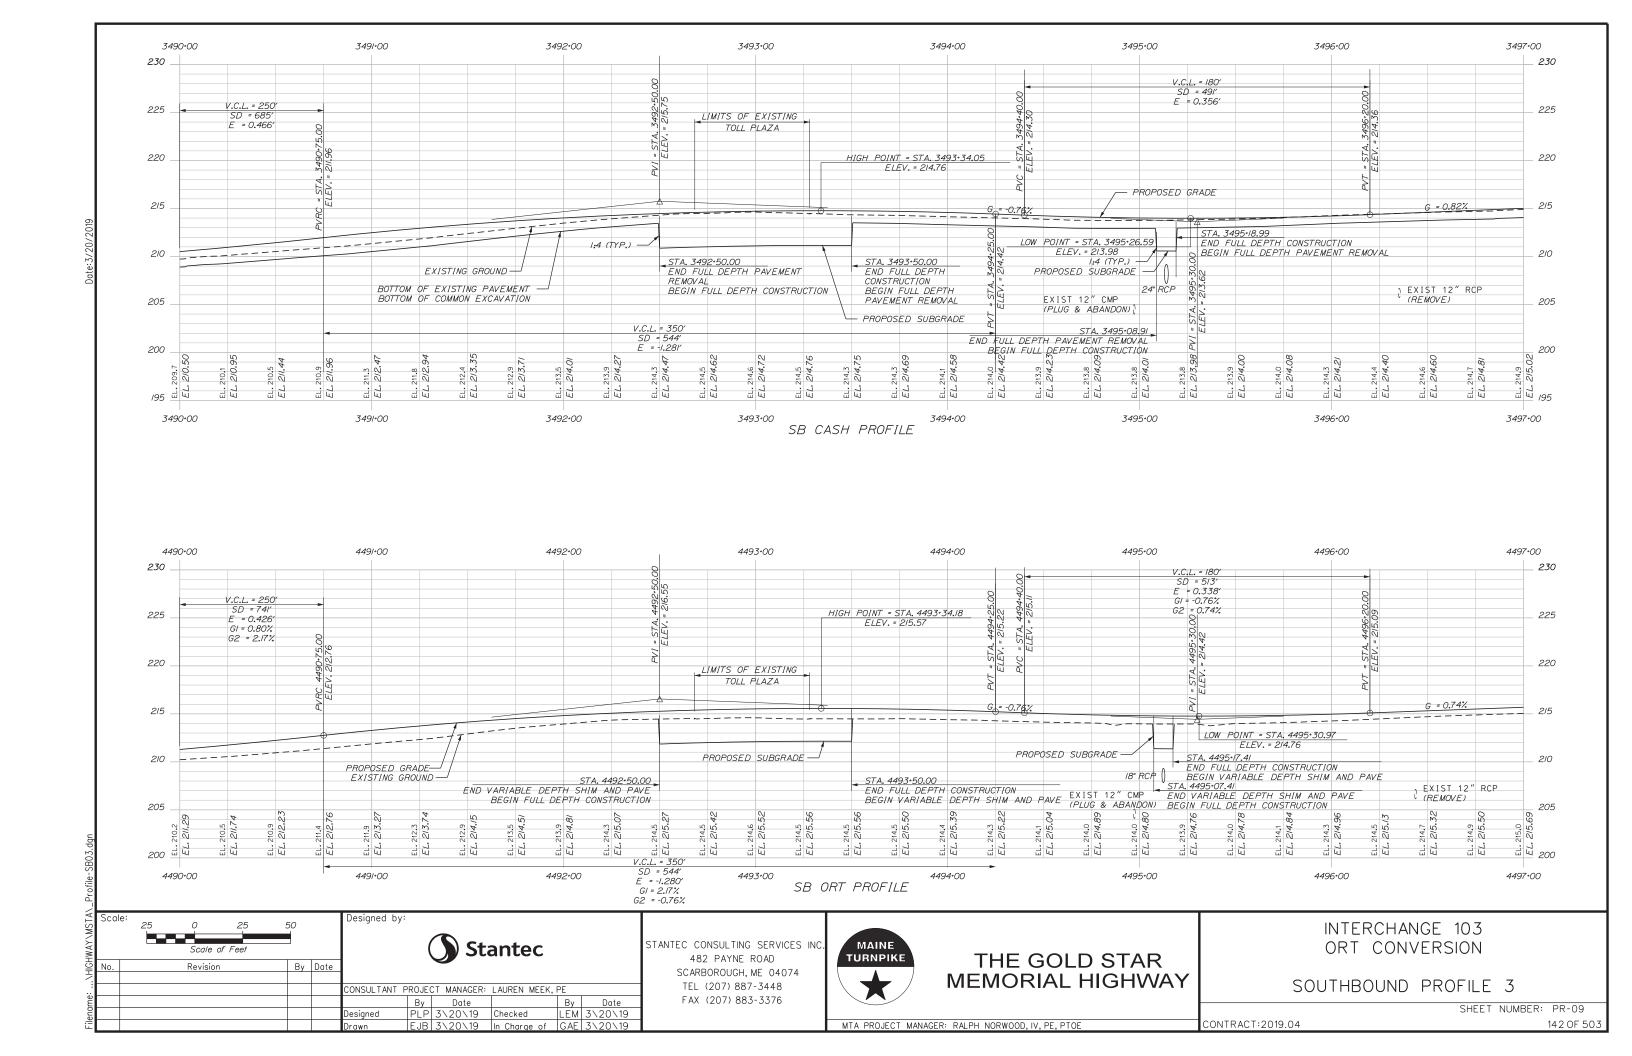


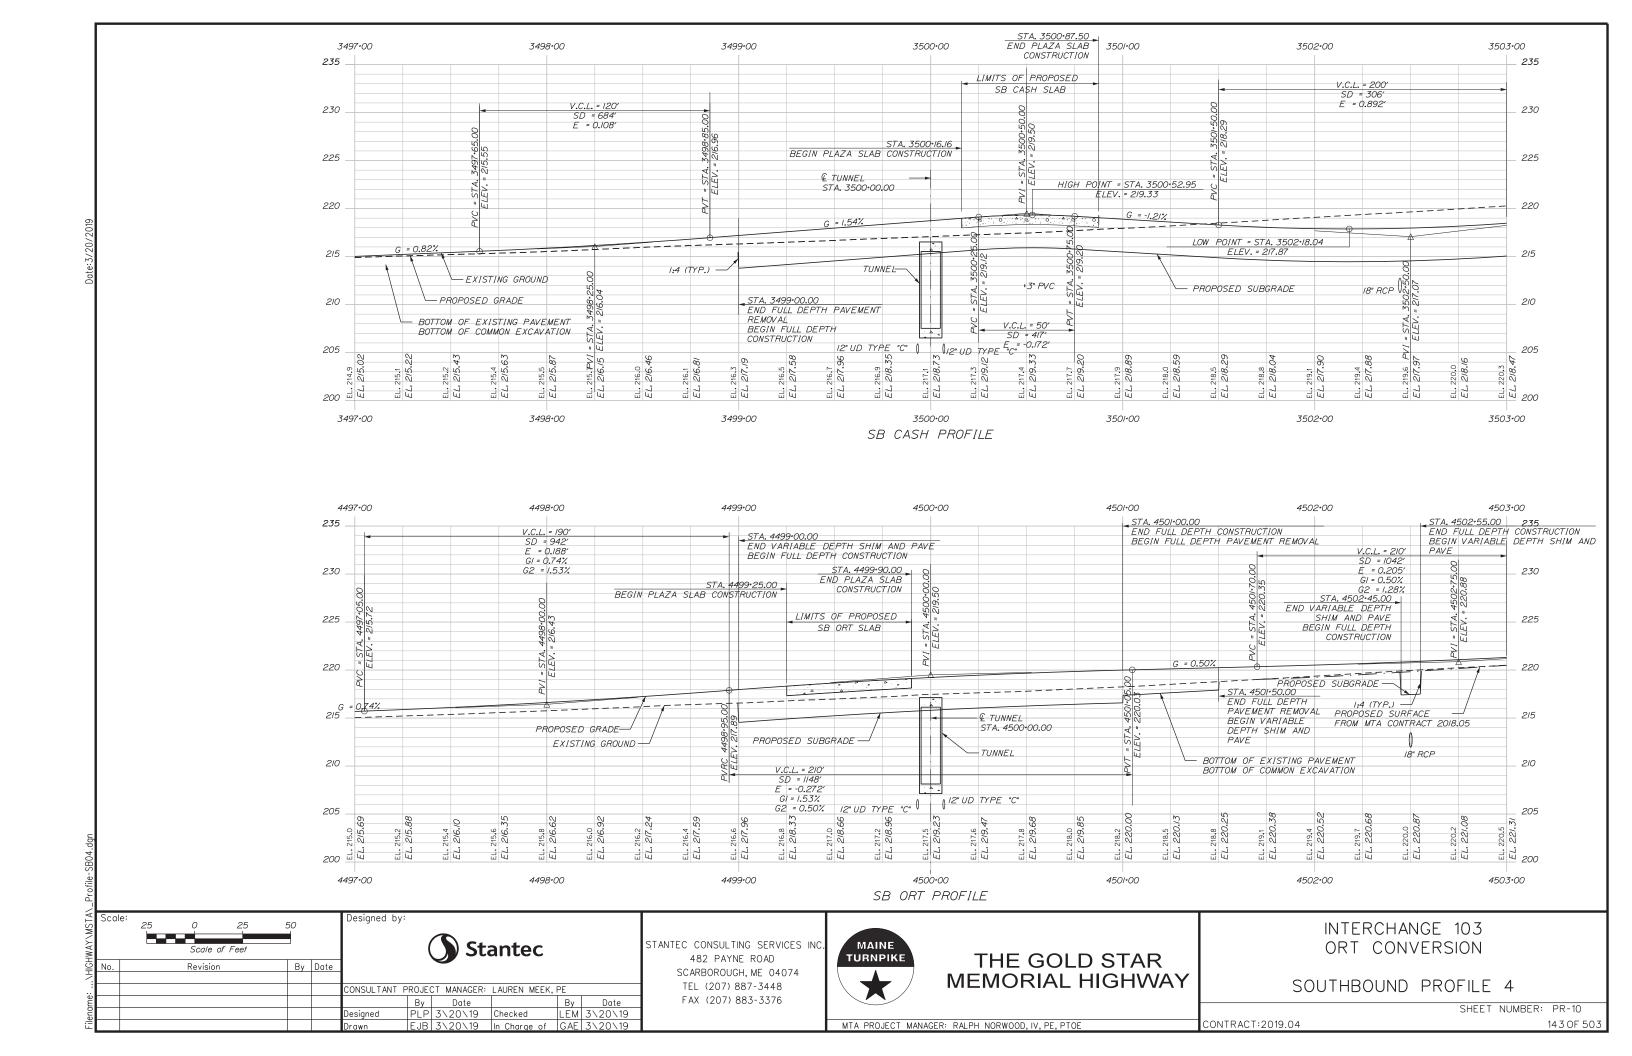

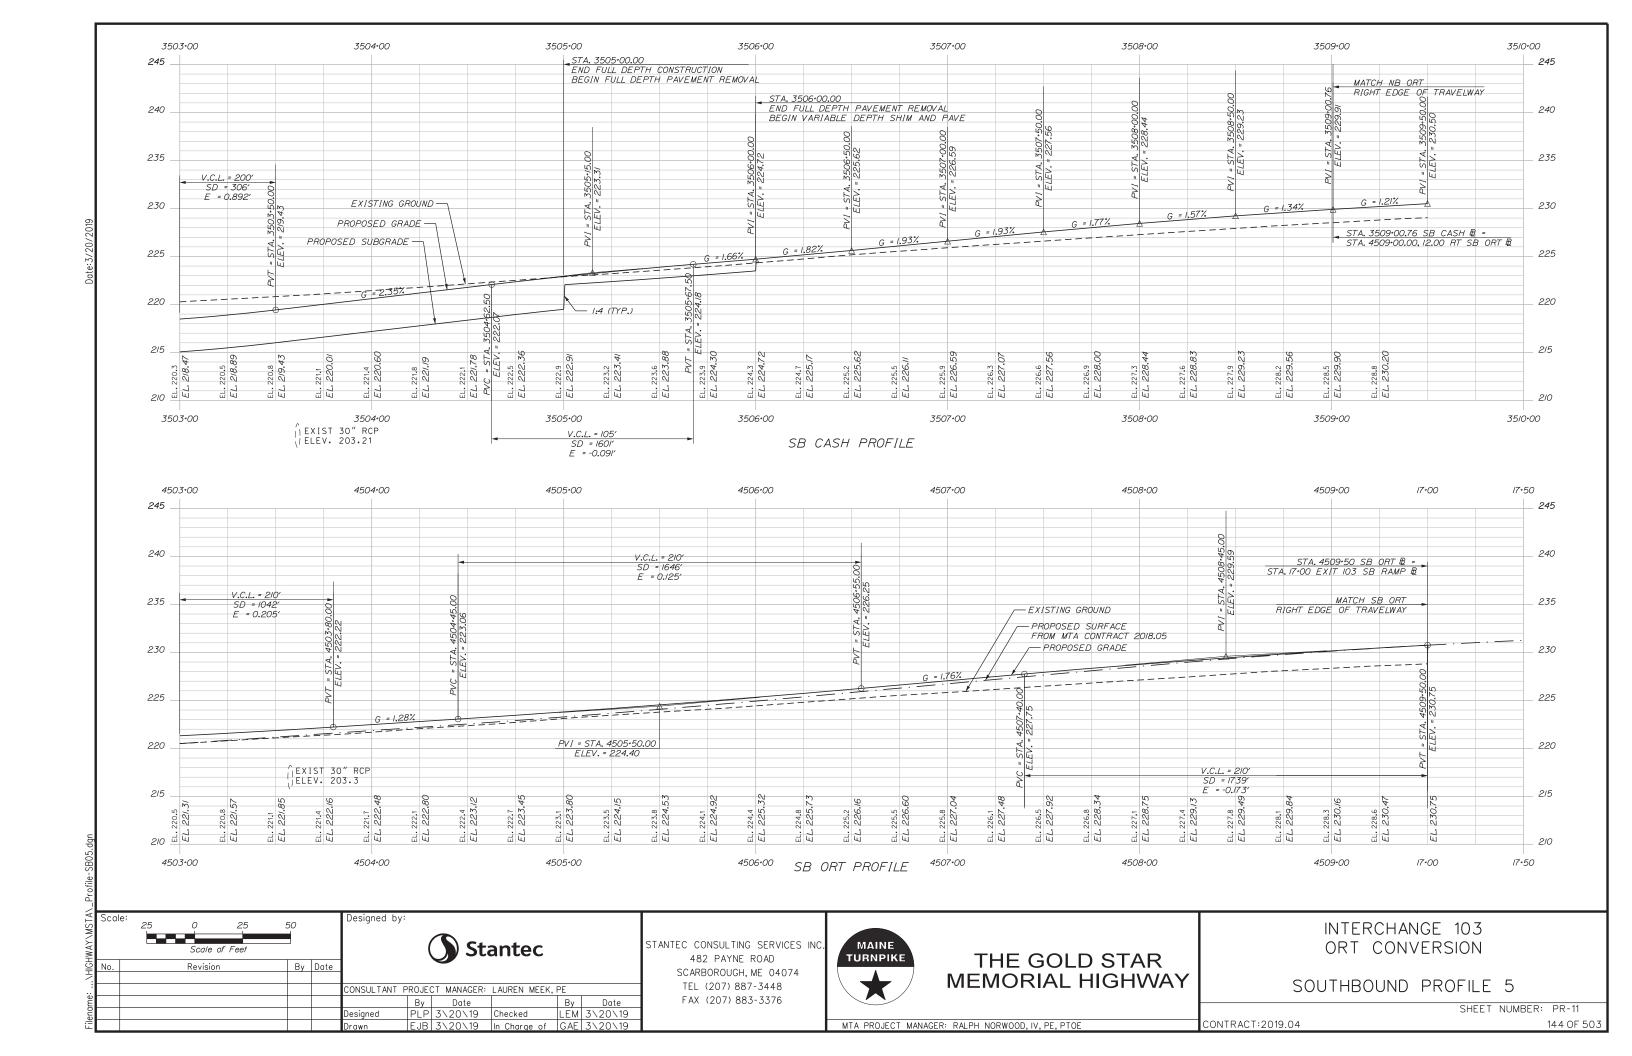

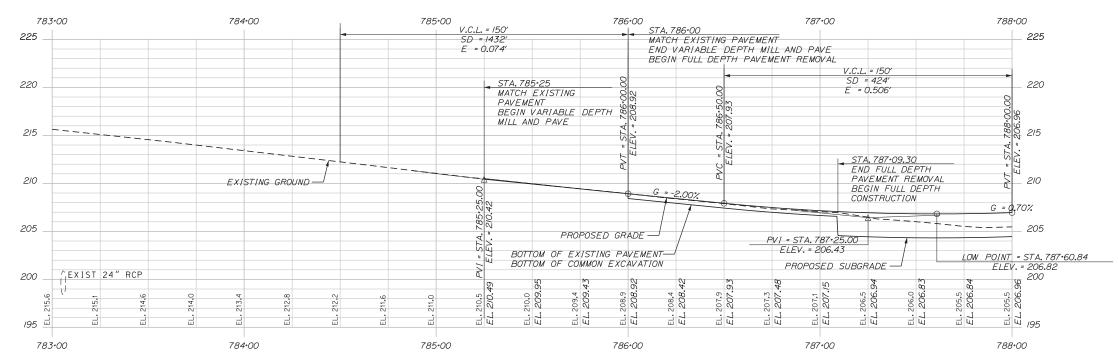

EXIT 51 SB OFF RAMP PROFILE

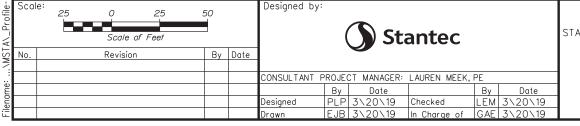

STANTEC CONSULTING SERVICES INC.
482 PAYNE ROAD
SCARBOROUGH, ME 04074
TEL (207) 887-3448
FAX (207) 883-3376



THE GOLD STAR MEMORIAL HIGHWAY


INTERCHANGE 103 ORT CONVERSION

EXIT 51 SB OFF RAMP PROFILE

SHEET NUMBER: PR-12

MTA PROJECT MANAGER: RALPH NORWOOD, IV, PE, PTOE

CONTRACT:2019.04

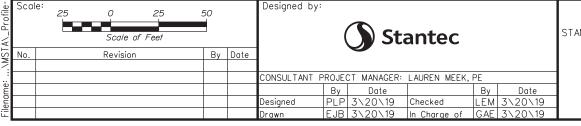

STANTEC CONSULTING SERVICES INC 482 PAYNE ROAD SCARBOROUGH, ME 04074 TEL (207) 887-3448 FAX (207) 883-3376



THE GOLD STAR **MEMORIAL HIGHWAY**


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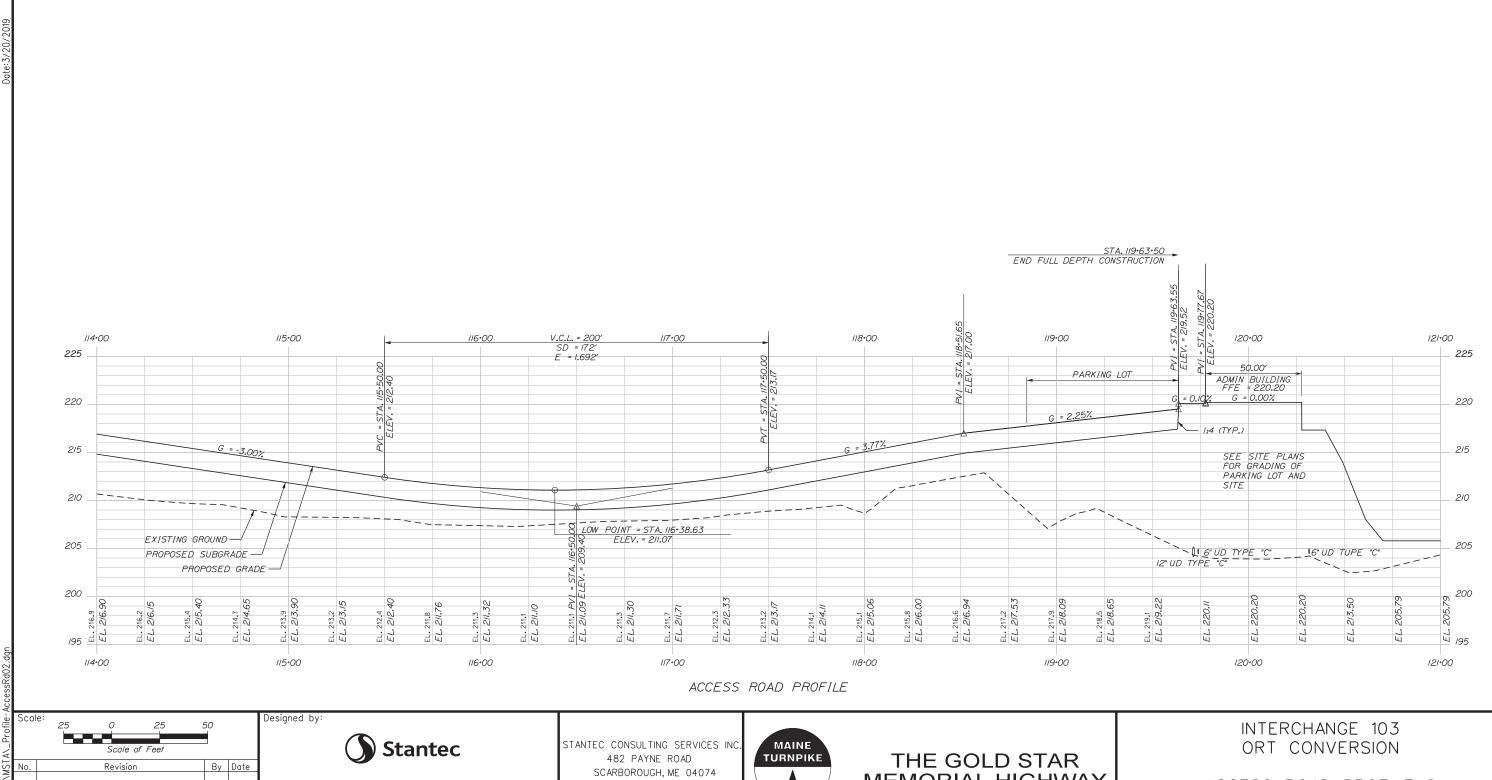
INTERCHANGE 103

EXIT 51 NB ON RAMP PROFILE

SHEET NUMBER: PR-13 CONTRACT:2019.04

MTA PROJECT MANAGER: RALPH NORWOOD, IV, PE, PTOE



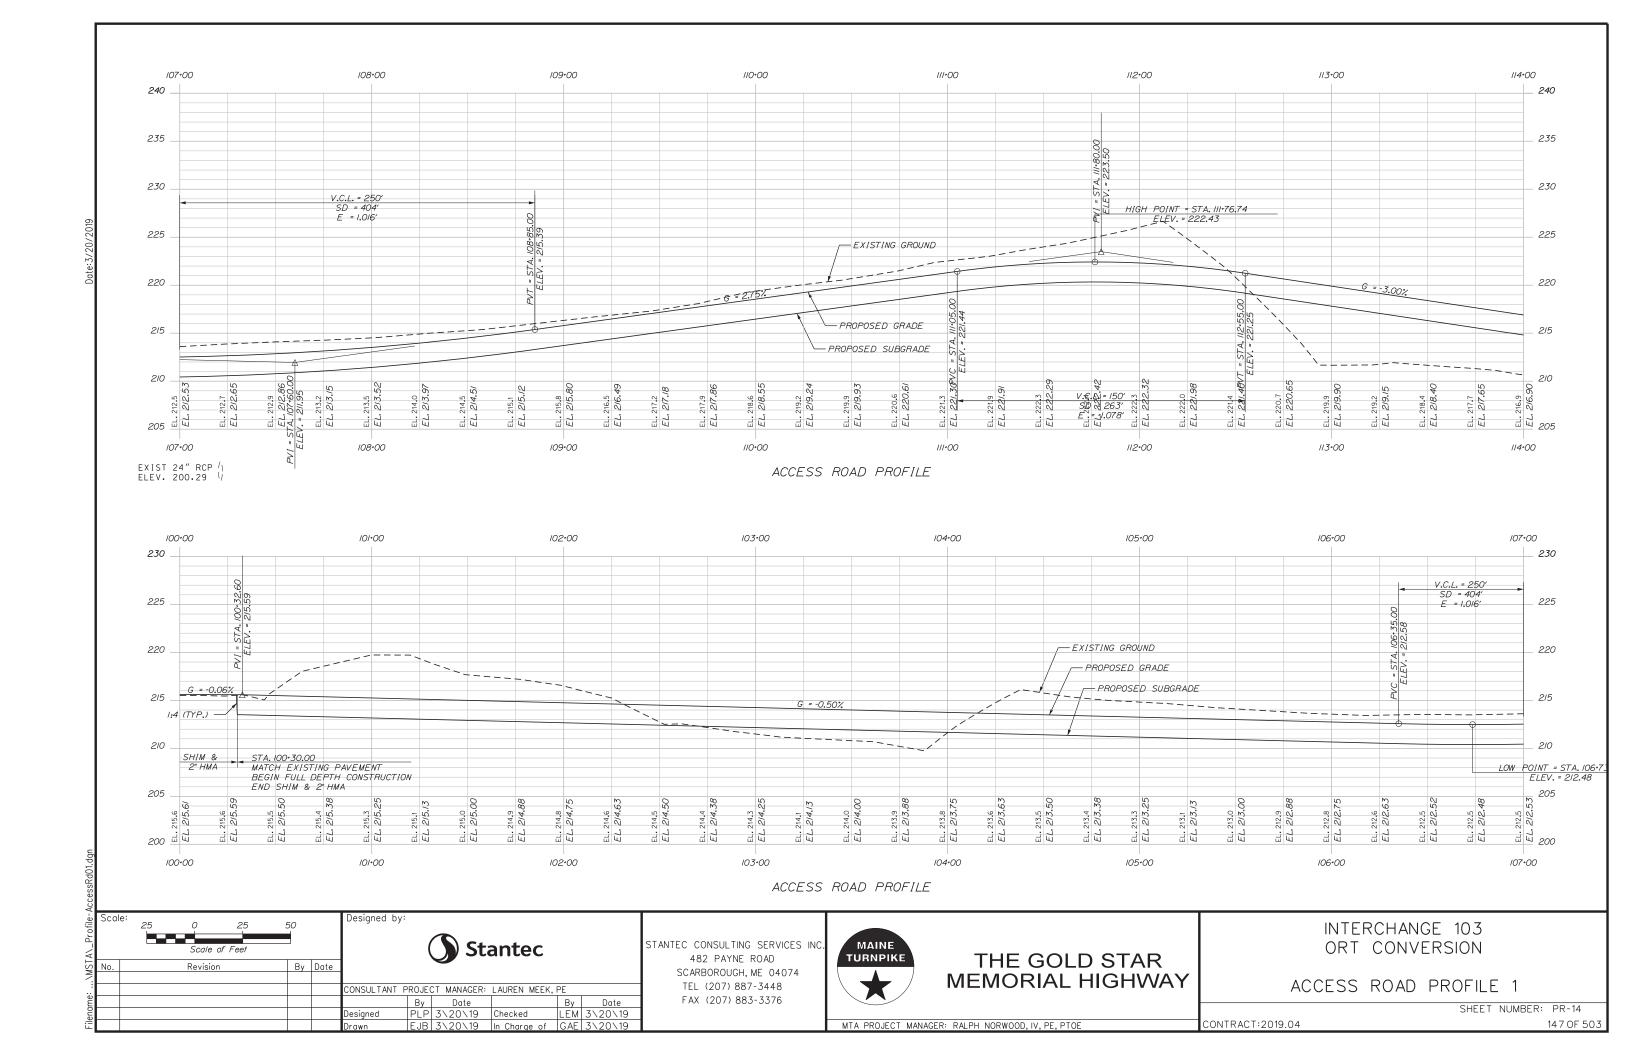

ONSULTANT PROJECT MANAGER: LAUREN MEEK, PE

 By
 Date
 By
 Date

 PLP 3\20\19
 Checked
 LEM 3\20\19

 EJB 3\20\19
 In Charge of GAE 3\20\19

TEL (207) 887-3448 FAX (207) 883-3376





MTA PROJECT MANAGER: RALPH NORWOOD, IV, PE, PTOE


MEMORIAL HIGHWAY


ACCESS ROAD PROFILE 2


SHEET NUMBER: PR-15 CONTRACT:2019.04

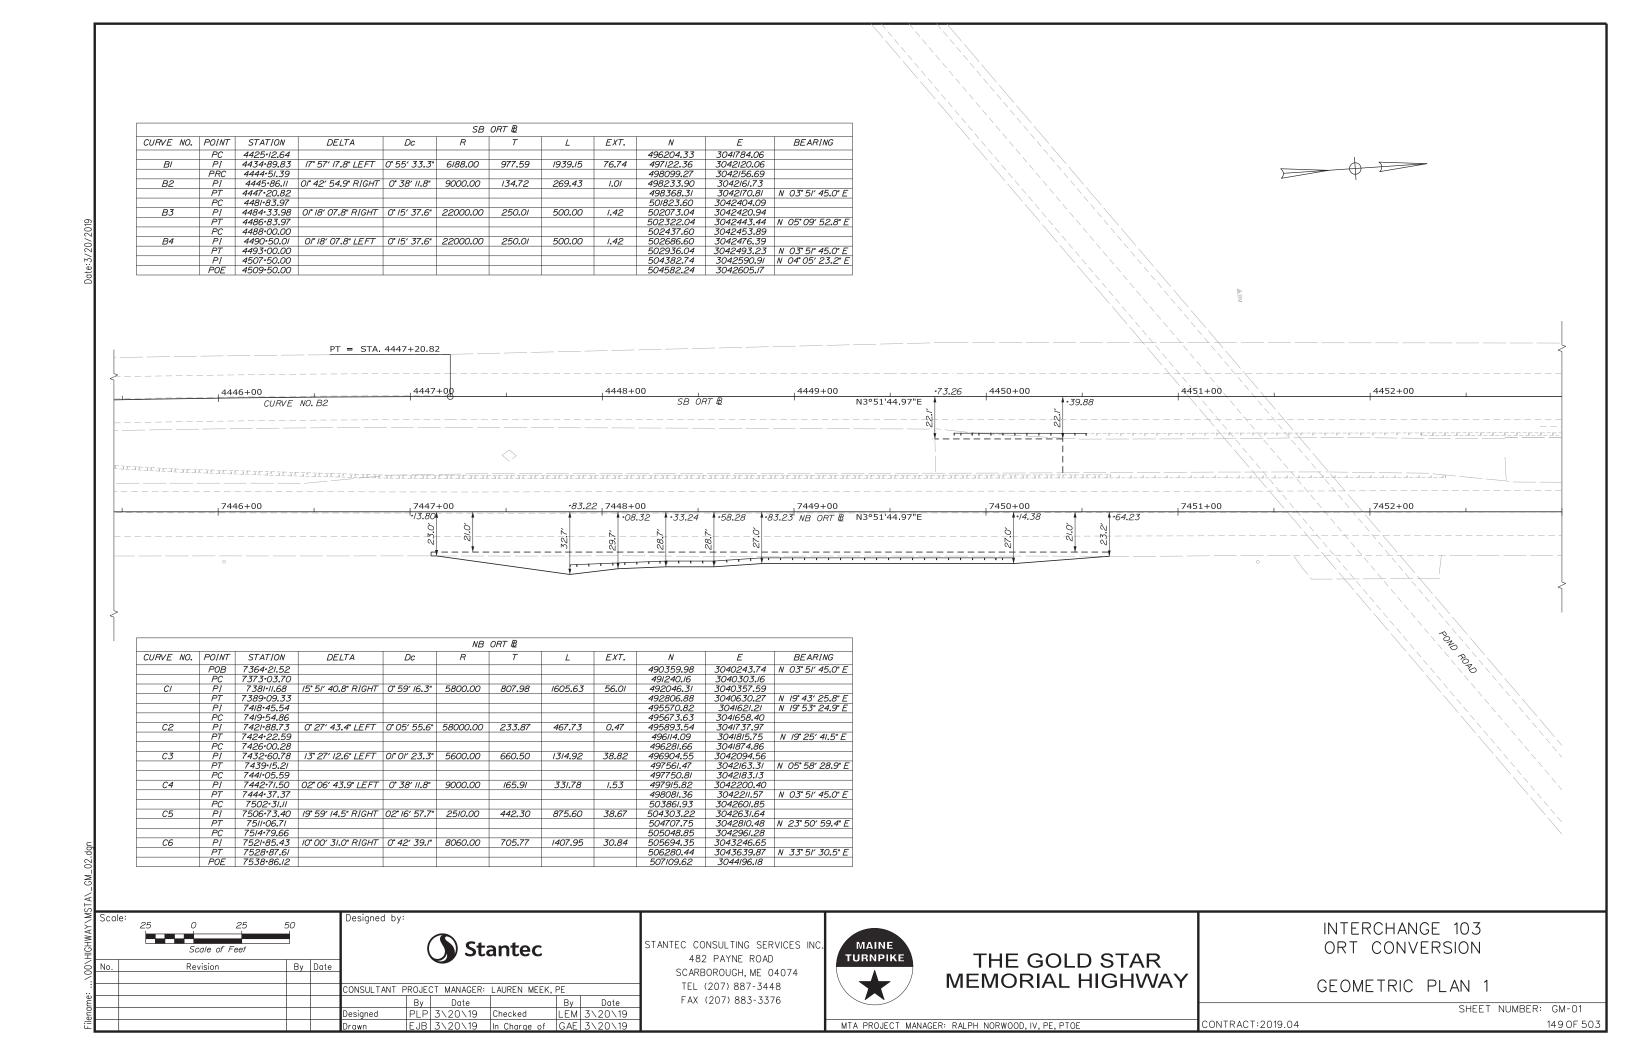


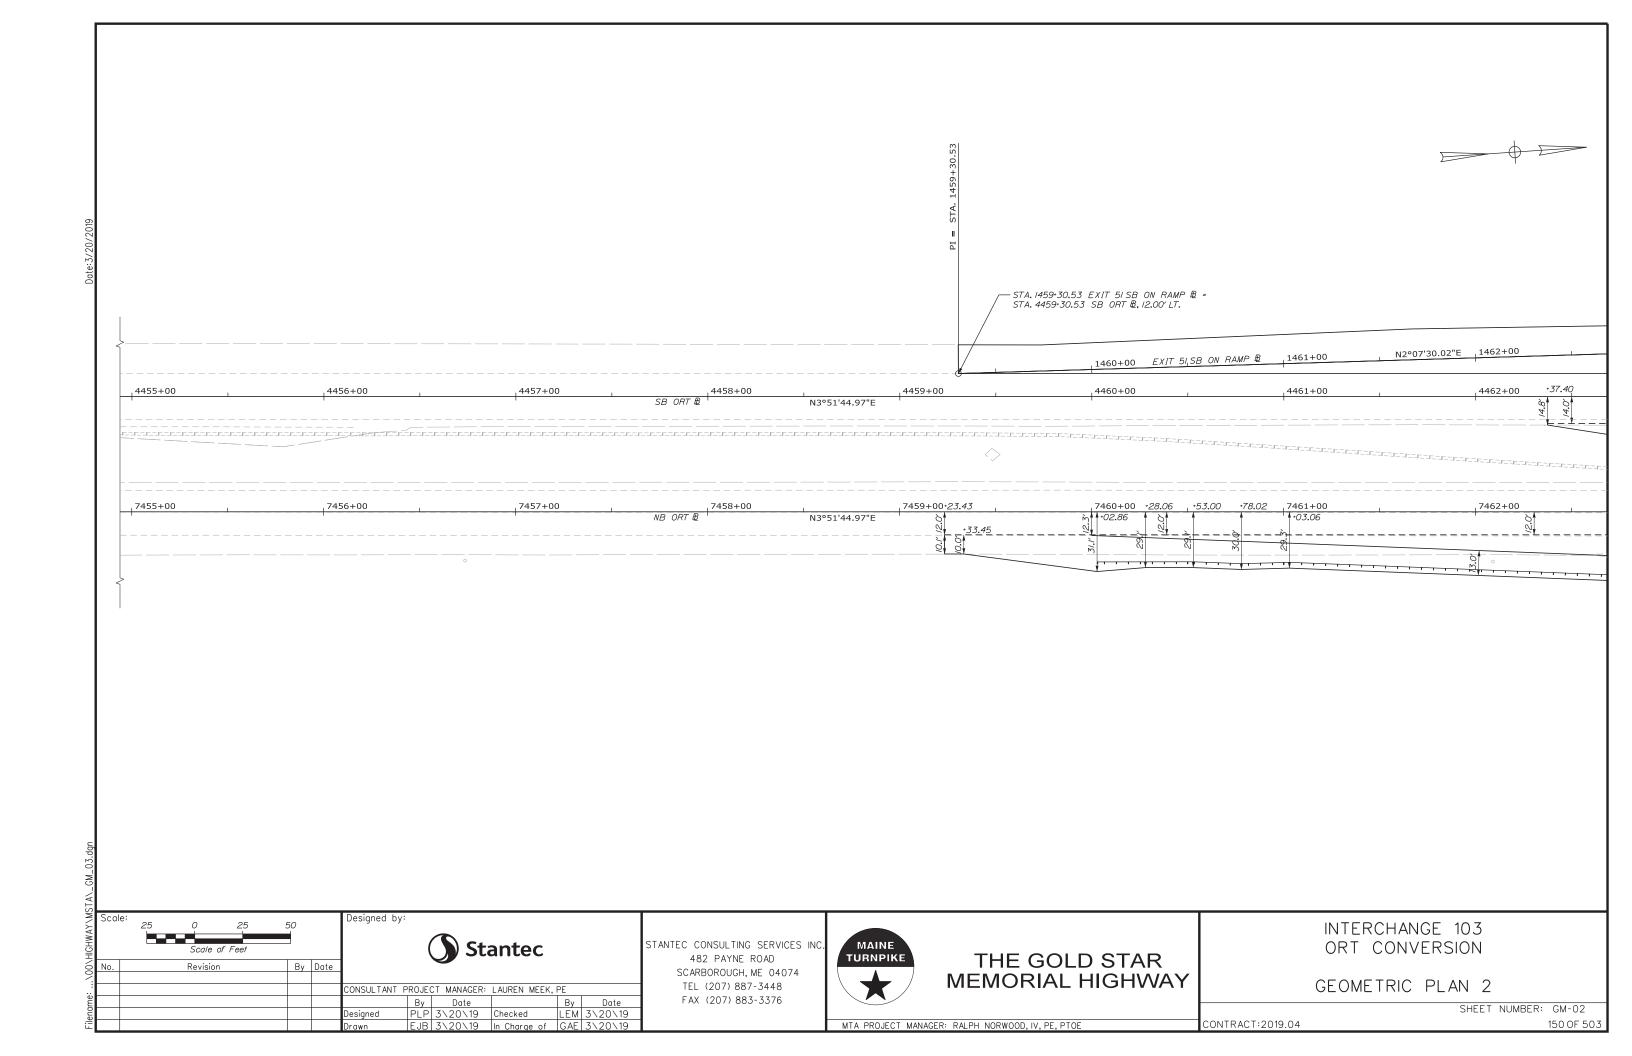


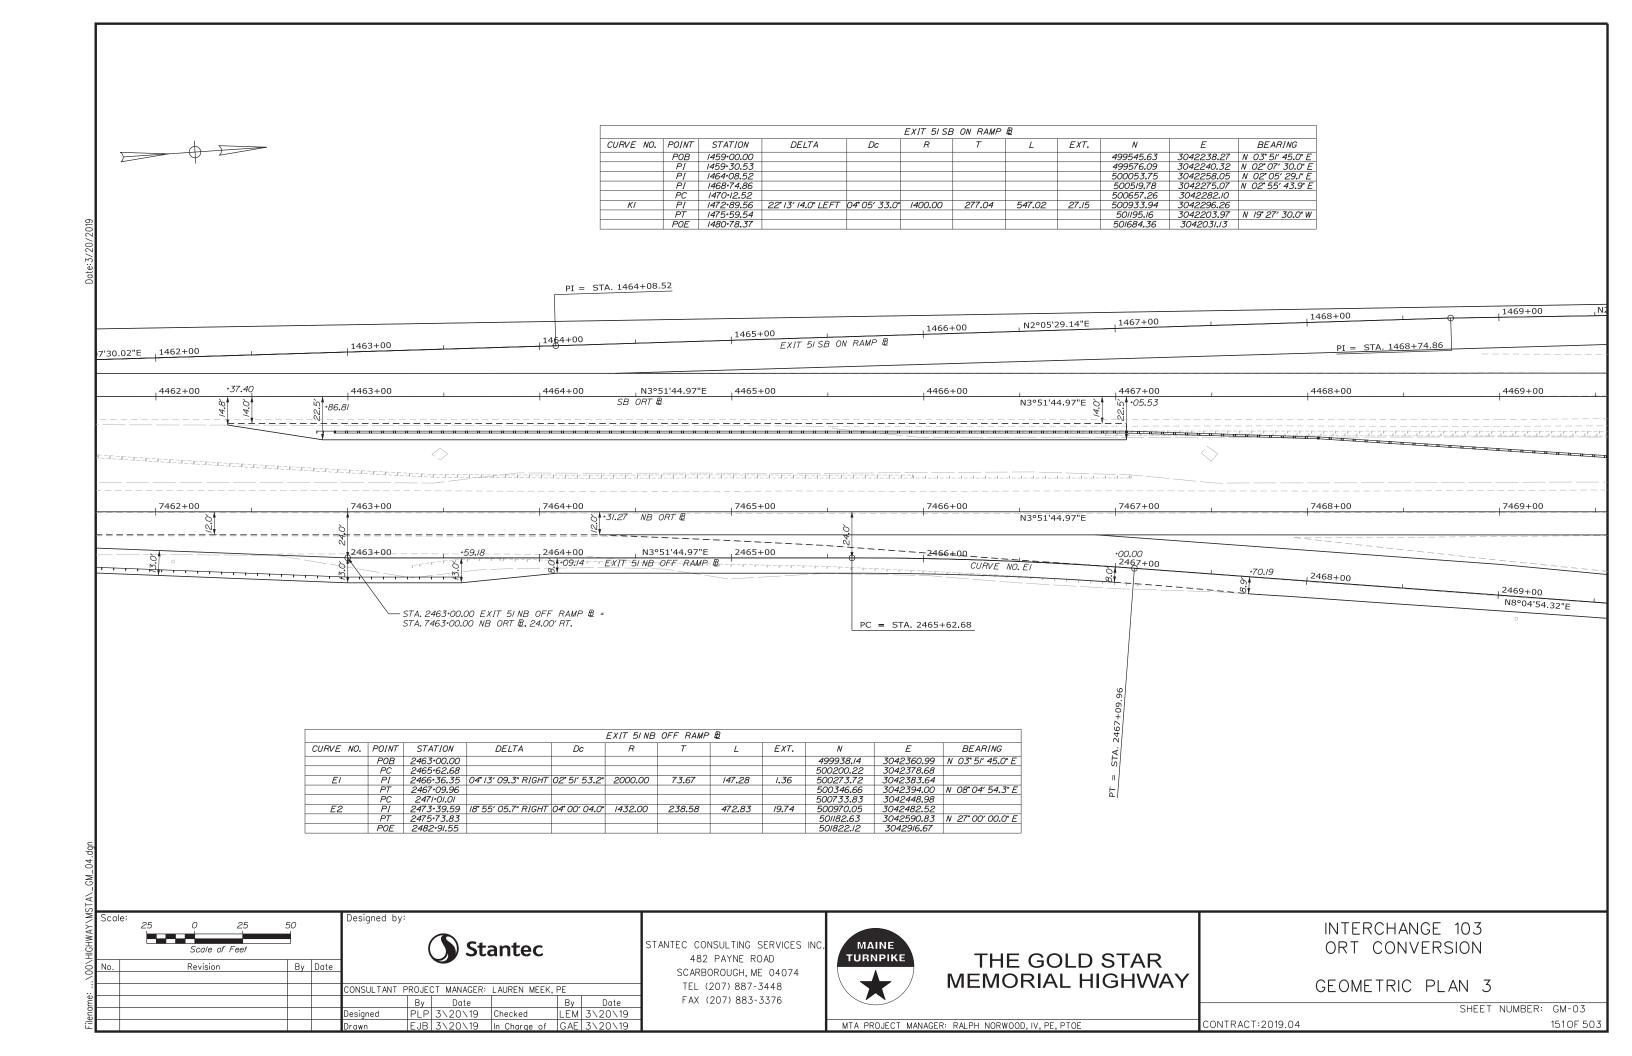


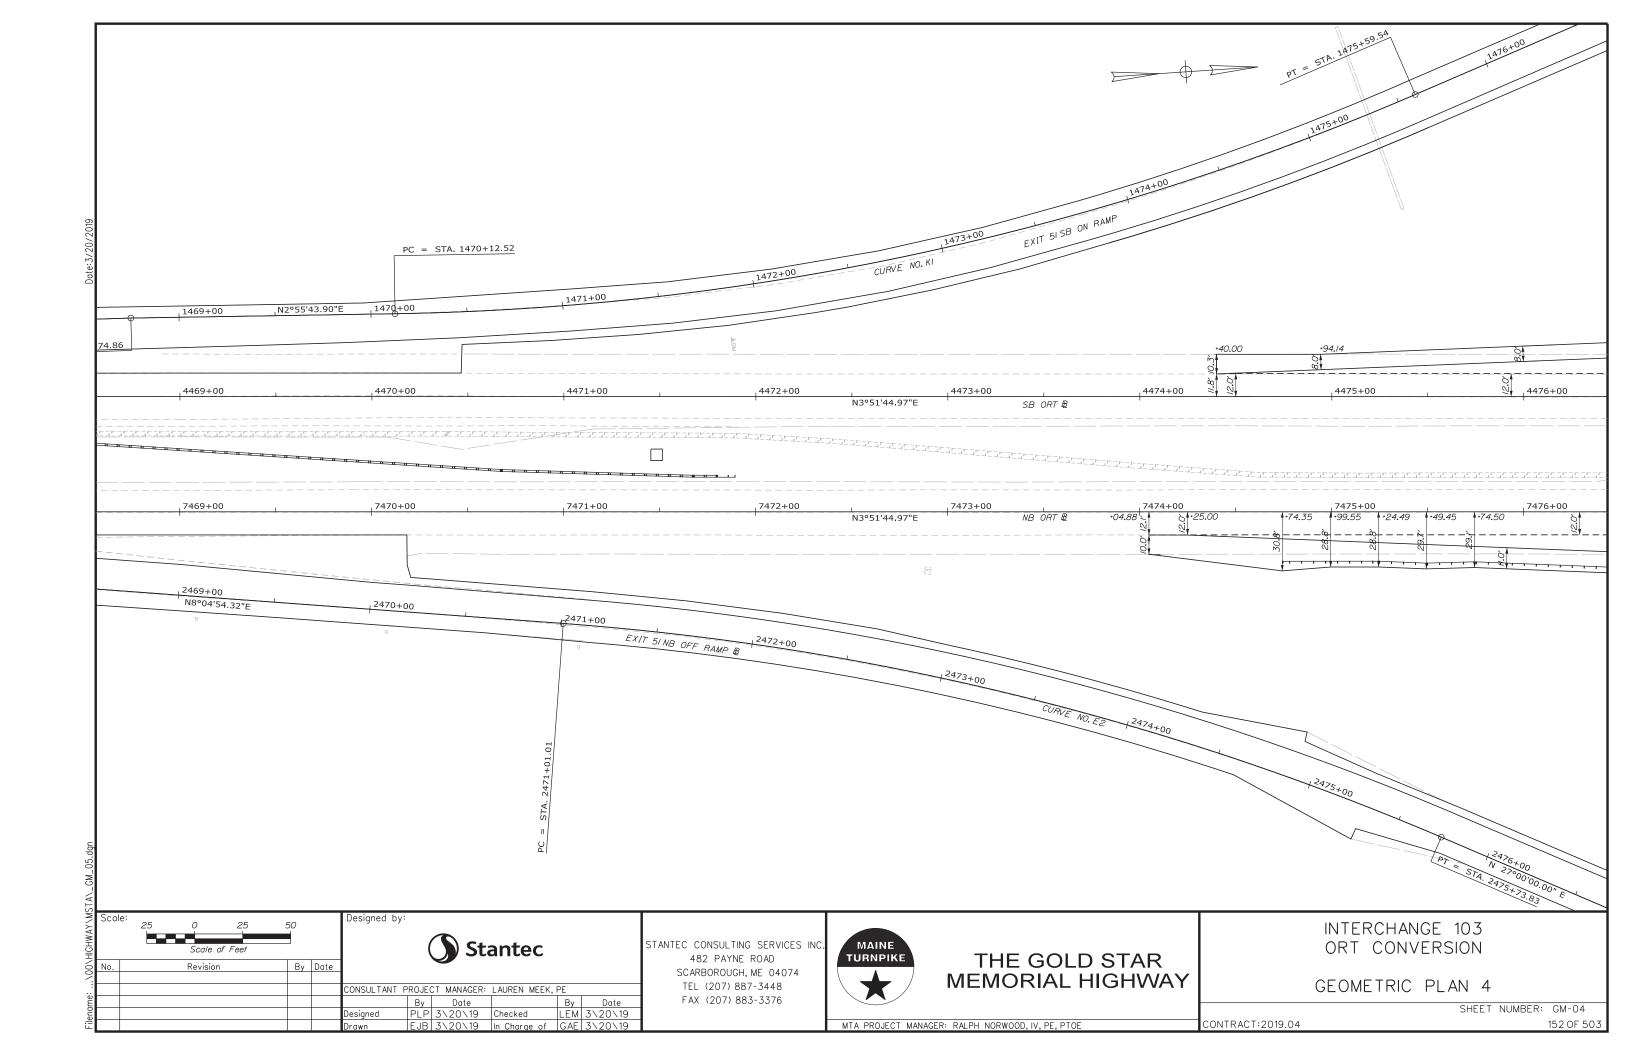


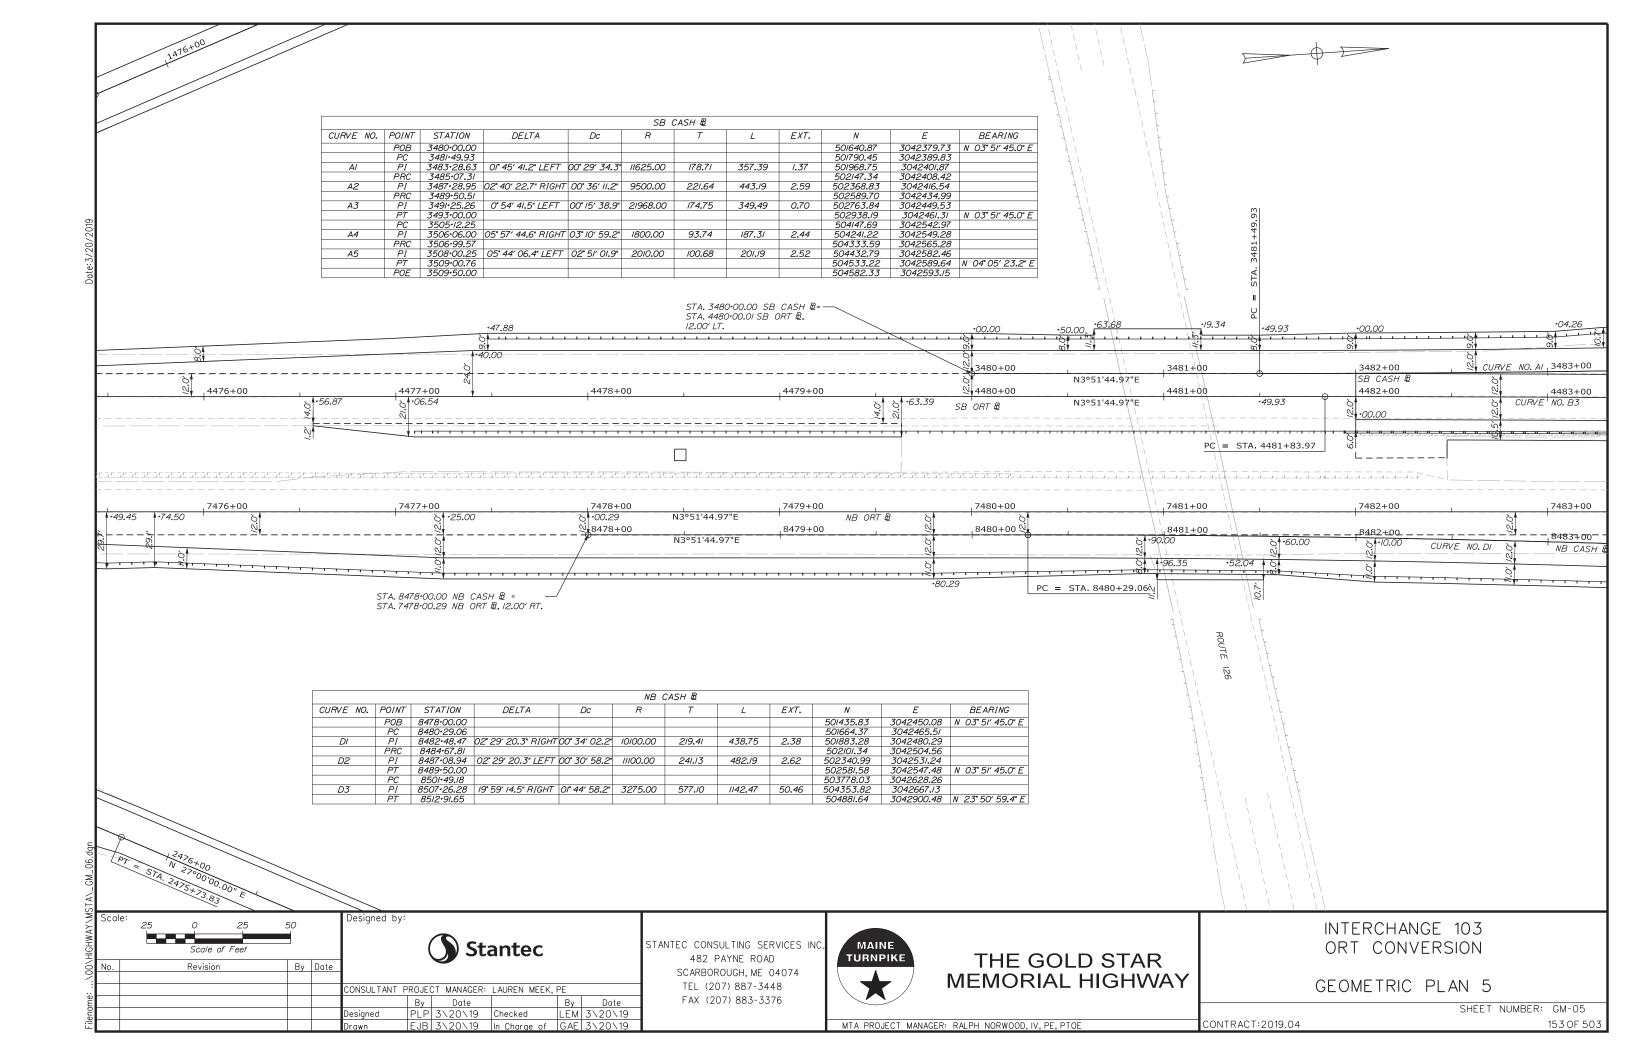


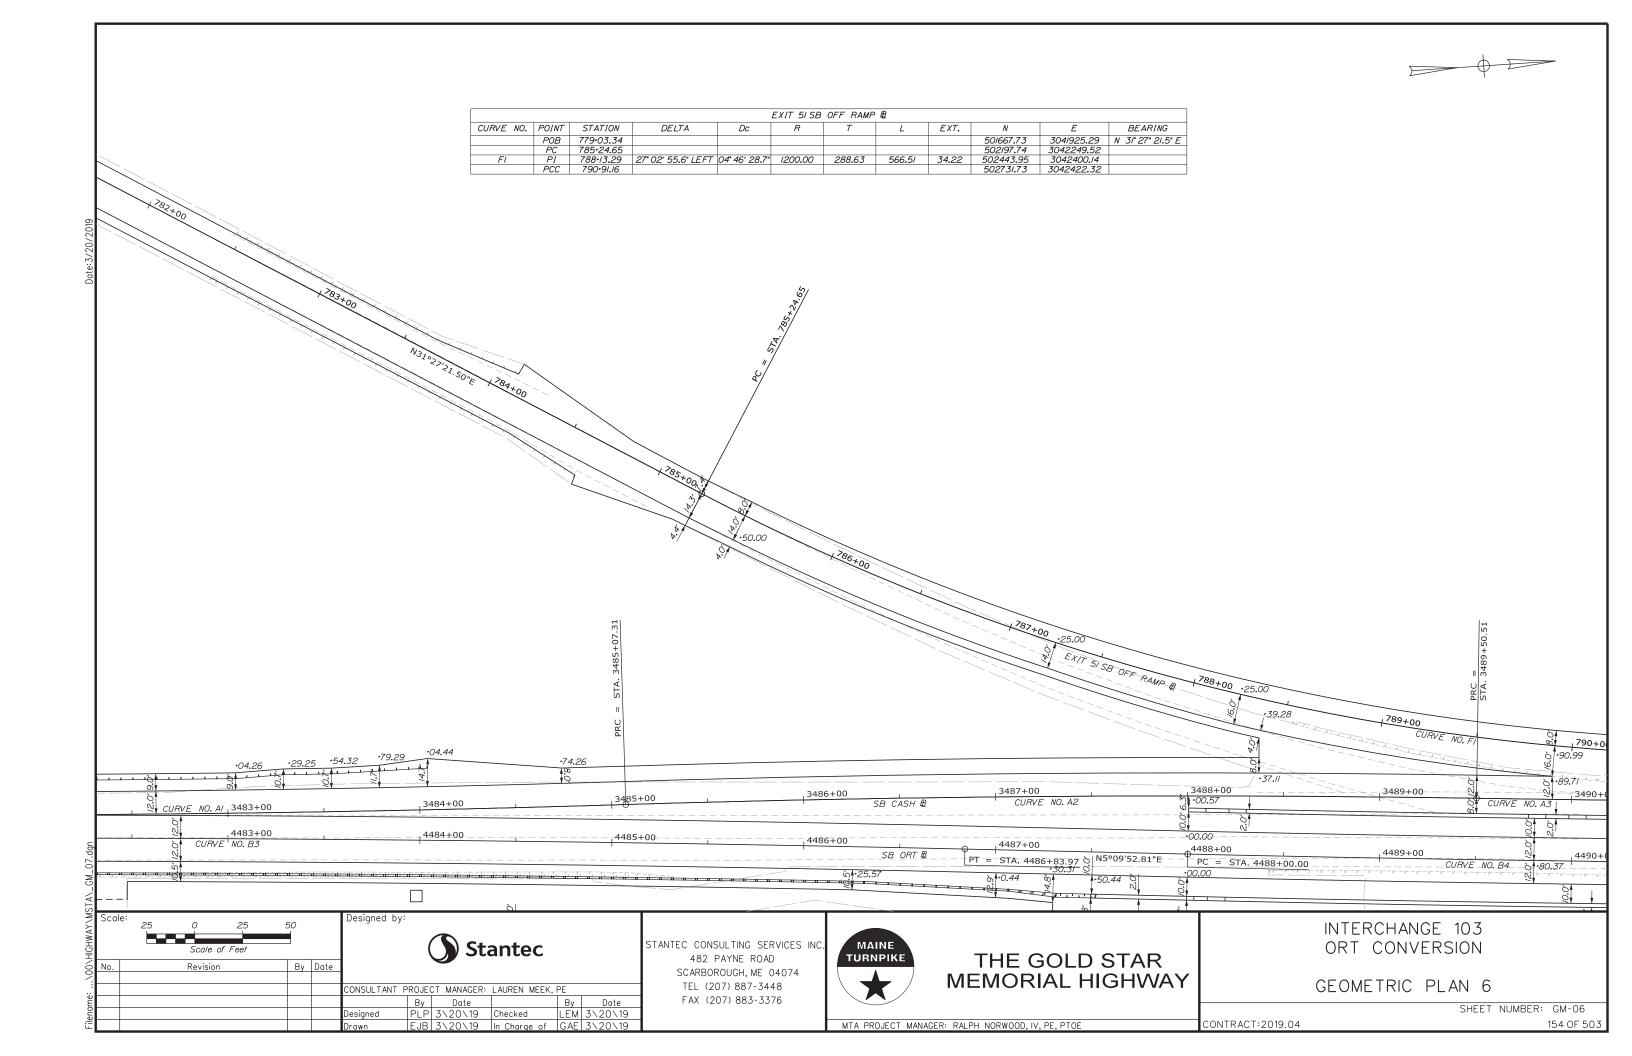


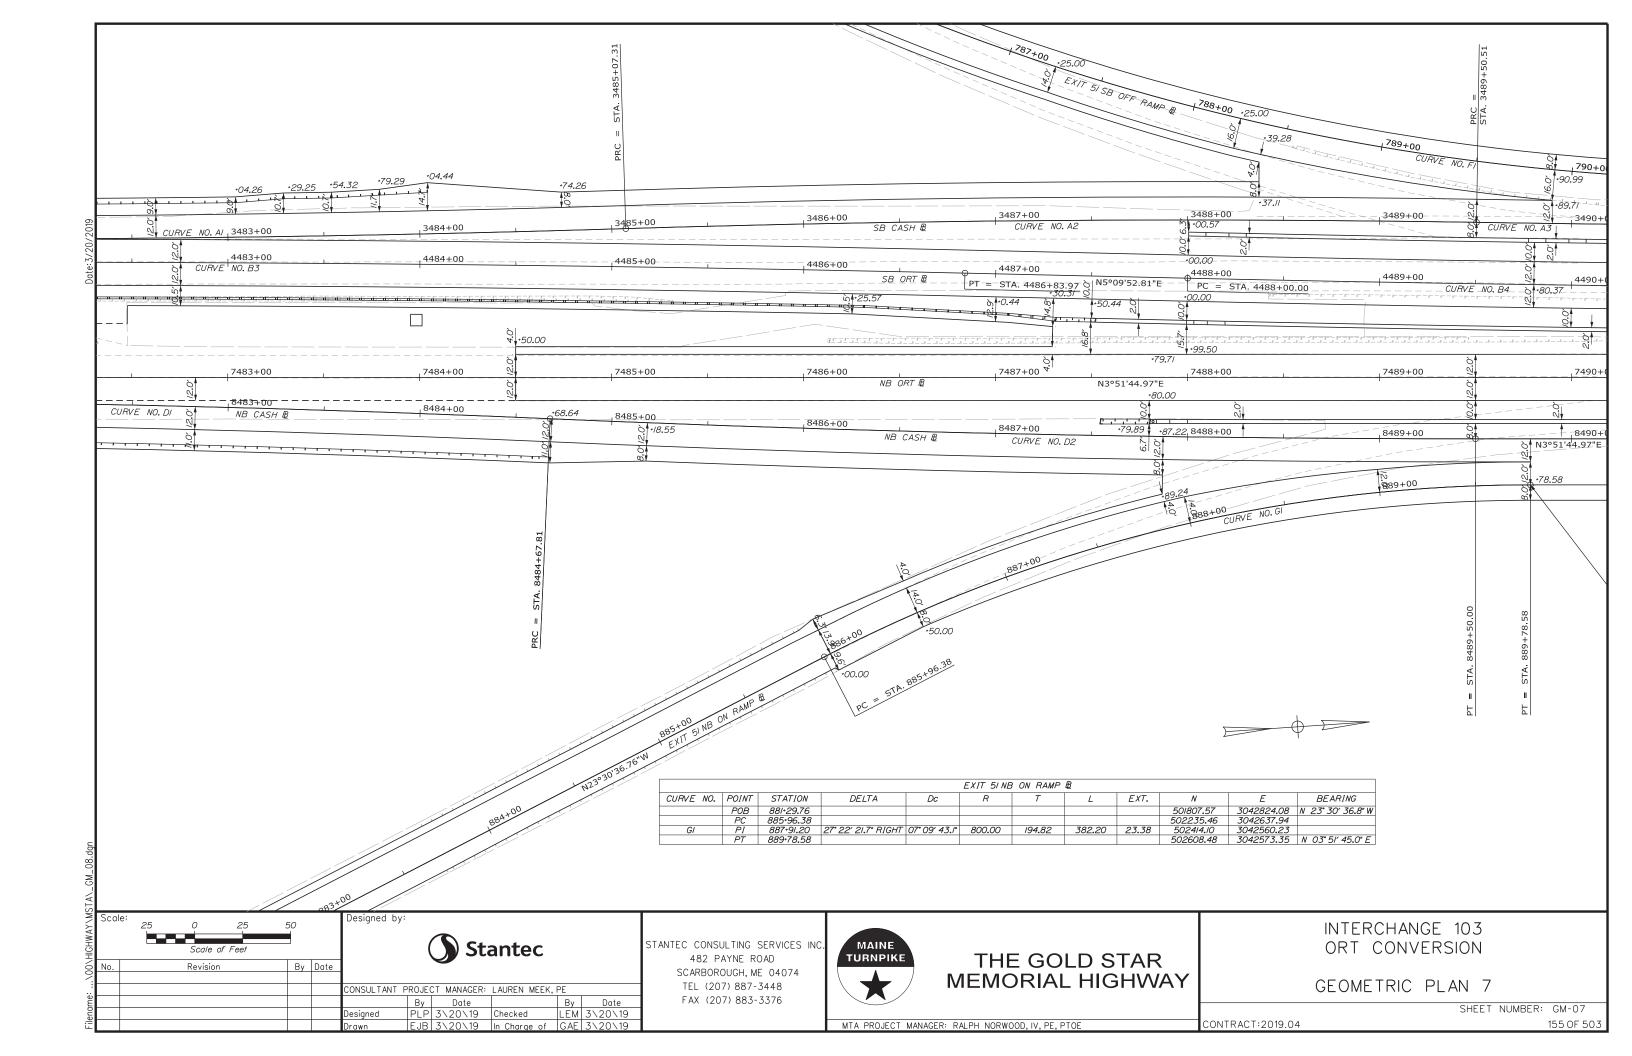


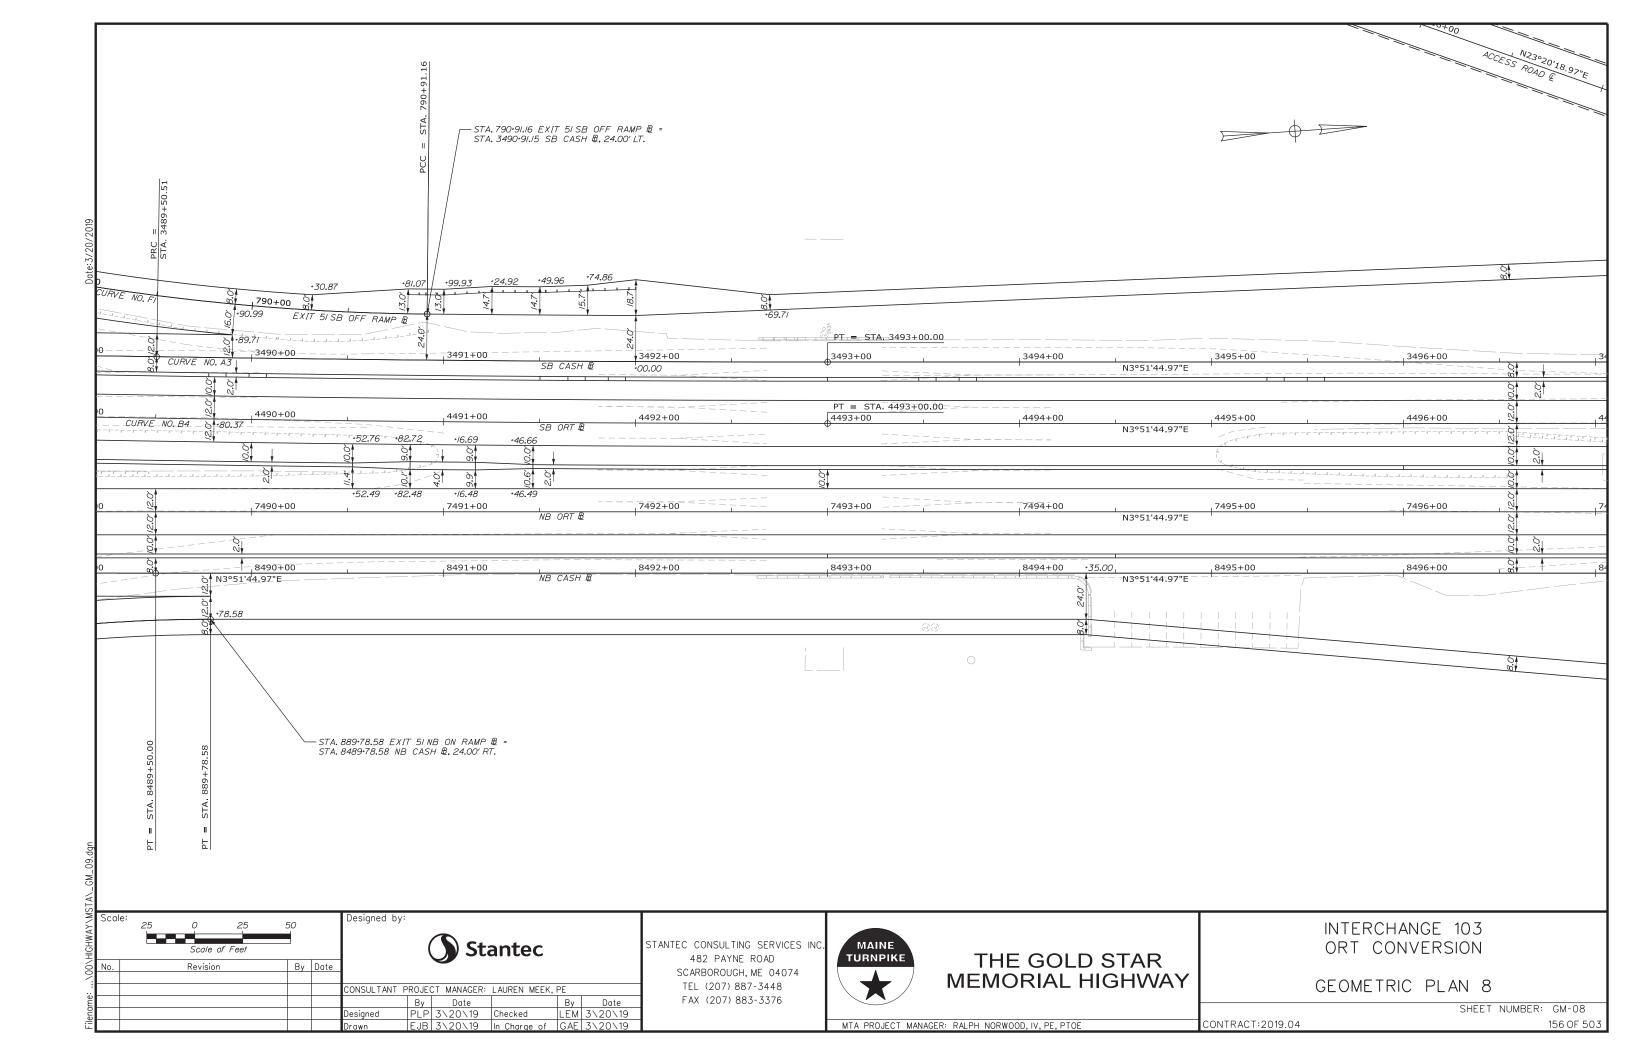


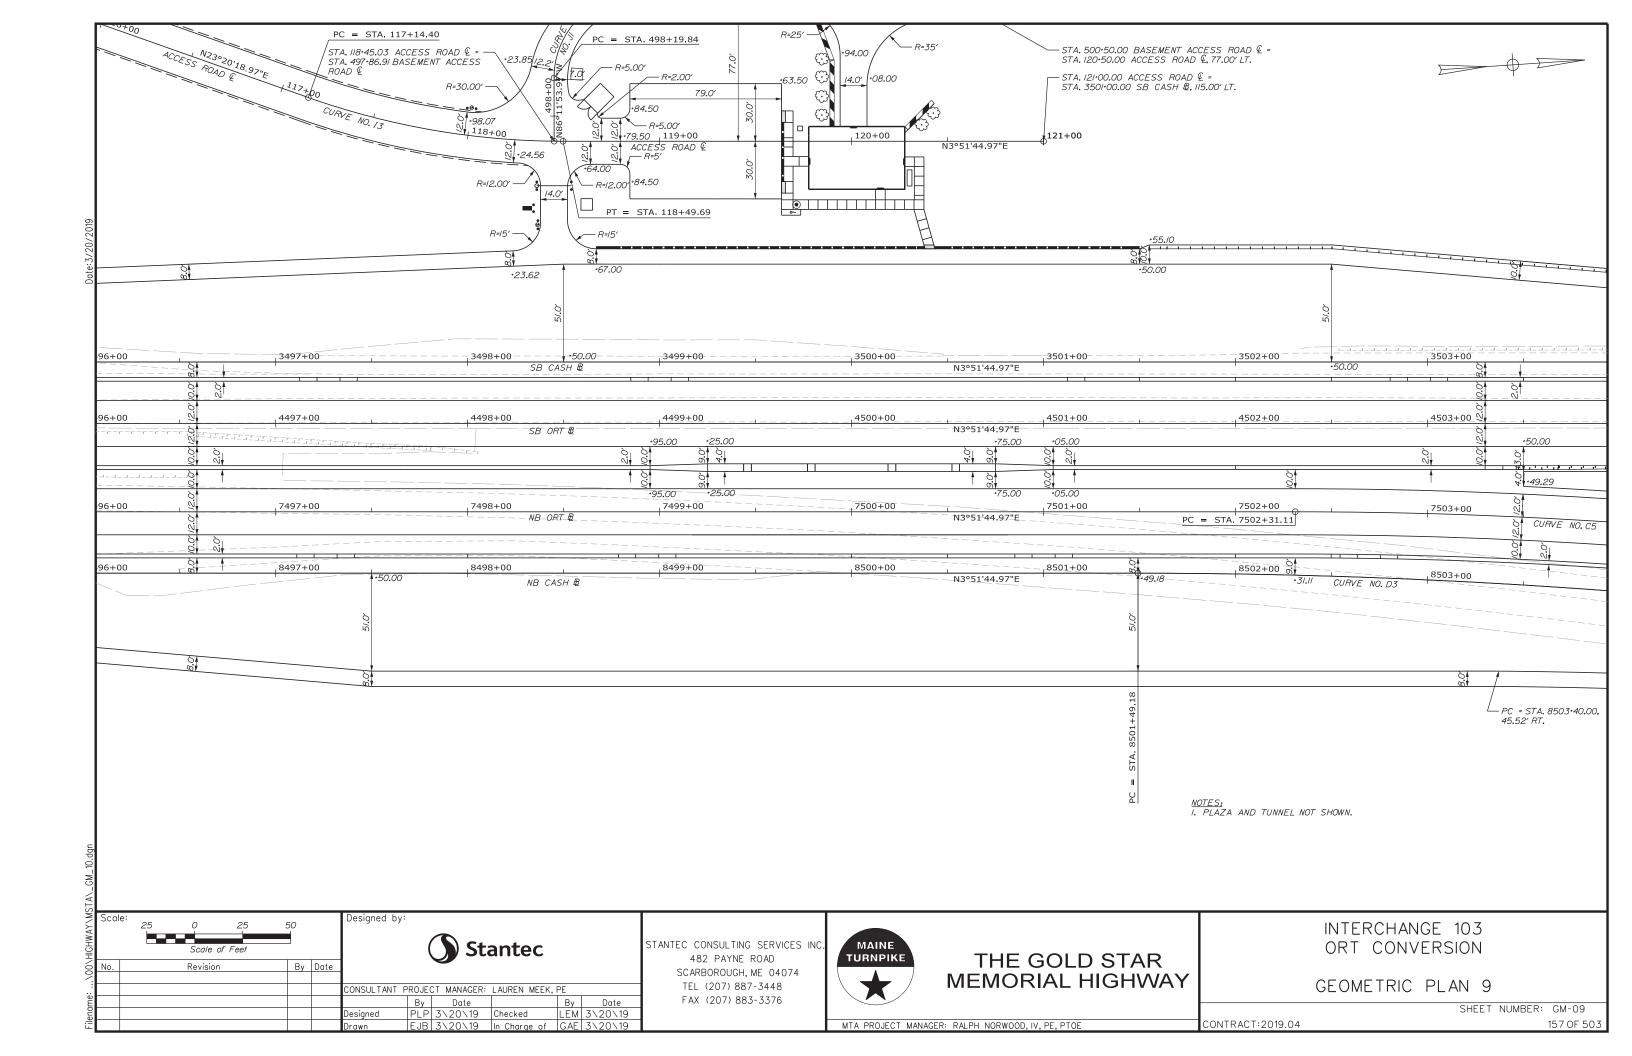


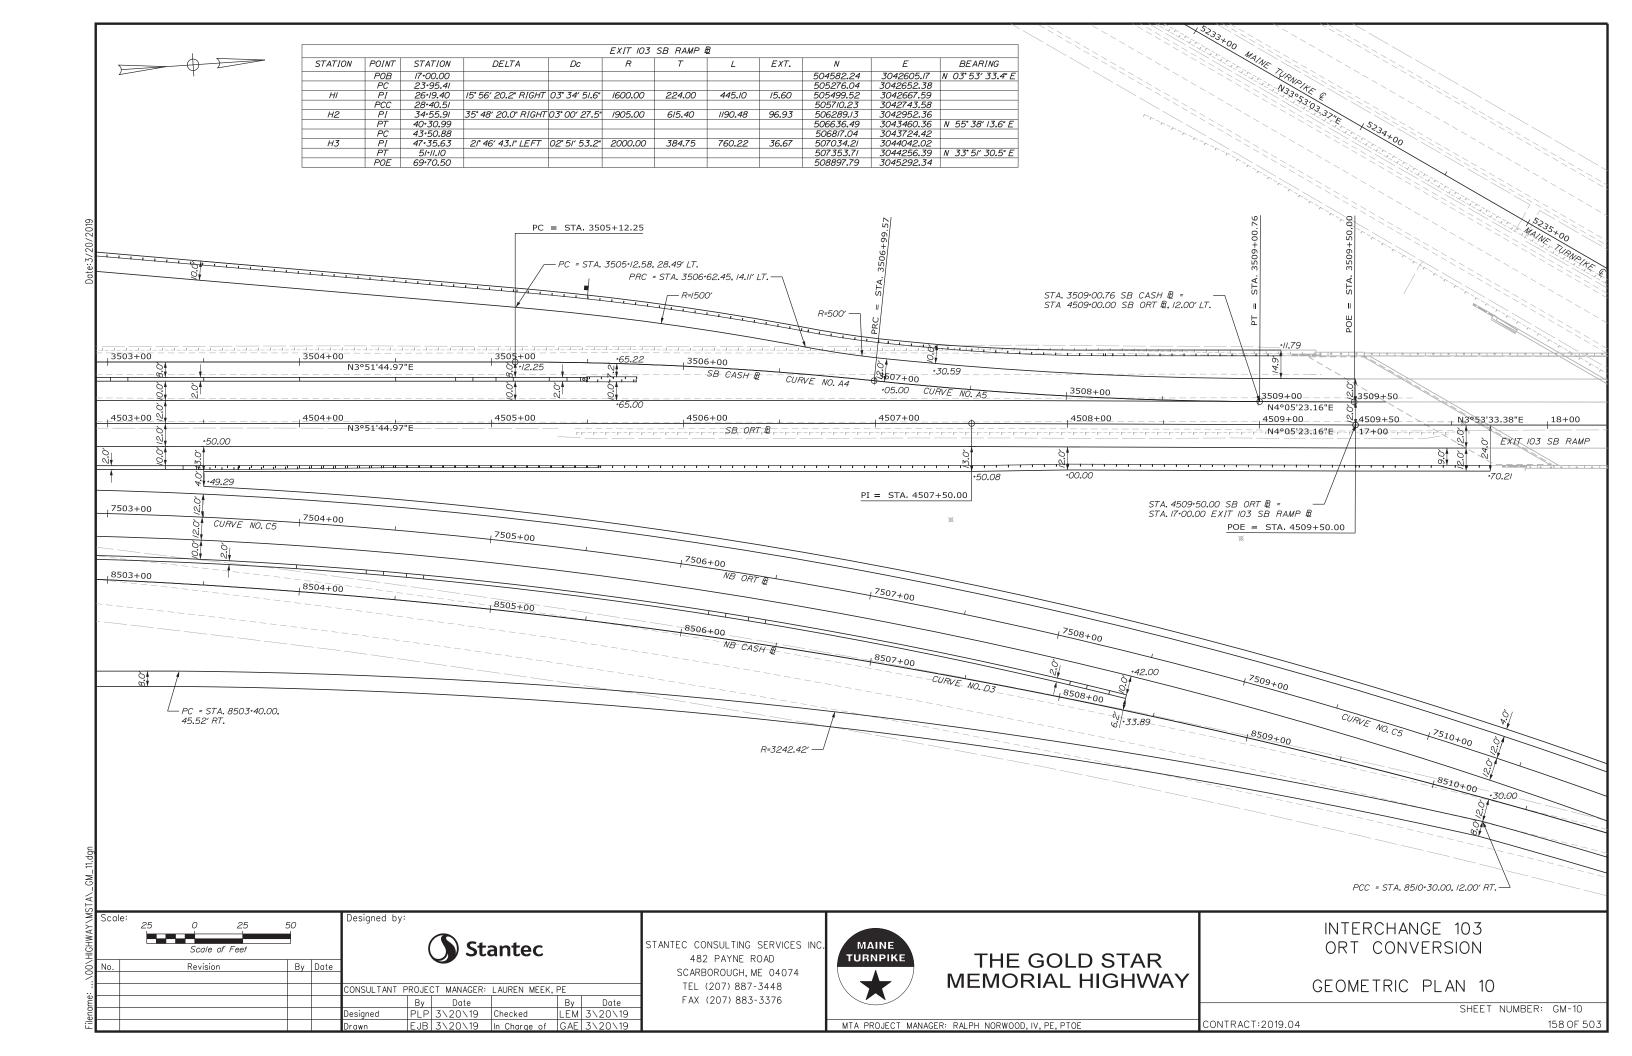


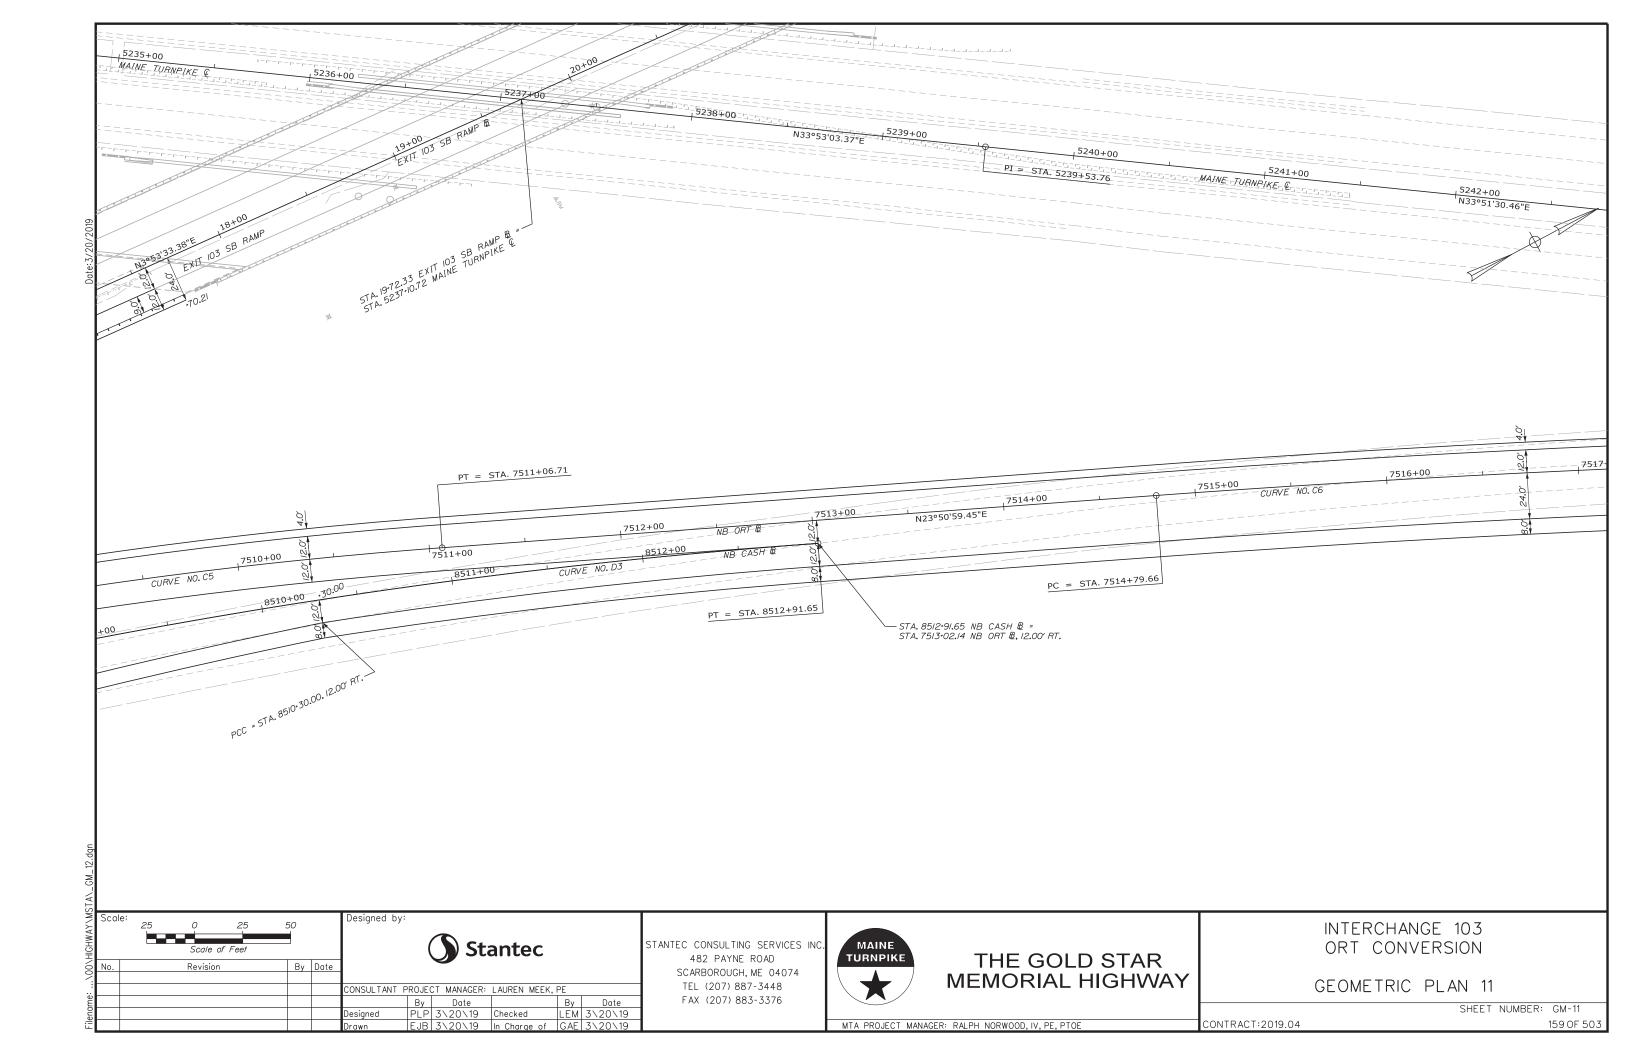


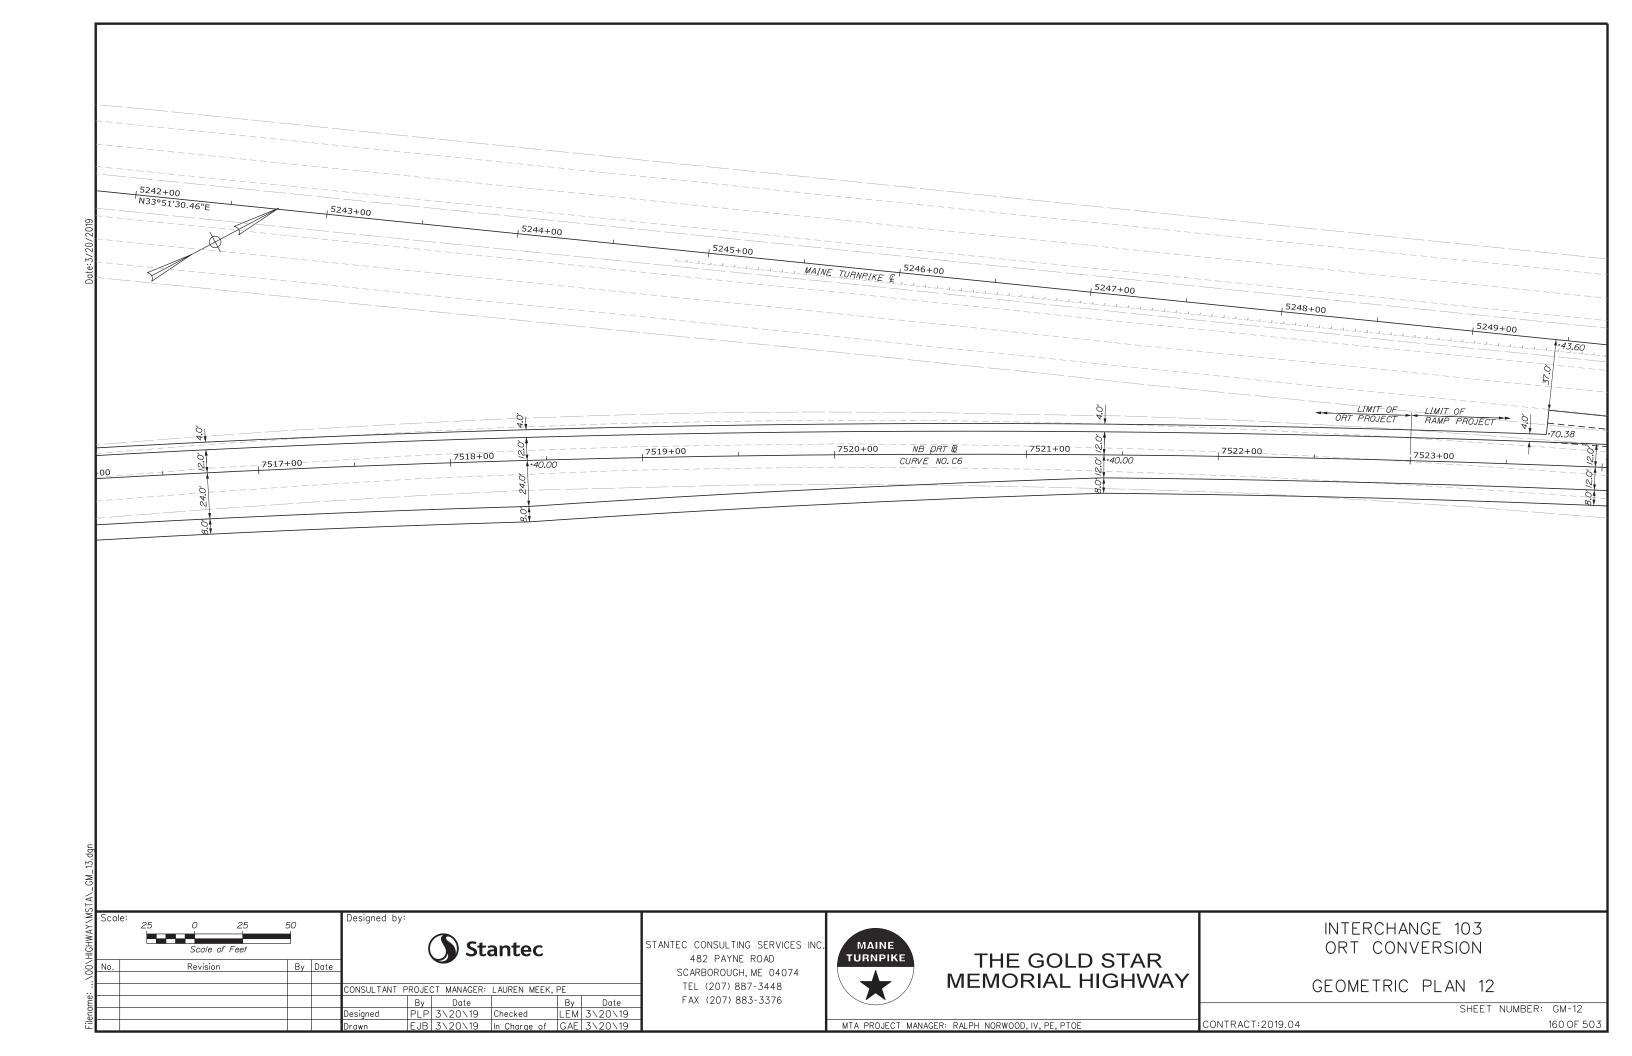


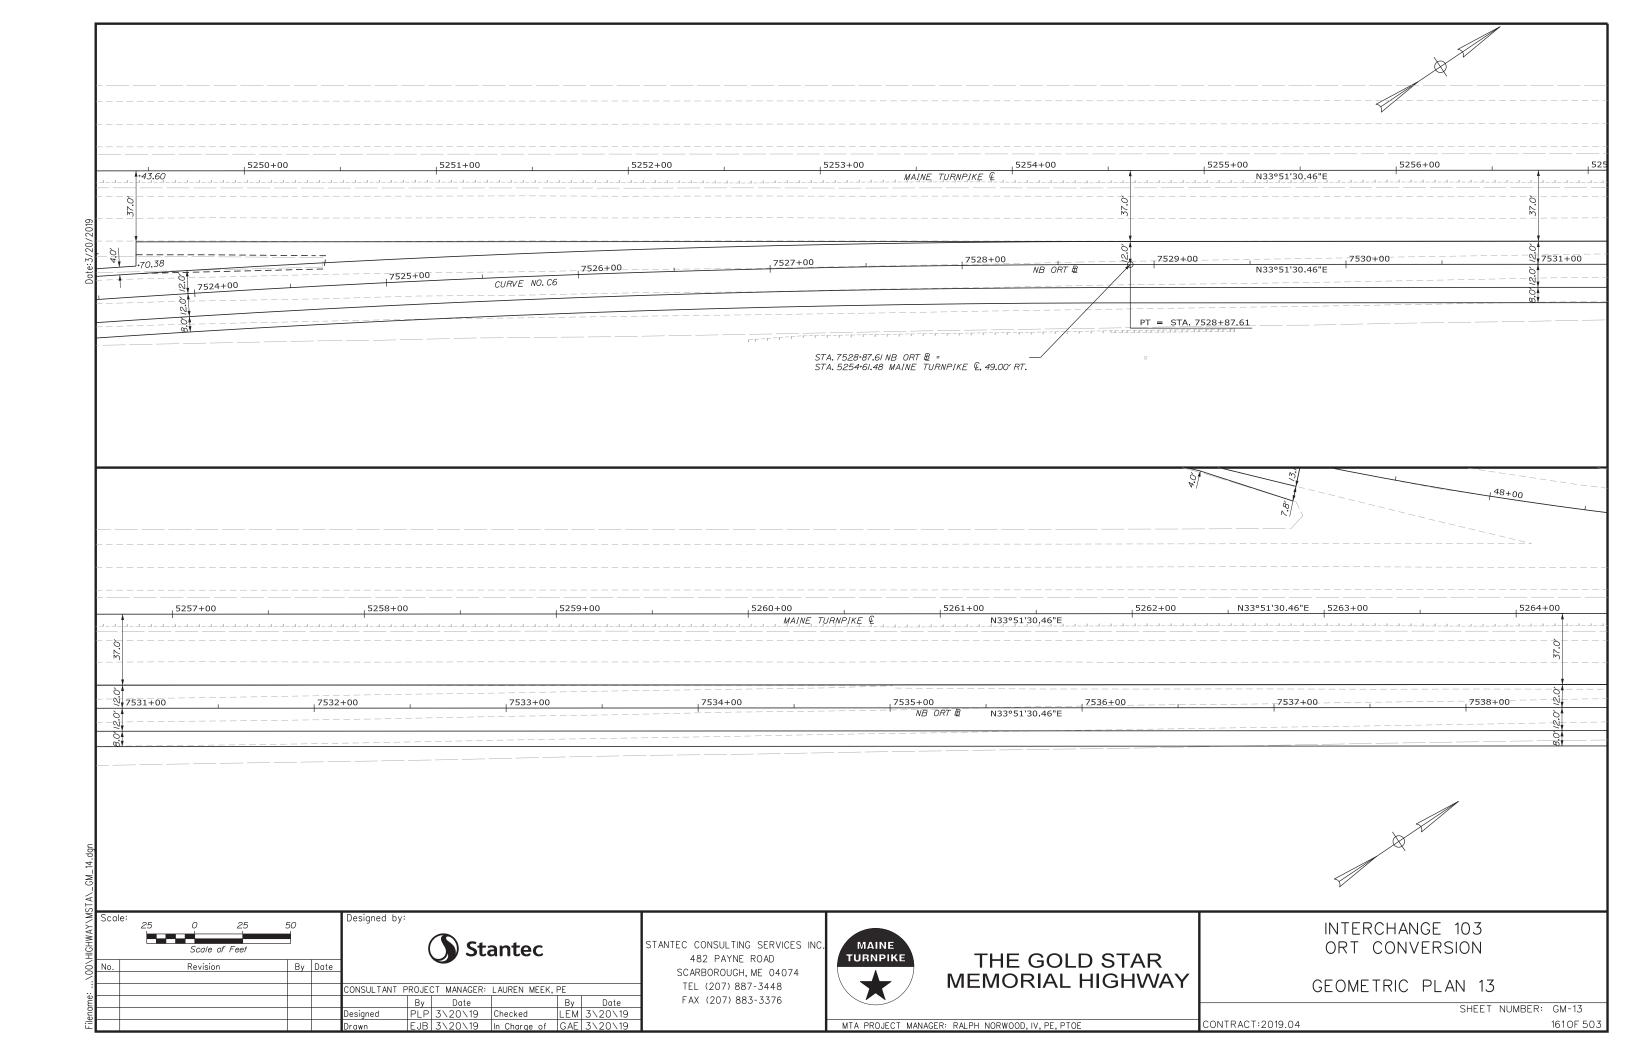

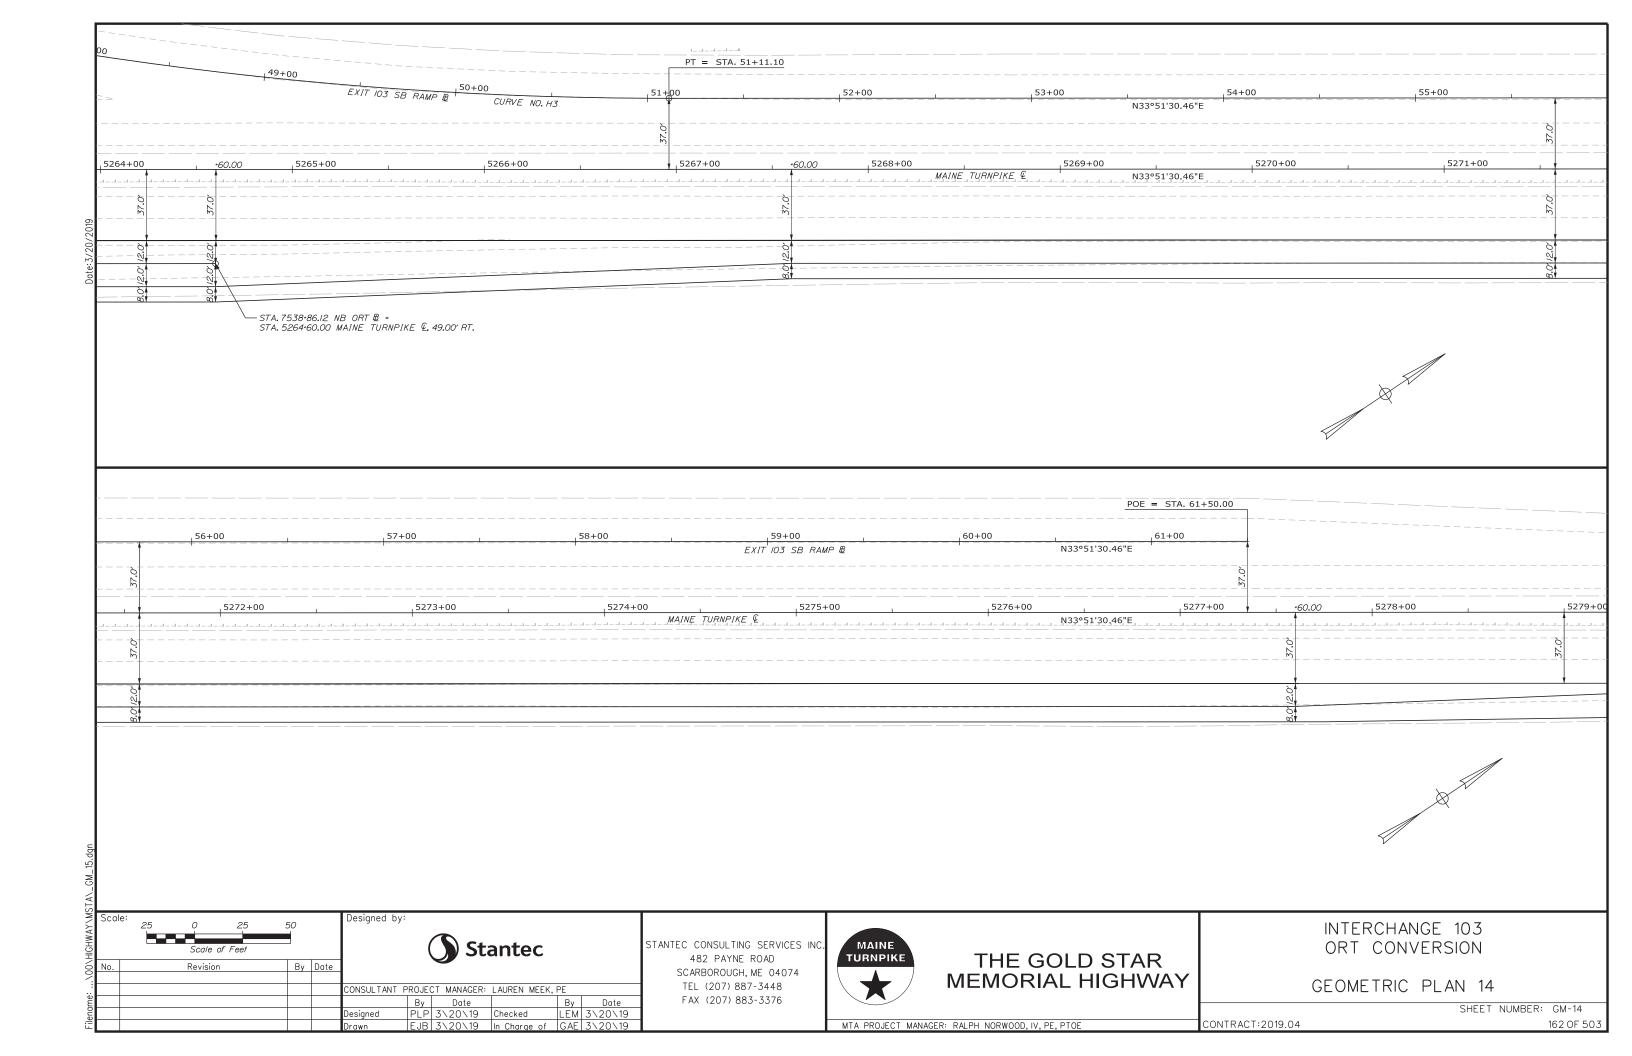

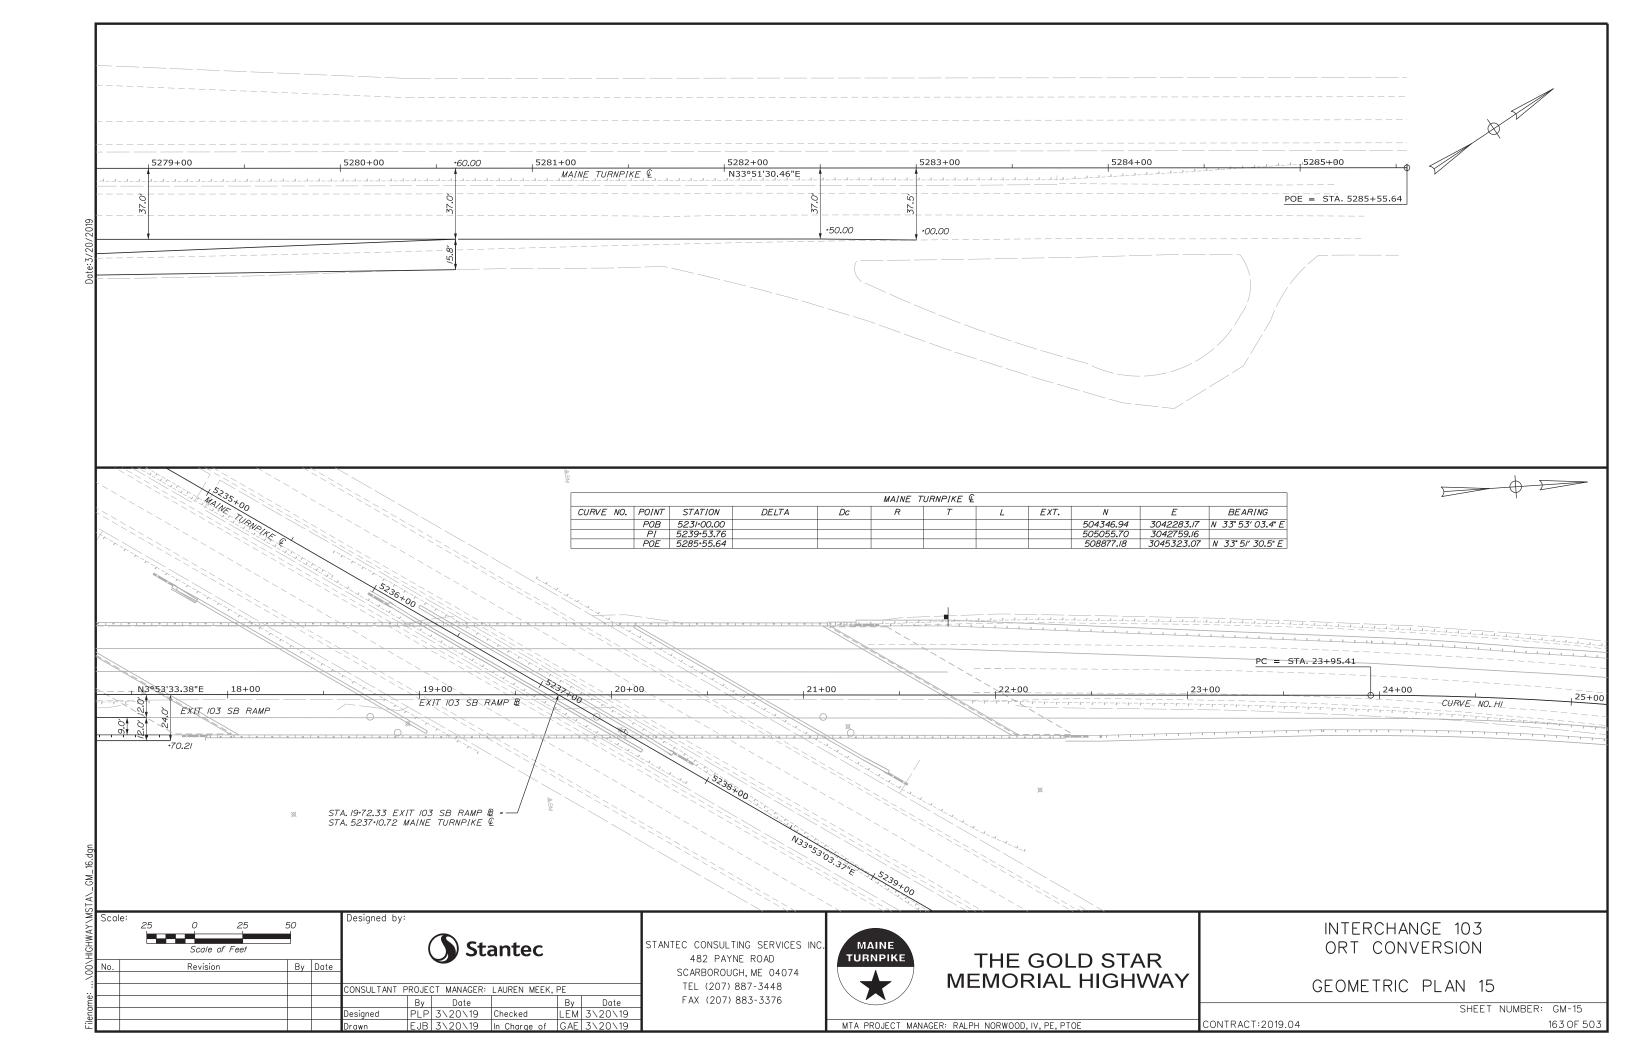

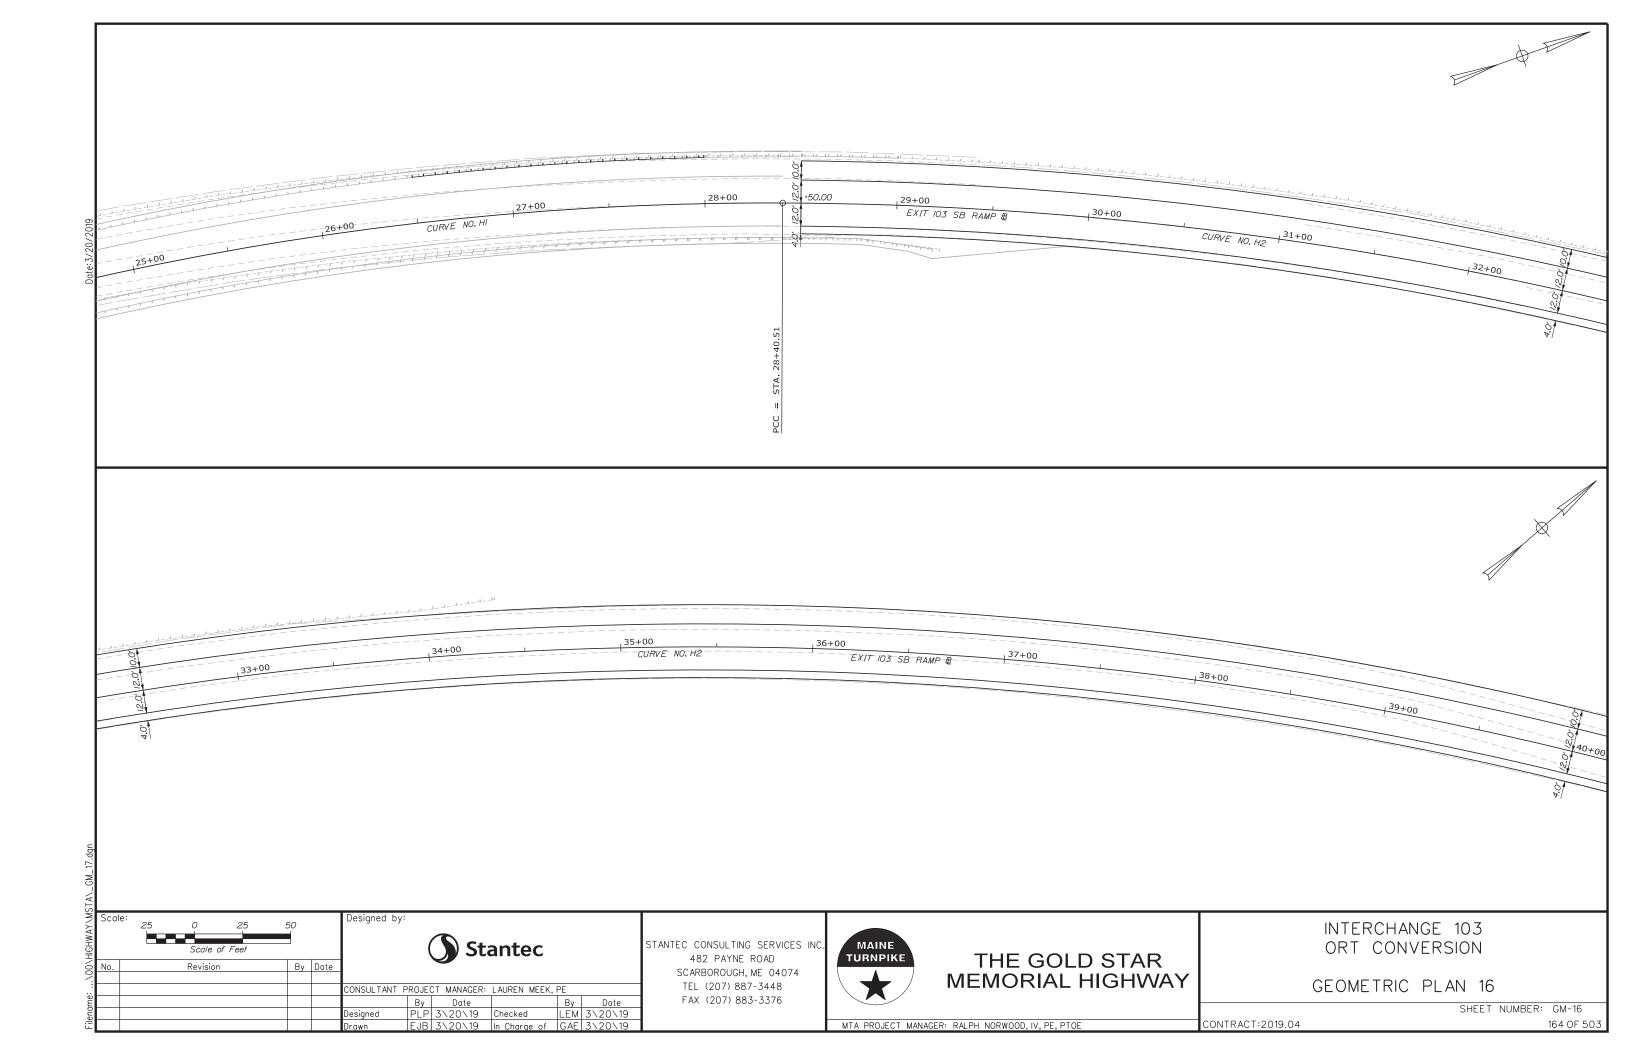

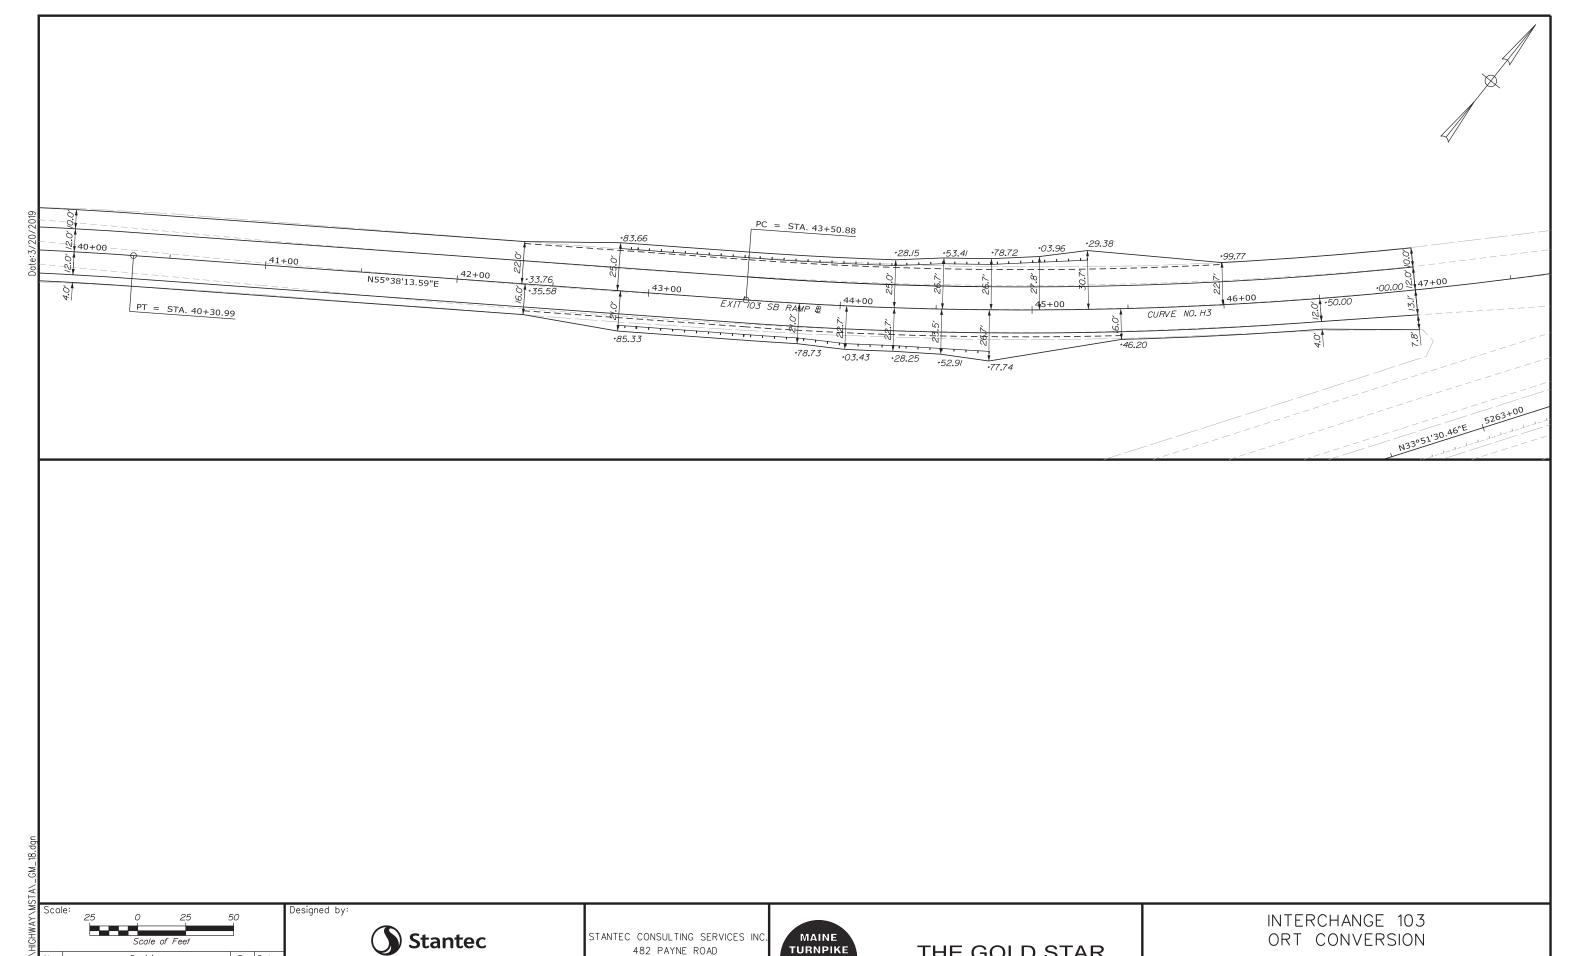

ONSULTANT PROJECT MANAGER: LAUREN MEEK, PE
 By
 Date
 By
 Date

 PLP 3\20\19
 Checked
 LEM 3\20\19

 EJB 3\20\19
 In Charge of GAE 3\20\19

STANTEC CONSULTING SERVICES INC 482 PAYNE ROAD SCARBOROUGH, ME 04074 TEL (207) 887-3448 FAX (207) 883-3376




MTA PROJECT MANAGER: RALPH NORWOOD, IV, PE, PTOE


THE GOLD STAR MEMORIAL HIGHWAY


ORT CONVERSION


GEOMETRIC PLAN 17


SHEET NUMBER: GM-17 CONTRACT:2019.04

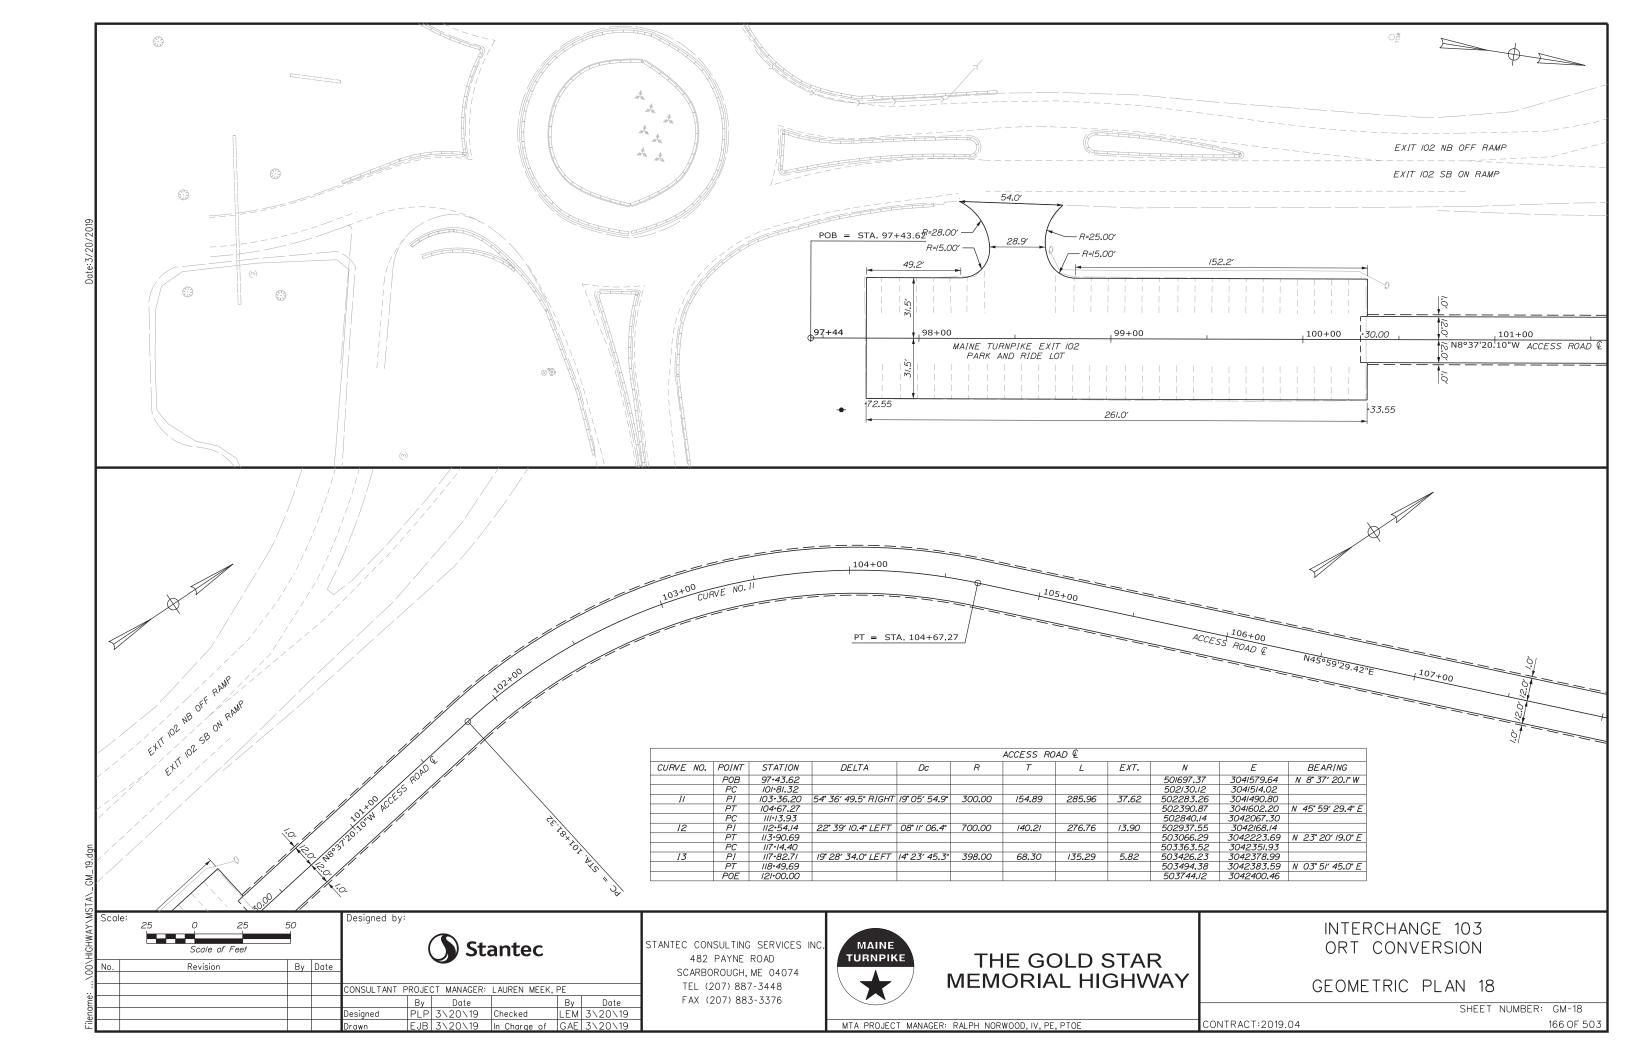


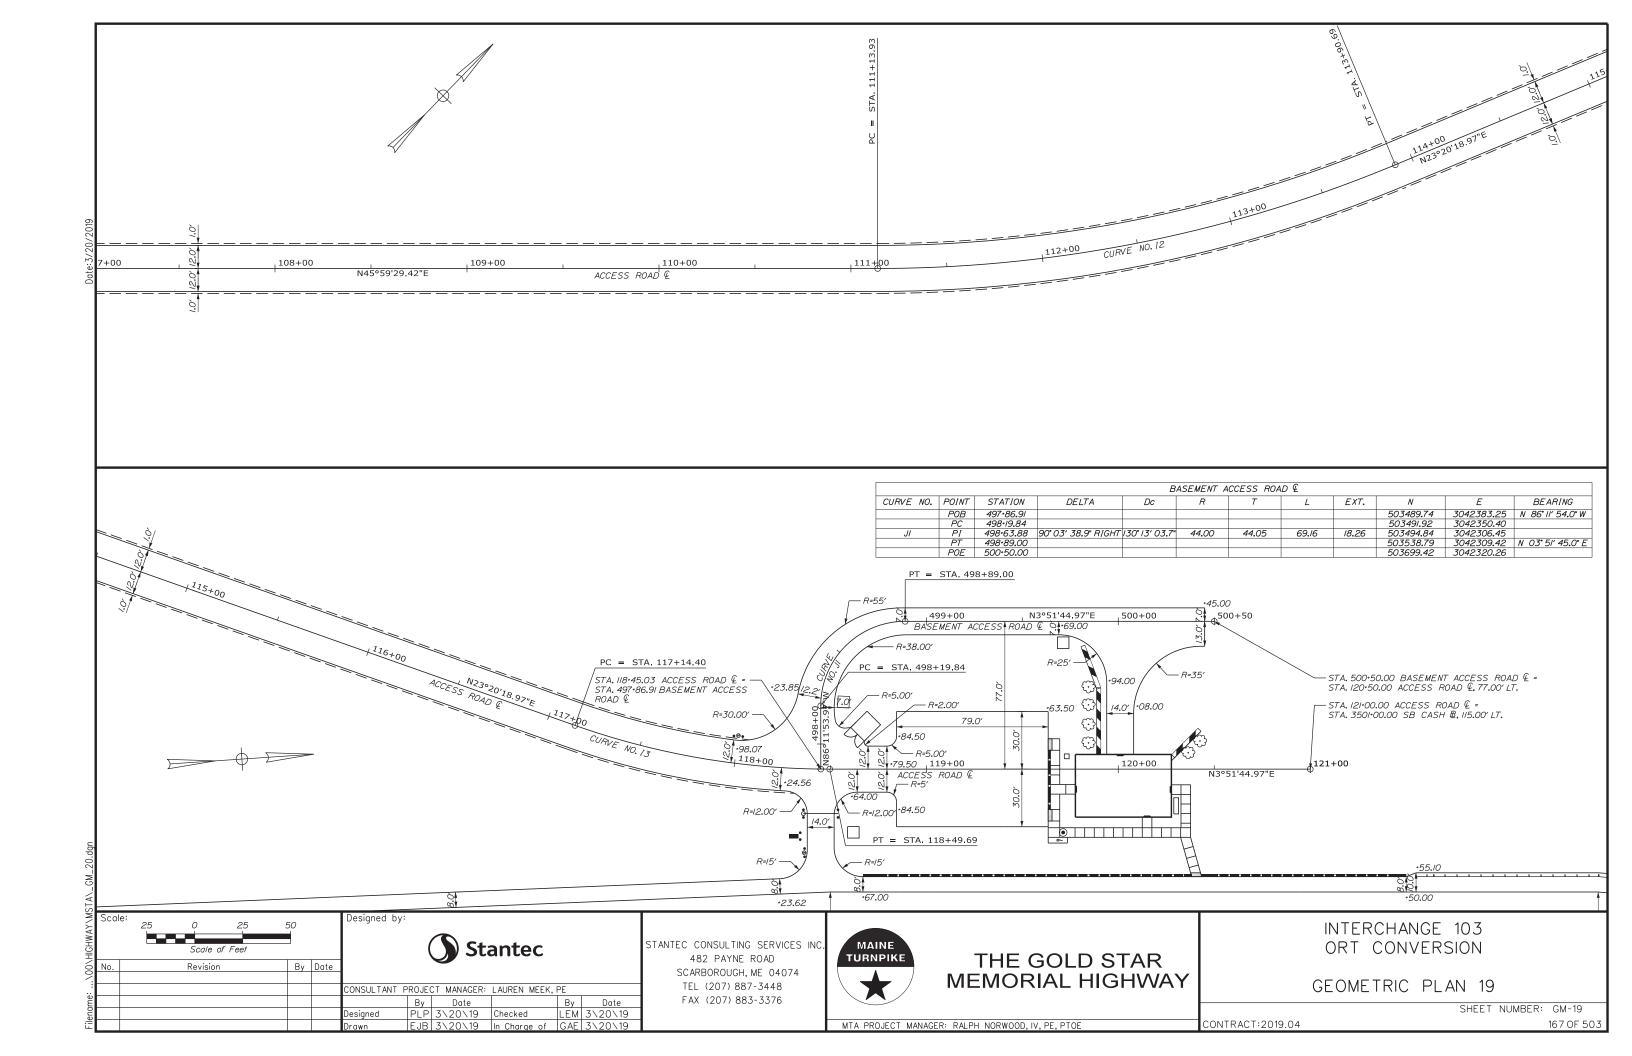

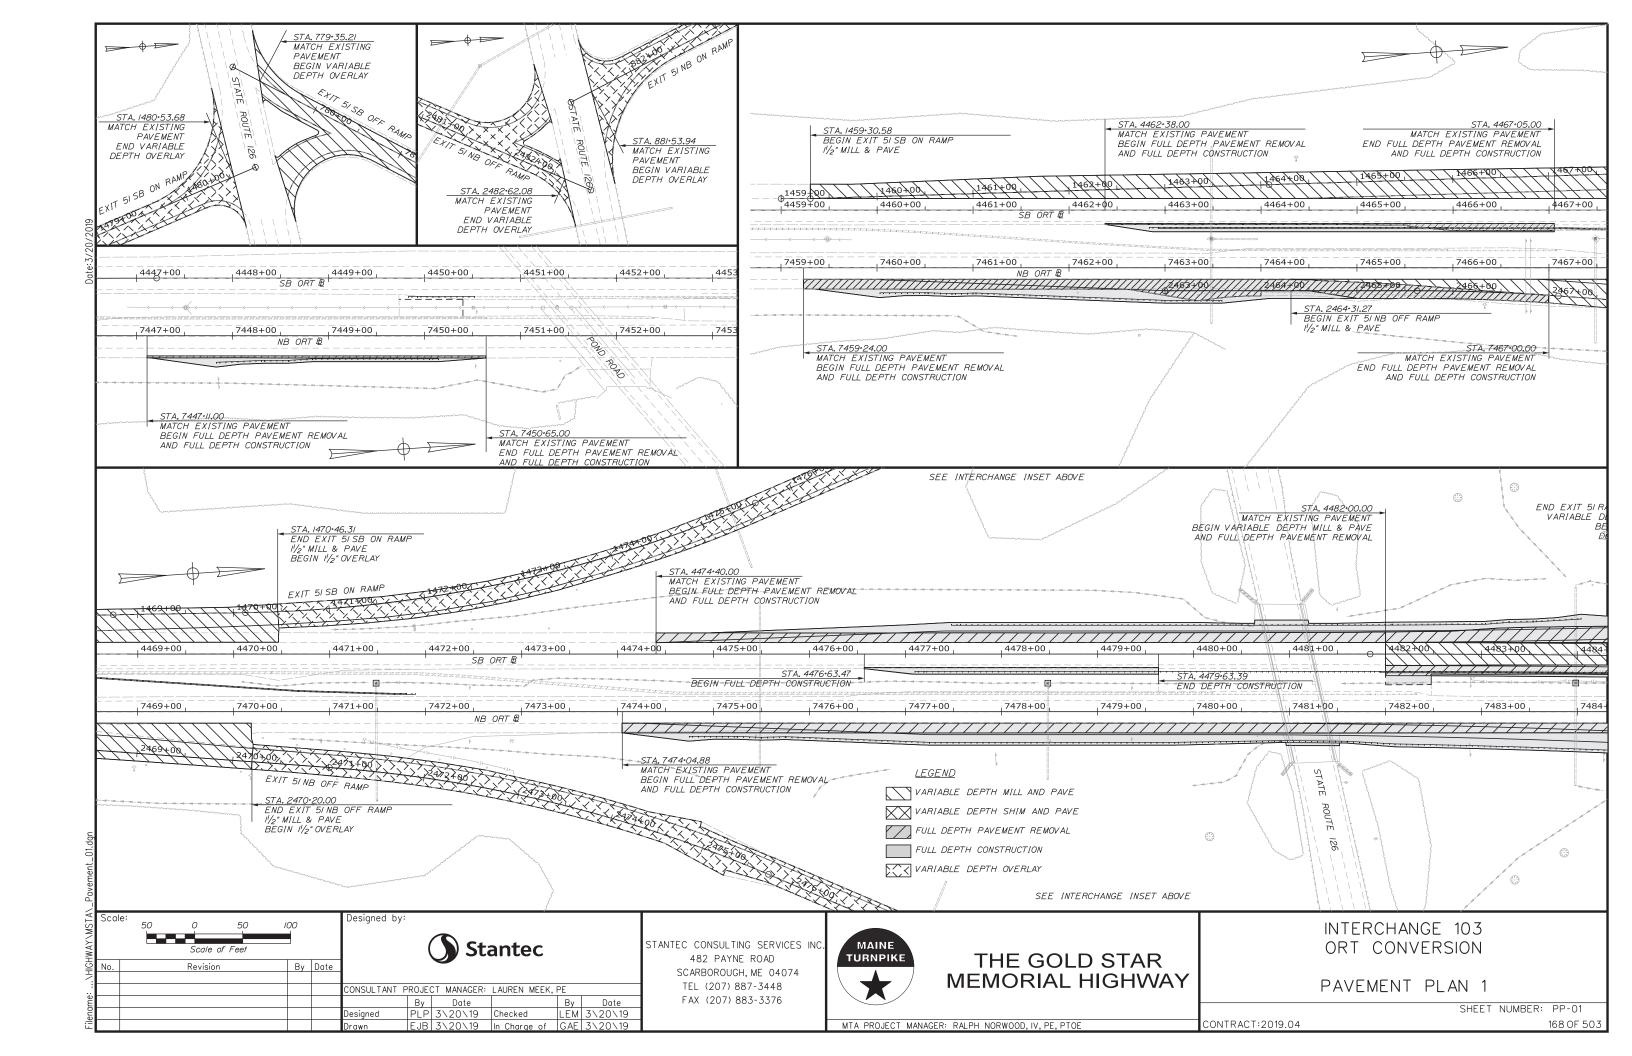

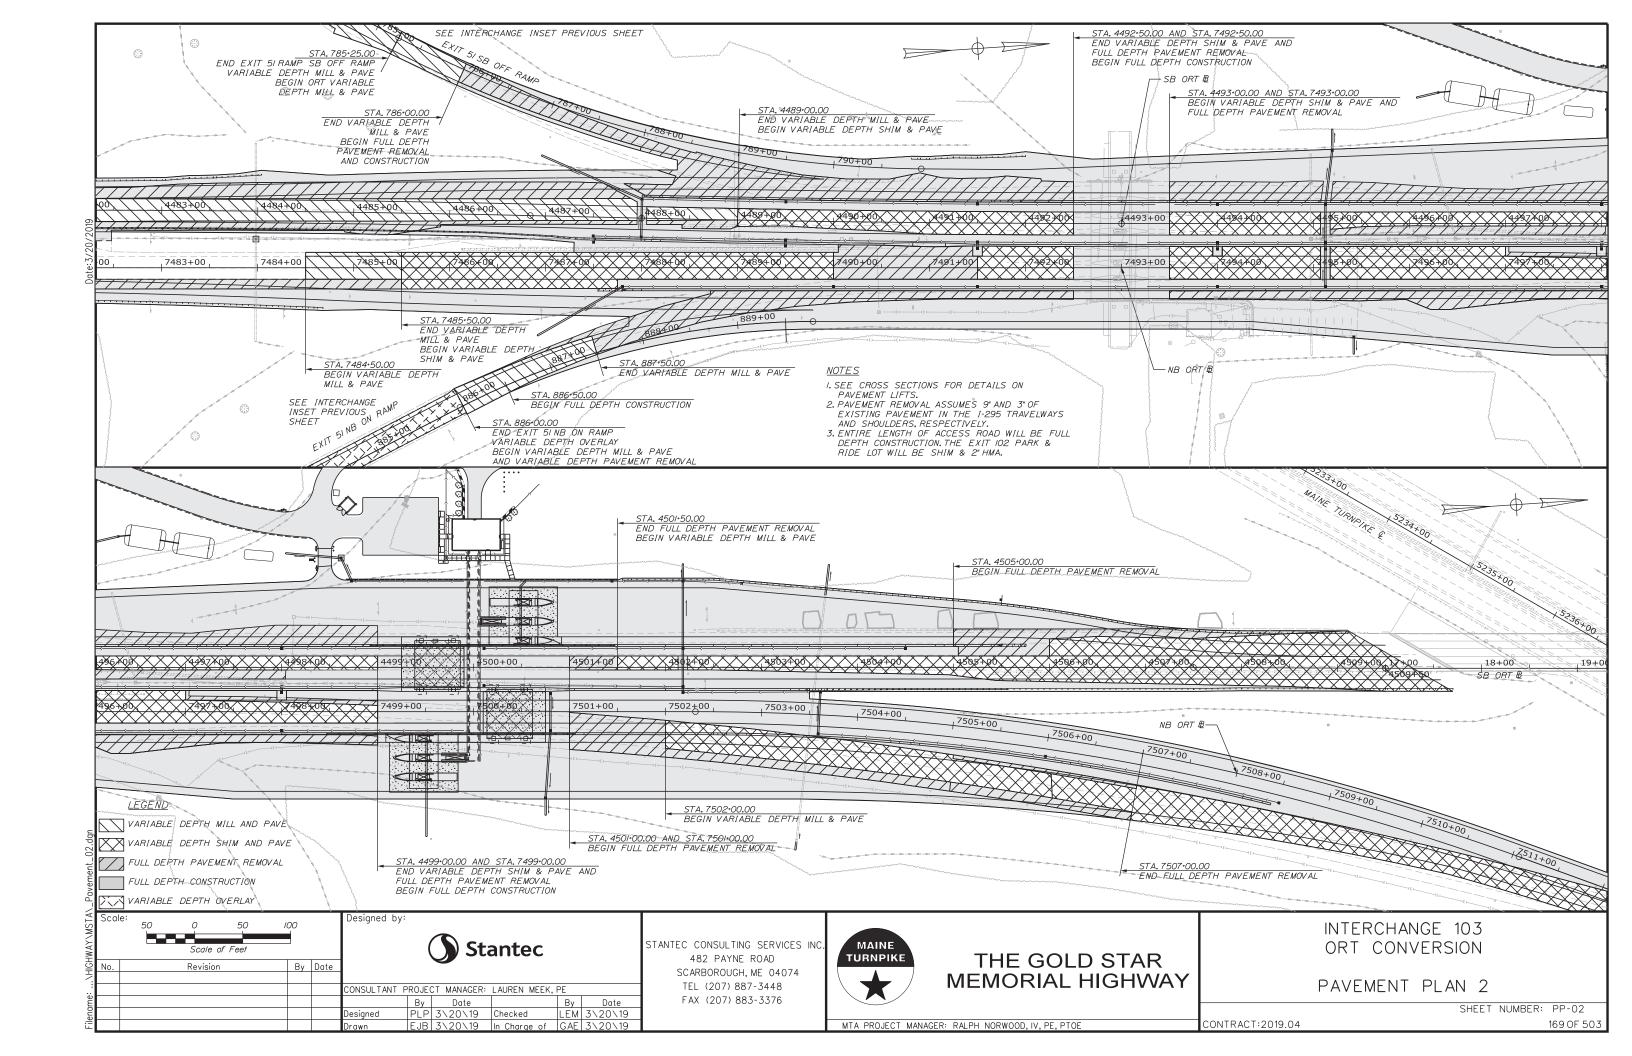

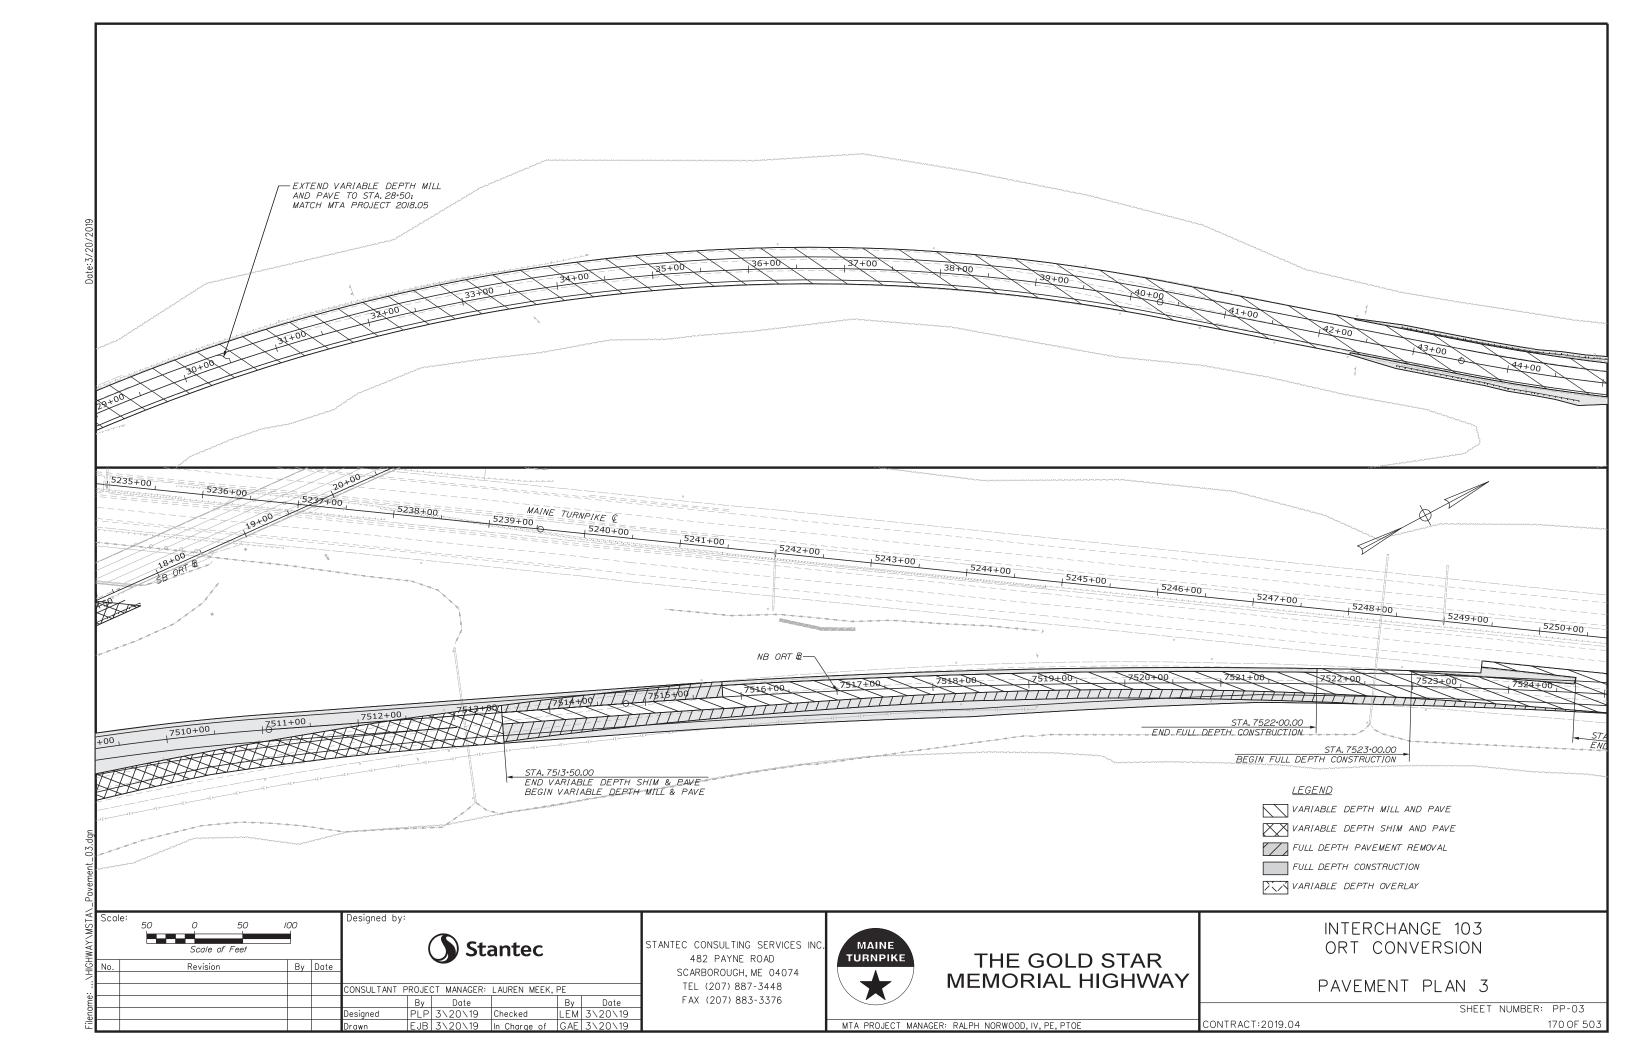


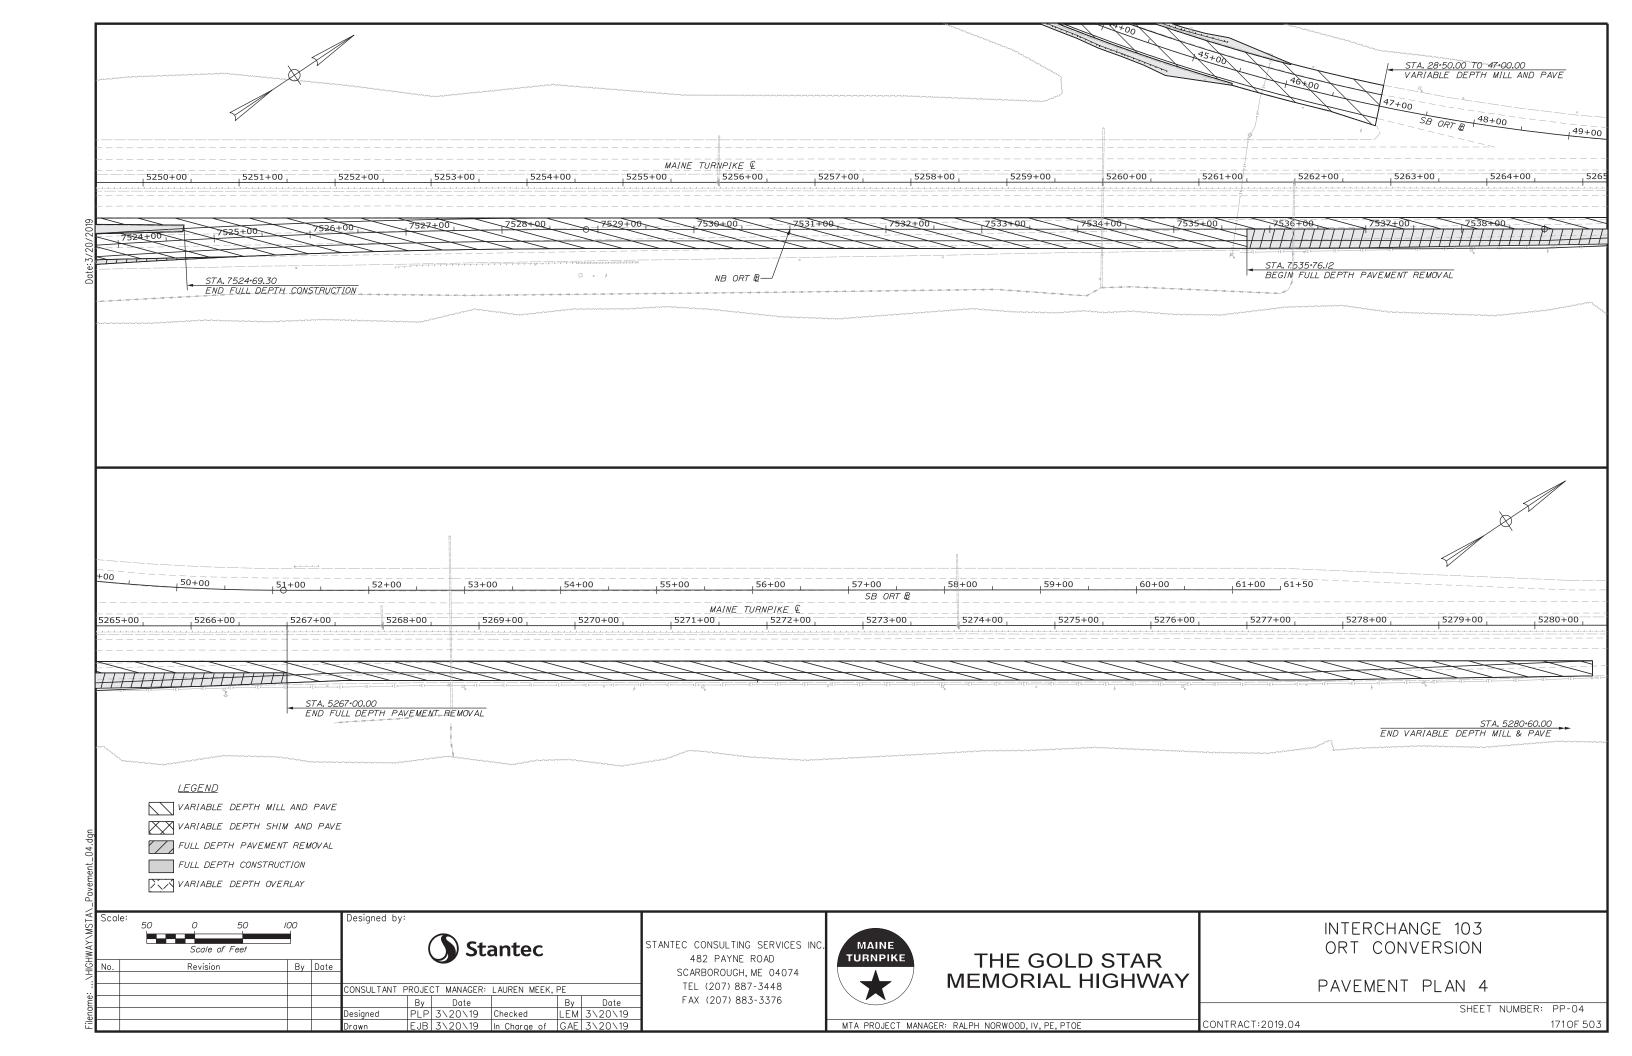



G©RRILL

ONSULTANT PROJECT MANAGER: BRANDON M. HAVU, PE

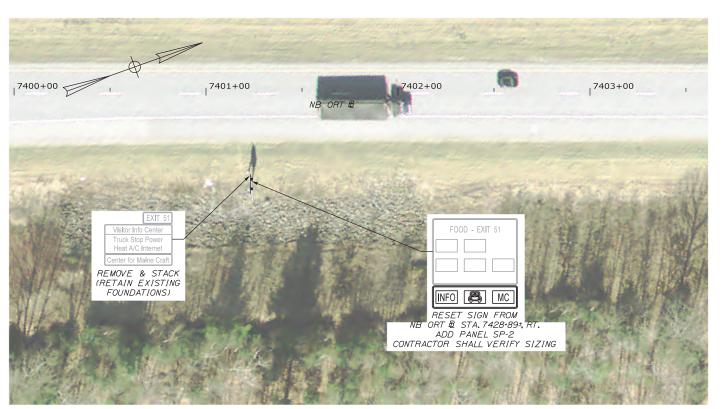


ORT CONVERSION

SIGNING AND STRIPING PLAN 1

CONTRACT:2019.04

SHEET NUMBER: SS-01

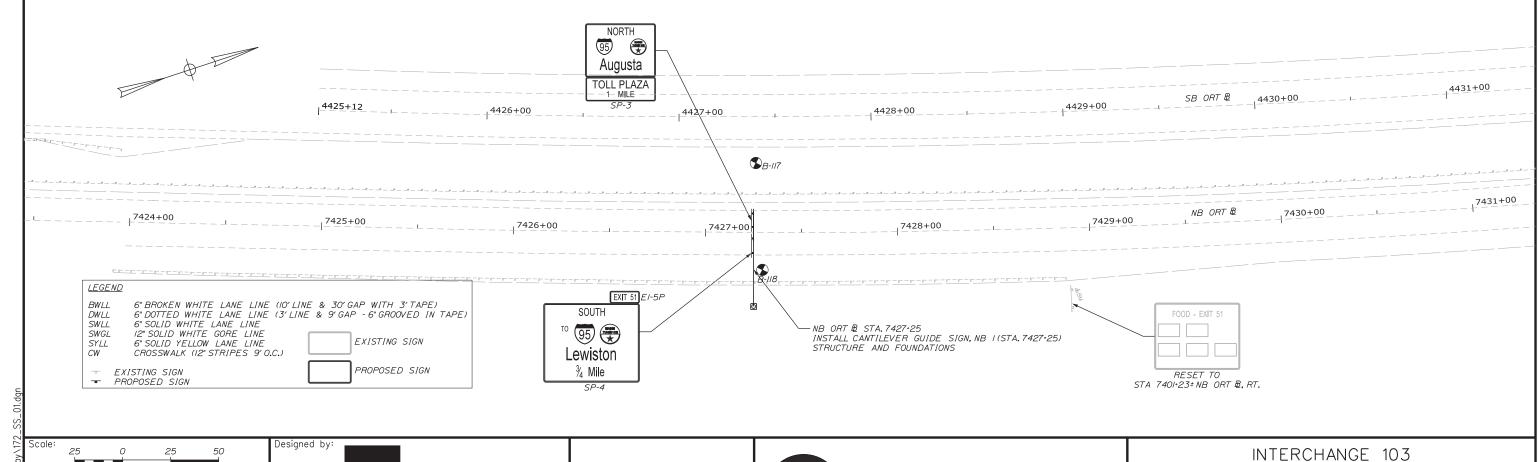

MAINE TURNPIKE

MTA PROJECT MANAGER: RALPH C. NORWOOD, IV, PE, PTOE


THE GOLD STAR

MEMORIAL HIGHWAY

GORRILL PALMER

707 SABLE OAKS DRIVE, SUITE 30 SOUTH PORTLAND, MAINE 04106

www.gorrillpalmer.com 207.772.2515

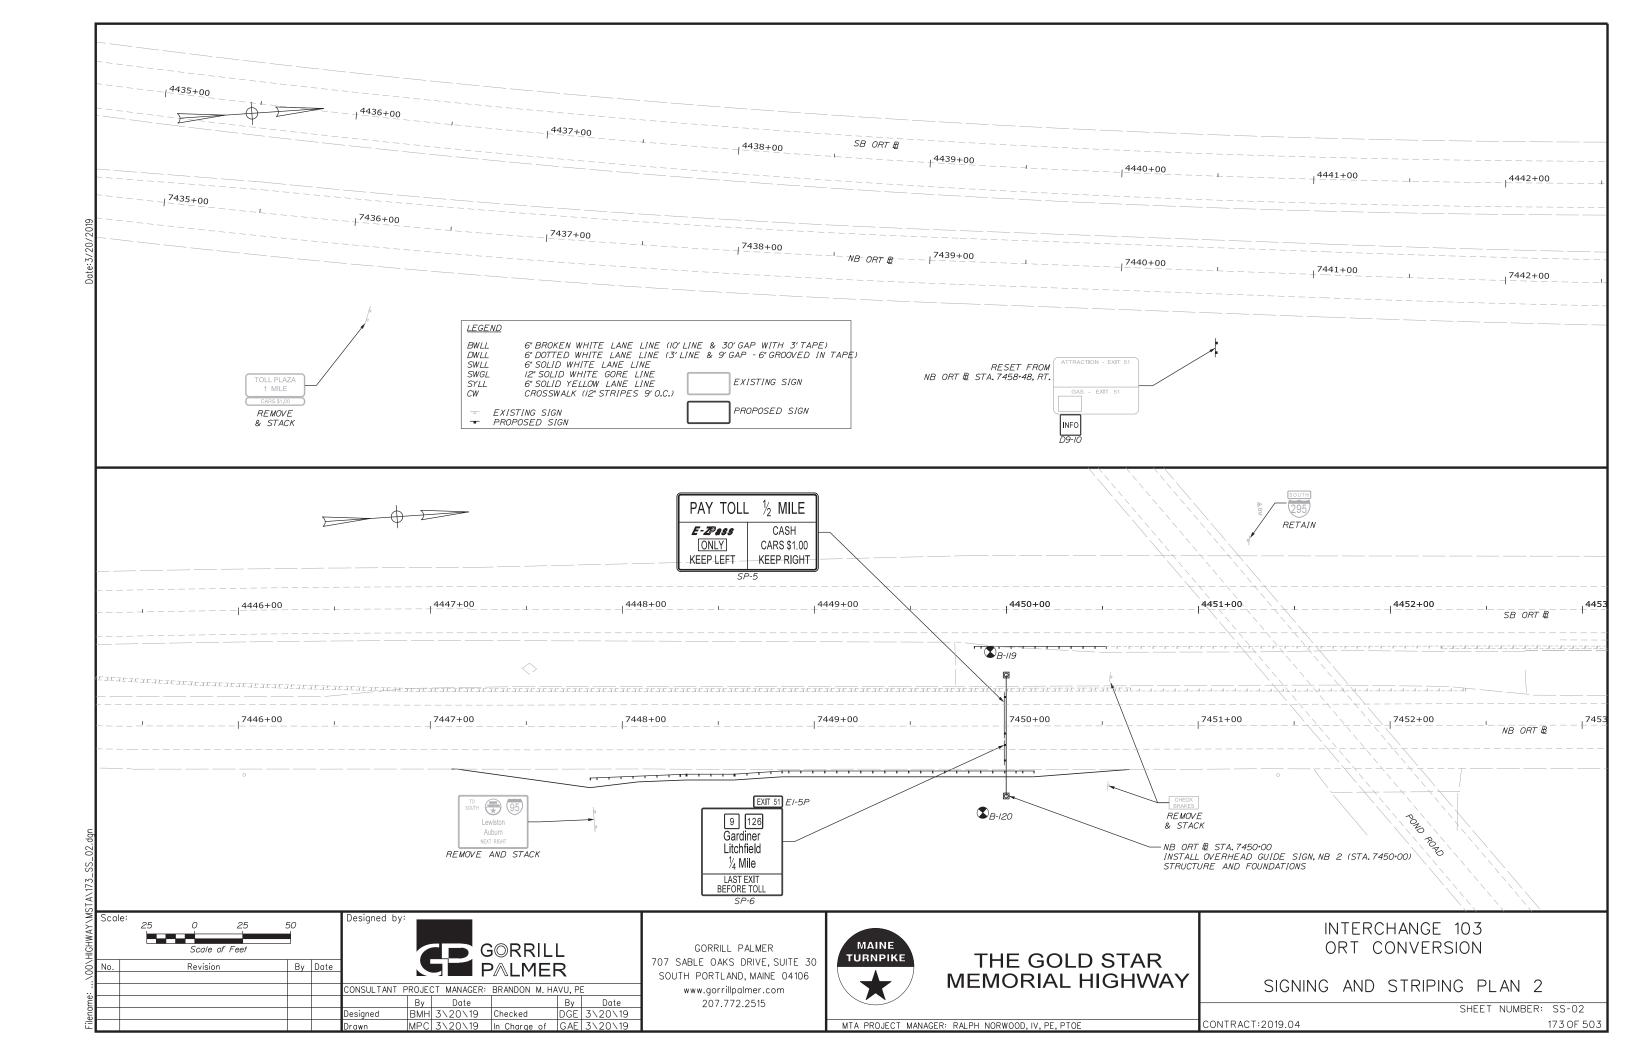



RESET FROM SB CASH & STA. 3487+12, LT.

					1459+00 9 BEGIN SWLL	1460+00	SWLL 1461+00	1462+00
4455+00		4457+00	SB ORT ₩ -	EXIST. SWLL EXIST. BWLL EXIST. SYLL	######################################	4460+00	DWLL 4461+00	4462+00
					<u> </u>			
7455+00	7456+00	7457+00		EXIST. SYLL EXIST. BWLL EXIST. SWLL	7459+00	7460+00 10 00.00 MATCH EXIST. BEGIN SWILL	7461+00	7462+00
								SWLL
			ATTRACTION - EXIT 51) - -				

<u>NOTES</u>

- 1. PAVEMENT MARKINGS SHALL BE IN ACCORDANCE WITH MUTCD.
 2. SEE GEOMETRIC PLANS FOR DIMENSIONS ON PAVEMENT MARKINGS.
 3. THE CONTRACTOR SHALL BE RESPONSIBLE FOR MILLING A GROOVE IN THE PAVEMENT FOR EACH TAPE LENGTH OF THE DOTTED WHITE LANE LINE (DWLL), MILLING SHALL BE INCIDENTAL TO THE PAVEMENT MARKING TAPE.

LEGEND		
BWLL	6" BROKEN WHITE LANE L	INE (IO'LINE & 30'GAP WITH 3'TAPE)
DWLL	6" DOTTED WHITE LANE L	INE (3'LINE & 9'GAP -6"GROOVED IN TAPE
SWLL	6" SOLID WHITE LANE LIN	IE
SWGL	12" SOLID WHITE GORE LI	
SYLL	6" SOLID YELLOW LANE LI	NE EXISTING SIGN
CW	CROSSWALK (12" STRIPES	9' O.C.)
- EX	(ISTING SIGN	PROPOSED SIGN
PR	ROPOSED SIGN	

HIGHWAY	Scale of Feet				G©RRILL					
No.	Revision	Ву	Date	S PALMER						
					CONSULTANT PROJECT MANAGER: BRANDON M. HAVU, PE					
me					Ву	Date		Ву	Date	
ilename				Designed	ВМН	3\20\19	Checked	DGE	3\20\19	
Ē	·			Drawn	MPC	3\20\19	In Charge of	GAE	3\20\19	

Designed by:

GORRILL PALMER 707 SABLE OAKS DRIVE, SUITE 30 SOUTH PORTLAND, MAINE 04106 www.gorrillpalmer.com 207.772.2515

RESET TO NB ORT & STA.7440+50, RT.



THE GOLD STAR **MEMORIAL HIGHWAY**


INTERCHANGE 103 ORT CONVERSION


SIGNING AND STRIPING PLAN 3


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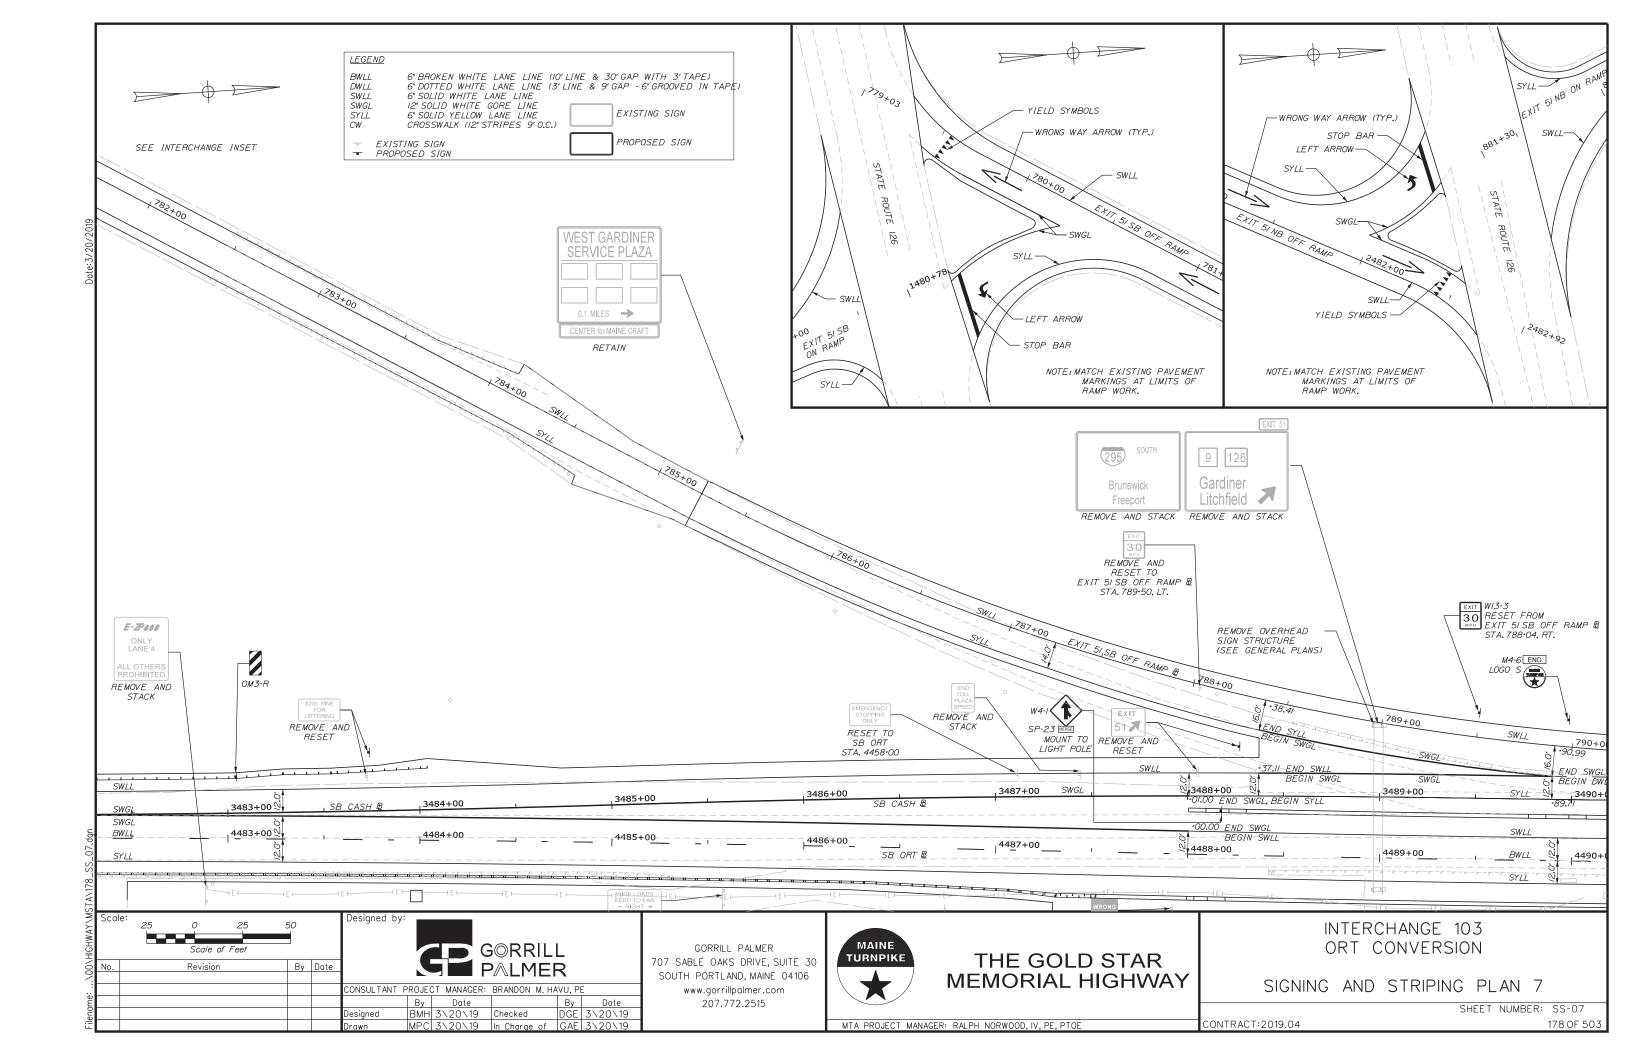
MTA PROJECT MANAGER: RALPH NORWOOD, IV, PE, PTOE


CONTRACT:2019.04




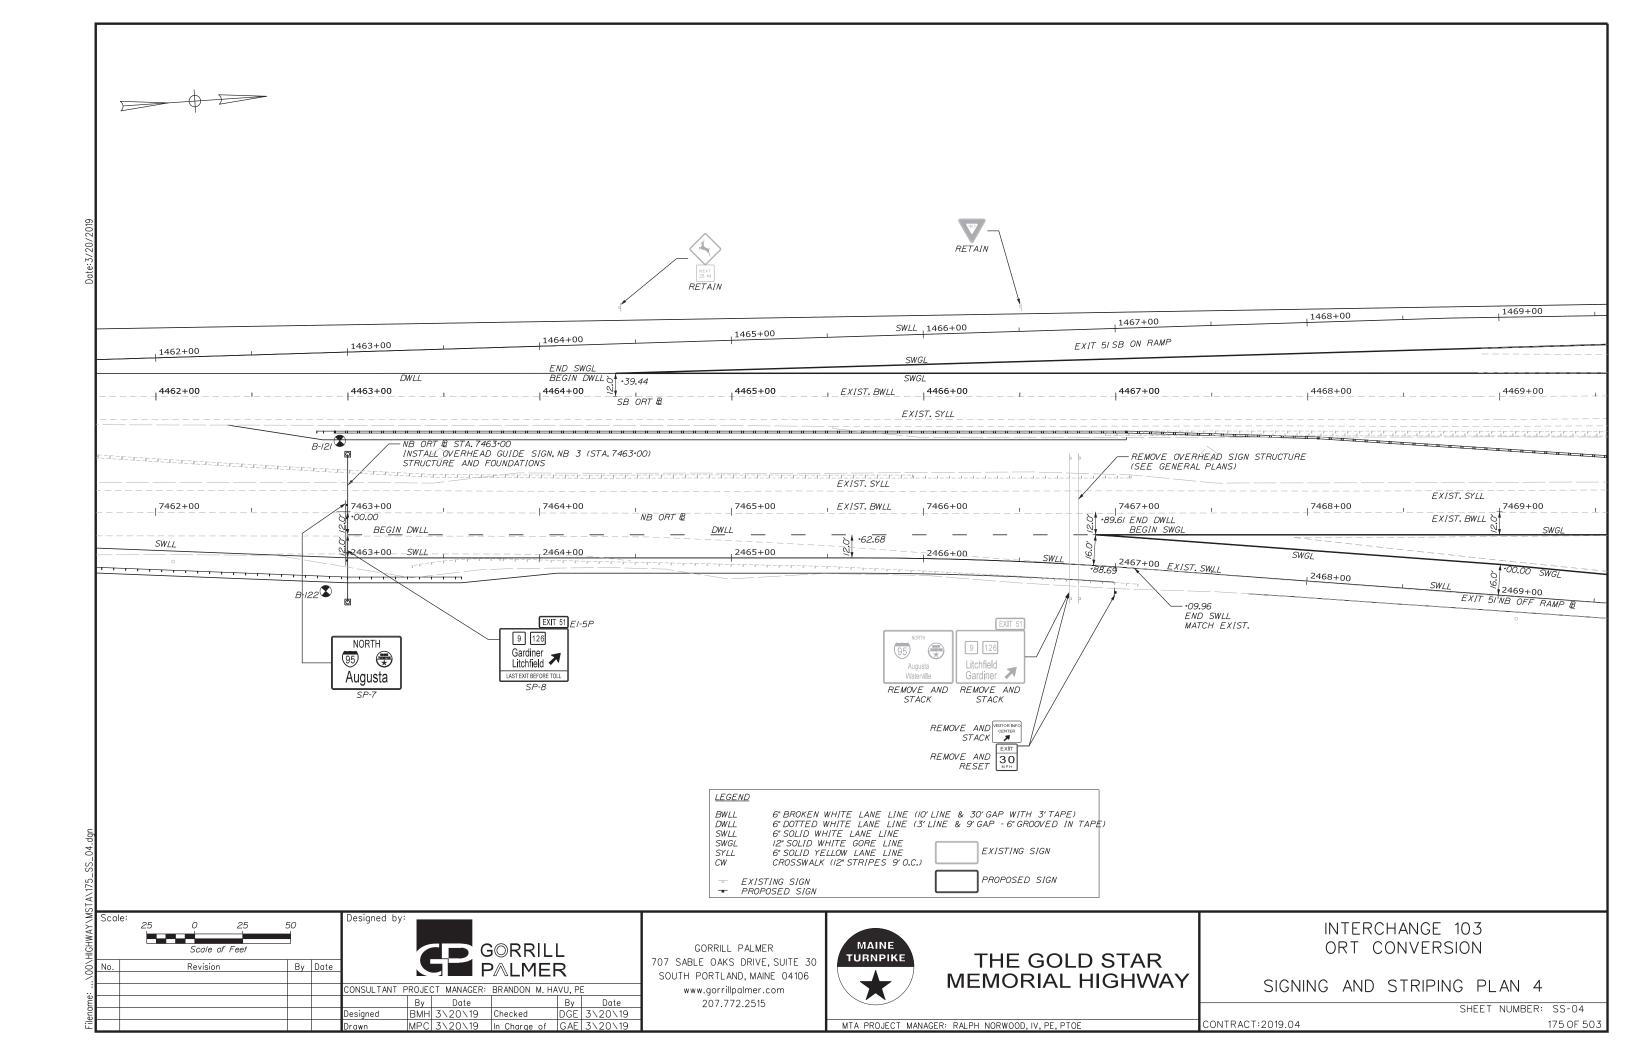


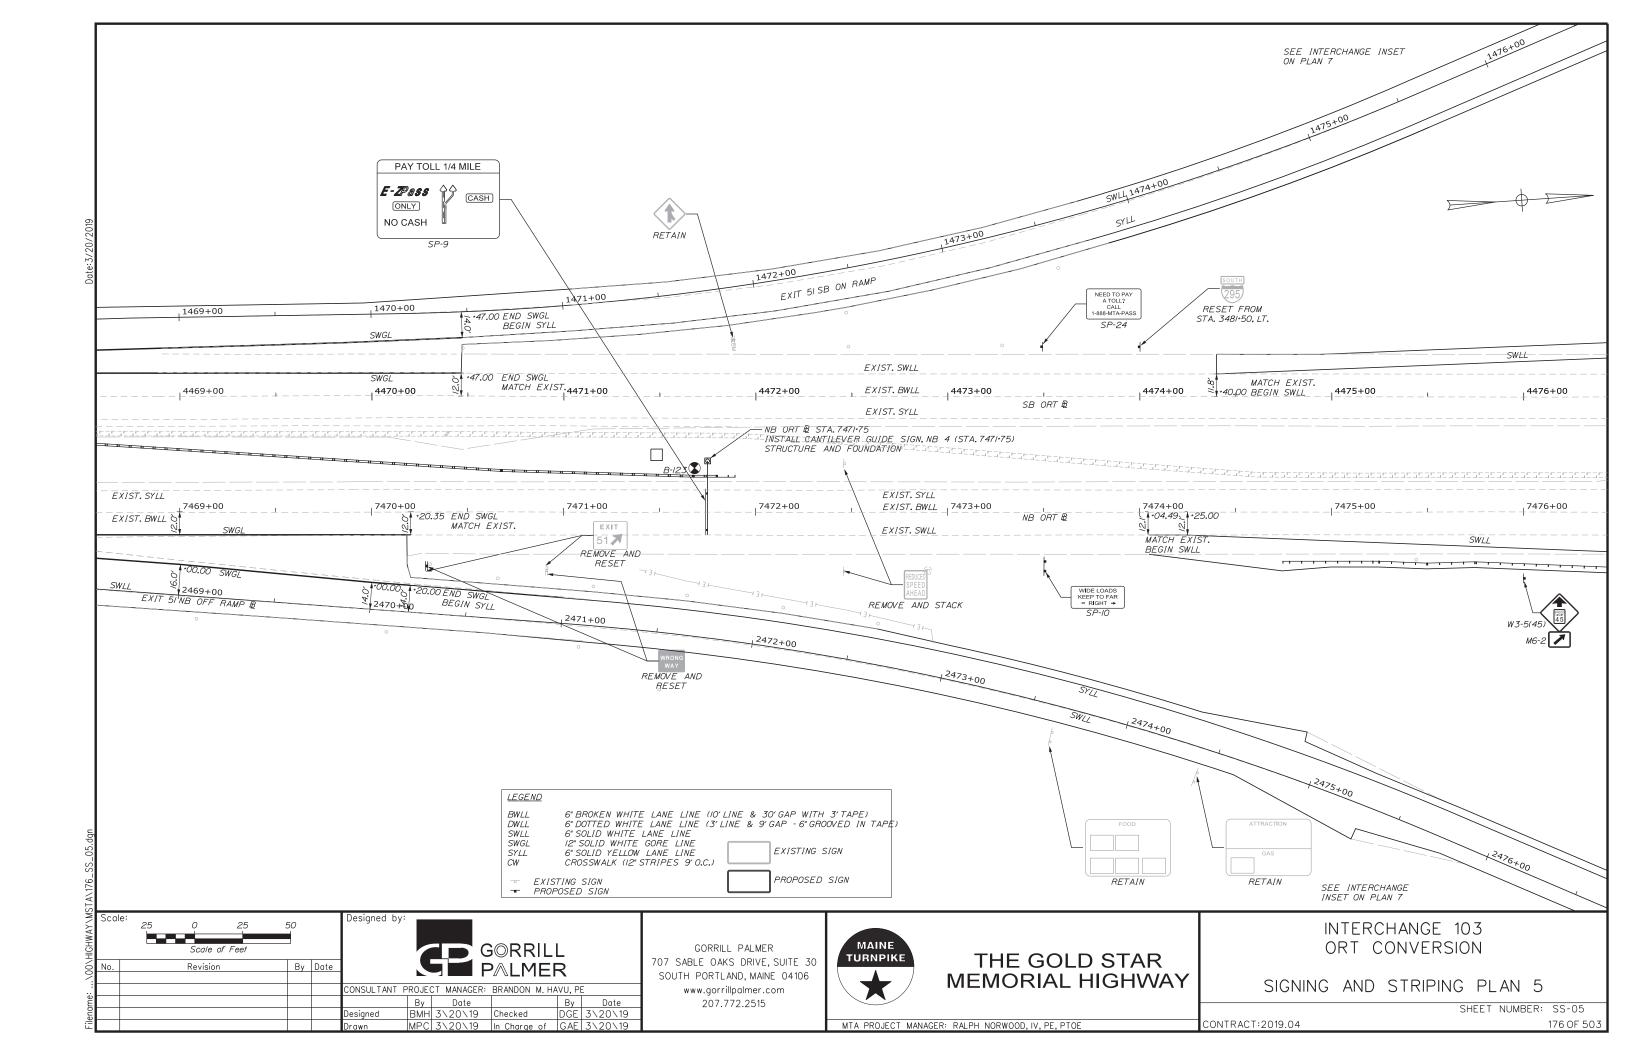


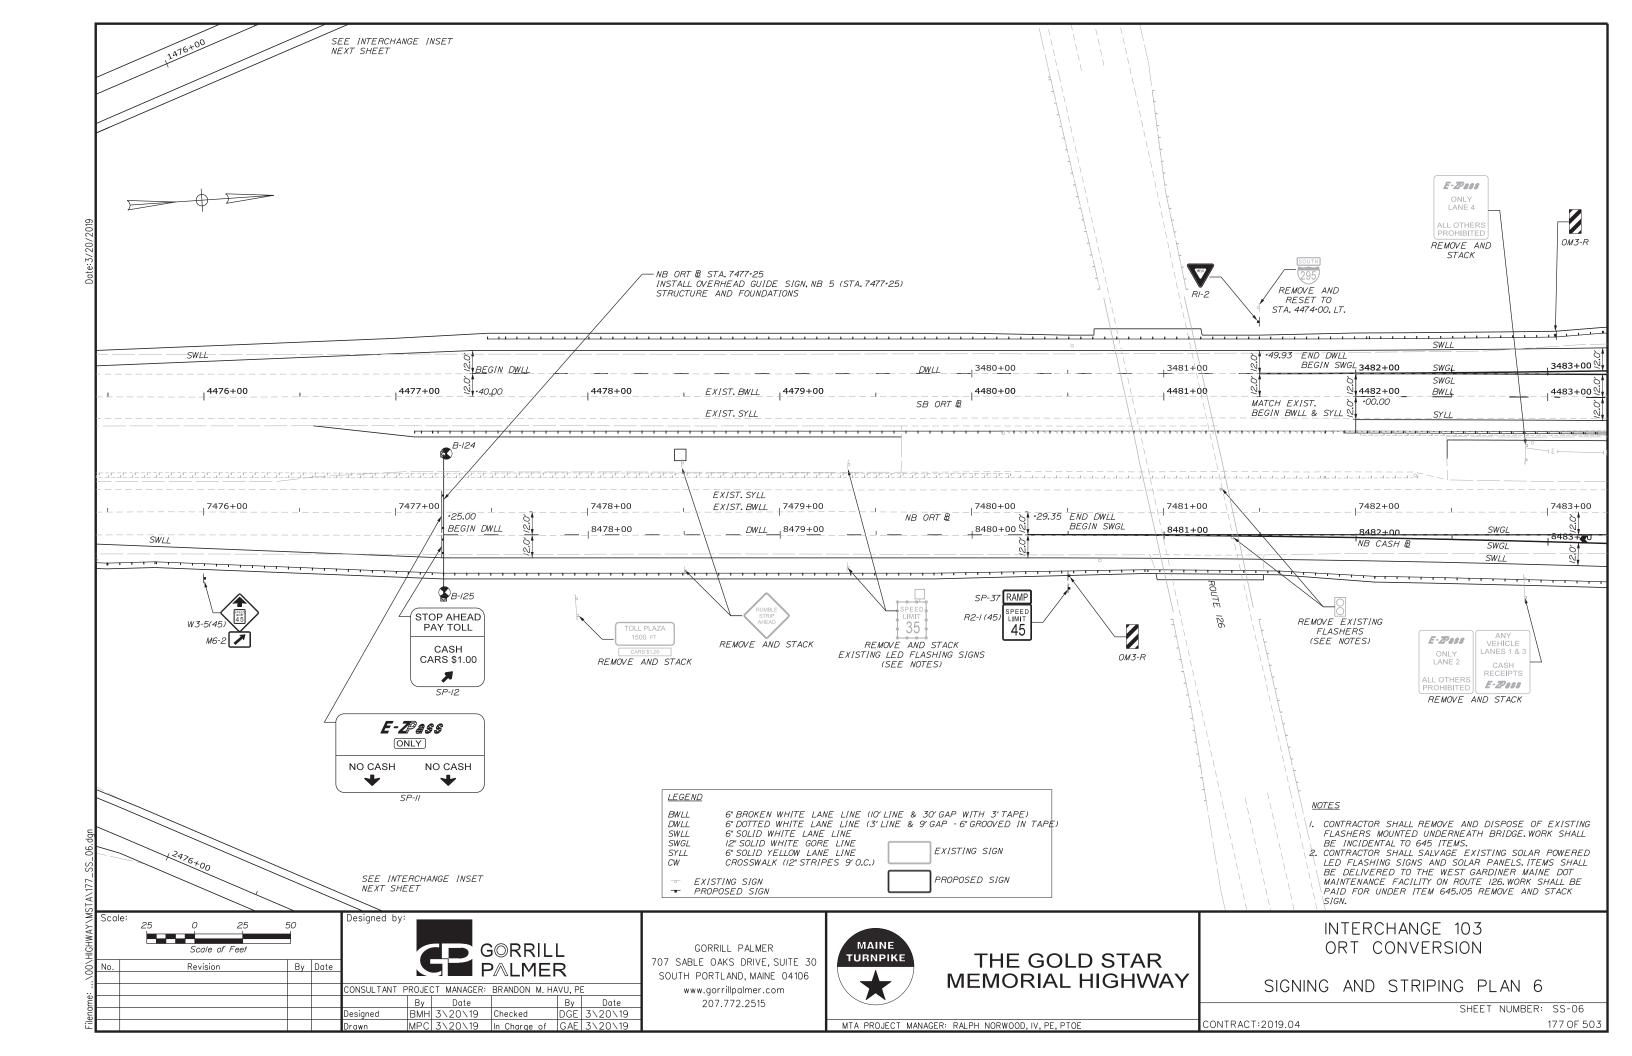


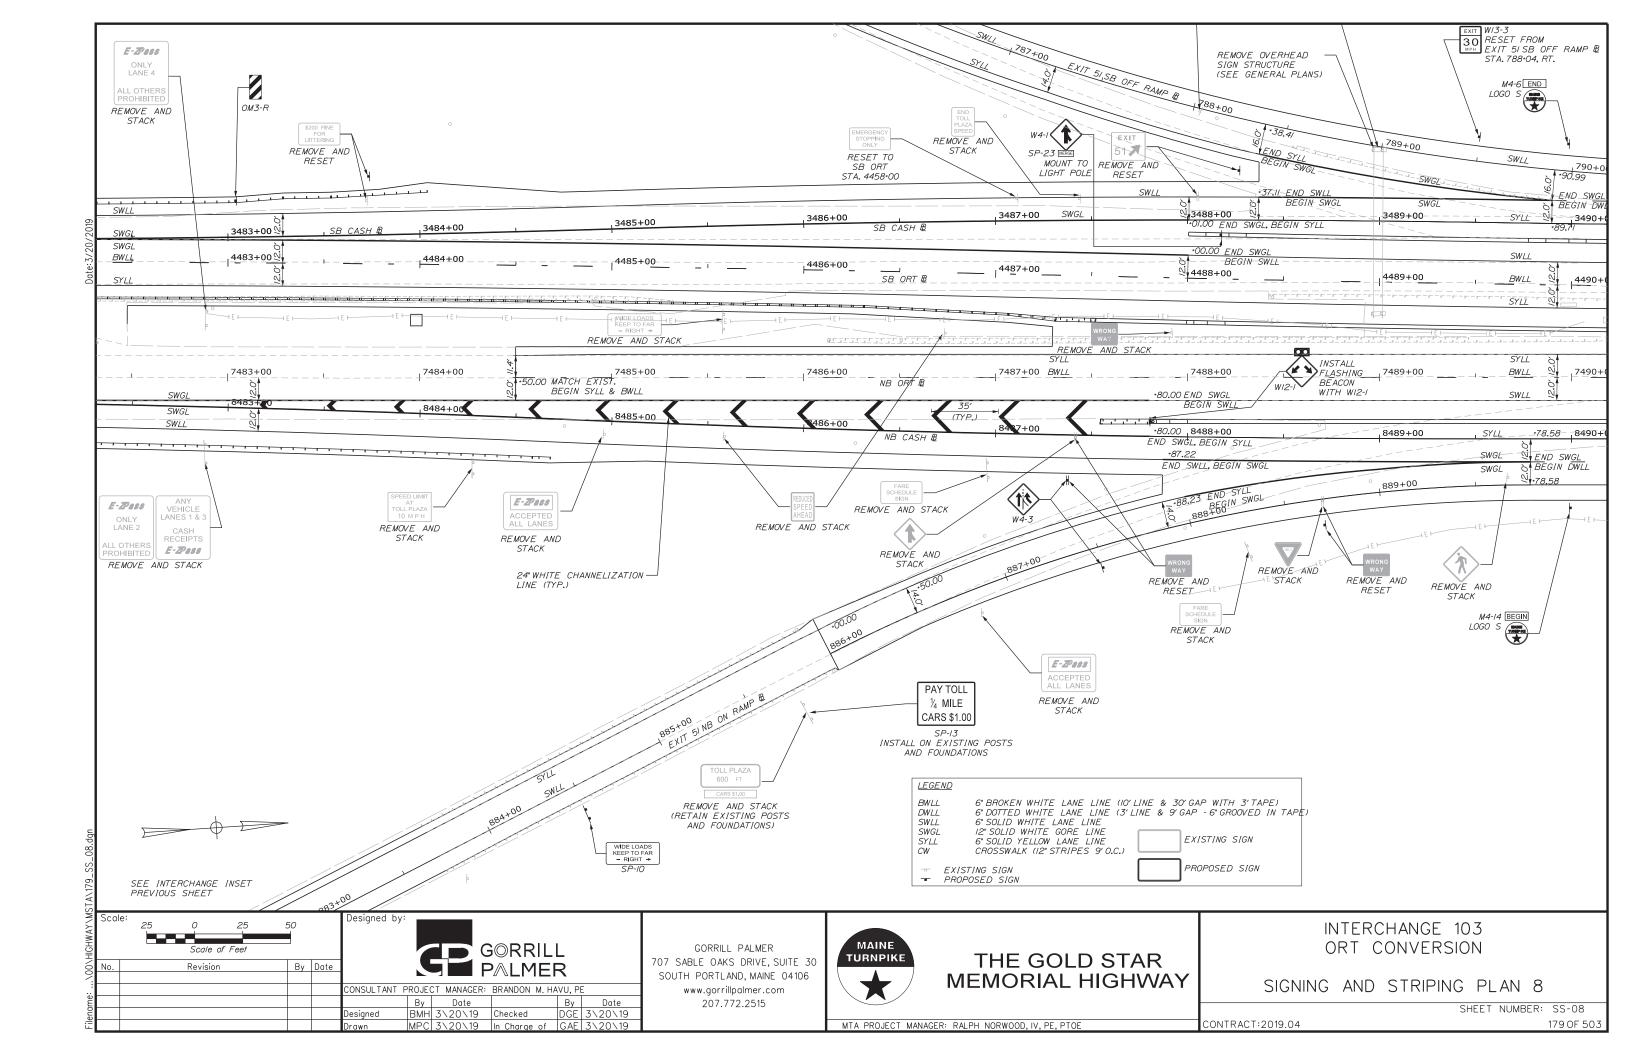


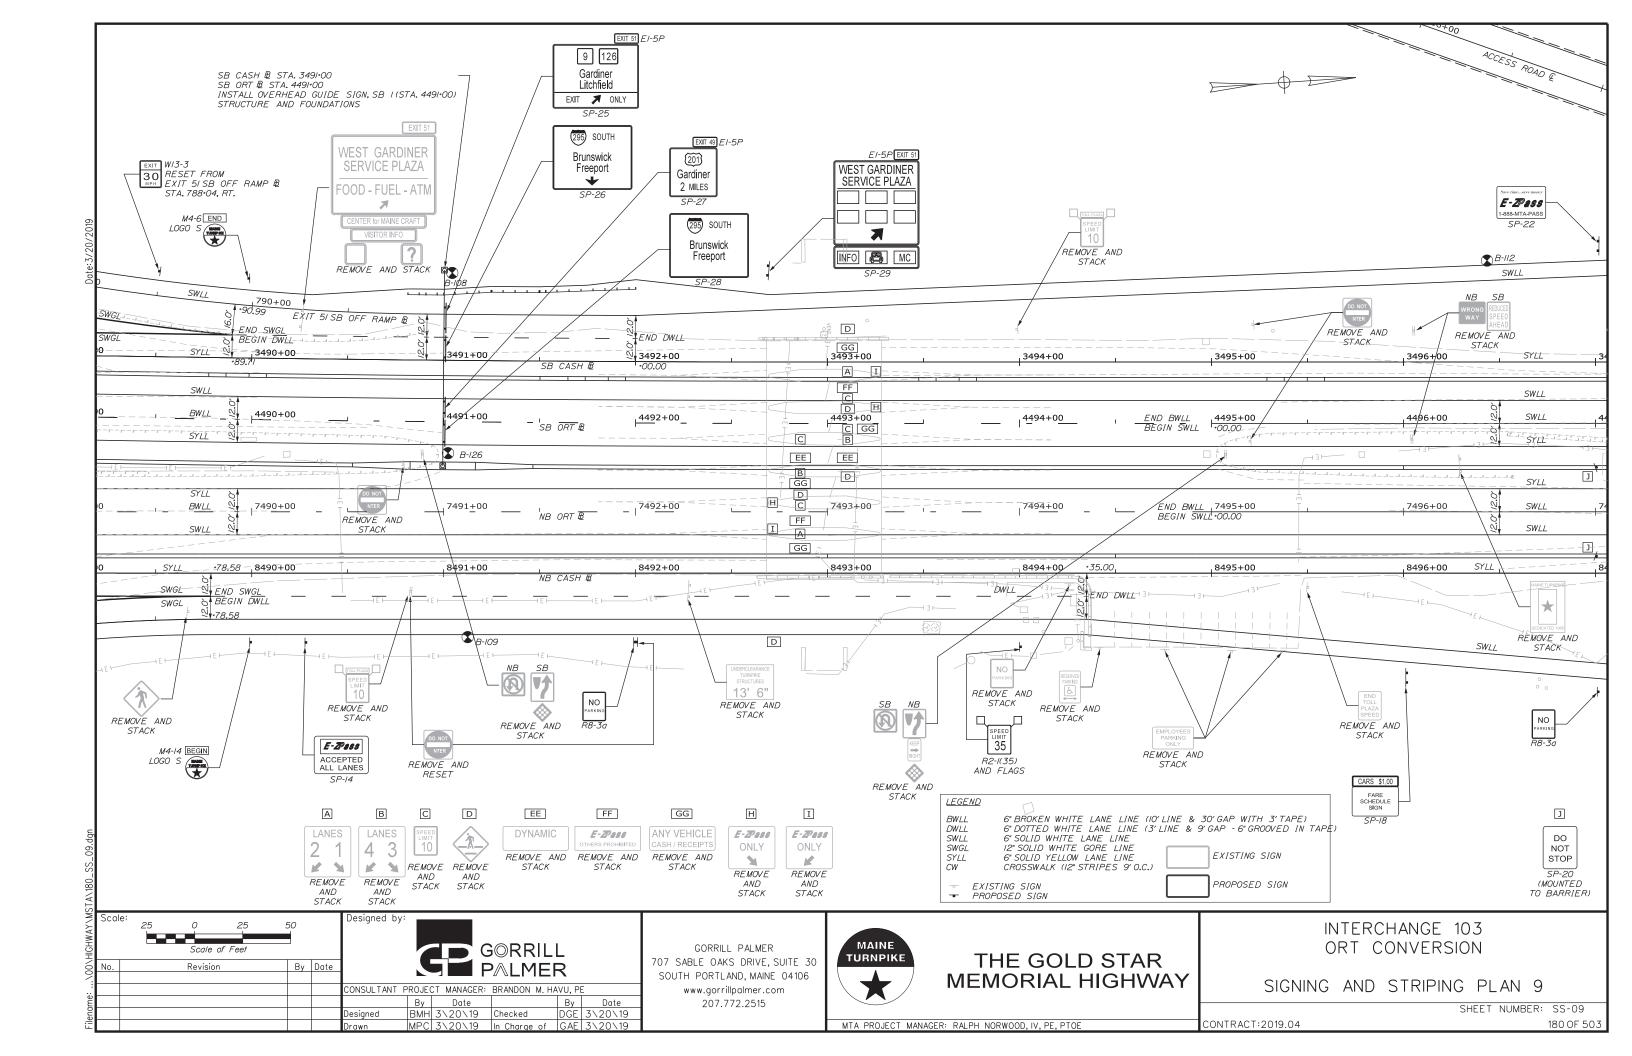


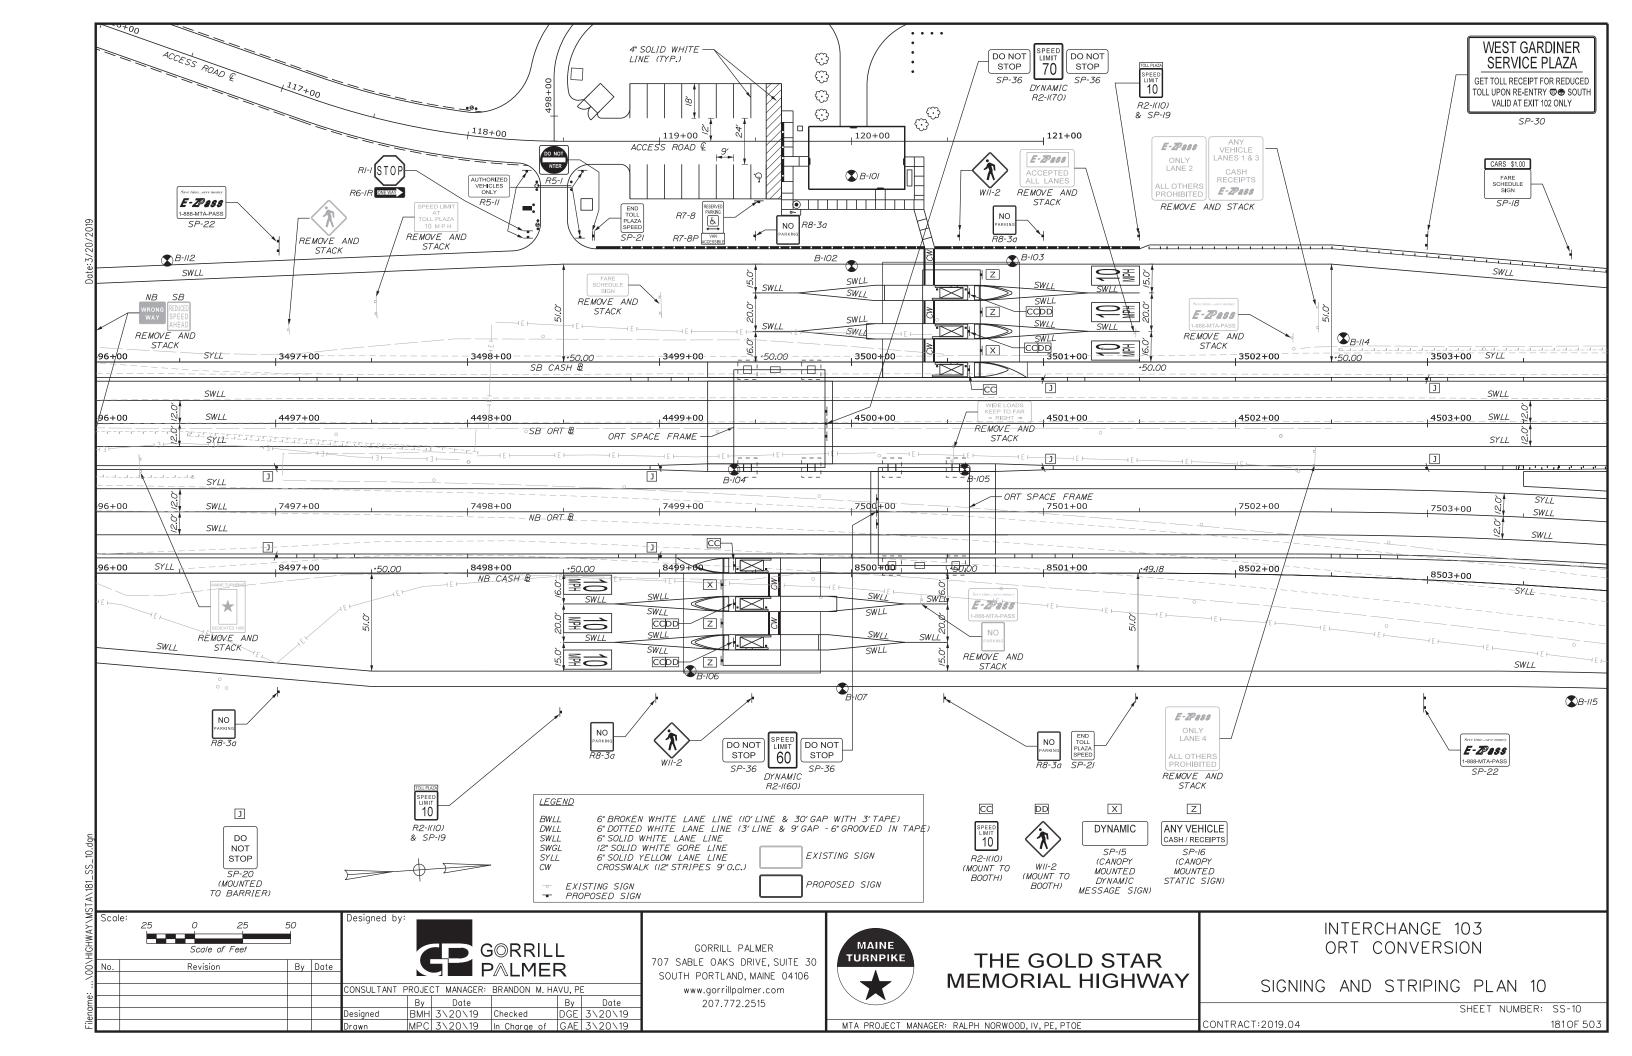


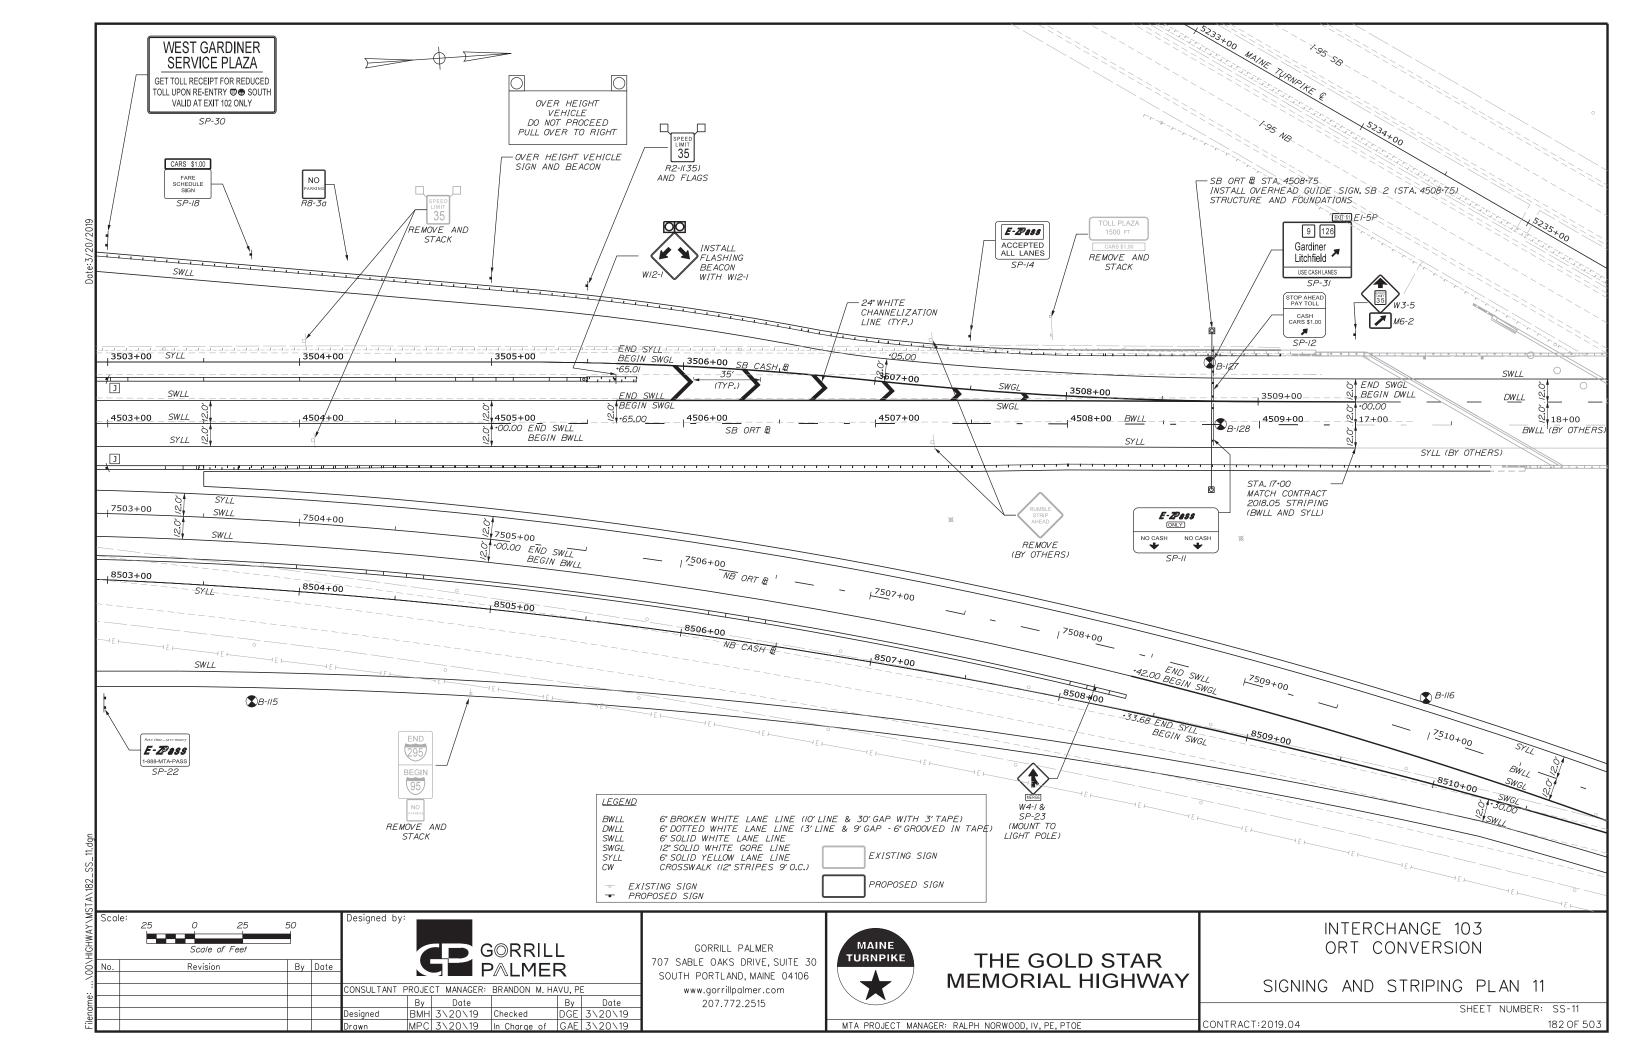


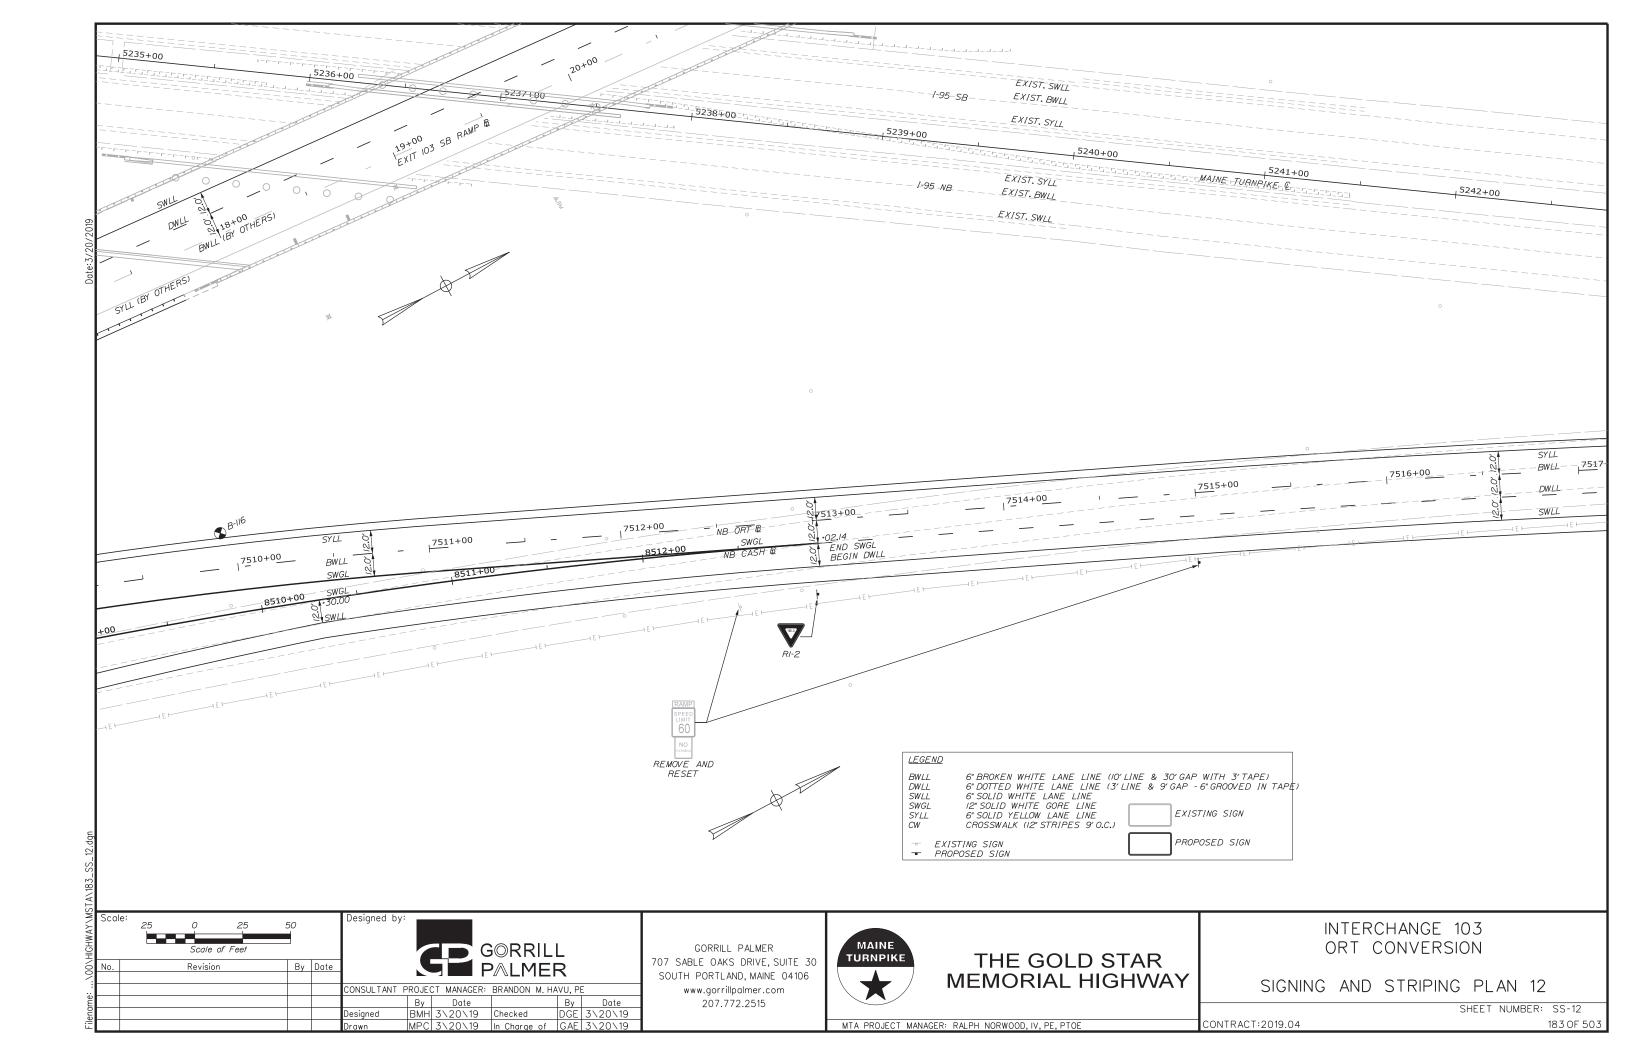


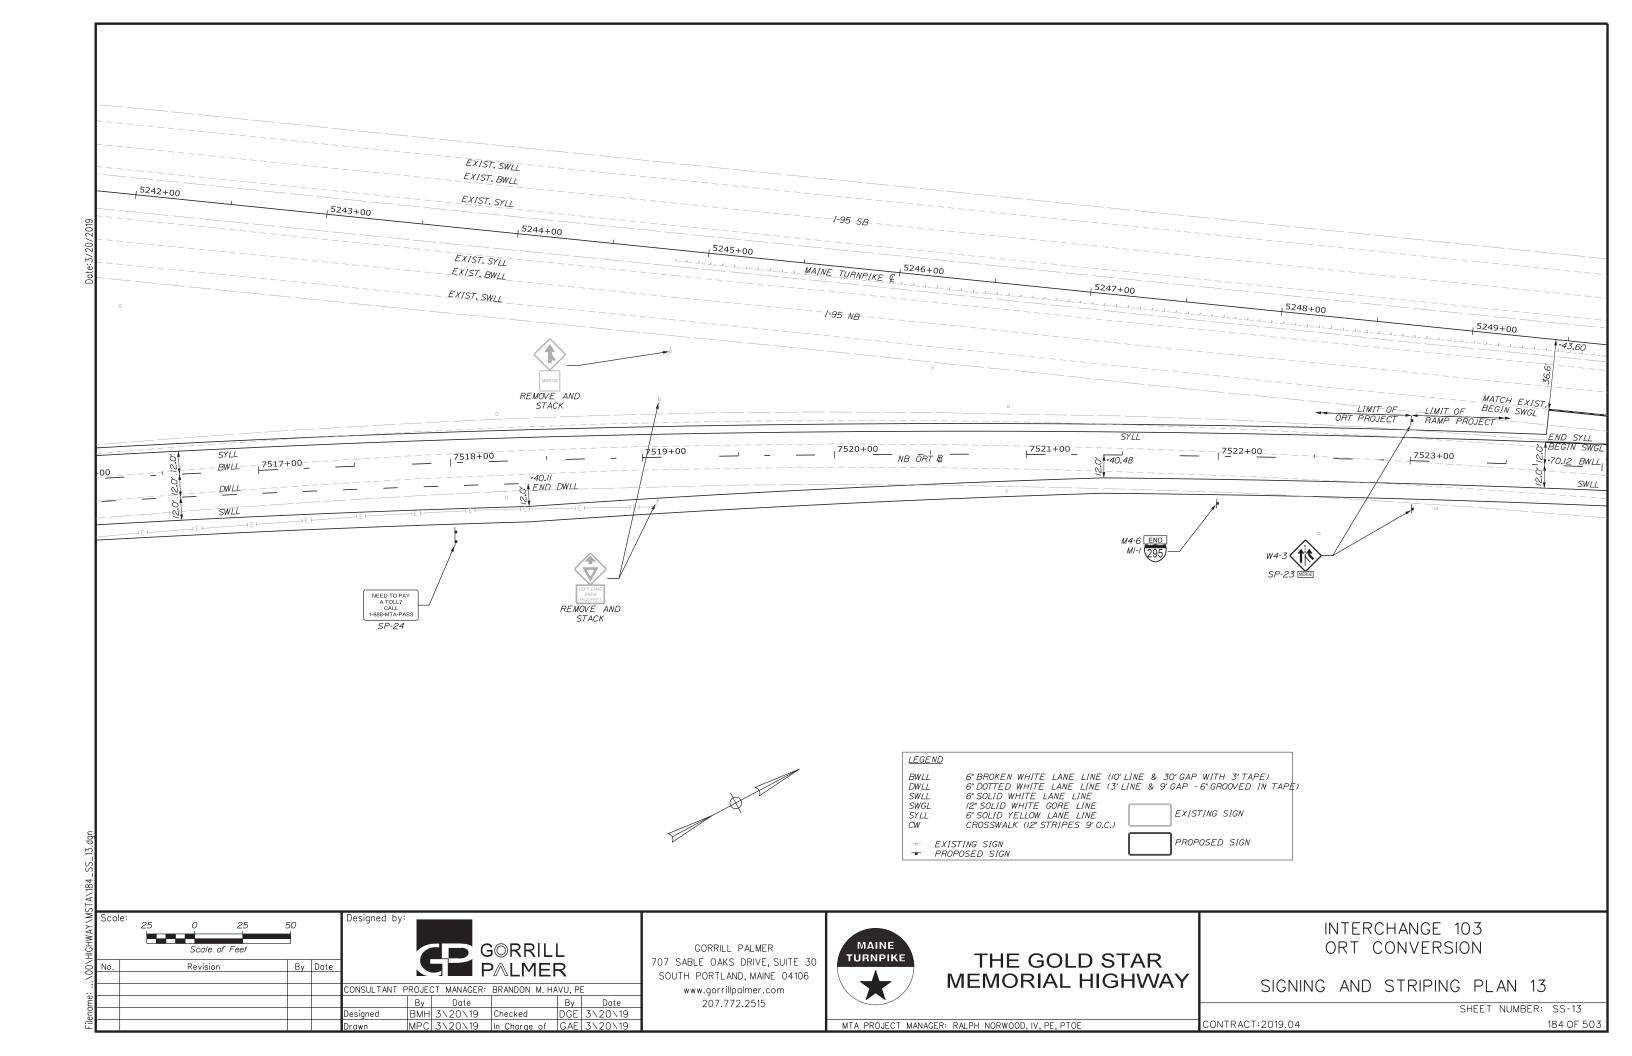


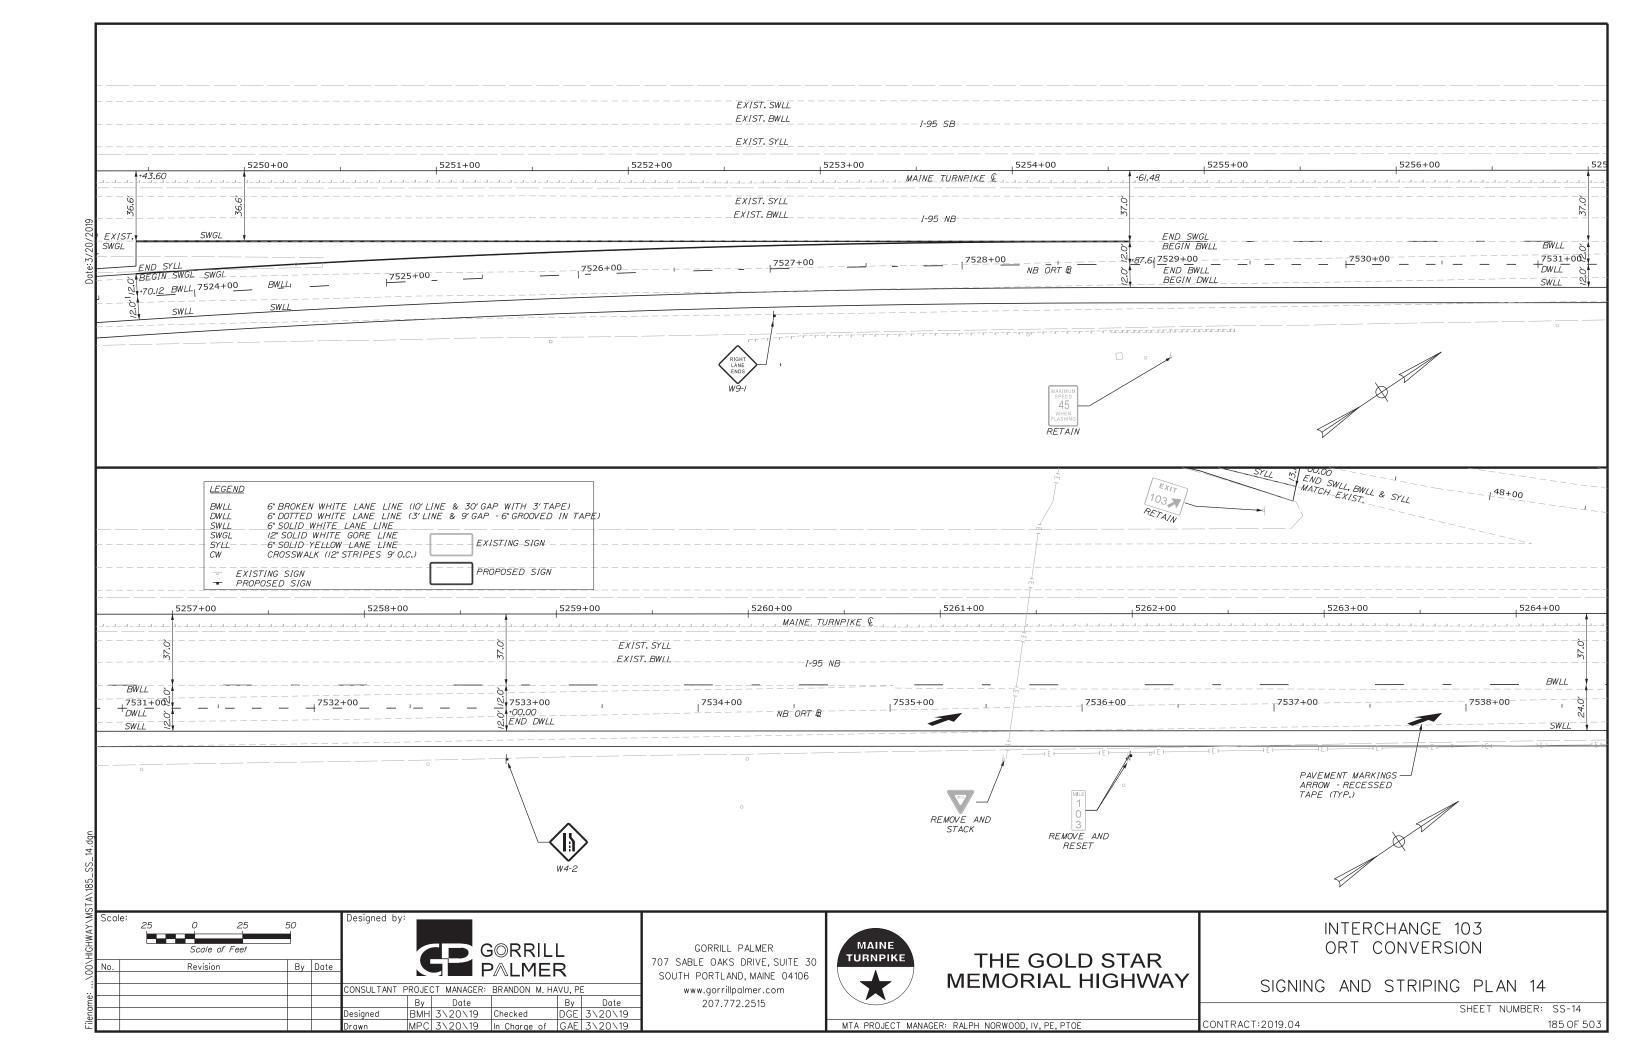


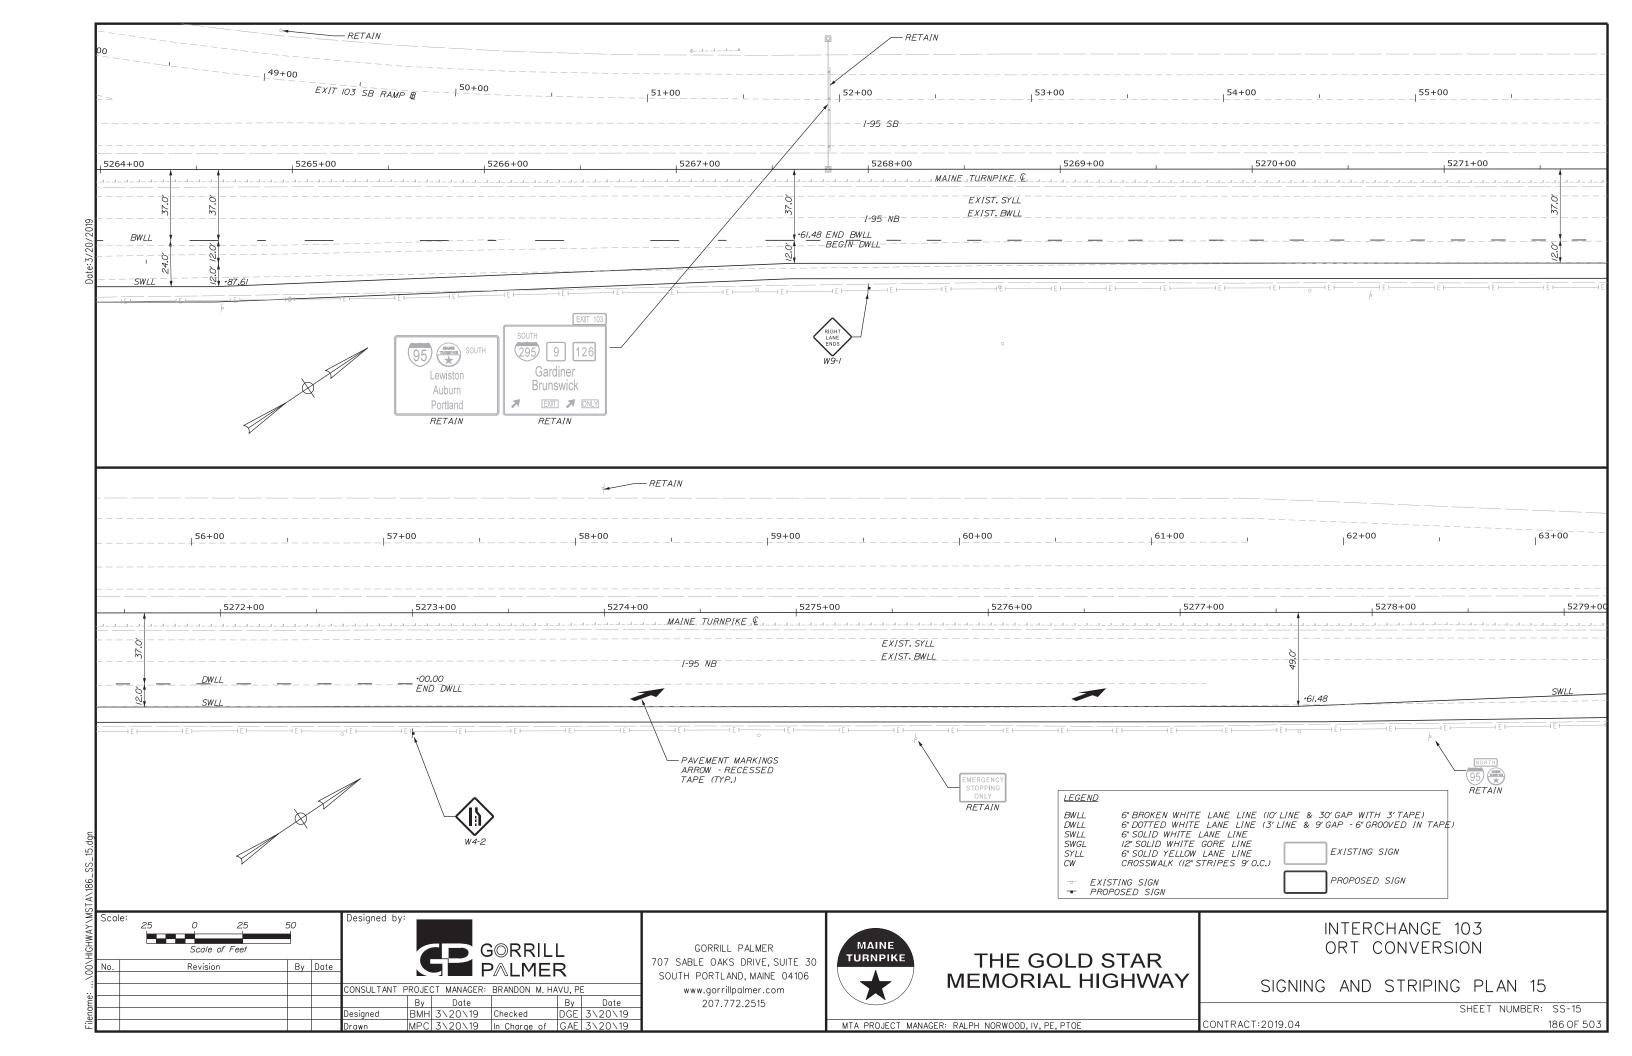


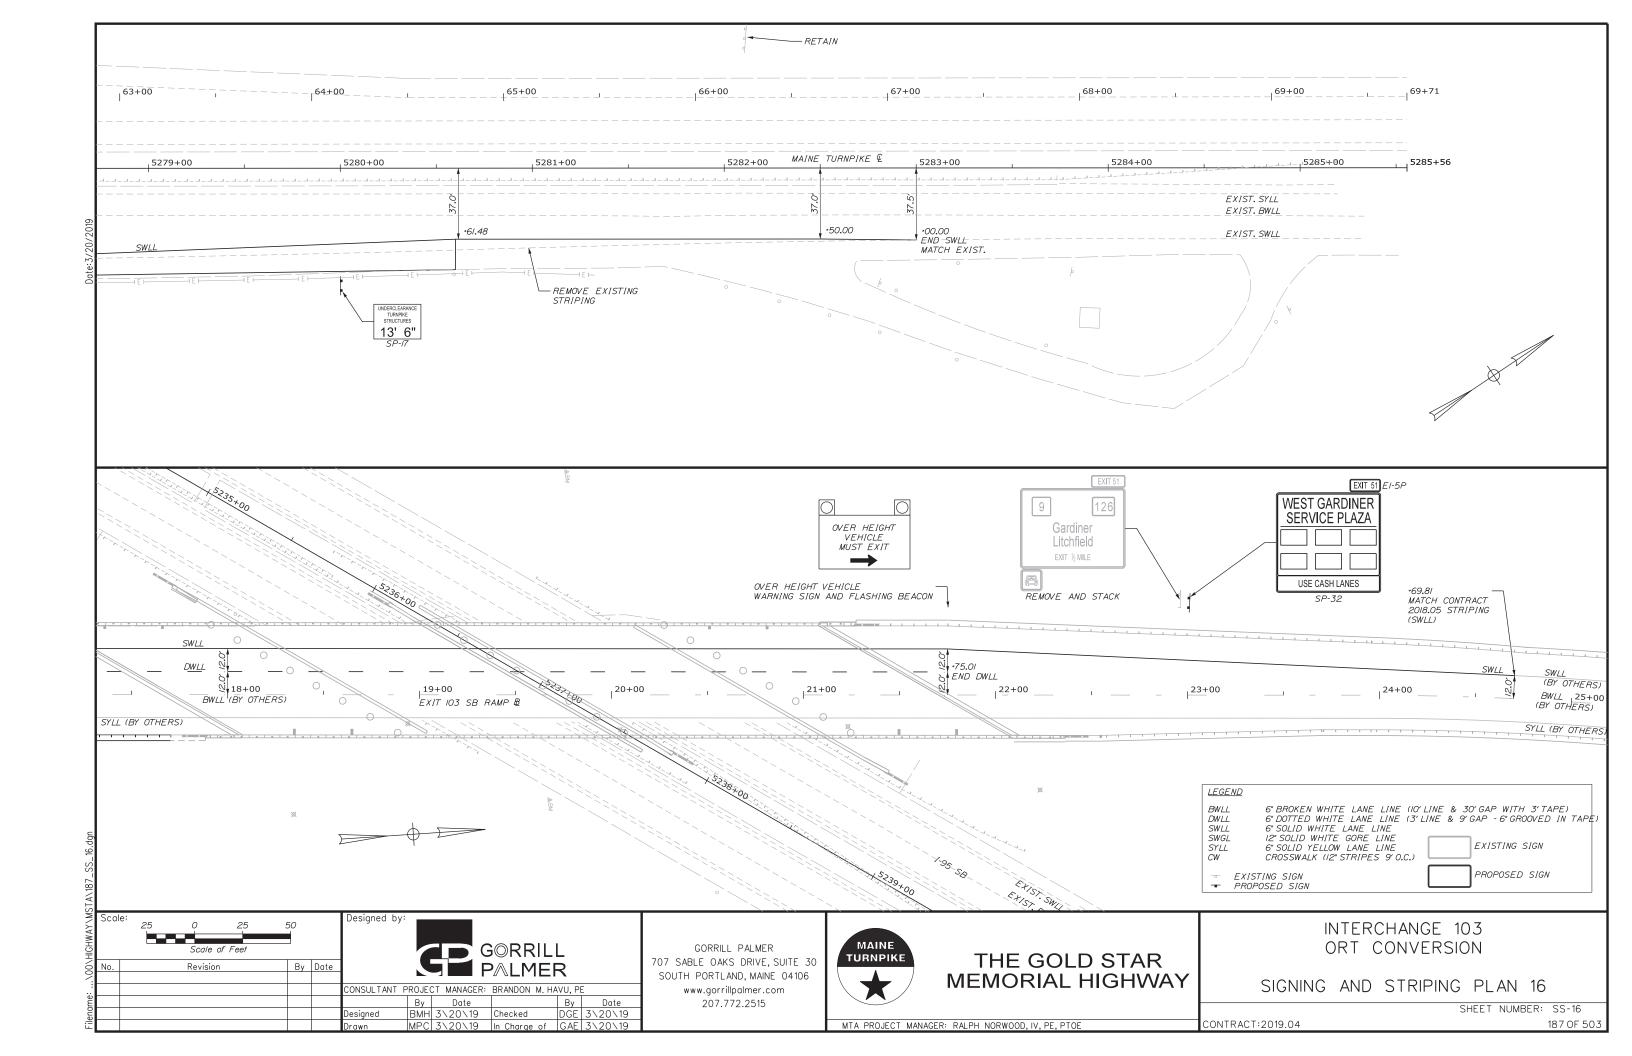


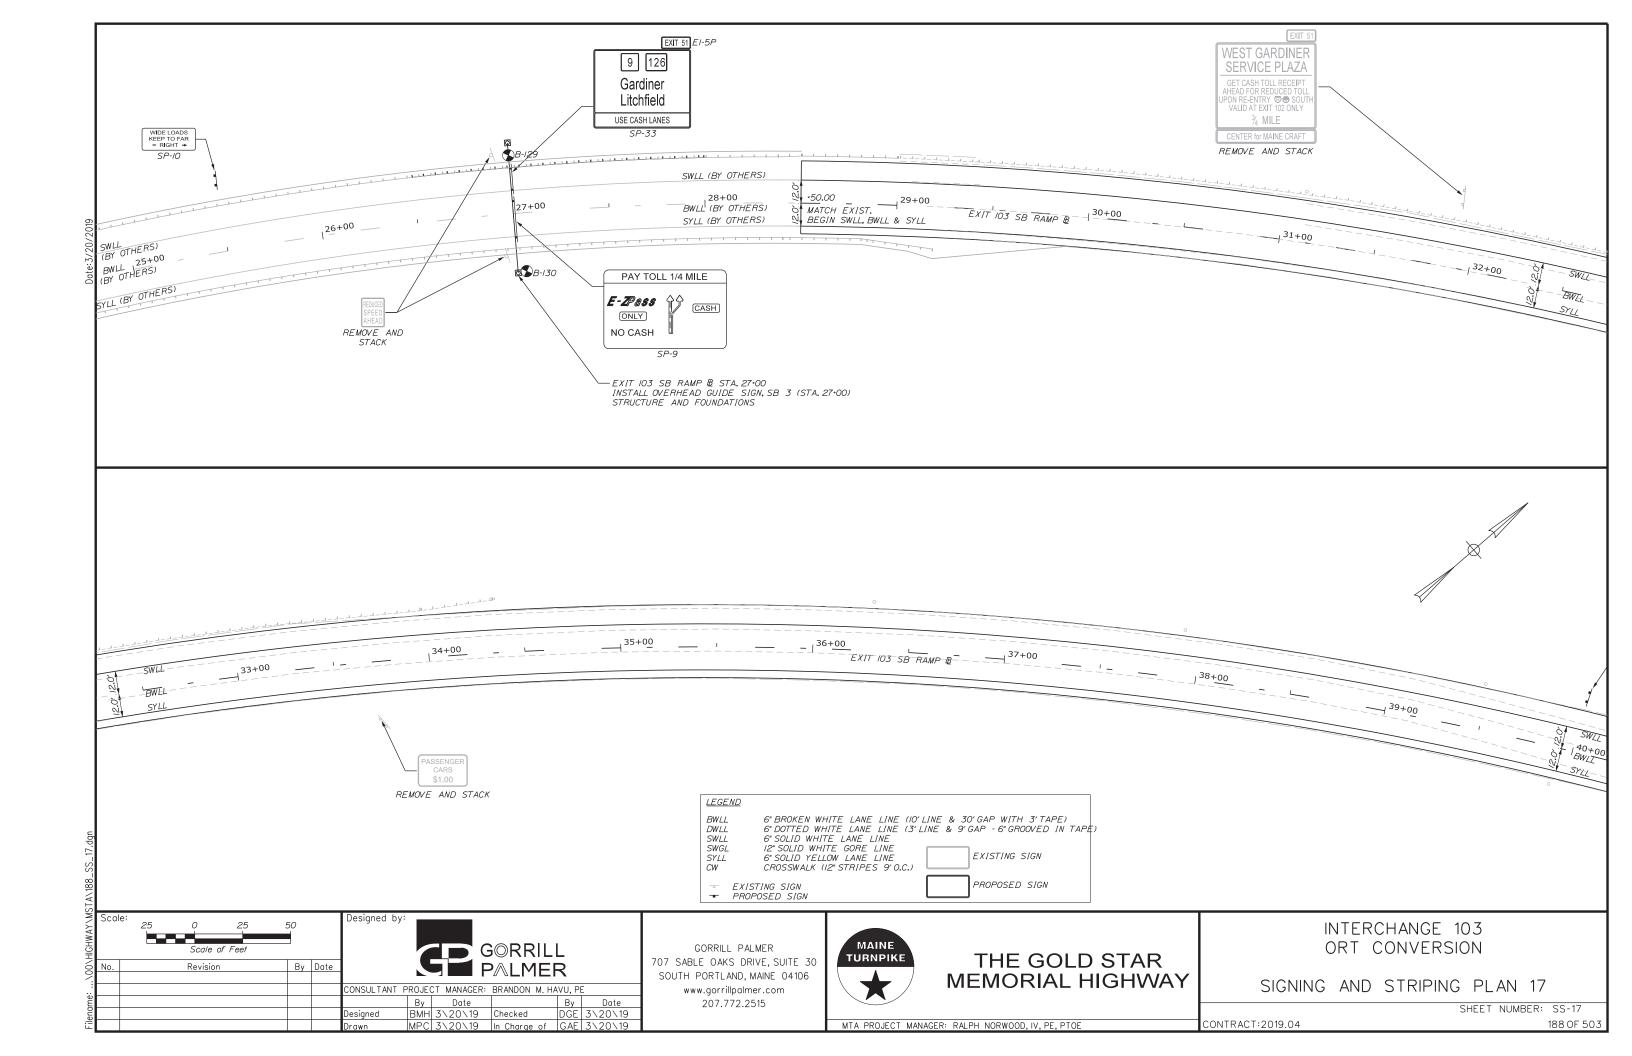


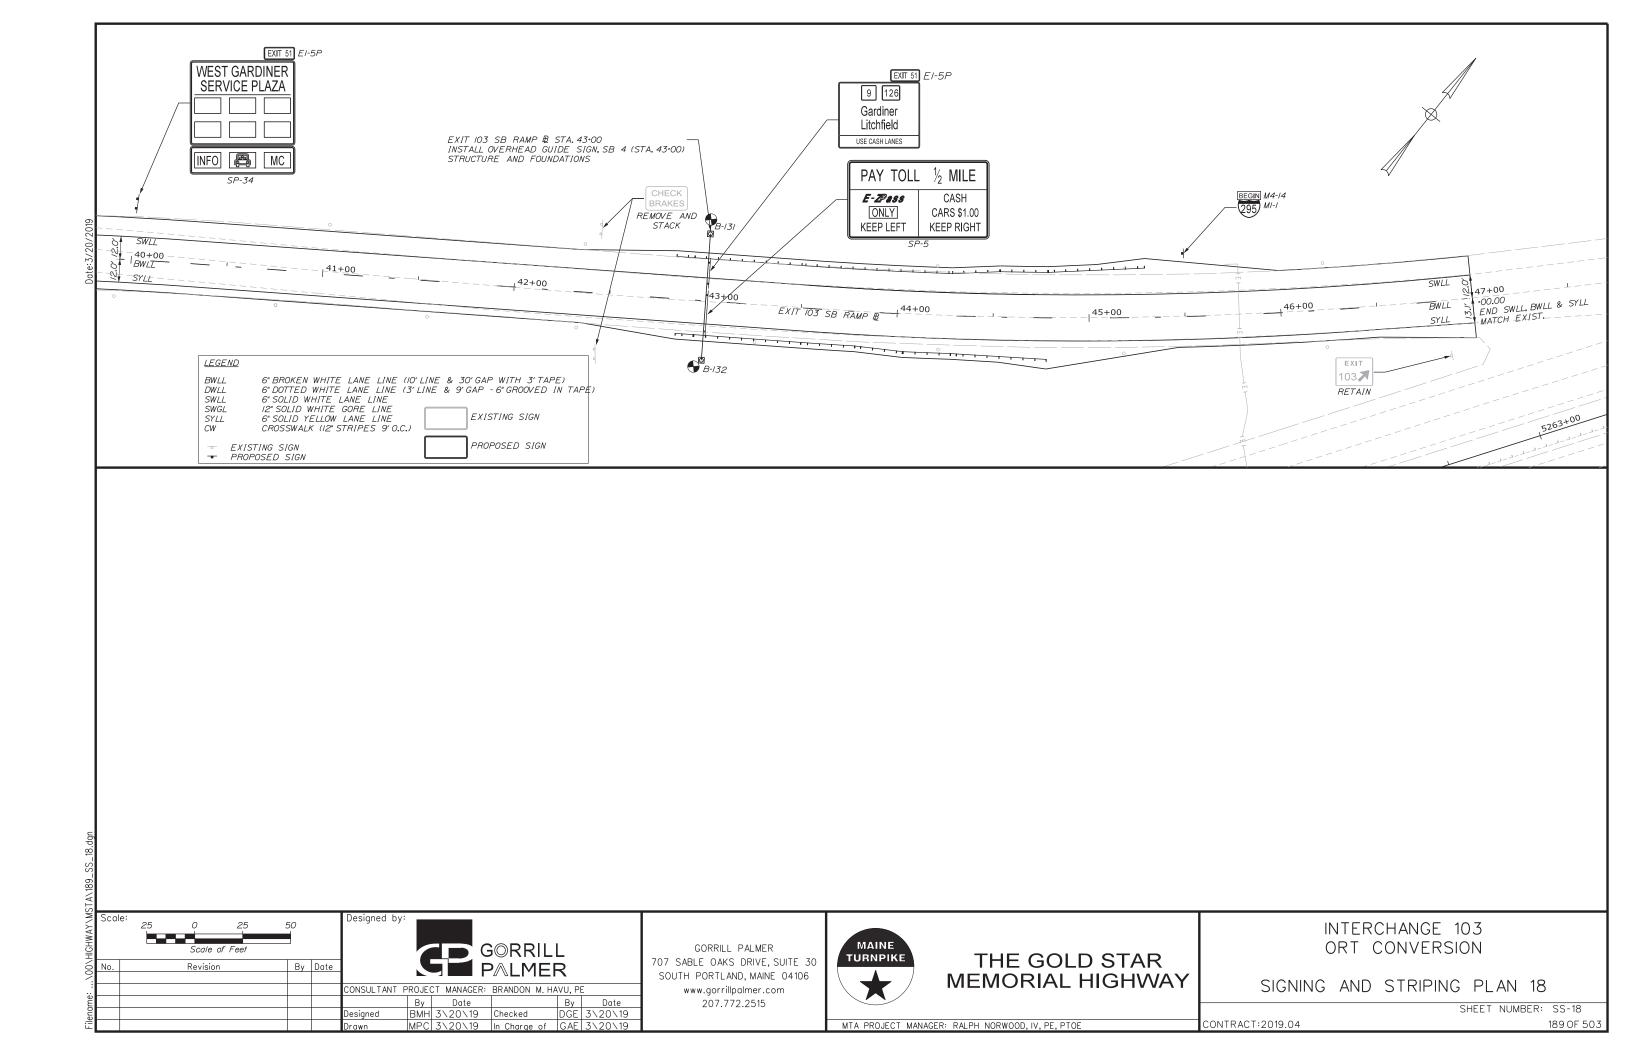


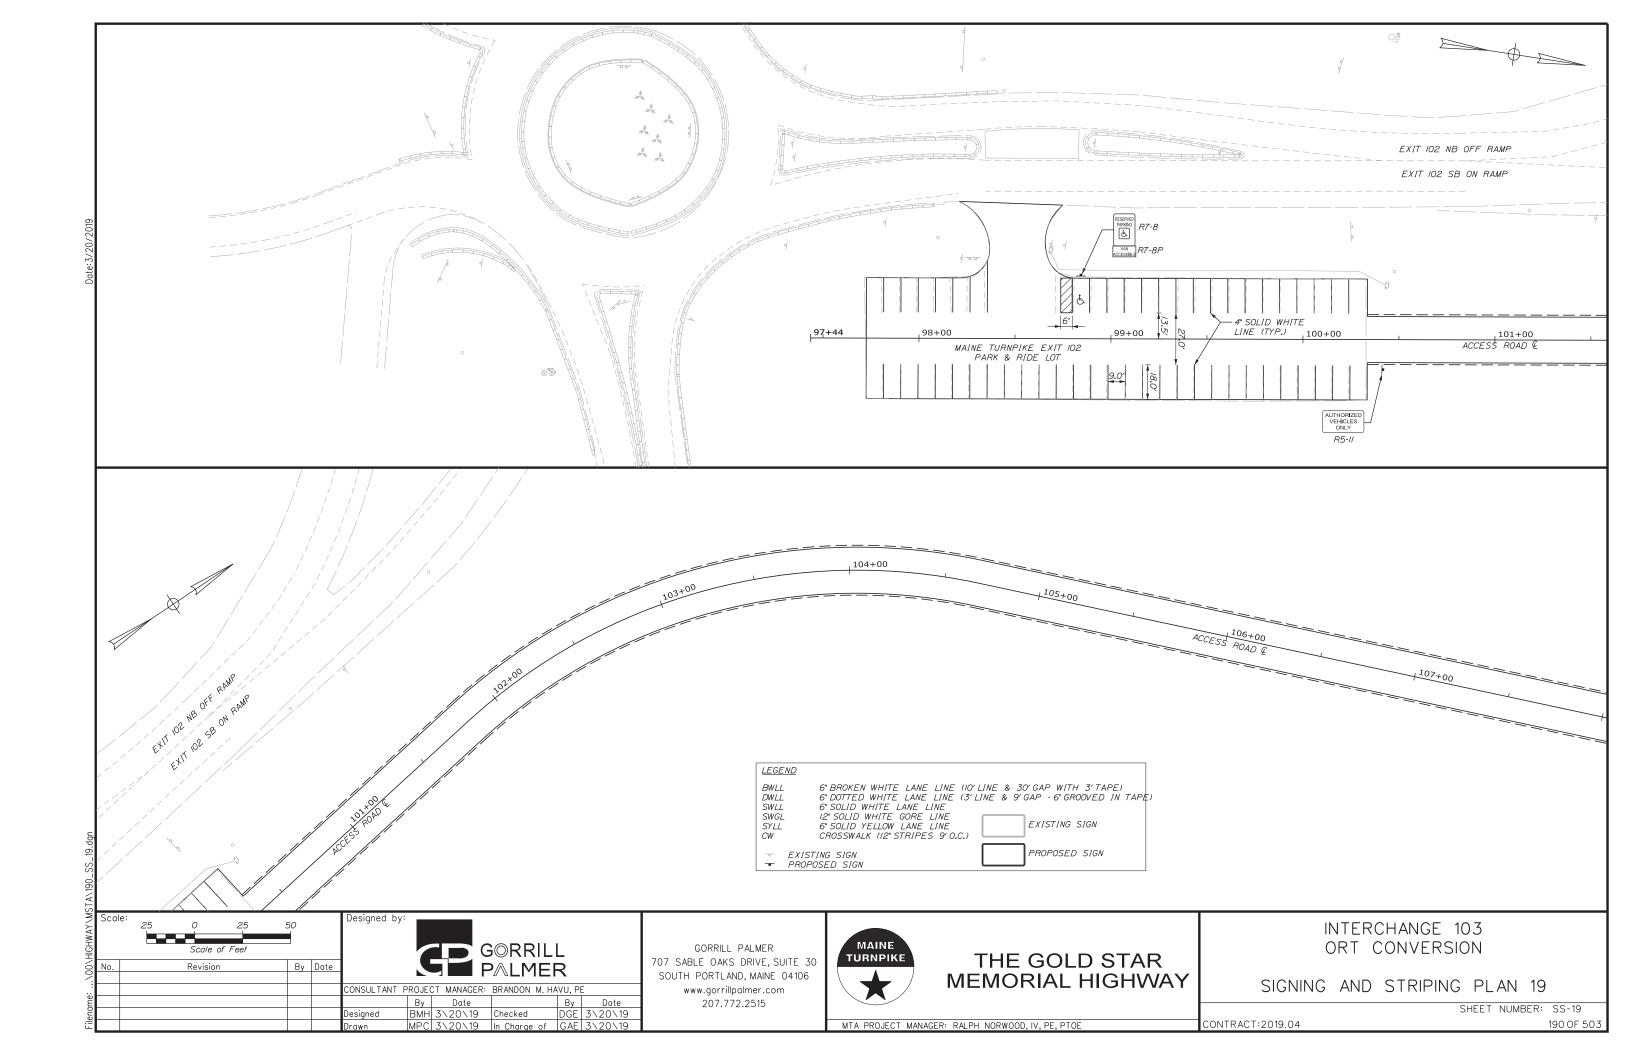


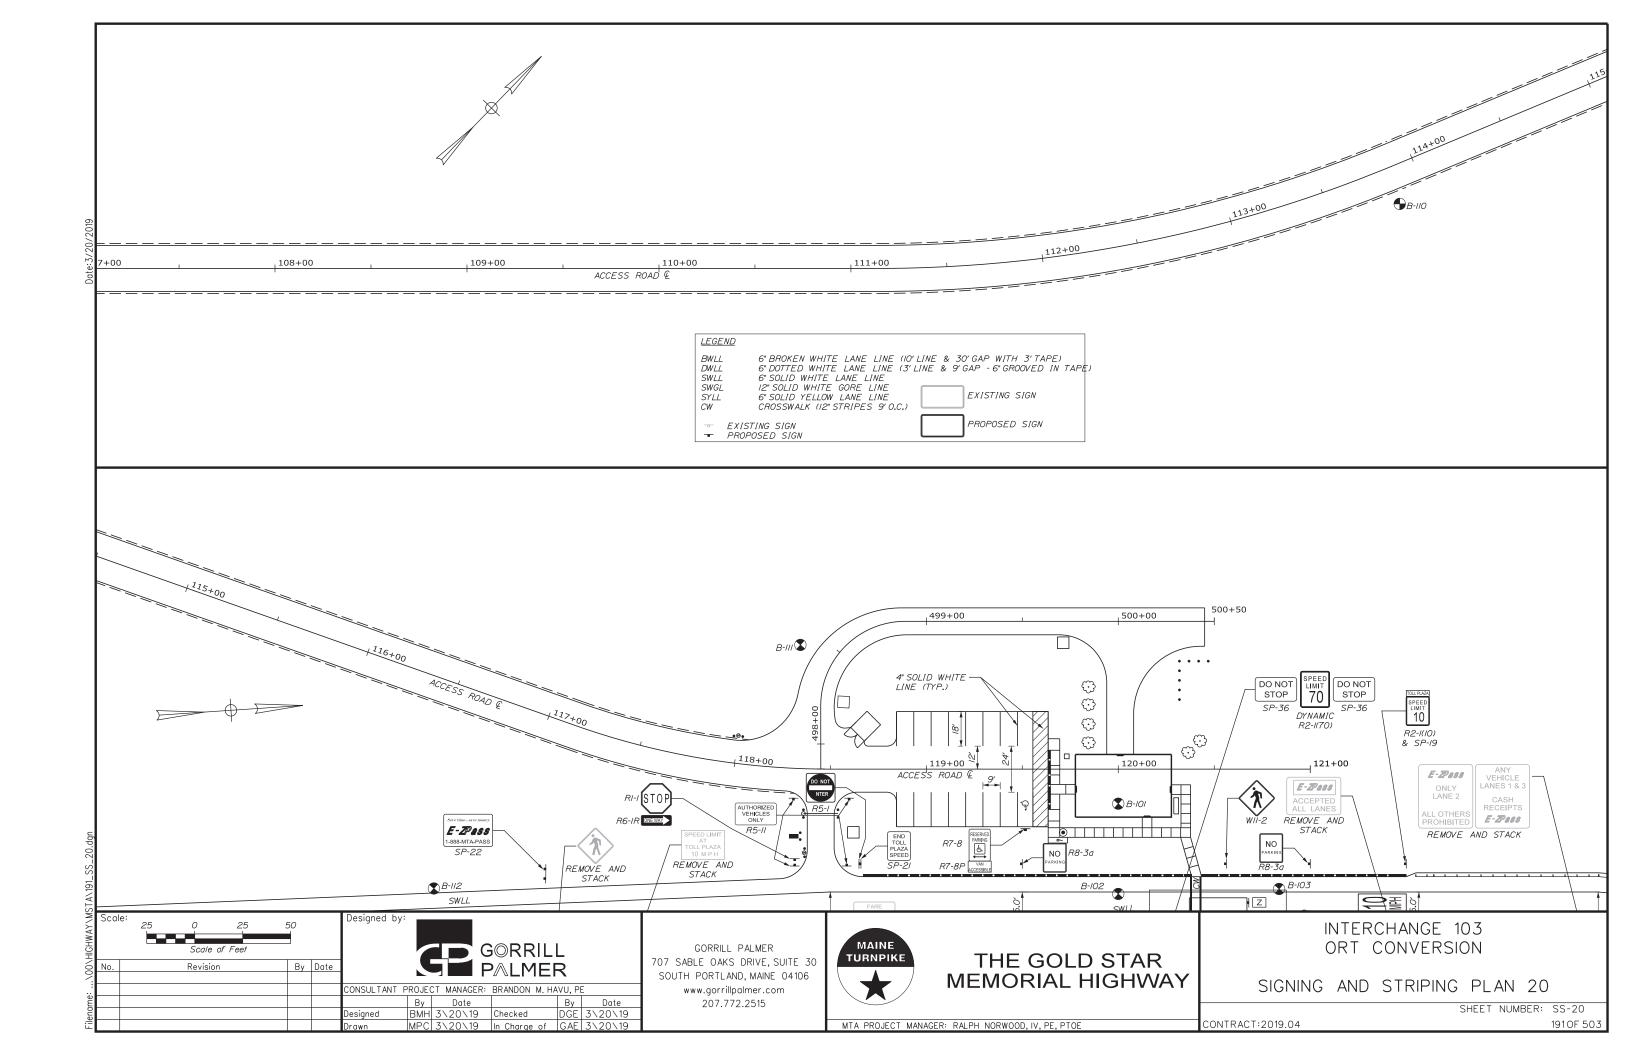


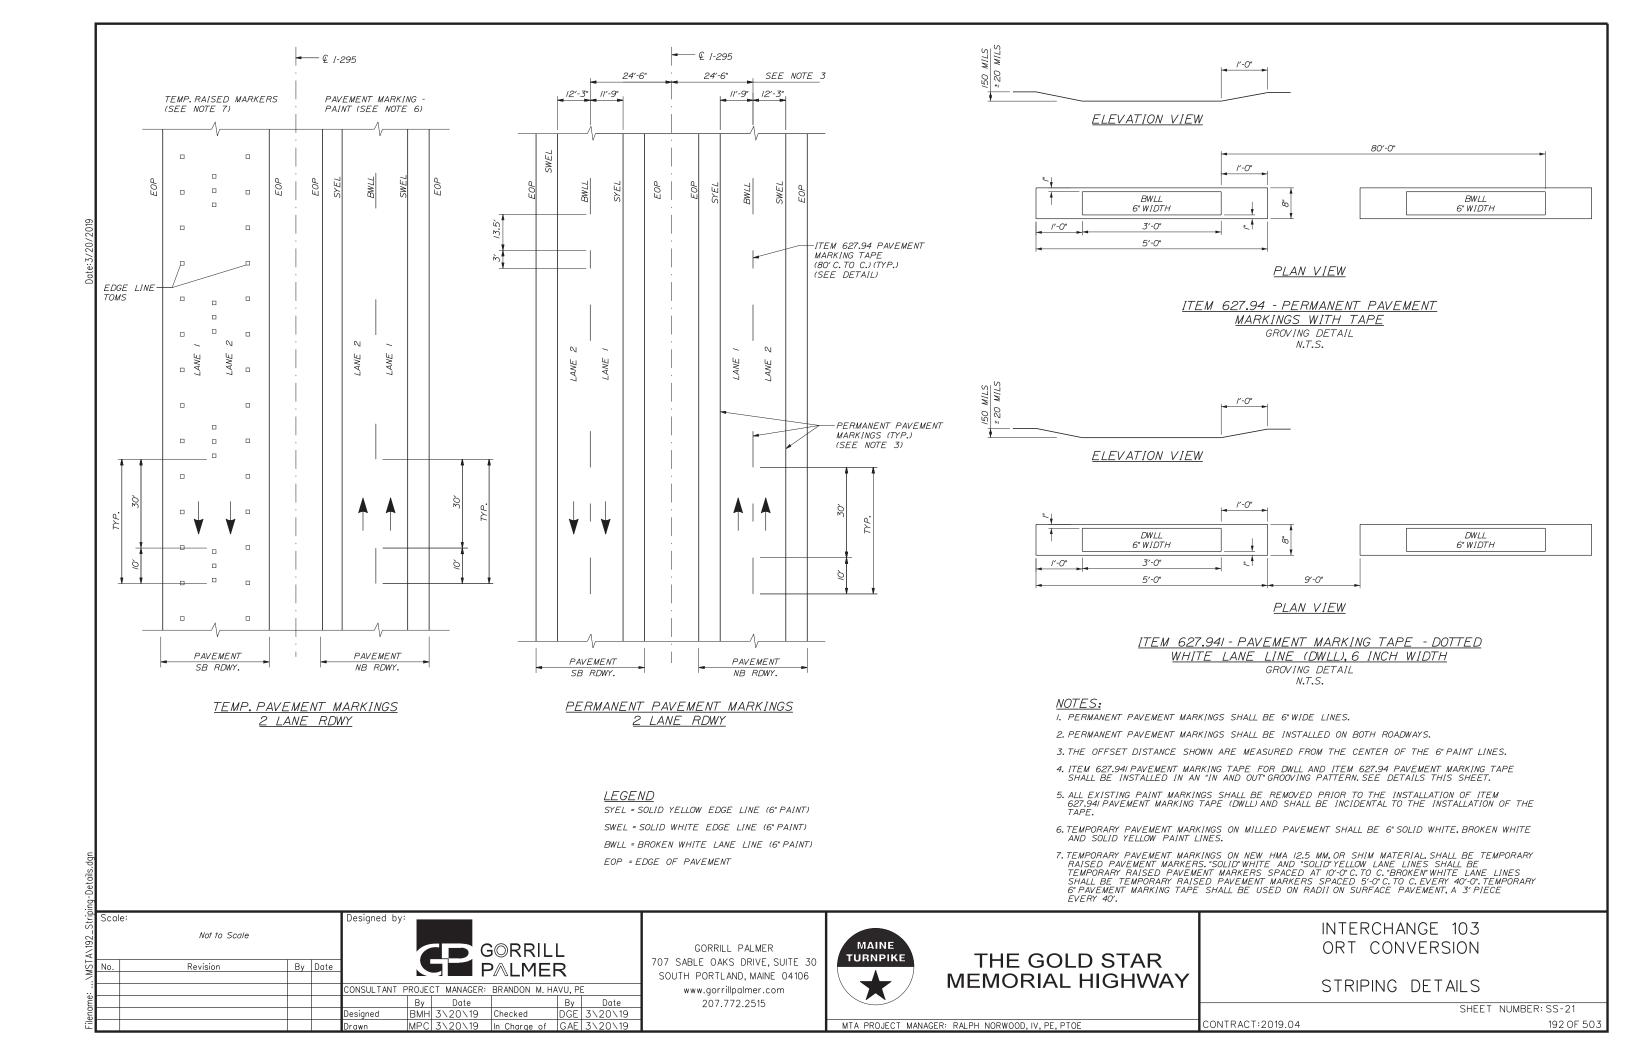


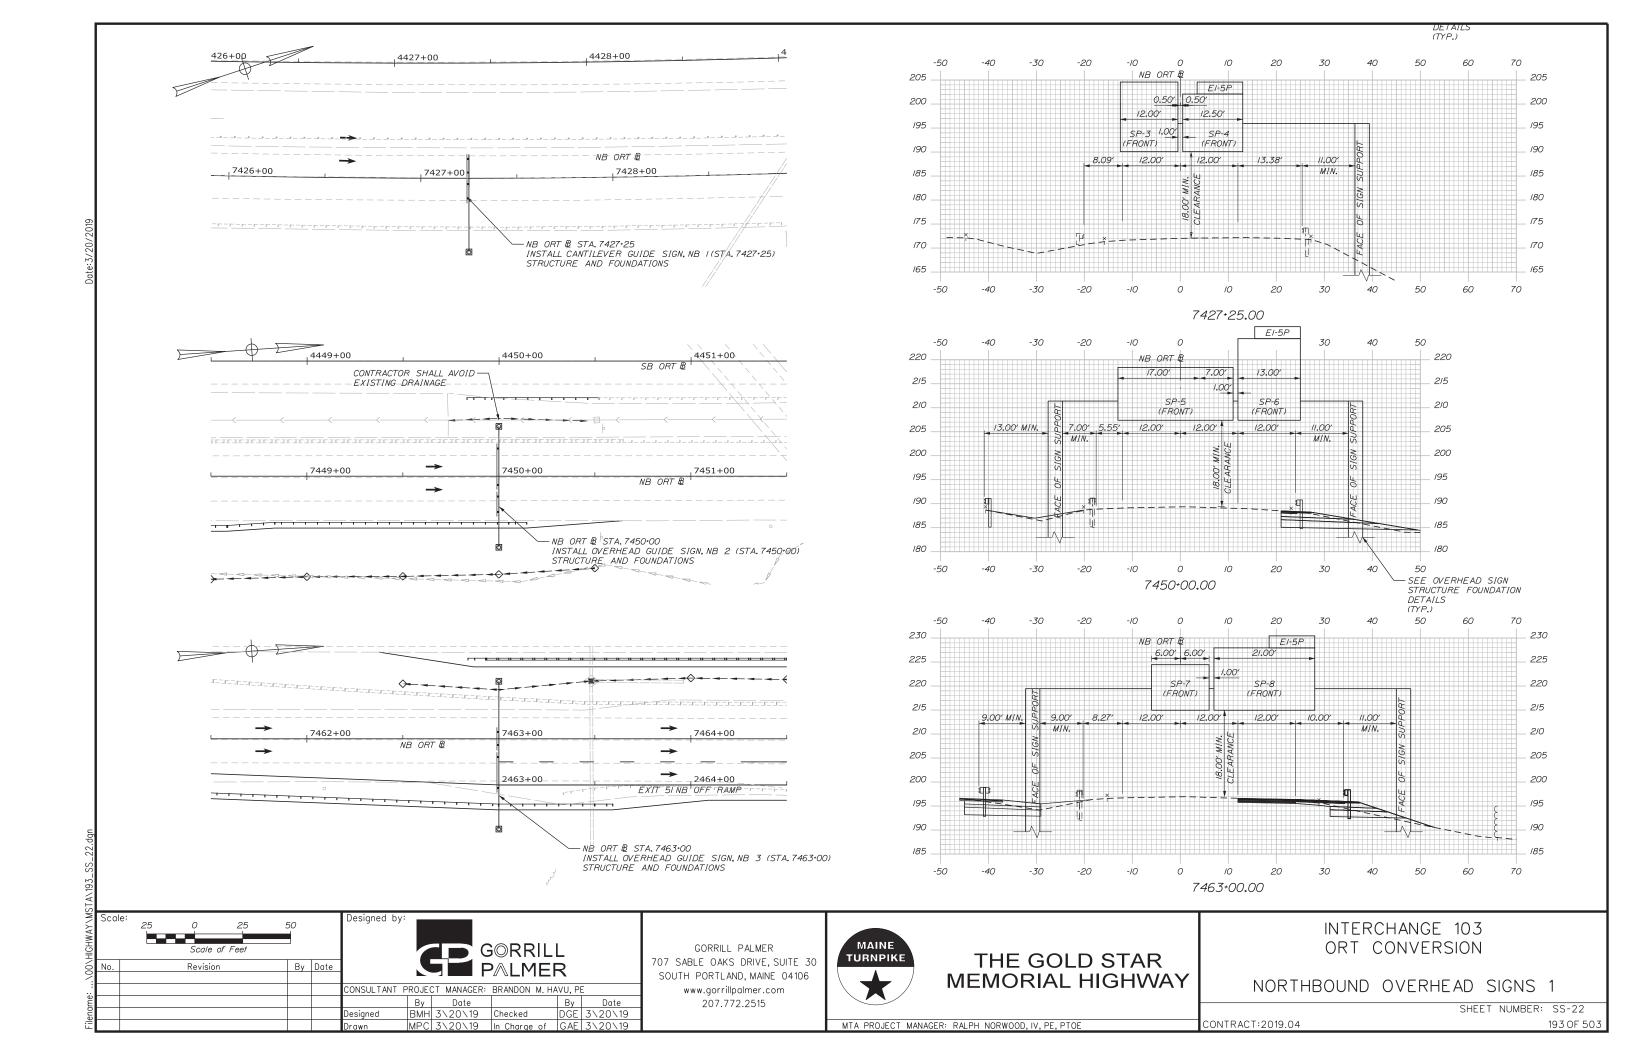

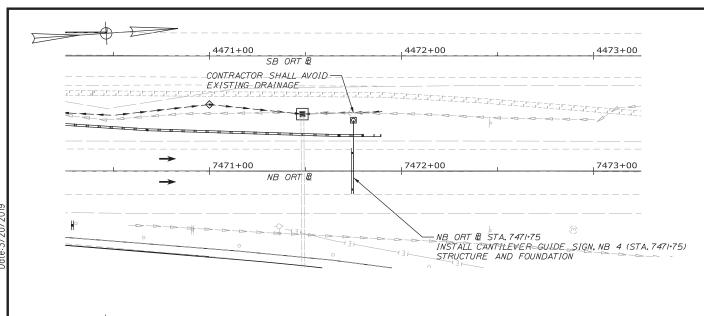

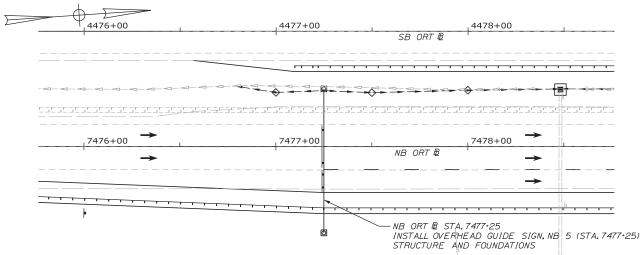

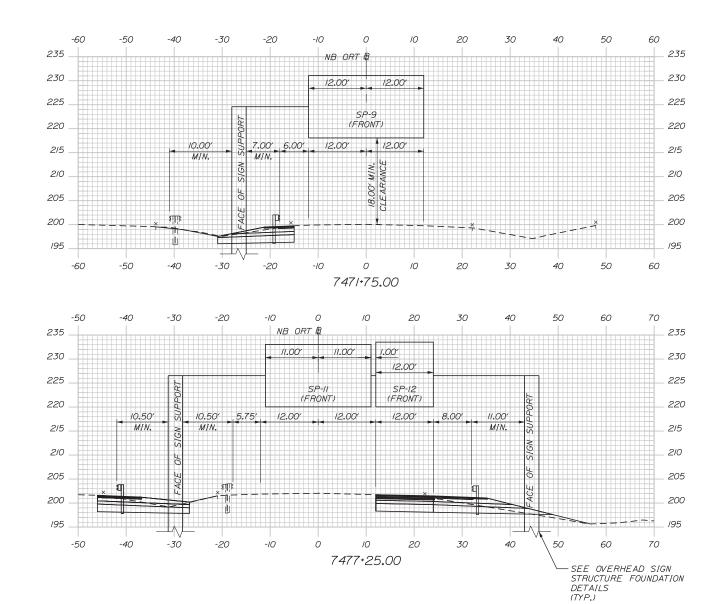

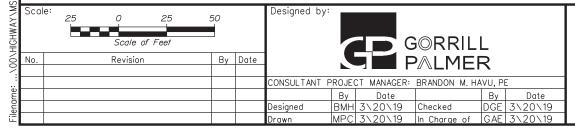

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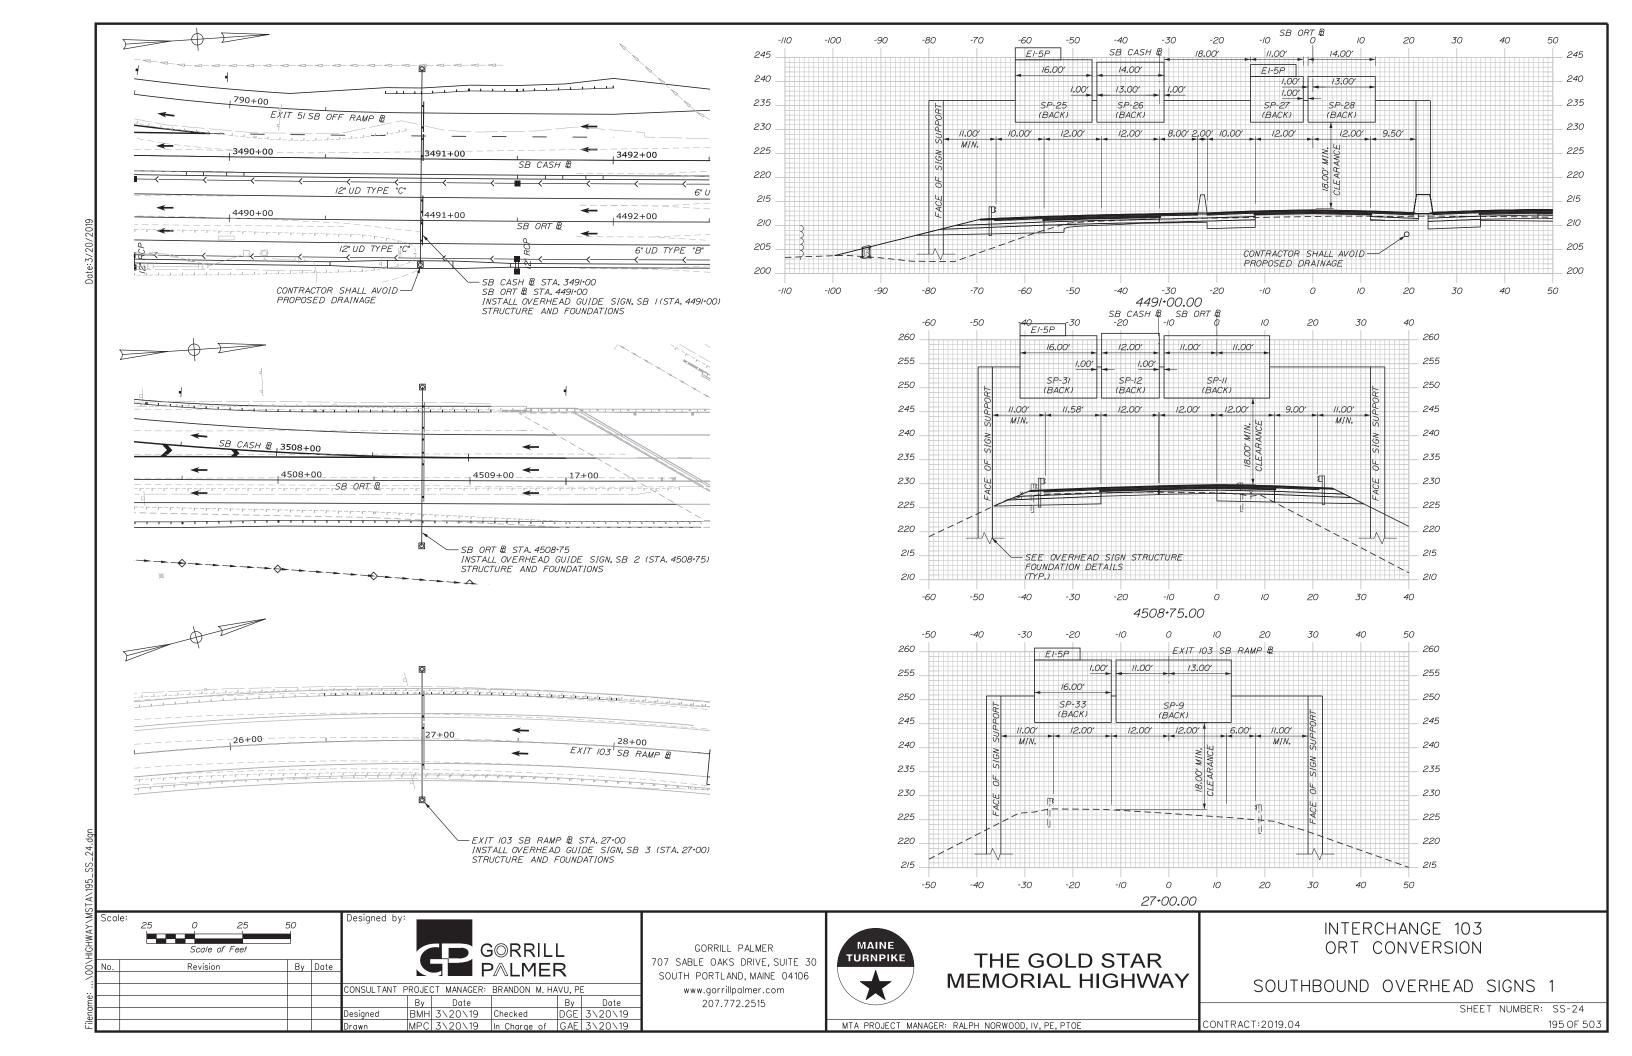



THE GOLD STAR MEMORIAL HIGHWAY INTERCHANGE 103 ORT CONVERSION


NORTHBOUND OVERHEAD SIGNS 2


SHEET NUMBER: SS-23 194 OF 50

MTA PROJECT MANAGER: RALPH NORWOOD, IV, PE, PTOE



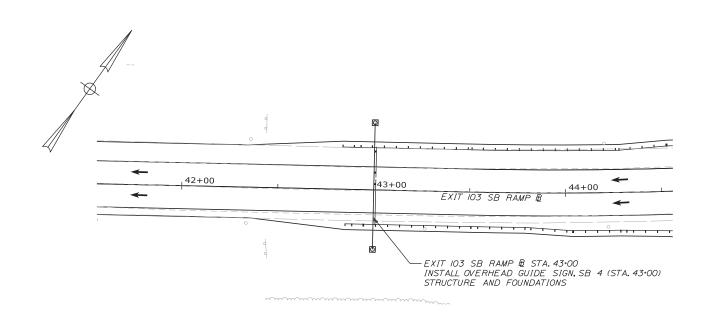

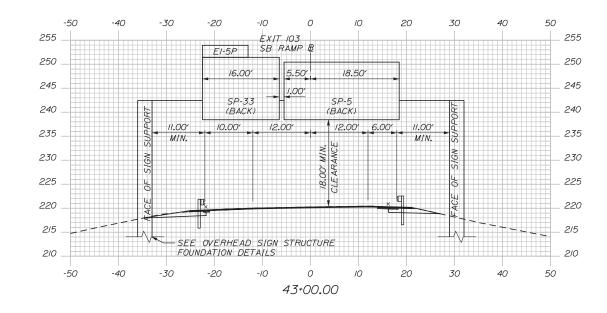

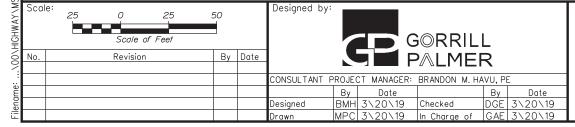

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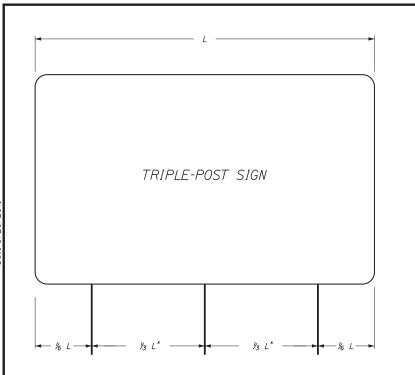
THE GOLD STAR **MEMORIAL HIGHWAY**


INTERCHANGE 103 ORT CONVERSION

SOUTHBOUND OVERHEAD SIGNS 2

SHEET NUMBER: SS-25

MTA PROJECT MANAGER: RALPH NORWOOD, IV, PE, PTOE



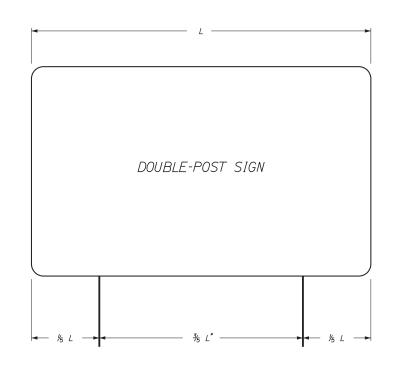


* - A MINIMUM 7 FEET REQUIRED WHEN INSTALLED ON BREAKAWAY DEVICES

POLE SPACING DETAIL

SINGLE SUPPORT SIGNS												
FOUNDATION DIAMETER	SIGN AREA (A)	SIGN WIDTH (W)	POST SIZE	BASE PLATE (I) (3)	MATERIAL	ANCHOR BOLTS (2)	BOLT CIRCLE	MAX!MUM MOUNTING HEIGHT				
	A < 4 FT ²		U CHANNEL POST									
	4 < A <= 10 FT ²		WOOD POST 6"X6"					12 FEET TO				
18"	10 < A <= 16 FT ²	W=4'-O" MAX. BUT INCLUDES 5'-O"YIELD SIGN	W6X9	12"X12"X1" 41 LBS.	A36	Ι" φ Χ 3'-0"	12"	SIGN CENTER				
18"	16 < A <= 25 FT ²	W=5'-O" MAX	W6XI5	12"X12"X1" 41 LBS.	A36	I" ∮ X 3'-O"	12"					
24"	25 < A <= 42 FT ²	W=7'-0" MAX	W8X24	14"X14"X1" 55 LBS.	A36	I-1/4" φ X 3'-6"	14"					

	MULTIPLE SUPPORT SIGNS										
24"	TO 60 FT ² /POST		W8XI8	14"X14"X1" 55 LBS.	A36	I-1/4" φ X 3′-6"	14"				
24"	60-85 FT ² /POST		WIOX22	12"X17"X1-1/4" 72 LBS.	A36	I-I/4" Ø X 3'-6"	/5"	20 FEET TO			
30"	85-IIO FT ² /POST		WI2X26	13"X19"X1-1/4" 87 LBS.	A36	1-1/2" φ X 4'-0"	17"	SIGN CENTER			
30"	110-135 FT ² /POST		WI4X30	14"X21"XI-1/4" 104 LBS.	A36	I-1/2" φ X 4'-0"	19"				

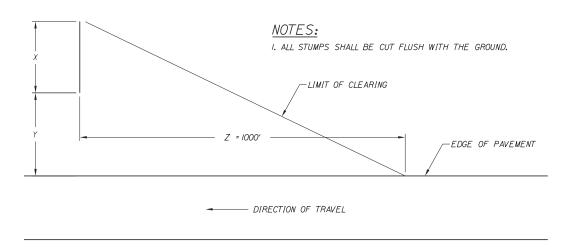

WHERE:

- X = WIDTH OF SIGN + 10' Y = OFFSET TO EDGE OF SIGN FROM EDGE OF PAVEMENT Z = DISTANCE FROM FACE OF SIGN TO A POINT ON THE EDGE OF PAVEMENT 1000' BACK

CLEARING DETAIL **FOR** MAINLINE SIGN INSTALLATION

GENERAL NOTES

- I. BOLTS TO BE 50,000 PSI MINIMUM YIELD STRENGTH.
- 2. POST TO BASE PLATE WELD SHALL BE 5/16" FILLET WELD.
- 3. BASE PLATES AND H-BEAMS SHALL BE HOT DIPPED GALVANIZED AFTER FABRICATION IN ACCORDANCE WITH SECTION 720.06.

BREAKAWAY NOTES

- I. ON 6"X6" WOOD POSTS, DRILL 3/4" DIAMETER HOLES AT RIGHT ANGLES TO ONE ANOTHER 4 INCHES ABOVE GROUND LEVEL TO MEET BREAKAWAY STANDARDS.
- 2. ON BREAKAWAY SUPPORTS, THE HINGE SHOULD BE A MINIMUM OF 7 FEET ABOVE THE FOUNDATION. NO PERMANENT SUPPLEMENTARY SIGNS SHALL BE ATTACHED BELOW THE HINGE. SIGN SHALL BE MOUNTED ABOVE HINGE.
- 3. DIAMETER OF THE FOUNDATION SHALL BE INCREASED IF NEEDED TO LOCATE BREAK-AWAY DEVICE ANCHOR BOLTS WITHIN THE FOUNDATION REINFORCING ANY NECESSARY INCREASE IN SIZE SHOULD BE CONSIDERED INCIDENTAL TO THE ORIGINAL CONCRETE FOUNDATION SIZE SPECIFIED ON THE

REMOVE AND RESET GUIDE SIGN NOTES I. EXISTING SIGN POST LENGTHS ARE APPROXIMATE AND SHALL BE FIELD VERIFIED BY THE CONTRACTOR IF THE POSTS ARE TO BE REUSED.

2. PROPOSED POST LENGTHS ARE MEASURED FROM THE TOP OF THE FOUNDATION TO THE TOP OF SIGN AND ARE APPROXIMATE. FINAL POST LENGTHS SHALL BE DETERMINED BY THE CONTRACTOR ONCE FOUNDATIONS ARE

Signing	Sca	le:			Designed by:					
A\197_		Not to Scale					G	©RRIL	L	
\MST	No.	Revision	Ву	Date			P	PALMEI	₹	
.:					CONSULTANT F	PROJE	CT MANAGER:	BRANDON M. HA	AVU, PI	
me						Ву	Date		Ву	Date
ilename:					Designed	ВМН	3\20\19	Checked	DGE	3\20\19
Ē					Drawn	MPC	3\20\19	In Charge of	GAE	3\20\19

GORRILL PALMER 707 SABLE OAKS DRIVE, SUITE 30 SOUTH PORTLAND, MAINE 04106 www.gorrillpalmer.com 207.772.2515



THE GOLD STAR **MEMORIAL HIGHWAY**

INTERCHANGE 103 ORT CONVERSION

SIGNING DETAILS

SHEET NUMBER: SS-26

MTA PROJECT MANAGER: RALPH NORWOOD, IV. PE, PTOE

REMOVE AND STACK SIGN SUMMARY - POST MOUNTED

DESCRIPTION	QUANTITY	(CONT F	SIGN SIZE RACTOR TO V	(ERIFY)	COL	.OR	DIRECTION	LOCATION	
		HEIGHT (IN.)	WIDTH (IN.)	AREA (SQ. FT.)	BACKGROUND	LEGEND	(SB-SOUTHBOUND) (NB-NORTHBOUND)		
Visitor Info Center Truck Stop Power Heat A/C Internet	1	30 66 24	66 108	13.75 (13.75) 49.50 (49.50)	BLUE BLUE BROWN	WHITE WHITE WHITE	NB	STA. 7401-25, RT.	
Center for Maine Craft TOLL PLAZA	/		108	/8.00 (/8.00) 75.00					
1 MILE	/	72 24	150 120	(75.00) 20.00 (20.00)	YELLOW YELLOW	BLACK BLACK	NB	STA. 7436+10, RT.	
TO SOUTH 95 Lewiston Aubtum NEXT RIGHT	/	120	168	140.00 (140.00)	GREEN	WHITE	NB	STA. 7447+85, RT.	
CHECK BRAKES	4	36	42	10.50 (42.00)	YELLOW	BLACK	NB NB SB SB	STA. 7450+53, LT. STA. 7450+53, RT. STA. 42+45, LT. STA. 42+45, RT.	
REDUCED SPEED AHEAD	8	30	24	5.00 (40.00)	WHITE	BLACK	NB NB NB SB SB	STA. 7472-46, LT. & RT. STA. 8485-58, RT. STA. 7486-73, LT. STA. 3496-05, LT. & RT. STA. 26-90, LT. & RT.	
TOLL PLAZA 1500 FT CARS \$1.00	2	72 24	150 120	75.00 (150.00) 20.00 (40.00)	YELLOW YELLOW	BLACK BLACK	NB SB	STA. 7477•95, RT. STA. 3507•90, LT.	
RUMBLE STRIP AHEAD	2	48	48	16.00 (32.00)	YELLOW	BLACK	NB	STA. 7478•50, LT. STA. 7478•50, RT.	
SPEED LIMIT	2	60	48	20.00 (40.00)	WHITE	BLACK	NB	STA. 7479•35, LT. STA. 7479•35, RT.	
E-ZOOD ONLY LANE 4 ALL OTHERS PROHIBITED	2	120	96	80.00 (160.00)	PURPLE	WHITE	NB SB	STA. 7482•88, LT. STA. 4502•41, RT.	
ONLY LANE 2 CASH RECEIPTS FROHIBITED F. 2000	2	120	192	160.00 (320.00)	PURPLE/ WHITE	WHITE/ BLACK	NB SB	STA. 7482•88, RT. STA. 3502•43, LT.	
END TOLL PLAZA SPEED	2	60	48	20.00 (40.00)	WHITE	BLACK	SB NB	STA. 3487•45, LT. STA. 8495•50, RT.	
SPEED LIMIT AT TOLL PLAZA 10 M P H	2	84	108	63.00 (126.00)	YELLOW	BLACK	NB SB	STA. 8484•28, RT. STA. 3497•53, LT.	
E-ZPOSS ACCEPTED ALL LANES	3	96	120	80.00 (240.00)	GREEN/ PURPLE	WHITE	NB EXIT 51 NB ON RAMP SB	STA. 8484·96, RT. STA. 886·81, RT. STA. 3501·48, LT.	

RFMOVF	$\Delta N/\Omega$	$ST\Delta CK$	SIGN	$SIIMM\Delta RY$	- POST	MOUNTED

DESCRIPTION	QUANTITY	(CONT F	SIGN SIZE RACTOR TO V	ERIFY)	COL	.OR	DIRECTION	LOCATION
		HEIGHT (IN.)	WIDTH (IN.)	AREA (SQ. FT.)	BACKGROUND	LEGEND	(SB-SOUTHBOUND) (NB-NORTHBOUND)	
TOLL PLAZA 600 FT CARS \$1.00	1	72 24	156 120	78.00 (78.00) 20.00 (20.00)	YELLOW YELLOW	BLACK BLACK	EXIT 51 NB ON RAMP	STA. 885•75, RT.
FARE SCHEDULE SIGN	3	84	144	84.00 (252.00)	WHITE	BLACK	NB EXIT 51 NB ON RAMP SB	STA, 8486·96, RT. STA, 888·27, RT. STA, 3499·01, LT.
(t)	2	48	48	16.00 (32.00)	YELLOW	BLACK	NB NB	STA. 8487*4I. RT. STA. 5244*85, RT.
WRONG WAY	3	30	42	8.75 (26.25)	RED	WHITE	SB NB NB	STA. 4487·92, RT. STA. 3496·05, LT. STA. 3496·05, RT.
YIELD	2	60	60	25.00 (50.00)	RED/ WHITE	RED	EXIT 51 NB ON RAMP NB	STA. 888+69, RT. STA. 7535+60, RT.
(A)	2	48	48	16.00 (32.00)	YELLOW	BLACK	EXIT 51 NB ON RAMP SB	STA. 889·66, LT. STA. 3497·07, LT.
WEST GARDINER SERVICE PLAZA FOOD - FUEL - ATM CONTRIBUTION OF THE	; ; ; ;	30 84 24 12 24	60 204 192 156 24	12.50 (12.50) 119.00 (119.00) 32.00 (32.00) 13.00 (13.00) 4.00 (8.00)	BLUE BLUE BROWN BLUE BLUE	WHITE WHITE WHITE WHITE WHITE	SB	STA. 3490+25, LT.
SPEED LIMIT	2	12 60	48 48	4.00 (8.00) 20.00 (40.00)	YELLOW WHITE	BLACK BLACK	NB SB	STA. 8490*82, RT. STA. 3494*00, LT.
DO NOT ENTER	3	48	48	16.00 (48.00)	WHITE/ RED	WHITE	SB NB NB	STA. 7490•79, LT. STA. 3495•20, LT. STA. 3495•20, RT.
	2	36	36	9.00 (18.00)	WHITE	RED/ BLACK	NB SB	STA. 7490·89, LT. STA. 4495·08, RT.
▼ ↑	/	60 18	48 18	20.00 (20.00) 2.25 (2.25)	WHITE YELLOW	BLACK BLACK/ YELLOW	SB	STA. 4490·89, RT.
(II) (II) (III) (III)	/	60 48 18	48 36 18	20.00 (20.00) (2.00 (12.00) 2.25 (2.25)	WHITE WHITE YELLOW	BLACK BLACK BLACK/ YELLOW	NB	STA. 7495·08, LT.
underclearance Turnpike Structures 13' 6"	/	48	60	20.00	YELLOW	BLACK	NB	STA. 8492-27, RT.
						INITE	ERCHANGE 10:	3

CONTRACT:2019.04

Scale: GORRILL GORRILL PALMER By Date Revision CONSULTANT PROJECT MANAGER: BRANDON M. HAVU, PE Designed

GORRILL PALMER 707 SABLE OAKS DRIVE, SUITE 30 SOUTH PORTLAND, MAINE 04106 www.gorrillpalmer.com 207.772.2515



THE GOLD STAR **MEMORIAL HIGHWAY**

INTERCHANGE 103 ORT CONVERSION SIGN SUMMARY -REMOVE AND STACK 1

SHEET NUMBER: SS-27

REMOVE AND STACK SIGN SUMMARY - COLUMN AND BOOTH MOUNTED

DESCRIPTION	QUANTITY	(CONTF	SIGN SIZE RACTOR TO V	(ERIFY)	COL	.OR	DIRECTION (SB-SOUTHBOUND)	LOCATION
		HEIGHT (IN.)	WIDTH (IN.)	AREA (SQ. FT.)	BACKGROUND	LEGEND	(SB-SOUTHBOUND) (NB-NORTHBOUND)	
NO PARKING	3	30	24	5.00 (/5.00)	WHITE	BLACK	NB NB NB	STA. 8494+26, RT. STA. 8500+36, RT. STA. 8504+94, RT.
RESERVED PARKING	1	18	12	1.50 (1.50)	BLUE/ WHITE	WHITE/ GREEN	NB	STA. 8494·43, RT.
EMPLOYEES PARKING ONLY	3	18	24	3.00 (9.00)	GREEN	WHITE	NB NB NB	STA. 8494•76, RT. STA. 8495•II, RT. STA. 8495•37, RT.
MANE TURNPIKE DEDICATED 1986	/	108	72	54.00 (54.00)	RED/ WHITE	BLACK/ GOLD/ WHITE	NB	STA. 7496+29, LT.
Save timesave money E-ZPass 1-888-MTA-PASS	2	48	60	20.00 (40.00)	PURPLE	WHITE	NB SB	STA. 8500•36, RT. STA. 3502•30, LT.
WIDE LOADS KEEP TO FAR - RIGHT →	2	48	96	32.00 (64.00)	WHITE	BLACK	NB SB	STA. 7485+58, LT. STA. 4500+53, RT.
SPEED LIMIT 35	2	60	48	20.00 (40.00)	WHITE	BLACK	SB	STA. 3504·03, LT. STA. 3504·05, RT.
END 295 BEGIN 95	/	96	48	32.00 (32.00)	GREEN	WHITE	NB	STA. 8504·94, RT.
MERGE	/	12	36	3.00 (3.00)	YELLOW	BLACK	NB	STA. 5244·85, RT.
LEFT LANE ENDS 1500 FEET	2	48 18	48 30	16.00 (32.00) 3.75 (7.50)	YELLOW YELLOW	BLACK/ RED BLACK	NB	STA. 7519+10, LT.&RT.
9 126 Gardiner Litchfield	/	24 144	60 144	10.00 (10.00) 144.00 (144.00)	GREEN GREEN	WHITE WHITE	SB	STA. 22•96, LT.
EXIT & NILE	/	36	36	9.00 (9.00)	GREEN	WHITE		
WEST GARDINER SERVICE PLAZA	/	24	60	10.00 (10.00)	BLUE	WHITE	SB	STA. 31+91, LT.
GET CASH TOLL RECEIPT AFEA PER REQUISED TOLL UPON RESENTEY TO SOUTH VALID AT BUT TOE ONLY WILLE M. MILE	/	150 24	168 168	175.00 (175.00) 28.00	BLUE BROWN	WHITE WHITE	J. J	31 A. 31 31, E1.
PASSENGER CARS \$1.00	1	48	72	(28.00) 24.00 (24.00)	YELLOW	BLACK	SB	STA. 33-72, RT.

DESCRIPTION	QUANTITY SIGN SIZE (CONTRACTOR TO VERIFY)				COL	.OR	DIRECTION (SB-SOUTHBOUND)	LOCATION
		HEIGHT (IN.)	WIDTH (IN.)	AREA (SQ. FT.)	BACKGROUND	LEGEND	(NB-NORTHBOUND)	
LANES 2 1	2	72	54	27.00 (54.00)	YELLOW	BLACK	NB SB	STA. 7492•92, I2′ RT. STA. 4493•05, 25′ LT.
LANES 4 3	2	72	54	27.00 (54.00)	YELLOW	BLACK	NB SB	STA. 7492•92, 21' LT. STA. 4493•05, 8' RT.
SPEED LIMIT 10	4	36	30	7.50 (30.00)	WHITE	BLACK	NB NB SB SB	STA. 7492·92, 3' LT. STA. 7492·92, 38' LT. STA. 4493·05, 10' LT. STA. 4493·05, 6' RT.
	5	36	36	9.00 (45.00)	YELLOW	BLACK	NB NB SB SB SB	STA. 7492•92, 7' LT. STA. 8492•80, 5' RT. STA. 4493•05, 6' LT. STA. 4493•05, 27' RT. STA. 3493•20, 15' LT.
E-Zess ONLY	2	36	36	9.00 (18.00)	PURPLE	WHITE	NB SB	STA. 7492•70, 5′ LT. STA. 4493•26, 9′ LT.
E-Zass Only	2	36	36	9.00 (18.00)	PURPLE	BLACK	NB SB	STA. 7492•70, I2' RT. STA. 4493•26, 25' LT.

<u>REMOVE AND STACK SIGN SUMMARY - CANOPY/BRIDGE MOUNTED</u>

DESCRIPTION	QUANTITY	(CONT F	SIGN SIZE RACTOR TO V	ERIFY)	COL	.OR	DIRECTION (SB-SOUTHBOUND)	LOCATION	
		HEIGHT (IN.)	WIDTH (IN.)	AREA (SQ. FT.)	BACKGROUND	LEGEND	(NB-NORTHBOUND)		
DYNAMIC	4	72	120	60.00 (120.00)	DYNA	AMIC	NB SB NB SB	STA. 7492-68, 30' LT. STA. 4493-28, 30' RT. WEST GARDINER I-95 TOLL PLAZA	
E-ZPSS OTHERS PROHIBITED	2	48	144	48.00 (96.00)	PURPLE	WHITE	NB SB	STA. 7492+68, 6′ RT. SA. 4493+28, I7′ LT.	
ANY VEHICLE CASH / RECEIPTS	4	48	144	48.00 (192.00)	WHITE	BLACK	NB NB SB SB	STA. 7492*68, 12' LT. STA. 7492*68, 24' RT. STA. 4493*28, 0' LT. STA. 4493*28, 34' LT.	

CONTRACT:2019.04

Scale: **G** G ⊗ RRILL PALMER Revision By Date CONSULTANT PROJECT MANAGER: BRANDON M. HAVU, PE Designed

GORRILL PALMER 707 SABLE OAKS DRIVE, SUITE 30 SOUTH PORTLAND, MAINE 04106 www.gorrillpalmer.com 207.772.2515



THE GOLD STAR **MEMORIAL HIGHWAY**

INTERCHANGE 103 ORT CONVERSION SIGN SUMMARY -REMOVE AND STACK 2

SHEET NUMBER: SS-28

REMOVE AND RESET SIGN SUMMARY

EXISTING								PROPOSED							
DESCRIPTION	HEIGHT	SIGN SIZE RACTOR TO V	(ERIFY) AREA	NUMBER AND TYPE OF POSTS	CO. BACKGROUNE	LEGEND	DIRECTION - (SB-SOUTHBOUND) (NB-NORTHBOUND)	LOCATION	NUMBER OF POSTS, TYPE AND SIZE (CONTRACTOR TO VERIFY)	FOUNDATION SIZE AND TYPE (CONTRACTOR TO VERIFY)	BREAKAWAY DEVICE	DIRECTION (SB-SOUTHBOUND) (NB-NORTHBOUND)	LOCATION	PAY ITEM NUMBER	
FOOD - EXIT 51	(IN.) 144	(IN.) 174	(SQ. FT.) 174.00	2 STEEL	BLUE	WHITE	NB	STA. 7428·89, RT.	SIGN TO BE PLACED ON EXISTING POSTS AND FOUNDATION (CONTRACTOR TO REVIEW SIZE AND CONDITION)	SIGN TO BE PLACED ON EXISTING POSTS AND FOUNDATION (CONTRACTOR TO REVIEW SIZE AND CONDITION)	YES	NB	STA. 740I-23, RT.	645.501	
GAS - EXIT 51	120	120	100.00	2 STEEL	BLUE	WHITE	NB	STA. 7458·48, RT.	2 - W8XI8	24" DIA.	YES	NB	STA. 7440·50, RT.	645.502	
EMERGENCY STOPPING ONLY	30	48	100	I WOOD	WHITE	BLACK	SB	STA. 3487•12, LT.	I-WOOD POST	N/A	YES	SB	STA. 4458+00, LT.	645.109	
WISTOR INFO CENTER EXIT 30 MPH	42 48	48 36	14.00 12.00	MOUNTED TO OVERHEAD SIGN STRUCTURE	BLUE YELLOW	WHITE BLACK	NB	STA. 7466•75, RT.	I - W8X24	24" DIA.	YES	NB	STA. 7467+00, RT.	645.503	
51 7	72	60	30.00	I STEEL I STEEL	GREEN	WHITE	NB SB	STA. 7470•91, RT. STA. 3488•06, LT.	I - W8X24 I - W8X24	24" DIA. 24" DIA.	YES YES	NB SB	STA. 7470•29, RT. STA. 3488•27, LT.	645.504 645.505	
WRONG WAY	30	42	8.75	I STEEL I STEEL I STEEL	RED	WHITE	NB NB NB	STA. 888+69, RT. STA. 7470-91, RT. STA. 8487+41, RT.	I-WOOD POST	N/A	YES YES YES	NB NB NB	STA. 888*69, RT. STA. 7470*29, RT. STA. 8487*38, RT.	645.109	
295	12 36	24 36	2.00 9.00	l STEEL	BLUE	WHITE	SB	STA. 3481·50, LT.	I - W6X9	I8" DIA.	YES	SB	STA. 4474+00, LT.	645.506	
\$200 FINE FOR LITTERING	30	48	10.00	I WOOD	WHITE	BLACK	SB	STA. 3483•73, LT.	I-WOOD POST	N/A	YES	SB	STA. 3483•75, LT.	645.109	
EXIT 30 MPH	48	36	12.00	l STEEL	YELLOW	BLACK	EXIT 51 SB OFF RAMP	STA. 788•04	I - W6X9	IS" DIA.	YES	EXIT 51 SB OFF RAMP	STA. 789·50, LT.	645.507	
DO NOT ENTER	48	48	16.00	l STEEL	WHITE/ RED	WHITE	NB	STA. 8490·82, RT.	/ - W6X9	IS" DI A.	YES	NB	STA. 8492+00, RT.	645.508	
RAMP SPED LIMIT 60	12 60 18	48 48 12	4.00 20.00 1.50	I WOOD	YELLOW WHITE WHITE	BLACK BLACK BLACK	NB	STA. 75/2•60, RT.	I - W8X24	24" DIA.	YES	NB	STA. 75/5•00, RT.	645.509	
MILE 1 0 3	24	12	2.00	I U-CHANNEL	GREEN	WHITE	NB	STA. 7536•23, RT.	I - U-CHANNEL POST	N/A	YES	NB	STA. 7536•25, RT.	645.109	

Scale:

GORRILL PALMER Revision By Date CONSULTANT PROJECT MANAGER: BRANDON M. HAVU, PE
 By
 Date
 By
 Date

 BMH 3\20\19
 Checked
 DGE 3\20\19

 MPC 3\20\19
 In Charge of GAE 3\20\19

GORRILL PALMER 707 SABLE OAKS DRIVE, SUITE 30 SOUTH PORTLAND, MAINE 04106 www.gorrillpalmer.com 207.772.2515



THE GOLD STAR **MEMORIAL HIGHWAY**

INTERCHANGE 103 ORT CONVERSION SIGN SUMMARY -REMOVE AND RESET

SHEET NUMBER: SS-29

MTA PROJECT MANAGER: RALPH NORWOOD, IV, PE, PTOE

CONTRACT:2019.04 200 OF 503

DENTIFICATION NUMBER	DESCRIPTION	QUANTITY		SIGN SIZE		CO	LOR	NUMBER OF POSTS	POST SIZE		HEIGHT OF POS TOR TO CONFIR		FOUNDATION SIZE AND TYPE	BREAKAWAY DEVICE	DIRECTION (SB-SOUTHBOUND)	LOCATION	PAY ITE
NOMBEN			HEIGHT ([N.)	WIDTH ([N.)	AREA (SQ. FT.)	BACKGROUNL	LEGEND	01 10313		LEFT (FEET)	CENTER (FEET)	RIGHT (FEET)	SIZE AND THE	DEVICE	(NB-NORTHBOUND)		NOWEL
M6-2	7	2	21	30	4.375 (8.75)	YELLOW	BLACK	4			MOUNT WITH	W3-5		-	NB SB	STA. 7476+00, RT. STA. 3509+50, LT.	645.27) 645.27)
RI-I	STOP	1	48	48	16.00 (16.00)	RED	WHITE	/	W6XI5	-	-	-	18" DIA.	YES	ACCESS ROAD	STA. II8•33, RT.	645.27
RI-2	YIELD	2	60	60	25.00 (50.00)	WHITE/ RED	RED	,	W6X9	-	-	-	18" DI A.	YES	SB NB	STA. 348I+50, LT. STA. 75I3+00, RT.	645.27 645.27
R2-I(IO)	SPEED LIMIT 10	2	60	48	20.00 (40.00)	WHITE	BLACK	/	W8X24	-	-	-	24" DIA.	YES	NB SB	STA. 8498•50, RT. STA. 3501•50, LT.	645.2 645.2
R2-I(IO)	SPEED LIMIT 10	6	60	48	20.00 (120.00)	WHITE	BLACK	4			MOUNT TO BO	ООТН		<u> </u>	NB NB NB SB SB SB SB	STA. 8499-38, 16' RT. STA. 8499-38, 36' RT. STA. 8499-38, 4' LT. STA. 3500-61, 16' LT. STA. 3500-61, 36' LT. STA. 3500-61, 4' RT.	645.2 645.2 645.2 645.2 645.2 645.2
R2-I(35) WITH FLAGS	SPEED LIMIT 35	2	60	48	20.00 (40.00)	WHITE	BLACK	/	W6X/5	-	-	-	18" DIA.	YES	NB SB	STA. 8494+00, RT. STA. 3505+50, LT.	645.2 645.2
R2-I(45)	SPEED LIMIT 45	1	60	48	20.00 (20.00)	WHITE	BLACK	/	W8X24	-	-	-	24" DIA.	YES	NB	STA. 8480•50, RT.	645.2
DYNAMIC R2-I(60)	SPEED LIMIT 60	,	60	48	20.00 (20.00)	WHITE	BLACK	-		A	I IOUNT TO SPACE	FRAME			NB .	STA. 7500+13	645,15
DYNAMIC R2-I(70)	SPEED LIMIT 70	1	60	48	20.00 (20.00)	WHITE	BLACK			A	OUNT TO SPACE	FRAME		•	SB	STA. 4499•87	645./5
R5-I	DO NOT ENTER	1	48	48	/6.00 (/6.00)	WHITE/ RED	WHITE	4		MOUNT	ON REVERSE S	IDE OF SP-21		•	NB	STA. 3498·65, LT.	645.2
R5-II	AUTHORIZED VEHICLES ONLY	5	24	30	5.00 (25.00)	WHITE	BLACK	/	6X6 WOOD POST	-	-	-	-	YES	ACCESS ROAD ACCESS ROAD ACCESS ROAD ACCESS ROAD ACCESS ROAD	STA. II8·3I, RT. STA. II8·32, RT. STA. II8·59, RT. STA. II8·60, RT. STA. IO0·4I, RT.	645.2 645.2 645.2 645.2 645.2
R6-IR	ONE WAY	1	12	36	3.00 (3.00)	BLACK/ WHITE	BLACK	-			MOUNT WITH	RI-I		-	ACCESS ROAD	STA. 118•33, RT.	645.2
R7-8	RESERVED PARKING	2	18	12	1.50 (3.00)	BLUE/ WHITE	WHITE/ GREEN	,	U-CHANNEL POST	-	-	-	-	YES	EMPLOYEE PARKING PARK & RIDE LOT	STA. 119·50, RT. STA. 98·84, LT.	645.2 645.2
R7-8P	VAN ACCESSIBLE	2	9	18	1.125 (2.25)	WHITE	GREEN	4			MOUNT WITH	R7-8	1	-	EMPLOYEE PARKING PARK & RIDE LOT	STA. 119•50, RT. STA. 98•84, LT.	645.2 645.2

Scale:

Revision

GORRILL PALMER CONSULTANT PROJECT MANAGER: BRANDON M. HAVU, PE

 By
 Date
 By
 Date

 BMH 3\20\19
 Checked
 DGE 3\20\19

 MPC 3\20\19
 In Charge of GAE 3\20\19

By Date

Designed

707 SABLE OAKS DRIVE, SUITE 30 SOUTH PORTLAND, MAINE 04106 www.gorrillpalmer.com 207.772.2515



THE GOLD STAR MEMORIAL HIGHWAY

SIGN SUMMARY -PROPOSED 1

CONTRACT:2019.04

SHEET NUMBER: SS-30

<u>PROPOSED</u>	SIGN	SUMMARY

IDENTIFICATION	DESCRIPTION	QUANTITY		SIGN SIZE		COLOR		NUMBER	POST SIZE (CONT		HEIGHT OF POST CONTRACTOR TO CONFIRM HEIGHT)		FOUNDATION	BREAKAWAY	DIRECTION	LOCATION	PAY ITEM
NUMBER			HEIGHT ([N.)	WIDTH (IN.)	AREA (SQ. FT.)	BACKGROUND	LEGEND	OF POSTS		LEFT (FEET)	CENTER (FEET)	RIGHT (FEET)	SIZE AND TYPE	DEVICE	(SB-SOUTHBOUND) (NB-NORTHBOUND)		NUMBER
R8-3a	NO PARKING	7	48	48	16.00 (112.00)	WHITE	RED	1	W6X9	-	-	-	18" DIA.	YES	NB NB NB NB SB SB SB	STA. 8492·00, RT. STA. 8497·00, RT. STA. 8499·00, RT. STA. 8500·50, RT. STA. 3499·50, LT. STA. 3501·00, LT. STA. 3504·75, LT.	645.271 645.271 645.271 645.271 645.271 645.271 645.271
SP-I	PAY TOLL 2 MILES CARS \$1.00	/	66	96	44.00 (44.00)	YELLOW	BLACK	2	W8XI8	-	-	-	24" DIA.	YES	NB	STA. 7377+87, RT.	645.271
SP-2	INFO MC	/	36	174	43.50 (43.50)	BLUE	WHITE	MOUNT ON EXISTING FOUNDATION AND POSTS MOUNT WITH RESET SIGN (CONTRACTOR SHALL VERIFY EXISTING SIGN WIDTH AND MATCH ACCORDINGLY)							NB	STA. 7401-23, RT.	645.251
SP-3	NORTH S Augusta TOLL PLAZA 1 MILE	/	174	144	174.00 (174.00)	GREEN/ YELLOW	WHITE/ BLACK	-	MOUNT TO CANTILEVER STRUCTURE							STA. 7427·25, LT.	645.151
SP-4	South To (35) (Compared to the state of th	/	144	150	150.00 (150.00)	GREEN	WHITE	-	MOUNT TO CANTILEVER STRUCTURE							STA. 7427+25, RT.	645.151
SP-5	PAY TOLL ½ MILE E-2000 CASH ONLY CARS \$1.00 KEEP LEFT KEEP RIGHT	2	132	288	264.00 (528.00)	YELLOW/ PURPLE/ GREEN	BLACK/ WHITE	4	MOUNT TO OVERHEAD STRUCTURE							STA. 7450+00, LT. STA. 43+00, LT.	645.121 645.127
SP-6	9 [128] Gardiner Litchfield ¼ Mile LISTEXT BEFORE TOLL	/	204	156	221.00 (221.00)	GREEN/ YELLOW	WHITE/ BLACK	•	MOUNT TO OVERHEAD STRUCTURE							STA. 7450+00, RT.	645.121
SP-7	NORTH 95 Augusta	/	114	144	114.00 (114.00)	GREEN	WHITE	4	MOUNT TO OVERHEAD STRUCTURE							STA. 7463+00, LT.	645.122
SP-8	9 [126] Gardiner Litchfield LAST EAT REFORE TOLL	/	156	252	273.00 (273.00)	GREEN/ YELLOW	WHITE/ BLACK	4		MOUN	IT TO OVERHEAD	STRUCTURE		•	NB	STA. 7463+00, RT.	645.122
SP-9	PAY TOLL 1/4 MILE F-2900 ONLY NO CASH	2	156	288	312.00 (624.00)	YELLOW/ GREEN	BLACK/ WHITE	4			TO CANTILEVER IT TO OVERHEAD			-	NB SB	STA. 7471+75 STA. 27+00, RT.	645.I52 645.I26
SP-10	WIDE LOADS KEEP TO FAR ■ RIGHT →	3	48	96	32.00 (96.00)	WHITE	BLACK	2	W8XI8	-	-	-	24" DIA.	YES	NB EXIT 51 NB ON RAMP SB	STA. 7473+50, RT. STA. 884+50, RT. STA. 25+50, LT.	645.271 645.271 645.271
SP-II	E-ZOSS ONLY NO CASH NO CASH	2	156	264	286.00 (572.00)	PURPLE/ GREEN	WHITE/ BLACK	•	1	MOUN	IT TO OVERHEAD	STRUCTURE	1	•	NB SB	STA. 7477•25 STA. 4508•75, RT.	645.123 645.125
SP-I2	STOP AHEAD PAY TOLL CASH CARS \$1.00	2	162	144	162.00 (324.00)	YELLOW/ GREEN	BLACK/ WHITE	-		MOUN	IT TO OVERHEAD	STRUCTURE		•	NB SB	STA. 7477•25, RT. STA. 4508•75, LT.	645.123 645.125

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9	INO.	Revision	Ву	Date			P	MLMER	~	
Ĺ:					CONSULTANT F	PROJEC	CT MANAGER:	BRANDON M. HA	AVU, PE	
me						Ву	Date		Ву	Date
ilename:					Designed	ВМН	3\20\19	Checked	DGE	3\20\19
Ě					Drawn	MPC	3\20\19	In Charge of	GAE	3\20\19

GORRILL PALMER 707 SABLE OAKS DRIVE, SUITE 30 SOUTH PORTLAND, MAINE 04106 www.gorrillpalmer.com 207.772.2515



THE GOLD STAR MEMORIAL HIGHWAY

INTERCHANGE 103 ORT CONVERSION SIGN SUMMARY -PROPOSED 2

CONTRACT:2019.04

SHEET NUMBER: SS-31

PROPOSED SIGN SUMMARY																	
IDENTIFICATION NUMBER	DESCRIPTION	QUANTITY		SIGN SIZE		COL	_OR	NUMBER OF POSTS	POST SIZE		HEIGHT OF POST TOR TO CONFIRM		FOUNDATION SIZE AND TYPE	BREAKAWAY DEVICE	DIRECTION (SB-SOUTHBOUND)	LOCATION	PAY ITEM NUMBER
			HEIGHT (IN.)	WIDTH (IN.)	AREA (SQ. FT.)	BACKGROUND	LEGEND			LEFT (FEET)	CENTER (FEET)	RIGHT (FEET)			(NB-NORTHBOUND)		
SP-13	PAY TOLL ¼ MILE CARS \$1.00	/	66	96	44.00 (44.00)	YELLOW	BLACK	-	INSTALL ON EXISTING POSTS AND FOUNDATIONS					NB	STA. 885-75, RT.	645.271	
SP-14	E-Z988 ACCEPTED ALL LANES	2	36	48	12.00 (24.00)	PURPLE/ GREEN	WHITE	/	W6X9	-	-	-	I8" DIA.	YES	NB SB	STA. 8490+25, RT. STA. 3507+50, LT.	645.271 645.271
SP-15	DYNAMIC	4	48	160	53 . 33 (2/3 . 33)	ELECT	RONIC	MOUNT TO CANOPY						NB SB NB SB	STA. 8499+32, 6' RT. STA. 3500+68, 6' LT. WEST GARDINER I-95 TOLL PLAZA	645.1092 645.1092 645.1092 645.1092	
SP-16	ANY VEHICLE CASH / RECEIPTS	4	48	144	48,00 (192,00)	WHITE	BLACK	◄	MOUNT TO CANOPY						NB NB SB SB	STA. 8499+32, 26' RT. STA. 8499+32, 46' RT. STA. 3500+68, 26' LT. STA. 3500+68, 46' LT.	645.14
SP-17	UNDERCLEARANCE TURNPIKE STRUCTURES 13' 6"	1	60	72	30 . 00 (30 . 00)	YELLOW	BLACK	,	W8x24	-	-	-	24" DIA.	YES	NB	STA. 5280*00, RT.	645.271
SP-18	CARS \$1.00 FARE SCHEDULE SIGN	2	72	78	39.00 (78.00)	YELLOW/ WHITE	BLACK	/	W8X24	-	-	-	24" DIA.	YES	NB SB	STA. 8496+00, RT. STA. 3501+50, LT.	645.271 645.271
SP-19	TOLL PLAZA	2	24	48	8.00 (16.00)	YELLOW	BLACK	-			MOUNT WITH R	2-1(10)		•	NB SB	STA. 8498+50, RT. STA. 3504+50, LT.	645.271 645.271
SP-20	DO NOT STOP	8	36	24	6.00 (48.00)	WHITE	BLACK	-			MOUNT TO BAR	PRIER		•	NB NB SB SB	STA. 7497*00, LT. & RT. STA. 7499*00, LT. & RT. STA. 4501*00, LT. & RT. STA. 4503*00, LT. & RT.	645.271 645.271 645.271 645.271
SP-2I	END TOLL PLAZA SPEED	2	36	24	6.00 (12.00)	WHITE	BLACK	/	6X6 WOOD POST	-	-	-	-	YES	SB NB	STA. 3498+65, LT. STA. 850I+50, RT.	645.271 645.271
SP-22	Save timesave money E-ZP & S 1-888-MTA-PASS	2	48	60	20.00 (40.00)	PURPLE	WHITE	/	W6X15	-	-	-	18" DIA.	YES	SB NB	STA. 3497+00, LT. STA. 8503+00, RT.	645.271 645.271
SP-23	MERGE	4	12	36	3.00 (12.00)	YELLOW	BLACK	-		٨	OUNT WITH W4-1	OR W4-3		-	SB NB NB NB	STA, 4488·16, LT. STA, 7508·25, RT. STA, 7523·00, LT. STA, 7523·00, RT.	645.271 645.271 645.271 645.271
SP-24	NEED TO PAY A TOLL? CALL 1-888-MTA-PASS	2	96	162	108.00 (216.00)	BLUE	WHITE	2	W8XI8	-	-	-	24" DIA.	YES	SB NB	STA. 4473+50, LT. STA. 7518+00, RT.	645.25/ 645.25/
SP-25	9 126 Gardiner Litchfield EXIT	/	/56	192	208.00 (208.00)	GREEN/ YELLOW	WHITE/ BLACK	MOUNT TO OVERHEAD STRUCTURE						SB	STA. 3491·00, LT.	645.124	
SP-26	Brunswick Freeport	1	/50	168	175.00 (175.00)	GREEN	WHITE	-		MOUN	T TO OVERHEAD	STRUCTURE		•	SB	STA. 3491+00, LT.	645.124

Scale: Revision By Date

G©RRILL PALMER CONSULTANT PROJECT MANAGER: BRANDON M. HAVU, PE

 By
 Date
 By
 Date

 BMH 3\20\19
 Checked
 DGE 3\20\19

 MPC 3\20\19
 In Charge of GAE 3\20\19

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THE GOLD STAR MEMORIAL HIGHWAY

INTERCHANGE 103 ORT CONVERSION SIGN SUMMARY -PROPOSED 3

SHEET NUMBER: SS-32

MTA PROJECT MANAGER: RALPH NORWOOD, IV, PE, PTOE

PROPOSED SIGN SUMMARY																		
	IDENTIFICATION NUMBER	DESCRIPTION	QUANTITY		SIGN SIZE		COL	OR	NUMBER OF POSTS	POST SIZE		HEIGHT OF POST CTOR TO CONFIRM		FOUNDATION SIZE AND TYPE	BREAKAWAY DEVICE	DIRECTION (SB-SOUTHBOUND)	LOCATION	PAY ITEM NUMBER
				HEIGHT (IN.)	WIDTH (IN.)	AREA (SQ. FT.)	BACKGROUND	LEGEND			LEFT (FEET)	CENTER (FEET)	RIGHT (FEET)			(NB-NORTHBOUND)		
	SP-27	Gardiner 2 MILES	/	114	132	104.50 (104.50)	GREEN	WHITE	-	MOUNT TO OVERHEAD STRUCTURE						SB	STA. 4491·00. LT.	645.124
	SP-28	Вгильміск Freeport	/	114	168	133.00 (133.00)	GREEN	WHITE		MOUNT TO OVERHEAD STRUCTURE						SB	STA. 4491+00, RT.	645.124
	SP-29	WEST GARDINER SERVICE PLAZ SERVICE PLAZ MED LES MED LE	/	150 36	150 150	156.25 (156.25) 37.50 (37.50)	BLUE BLUE	WHITE WHITE	2	WI2X26	-	-	-	30° DIA.	YES	SB	STA. 3492-70, LT.	645.25/
	SP-30	WEST GARDINER SERVICE PLAZA GET TOLL RECEIPT FOR REDUCED TOLL UPON RE-ENTRY 😎 SOUTH VALID AT EXIT 102 ONLY	/	96	174	//6.00 (//6.00)	BLUE	WHITE	2	W8XI8	-	-	-	24" DIA.	YES	SB	STA. 3503+00, LT.	645,25/
	SP-31	9 128 Gardiner Litchfield USE CASHLAMES	/	/56	192	208.00 (208.00)	GREEN/ YELLOW	WHITE/ BLACK	-		MOUN	T TO OVERHEAD	STRUCTURE		•	SB	STA. 4508•75, LT.	645.125
	SP-32	WEST GARDINER SERVICE PLAZA USE CASHLANES	/	192	192	256.00 (256.00)	BLUE/ YELLOW	WHITE/ BLACK	3	WI2X26	-	-	-	30° DIA.	YES	SB	STA. 23·00, LT.	645.251
	SP-33	9 128 Gardiner Litchfield USE CASHLANES	2	/56	192	208.00 (416.00)	GREEN/ YELLOW	WHITE/ BLACK	-	MOUNT TO OVERHEAD STRUCTURE					SB SB	STA. 27*00, LT. STA. 43*00, LT.	645.126 645.127	
	SP-34	WEST GARDINER SERVICE PLAZA INFO L. INFO L.	/	156 42	192 192	208.00 (208.00) 56.00 (56.00)	BLUE BLUE	WHITE WHITE	3	WI2X26	-	-	-	30° DIA.	YES	SB	STA. 40*00, LT.	645.25/
	SP-36	DO NOT STOP	4	48	84	28.00 (112.00)	WHITE	BLACK	◄		Λ	MOUNT TO SPACE	FRAME		-	NB NB SB SB	STA. 7500+13, LT. STA. 7500+13, RT. STA. 4499+87, LT. STA. 4499+87, RT.	645.271 645.271 645.271 645.271
	SP-37	RAMP	/	24	48	8.00 (8.00)	YELLOW	BLACK	◄			MOUNT WITH R	2-1(45)		-	NB	STA. 8480•50, RT.	645.271
	W3-5(35)		/	48	48	16.00 (16.00)	YELLOW/ WHITE	BLACK	/	W6XI5	-	-	-	18" DI A.	YES	SB	STA. 3509+50, LT.	645.271
	W3-5(45)		/	48	48	16.00 (16.00)	YELLOW/ WHITE	BLACK	/	W6X9	-	-	-	18" DI A.	YES	NB	STA. 7476+00. RT.	645.271
	W4-I	(\$	2	48	48	16.00 (32.00)	YELLOW	BLACK				MOUNT TO LIGHT			-	SB NB	STA. 4488*16, LT. STA. 7508*25, RT.	645.271 645.271
	W4-2		2	48	48	16.00 (32.00)	YELLOW	BLACK	/	W6X9	-	-	-	18" DI A.	YES	NB NB	STA. 7533+00, RT. STA. 5273+00, RT.	645.271 645.271

Scale: Revision

By Date

GORRILL PALMER CONSULTANT PROJECT MANAGER: BRANDON M. HAVU, PE

 By
 Date
 By
 Date

 BMH 3\20\19
 Checked
 DGE 3\20\19

 MPC 3\20\19
 In Charge of GAE 3\20\19

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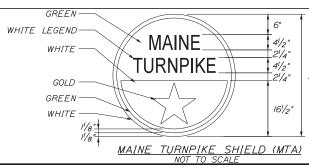
THE GOLD STAR MEMORIAL HIGHWAY

INTERCHANGE 103 ORT CONVERSION SIGN SUMMARY -PROPOSED 4

CONTRACT:2019.04

SHEET NUMBER: SS-33

								<u>PRC</u>	POSED SI	<i>GN SUMMAF</i>	<u> </u>						
IDENTIFICATION NUMBER	DESCRIPTION	QUANTITY		SIGN SIZE		COL	LOR	NUMBER OF POSTS	POST SIZE		HEIGHT OF POST TOR TO CONFIRM		FOUNDATION SIZE AND TYPE	BREAKAWAY	DIRECTION	LOCATION	PAY ITEM NUMBER
NUMBER			HEIGHT (IN.)	WIDTH (IN.)	AREA (SQ. FT.)	BACKGROUND	LEGEND	05 70575		LEFT (FEET)	CENTER (FEET)	RIGHT (FEET)	- SIZE AND TIPE	DEVICE	(SB-SOUTHBOUND) (NB-NORTHBOUND)		NUMBER
W4-3	113	4	48	48	16.00 (64.00)	YELLOW	BLACK	/	W6X9	-	-	-	I8" DIA.	YES	EXIT 51 NB ON RAMP NB NB NB	STA. 887·50, RT. STA. 8487·38, RT. STA. 7523·00, LT. STA. 7523·00, RT.	645.271 645.271 645.271 645.271
W9-/	RIGHT LANE ENDS	2	48	48	16.00 (32.00)	YELLOW	BLACK	/	W6X9	-	-	-	18" DIA.	YES	NB NB	STA. 7527·00, RT. STA. 5268·00, RT.	645.271 645.271
WII-2	Ŕ	6	36	36	9.00 (54.00)	YELLOW	BLACK	-	W6X9	l -		OTH	/8" DIA.	YES	NB NB SB SB NB	STA. 8499+38, 16' RT. STA. 8499+38, 36' RT. STA. 3500+61, 16' LT. STA. 3500+61, 36' LT. STA. 8499+50, 65' RT.	645.271 645.271 645.271 645.271 645.271
								,	W6X9	-	-	-	18" DIA.	YES	SB	STA. 3500+56, 65' LT.	645.271
WI2-I	W Y	2	48	48	16.00 (32.00)	YELLOW	BLACK	•		MOUNT TO	BARRIER WITH I	FLASHING BEACO	DN .	-	NB SB	STA. 7487•80, RT. STA. 4505•65, LT.	645 . 271 645 . 271
M4-6	END	2	18	36	4.50 (9.00)	WHITE	BLACK	4	MOUNT WITH LOGO S → MOUNT WITH MI-I →						SB NB	STA. 4489•99, LT. STA. 7522•00, RT.	645.27 <i>I</i> 645.27 <i>I</i>
M4-14	BEGIN	2	18	36	4.50 (9.00)	WHITE	BLACK	-	MOUNT WITH MI-I						NB SB	STA. 7489•99, RT. STA. 45•50, LT.	645.271 645.271
MI-I	295	2	36	45	II.25 (22.50)	RED/ BLUE	WHITE	/	W6X9	-	-	-	18" DIA.	YES	NB SB	STA. 7522•00, RT. STA. 45•50, LT.	645.271 645.271
LOGO S	MAINE TURNPIKE	2	36	36	9.00 (18.00)	SEE I THIS	DETAIL SHEET	/	W6X9 W6X9	- -	-	-	18" DIA. 18" DIA.	YES YES	NB SB	STA. 7489·99, RT. STA. 4489·99, LT.	645.271 645.271
EI-5P(49)	EXIT 49	1	30	114	23.75 (23.75)	GREEN	WHITE	-		MOUN	T TO OVERHEAD	STRUCTURE		-	SB .	STA. 4491*00, LT.	645,124
EI-5P(5I)	EXIT 51	10	30	114	23.75 (237.50)	GREEN	WHITE	4 4 4 4 4 4 4 4 4 4 4 4 4 4 4 4 4 4 4	MOUNT OVERHEAD WITH SP-4 MOUNT OVERHEAD WITH SP-6 MOUNT OVERHEAD WITH SP-8 MOUNT OVERHEAD WITH SP-25 GROUND MOUNT WITH SP-29 MOUNT OVERHEAD WITH SP-31 GROUND MOUNT WITH SP-32 MOUNT OVERHEAD WITH SP-33 GROUND MOUNT WITH SP-34 MOUNT OVERHEAD WITH SP-34							STA. 7427·25, RT. STA. 7450·00, RT. STA. 7463·00, RT. STA. 4491·00, LT. STA. 3492·70, LT. STA. 4508·75, LT. STA. 27·00, LT. STA. 40·00, LT. STA. 40·00, LT. STA. 43·00, LT.	645.151 645.121 645.122 645.124 645.251 645.125 645.251 645.251 645.251 645.27
OM3-R		2	36	12	3.00 (6.00)	BLACK/	YELLOW	/	U-CHANNEL POST	-	-	-	-	YES	NB SB	STA, 8480+50, RT. STA, 3483+00, LT.	645.271 645.271
D9-10	INFO	,	30	30	6.25 (6.25)	BLUE	WHITE	MOUNT TO POST BELOW SERVICE SIGN							NB .	STA. 7440+50, RT.	645.271



NOTE: FOR 24" SHEILD REDUCE ALL MEASUREMENTS BY 1/3.

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					CONSULTANT P	ROJE	CT MANAGER:	BRANDON M. HA	VU, P	Ξ.
2						Ву	Date		Ву	Date
n e li					Designed	ВМН	3\20\19	Checked	DGE	3\20\19
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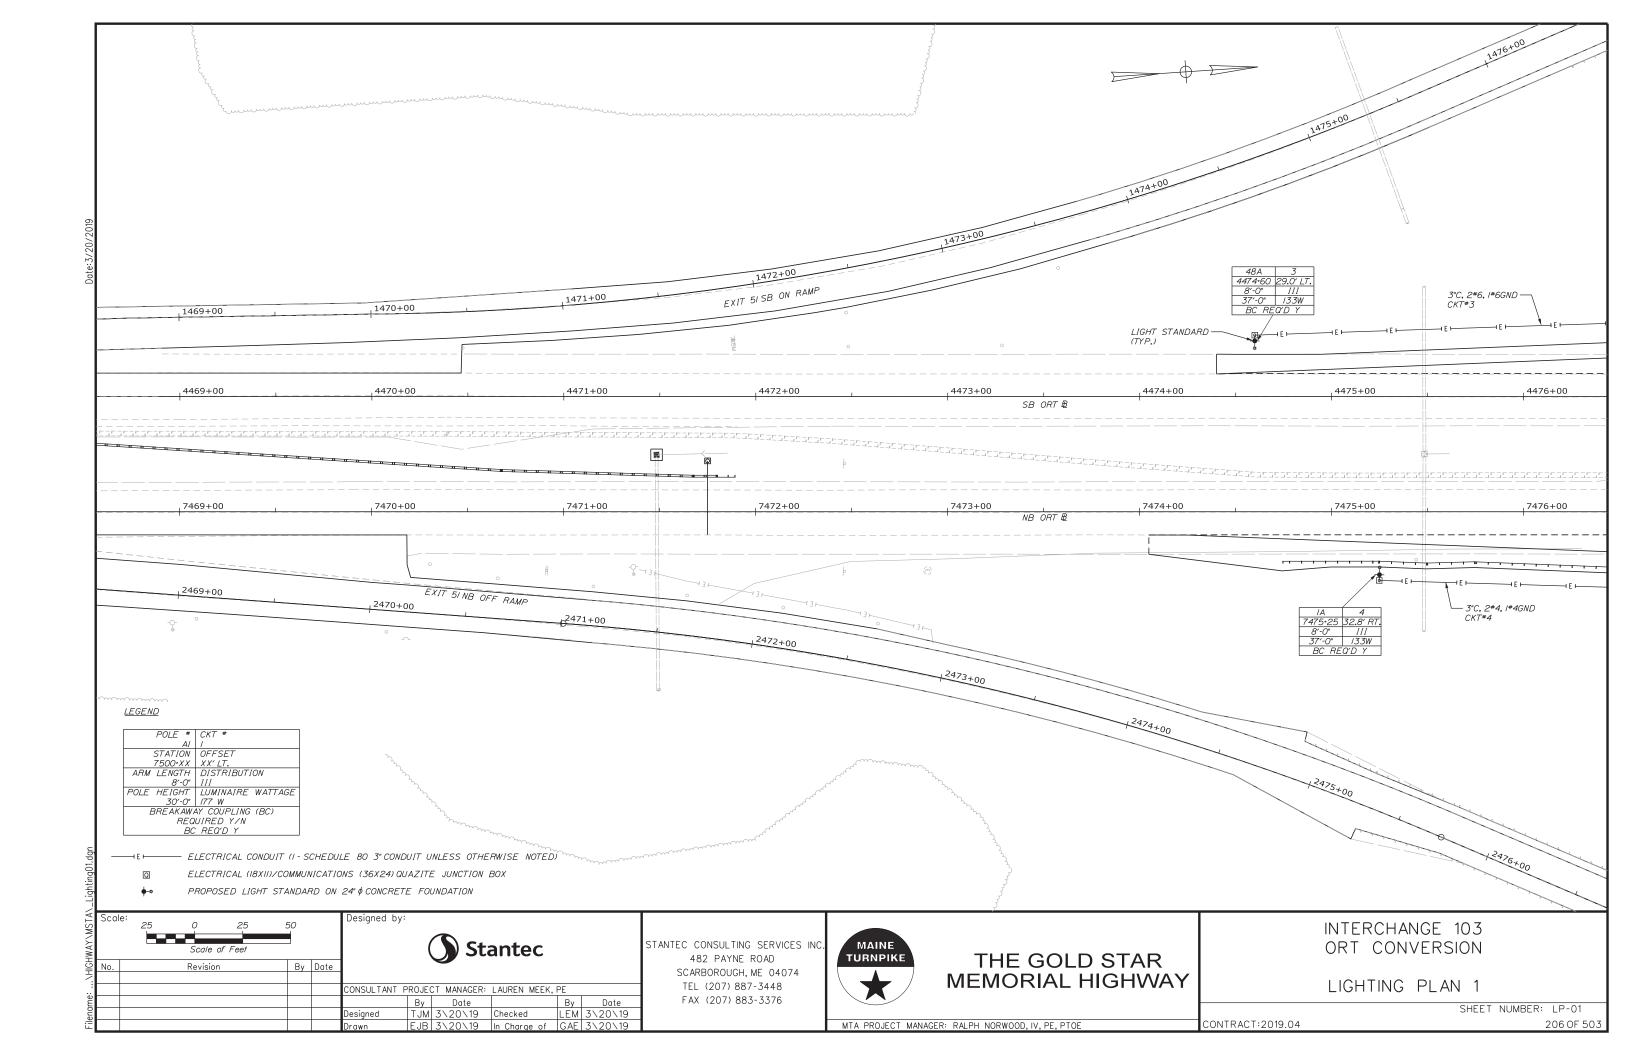



THE GOLD STAR MEMORIAL HIGHWAY


INTERCHANGE 103 ORT CONVERSION SIGN SUMMARY -PROPOSED 5


SHEET NUMBER: SS-34


MTA PROJECT MANAGER: RALPH NORWOOD, IV, PE, PTOE




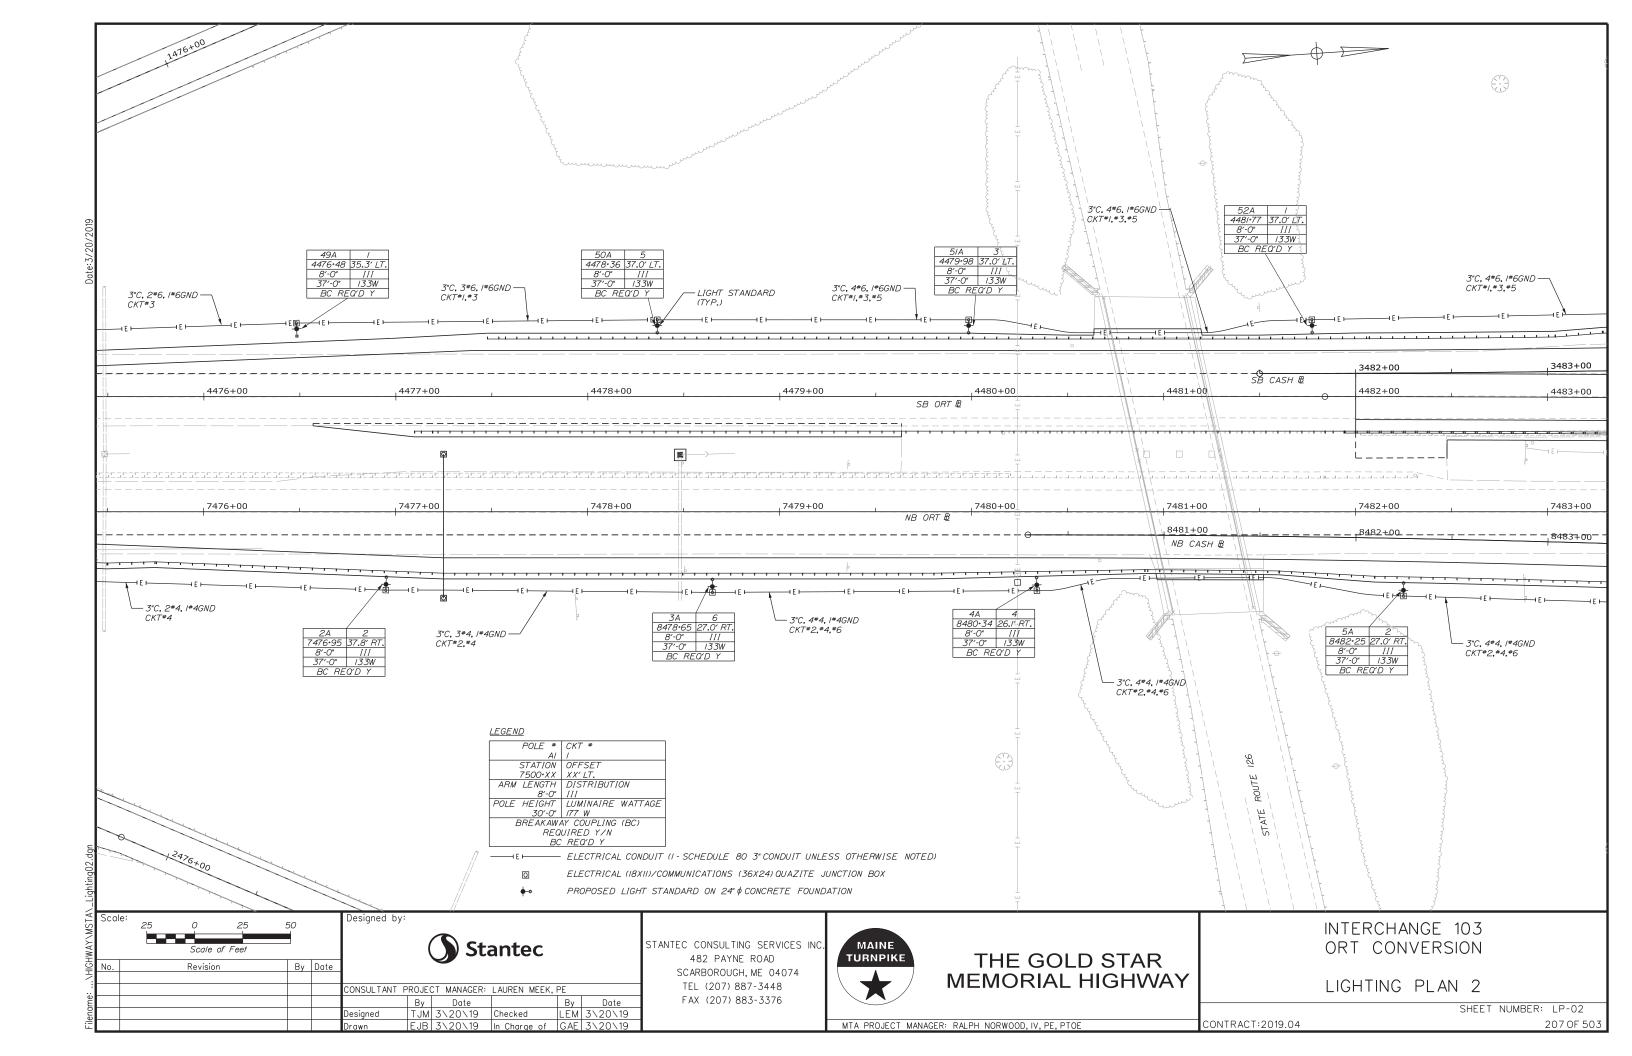


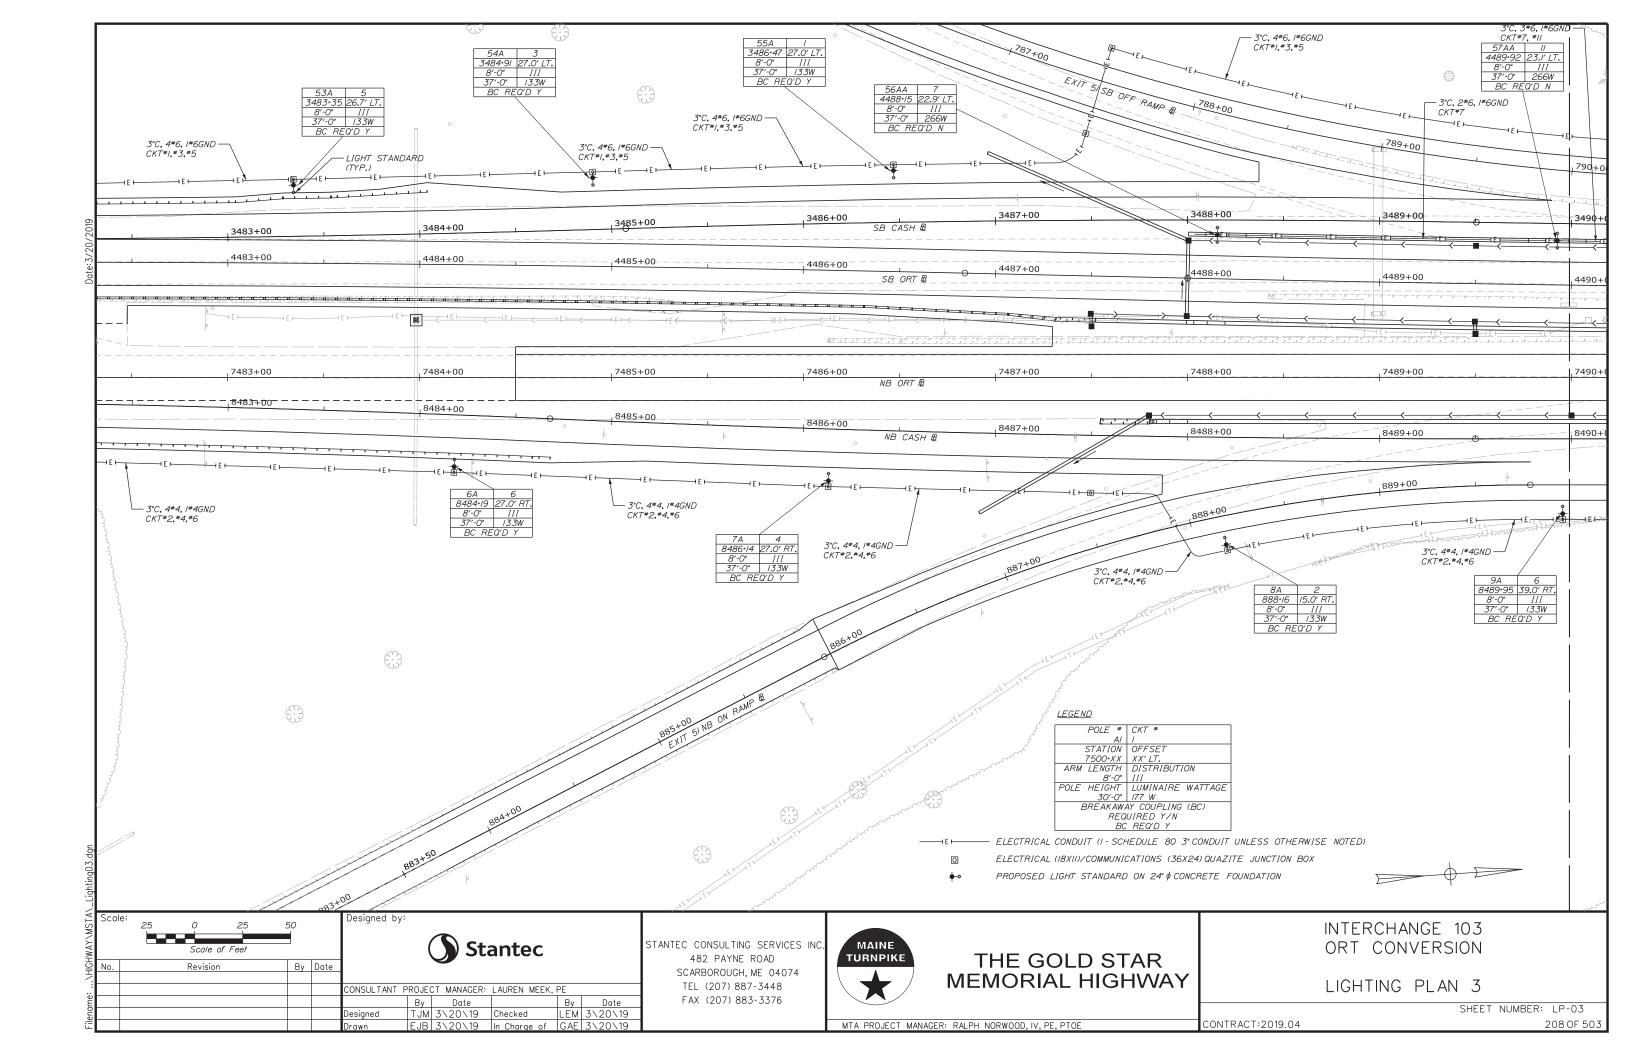


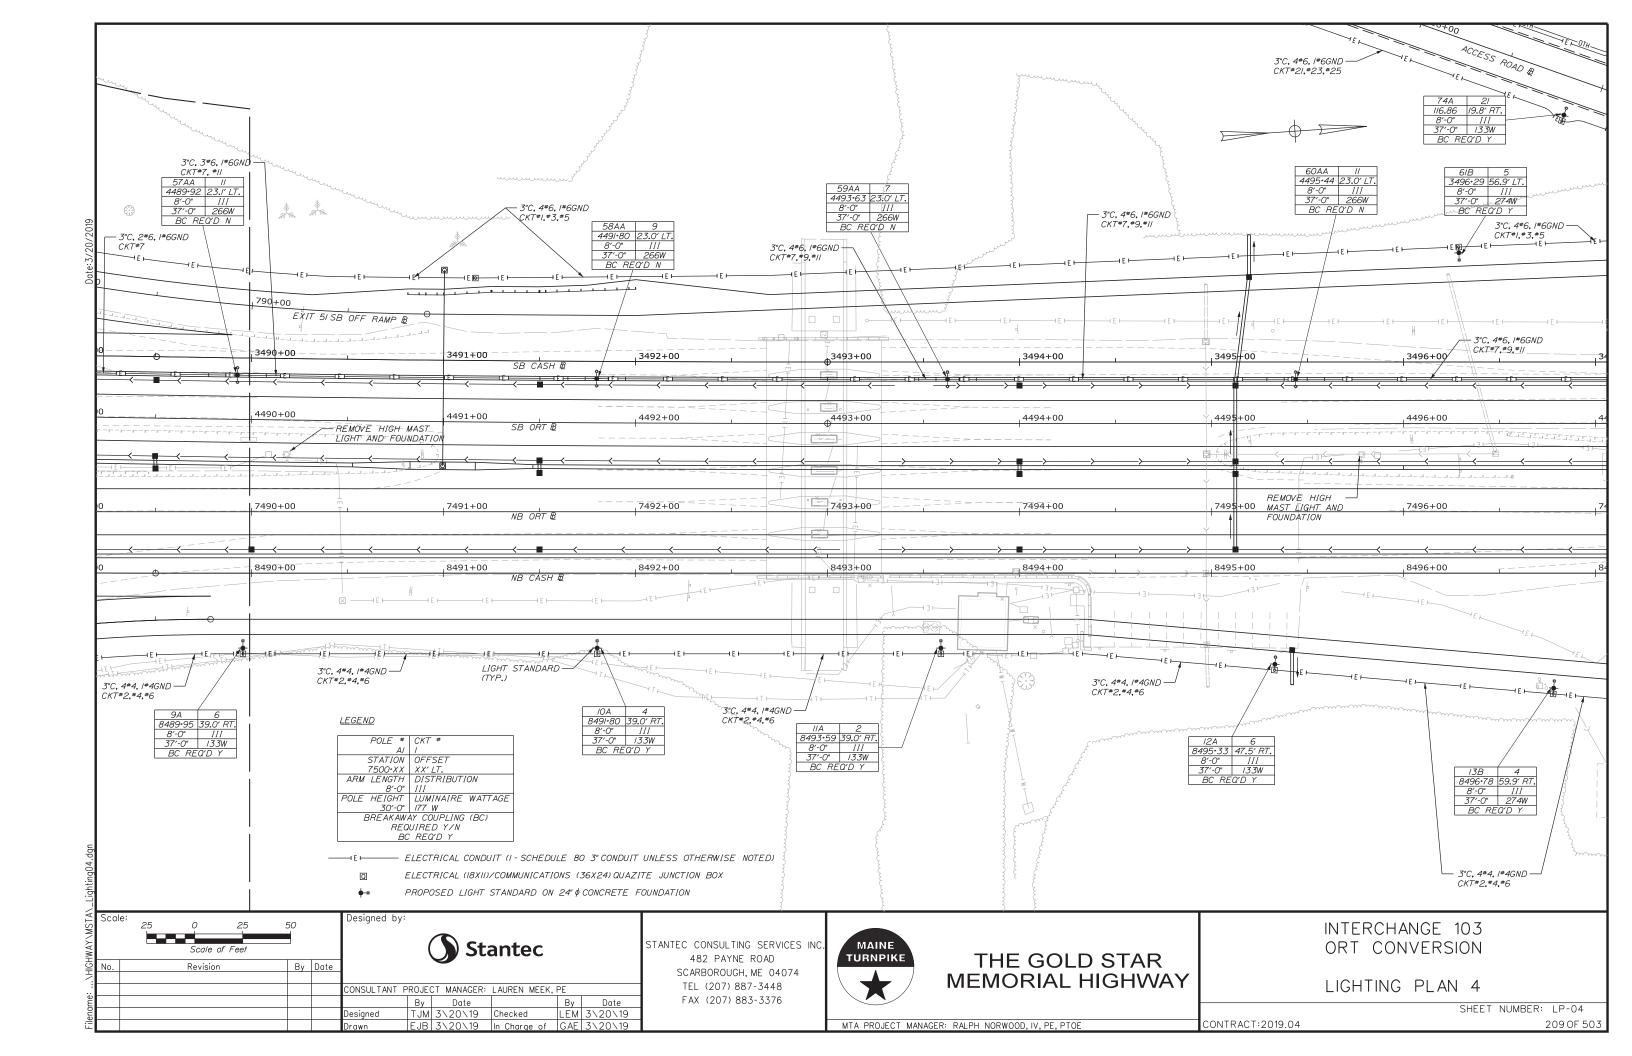


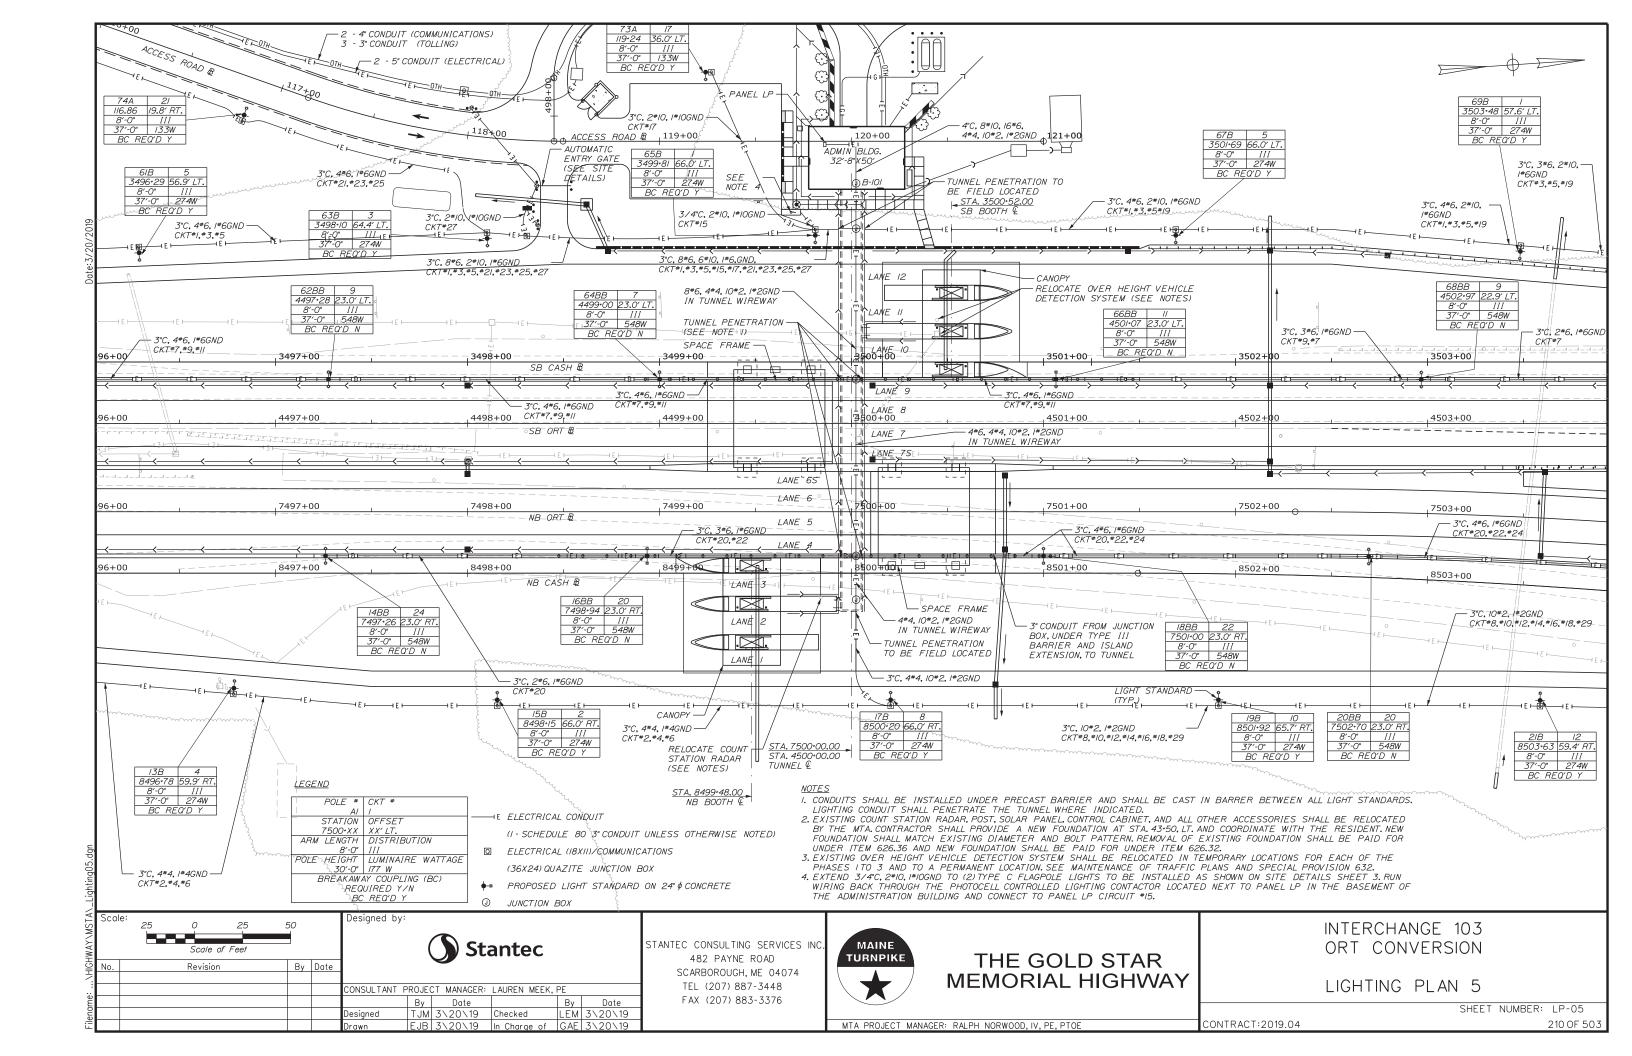


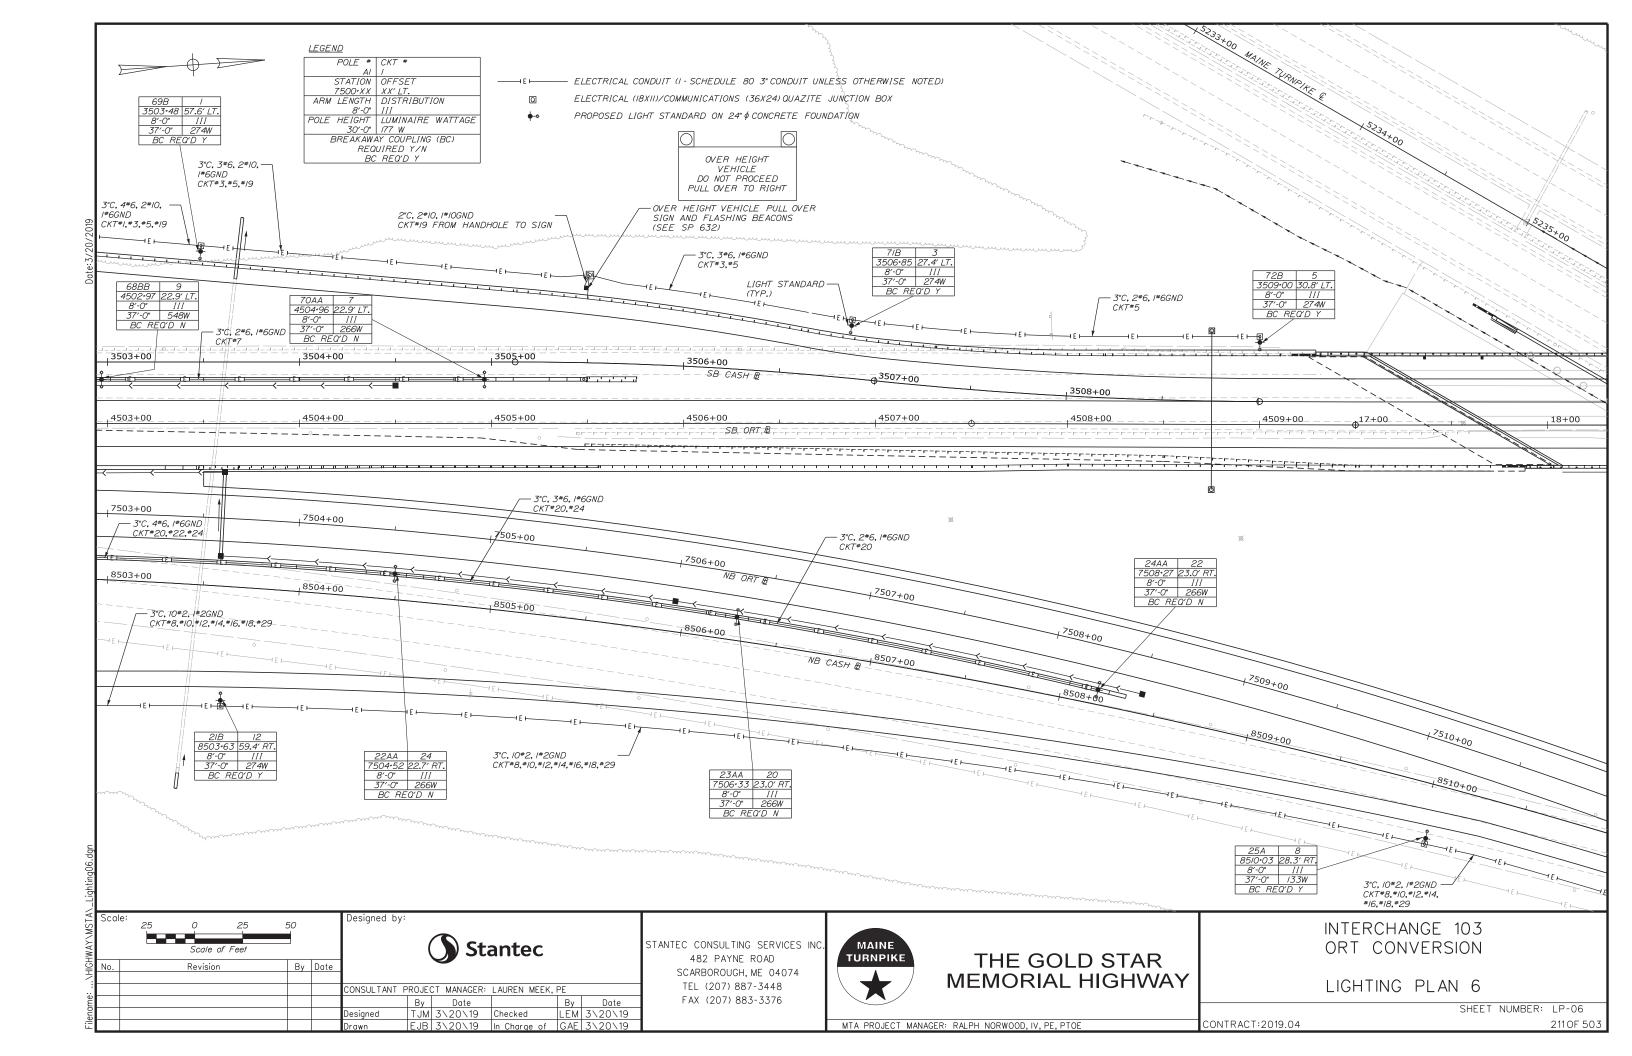


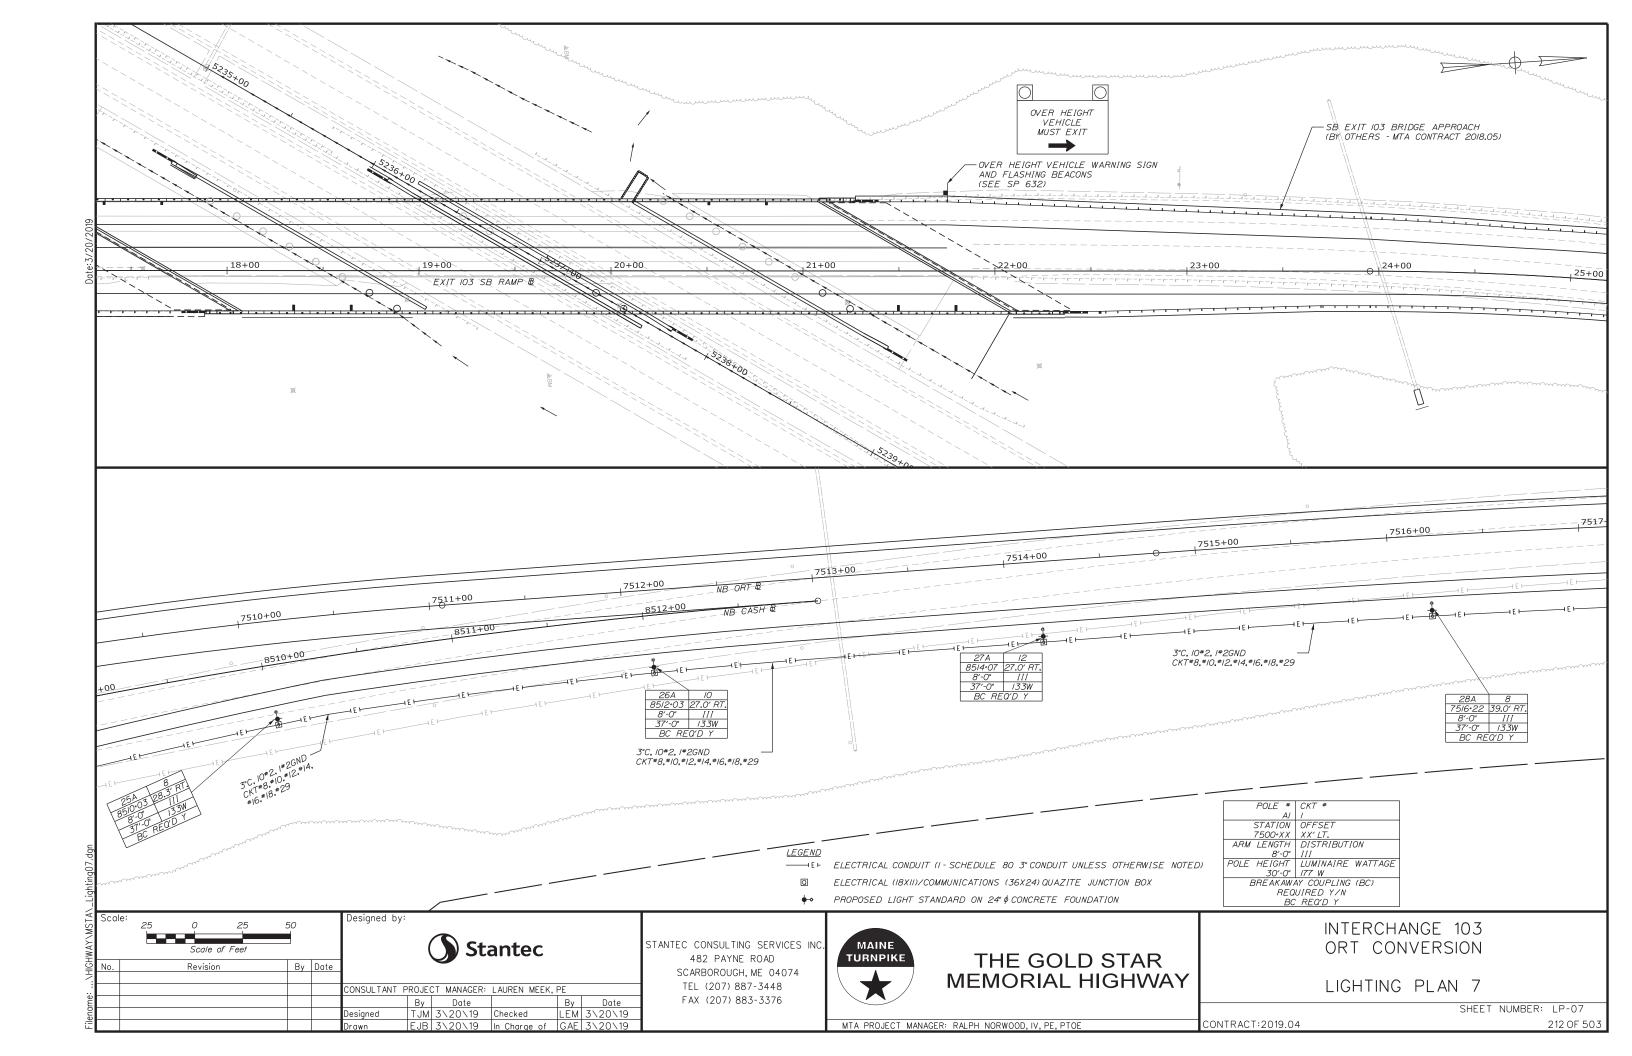


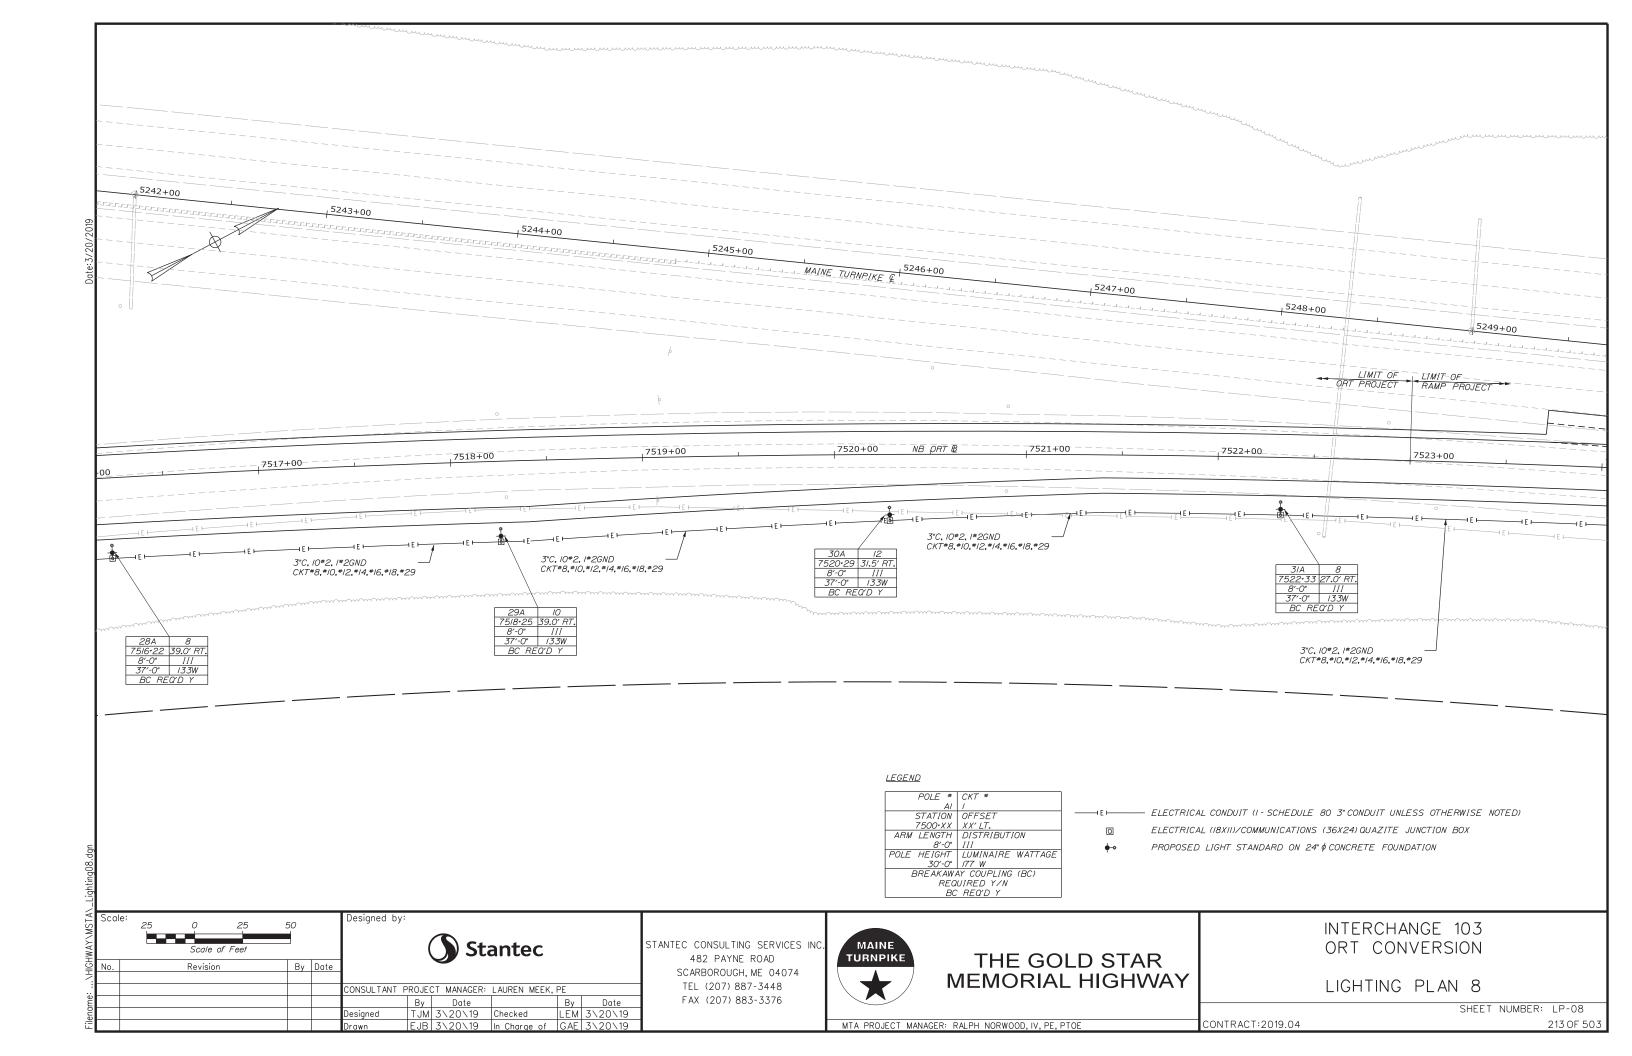


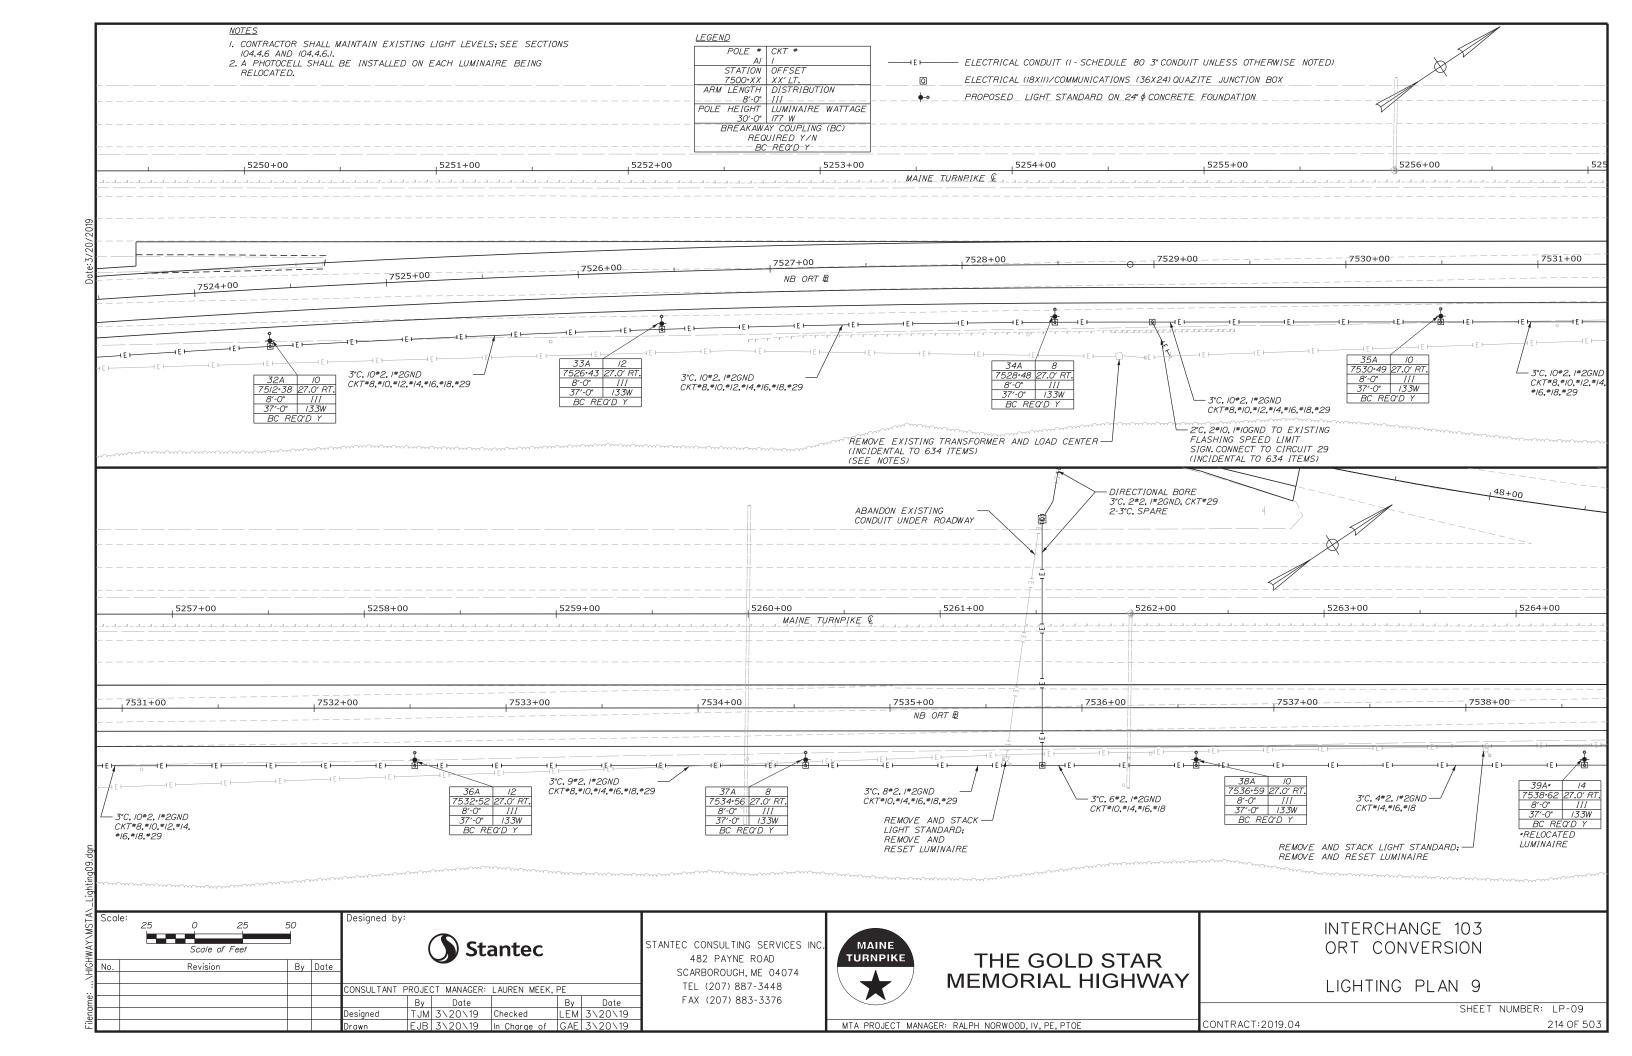


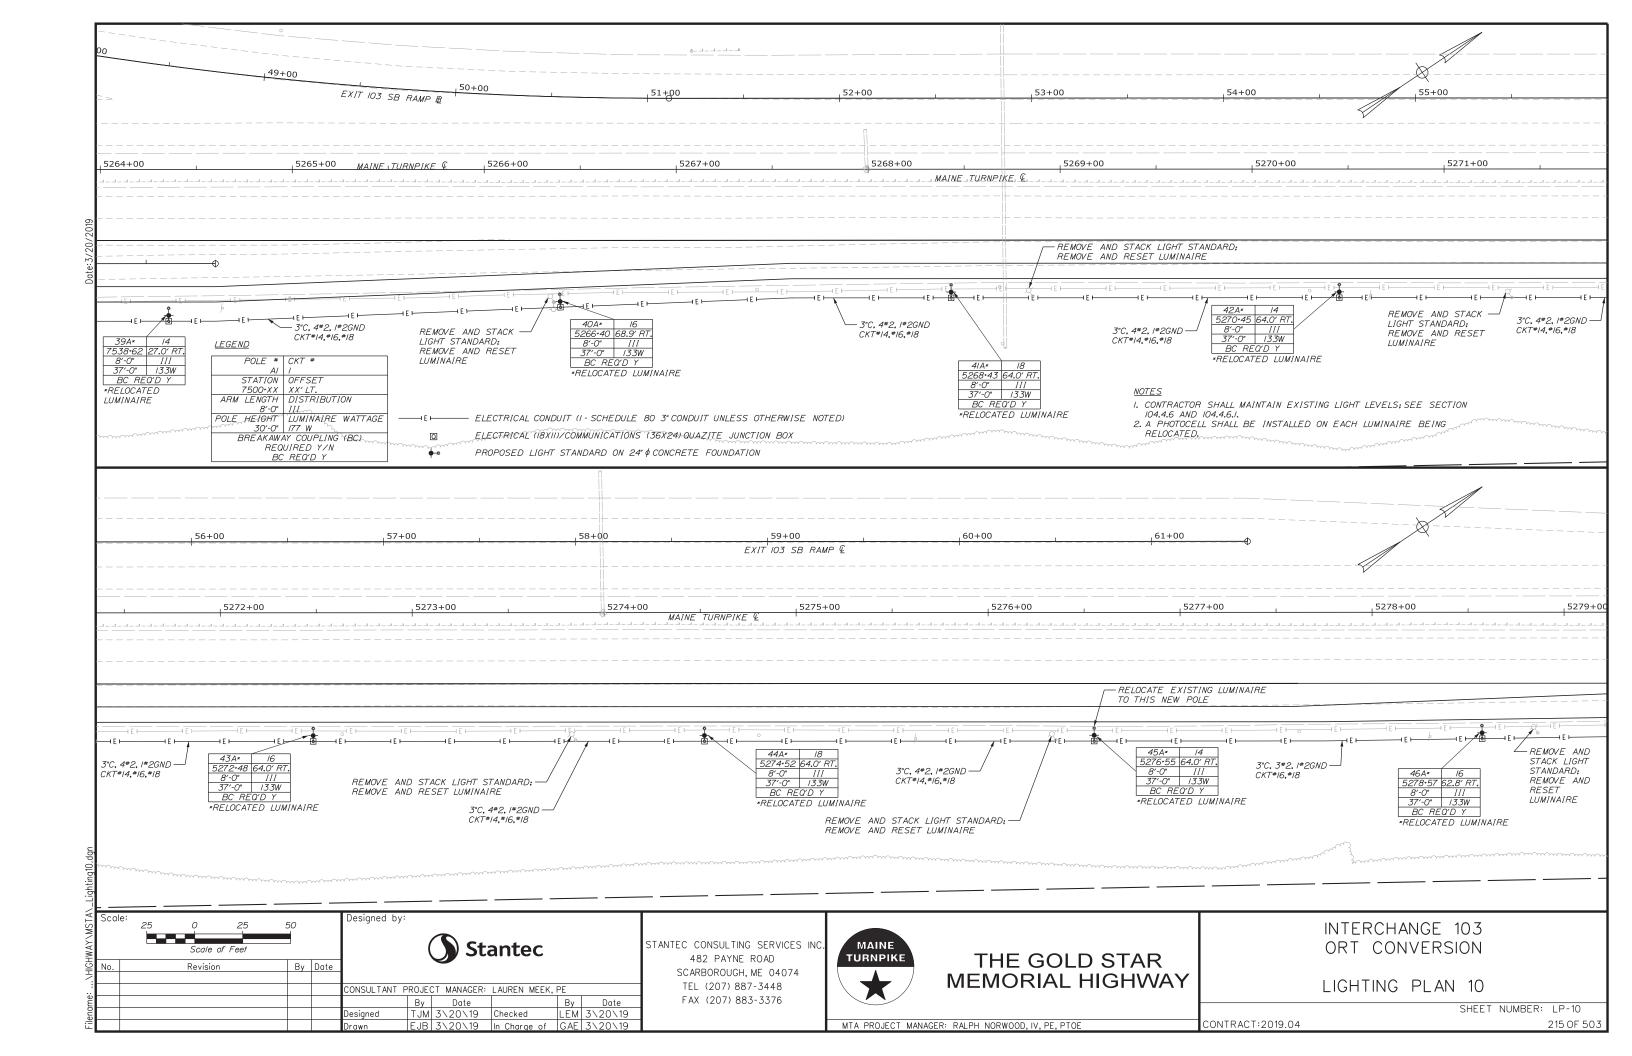

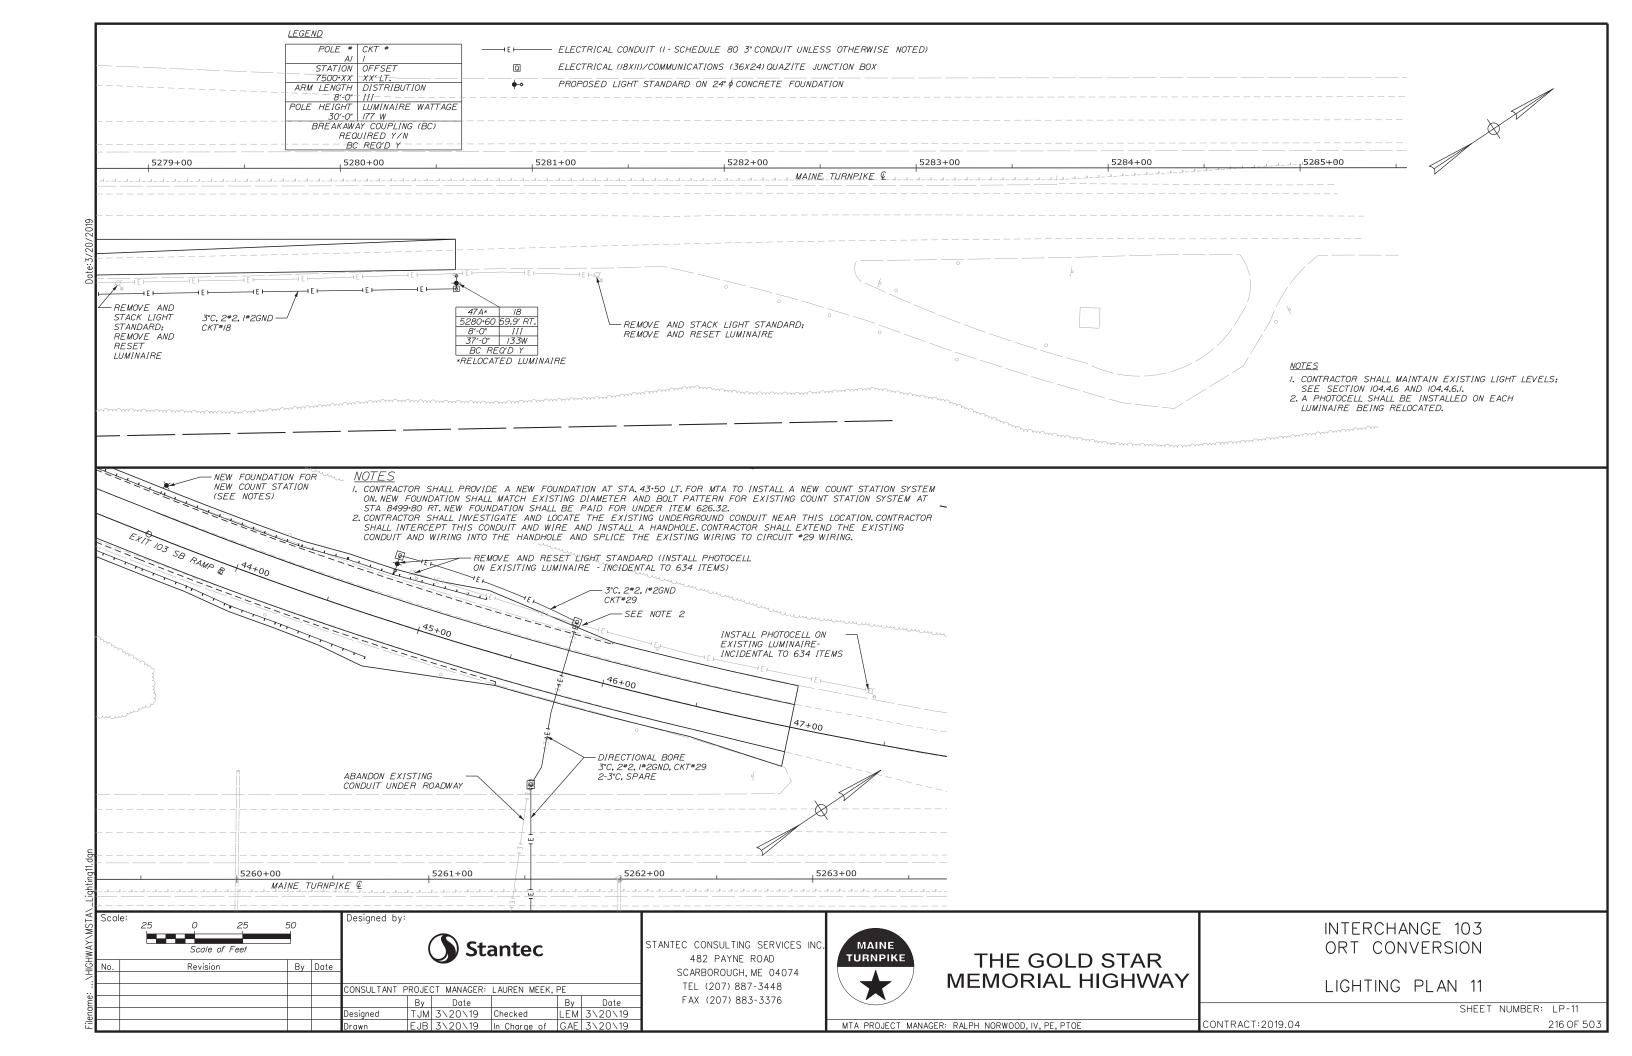

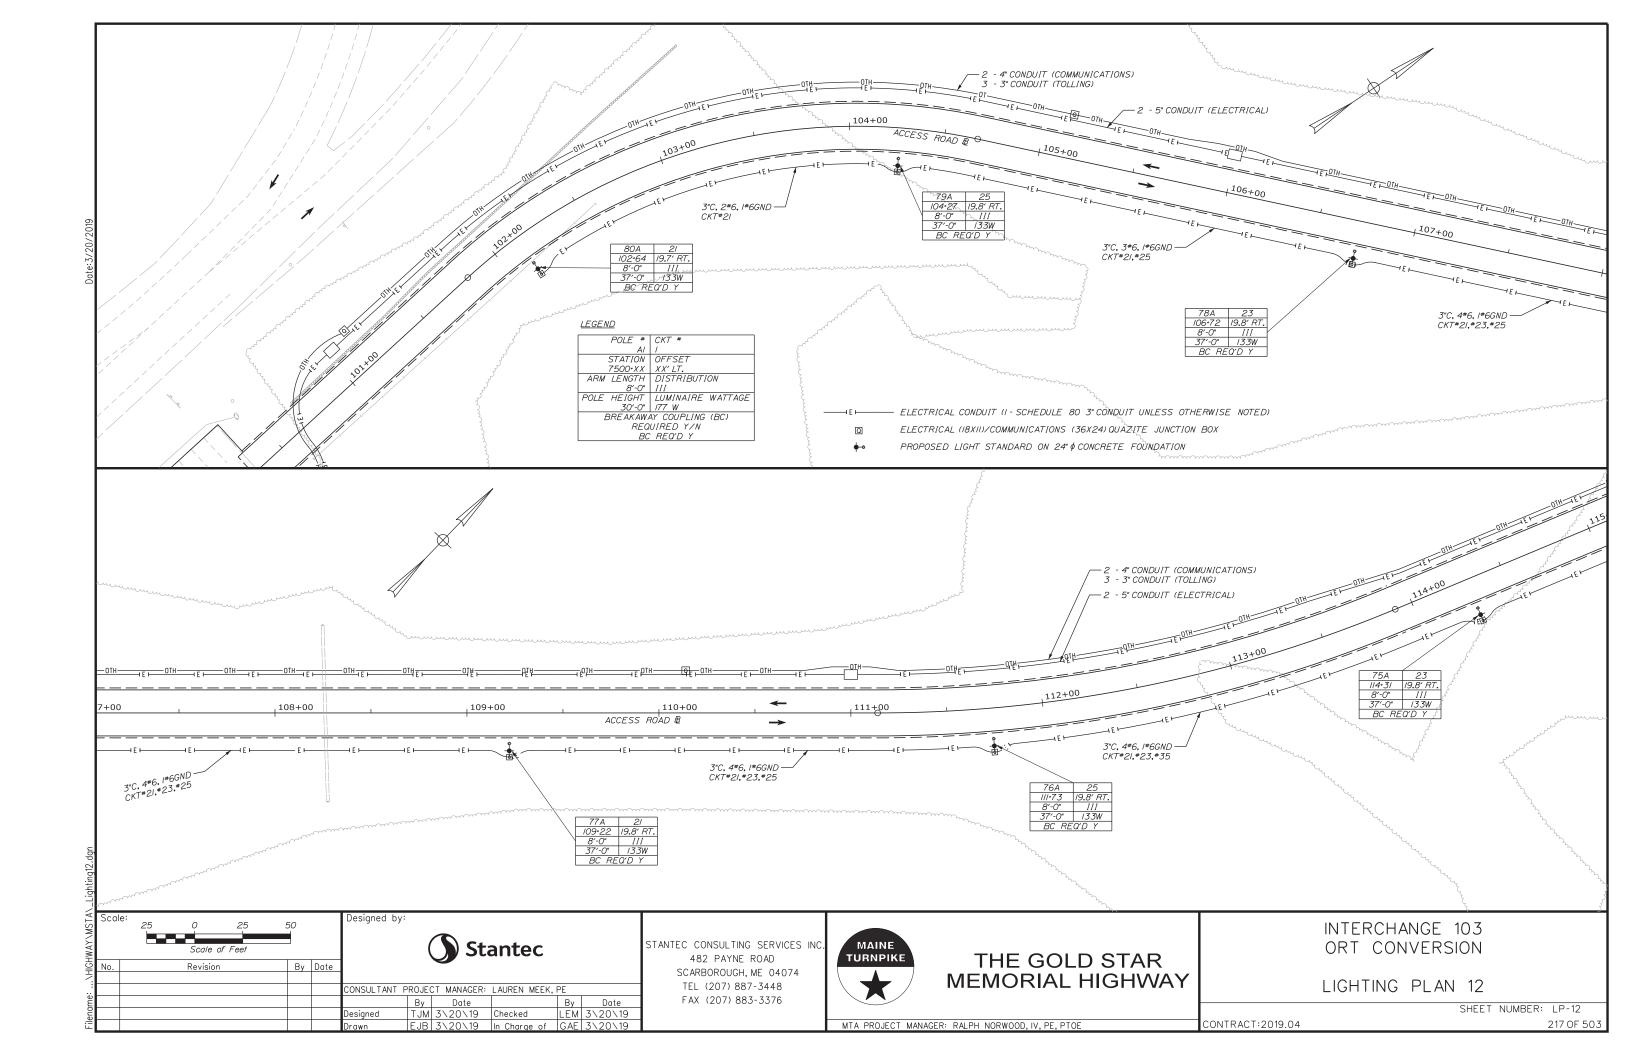

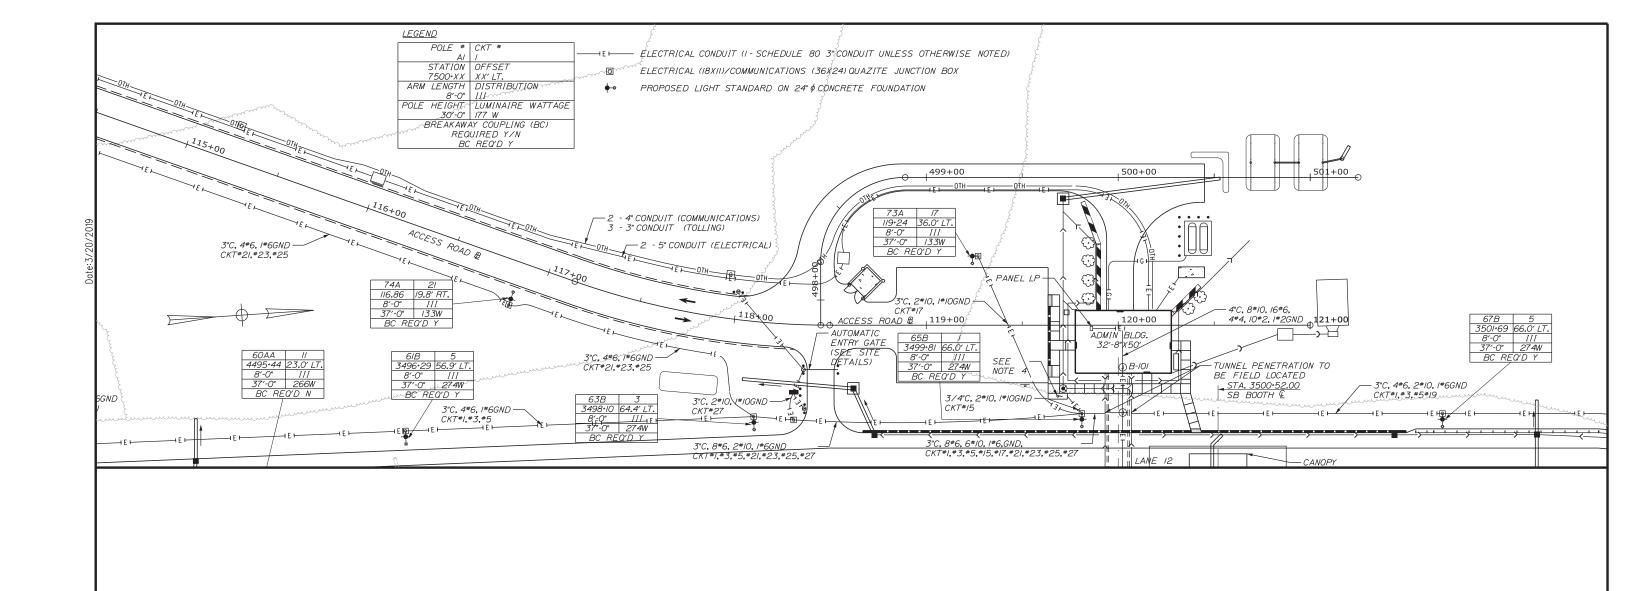

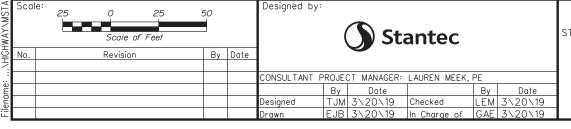

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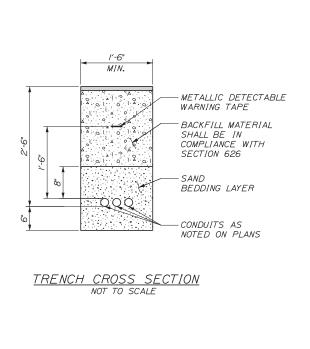
THE GOLD STAR MEMORIAL HIGHWAY


INTERCHANGE 103 ORT CONVERSION

LIGHTING PLAN 13

SHEET NUMBER: LP-13
CONTRACT:2019.04 218 OF 503

MTA PROJECT MANAGER: RALPH NORWOOD, IV, PE, PTOE



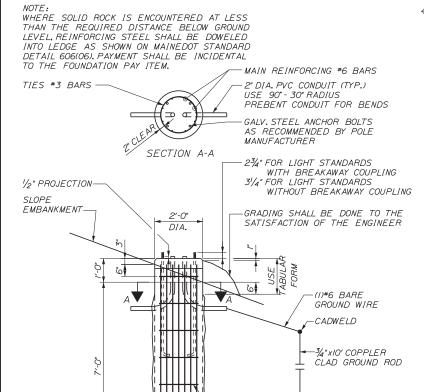

<u>||||||</u>

24 INCH FOUNDATION

(2) 1/2" STAINLESS STEEL PENTA %" x 4" PULL SLOT HEAD CAPTIVE BOLT WITH WASHER-(2 PLACES) -SKID RESISTANT SURFACE TIER LOGO--SEE NOTE 3 -QUAZITE LOGO


I. SPLICES IN BOX SHALL BE MADE WITH ILSCP USPA-350-SS-DB SAFTEYSUB WATER TIGHT DIRECT BURY SPLICE WIRE RANGE 350MCM-IO-STR, ONLY. PROVICE ENOUGH SLACK IN THE WIRE TO ALLOW REMOVAL OF SPLICES AND NEATLY ARRANGE WIRE IN

2. PROVIDE 12 CRUSHED STONE OR GRAVEL UNDER BOX. 3. THE COVER SHALL BE LABELED WITH THE FUNCTION DESIGNATION IN I" MIN TEXT AS FOLLOWS: -"LIGHTING" FOR LIGHTING CONDUIT


-"COMMUNICATION" FOR COMMUNICATIONS CONDUIT 4. DIMENSIONS SHOWN FOR ITEM 626,121 QUAZITE JUNCTION BOX (36X24). SEE MANUFACTURERS DETAILS FOR DIMENSIONS OF ITEM 626.122 (18XII).

*BOTTOM OPENING

QUAZITE BOX DETAIL NOT TO SCALE

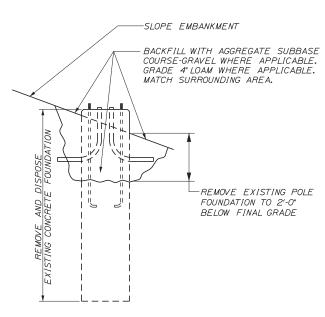

REMOVAL OF CONCRETE FOUNDATION

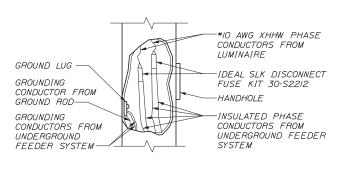

NOTE: CONTRACTOR SHALL PROVIDE 18" OF SLACK IN


OF THE RESIDENT.

POLES

TYPICAL WIRING DETAIL NOT TO SCALE

LUMINAIRE - SEE LUMINAIRE SCHEDULE -2' RISER WITH 8' OFFSET -FACE OF LIGHT STANDARD LIGHT STANDARD WILL BE SHORTER WHEN POLE IS TO BE LOCATED ON MEDIAN BARRIER TO MAINTAIN LUMINAIRE MOUNTING HEIGHT. FACE OF GUARDRAIL OR EDGE OF PAVEMENT EDGE OF PAVEMENT PROPOSED SLOPE.GRADING SHALL-BE DONE TO THE SATISFACTION 24" FOUNDATION 3'-0" QUAZITE JUNCTION BOX

> PLACEMENT OF LIGHT STANDARD NOT TO SCALE

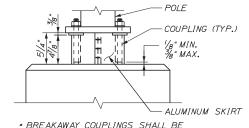

* BREAKAWAY COUPLINGS SHALL BE REOUIRED ON ALL NEW LIGHT STANDARDS EXCEPT POLES MOUNTED ON BARRIER

BREAKAWAY COUPLINGS AND SKIRT DETAIL NOT TO SCALE

	Scal	e:	Designed by:							
A_Uetail-L			Stantec							
SW/	No.	Revision	Ву	Date			•			
:					CONSULTANT P	ROJEC	CT MANAGER:	LAUREN MEEK.	PE	
llendme.						Ву	Date		Ву	Date
Bue					Designed	TJM	3\20\19	Checked	LEM	3\20\19
Ĭ					Drawn	EJB	3\20\19	In Charge of	GAE	3\20\19

-#3 BARS @ 12" O.C. FOR FULL LENGTH OF BASE

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THE GOLD STAR **MEMORIAL HIGHWAY**

INTERCHANGE 103 ORT CONVERSION

LIGHTING AND COMMUNICATION DETAILS 1

SHEET NUMBER: LDET-01

MTA PROJECT MANAGER: RALPH NORWOOD, IV. PE, PTOE

CONTRACT: 2019.04

- 2. LIGHTING FIXTURE VOLTAGE SHALL BE 120 VOLTS.
- 3. LIGHTING FIXTURES SHALL BE IES FULL CUTOFF, LIGHT EMITTING DIODE (LED) FIXTURES.
- 4. ALL FIXTURES SHALL BE GASKETED AND HAVE SURGE PROTECTION AND A DOUBLE FUSE KIT. ALL FIXTURES SHALL BE GRAY, IF DIFFERENT FIXTURES ARE PROPOSED, THEY SHALL BE IES FULL CUTOFF OR CUTOFF, TYPE 3 IES DISTRIBUTION TYPE AS NOTED IN THE LUMINAIRE SCHEDULE, LED LUMINAIRES. B.U.G. RATINGS SHALL BE EQUAL TO OR BETTER THAN THE DESIGNED FIXTURES. THE CONTRACTOR MUST DEMONSTRATE THAT THE PROPOSED FIXTURES WILL REASONABLY EQUAL THE LIGHT LEVELS AND DISTRIBUTIONS SHOWN ON THE PLANS, IN THE OPINION OF MTA.
- 5. EVALUATION OF ALTERNATIVE LED LUMINAIRES THAT MAY BE PROPOSED BY THE CONTRACTOR FOR SUBSTITUTION WILL REQUIRE SUBMITTAL OF THE FOLLOWING, AT MINIMUM: IES LM-79-08 ABSOLUTE TESTING REPORT FOR THE PROPOSED ALTERNATIVE LUMINAIRE; IES LM-80-15 TESTING REPORT FOR LED CHIPS TO BE USED IN THE ALTERNATIVE LUMINAIRE, DOCUMENTING TESTING FOR A MINIMUM OF 8500 HOURS, IES TM-21-II REPORT FOR PROJECTED LONG TERM LUMEN MAINTENANCE, INCLUDING INCREMENTAL LUMEN DEPRECIATION TABLE AT 25 DEGREES CELSIUS TO A MINIMUM OF 50,000 HOURS; IES PHOTOMETRIC FILE FROM THE MANUFACTURER FOR THE PROPOSED ALTERNATIVE LUMINAIRE; PHOTOMETRIC PLOT, OVERLAID ON THE LAYOUT OF PROJECT, SHOWING LIGHT CONTOURS, ILLUMINATION STATISTICS FOR EACH OF THE LIGHTING GROUPS, AND VALUE OF LIGHT LOSS FACTOR USED IN THE ANALYSIS, VALUES OF LLD, LDD, BALLAST FACTOR AND OTHER FACTORS USED FOR CALCULATION OF THE ASSUMED LIGHT LOSS FACTOR; SPECIFICATION DATA REGARDING OPTICS, CHROMATIC COLOR TEMPERATURE, DRIVER, SURGE PROTECTION, HOUSING AND GASKETING.
- 6. CONDUIT SHALL BE 3" MINIMUM PVC SCHEDULE 80. MINIMUM BURIAL DEPTH FOR CONDUIT SHALL BE 30".
- 7. A JUNCTION BOX SHALL BE INSTALLED AT EACH POLE. THE WIRING IN CONDUITS SHALL BE CONTINUOUS BETWEEN JUNCTION BOXES WITHOUT RUNNING SPLICES IN CONDUITS.
- 8. UPON COMPLETION OF THIS PROJECT, THE CONTRACTOR SHALL FURNISH TO MTA A SET OF AS-BUILT PLANS FOR FUTURE REFERENCE AND SYSTEM MAINTENANCE.
- 9. ALL LIGHT BASES SHALL HAVE A GROUND ROD LOCATED ADJACENT TO THE POLE THAT IS BONDED TO THE GROUNDING CONDUCTOR. PAYMENT FOR THE GROUND ROD SHALL BE INCLUDED IN LIGHT POLE ITEM.
- IO. PAYMENT UNDER ITEM 634.231, CONVENTIONAL LIGHT STANDARD WITH LED FIXTURE, WILL INCLUDE BUT NOT BE LIMITED TO NEW POLES, LED FIXTURE, WIRING, AND BREAKAWAY DEVICES.
- II. LIGHTING SERVICE PANEL SHALL BE MARKED WITH ARC FLASH HAZARD TYPE 1, 2, 3 OR 4 AND THE APPROPRIATE PPE REQUIRED.
- IZ.BREAKAWAY DEVICES FOR LIGHT POLES SHALL CONFORM TO THE LATEST VERSION OF "AASHTO STANDARD SPECIFICATIONS FOR STRUCTURAL SUPPORTS FOR HIGHWAY SIGNS, LUMINAIRES AND TRAFFIC SIGNALS" AND NCHRP REPORT 350. THE BREAKAWAY DEVICE SHALL BE DESIGNED SO THAT THE ANCHOR BOLTS WILL NOT BEND WHEN A VEHICLE HITS THE POLE. A FRANGIBLE COUPLING SUCH AS TRANSPO POLE-SAFE 5000 SERIES (WITH A FEMALE ANCHOR), THE MANITOBA SAFETY BASE WITH REACTION PLATE, OR APPROVED EQUAL SHALL BE USED. BREAKAWAY DEVICES SHALL BE INSTALLED ON ALL POLES EXCEPT THOSE LOCATED ON BARRIERS.
- 13.WIRE SHALL BE STRANDED COPPER XHHW-2, SIZE AS NOTED ON THE PLANS.
- 14. FOUNDATIONS SHALL BE PRECAST 24 INCH DIAMETER BY 7' HEIGHT FOUNDATIONS.
- IS.LIGHT POLES THAT ARE REMOVED SHALL BE CAREFULLY REMOVED AND DELIVERED TO THE MTA SIGN SHOP AT MM 58.3 NB.WHEN REMOVING LIGHT POLES, REMOVE ALL EXISTING CONDUCTORS ASSOCIATED WITH THE LIGHT POLE. WHEN REMOVING HANDHOLES, REMOVE ALL CONDUCTORS IN CONDUITS ENTERING THE HANDHOLE BACK TO NEAREST HANDHOLE OR LIGHTING UNIT TO REMAIN AND ABONDON THE EMPTY CONDUIT IN PLACE. PRIOR TO CONDUCTOR REMOVAL, CONTRACTOR SHALL TEST THAT CIRCUITS THAT SERVICE EXISTING LOADS ARE NOT AFFECTED BY REMOVAL.
- I6.EXISTING INTERCHANGE LIGHTING IS INTENDED TO REMAIN OPERATIONAL UNTIL NEW LIGHTING IS ACTIVATED. IF NECESSARY TO REMOVE OR DEACTIVATE ANY LUMINAIRE BEFORE NEW LIGHTING IS ACTIVATED. WHEN APPROVED BY THE RESIDENT, TEMPORARY LIGHTING SHALL BE USED TO MAINTAIN ILLUMINATION AND WILL BE PAID UNDER ITEM NO. 800.30 EXISTING TOLL PLAZA DEMOLITION. ALL TEMPORARY LIGHTING SHALL BE PROTECTED OR LOCATED OUTSIDE OF THE CLEAR ZONE.
- 17. AT EACH POLE, CONTRACTOR SHALL PROVIDE 18" OF EXTRA WIRE SLACK.
- 18.ALL REMOVED AND RESET LIGHT STANDARDS SHALL HAVE BREAKAWAY BASES/COUPLINGS.
- 19.FOR ALL POLES TO BE RELOCATED, REMOVE ALL EXISTING WIRING FROM THE EXISTING POLE AND REPLACE PER THE TYPICAL WIRING DETAIL ON SHEET "LDET-OI".
- 20. FOR ALL CONDUIT RUNS FROM HANDHOLE TO POLE, THE CONTRACTOR SHALL INSTALL 2"C WITH 2#10

CALCULATION SUMMARY									
PROJECT: ROADWAY LIGHTING CALCULATIONS									
LABEL	CALCTYPE	UNITS	AVG	MAX	MIN	AVG/MIN	MAX/MIN		
PARKING AREA	ILLUMINANCE	FC	1.15	1.8	0.6	1.92	3.00		
I-295 - SOUTH OF TOLLS	ILLUMINANCE	FC	0.86	2.5	0.3	2.87	8.33		
I-295 NORTH OF TOLLS INCL. I-95	ILLUMINANCE	FC	0.78	3./	0.3	2.60	10.33		
TOLL APPROACH/DEPARTURE AREA	ILLUMINANCE	FC	3.05	13.4	/./	2.77	12.18		

ROADWAY LUMINAIRE SCHEDULE										
LABEL	CATALOG NUMBER	DESCRIBTION	MINIMUM LUMENS	LIGHT LOSS FACTOR	MAXIMUM WATTS					
А	AMERICAN ELECTRIC ATB2 60BLEDE70 MVOLT R3 NL PCLL	LED COBRAHEAD, 4000K CCT, IES TYPE 3 DISTRIBUTION	17000	0.67	/33					
В	AMERICAN ELECTRIC ATB2 80BLEDEIO MVOLT R3 NL PCLL	LED COBRAHEAD, 4000K CCT, IES TYPE 3 DISTRIBUTION	30000	0.67	274					
С	HYDREL M982OALED- WHT53KMVOLTN- SPFLC34BIHLLPDNA	LED IN-GROUND, 5000K CCT, NARROW SPOT DISTRIBUTION	4600	0.67	274					

Scale:				Designed by	/:					Τ
				Stantec						5
No.	Revision	Ву	Date							ı
				CONSULTANT	PROJE	CT MANAGER:	LAUREN MEEK,	PE		1
					Ву	Date		Ву	Date	1
				Designed	TJM	3\20\19	Checked	LEM	3\20\19	1
				Drawn	EJB	3\20\19	In Charge of	GAE	3\20\19	1

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THE GOLD STAR MEMORIAL HIGHWAY

INTERCHANGE 103 ORT CONVERSION LIGHTING NOTES, SCHEDULES AND DETAILS

SHEET NUMBER: LDET-02

MTA PROJECT MANAGER: RALPH NORWOOD, IV. PE, PTOE

CONTRACT:2019.04

