

MAINE TURNPIKE AUTHORITY

MICHAEL J. CIANCHETTE, CHAIRMAN JANE L. LINCOLN, VICE-CHAIR EMILY BECKER, POLAND, MEMBER NINA A. FISHER, FARMINGDALE, MEMBER ANDREW MCLEAN, GORHAM, MEMBER THOMAS J. ZUKE, SACO, MEMBER DALE F. DOUGHTY, MEMBER EX-OFFICIO

ANDRE J. BRIERE, COLONEL, USAF (RET.), EXECUTIVE DIRECTOR

CONTRACT 2025.15 TOLL PLAZA TUNNEL REPAIR NEW GLOUCESTER (MM 67.0) WEST GARDINER (MM 102.0)

MEMORIAL HIGHWAY

CONTRACT 2025.15 WEST GARDINER TUNNEL REPAIR

NEW GLOUCESTER TUNNEL REPAIR MILE MARKER 67.0

LOCATION MAP

HNTB

INDEX OF SHEETS

SHEET NO.

DESCRIPTION TITLE SHEET

ESTIMATED QUANTITIES GENERAL NOTES

STRUCTURAL REPAIRS

EXIST. ELECTRICAL REPLACEMENT

HVAC AND LIFE SAFETY - ELECTRICAL HVAC AND LIFE SAFETY - MECHANICAL

KITTERY PORTSMOUTH

SOUTH

NORTH BERWICK\\

BIDDEFORD

KENNEBUNK

WELLS

OGUNQUIT

WESTBROOK

ATLANTIC

ITEM NO.	ITEM DESCRIPTION	UNIT	QUANTITY
515.203	Broadcast Sealant for Concrete Surfaces	SY	1910
518.40	Epoxy Injection Crack Repair	LF	200
518.511	Repair of Concrete Surfaces - Stairwell Steps	LS	1
518.512	Repair of Concrete Surfaces - Stairwell Grinding	EA	4
518.513	Repair of Concrete Surfaces - Stairwell Landing	EA	4
518.514	Tollbooth Blockout Sealing	EA	10
526.306	Temporary Concrete Barrier, Type I - Supplied by Authority (600 LF)	LS	1
527.341	Work Zone Crash Cushions - TL-3	UNIT	1
631.53	Electrician	HR	80
631.54	Electrician's Apprentice	HR	80
652.361	Maintenance of Traffic Control Devices	LS	1
655.1004	#4/0 AWG Wire	LF	130
655.101	#6 AWG Wire	LF	700
655.103	#10 AWG Wire	LF	200
655.12	#12 AWG Wire	LF	1880
655.141	4pr/24 (Category 5e) Cable	LF	1700
655.2021	1" Sch 80 PVC Conduit	LF	150
655.203	1 1/2" Sch 80 PVC Conduit	LF	140
655.2031	2" Sch 80 PVC Conduit	LF	90
655.2032	2 1/2" Sch 80 PVC Conduit	LF	230
655.2101	1-1/2" Liquid Tight Metallic Flexible Conduit	LF	300
655.2102	2" Liquid Tight Metallic Flexible Conduit	LF	250
655.2103	1" Liquid Tight Metallic Flexible Conduit	LF	100
655.225	Type F Pull Box	EA	1
655.227	Type H Pull Box	EA	3
655.228	Type I Pull Box	EA	1
655.431	60 AMP Panel Board and Cabinet	EA	4
655.432	100 AMP Panel Board and Cabinet	EA	6
655.433	225 AMP Panel Board and Cabinet	EA	1
655.501	1" PVC Conduit Condulets	EA	2
655.502	1 1/2" PVC Conduit Condulets	EA	2
655.503	2" PVC Conduit Condulets	EA	2
655.5031	2 1/2" PVC Conduit Condulets	EA	2
655.63	4"x4" Plastic NEMA 4R Raceway	LF	55
655.64	6"x6" Plastic NEMA 4R Raceway	LF	715
655.82	Duplex Receptacle	EA	1
655.84	Quadplex Receptacle	EA	3
659.10	Mobilization	LS	1
800.31	Stairwell Enclosure	LS	1
800.32	Tollbooth Canopy Drainage Modifications	LS	1
800.33	Heating, Ventilation, and Dehumidification	LS	1

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					CONSULTANT F	PROJEC	T MANAGER:	DALE MITCHELL	., P.E.	
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HNTB CORPORATION 82 Running Hill Road, Suite 201 South Portland, ME 04106 TEL (207) 774-5155 FAX (207) 228-0909



WEST GARDINER & NEW GLOUCESTER TOLL TUNNEL REPAIRS

QUANTITIES

SHEET NUMBER: EQ-01

MTA PROJECT MANAGER: KRISTI VAN OOYEN, P.E.

GENERAL NOTES

- I. ALL DETAILS SHALL BE IN CONFORMANCE WITH MAINE DEPARTMENT OF TRANSPORTATION (MDOT) STANDARD DETAILS HIGHWAYS AND BRIDGES LATEST REVISION AND MDOT BEST MANAGEMENT PRACTICES FOR EROSION AND SEDIMENT CONTROL LATEST REVISION UNLESS OTHERWISE INCLUDED IN THESE PLANS.
- 2. DIMENSIONS SHOWN ON THE PLANS ARE BASED ON THE AVAILABLE HISTORICAL PLANS, ALL DIMENSIONS SHALL BE VERIFIED IN THE FIELD BY THE CONTRACOR.
- 3. THE CONTRACTOR SHALL SUBMIT THE PROPOSED STAGING AREA(S) AND FIELD TRAILER LOCATION TO THE RESIDENT FOR APPROVAL PRIOR TO STARTING WORK.
- 4. ALL CRACKS IN THE TUNNEL WALLS, CEILING, AND STAIRWELLS THAT ARE 1/8 INCH WIDE OR GREATER SHALL BE SEALED USING AN EPOXY INJECTION SEALER.
- 5. WASTE MATERIALS SHALL BE DISPOSED OF OFF THE PROJECT SITE AND IN ACCORDANCE WITH ALL ENVIRONMENTAL REGULATIONS.
- 6. EXCAVATIONS ACCOMPLISHED AS PART OF THIS PROJECT SHALL BE CONSTRUCTED IN ACCORDANCE WITH OSHA SUBPART P OF 29 CFR PART f92.6.65D-652 (CONSTRUCTION STANDARDS FOR EXCAVATION).
- 7. FILL/BORROW SHALL BE COMPACTED TO 90% OF ITS MAXIMUM DRY DENSITY AS DETERMINED BY THE MODIFIED PROCTOR, EXCEPT AS AMENDED BY SPECIAL PROVISION 203. GRANULAR BORROW AND AGGREGATE SHALL BE COMPACTED TO 95% OF THEIR MAXIMUM DRY DENSITY AS DETERMINED BY THE MODIFIED PROCTOR, EXCEPT AS AMENDED BY SPECIAL PROVISION 203.
- 8. MATERIALS AND EQUIPMENT SHALL NOT BE STORED UNDER OR IN CLOSE PROXIMITY TO HIGHWAY STRUCTURES OR LOOPS UNLESS THE CONTRACTOR RECEIVES WRITTEN
- 9. COPIES OF THE AS-BUILT PLANS ARE POSTED ON THE MAINE TURNPIKE AUTHORITY WEBSITE AT WWW.MAINETORNPIKE.COM/PROJECTS/CONSRUCTION-CONTRACTS. THE COMPLETENESS AND ACCURACY OF THESE PLANS IS NOT GUARANTEED.
- 10. CHAMFER ALL EXPOSED NEW CONCRETE EDGES 3/4" UNLESS OTHERWISE NOTED.

UTILITY NOTES

- I. EXISTING UTILITIES ON THESE PLANS WERE COMPILED FROM EXISTING PLANS AND VARIOUS OTHER SOURCES. LOCATIONS ARE NOT GUARANTEED TO BE ACCURATE NOR IS IT GUARANTEED THAT ALL UTILITIES ARE SHOWN. NO SEPARATE OR ADDITIONAL COMPENSATION WILL BE ALLOWED TO THE CONTRACTOR DUE TO ANY VARIANCE BETWEEN THE DATA SHOWN ON THE PLANS AND THE ACTUAL FIELD CONDITIONS ENCOUNTERED. THE CONTRACTOR IS REQUIRED TO CALL DIG SAFE AT 1-888-344-7233 AT LEAST 72 HOURS PRIOR TO THE START OF WORK, ALL PROPOSED SIGN AND EXCAVATION LOCATIONS SHALL BE MARKED AT THE NOTIFICATION TIME. THE RESIDENT ENGINEER SHALL BE PROVIDED AN ELECTRONIC COPY OF ALL DIG SAFE TICKETS WITHIN 24 HOURS OF THEIR RELEASE FOR PROJECT NOTIFICATIONS AND 3RD PARTY UTILITY LOCATOR COORDINATION.
- 2. THE CONTRACTOR SHALL NOTIFY ALL NON-MEMBERS THROUGH WWW.OKTODIG.COM OR AS OTHERWISE REQUIRED BY THE MAINE PUBLIC UTILITIES COMMISSION. ALL PROPOSED SIGN AND EXCAVATION LOCATIONS SHALL BE MARKED AT THE NOTIFICATION TIME. THE RESIDENT ENGINEER SHALL BE PROVIDED AN ELECTRONIC COPY OF ALL NON-MEMBER NOTIFICATIONS WITHIN 24 HOURS OF THEIR RELEASE
- 3. THE CONTRACTOR SHALL NOTIFY THE RESIDENT 10 CALENDAR DAYS PRIOR TO SUBMITTING ANY UTILITY LOCATE REQUESTS AS NOTED ABOVE SO THAT THE RESIDENT CAN ARRANGE FOR MAINE TURNPIKE UNDERGROUND UTILITY LOCATION. ALL PROPOSED SIGN AND EXCAVATION LOCATIONS SHALL BE MARKED AT THE NOTIFICATION TIME, NO EXCAVATION SHALL BE PERMITTED UNTIL THE AUTHORITY HAS LOCATED AND MARKED ITS UNDERGROUND UTILITIES.
- 4. FOLLOWING THE COMPLETION OF THE INITIAL UTILITY LOCATE THE CONTRACTOR WILL GPS LOCATE ALL UTILITIES WITHIN THE PROJECT LIMITS AND PROVIDE A COPY OF THE DIG SAFE RECORDS TO THE AUTHORITY, THE CONTRACTOR, ACTING AS THE AUTHORITY'S THIRD-PARTY LOCATOR, SHALL BE RESPONSIBLE FOR REMARKING ALL MAINE TURNPIKE FACILITIES WHEN A DIG SAFE UTILITY IS CALLED FOR THE PROJECT. THIS WORK SHALL BE CONSIDERED INCIDENTAL TO THE CONTRACT.

DRAINAGE NOTES

I. NO EXISTING DRAINAGE SHALL BE ABANDONED, REMOVED OR PLUGGED WITHOUT APPROVAL OF THE RESIDENT.

EROSION CONTROL

- I. ADDITIONAL MEASURES MAY BE PROPOSED BY THE CONTRACTOR DUE TO SITE OR WEATHER CONDITIONS. THE RESIDENT MAY DIRECT THE CONTRACTOR TO IMPLEMENT ADDITIONAL MEASURES, ANY ADDITIONAL MEASURES APPROVED BY THE RESIDENT WILL BE MEASURED FOR PAYMENT.
- 2. ALL TEMPORARY EROSION CONTROL DEVICES SHALL BE INSTALLED IN ACCORDANCE WITH THE MAINE DEPARTMENT OF TRANSPORTATION BEST MANAGEMENT PRACTICES.

TOLL NOTES

- I. DRAWINGS ARE SCHEMATIC AND PROVIDED FOR GENERAL REFERENCE ONLY. THE PLANS SHOULD NOT BE SCALED FOR THE PURPOSED OF DETERMINING DIMENSIONS OR QUANTITIES.
- 2. VERIFY AND REMOVE ALL ABANDONED OR UNUSED ELECTRICAL WIRING AND COMMUNICATION CABLING, REMOVAL OF ABANDONED ITEMS WILL BE PAID ON A TIME-AND-MATERIALS BASIS UNDER ITEMS 631.53 ELECTRICIAN AND 631.54 ELECTRICIAN APPRENTICE. COORDINATE WITH THE RESIDENT PRIOR TO REMOVING ABANDONED ITEMS.
- 3. REMOVE IN THEIR ENTIRETY ALL EXISTING CONDUITS, WIREWAYS, AND SIMILAR RACEWAYS THAT ARE IDENTIFIED FOR REPLACEMENT, CAP ANY UNUSED CONDUITS THAT CANNOT BE REMOVED, AND CAP ALL WIRE TROUGHS WHERE CONDUIT HAS BEEN REMOVED BUT THE TROUGH REMAINS. REMOVAL OF EXISTING CONDUITS, WIREWAYS, AND SIMILAR RACEWAYS IS INCIDENTAL TO THE INSTALLATION OF THE REPLACEMENT ITEM.
- 4. CUTTING POWER TO TOLLING EQUIPMENT WILL CAUSE CATASTROPHIC FAILURE OF THE FOLIPMENT PRIOR TO SHUTTING DOWN OR POWERING ANY TOLLING EQUIPMENT, COORDINATION BY THE CONTRACTOR IS REQUIRED WITH THE RESIDENT, MTA'S DIRECTOR OF ITS, AND TRANSCORE.

LIST OF ABBREVIATIONS

ABUT. - ABUTMENT ADDL - ADDITIONAL ALT. - ALTERNATE APPROX. - APPROXIMATELY B - BASELINE BOT. - BOTTOM BRG. - BEARING CL. - CLEAR **€** - CENTERLINE CONC. - CONCRETE CONSTR. - CONSTRUCTION C.Y. - CUBIC YARD DEMO. - DEMOLITION DIA. - DIAMETER

E.F. - EACH FACE EL. - ELEVATION EQ. - EQUAL EXIST. - EXISTING FXP. - FXPANSION F.F. - FAR FACE JT. - JOINT MAX. - MAXIMUM MEDOT - MAINE DEPARTMENT MIN. - MINIMUM

EA. - EACH

FR - FASTROUND

OF TRANSPORTATION

MTA - MAINE TURNPIKE **AUTHORITY** NB - NORTHBOUND N.F. - NEAR FACE N.T.S. - NOT TO SCALE PED. - PEDESTAL PGL - PROFILE GRADE LINE P - PLATE PROP. - PROPOSED P.S.I. - POUNDS per

U.O.N. - UNLESS OTHERWISE NOTED SQUARE INCH VERT. - VERTICAL SHLDR. - SHOULDER WB - WESTBOUND SB - SOUTHBOUND W.P. - WORKING POINT SF - SQUARE FEET WW - WINGWAII

SP. - SPACES

STA. - STATION

TYP. - TYPICAL

T.&B. - TOP & BOTTOM

TSYLL - TEMPORARY SOLID

TSWLL - TEMPORARY SOLID

YFIIOW LANF LINF

WHITE LANE LINE

TPKE. - TURNPIKE

Scale: Designed by: No. Revision By Date CONSULTANT PROJECT MANAGER: DALE MITCHELL, P.E. 09/25 Checked Designed 09/25 In Charge of TRC 09/25 BRG

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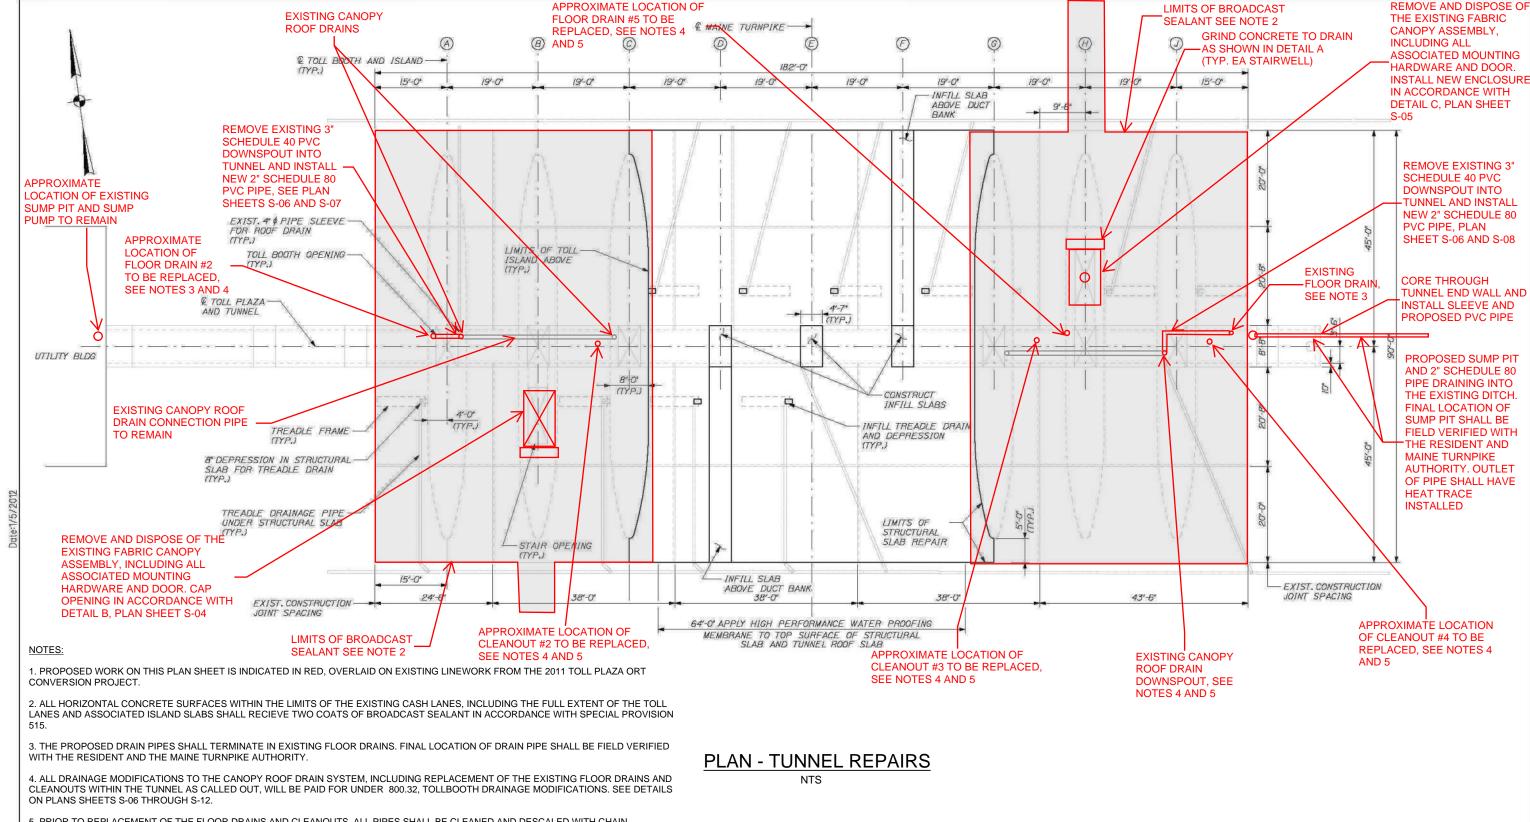


THE GOLD STAR MEMORIAL HIGHWAY WEST GARDINER & NEW GLOUCESTER TOLL TUNNEL REPAIRS

GENERAL NOTES

SHEET NUMBER: GN-01

MTA PROJECT MANAGER: KRISTI VAN OOYEN, P.E.



5. PRIOR TO REPLACEMENT OF THE FLOOR DRAINS AND CLEANOUTS, ALL PIPES SHALL BE CLEANED AND DESCALED WITH CHAIN

CLEANING THEN FLUSHED TO REMOVE ANY LOOSE DEBRIS. PIPES SHALL THEN BE SEALED WITH 2 COATSOF PICOTE XPRESS EPOXY COATING SYSTEM OR APPROVED EQUAL.

6. ALL CRACKS IN THE TUNNEL WALLS, CEILING, AND STAIRWELLS THAT ARE 1/8 INCH WIDE OR GREATER SHALL BE SEALED USING AN **EPOXY INJECTION SEALER**

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				CONSULTANT	PROJEC	CT MANAGER:	DALE MITCHELL	, P.E.	
					Ву	Date		Ву	Date
				Designed	KJK	09/25	Checked	BRG	09/25
				Drawn	KJK	09/25	In Charge of	TRC	09/25

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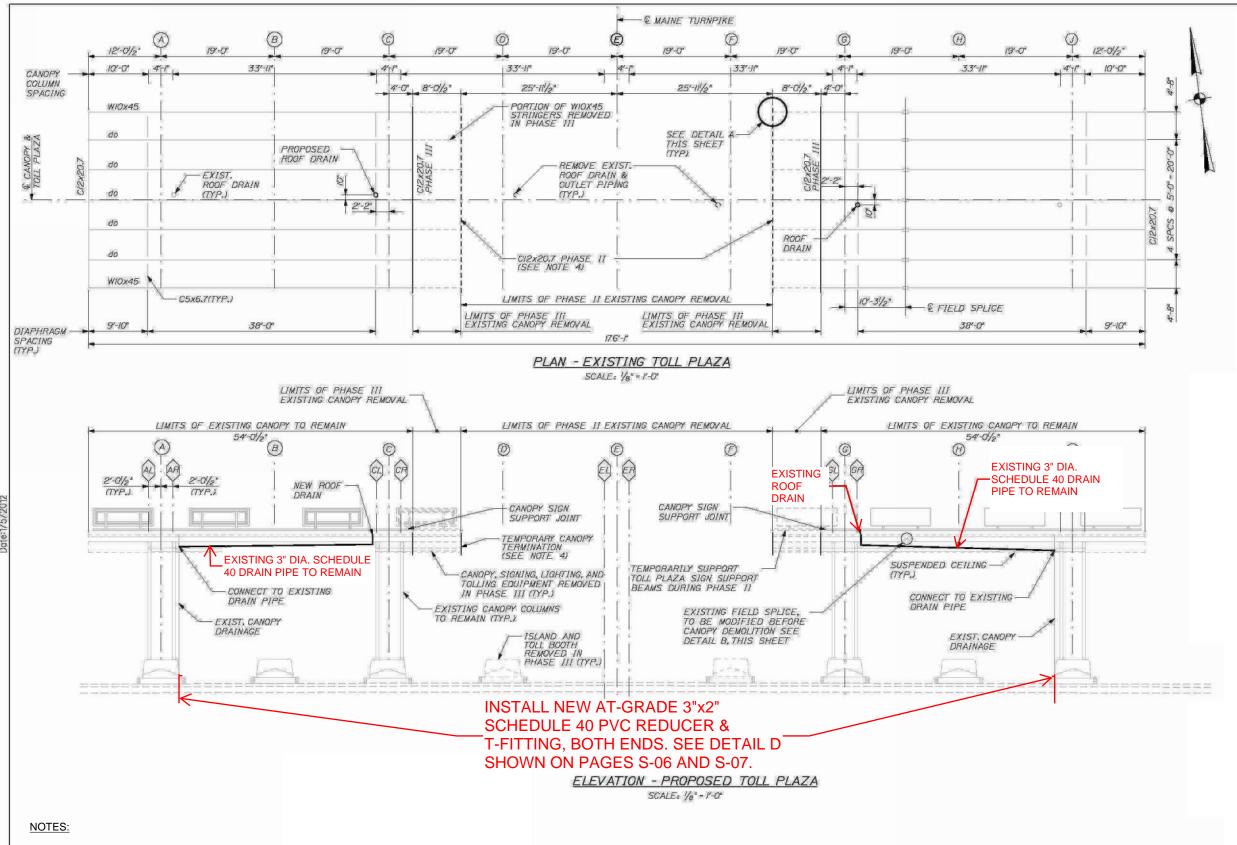


THE GOLD STAR **MEMORIAL HIGHWAY** WEST GARDINER & NEW GLOUCESTER TOLL TUNNEL REPAIRS

NEW GLOUCESTER TOLL TUNNEL

SHEET NUMBER: \$-01

MTA PROJECT MANAGER: KRISTI VAN OOYEN, P.E.



1. PROPOSED WORK ON THIS PLAN SHEET IS INDICATED IN RED, OVERLAID ON EXISTING LINEWORK FROM THE 2011 TOLL PLAZA ORT CONVERSION PROJECT.

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THE GOLD STAR MEMORIAL HIGHWAY


WEST GARDINER & NEW GLOUCESTER TOLL TUNNEL REPAIRS


NEW GLOUCESTER TOLL TUNNEL

SHEET NUMBER: \$-02

MTA PROJECT MANAGER: KRISTI VAN OOYEN, P.E.

CONTRACT:2025.15 5 OF

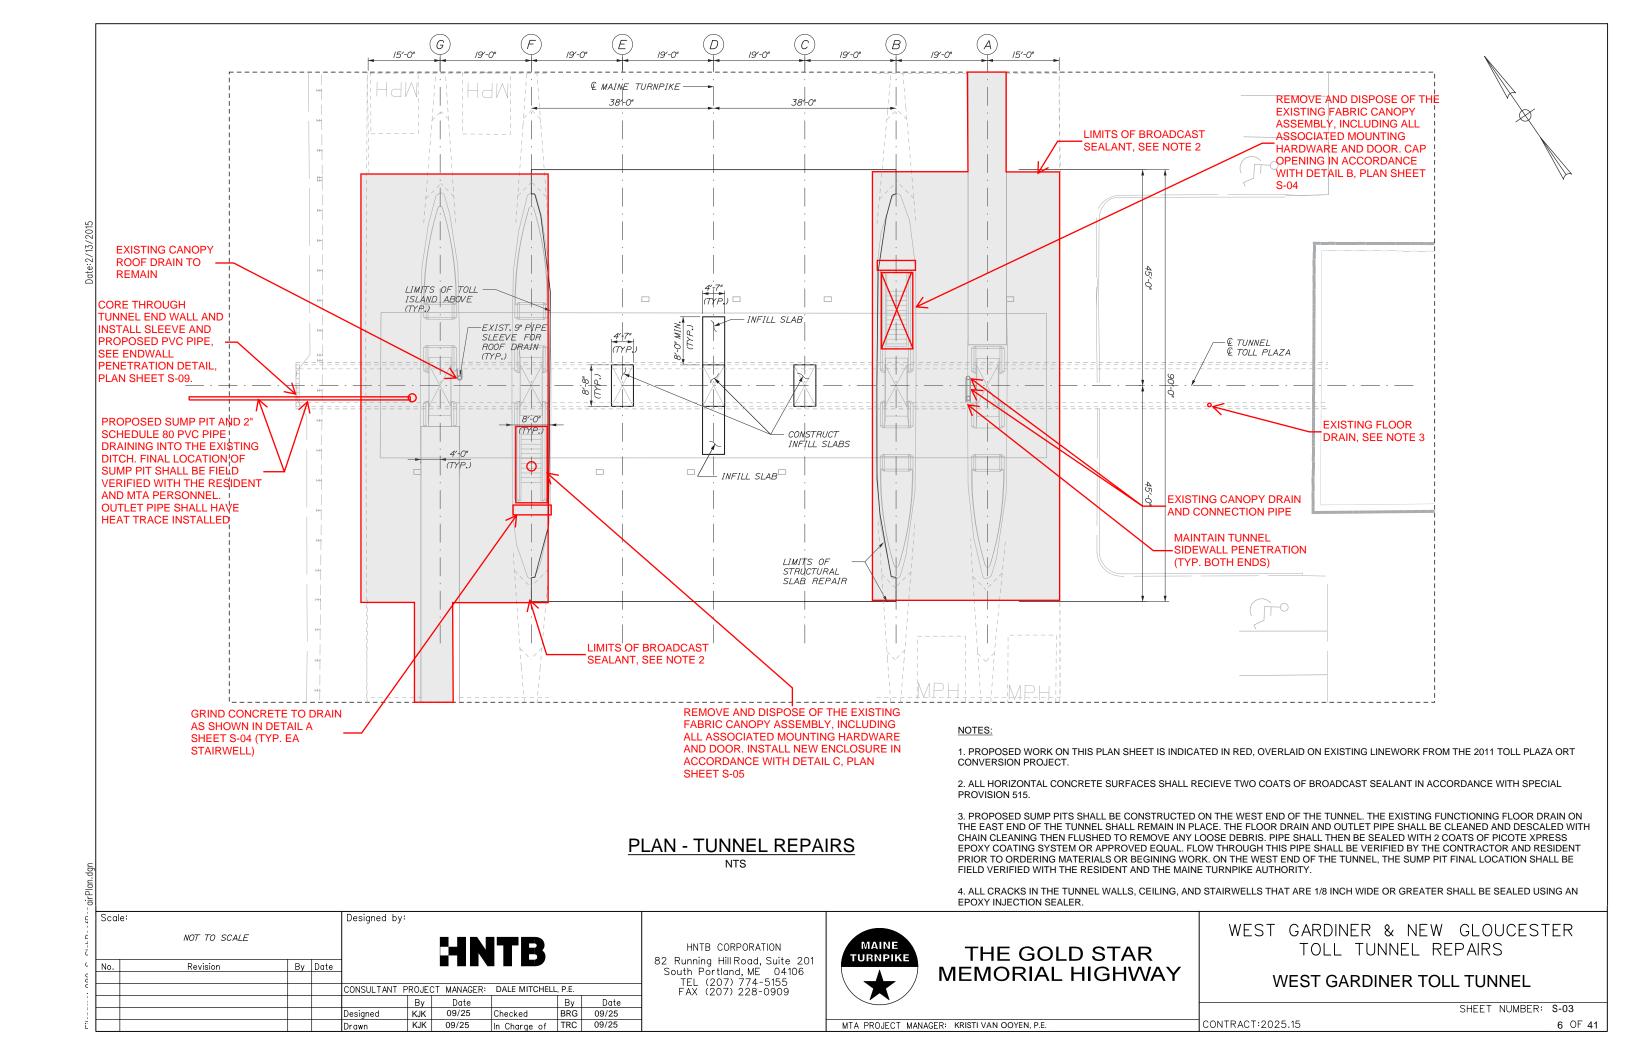

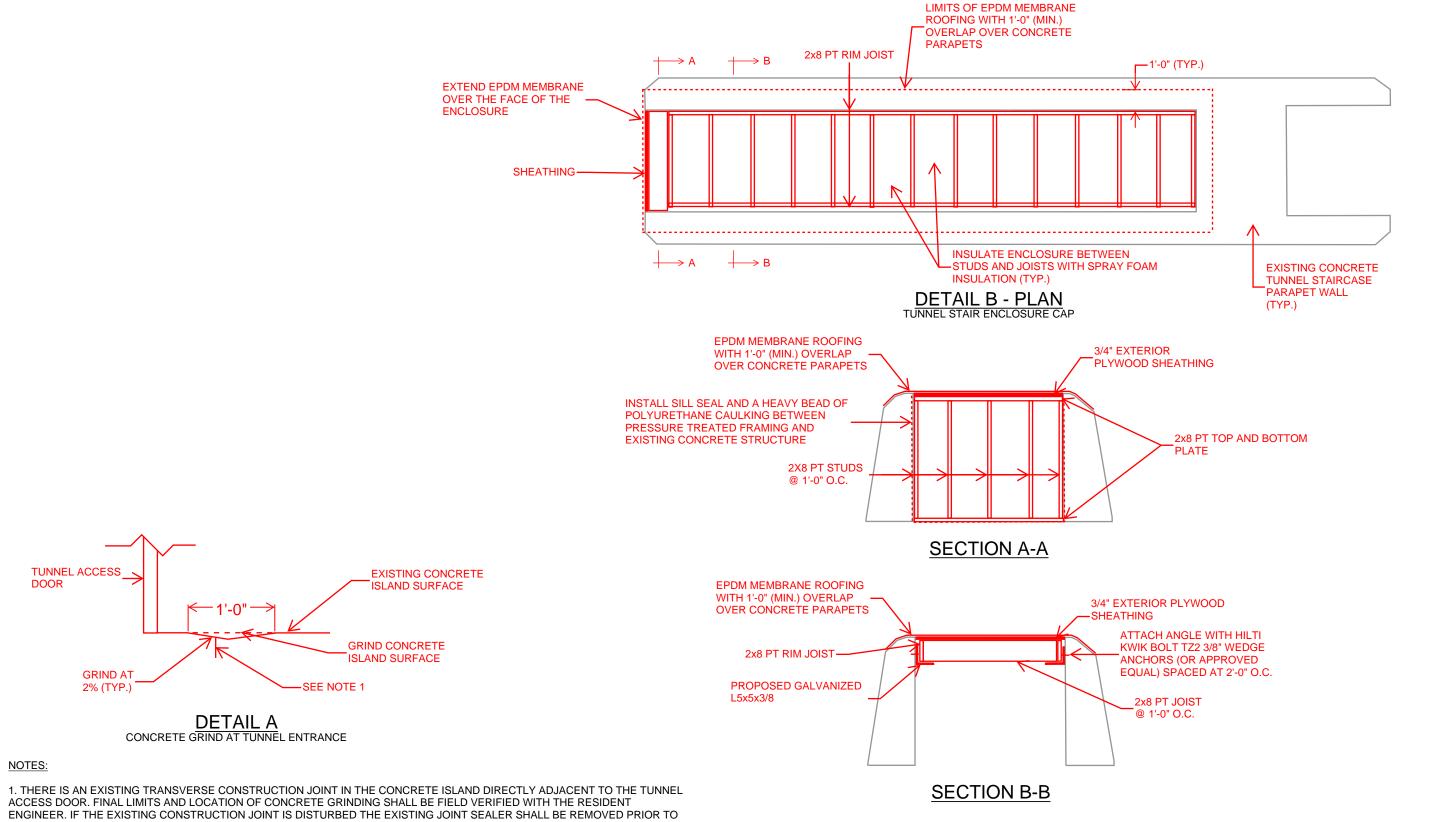

GRINDING ACTIVITIES. AFTER GRINDING IS COMPLETE, THE CONSTRUCTION JOINT SHALL BE CLEANED AND SEALED WITH A SELF LEVELING ELASTOMERIC SEALER (1" DEEP, MIN.). THE CONSTRUCTION JOINT SHALL NOT BE LOCATED AT THE LOW POINT OF THE CONCRETE GRINDING IN THE FINAL CONDITION.

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				CONSULTANT	PROJE	CT MANAGER:	DALE MITCHELL	., P.E.	
					Ву	Date		Ву	Date
				Designed	KJK	09/25	Checked	BRG	09/25
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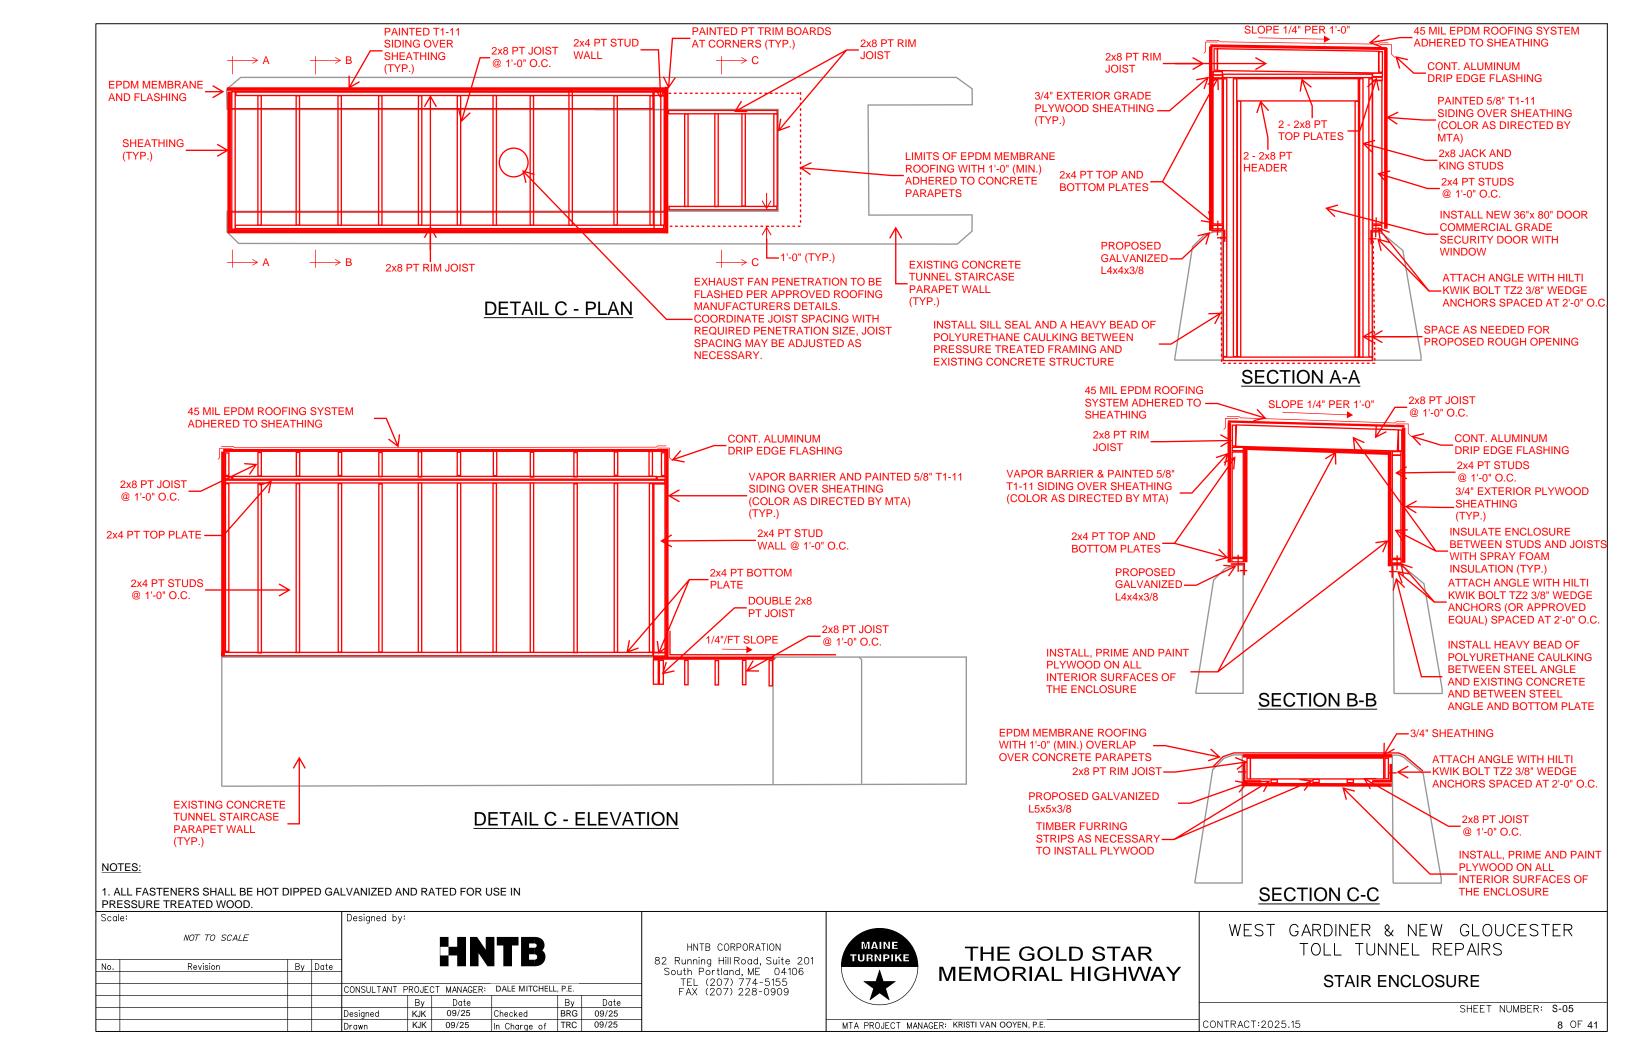



THE GOLD STAR **MEMORIAL HIGHWAY** WEST GARDINER & NEW GLOUCESTER TOLL TUNNEL REPAIRS


STAIR ENCLOSURE CAP

SHEET NUMBER: \$-04

MTA PROJECT MANAGER: KRISTI VAN OOYEN, P.E.



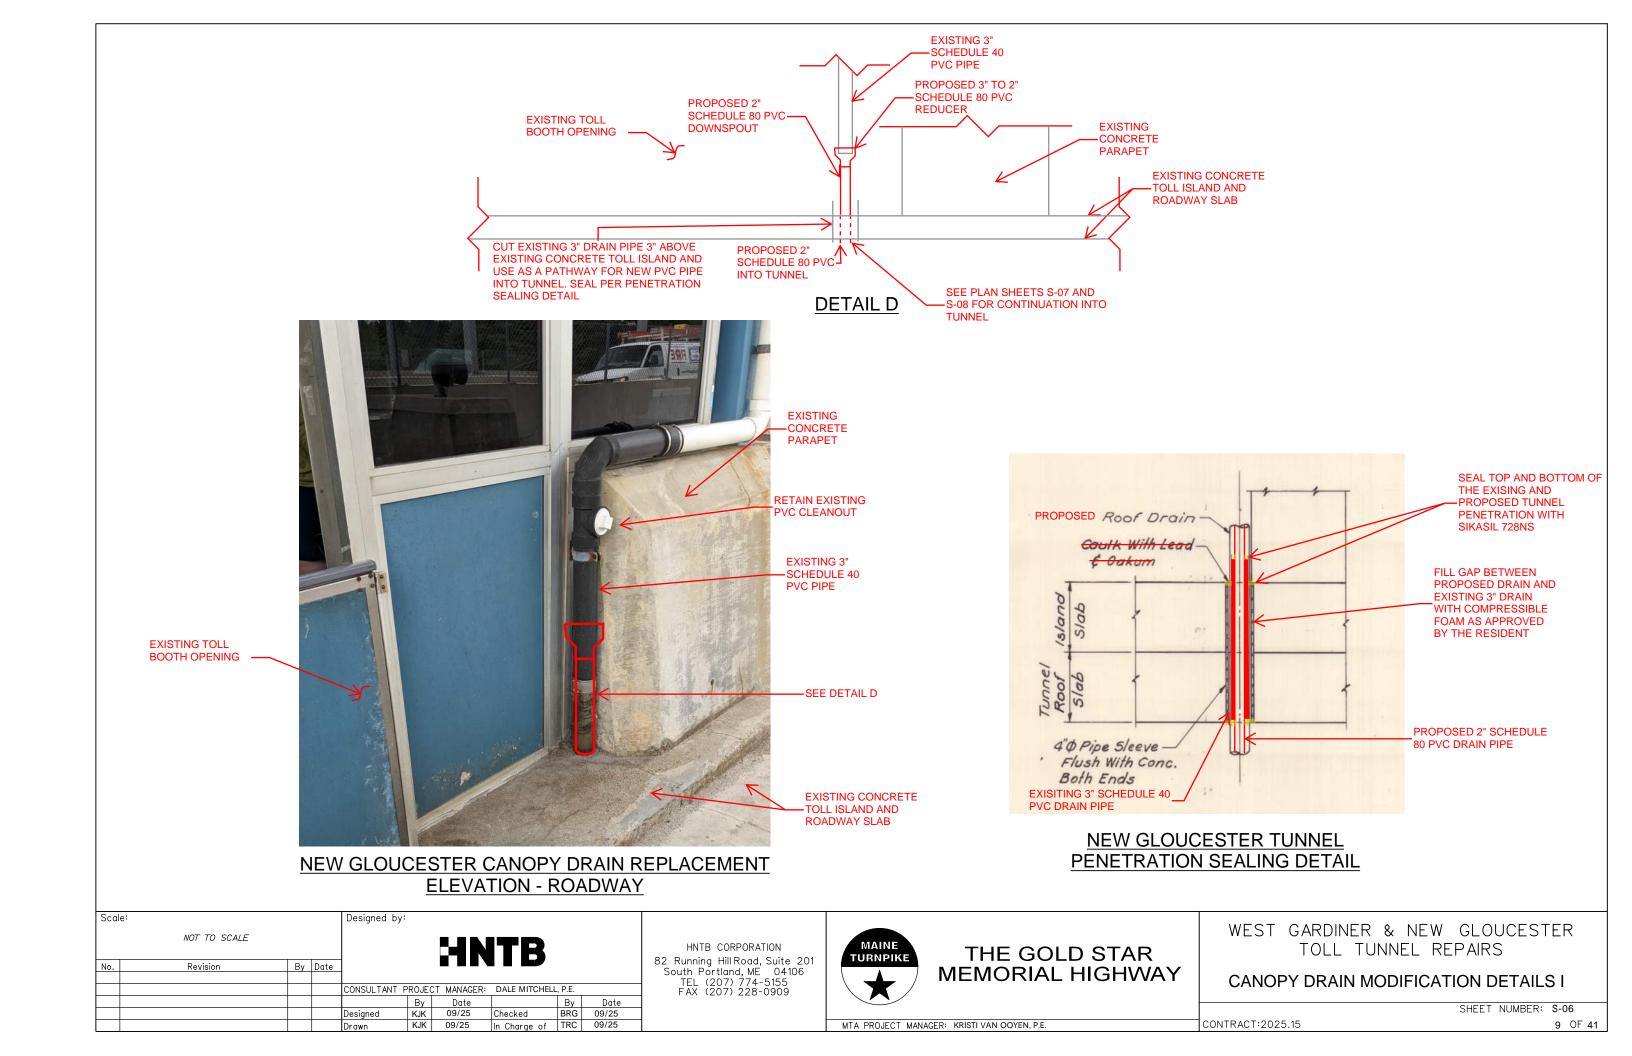

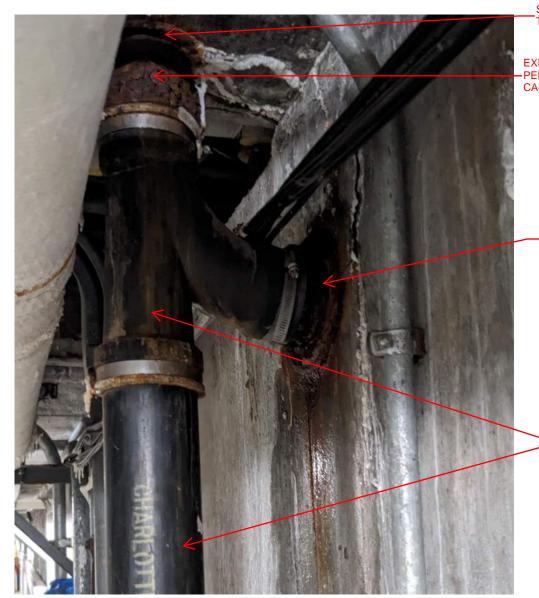

NEW GLOUCESTER CANOPY DRAIN REPLACEMENT ELEVATION - CONFIGURATION 1 SEE PLAN SHEET S-06 FOR TOPSIDE MODIFICATIONS.

EXISTING TUNNEL PENETRATION FROM ROOF **CANOPY DRAIN TO REMAIN**

> CAP AND SEAL EXISTING **TUNNEL SIDE WALL** PENETRATION WITH END OF PIPE PLUG WITH WING NUT

> > PROPOSED 2" SCHEDULE 80 **PVC PIPE**


> > > 3" MIN. 6" MAX.

REMOVE EXISTING WYE FITTING AND 3" SCHEDULE 40 PIPE

EXISTING FLOOR DRAIN TO BE REPLACED, SEE PLAN SHEET S-12

-SEE NOTE 1 SHEET S-08

NEW GLOUCESTER CANOPY DRAIN REPLACEMENT ELEVATION - CONFIGURATION 1

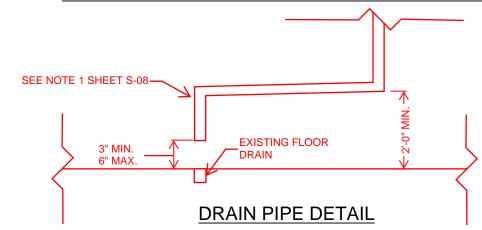

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THE GOLD STAR **MEMORIAL HIGHWAY**

WEST GARDINER & NEW GLOUCESTER TOLL TUNNEL REPAIRS

CANOPY DRAIN MODIFICATION DETAILS II

CONTRACT:2025.15

SHEET NUMBER: \$-07

SEE PLAN SHEET S-06 FOR

TOPSIDE MODIFICATIONS


REMOVE **EXISTING** DOWNSPOUT -AND REPLACE WITH 2" **SCHEDULE 80 PVC PIPE**

EXISTING

ELECTRICAL **RACEWAY**

SEE NOTE 2 -SHEET S-09

MTA PROJECT MANAGER: KRISTI VAN OOYEN, P.E.

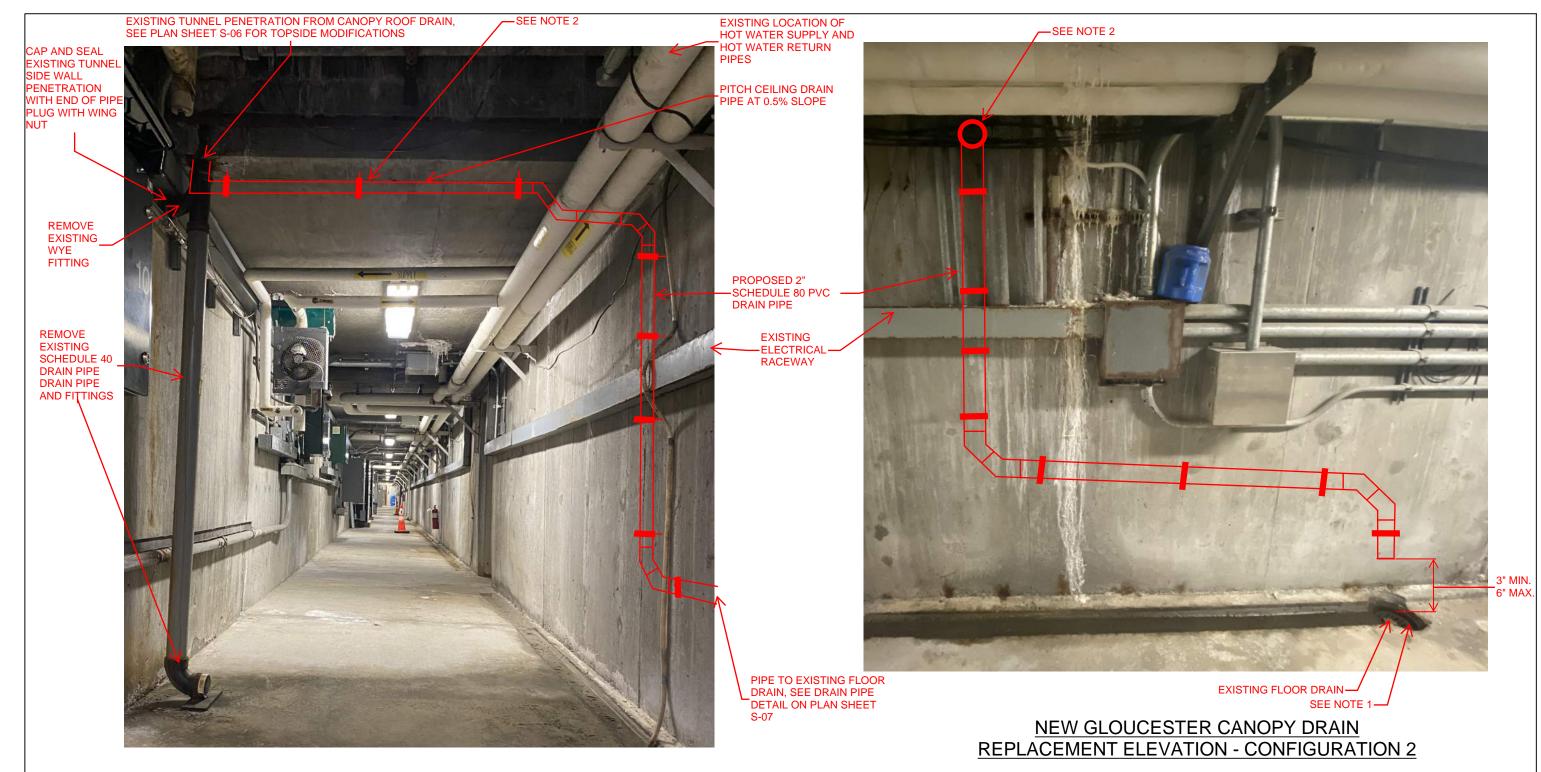

NEW GLOUCESTER CANOPY DRAIN REPLACEMENT ELEVATION - CONFIGURATION 2

NOTES:

- 1. THE DRAIN PIPE DOWNSPOUTS FROM THE TUNNEL PENETRATION SHALL BE PIPED HORIZONTALLY AT 1/4" PER FOOT ALONG THE WALL TO THE CLOSEST FLOOR DRAIN LOCATION AT THE NEW GLOUCSTER TOLL PLAZA.
- 2. SCHEDULE 80 PVC 2" DRAIN PIPE SHALL BE SUPPORTED BOTH HORIZONTALLY AND VERTICALLY USING GALVANIZED SPLIT RING HANGERS WITH MINIMUM 3/8" RODS FASTENED TO CONCRETE STRUCTURE, OR AS APPROVED BY THE RESIDENT. HANGERS SHALL BE SPACED NO FURTHER THAN 48" APART AND WITHIN 12" OF A CHANGE OF DIRECTION.

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				CONSULTANT F	PROJEC	CT MANAGER:	DALE MITCHELL	., P.E.	
					Ву	Date		Ву	Date
				Designed	KJK	09/25	Checked	BRG	09/25
				Drawn	KJK	09/25	In Charge of	TRC	09/25

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THE GOLD STAR **MEMORIAL HIGHWAY**


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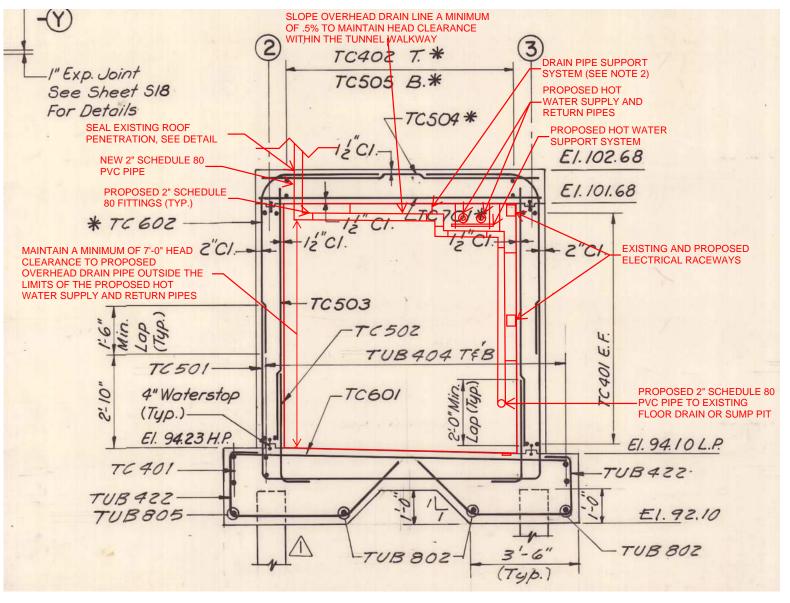
CANOPY DRAIN MODIFICATION DETAILS III

SHEET NUMBER: \$-08

CONTRACT:2025.15

MTA PROJECT MANAGER: KRISTI VAN OOYEN, P.E.



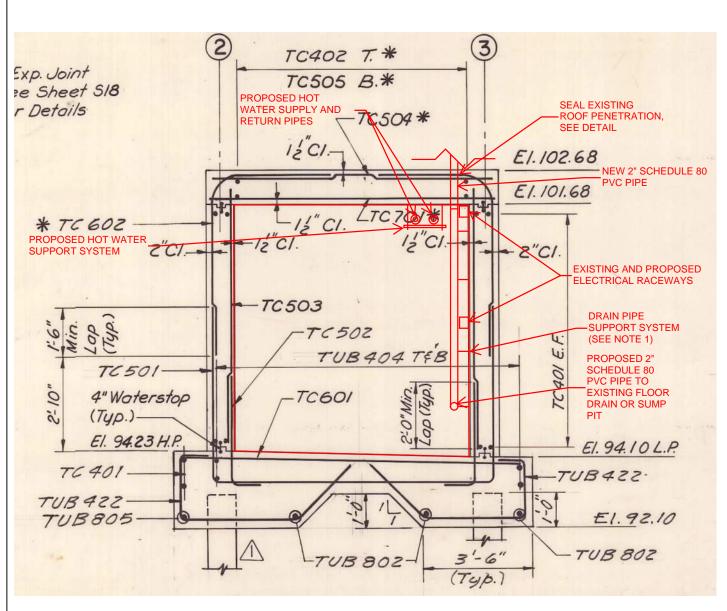

NEW GLOUCESTER CANOPY DRAIN
REPLACEMENT SECTION - CONFIGURATION 1

NEW GLOUCESTER CANOPY DRAIN
REPLACEMENT SECTION - CONFIGURATION 2

CONTRACT:2025.15

NOTES:

1. SCHEDULE 80 PVC 2" DRAIN PIPE SHALL BE SUPPORTED BOTH HORIZONTALLY AND VERTICALLY USING GALVANIZED SPLIT RING HANGERS WITH MINIMUM 3/8" RODS FASTENED TO CONCRETE STRUCTURE, OR AS APPROVED BY THE RESIDENT. HANGERS SHALL BE SPACED NO FURTHER THAN 48" APART AND WITHIN 12" OF A CHANGE OF DIRECTION.

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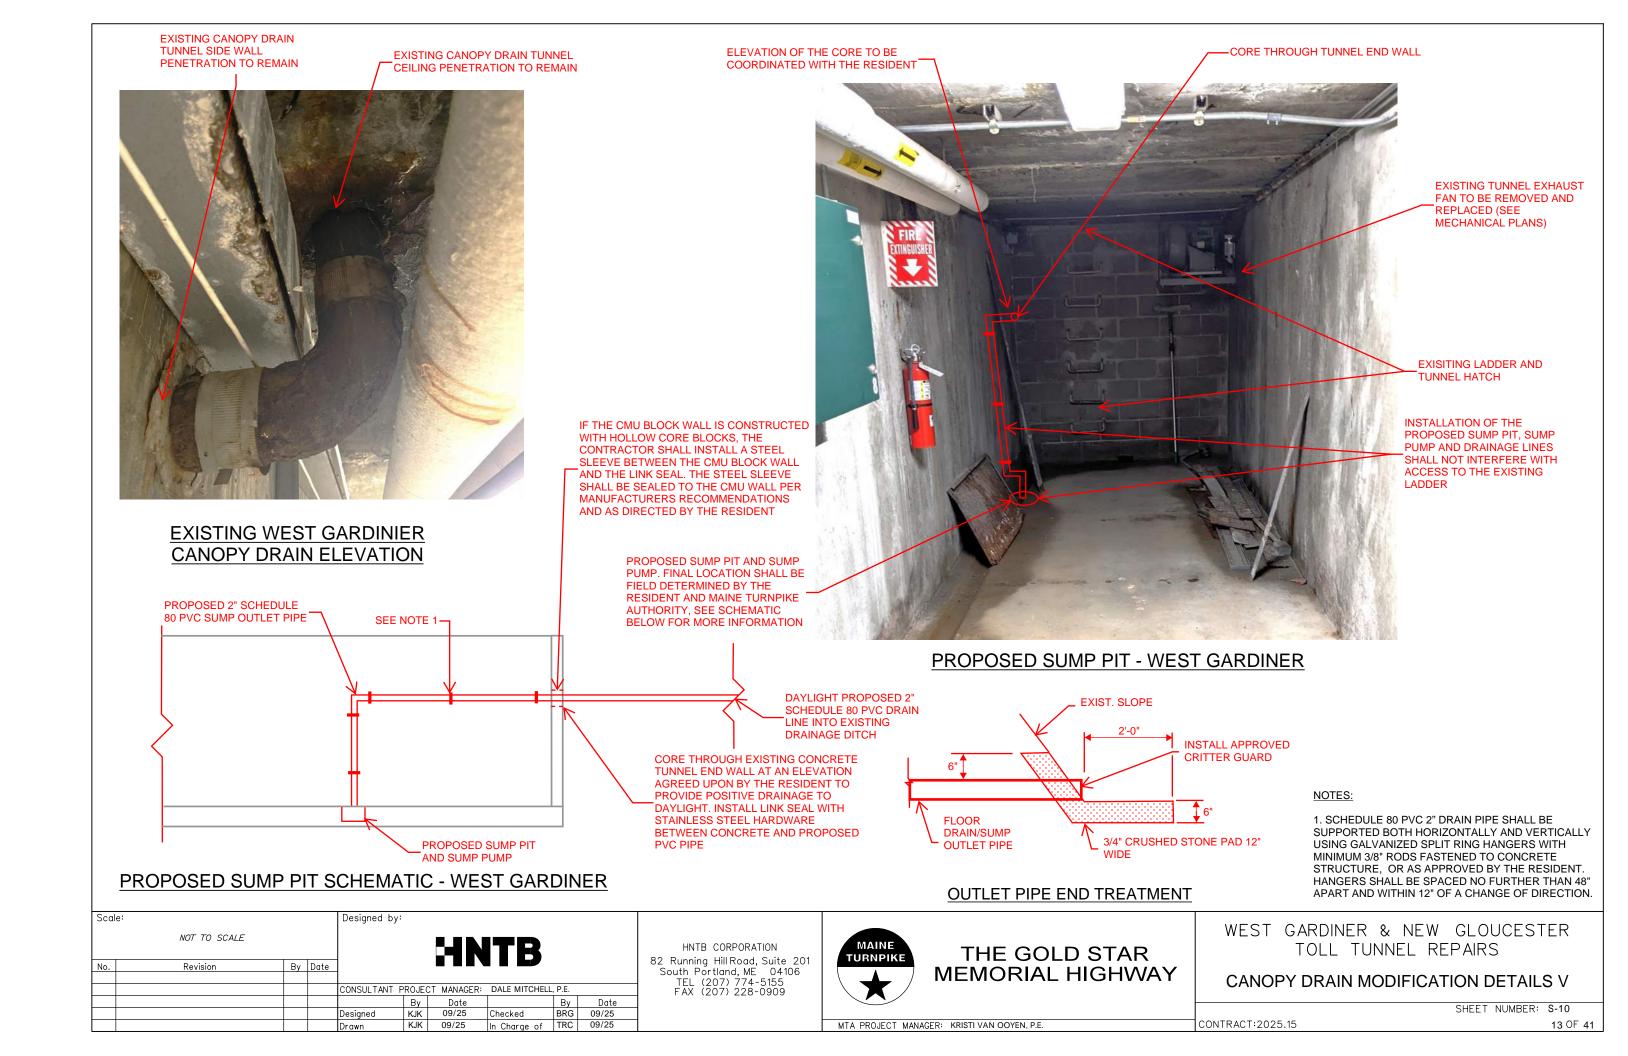
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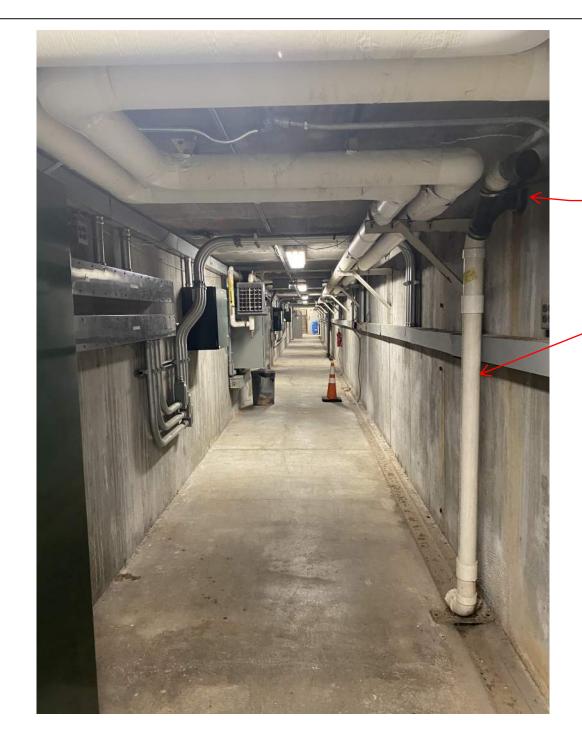
CANOPY DRAIN MODIFICATION DETAILS IV

SHEET NUMBER: S-09

MTA PROJECT MANAGER: KRISTI VAN OOYEN, P.E.


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CAP AND SEAL ALL EXISTING TUNNEL SIDE WALL PENETRATIONS FROM THE ORIGINAL PLAZA THAT ARE NOT IN USE WITH END OF PIPE PLUG WITH WING NUT AT THE DIRECTION OF THE RESIDENT

ALL REMAINING DRAIN PIPES FROM THE ORIGINAL PLAZA THAT ARE NOT IN USE SHALL BE REMOVED AT THE DIRECTION OF THE RESIDENT, LOCATION IS APPROXIMATELY MID-TUNNEL



MISCELLANEOUS DRAINAGE DETAILS

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				CONSULTANT	PROJEC	CT MANAGER:	DALE MITCHELL	., P.E.	
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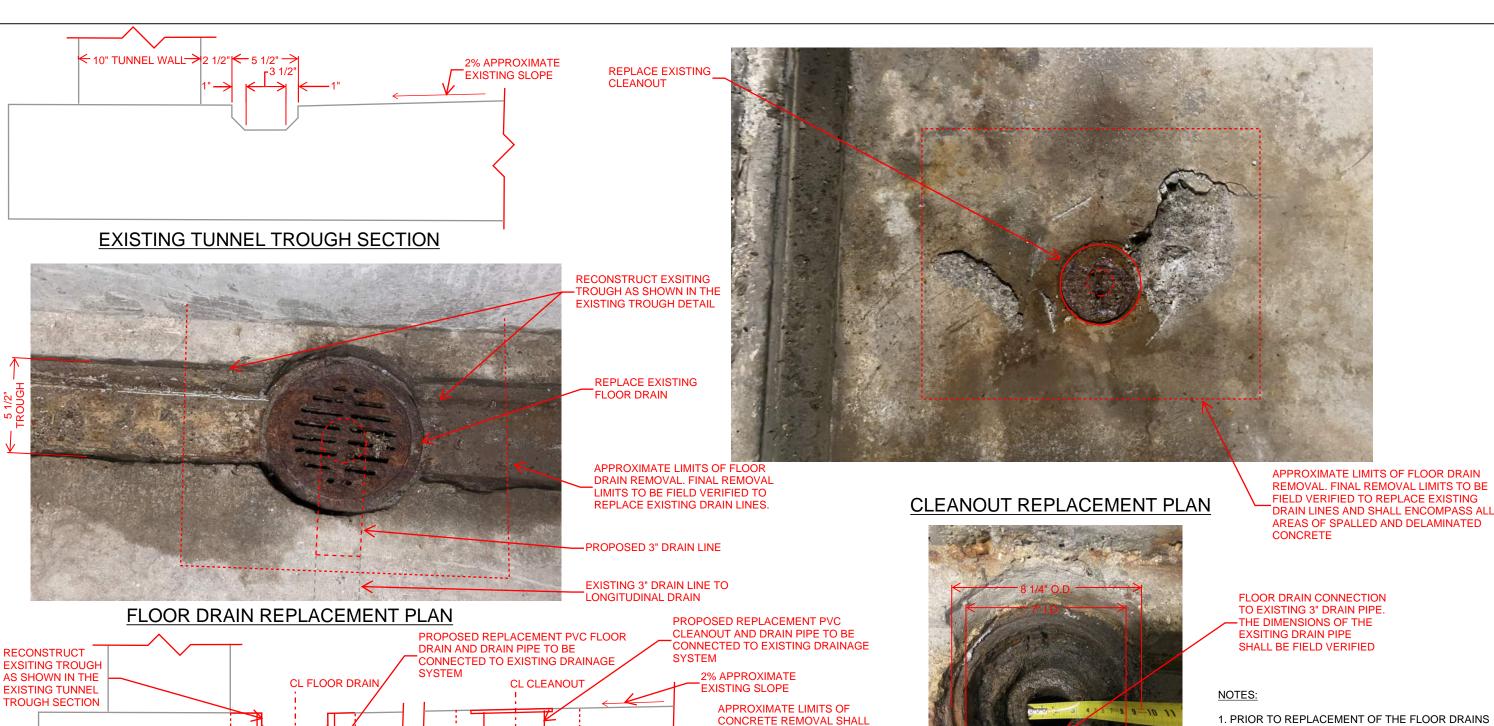
WEST GARDINER & NEW GLOUCESTER TOLL TUNNEL REPAIRS

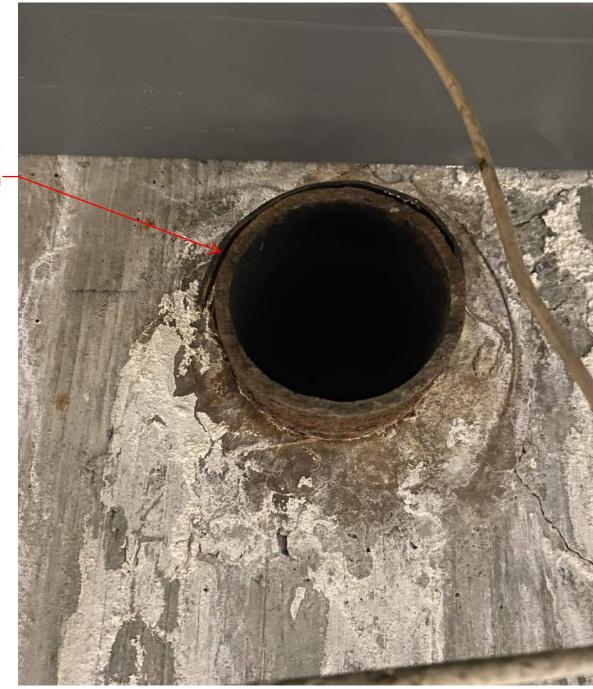CANOPY DRAIN MODIFICATION DETAILS VI

SHEET NUMBER: S-11

MTA PROJECT MANAGER: KRISTI VAN OOYEN, P.E.

CONTRACT: 2025.15 14 OF 41



FLOOR DRAIN CONNECTION TO EXISTING 3" DRAIN PIPE.

1. PRIOR TO REPLACEMENT OF THE FLOOR DRAINS XPRESS EPOXY COATING SYSTEM OR APPROVED

AND CLEANOUTS, ALL PIPES SHALL BE CLEANED AND DESCALED WITH CHAIN CLEANING THEN FLUSHED TO REMOVE ANY LOOSE DEBRIS. PIPES SHALL THEN BE SEALED WITH 2 COATS OF PICOTE

EXISTING FLOOR DRAIN DETAIL

EXISTING FLOOR DRAIN REPLACEMENT SECTION (TYP. BOTH CONNECTIONS) Scale: Designed by: NOT TO SCALE By Date Revision CONSULTANT PROJECT MANAGER: DALE MITCHELL, P.E. Ву 09/25 In Charge of TRC 09/25 09/25

1" MIN.

EXCAVATE AS NECESSARY TO EXPOSE CONNECTION TO

EXISTING VERTICAL PIPE.

BACKFILL WITH CLEAN 3/4"

CRUSHED STONE AND PATCH

CONRETE SLAB, 6" MINIMUM.

(TYP ALL SIDES)

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CUT BACK EXISTING VERTICAL PIPE

COUPLEING AND EXTEND VERTICAL PIPE AS NECESSARY TO INSTALL NEW

CLEANOUTS AND FLOOR DRAINS AT

TO SOLID MATERIAL, INSTALL

FINISHED FLOOR ELEVATION

SAWCUT FOR A MINIMUM OF 1"

DEPTH

CONNECT PROPOSED 3" DRAIN LINE TO EXISTING FLOOR DRAIN SYSTEM


> THE GOLD STAR **MEMORIAL HIGHWAY**

WEST GARDINER & NEW GLOUCESTER TOLL TUNNEL REPAIRS

> FLOOR DRAIN & CLEAN OUT REPLACEMENT DETAILS

> > SHEET NUMBER: \$-12

MTA PROJECT MANAGER: KRISTI VAN OOYEN, P.E.

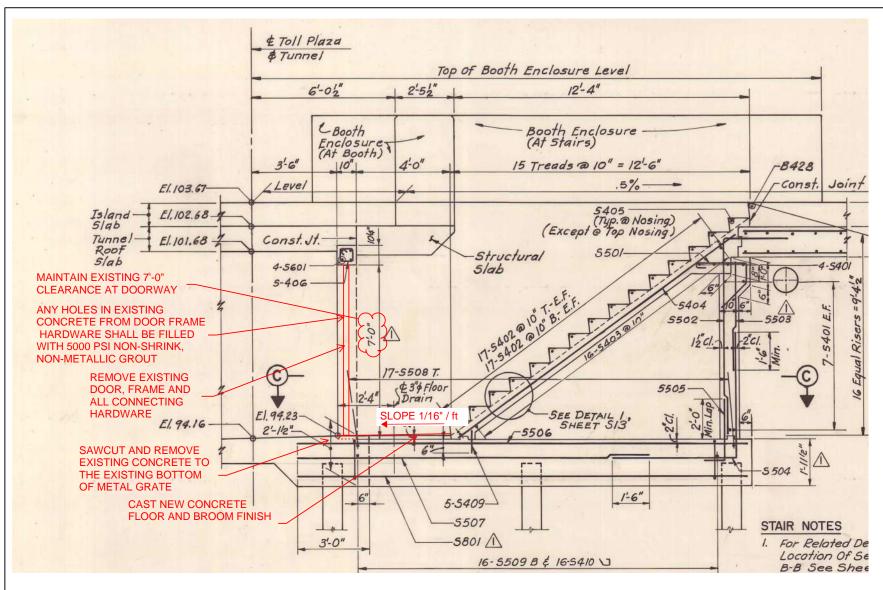

WEST GARDINIER STAIRWELL LANDING SECTION

(SEE WEST GARDINER STAIRWELL LANDING PHOTOS ON SHEET S-14 FOR ADDITIONAL DETAILS)

Ву

In Charge of TRC

Date

09/25

EXISTING CAST ALUMINUM ABRASIVE NOSING TO BE **REMOVED**

NOTE:

Scale:

NOT TO SCALE

Revision

1. STAIRWELL NOSING REPAIRS ARE REQUIRED ONLY AT THE STAIRWELLS TO REMAIN OPEN. CAPPED STAIRWELLS NEED NOT BE REPAIRED.

Designed by:

CONSULTANT PROJECT MANAGER: DALE MITCHELL, P.E. Date

09/25

09/25

2. STAIRWELL LANDING SLOPE REPAIRS ARE REQUIRED AT ALL STAIR LOCATIONS, BOTH CAPPED AND ENCLOSURE ENTRANCE, EXCEPT AS DESCRIBED IN NOTE 1 ON SHEET S-16.

Designed

By Date



HNTB CORPORATION 82 Running Hill Road, Suite 201 South Portland, ME 04106 TEL (207) 774-5155 FAX (207) 228-0909



WEST GARDINER & NEW GLOUCESTER TOLL TUNNEL REPAIRS

STAIR REPAIR DETAILS I

SHEET NUMBER: S-13

REMOVE AND REPLACE

MTA PROJECT MANAGER: KRISTI VAN OOYEN, P.E.

EXISTING DETERIORATED CONCRETE STAIR (BROOM FINISH ON STAIR TREAD) **REMOVE EXISTING** CAST ALUMINUM ABRASIVE NOSING " MIN OR TO SOUND CONCRETE STEEL WING ANCHOR SAWCUT LIMITS OF PROPOSED AREA TO A MINIMUM CONC. STAIRS **DEPTH OF 1"** 00 . 0,

STAIRWELL NOSING REPAIR SECTION

APPROXIMATE CONCRETE REMOVAL AREA. FINAL SAWCUT LIMITS OF REMOVAL AND REPAIR AREAS SHALL BE PROPOSED AREA DETERMINED BY THE RESIDENT AND SHALL TO A MINIMUM INCLUDE ALL AREAS OF CONCRETE DEPTH OF 1" DETERIORATION, SPALLING AND DELAMINATION.

STAIRWELL NOSING REPAIR ELEVATION



WEST GARDINER STAIRWELL LANDING **REPAIR PLAN**

ANY HOLES IN EXISTING **CONCRETE FROM DOOR** FRAME HARDWARE SHALL BE FILLED WITH 5000 PSI NON-SHRINK, NON-METALLIC

REMOVE EXISTING DOOR, FRAME AND ALL CONNECTING HARDWARE

REMOVE EXISTING DEBRIS FROM CONCERTE SURFACE

EXISTING 3" DIA. FLOOR

REMOVE EXISTING METAL GRATE

REMOVE FLOOR DRAIN GRATE AND CAP FLOOR DRAIN TO PREVENT CONCRETE FROM ENTERING THE

ROUGHEN CONCRETE SURFACE TO 1/4" AMPLITUDE AND CLEAN THE SURFACE TO REMOVE ANY DEBRIS PRIOR TO CONCRETE PLACEMENT



WEST GARDINER STAIRWELL LANDING **REPAIR ELEVATION**

Scal	e:			Designed by	<i>/</i> :				
	NOT TO SCALE						ITB		
No.	Revision	Ву	Date	1					
				CONSULTANT	PROJEC	T MANAGER:	DALE MITCHELL	., P.E.	
					Ву	Date		Ву	Date
				Designed	KJK	09/25	Checked	BRG	09/25
				Drawn	KJK	09/25	In Charge of	TRC	09/25

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WEST GARDINER & NEW GLOUCESTER TOLL TUNNEL REPAIRS THE GOLD STAR

STAIR REPAIR DETAILS II

SHEET NUMBER: S-14

MTA PROJECT MANAGER: KRISTI VAN OOYEN, P.E.

ANY HOLES IN EXISTING CONCRETE FROM DOOR FRAME HARDWARE SHALL BE FILLED WITH 5000 PSI NON-SHRINK, CEMENTITIOUS GROUT

SEE NOTE 1-



NEW GLOUCESTER STAIRWELL LANDING REPAIR ELEVATION

REMOVE EXISTING DOOR, -FRAME AND ALL CONNECTING HARDWARE

NOTES:

1. THE EXISTING LANDINGS AT THE NEW GLOUCESTER TOLL PLAZA HAVE BEEN PREVIOUSLY REPAIRED TO REMOVE THE EXISTING GRATING AND PLACE A CONCRETE SLAB. THE EXISTING 3" DIA. FLOOR DRAIN AT THE STAIR LANDING SHALL BE CLEANED AND DESCALED WITH CHAIN CLEANING THEN FLUSHED TO REMOVE ANY LOOSE DEBRIS. IF THE RESIDENT DETERMINES THAT THERE IS ADEQUATE FLOW AT THIS FLOOR DRAIN, THE PIPES SHALL THEN BE SEALED WITH 2 COATS OF PICOTE XPRESS EPOXY COATING SYSTEM OR APPROVED EQUAL. IF IT IS DETERMINED BY THE RESIDENT THAT THERE IS INADEQUATE OR NO DRAINAGE THROUGH THIS PIPE, THEN THE EXISTING FLOOR DRAIN AND CONRETE LANDING SLAB SHALL BE REMOVED AND REPAIRED AS SHOWN ON THE WEST GARDINIER STAIRWELL LANDING DETAILS.

Scale	9:			Designed by:					
	NOT TO SCALE					HN	ITR		
No.	Revision	Ву	Date						
				CONSULTANT F	ROJE	CT MANAGER:	DALE MITCHELL	, P.E.	
					Ву	Date		Ву	Date
				Designed	KJK	09/25	Checked	BRG	09/25
				Drawn	KJK	09/25	In Charge of	TRC	09/25

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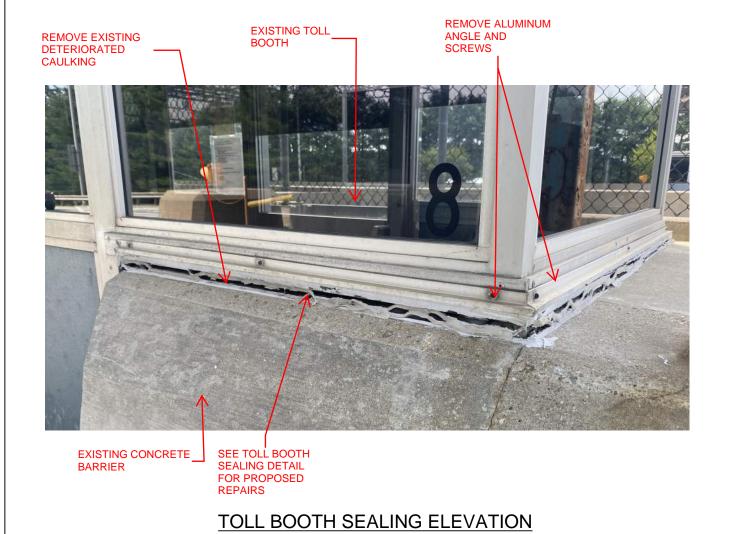
WEST GARDINER & NEW GLOUCESTER TOLL TUNNEL REPAIRS


STAIR REPAIR DETAILS III

SHEET NUMBER: S-15

MTA PROJECT MANAGER: KRISTI VAN OOYEN, P.E. CONTRACT: 2025.15

18 OF 41



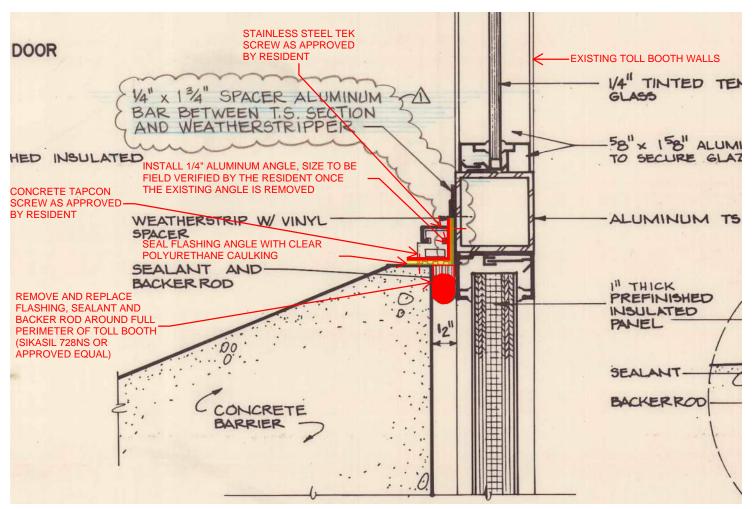

TOLL BOOTH SEALING DETAIL

CONTRACT:2025.15

Scale:				Designed b	y:				
	NOT TO SCALE						ITB		
No.	Revision	Ву	Date	-					
				CONSULTANT	PROJEC	T MANAGER:	DALE MITCHEL	L, P.E.	
					Ву	Date		Ву	Date
				Designed	KJK	09/25	Checked	BRG	09/25
				Drawn	KJK	09/25	In Charge of	TRC	09/25

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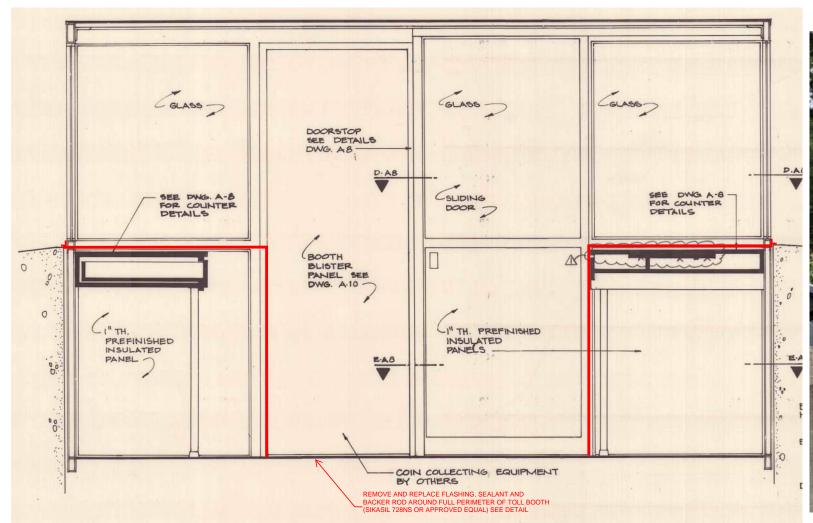
WEST GARDINER & NEW GLOUCESTER TOLL TUNNEL REPAIRS

TOLL BOOTH SEALING DETAILS I

SHEET NUMBER: S-16

MTA PROJECT MANAGER: KRISTI VAN OOYEN, P.E.

19 OF 4





TOLLBOOTH SEALING ELEVATION

Scale:				Designed by	y:				
	NOT TO SCALE						ITB		
No.	Revision	Ву	Date	1					
				CONSULTANT	PROJECT	MANAGER:	DALE MITCHELL	., P.E.	
					Ву	Date		Ву	Date
				Designed	KJK	09/25	Checked	BRG	09/25
				Drawn	KJK	09/25	In Charge of	TRC	09/25

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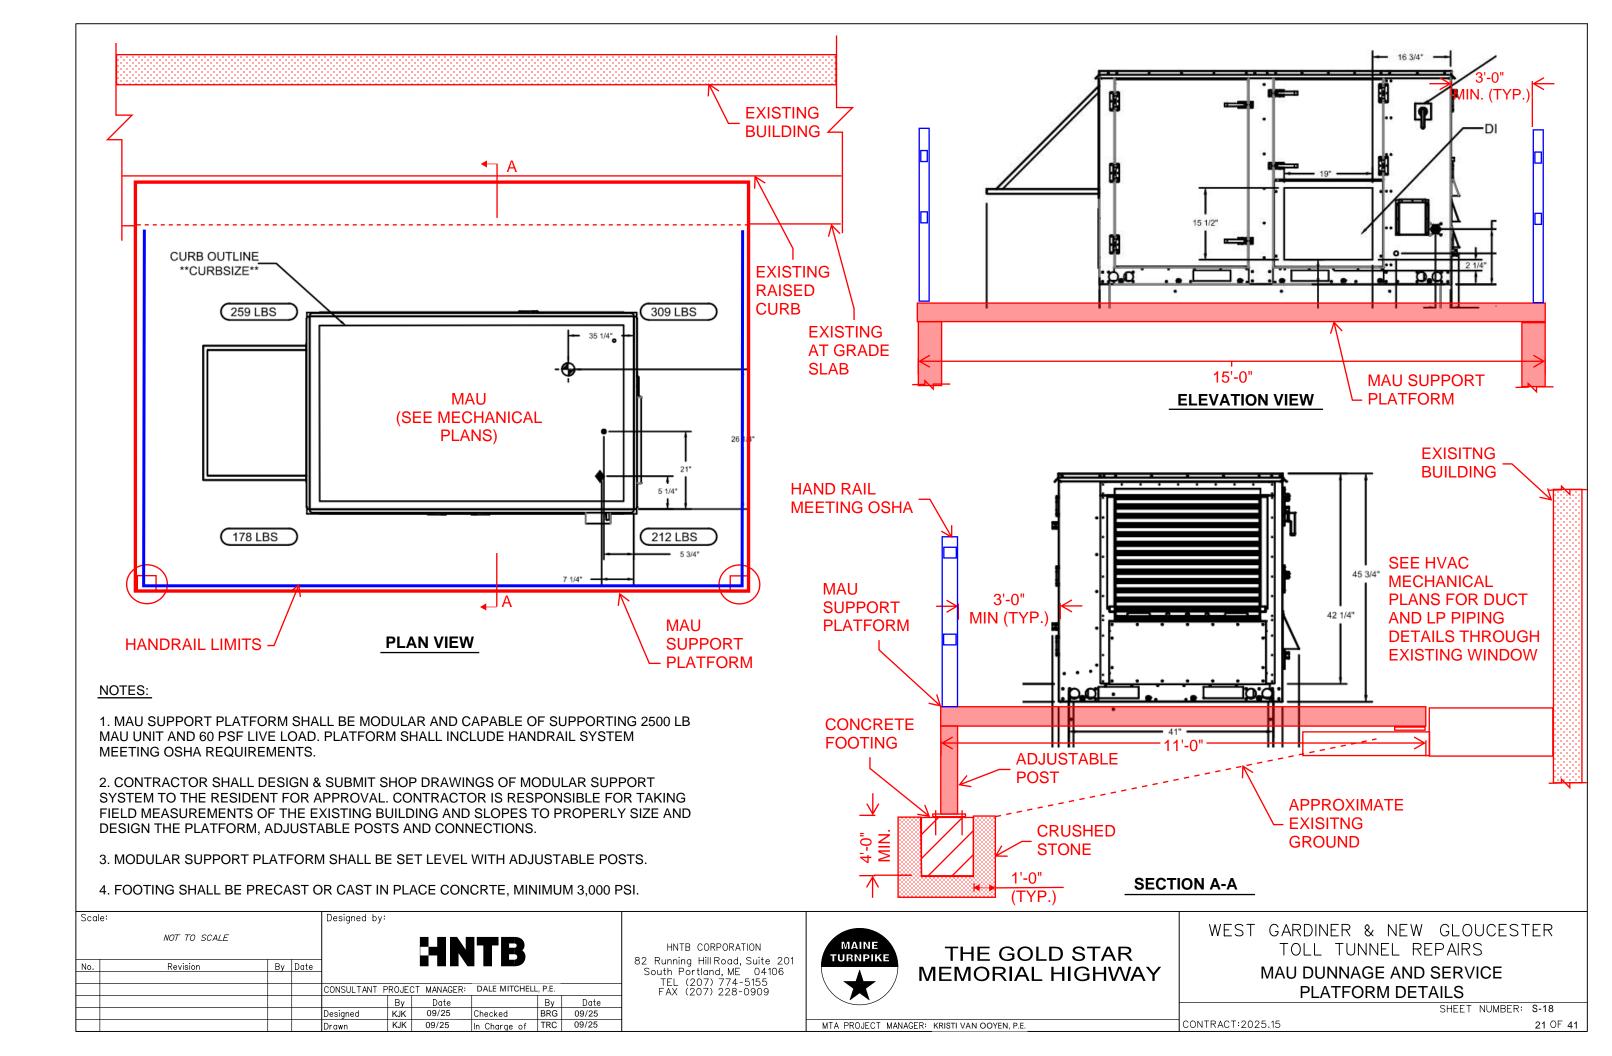



WEST GARDINER & NEW GLOUCESTER TOLL TUNNEL REPAIRS


TOLL BOOTH SEALING DETAILS II


SHEET NUMBER: S-17 CONTRACT:2025.15


MTA PROJECT MANAGER: KRISTI VAN OOYEN, P.E.



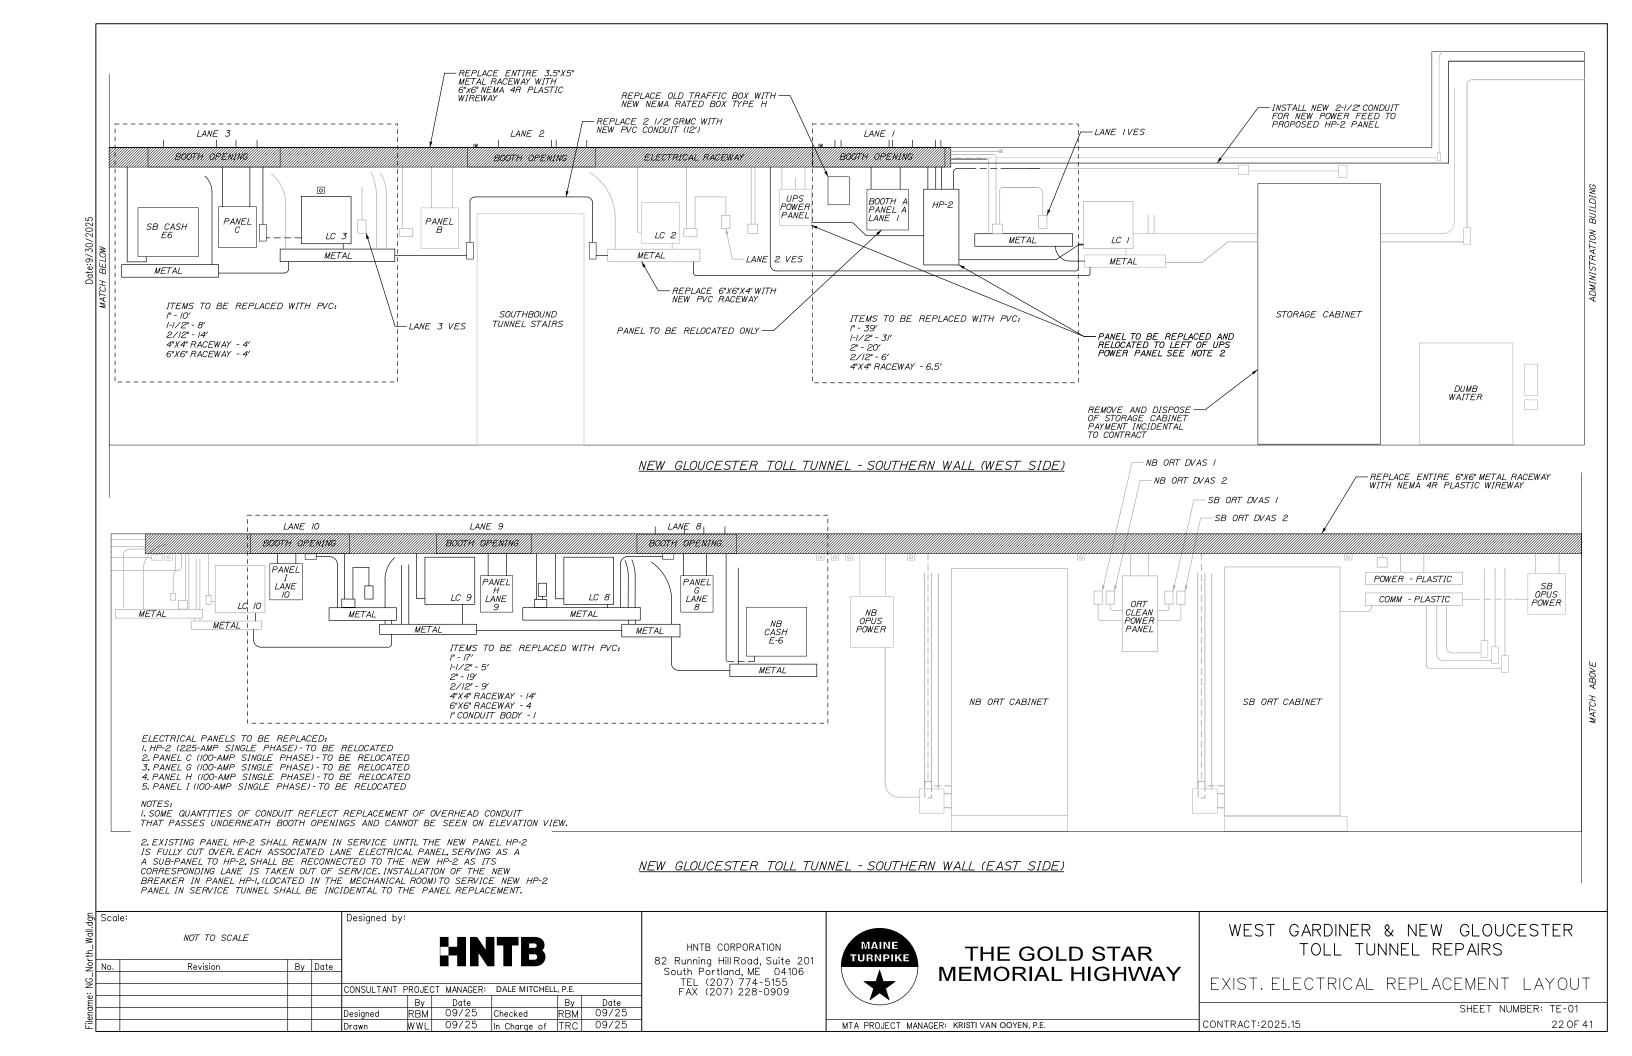

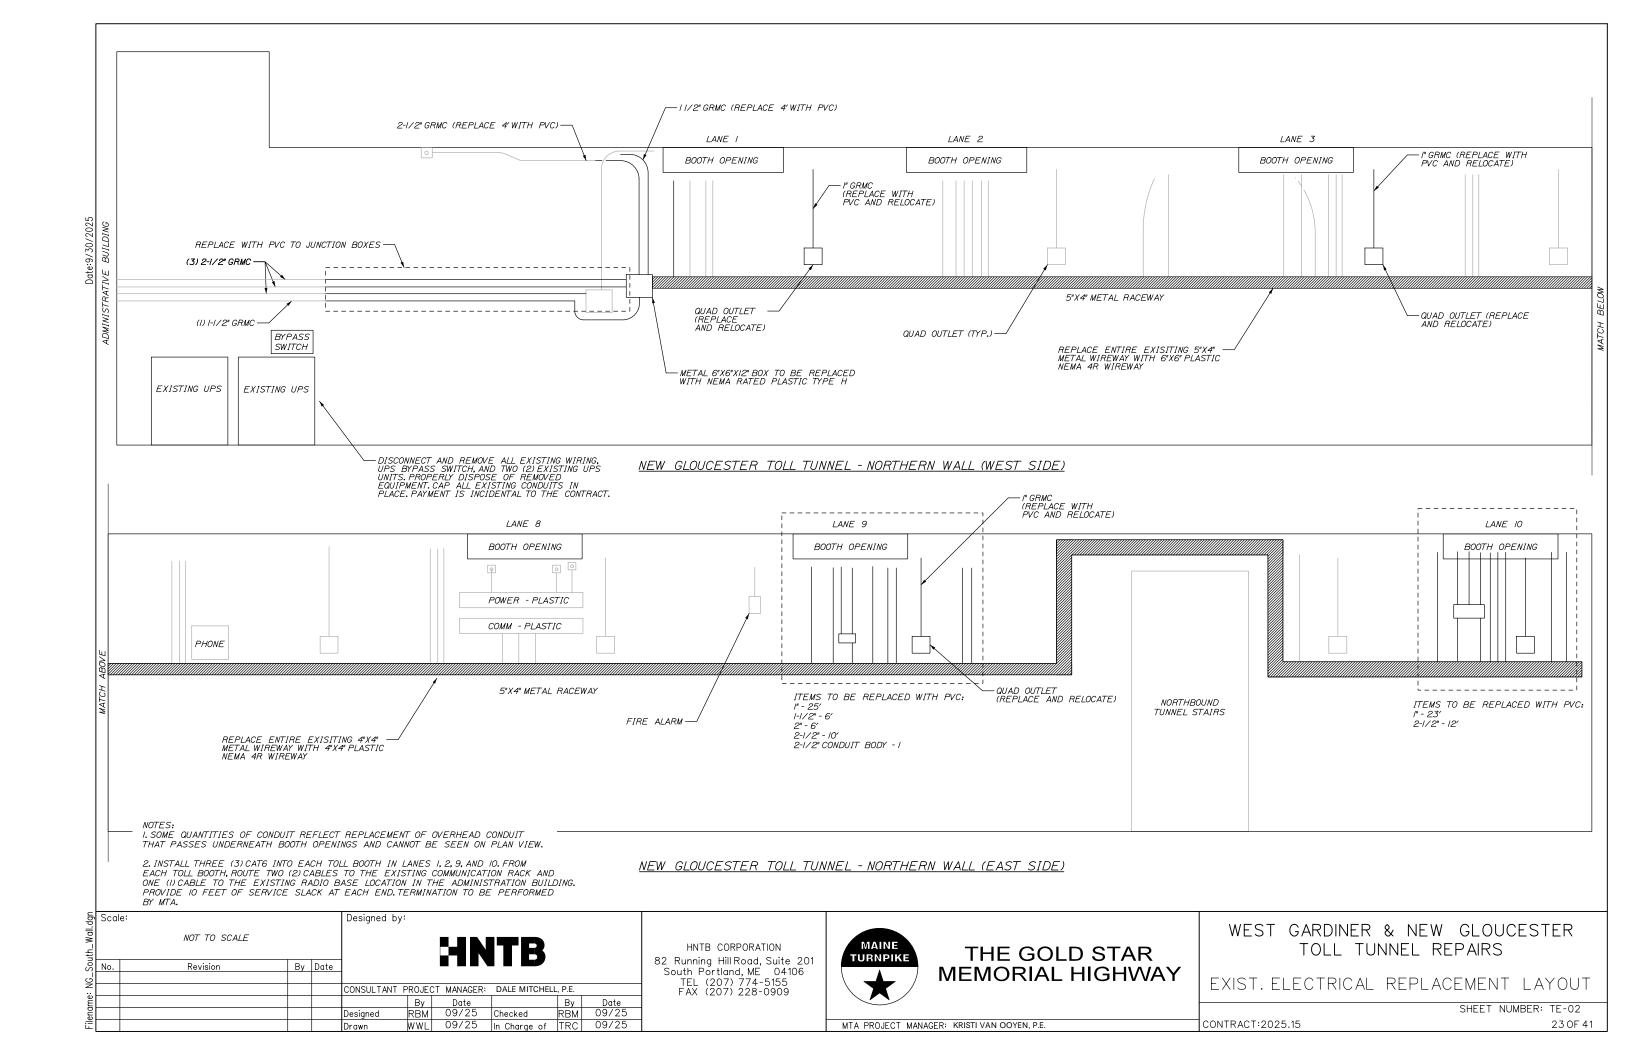

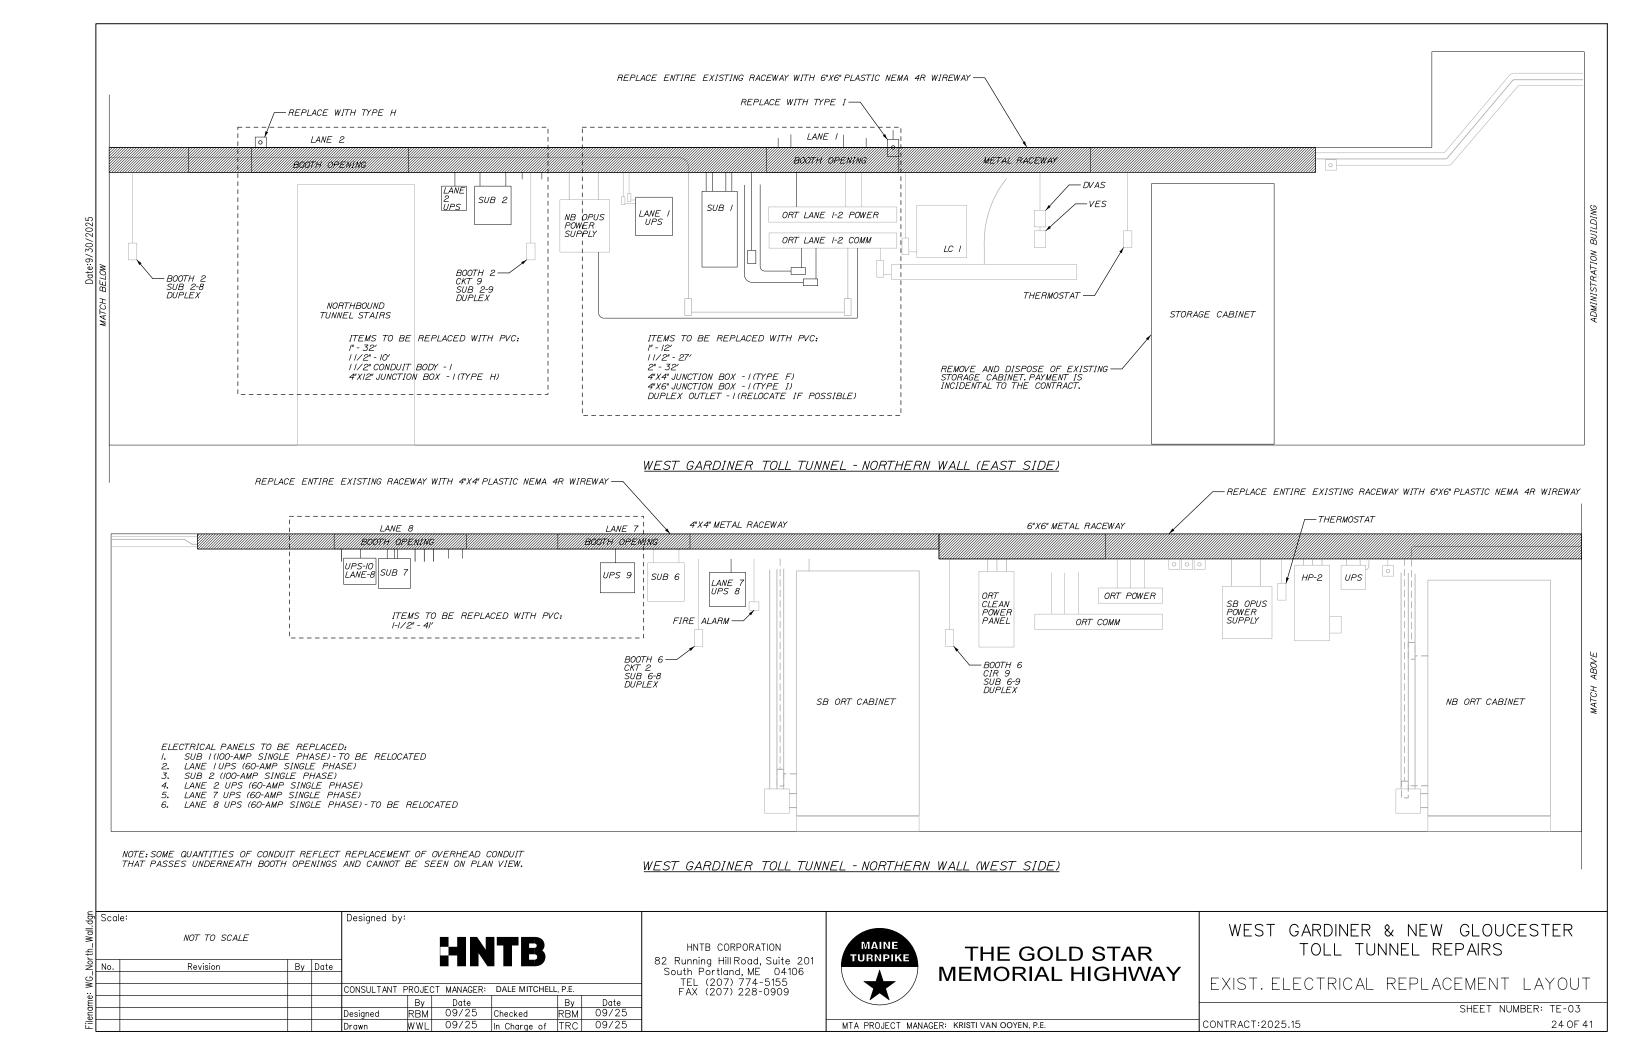

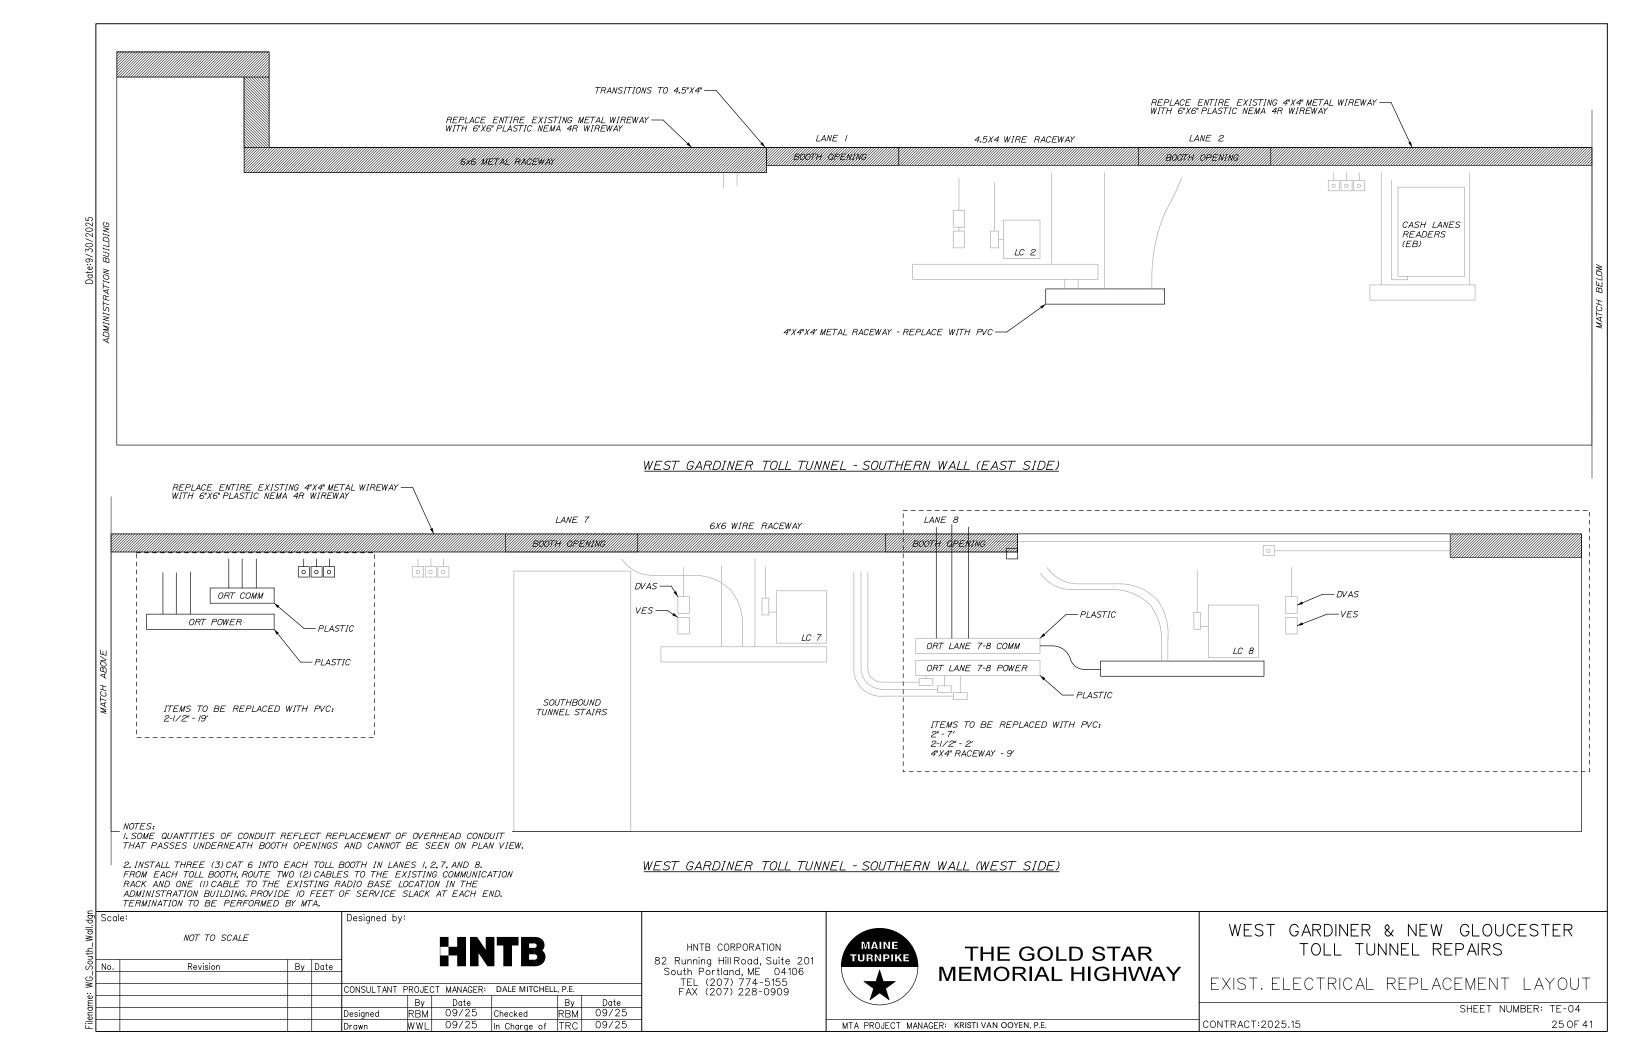

F,	1		2	3	4	1	5 , 6			7	. 8		9
	-		,				D MECHANICAL DRAWINGS FOR ADDITIONAL INFORMATION AS	BOUT					-
A	AMPERE	MC	MICROPHONE		DEMOLITION SCOPE OF WORK AS RELATED TO THEIR							1	
AC AFF	ALTERNATING CURRENT ABOVE FINISHED FLOOR	MW MLO	MICROWAVE MAIN LUG ONLY		ES REPRESENT WALLS SCHEDULED FOR REMOVAL; SC		SENT WALLS REMAINING OR NEW WALLS.		1 00	NOT SCALE THE DRAWING	2S PEEED TO	1	
AFG	ABOVE FINISHED FLOOR ABOVE FINISHED GRADE	MT	MOUNT		EGEND FOR DEFINITION OF (E), (R), (ER) AND (RL) TAGS				AF	CHITECTURAL DRAWINGS	AND EXISTING	1	
AHU	AIR HANDLING UNIT	MTS	MANUAL TRANSFER SWITCH	COMPONEN'	TS FOR INSTALLATION AT NEW LOCATION. EXTEND CO		QUIPMENT SCHEDULE FOR RELOCATION. PROVIDE REQUIRED S ROM EXISTING SOURCE OR LAST MAINTAINED ACTIVE DEVICE			E LOCATION OF EQUIPMEN		1	
AIC	AMPERES INTERRUPTING CAPACITY	MCP	MOTOR CONTROL PANEL		ND RE-TERMINATE TO DEVICE/EQUIPMENT.	LOCATED ON WAL	LO COLUEDUR ED FOR DEMOVAL (F.O. LIQUENIO DECEDIA OLEO	CONTROL	Gľ	/EN ON THE DRAWINGS IS ALL BE UNDERSTOOD THA	APPROXIMATE. IT	1	
ATS AWG	AUTOMATIC TRANSFER SWITCH AMERICAN WIRE GAUGE	MH MDP	METAL HALIDE MAIN DISTRIBUTION PANEL	DEVICES, SV	VITCHES, POWER DISTRIBUTION EQUIPMENT, FIRE ALA		LLS SCHEDULED FOR REMOVAL (E.G. LIGHTING, RECEPTACLES, IMUNICATION AND DATA DEVICES, ETC.) UNLESS OTHERWISE S		AF	E SUBJECT TO MODIFICAT CESSARY OR DESIRABLE	ION AS MAY BE FOUND	1	
BAS	BUILDING AUTOMATION SYSTEM	MIN	MINIMUM	NOTED ON T		LED TO BE DEMOV	VED BACK TO THE BOINT OF CONNECTION OR THE NEXT ACTIVE	YE DEVICE	IN	STALLATION IN ORDER TO I	MEET PROJECT	1	
BKBD	BACKBOARD	N	NEUTRAL		T AND REMOVE ALL WIRING FOR EQUIPMENT, SCHEDO TO REMAIN. NOTHING SHALL BE ABANDONED IN PLAC		/ED, BACK TO THE POINT OF CONNECTION OR THE NEXT ACTIV	E DEVICE		THOUT EXTRA CHARGE.	1020 01 11 122 22 111 132	1	
С	CONDUIT	NC	NORMALLY CLOSED	7. VERIFY ALL	EXISTING SOURCES OF POWER TO DEVICES/EQUIPME	NT PRIOR TO FINAL	L REMOVAL.			LELECTRICAL DEVICES, W PROTECTED FROM DAMA		1	
E CAT	CATALOG, CATEGORY	NEC	NATIONAL ELECTRICAL MANUFACTURERS	8. COORDINAT	E ALL SHUTDOWN PROCEDURES WITH THE OWNER PR	IOR TO DISCONNE	CTING ANY CIRCUITS.		CC	NSTRUCTION. COVER PLA STALLED AFTER FINISH MA	TES SHALL BE	1	
CATV	CABLE TV	NEMA	NATIONAL ELECTRICAL MANUFACTURERS ASSOCIATION	9. ALL DEVICES	S/EQUIPMENT LOCATED ON WALLS SCHEDULED TO RE	MAIN SHALL BE MA	AINTAINED; RECIRCUIT THESE DEVICES/EQUIPMENT AS NECESS	SARY.		PLIED.	TERMINES TIME BEEN	1	
СВ	CIRCUIT BREAKER	NFPA	NATIONAL FIRE PROTECTION ASSOCIATION		WALL OR SYSTEM COMPONENT REMOVALS IMPACT W NS AS REQUIRED TO RE-FEED THESE DEVICES/EQUIPM		G DEVICES/EQUIPMENT SCHEDULED TO REMAIN, PROVIDE WIR	ING AND		ORDINATE ALL WORK WITH DITHE OWNER.	H OTHER DIVISIONS	1	
CCTV	CLOSED CIRCUIT TELEVISION	NIC	NOT IN CONTRACT				LETS IN EXISTING WALLS THAT ARE SCHEDULED TO REMAIN.			RIFY EXACT POWER REQU	IREMENTS OF	1	
CM	CIRCULAR MILS	NF	NON-FUSED				T/CONDUIT/WIRING/BOXES INCLUDING BALLASTS, DRIVERS, LAI	MDS		UIPMENT PRIOR TO ROUG			E ALARM CONTROL PANEL, MOUNT WITH TOP OF PANEL NOT RE THAN 72"AFF
COMM	COMMUNICATIONS MECH CONDENSING UNIT	NO NO., #	NORMALLY OPEN NUMBER	THERMOSTA	ATS, ETC. LEGALLY DISPOSE OF ALL HAZARDOUS MATE	RIALS. COORDINA	TE WITH THE OWNER TO RECEIVE DIRECTION FOR ANY REMOV NNECT AND REMOVED THEM THEN RELOCATE THEM TO A LOCATE T	/ED		ORDINATE LOCATIONS OF			E ALARM TRANSPONDER CABINET
CU	COPPER	NTS	NOT TO SCALE		D BY THE OWNER.	AREI GEET BIGGOT	NACOT AND REMOVED THEM THEN RECOGNIC THEM TO A EGO.	ATION ON OILE	AF	CHITECTURAL INTERIOR E	LEVATIONS.		E ALARM ANNUNCIATOR, MOUNT WITH TOP OF PANEL NOT MOR
CUH	CABINET UNIT HEATER	ОС	ON CENTER	13. THE ELECTR	RICAL DEMOLITION FLOOR PLANS REPRESENT THE GET	IERAL SCOPE AND	ARE NOT INTENDED TO SHOW ALL EXISTING EQUIPMENT, WIR	ING, CONDUITS,		FER TO EQUIPMENT SCHE VICES AND POWER REQUI			AN 72"AFF, WIRED TO FACP
CR	CORD REEL						SCOPE CLARIFICATION AS NEEDED PRIOR TO REMOVING ITEMS		FL	OOR PLANS FOR ALL DIVIS QUIREMENTS.			OKE DETECTOR, WIRED TO FACP "E" INDICATES CONNECTION R ELEVATOR RECALL, WIRED TO FACP
DC	DIRECT CURRENT	OCC	OCCUPANCY	14. COORDINAT	E, IN FIELD, WITH OTHER TRADES AND THEIR SYSTEM	COMPONENTS SCH	HEDULED FOR REMOVAL TO ENSURE ANY RELATED POWER HA	AS BEEN					AT DETECTOR, "E" INDICATES CONNECTION FOR ELEVATOR
D DN	DIGITAL DIRECT CONTROL DOWN	P	OVERHEAD POLE				S AND EXTERIOR WALL MOUNTED FIXTURES AS WELL AS THEIF	R RELATED					CALL, WIRED TO FACP
DW	DISHWASHER	PA	PUBLIC ADDRESS		EVICES AND WIRING.		- I I I I I I I I I I I I I I I I I I I					♠ DUC	CT SMOKE DETECTOR, WIRED TO FACP
DWG	DRAWING	PB	PULLBOX				LOADS THAT HAVE BEEN REMOVED. TURN TO THE OFF POSITIC NEL ENCLOSURES WHERE OPENINGS HAVE BEEN LEFT DUE TO						IGLE STATION SMOKE DETECTOR WITH AUDIBLE INDICATING PLIANCE, WALL MOUNTED
EF ELEV	EXHAUST FAN ELEVATOR	PH, Ø PIR	PHASE PASSIVE INFRARED		OR WRING AND PROVIDE BLANKING PLATES IN PANELS			TREMOVES					IGLE STATION SMOKE DETECTOR WITH AUDIBLE/VISUAL
EMT	ELECTRICAL METALLIC TUBING	PNL	PANELBOARD	D3	ELECTRICAL REMOVALS NOTES				D7	ELECTRICAL GE	NERAL NOTES	INDI	DICATING APPLIANCE, CEILING MOUNTED
EP	EXPLOSION PROOF	P/O	PART OF									SING WIT	IGLE/MULTI-STATION SMOKE/CARBON MONOXIDE DETECTOR I'H AUDIBLE INDICATING APPLIANCE, CEILING MOUNTED
ERU	ENERGY RECOVERY UNIT	PV	PHOTOVOLTAIC						LIGHT	ING SWITCHES			IGLE/MULTI-STATION SMOKE/CARBON MONOXIDE DETECTOR
EWC FACP	ELECTRIC WATER COOLER	PVC	POLY-VINYL CHLORIDE						\$a LIGHT SV	/ITCH, 20A,125/277V			TH AUDIBLE INDICATING APPLIANCE, WALL MOUNTED
FB	FIRE ALARM CONTROL PANEL FLOOR BOX	REC REF	RECEPTACLE REFRIGERATOR							NGED SWITCHES, GANG L S SWITCHING	INDER ONE PLATE, LETTER		S DETECTOR, WIRED TO FACP
FLA	FULL LOAD AMPS	RF	RETURN FAN			CIN	NGLE RECEPTACLES				IDANICY SENSOR SWITCH	ÇÓ CAR	RBON MONOXIDE DETECTOR, WIRED TO FACP
FWE	FURNISHED WITH EQUIPMENT	RGS	RIGID GALVANIZED STEEL	■ PA	NELBOARD ~ FLUSH MOUNTED	IP -				NCY SENSOR SWITCHOCCI		t) FLAI	AME DETECTOR, WIRED TO FACP
C G, GND		RM	ROOM	■ PA	NELBOARD ~ SURFACE MOUNTED	30" ¥ SC⊦	:CIAL RECEPTACLE ~ REFER TO SPECIAL RECEPTACLE HEDULE FOR AMPACITY, NEMA CONFIGURATION, WIRE SIZE ANI DITIONAL RELATED INFORMATION FOR ASSOCIATED LETTER	D	\$osd DIMMING	TECHNOLOGY WITH LOAD	H DIMMING ~ COORDINATE TO BE DIMMED	€H MAG	GNETIC DOOR HOLD OPEN DEVICE, WIRED TO FACP
GFCI	GROUND FAULT CIRCUIT INTERRUPTER GROUND FAULT PROTECTION	RMC RTU	RIGID METAL CONDUIT ROOFTOP UNIT	☑ ₁ DIS	SCONNECT SWITCH	_	ERHEAD SPECIAL RECEPTACLE DROP ~ REFER TO SPECIAL		©S OCCUPA	NCY SENSOR, CEILING MO	UNTED		RINKLER SYSTEM WATER FLOW SWITCH, PROVIDED UNDER ISION 23, WIRED TO FACP UNDER DIVISION 26
HID	HIGH INTENSITY DISCHARGE	REF	REFRIGERATOR	TTTTT CA	BLE TRAY	REC	CEPTACLE SCHEDULE FOR AMPACITY, NEMA CONFIGURATION, RE SIZE AND ADDITIONAL RELATED INFORMATION FOR		\$D DIMMER TO BE DI		MMING TECHNOLOGY WITH LOAD	⟨f⟩ SPR	RINKLER SYSTEM TAMPER SWITCH, PROVIDED UNDER DIVISION
HOA	HAND-OFF-AUTO SELECTOR SWITCH	SF	SUPPLY FAN	✓ MC	OTOR OR FAN		SOCIATED LETTER			TAGE LIGHT SWITCH, MON	IENTARY CONTACT	¥ 23, V	WIRED TO FACP UNDER DIVISION 26
HP	HORSEPOWER HEATING, VENTILATION AND COOLING	SPDT	SINGLE POLE, DOUBLE THROW		NCTION BOX, CEILING OR WALL MOUNTED. MAKE	<u>NO1</u>	TES:			T HARVESTING SENSOR, C			RINKLER SYSTEM CHECK VALVE PRESSURE SWITCH, FURNISHEI D INSTALLED UNDER DIVISION 23, WIRED TO FACP UNDER
HVAC	UNIT	SQ	SQUARE	CO	ORDINATE EXACT TERMINATION POINT IN FIELD THROUGH APPROVED SUBMITTALS.	1. PROVID	DE MATCHING CORD AND PLUG FOR SINGLE RECEPTACLES		NOTES:		Elento mooniie		IISION 26
IDS	INTRUSION DETECTION SYSTEM	TEL	TELEPHONE	T# TR	ANSFORMER ~ SEE TRANSFORMER SCHEDULE	2. MOUNT	EXTERIOR RECEPTACLES WITH CENTERLINE 24" AFG UNO			LIGHT SWITCHES WITH C	ENTERLINE 48" AFF, UNO I INDICATES SWITCH GROUP		RINKLER SYSTEM PRE-ACTION VALVE, FURNISHED AND TALLED UNDER DIVISION 21, WIRED TO FACP UNDER DIVISION 2
IG	ISOLATED GROUND	TVSS	TRANSIENT VOLTAGE SURGE SUPPRESSOR		DICATES DEDICATED CIRCUIT OR HOMERUN BACK		RECEPTACLES WITH CENTERLINE 18" AFF UNO. (30") TES DEVICE MOUNTING HEIGHT WHEN NOT MOUNTED AT 18".		EMED	GENCY AND EXIT	LICHTING	⊵⊢ KNC	OX BOX, MOUNT 60" AFF
IMC	INTERMEDIATE METAL CONDUIT	TYP UF	TYPICAL UNDER FLOOR		RESPECTIVE PANEL ~ (2)#12+(1)#12G UNO. REFER EQUIPMENT SCHEDULES AND PANELBOARD	INDICA	TES DEVICE MOONTING HEIGHT WHEN NOT MOONTED AT 10.	00.		G INDICATES FIXTURE CON		SD SMC	OKE DAMPER, WIRED TO FACP
K	INFRARED KILO	UG	UNDERGROUND		HEDULES FOR ADDITIONAL INFORMATION.	<u>FL</u>	OOR AND CEILING DEVICES	H 1	BRANCH	PANEL. FIXTURES SHALL A UPON FIRE ALARM OR LOS	UTOMATICALLY SWITCH TO	FSD FIRE	E AND SMOKE DAMPER, WIRED TO FACP
B KCMIL	KILO CIRCULAR MILS	UH	UNIT HEATER		/IDED POWER POLE FOR SYSTEM FURNITURE DWER AND DATA WIRING	A OVE	ERHEAD RECEPTACLE DROP, DOUBLE DUPLEX			CATES EMERGENCY WHER		RTS REM	MOTE TEST/INDICATOR FOR DUCT SMOKES, MOUNT ON CEILING
KW	KILOWATT	UL	UNDERWRITER'S LABORATORY	P- MC	OTORIZED DOOR OPERATOR AND PUSH PADDLE ~	CR=	= CORD REEL		UNCLEAR				NEATH UNIT, OR WALL MOUNT WHERE INDICATED ON PLANS. NUAL PULL STATION, MOUNT 48" AFF
KVA	KILO VOLT-AMPS	UNO	UNLESS NOTED OTHERWISE UNINTERRUPTIBLE POWER SUPPLY		RNISHED BY DIVISION 08, WIRED BY DIVISION 26	RE	ECEPTACLES		EXIT SIG	N, CEILING MOUNTED, SHA	DING INDICATES FACE(S)	_	RN/STROBE, WALL MOUNTED CANDELA AS NOTED ON PLANS,
LAN LC	LOCAL AREA NETWORK LIGHTING CONTACTOR	UPS V	VOLTS		CLOSED CIRCUIT BREAKER		PLEX RECEPTACLE ~ 20A, 125V, 2P, 3W, NEMA 5-20R		TO UNSV	EAD INDICATES CHEVRON ITCHED PORTION OF AREA		WIR	RNISTROBE, WALL MOUNTED CANDELA AS NOTED ON PLANS, RED TO FACP. MOUNT 80" AFF TO BOTTOM, OR 6" BELOW ILING, WHICH EVER IS LOWER.
LF	LINEAR FEET	VFD	VARIABLE FREQUENCY DRIVE		TOMATIC TRANSFER SWITCH	ф рог	UBLE DUPLEX RECEPTACLE			CIRCUIT, U.N.O. N. WALL MOUNTED. SHADIN	NG INDICATES FACE(S) MOUNT		RN/STROBE, CEILING MOUNTED, CANDELA AS NOTED ON PLANS
LC	LOADCENTER	W	WATT	MC	STEMS FURNITURE FEED WITH WHIPS, WALL OUNT OR MOUNTED AT POWER POLE WHERE OUGATED - DROVIDE SINCLE CANC UNICTION BOX	∯ gF0	CI DUPLEX RECEPTACLE, MOUNT 44" AFF UNO	H⊠	AT 7'-6"A	F OR OVER DOOR, CONNE LIFE SAFETY LIGHTING BR	CT TO UNSWITCHED PORTION	WIR	RED TO FACP, MOUNT 80" AFF TO BOTTOM, OR 6" BELOW ILING, WHICH EVER IS LOWER
LCP	LIGHTING CONTROL PANEL LIGHT EMITTING DIODE	WP WG	WEATHERPROOF WIREGUARD	18"	DICATED ~ PROVIDE SINGLE GANG JUNCTION BOX ' AFF FOR POWER; PROVIDE DOUBLE GANG NCTION BOX 18" AFF WITH EMPTY 1"CONDUIT WITH	eth.	CI DOUBLE DUPLEX RECEPTACLE, MOUNT 44" AFF UNO	4	_		NIT WITH INTEGRAL HEADS		ROBE ONLY INDICATING APPLIANCE, CEILING MOUNTED, CANDEI
LTG	LIGHTING	XFMR	TRANSFORMER	PU	NCTION BOX 18" AFF WITH EMPTY 1"CONDUIT WITH ILLSTRING FOR VOICE/DATA CABLING UP TO 6" OVE NEAREST ACCESSIBLE CEILING		CI RECEPTACLE WITH WEATHERPROOF COVER		_				NOTED ON PLANS, WIRED TO FACP
LTS	LIGHTS				IPLE SWITCH FOR MANUAL TRANSFER FROM	# 0.0	CI RECEPTACLE IN WP ENCLOSURE ON ROOF	2	A_D EMERGE	NCY LIGHTING REMOTE HE	ADS		ROBE ONLY INDICATING APPLIANCE, WALL MOUNTED, CANDELA NOTED ON PLANS, WIRED TO FACP, MOUNT 80" AFF TO BOTTOM
MAX	MAXIMUM	(E)	EXISTING ITEM TO REMAIN	PE	IPLE SWITCH FOR MANUAL TRANSFER FROM RMANENT GENERATOR TO TEMPORARY ROLL-UP NERATOR WITH CONNECTION (CAM-LOK)		CHNOLOGY DEVICES ~ REFER TO TECHNOLOGY SCHEDULE			AL FOR ALL FIXTU		OR 6	6" BELOW CEILING, WHICH EVER IS LOWER.
MCB	MAIN CIRCUIT BREAKER	(R)	REMOVE ITEM AND DISPOSE OF PROPERLY		OVISIONS FOR ROLL-UP UNIT (ESL OR EQUAL)		STINGLOGT DEVIGES THE ENTO TECHNOLOGT SCHEDOLE			ES LUMINAIRE TYPE ON SO		DШ—Ш— HOF AFF	RN/STROBE WITH PULL STATION DIRECTLY BELOW, MOUNT 80" TO BOTTOM, OR 6" BELOW CEILING, WHICH EVER IS LOWER.
A MECH	MECHANICAL	(ER)	RELOCATED ITEM AT NEW LOCATION		GRADE PULL HOLE, REFER TO PLANS FOR QUIRED SIZE	NOTES:			1 a - LOWER	CASE LETTER INDICATES S	SWITCHING	DØ⊢ SPE	EAKER/STROBE, WALL MOUNTED CANDELA AS NOTED ON PLANS
MH	MOUNTING HEIGHT	(RL)	REMOVE AND RELOCATE		OTOR RATED SWITCH WITH THERMAL OVERLOAD		CEPTACLES WITH CENTERLINE AT 18" AFF UNO	R1 W 2 O a 2 (RED TO FACP
					OTECTION	2. MOUNTEXT	FERIOR RECEPTACLES WITH CENTERLINE 24" AFG UNO	C1	<u> </u>			DØ SPE PLA	EAKER/STROBE, CEILING MOUNTED, CANDELA AS NOTED ON ANS, WIRED TO FACP
	4 TARRESVIATIONS			40	DOWED DISTRIBUTION	٨٢	RECEPTACLES	2 	LUGUTIN				Teide al adau egend
A	1 ABBREVIATIONS			A3	POWER DISTRIBUTION	A5	RECEPTACLES	A6	LIGHTIN	G		A8	FIRE ALARM LEGEND
Scale:			Designed by:									<u></u> '	<u> </u>
ocale:			Designed by:								WEST G	ARDINEF	R & NEW GLOUCESTER
40" = 41	ח"					NT	MAINE TL						INNEL REPAIRS
12" = 1'-		1. ,					TURNPIKE	IE GOI	_レ 5	AH			
No.	Revision	Ву						10RIAL	HICH	$JW\DeltaY$	ELEC	I RICAL L	LEGEND AND NOTES
		+ +	100% PS&E REVIEW SUBMIS - NOT FOR CONSTRUCTION		, ,		/eranda Street and, Maine 04103		- 1 11/41	177/			
			By Date	-	By Date Allied Engin	P: 20	7.221.2260						
				25 Checked:	BTG 10/03/2025								SHEET NUMBER: E-01

MTA PROJECT MANAGER: KRISTI VAN OOYEN, P.E.

Designed: Drawn:

PMC 10/03/2025 Checked: PMC 10/03/2025

AEI PRO.NO.: 2461-66453 CAD FILE: 2461-66453.RVT

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PROJECT NOTES

- THE SCOPE OF WORK SHALL INCLUDE PROVIDING ALL WORK INDICATED UNLESS OTHERWISE THE SCOPE OF WORK STALL INCLUDE PROVIDING ALL WORK INJURATED WILESSO THERWISE SPECIFICALLY INDICATED AS EXISTING OR WORK BY OTHERS, AND COORDINATION WITH ALL TRADES SCOPE OF WORK AS INDICATED ON THE CONTRACT DOCUMENTS INCLUDING BOTH THE DRAWINGS AND THE SPECIFICATIONS, WHICH ARE COMPLIMENTARY, WORK REQUIREMENTS INDICATED IN ANY CONTRACT DOCUMENT SHALL BE CONSIDERED PART OF THE SCOPE OF WORK. UNLESS SPECIFICALLY INDICATED AS EXISTING OR WORK BY OTHERS.
- IN GENERAL WORK REQUIREMENTS ARE NOT INDICATED IN BOTH DOCUMENTS. WHERE DOCUMENTS CONFLICT WITHIN THEMSELVES OR WITH CODES AND REGULATIONS. PROVIDE
- WORK AT A MINIMUM SHALL BE IN ACCORDANCE WITH OSHA, NFPA STANDARDS, THE ELECTRICAL CODE AND THE LOCAL GOVERNING AUTHORITIES. THE DRAWINGS AND SPECIFICATIONS DO NOT ATTEMPT TO INDICATE ALL WORK REQUIRED BY CODE AND AUTHORITIES, DO NOT INSTALL WORK THAT DOES NOT MEET THE MINIMUM REQUIREMENTS, IF NECESSARY, REQUEST CLARIFICATION FROM ARCHITECT AND ENGINEER BEFORE
- ALL EQUIPMENT SHALL BE INSTALLED IN A NEAT AND PROFESSIONAL MANNER. RECTILINEAR TO BUILDING STRUCTURE.
- ALL COMPONENTS SHOWN ON THE RISER DIAGRAMS OR DETAILS, BUT NOT ON THE PLAN OR VICE VERSA SHALL BE INCLUDED AS IF SHOWN ON BOTH
- 5. IT IS THE INTENT OF THESE PLANS AND SPECIFICATIONS TO PROVIDE A WORKING INSTALLATION IN EVERY DETAIL AND ALL ITEMS REQUIRED FOR SUCH AN INSTALLATION SHALL BE PROVIDED WHETHER OR NOT SPECIFICALLY INDICATED OR MENTIONED
- VISIT THE SITE TO DETERMINE PRE-EXISTING CONDITIONS AND WORK NECESSARY PRIOR TO SUBMISSION OF BID PRICE. SUBMIT ANY QUESTIONS REQUIRED TO CLARIFY SCOPE PRIOR TO BID. INCLUDE ALL REQUIRED WORK IN BID PRICE.
- INCLUDE IN BID WHATEVER IS REQUIRED TO MEET SCHEDULE INCLUDING OVERTIME, EXPRESS SHIPPING, EXPEDITING EQUIPMENT, ETC. PLAN FOR PROJECT AND SUBMIT SHOP DRAWING AND ORDER EQUIPMENT IN A TIMELY MANNER; EQUIPMENT SHALL BE BASED ON THE SPECIFIED
- ANY EQUIPMENT TO BE SUBSTITUTED SHALL BE IDENTIFIED AT THE TIME OF BID. REFER TO SPECIFICATIONS FOR ADDITIONAL REQUIREMENTS FOR SUBSTITUTIONS.
- 10. ALL ELECTRICAL DEVICES, WHEN INSTALLED, SHALL BE PROTECTED FROM DAMAGE DURING CONSTRUCTION. COVER PLATES SHALL BE INSTALLED AFTER FINISH MATERIALS HAVE BEEN
- 11. TEST ALL EQUIPMENT AND SYSTEMS INSTALLED TO CERTIFY COMPLIANCE WITH DRAWINGS SPECIFICATIONS, CODES, LOCAL AUTHORITIES AND REGULATIONS, INCLUDE LABOR AND COSTS FOR TESTING, REVIEWS, COMMISSIONING, APPROVALS AND CERTIFICATIONS.
- 12. PROVIDE TRAINING TO OWNER ON ALL EQUIPMENT AND SYSTEMS INSTALLED.
- 13. TEMPORARY LIGHTING AND POWER SHALL BE PROVIDED AS REQUIRED BY OSHA, CODES AND LOCAL AUTHORITIES. REMOVE ALL TEMPORARY FACILITIES PROVIDED AT PROJECT

INSTALLATION COORDINATION NOTES

- 1. PRIOR TO ROUGH-IN OF ELECTRICAL PROVISIONS FOR OWNER FURNISHED EQUIPMENT AND EQUIPMENT PROVIDED BY OTHER TRADES, COORDINATE WITH THE GENERAL CONTRACTOR, EQUIPMENT SHOP DRAWINGS AND APPLICABLE EQUIPMENT INSTALLER FOR EXACT LOCATION AND WIRING REQUIREMENTS. PROVIDE ALL NECESSARY EQUIPMENT, WIRING AND ACCESSORIES FOR A COMPLETE INSTALLATION. MAKE ALL FINAL CONNECTIONS AS REQUIRED, I.E. POWER, CONTROL, INTERLOCK, ETC.
- 2. DISCONNECT, REMOVE, RELOCATE, AND RECONNECT ELECTRICAL CONDUIT, WIRING, DEVICES, BOXES. FIXTURES FOURMENT FTC AS INDICATED AND AS REQUIRED TO FACILITATE THE WORK OF DIVISION 26 AND OTHER DIVISIONS. THESE DRAWINGS ARE NOT INTENDED TO INDICATE ALL ITEMS TO BE REMOVED.
- FURNITURE SHALL BE COORDINATED WITH THE EQUIPMENT AND FURNITURE INSTALLERS AND THE GENERAL CONTRACTOR PRIOR TO ROUGH-IN. EXCEPT WHERE INDICATED OR REQUIRED OTHERWISE
- 4 THE LOCATION OF EQUIPMENT OUTLETS ETC. AS GIVEN ON THE DRAWINGS IS APPROXIMATE IT SHALL BE UNDERSTOOD THAT THESE LOCATIONS ARE SUBJECT TO MODIFICATION AS MAY BE FOUND NECESSARY OR DESIRABLE AT THE TIME OF INSTALLATION IN ORDER TO MEET PROJECT REQUIREMENTS. SUCH CHANGES
- 5. IF EXACT LOCATION, MOUNTING OR RACEWAY ROUTING ARE NOT INDICATED OR ARE NOT CLEAR OR CONFLICT (LOCATION OR HEIGHT) COORDINATE WITH OTHER TRADES AND REQUEST CLARIFICATION PRIOR TO ROUGH-IN OR INSTALLATION. DRAWINGS ARE DIAGRAMMATIC ONLY. EXACT LOCATION, MOUNTING HEIGHTS OR EQUIPMENT AND ROUTING OF RACEWAYS SHALL BE COORDINATED WITH THE EQUIPMENT
- 6. WHERE LOADS ARE ADDED TO EXISTING BRANCH CIRCUITS, VERIFY THAT THE EXISTING CIRCUITS HAVE ADEQUATE CAPACITY TO SUPPORT THE ADDITIONAL LOAD WITHOUT EXCEEDING SPECIFIED MAXIMUM LOAD.
- UNLESS OTHERWISE DIRECTED, PROVIDE ALL NEW POWER DISTRIBUTION EQUIPMENT WITH AIC RATINGS THAT MATCH OR EXCEED THE AIC RATING OF THE NEXT ACTIVE EXISTING UPSTREAM OVER-CURRENT PROTECTIVE DEVICE SERVING THE PANEL WHEN SERVED DIRECTLY BY ITS SOURCE (E.G. NO TRANSFORMER) OR PROVIDE AIC RATING THAT EXCEEDS BY 10% THE MAXIMUM LET THROUGH FAULT CURRENT (UNDER INFINITE PRIMARY BUSS) OF THE NEXT ACTIVE UPSTREAM TRANSFORMER (EXISTING OR NEW) SERVING THE RESPECTIVE PANEL.
- 8. ALL NEW PANELS SHALL BE FULLY RATED FOR THE DESIGNATED AIC VALUE; PANELS UTILIZING SERIES RATINGS WILL NOT BE ACCEPTABLE. NEW CIRCUIT BREAKERS PROVIDED IN EXISTING PANELS SHALL BE PROVIDED WITH AIC RATINGS THAT MATCH OR EXCEED THE HIGHEST RATED OVER-CURRENT PROTECTIVE DEVICE WITHIN THE RESPECTIVE EXISTING PANEL
- 9. SUBMIT SHORT CIRCUIT STUDY WITH POWER DISTRIBUTION EQUIPMENT SUBMITTALS FOR REVIEW AND APPROVAL. IN THE STUDY DEMONSTRATE THAT THE AIC RATING SELECTIONS ARE PROPERLY INTEGRATED AND COORDINATED WITH THE EXISTING AND NEW POWER DISTRIBUTION EQUIPMENT, CONFIRM THAT THE AIC RATING SELECTIONS HAVE INCORPORATED THE AVAILABLE FAULT DUTY VALUES OBTAINED FROM THE UTILITY COMPANY FOR THE PROJECTS ELECTRICAL SERVICE POINT OF COMMON COUPLING.
- 10. SUBMIT OVER-CURRENT PROTECTIVE DEVICE COORDINATION STUDY, FOR ALL NEW POWER DISTRIBUTION EQUIPMENT, WITH THE POWER DISTRIBUTION EQUIPMENT SUBMITTALS FOR REVIEW AND APPROVAL. INCLUDE THE NEXT ACTIVE EXISTING UPSTREAM OVER-CURRENT PROTECTIVE DEVICES, IN THE STUDY ANALYSIS, WHEN PROJECT IS WITHIN AN EXISTING FACILITY.

3#10 & 1#10 GND - 3/4" C

3#8 & 1#10 GND - 3/4" C

3#6 & 1#10 GND - 3/4" C

3#6 & 1#10 GND - 3/4" C.

11. SUBMIT ARC FLASH REPORT, FOR ALL NEW POWER DISTRIBUTION EQUIPMENT, WITH POWER DISTRIBUTION FOLIPMENT SUBMITTALS FOR REVIEW AND APPROVAL

WIRING NOTES

- 1. UNLESS OTHERWISE INDICATED ON PLANS OR IN SPECIFICATIONS; ALL CONDUCTORS FABRICATED OF 98% CONDUCTIVE COPPER MATERIAL
- 2. WIRING IS INDICATED ON DRAWINGS ONLY FOR SPECIFIC ROUTES OR SPECIAL
- 3 BRANCH CIRCUIT WIRING NOT SHOWN, CIRCUITING SHALL IN ACCORDANCE WITH BRANCH CIRCUIT VIRKING NOT SHOWN. CIRCUITING SHALL IN ACCORDANCE WITH APPLICABLE CODES AND STANDARD PRACTICE. PROVIDE A 20A, 1P CIRCUIT BREAKER FOR EACH LIGHTING AND RECEPTACLE CIRCUIT UNLESS OTHERWISE INDICATED OR NOTED.

 CONNECT NO MORE THAN SIX DUPLEX CONVENIENCE RECEPTACLES PER BRANCH

 1970/1971 OF SUPERSTRANDARD OF THE PROVIDENCE CIRCUIT. CONNECTED LOAD ON LIGHTING CIRCUITS SHALL NOT EXCEED 12 AMPS.
- 4. ALL WIRING SHALL BE RUN CONCEALED UNLESS SPECIFIED OTHERWISE, ALL EXPOSED WIRING INCLUDING THAT WHICH IS INSTALLED ABOVE BUT IS VISIBLE FROM BELOW PARTIALLY OR FULLY OPEN CEILING, SHALL BE INSTALLED IN CONDUIT OR RACEWAYS.
 REFER TO SPECIFICATIONS FOR ACCEPTABLE WIRING METHODS.
- 5. WIRING AND CONDUIT SHALL BE REQUIRED FOR ALL SWITCHES, AND OUTLETS INDICATED WITH CIRCUIT NUMBERS. PROVIDE ¾ CONDUIT, 3#12 UNLESS OTHERWISE INDICATED (1 PHASE, 1 NEUTRAL AND 1 GROUND). WIRE AND CONDUIT SIZES ON HOME RUNS SHALL BE CONTINUOUS THROUGHOUT CIRCUIT, REFER TO VOLTAGE DROP CHART ON SCHEDULE SHEET ALTHOLIGH ALL BRANCH CIRCUIT WIRE AND CONDUIT IS NOT SHOWN IT IS THE INTENT OF THESE DOCUMENTS THAT A COMPLETE BRANCH CIRCUIT WIRING SYSTEM BE
- RACEWAYS SHALL BE LIMITED TO SIX CURRENT CARRYING CONDUCTORS (PHASE AND NEUTRALS) AND GROUNDING CONDUCTOR. PROVIDE A DEDICATED NEUTRAL CONDUCTOR FOR EACH SINGLE-PHASE RECEPTACLE OR LIGHTING CIRCUIT, UNLESS OTHERWISE INDICATED OR IF AN OVERSIZED NEUTRAL IS SPECIFIED, CIRCUITS WITH SHARED NEUTRALS SHALL BE PROVIDED WITH CIRCUIT BREAKERS THAT HAVE A COMMON
- . MARK ALL CONDUITS AND JUNCTION BOXES WITH PERMANENT MARKER INDICATING PANEL AND CIRCUIT NUMBER OF CONDUCTORS CONTAINED WITHIN. LABEL WHERE CONDUITS ENTER PANELS, WIRE WAYS, PULL BOXES, ETC. LABEL EMPTY CONDUITS WITH SYSTEM (VOICE, DATA, SECURITY, ETC.) AND SOURCE OF CONDUIT.
- 8. COORDINATE WITH OWNER TO DETERMINE WHICH RECEPTACLES AND ITEMS OF
- 9. ELECTRICAL WORK NOT SERVING STAIRWELLS SHALL NOT PASS THROUGH A STAIR ENCLOSURE UNLESS AN APPROVED RATED SOFFIT IS PROVIDED TO MAINTAIN FIRE AND
- 10. ALL RACEWAYS CROSSING EXPANSION JOINTS SHALL BE EQUIPPED WITH EXPANSION FITTINGS
- 11. PROVIDE WATERTIGHT AND GAS TIGHT SEALS INSIDE AND OUTSIDE OF CONDUITS THAT PENETRATE THE BUILDING BELOW GRADE. O.Z. GEDNEY OR APPROVED EQUAL. PROVIDE WEATHER TIGHT SEAL AT PENETRATIONS ABOVE GRADE.
- 12. PROVIDE NRTL LISTED SMOKE AND FIRE SEALS AT ALL PENETRATIONS THROUGH FLOORS OR FULL HEIGHT (FLOOR TO FLOOR) WALLS.

SYSTEM POWER WIRING NOTES

1. ALL VIDEO PROJECTOR, CAMERA AND MONITOR POWER OUTLETS AND THEIR ASSOCIATED COMPUTER POWER OUTLETS. FEEDING THE VIDEO SOURCE ARE TO BE CONNECTED TO THE SAME PHASE TO ELIMINATE THE POTENTIAL FOR VIDEO INTERFERENCE BETWEEN VIDEO SOURCE AND EQUIPMENT. COORDINATE ALL POWER WIRING FOR SYSTEM EQUIPMENT WITH THE SYSTEM INSTALLER PRIOR TO INSTALLATION

RECEPTACLE COLOR CODE NOTES

LINESS OTHERWISE INDICATED PROVIDE 20A HEAVY DUTY GRADE RECEPTACLES WITH COLOR CODE AS FOLLOWS:

- ON GENERATOR POWER RED ON UPS POWER BLUE
- ISOLATED GROUND ORANGE
 ON NORMAL POWER IVORY OR AS SELECTED BY ARCHITECT

- DO NOT SCALE THE DRAWINGS. REFER TO ARCHITECTURAL DRAWINGS AND EXISTING CONDITIONS FOR EXACT DIMENSIONS.
- 2. INSTALL ALL ELECTRICAL DEVICES (FIRE ALARM, SWITCHES, RECEPTACLES, WORK BOXES, JUNCTION BOXES, EXIT SIGNS, LUMINAIRES, ETC.) IN THE LOCATIONS IDENTIFIED OR DIMENSIONS ON THE ARCHITECTURAL PLANS, DETAILS, OR FLEVATIONS.
- 3. IF THE DEVICE LOCATION IS NOT SPECIFICALLY SHOWN ON ARCHITECTURAL DRAWINGS, FOLLOW THE GUIDELINES LISTED BELOW:
- 4. INSTALL NEARBY DEVICES ON ONE COMMON VERTICAL CENTERLINE
- 5. INSTALL ADJACENT TO DEVICES LINED UP WITH A COMMON BOTTOM LINE
- INSTALL DEVICES AT INDICATED HEIGHT AS APPLICABLE UNLESS OTHERWISE NOTED. ALL MOUNTING HEIGHTS SHALL BE MEASURED FROM FINISHED FLOOR TO CENTERLINE OF DEVICE EXCEPT AS INDICATED BY NOTE 7
- ON MASONRY WALLS LINE UP THE BOTTOM OF THE DEVICE WITH A MASONRY JOINT AS CLOSE TO THE INDICATED HEIGHT
- 8. INSTALL DEVICES IN SAME AREA AT THE SAME HEIGHT.
- 9. MOUNT PANELS SIX FEET TO THE TOP OF THE PANEL OR ANNUNCIATOR/ FA GRAPHIC
- 10. MOUNT AT 8 FOOT TO BOTTOM FOR SIGNAGE, EMERGENCY LIGHTING, CLOCKS, SECURITY SENSORS, WALL MOUNTED OCCUPANCY SENSORS MODIFIED AS FOLLOWS: 4" FROM TOP OF DEVICE TO CEILING AND 4" ABOVE DOOR FRAMES.
- 11. LOCATE CONTROL DEVISE AT LEAST 18' FROM AN INSIDE CORNER
- 12. SUPPORT WORK FROM THE BUILDING STRUCTURE
- 13. IN FINISHED AREAS ELECTRICAL WORK SHALL BE INSTALLED CONCEALED, RECESSED INTO WALLS OR INSTALLED ABOVE HUNG CEILINGS UNLESS OTHERWISE INDICATED.
- 14. DO NOT INSTALL OUTLETS BACK TO BACK, PROVIDE 24 SPACING IN FIRE RATED WALLS.
- 15. PROVIDE ELECTRICAL OLITLET PLATE GASKETS SEALS AT RECEPTACLES. SWITCHES AND OTHER ELECTRICAL BOXES ON EXTERIOR WALLS AND INTERIOR WALLS BETWEEN CONDITIONED AND NON-CONDITIONED SPACES.

C1 **ELECTRICAL GENERAL NOTES**

THREE PHASE AND SINGLE PHASE CIRCUIT SCHEDULE NOTES

- UNLESS OTHERWISE INDICATED, CONDUCTOR SIZING SHALL MATCH THE SIZE INDICATED FOR THE APPLICABLE OVERCURRENT DEVICE. PROVIDE LARGER CONDUCTORS AND RACEWAY WHERE INDICATED. PROVIDE TYPE AND MINIMUM SIZE OF RACEWAY OR CABLE AS INDICATED IN
- SPECIFICATION OR ON THE DRAWINGS. PROVIDE NEUTRAL IN CIRCUIT UNLESS DEVICE SERVED DOES NOT HAVE PROVISIONS FOR A NEUTRAL CONNECTION.
- MINIMUM SIZE CONDUIT FOR SCHEDULE 80 OR EMT IS ONE STANDARD ELECTRICAL SIZE LARGER THAN INDICATED IN THE SCHEDULE. PROVIDE LARGER CONDUIT WHERE SPECIFICALLY INDICATED OTHERWISE. DO NOT INSTALL PVC...
- PROVIDE SEPARATE, INSULATED EQUIPMENT GROUNDING CONDUCTOR WITH EACH FEEDER AND BRANCH CIRCUIT. PROVIDE ADDITIONAL ISOLATED GROUNDING CONDUCTOR SAME SIZE AS THE EQUIPMENT GROUND. IN CIRCUITS TO ISOLATED GROUND PANELS OR DEVICES,
- GREEN WITH YELLOW STRIPE. FOR PANELS WITH 200% NEUTRAL PROVIDE 200% NEUTRAL USING TWO PHASE SIZED CONDUCTORS IF SIZE 1/0 OR LARGER, OTHERWISE PROVIDE (1) 3/0.
- PROVIDE SEPARATE INDIVIDUAL NEUTRAL FOR ALL CIRCUITS EXCEPT LIGHTING CIRCUITS, PROVIDE A DEDICATED NEUTRAL FOR GECLAND AFCI CIRCUITS. CIRCUIT SIZING BASED ON 600 VOLT 90 DEGREE (C) RATED INSULATION. INTERIOR

TYPE THHN/THWN OR XHHW-2 (LARGER THAN SIZE #6), FOR EXTERIOR OR BELOW

GRADE LITILIZE RHW-2/USE-2 IN CONDUIT ONE SIZE LARGER SIZING BASED ON 60 DEGREE (C) FOR AMPACITIES 100A OR LESS AND 75 DEGREE (C) AMPACITIES...

- FOR SERVICE ENTRANCE CONDUCTORS IT IS NOT REQUIRED TO INSTALL THE GROUNDING CONDUCTOR THE NEUTRAL CONDUCTOR IS FULL SIZED AND IS BONDED TO THE GROUNDING ELECTRODE CONDUCTOR AT THE TRANSFORMER AND THE SERVICE DISCONNECT.
- FOR BATTERY CABLES, INSTALL AND GROUP IN PAIRS (ONE POSITIVE AND ONE NEGATIVE CONDUCTOR). MARK POSITIVE CONDUCTOR WITH (5) OVERLAPPING WRAPS OF RED ELECTRICAL TAPE ON EACH END.

BRANCH CIRCUITS SCHEDULE 120 OR 277 VOLT, 1 PH., 2W CIRCUITS 15A-1P 20A-1P 2#12 & 1#12 GND - 3/4" C

30A-1P	2#10 & 1#10 GND - 3/4" C.
40A-1P	2#8 & 1#10 GND - 3/4" C.
50A-1P	2#6 & 1#10 GND - 3/4" C.
60A-1P	2#6 & 1#10 GND - 3/4" C.
208 OR 480 VOLT,	1PH., 2W CIRCUITS
15A-2P, 20A-2P	2#12 & 1#12 GND - 3/4" C.
30A-2P	2#10 & 1#10 GND - 3/4" C.
40A-2P	2#8 & 1#10 GND - 3/4" C.
50A-2P	2#6 & 1#10 GND - 3/4" C.
60A-2P	2#6 & 1#10 GND - 3/4" C.
208 OR 480 VOLT,	3PH., 3W CIRCUITS
15A_3D_20A_3D	3#12 & 1#12 GND - 3/4" C

60A-3F BRANCH CIRCUIT SCHEDULE NOTES

30A-3P

40A-3P

50A-3P

- . TYPE MC CABLE SHALL INCLUDE FULL SIZE INSULATED GROUND CONDUCTOR, SIZES AS INDICATED IN SCHEDULE.
- 2. WIRING BASED ON MAXIMUM FEEDER LENGTH OF 150 FEET FOR 120 VOLT CIRCUITS AND 300 FEET FOR 277 VOLT CIRCUITS.
- 3. UPGRADE WIRE AND CONDUIT SIZE AS REQUIRED TO ADDRESS VOLTAGE DROP.

V	OLIAGED	VOLTAGE DIXOF CHART									
MAXIMUM LOAD	MAXIMUM LE	NGTH PER COND	OUCTOR SIZE								
(VA)	#12	#10	#8								
	120 VOLT	CIRCUITS									
800	155	245	390								
1000	125	195	310								
1200	105	165	260								
1400	90	140	220								
1600	80	125	195								
1800	70	110	175								
	277 VOLT	CIRCUITS									
2000	330	525	830								
2500	265	420	665								
3000	220	350	555								
3500	190	300	475								
4000	165	260	415								

VOLTAGE DROP CHART

Designed by Scale 12" = 1'-0' By Date No. Revision

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Allied Engineering Portland, Maine 0410.




THE GOLD STAR MEMORIAL HIGHWAY WEST GARDINER & NEW GLOUCESTER **TOLL TUNNEL REPAIRS** GENERAL NOTES AND SCHEDULES


SHEET NUMBER: E-02

CONTRACT: 2025.15

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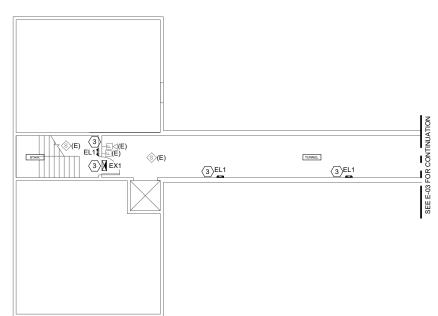
MTA PROJECT MANAGER: KRISTI VAN OOYEN, P.E.



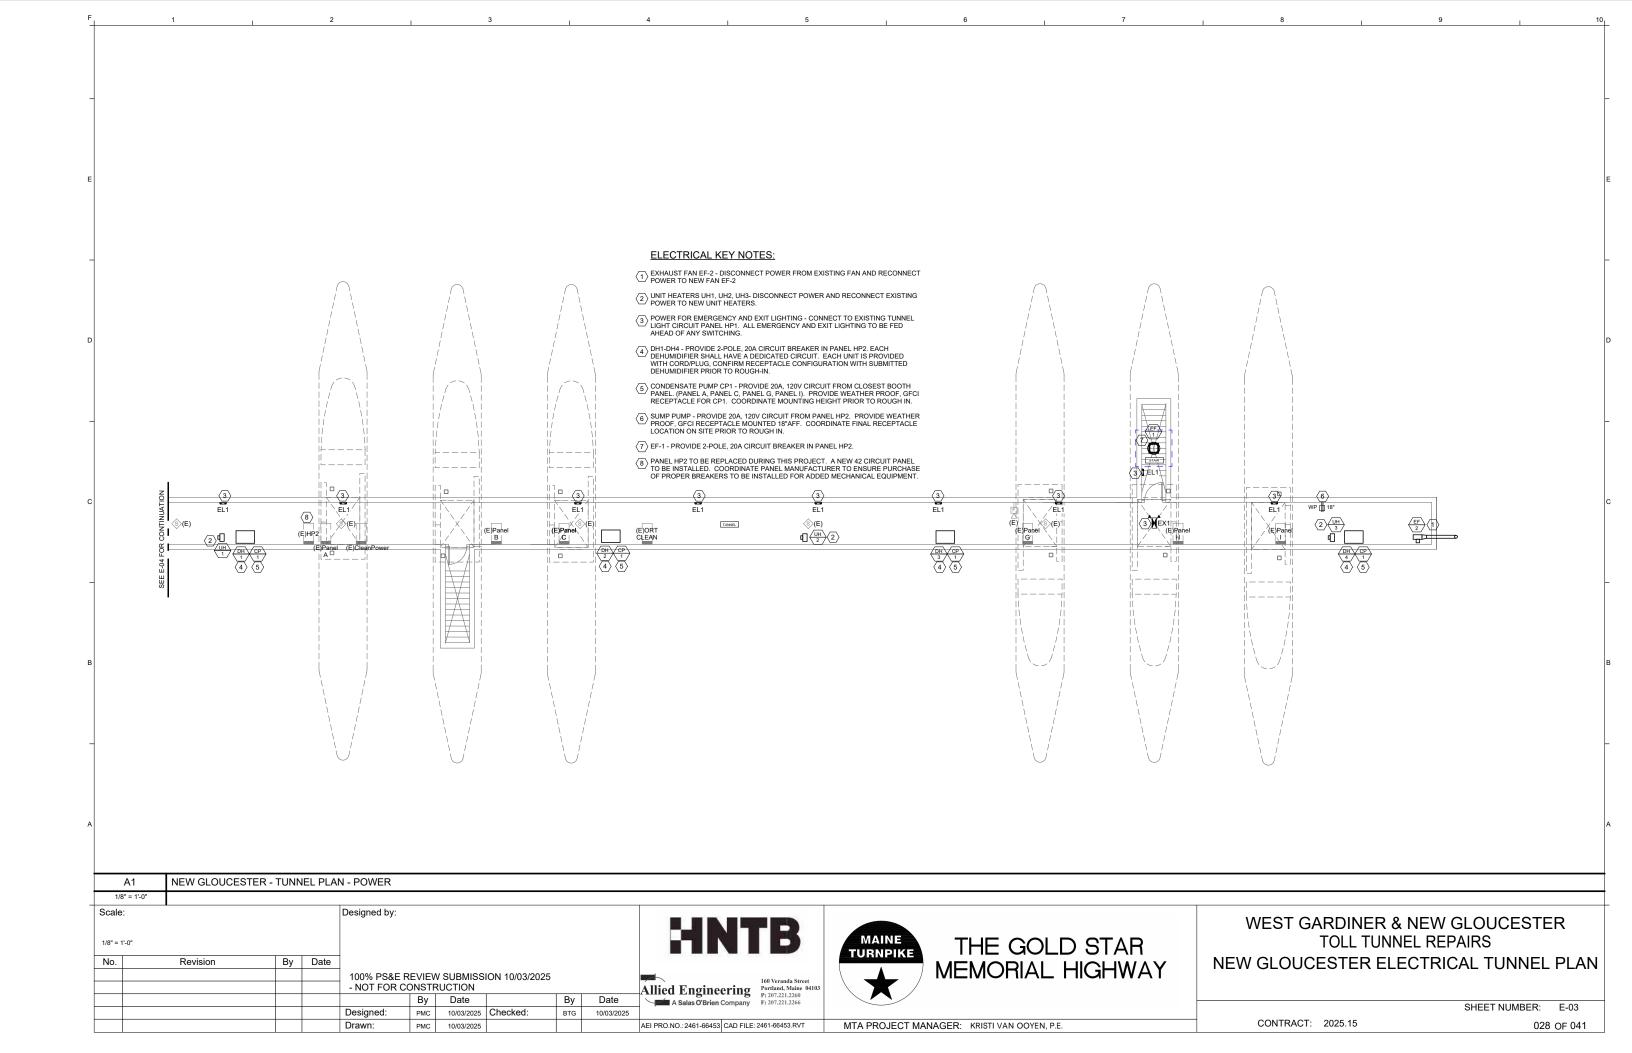

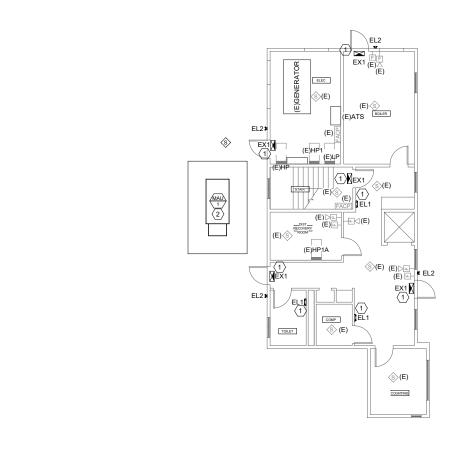ELECTRICAL KEY NOTES:

- 1) POWER FOR EMERGENCY AND EXIT LIGHTING CONNECT TO EXISTING BUILDING LIGHT CIRCUIT PANEL HP1. ALL EMERGENCY AND EXIT LIGHTING TO BE FED AHEAD OF ANY SWITCHING.
- (2) PROVIDE NEW CIRCUIT BREAKER IN PANEL HP FOR POWERING MAU1. CIRCUIT BREAKER TO MATCH ACC RATING OF EXISTING PANEL.
- (3) POWER FOR EMERGENCY AND EXIT LIGHTING CONNECT TO EXISTING TUNNEL LIGHT CIRCUIT PANEL HP1. ALL EMERGENCY AND EXIT LIGHTING TO BE FED AHEAD OF ANY SWITCHING.



Date

10/03/2025

BTG

A1	NEW GLOUCESTER - UPPER & LO	WER BUILDING PLANS - POWER			
1/8" = 1'-0"					
Scale:		Designed by:	HATE	MAINE	WEST GARDINER & NEW GLOUCESTE
1/8" = 1'-0"				IMIATINI	TOLL TUNNEL REPAIRS

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10/03/2025 Checked:

10/03/2025

By Date

No.

Revision

Allied Engineering

A Salas O'Brien Company

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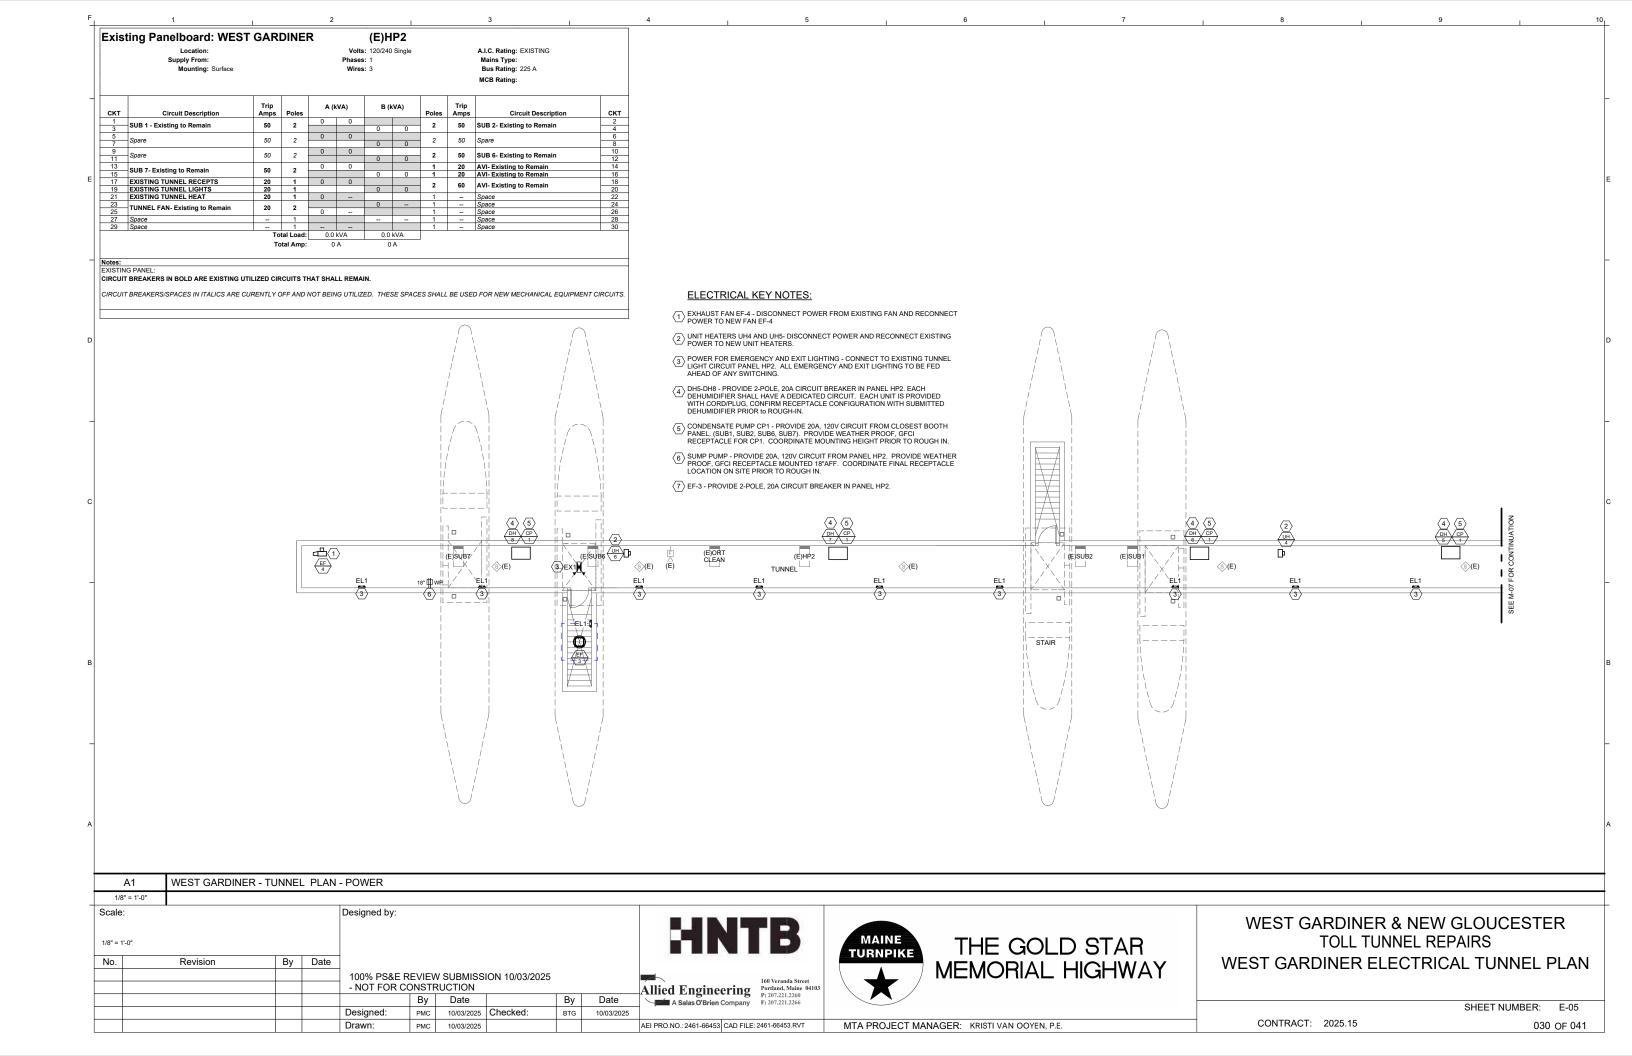
THE GOLD STAR
MEMORIAL HIGHWAY


WEST GARDINER & NEW GLOUCESTER
TOLL TUNNEL REPAIRS
NEW GLOUCESTER ELECTRICAL BUILDING PLAN


SHEET NUMBER: E-04

MTA PROJECT MANAGER: KRISTI VAN OOYEN, P.E.

CONTRACT: 2025.15 029 OF 041



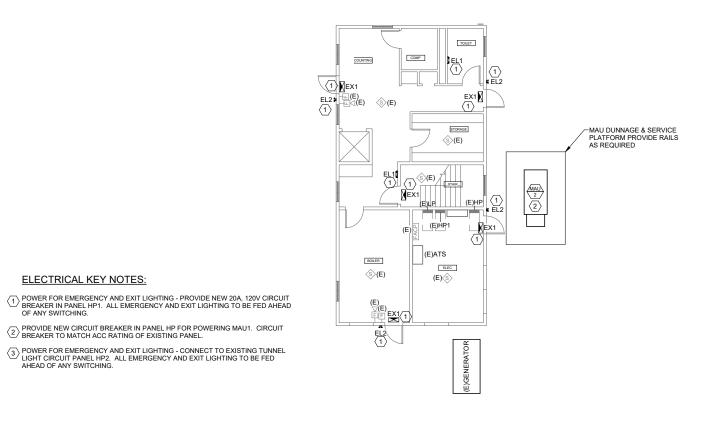

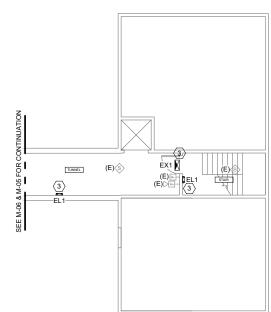

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ELECTRICAL KEY NOTES:

Designed:

Drawn:

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A1	WEST GARD	INER - UPPER	& LOWE	ER BUILDING P	PLANS - PO\	VER							
1/8" = 1'-0"													
Scale: 1/8" = 1'-0"				Designed by:						HNTB	MAINE TURNPIKE	THE GOLD STAR	WEST GARDINER & NEW GLOUCESTER TOLL TUNNEL REPAIRS
No.	Revision	Ву	Date	100% PS&E F	ONSTRUCT	ON	ON 10/03/2025		Date	Allied Engineering 160 Veranda Street Portland, Maine 0410. P. 207.221.2260		MEMORIAL HIGHWAY	WEST GARDINER ELECTRICAL BUILDING PLAN
			-	Designed:			Checked:	By	Date	A Salas O'Brien Company F: 207.221.2266			SHEET NUMBER: E-06

MTA PROJECT MANAGER: KRISTI VAN OOYEN, P.E.

CONTRACT: 2025.15

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		ELECTRICAL SCH	EDULE	OF N	/IECHAN	IICAL E	QUIPM	ENT- I	REFER T	O P	ANEL	SCH	EDUL	ES FC	R CIF	RCUIT	ING					
	TAG	DESCRIPTION/ AREA SERVED	VOLTS	PH	LOAD	FLA	MCA	MOPD			NECT S		FBD	STARTEI SIZE/	R (NEMA) FBD	CBD	WIRING IN CONDUIT (2 #12, 1#12 G UNO)	NOTES				
	MUA-1	MAKE-UP AIR UNIT - NEW GLOUCESTER	240	1		11.30	11.30	15		FW					/E		23		22	22	3 #12, 1 #12G	$\overline{}$
	MUA-2	MAKE-UP AIR UNIT - GARDINER	240	1		11.30	11.30	15		FW	E		23		22	22	3 #12, 1 #12G					
7	DH-1	DEHUMIDIFIER - NEW GLOUCESTER	240	1		11.10		20			ND PLUG		26		23	23	3 #12, 1 #12G	1				
	DH-2	DEHUMIDIFIER - NEW GLOUCESTER	240	1		11.10		20			D PLUG		26		23	23	3 #12, 1 #12G	1				
	DH-3	DEHUMIDIFIER - NEW GLOUCESTER	240	1		11.10		20			D PLUG		26		23	23	3 #12, 1 #12G	1				
	DH-4	DEHUMIDIFIER - NEW GLOUCESTER	240	1		11.10		20		CORD AND PLUG		26		23	23	3 #12, 1 #12G	1					
	DH-5	DEHUMIDIFIER - GARDINER	240	1		11.10		20			D PLUG		26		23	23	3 #12, 1 #12G	1				
	DH-6	DEHUMIDIFIER - GARDINER	240	1		11.10		20			D PLUG		26		23	23	3 #12, 1 #12G	1				
	DH-7	DEHUMIDIFIER - GARDINER	240	1		11.10		20			D PLUG		26		23	23	3 #12, 1 #12G	1				
	DH-8	DEHUMIDIFIER - GARDINER	240	1		11.10		20	COF		D PLUG		26		23	23	3 #12, 1 #12G	1				
Εĺ	UH-1	UNIT HEATER - NEW GLOUCESTER	120	1	1/20 HP	1.00		20		FW			23		23	23						
-	UH-2	UNIT HEATER - NEW GLOUCESTER	120	1	1/20 HP	1.00		20		FW			23		23	23						
	UH-3	UNIT HEATER - NEW GLOUCESTER	120	1	1/20 HP	1.00		20		FW			23		23	23						
	UH-4	UNIT HEATER - GARDINER	120	1	1/20 HP	1.00		20		FW			23		23	23						
	UH-5	UNIT HEATER - GARDINER	120	1	1/20 HP	1.00		20		FW			23		23	23						
	EF-1	EXHAUST FAN - NEW GLOUCESTER	240	1	1/2 HP	4.90		20		MRT		26		23	23	3 #12, 1 #12G						
	EF-2	EXHAUST FAN - NEW GLOUCESTER	240	1	1 HP	8.00		20		MRT		26		23	23	3 #12, 1 #12G						
	EF-3	EXHAUST FAN - GARDINER	240	1	1/2 HP	4.90		20		MR	T		26		23	23	3 #12, 1 #12G	1 1				
	EF-4	EXHAUST FAN - GARDINER	240	1	1 HP	8.00		20		MR	T		26		23	23	3 #12, 1 #12G					
+	CP-1	CONDENSATE PUMP AT DEHUMIDIFIER	120	1	1/50 HP	1.00		20	COF	D AN	D PLUG		26		23	23		2				
																		\perp				
		NOTES:														ABBR	EVIATIONS:					
	1	UNIT PROVIDED WITH POWER CORD. CO	NFIRM PL	.UG TYPE	WITH MECH	HANICAL CO	ONTRACTO	R FOR EX	ACT RECEPTA	CLE	TYPE RE	QUIRED.			FWE	FURNIS	HED WITH EQUIPMEN	г				
	2	UNIT PROVIDED WITH P5-20 PLUG AND COMITH MECHANICAL CONTRACTOR.	ORD. PRO	OVIDE 5-1	5 GFCI REC	EPTACLE W	/ITHIN 3' OF	PUMP LO	OCATION. CO	ORDI	NATE LO	CATION			NF	NOT FU	SED					
Ы															SWBD	SWITCH	HBOARD					
															FBD	FURNIS	HED BY DIVISION					
																	OL WIRING BY DIVISIO	N				
																(VOLTA	RATED TOGGLE SWIT GE, CURRENT RATING UANTITY AS REQUIRE	AND				

			CATALOG SERIES NUMBER -			l	AMP/LIGHT E	NGINE	KEY
TYPE	DESCRIPTION	MFR	SEE KEY NOTE 1	MOUNTING	VOLTS	WATTS	DELIVERED LUMENS	TYPE	NOTES
EX1	EXIT SIGN W/ EMER HEADS	SURELITES	APCH7R	MOUNT 7'-6" AFF	120VAC/ 12VDC	2.8W		LED	3
EL1	EMERGENCY BATTERY LIGHT	SURELITES	APELH2	WALL 7'-6" AFF	120VAC/ 12VDC	0.6W		LED	
EL2	EMERGENCY REMOTE HEADS - EXTERIOR WET LOCATION RATED	SURELITES	APWR-2	WALL 9'-0" AFF	120VAC/ 12VDC	.78W		LED	
	KEY NOTES	1							
1	NOTE THAT THESE NUMBERS ARE NOT COMBINED.	COMPLETE CATA	LOG NUMBERS. PROVIDE ALL R	EQUIREMENTS ON	SCHEDUI	LE, NOTE	S, SPECS, AN	D DRAWINGS	
2	VERIFY CEILING STRUCTURE AND MOU	NTING HEIGHT PR	IOR TO ORDERING ANY LIGHT F	IXTURES.					
3	PROVIDE WALL, CEILING, OR PENDANT	MOUNTING AS IND	ICATED ON PLANS. PROVIDE NU	IMBER OF FACES A	ND ARRO	WS AS IN	IDICATED.		
4	PROVIDE SATINICE DIFFUSED LENS								
5	PROVIDE RIGID STEMS FOR PENDANT I	MOUNTED FIXTURE	Ξ.						
6	PROVIDE INTEGRAL PHOTOCELL AND N	IOTION SENSOR T	HAT WILL BE AUTO ON/AUTO OF	E VIA MOTION SENS	SOR ONLY	/ AFTER	DUSK		

| Designed by: | | Designed by: | | Designed by: | | Designed by: | Designed by:





WEST GARDINER & NEW GLOUCESTER TOLL TUNNEL REPAIRS ELECTRICAL SCHEDULES


SHEET NUMBER: E-07


MTA PROJECT MANAGER: KRISTI VAN OOYEN, P.E.


CONTRACT: 2025.15 032 OF 041

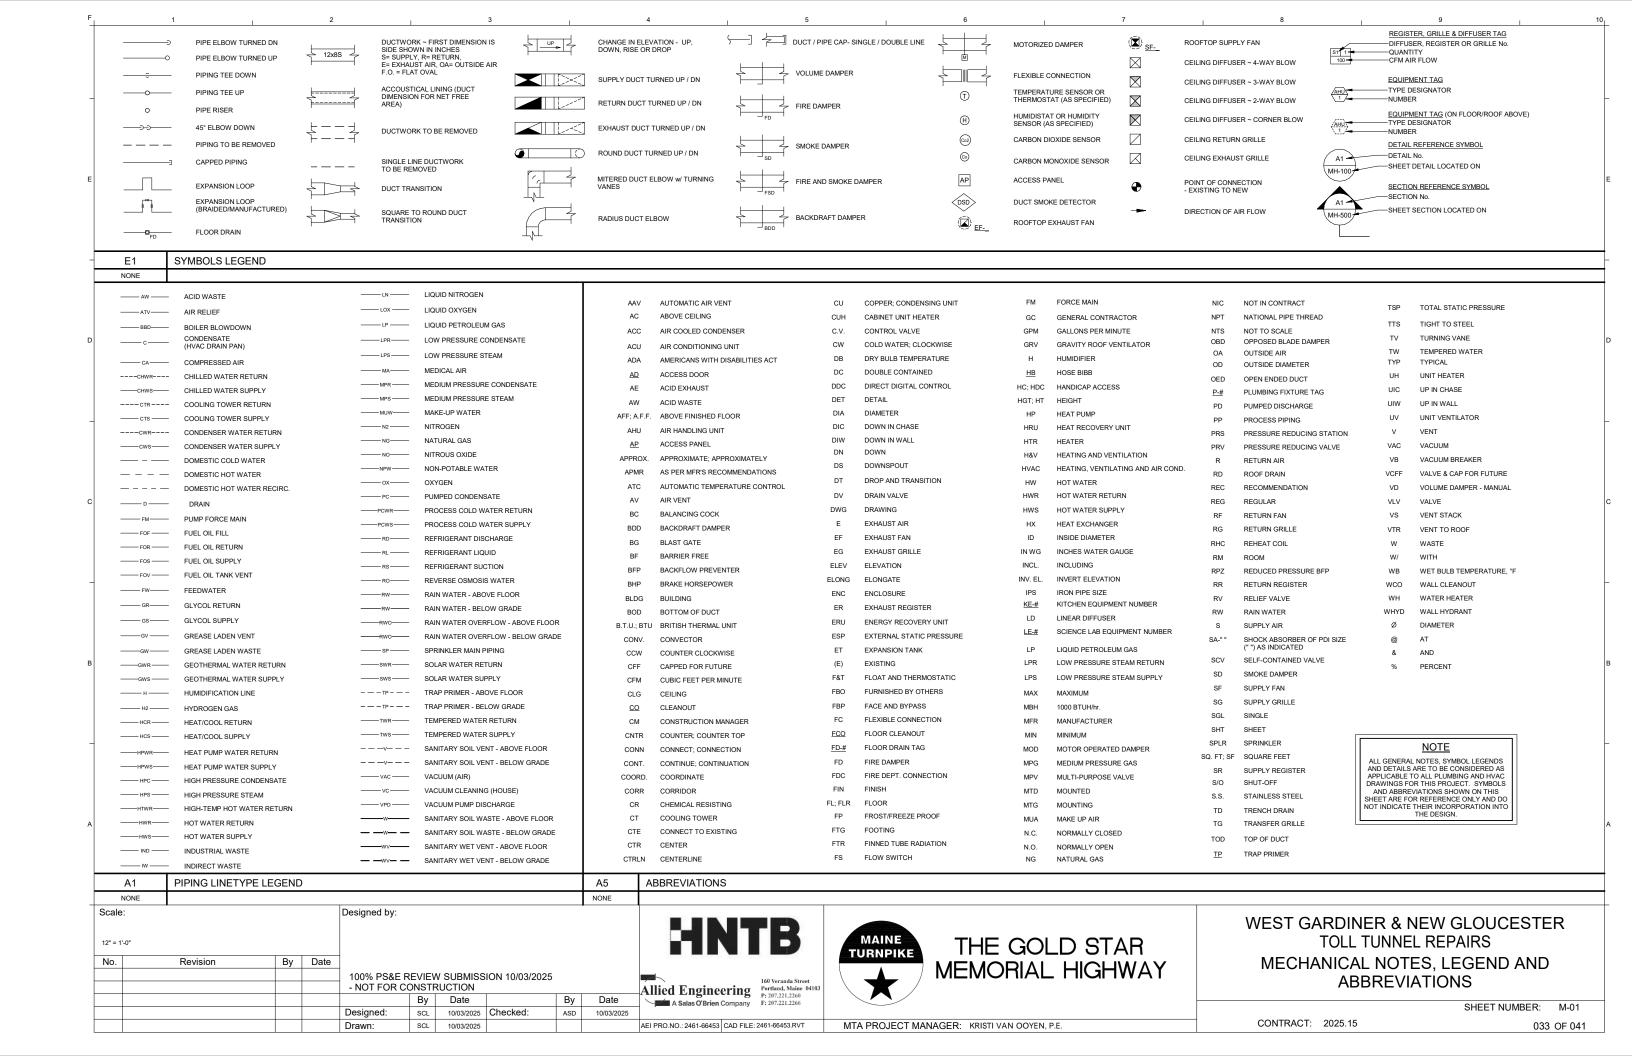


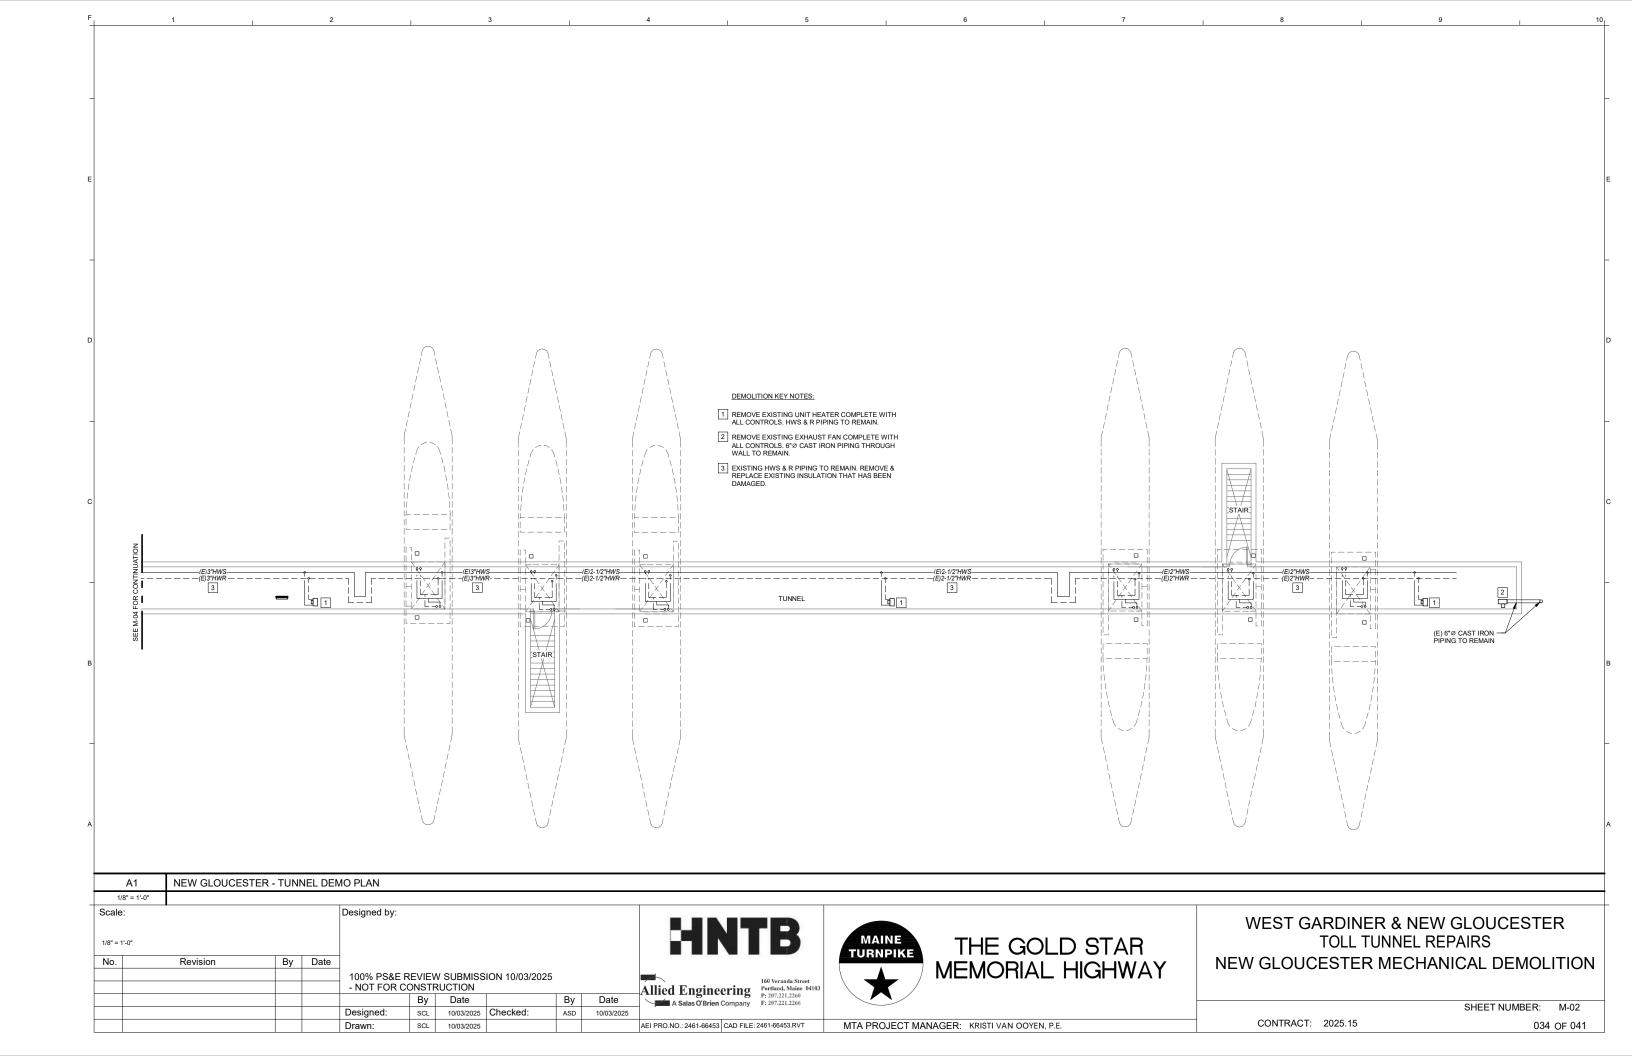


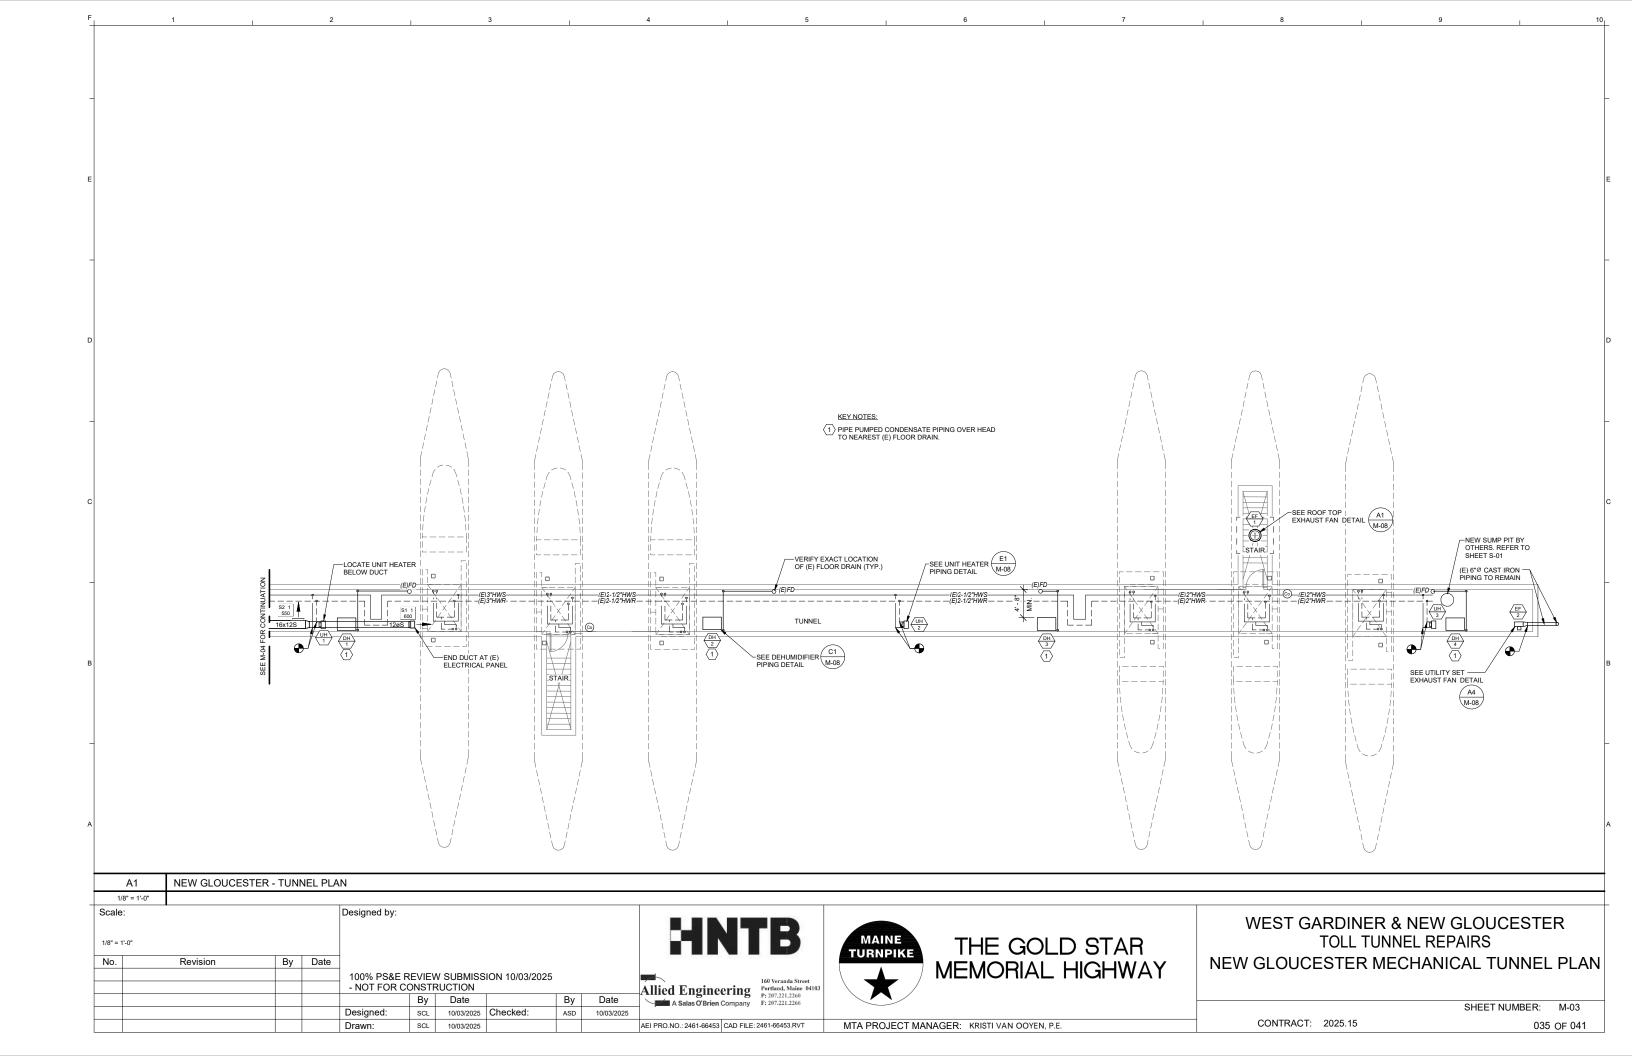


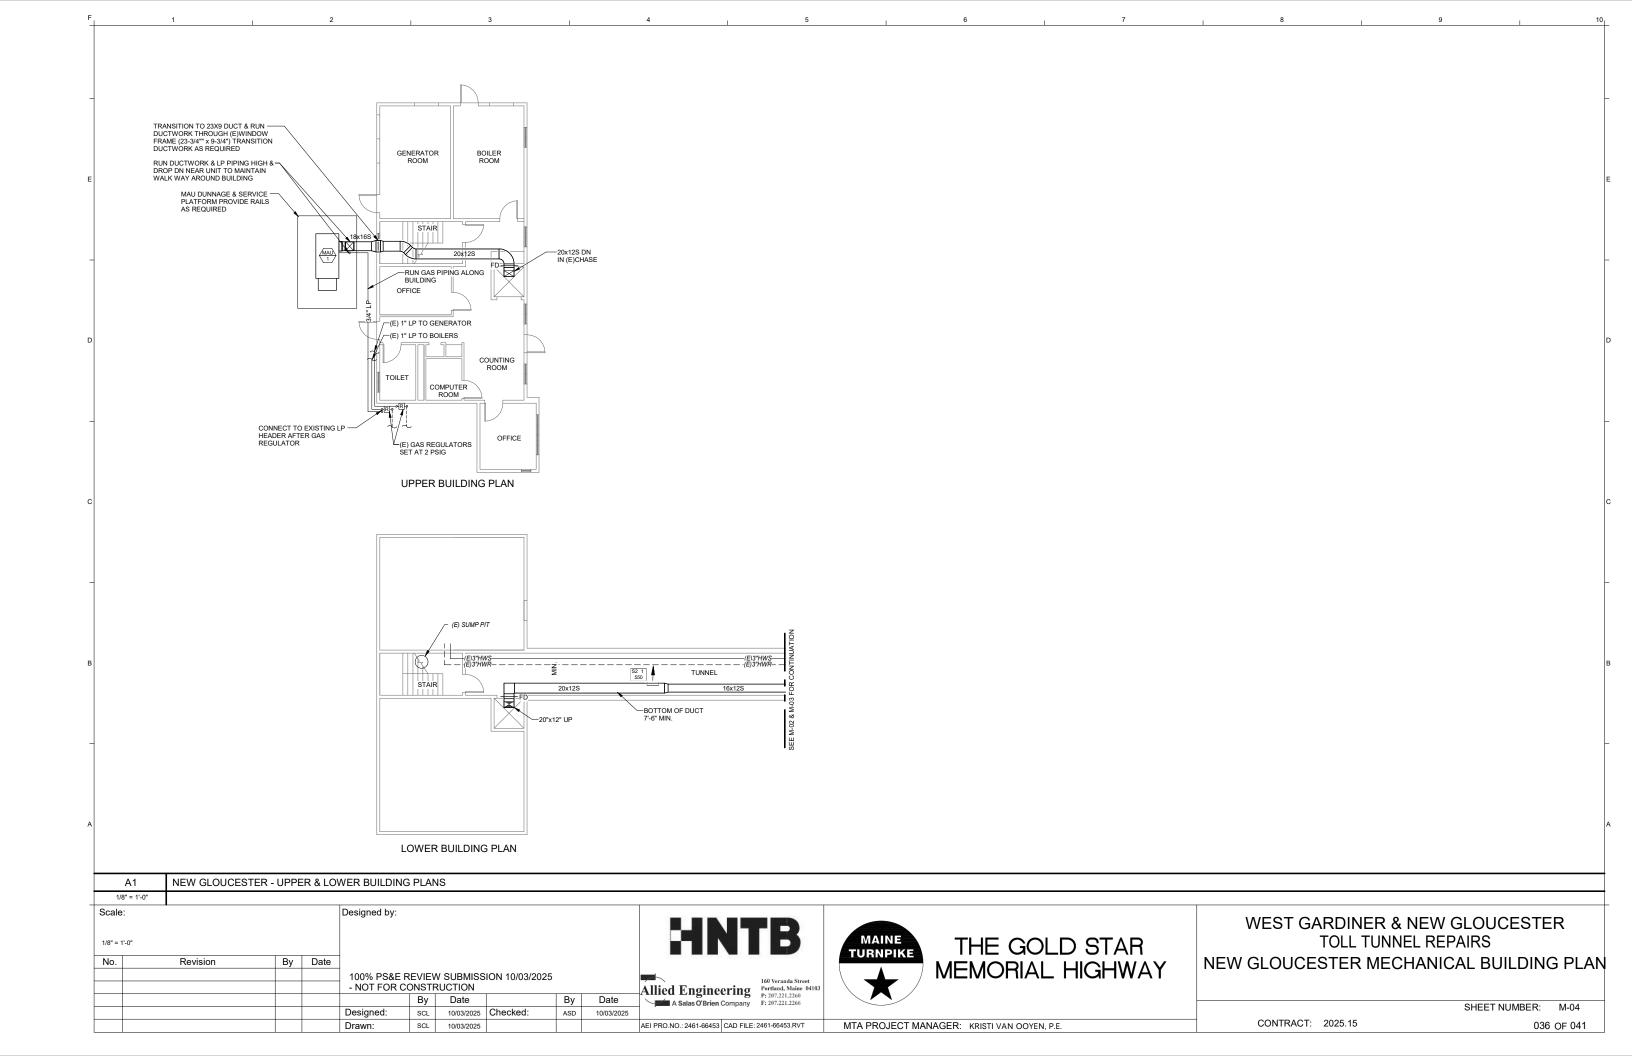

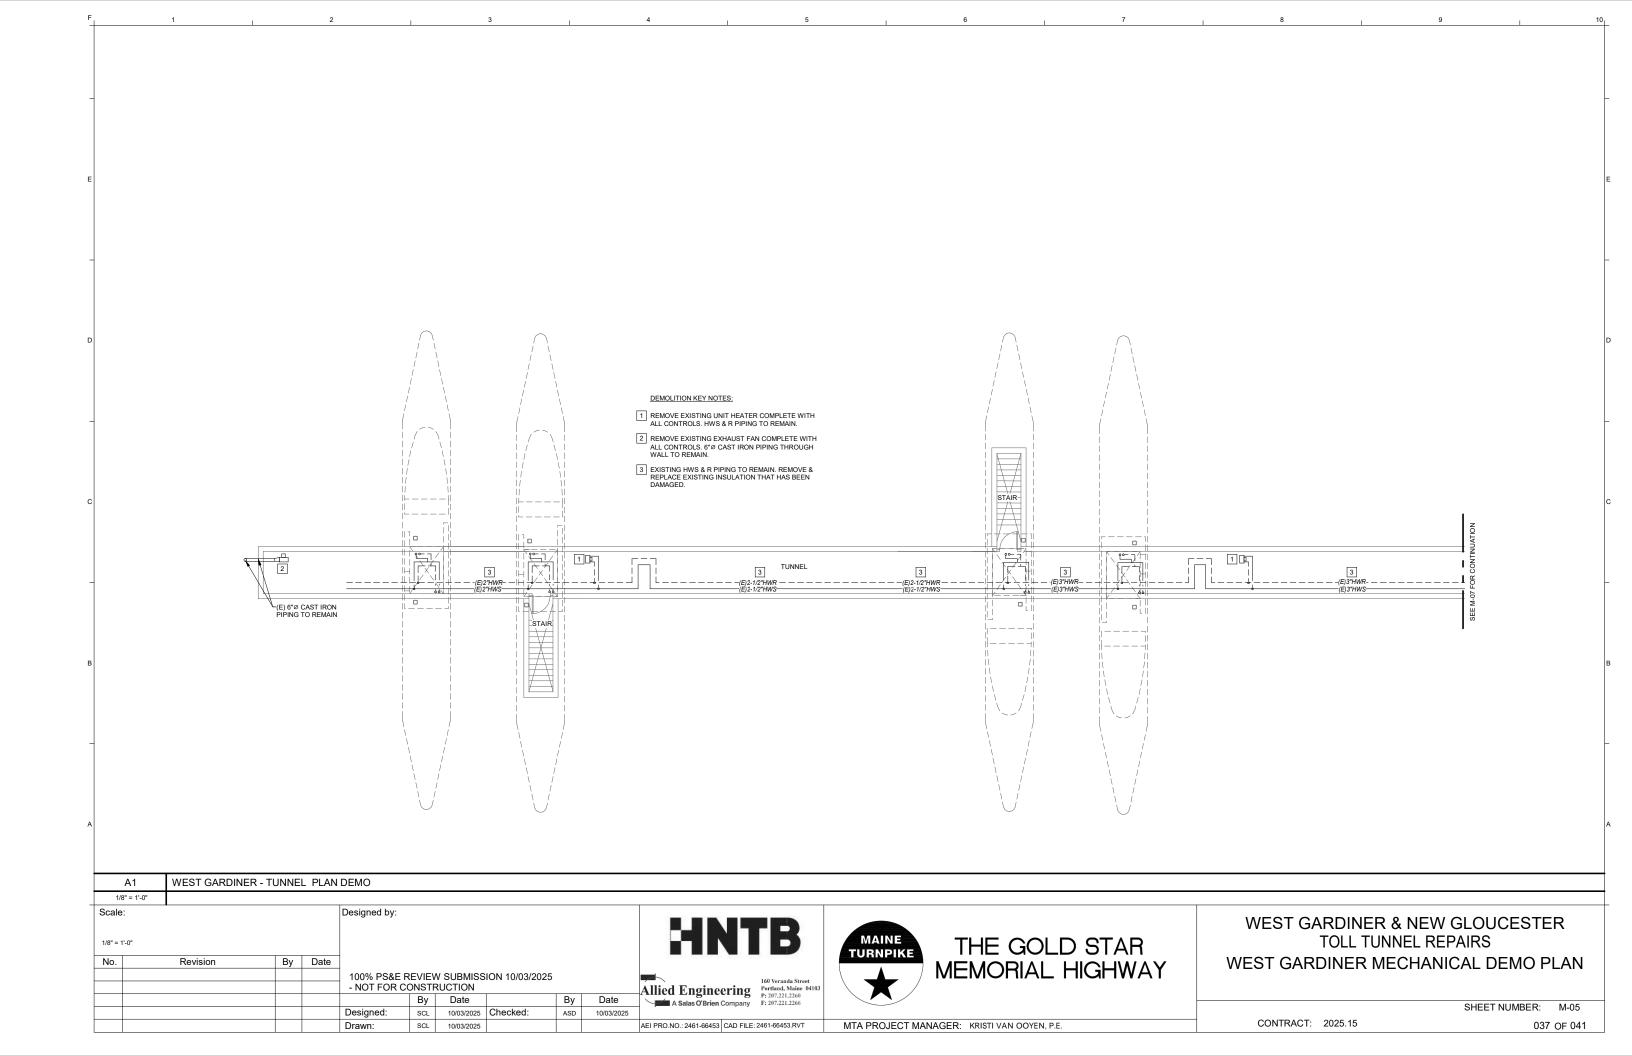

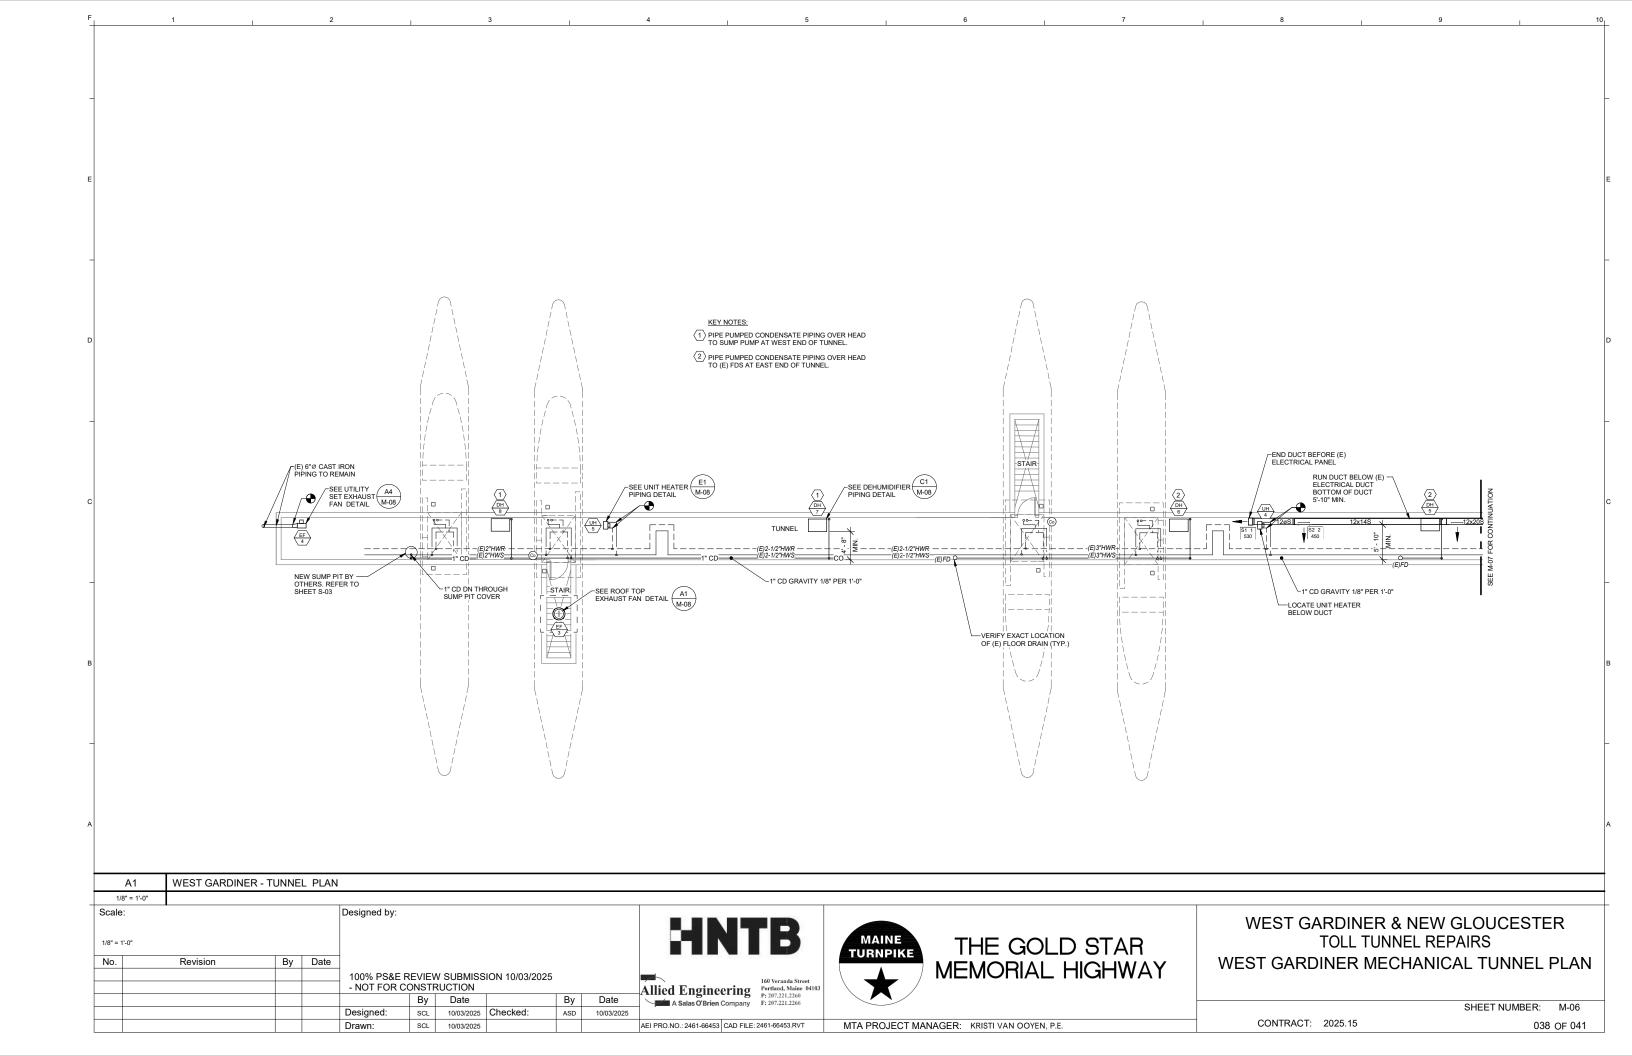

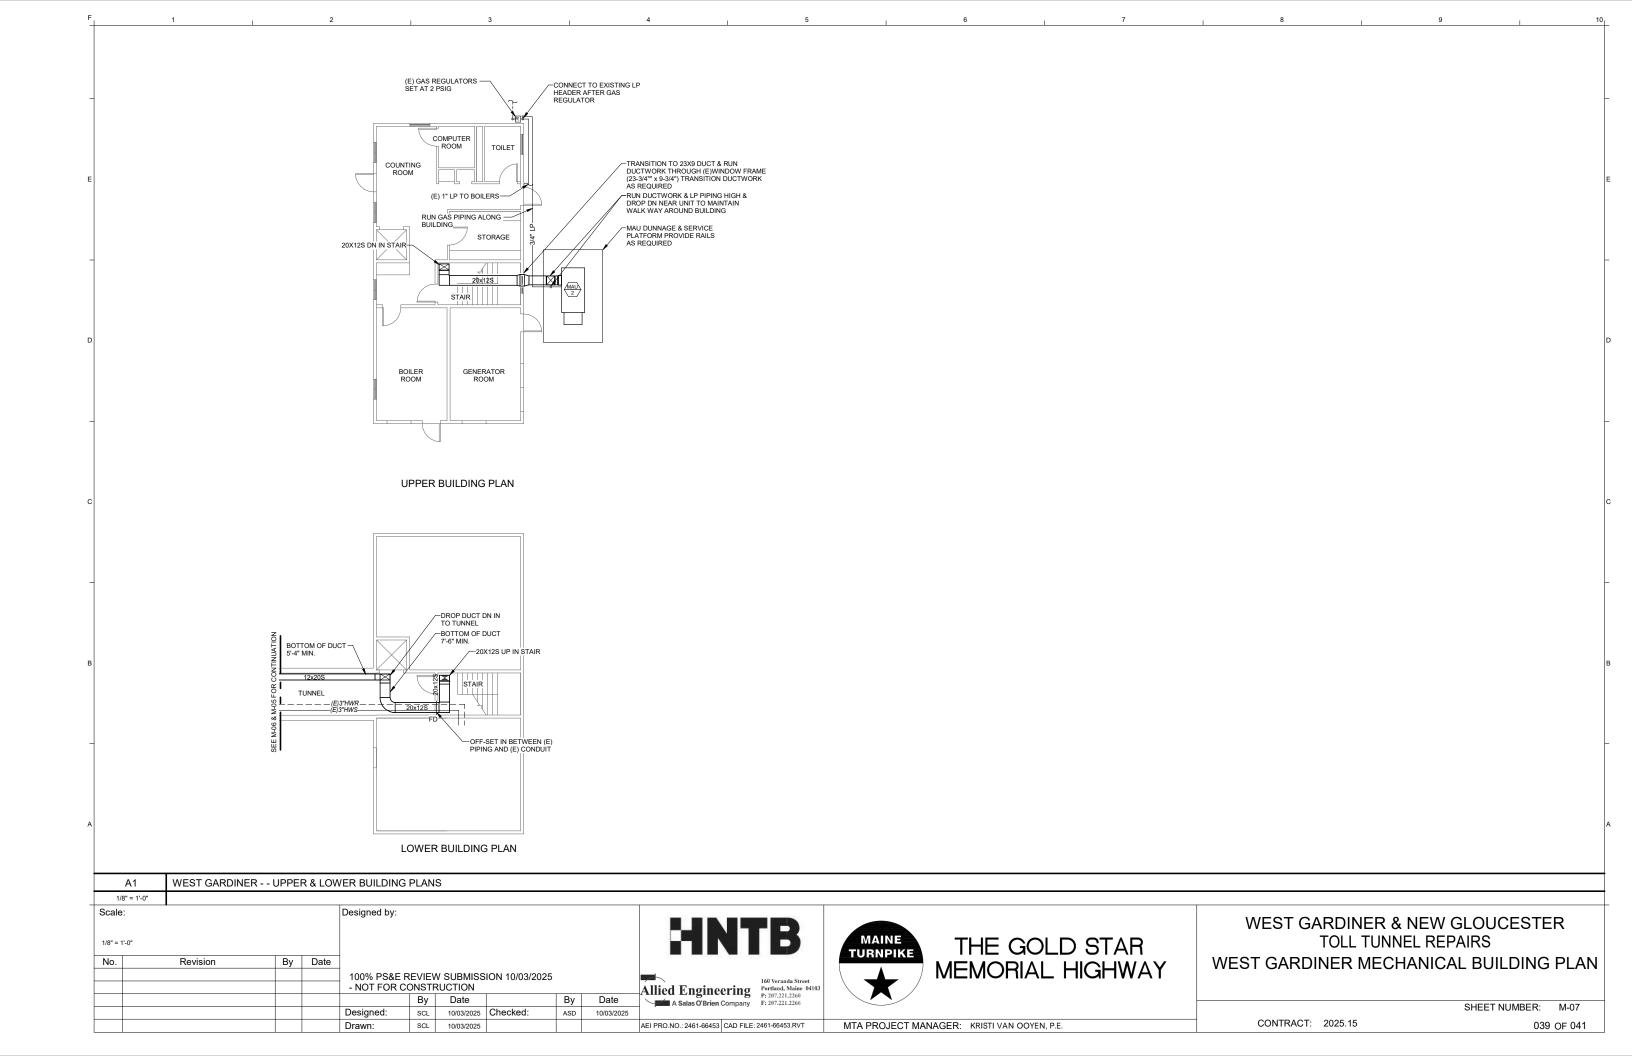

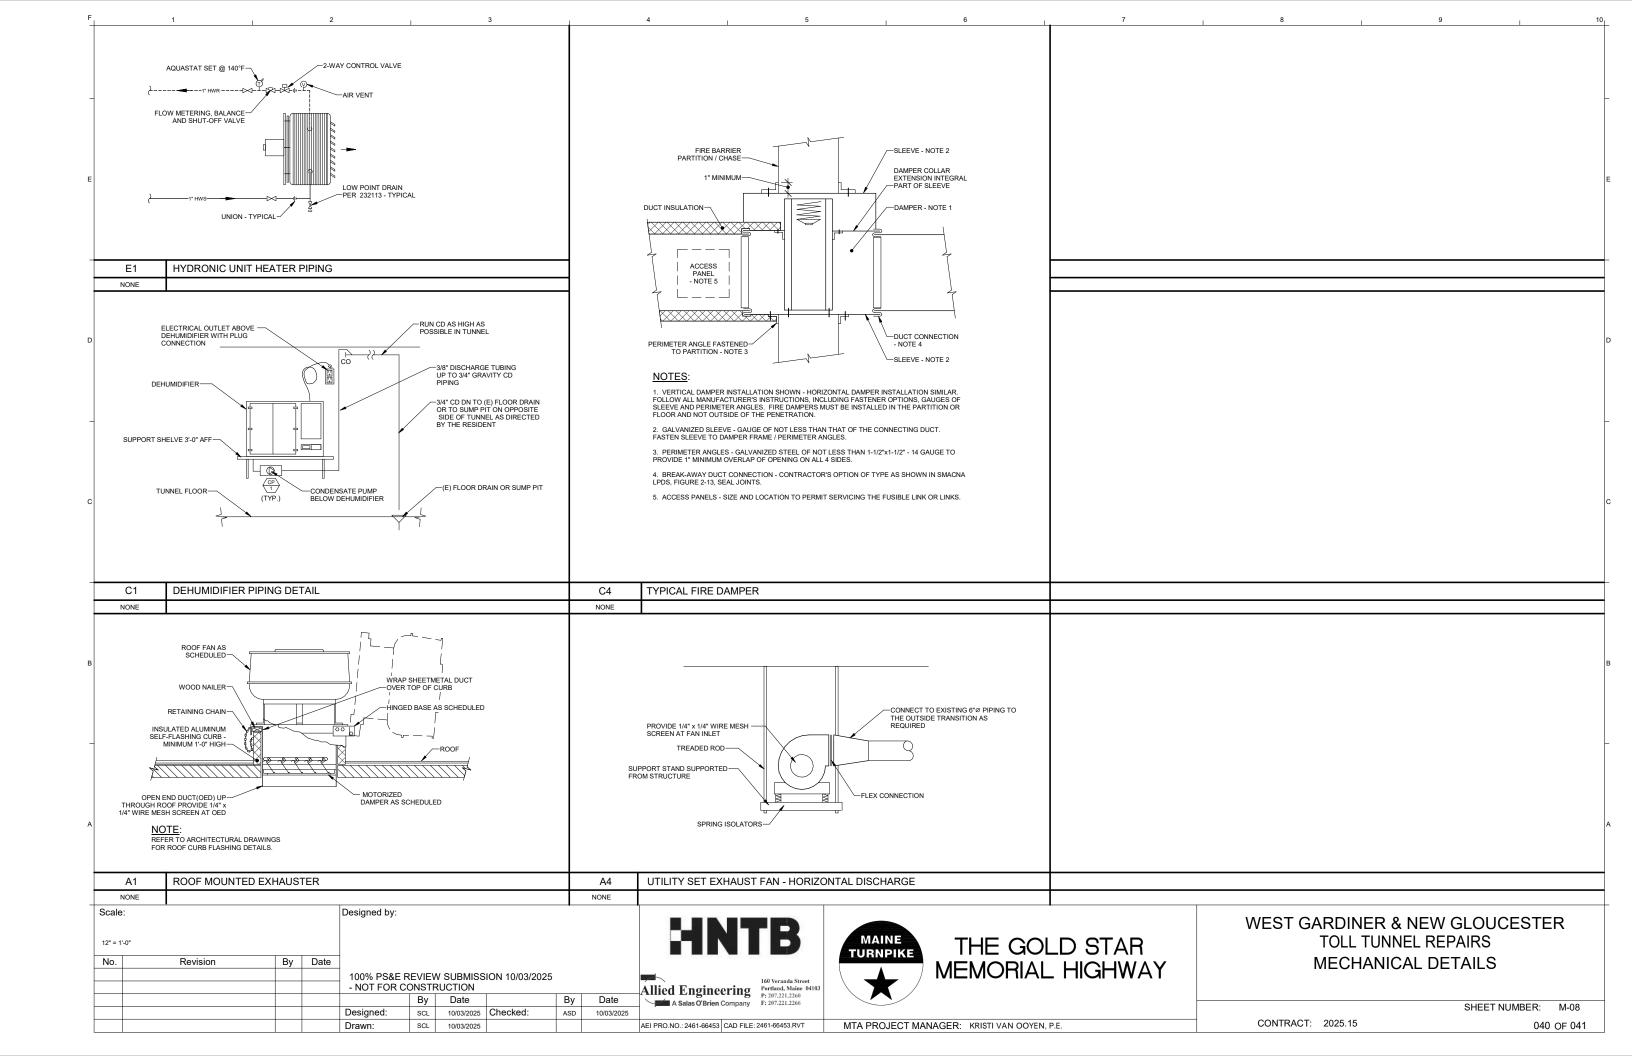

INDOOR UNIT:	MUA-1
MANUFACTURER	RUPPAIR
DESCRIPTION	INDIRECT FIRED
MODEL	186725/A01-ECM-60-277-16
WEIGHT	1213
AIRFLOW MAX, cfm	1,700
AIRFLOW MIN, cfm	850
ESP, in.wc.	1.5"
HP	1.75
RPM	1,805
HEATING	
FUEL	LP, 7" TO 14" WC
EAT - LAT, deg-F.	-10F to 85F
LP INPUT (MBH)	192
LP OUTPUT (MBH)	156
EFFICIENCY	81.3%
TURNDOWN	5 to 1
FILTERS	MERV 8
ELECTRICAL	
VOLTAGE/HZ/PHASE	208/1/60
MOP	15
MCA	11.3
NOTES:	

INDOOR UNIT:	MUA-2
MANUFACTURER	RUPPAIR
DESCRIPTION	INDIRECT FIRED
MODEL	186725/A01-ECM-60-277-16
WEIGHT	1213
AIRFLOW MAX, cfm	1,430
AIRFLOW MIN, cfm	700
ESP, in.wc.	1.5"
HP	1.75
RPM	1,663
HEATING	
FUEL	LP, 7" TO 14" WC
EAT - LAT, deg-F.	-10F to 85F
LP INPUT (MBH)	162
LP OUTPUT (MBH)	131
EFFICIENCY	80.9%
TURNDOWN	5 to 1
FILTERS	MERV 8
ELECTRICAL	
VOLTAGE/HZ/PHASE	208/1/60
MOP	15
MCA	11.3

2. Factory controller to maintain discharge air temperature when operating. Setpoint shall be via input from BAS.

			PLUMBING PU	IMP SCHEDULE					
							ELEC	TRICAL	
TAG	SERVES	MFR.	MODEL	TYPE	GPM	HEAD	MOTOR HP	VOLTS/PH (60 Hz.)	NOTES
CP-1	DEHUMIDIFERS	LITTLE GIANT	VCMA-15 SERIES	CONDENSATE PUMP	25	10	1/50	115/1	1
NOTES:									
 SEE S 	SPEC SECTION 221316	; PLUG ELECTRICAL	CONNECTION.						

						FAN	SCHE	DULE										
											El	ECTRICAL						
TAG	SERVES	MFR.	MODEL	TYPE	DRIVE	CFM-M IN	CFM-M AX			MOTOR HP	MOTOR TYPE	VFD FURN. BY	DISC. SWITCH FURN BY	VOLTS /PH	INLET LwA (db)	WEIGHT (LBS.)	DAMPER	NOTES
EF-1	TUNNEL	GREENHECK	CUE-130-VG	CENTRIFUGAL ROOF	DIRECT	1,100	1,100	0.75	0.23	0.5	ECM	DIV 23	FAN MFR.	208/1	73.0	77	MOD	2
EF-2	TUNNEL	GREENHECK	IP-5	UTILITY SET	DIRECT	600	600	1.0"	0.81	1	ECM	DIV 23	FAN MFR.	208/1	96.0	157	-	1
EF-3	TUNNEL	GREENHECK	CUE-130-VG	CENTRIFUGAL ROOF	DIRECT	1,100	1,100	0.75	0.23	0.5	ECM	DIV 23	FAN MFR.	208/1	73.0	77	MOD	2
EF-4	TUNNEL	GREENHECK	IP-5	UTILITY SET	DIRECT	600	600	1.0"	0.81	1	ECM	DIV 23	FAN MFR.	208/1	96.0	157	-	1
	1. TO RUN CONTI	NUOUSLY.																
	2. INTERLOCKED	WITH CO SENSO	OR, TO BE ENERGI	ZED ON A CALL FROM TH	E CO ALAF	RM.												

	DEHUMIDIFIE	R SCHEDULE NEW GLOUC	ESTER	
LOCATION	TOLL PLAZZA TUNNEL	TOLL PLAZZA TUNNEL	TOLL PLAZZA TUNNEL	TOLL PLAZZA TUNNEL
TAG	DH-1	DH-2	DH-3	DH-4
ARRANGEMENT	HORIZ. DEMUMIDIFIER	HORIZ. DEMUMIDIFIER	HORIZ. DEMUMIDIFIER	HORIZ. DEMUMIDIFIER
MANUFACTURER	DRISTEEM	DRISTEEM	DRISTEEM	DRISTEEM
MODEL	RL-14	RL-14	RL-14	RL-14
WATER REMOVAL (AT 70F AND 60%RH)	9.26 LBS/HR @ 75F / 50%RH			
ENERGY FACTOR	2.9 L / kWH			
REFRIGERANT	R410A	R410A	R410A	R410A
CFM	830	830	830	830
EXT. STATIC PRESSURE	0"	0"	0"	0"
ELECTRICAL	208/240-1-60	208/240-1-60	208/240-1-60	208/240-1-60
CURRENT DRAW, AMPS	11.1	11.1	11.1	11.1
DISCONNECT	10FT POWER CORD, GROUNDED			
COND. DRAIN SIZE	3/4"	3/4"	3/4"	3/4"
DIMENSIONS - H XW X L	24" X 37" X 25"			
WEIGHT, LBS.	180	180	180	180
NOTES: 1. PROVIDE CONDENSATE PUMP				

LOCATION	TOLL PLAZZA TUNNEL	TOLL PLAZZA TUNNEL	TOLL PLAZZA TUNNEL	TOLL PLAZZA TUNNEL
TAG	DH-5	DH-6	DH-7	DH-8
ARRANGEMENT	HORIZ. DEMUMIDIFIER	HORIZ. DEMUMIDIFIER	HORIZ. DEMUMIDIFIER	HORIZ. DEMUMIDIFIER
MANUFACTURER	DRISTEEM	DRISTEEM	DRISTEEM	DRISTEEM
MODEL	RL-14	RL-14	RL-14	RL-14
WATER REMOVAL (AT 70F AND 60%RH)	9.26 LBS/HR @ 75F / 50%RH			
ENERGY FACTOR	2.9 L / kWH			
REFRIGERANT	R410A	R410A	R410A	R410A
CFM	830	830	830	830
EXT. STATIC PRESSURE	0"	0"	0"	0"
ELECTRICAL	208/240-1-60	208/240-1-60	208/240-1-60	208/240-1-60
CURRENT DRAW, AMPS	11.1	11.1	11.1	11.1
DISCONNECT	10FT POWER CORD, GROUNDED	10FT POWER CORD, GROUNDED	10FT POWER CORD, GROUNDED	10FT POWER CORD, GROUNDE
COND. DRAIN SIZE	3/4"	3/4"	3/4"	3/4"
DIMENSIONS - H XW X L	24" X 37" X 25"			
WEIGHT, LBS.	180	180	180	180

UNIT HEATER SCHEDULE																		
TAG	SERVES	MFRMODEL	SIZE	TYPE	MBH	CFM	EAT (F)	LAT (F)	GPM	FLUID	EWT	LWT	MOTOR TYPE	MOTOR HP	ELECT	MAX WPD	CONTROL VALVE	NOTES
UH-1	NEW GLOUCESTER TUNNEL	TRANE UHSBA36	36	HORIZ. UH	35.9	850	60	99.1	3.6	WATER	180	150.0	TEAO	1/20	120-1-60	3.0	2-WAY	1
UH-2	NEW GLOUCESTER TUNNEL	TRANE UHSBA36	36	HORIZ. UH	35.9	850	60	99.1	3.6	WATER	180	150.0	TEAO	1/20	120-1-60	3.0	2-WAY	1
UH-3	NEW GLOUCESTER TUNNEL	TRANE UHSBA36	36	HORIZ. UH	35.9	850	60	99.1	3.6	WATER	180	150.0	TEAO	1/20	120-1-60	3.0	3-WAY	1
UH-4	GARDINER TUNNEL	TRANE UHSBA60	60	HORIZ. UH	43.6	900	60	104.9	4.4	WATER	180	150.0	TEAO	1/20	120-1-60	3.0	2-WAY	1
UH-5	GARDINER TUNNEL	TRANE UHSBA60	60	HORIZ. UH	43.6	900	60	104.9	4.4	WATER	180	150.0	TEAO	1/20	120-1-60	3.0	3-WAY	1
NOTES:																		
1. POWER WIRING TO UNIT HEATER BY DIV 26. ALL LOW VOLTAGE CONTROL WIRING, THERMOSTAT, RELAYS, AND TRANFORMERS BY DIV. 23. DISCONNECT SWITCH: PROVIDE BY UNIT HEATER MANUFACTURER.																		

	REGISTERS - GRILLES - DIFFUSERS (RGD) SCHEDULE													
TAG	MFR.	MODEL	TYPE	NECK SIZE	FACE SIZE		MAX TOTAL P.D	MAX NC LEVEL	BLOW	NOTES				
S-1	PRICE	620D	ALUMINUM DOUBLE DEFL. SUPPLY, W/DAMPER	14" X 10"	15.75" X 11.75"	600	0.10"	30	ADJUSTAB					
S-2	PRICE	AHCD2	ALUMINUM DRUM LOUVER. SUPPLY, W/DAMPER	15" X 6"	15.75" X 7.75"	600	0.10"	38	ADJUSTAB					

Scale	:		Designed by:						HNTB	MAINE THE GOLD		
No.	Revision	By Date							SALES AND SALES			
						ION 10/03/2025			160 Veranda Street	MEMORIAL H		
			- NOT FOR CONSTRUCTION						Allied Engineering Portland, Maine 04103			
				Ву	Date		Ву	Date	P: 207,221,2260 A Salas O'Brien Company F: 207.221,2266			
			Designed:	SCL	10/03/2025	Checked:	ASD	10/03/2025				
			Drawn:	SCL	10/03/2025				AEI PRO.NO.: 2461-66453 CAD FILE: 2461-66453.RVT	MTA PROJECT MANAGER: KRISTI VAN OOYEN, P.E.		



WEST GARDINER & NEW GLOUCESTER **TOLL TUNNEL REPAIRS** MECHANICAL SCHEDULES

SHEET NUMBER: M-09

CONTRACT: 2025.15

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