GARDINER

MAINE TURNPIKE AUTHORITY

MICHAEL J. CIANCHETTE, FALMOUTH, CHAIRMAN JANE L. LINCOLN, FARMINGDALE, VICE-CHAIR EMILY N. BECKER, POLAND, MEMBER NINA A. FISHER, FARMINGDALE, MEMBER ANDREW J. MCLEAN, GORHAM, MEMBER THOMAS J. ZUKE, SACO, MEMBER DALE F. DOUGHTY, MAINEDOT EX-OFFICIO

ANDRE J. BRIERE, COLONEL, USAF (ret.), EXECUTIVE DIRECTOR

CONTRACT 2025.17
BRIDGE REPAIRS
SACO RIVER OVERPASS SOUTHBOUND
(MM 33.0)
FOREST AVENUE OVERPASS
(MM 50.0)

INDEX OF SHEETS

SHEET NO. DESCRIPTION

- 1 TITLE SHEET
- 2 GENERAL NOTES & QUANTITIES
- 3 GUARDRAIL DETAIL

SACO RIVER OVERPASS

- 4-8 MAINTENANCE OF TRAFFIC
- CURB REPAIR PLAN & ELEVATION
 CURB REPAIR DETAILS
- 11 REINFORCING SCHEDULE
- 12 EXISTING RAILING STANDARD DETAILS
- 13 AS-BUILTS (SACO RIVER BRIDGE

FOREST AVENUE OVERPASS

14-16 FOREST AVENUE MOT

- 17 FOREST AVENUE OVERPASS DECK REPAIR PLAN
- 18 FOREST AVENUE OVERPASS DECK REPAIR DETAILS

APPROVED:

MAINE TURNPIKE AUTHORITY

SANFORD

LOCATION MAP

HNTB



7/25/2025 ATE

STEPHEN R. TARTRE, P.E., - CHIEF ENGINEER/DIRECTOR OF ENGINEERING

7/30/25

FOREST AVENUE

BRIDGE REPAIR MILE 50.0

SACO RIVER (SB) BRIDGE RAIL REPAIR

ATLANTIC

OGUNQUIT

SOUTH

YORK BEACH

PORTSMOUTH

"lename: 001_Title Sheet.dgn

GENERAL NOTES

- I. ALL DETAILS SHALL BE IN CONFORMANCE WITH MAINE DEPARTMENT OF TRANSPORTATION (MaineDOT) STANDARD DETAILS HIGHWAYS AND BRIDGES LATEST REVISION AND MaineDEP BEST MANAGEMENT PRACTICES FOR EROSION AND SEDIMENT CONTROL LATEST REVISION UNLESS OTHERWISE INCLUDED IN
- 2. WASTE MATERIALS SHALL BE DISPOSED OF OFF THE PROJECT SITE AND IN ACCORDANCE WITH ALL ENVIRONMENTAL REGULATIONS.
- 3. MATERIALS AND EQUIPMENT SHALL NOT BE STORED UNDER OR IN CLOSE PROXIMITY TO HIGHWAY STRUCTURES UNLESS THE CONTRACTOR RECEIVES WRITTEN PERMISSION FROM THE AUTHORITY.
- 4. COPIES OF THE AS-BUILT PLANS ARE POSTED ON THE MAINE TURNPIKE AUTHORITY WEBSITE AT WWW.MAINETURNPIKE.COM/PROJECTS/CONSRUCTION-CONTRACTS.THE COMPLETENESS AND ACCURACY OF THESE PLANS IS NOT GUARANTEED.
- 5. CHAMFER ALL EXPOSED NEW CONCRETE EDGES 3/4" UNLESS OTHERWISE NOTED.
- 6. NO EXISTING DRAINAGE SHALL BE ABANDONED, REMOVED OR PLUGGED WITHOUT APPROVAL OF THE
- 7. SPEED ZONE DATA COLLECTION DEVICES ARE REQUIRED AT SACO RIVER MAINLINE OVERPASS AND FOREST AVENUE MAINLINE OVERPASS. CONTRACTOR SHALL COORDINATE WITH THE AUTHORITY AND RESIDENT ON PLACEMENT OF DEVICES PRIOR TO LAYING OUT MAINTENANCE OF TRAFFIC CONTROL DEVICES.

UTILITY NOTES

- I. EXISTING UTILITIES ON THESE PLANS WERE COMPILED FROM EXISTING PLANS AND VARIOUS OTHER SOURCES. LOCATIONS ARE NOT GUARANTEED TO BE ACCURATE NOR IS IT GUARANTEED THAT ALL UTILITIES ARE SHOWN. NO SEPARATE OR ADDITIONAL COMPENSATION WILL BE ALLOWED TO THE CONTRACTOR DUE TO ANY VARIANCE BETWEEN THE DATA SHOWN ON THE PLANS AND THE ACTUAL FIELD CONDITIONS ENCOUNTERED. THE CONTRACTOR IS REQUIRED TO CALL DIG SAFE AT I-888-344-7233 AT LEAST 72 HOURS PRIOR TO THE START OF WORK, ALL PROPOSED SIGN AND EXCAVATION LOCATIONS SHALL BE MARKED AT THE NOTIFICATION TIME. THE RESIDENT ENGINEER SHALL BE PROVIDED AN ELECTRONIC COPY OF ALL DIG SAFE TICKETS WITHIN 24 HOURS OF THEIR RELEASE FOR PROJECT NOTIFICATIONS AND 3RD PARTY UTILITY LOCATOR COORDINATION.
- 2. THE CONTRACTOR SHALL NOTIFY ALL NON-MEMBERS THROUGH WWW.OKTODIG.COM OR AS OTHERWISE REQUIRED BY THE MAINE PUBLIC UTILITIES COMMISSION. ALL PROPOSED SIGN AND EXCAVATION IOCATIONS SHALL BE MARKED AT THE NOTIFICATION TIME. THE RESIDENT ENGINEER SHALL BE PROVIDED AN ELECTRONIC COPY OF ALL NON-MEMBER NOTIFICATIONS WITHIN 24 HOURS OF THEIR
- 3. THE CONTRACTOR SHALL NOTIFY THE RESIDENT 10 CALENDAR DAYS PRIOR TO SUBMITTING ANY UTILITY LOCATE REQUESTS AS NOTED ABOVE SO THAT THE RESIDENT CAN ARRANGE FOR MAINE TURNPIKE UNDERGROUND UTILITY LOCATION. ALL PROPOSED SIGN AND EXCAVATION LOCATIONS SHALL BE MARKED AT THE NOTIFICATION TIME. NO EXCAVATION SHALL BE PERMITTED UNTIL THE AUTHORITY HAS LOCATED AND MARKED ITS UNDERGROUND UTILITIES.
- 4. FOLLOWING THE COMPLETION OF THE INITIAL UTILITY LOCATE THE CONTRACTOR WILL GPS LOCATE ALL UTILITIES WITHIN THE PROJECT LIMITS AND PROVIDE A COPY OF THE DIG SAFE RECORDS TO THE AUTHORITY. THE CONTRACTOR, ACTING AS THE AUTHORITY'S THIRD-PARTY LOCATOR, SHALL BE RESPONSIBLE FOR REMARKING ALL MAINE TURNPIKE FACILITIES WHEN A DIG SAFE UTILITY IS CALLED FOR THE PROJECT. THIS WORK SHALL BE CONSIDERED INCIDENTAL TO THE CONTRACT.

EROSION CONTROL

- I. ADDITIONAL MEASURES MAY BE PROPOSED BY THE CONTRACTOR DUE TO SITE OR WEATHER CONDITIONS. THE RESIDENT MAY DIRECT THE CONTRACTOR TO IMPLEMENT ADDITIONAL MEASURES, ANY ADDITIONAL MEASURES APPROVED BY THE RESIDENT WILL
- 2. ALL TEMPORARY EROSION CONTROL DEVICES SHALL BE INSTALLED IN ACCORDANCE WITH THE MAINE DEPARTMENT OF TRANSPORTATION BEST MANAGEMENT PRACTICES.
- 3. A SILT SOCK OR SIMILAR SEDIMENT BARRIER SHALL BE INSTALLED AND MAINTAINED AROUND EACH BRIDGE SCUPPER.

MATERIALS

CONCRETE

ALL CONCRETE MEASURED FOR PAYMENT UNDER SECTION 502 SHALL BE CLASS AAA

REINFORCING STEEL

AASHTO M31, GRADE 60. ALL REINFORCING SHALL BE EPOXY-COATED.

			SACO	FOREST	TOTAL
ITEM NO.	ITEM DESCRIPTION	UNIT	QUANTITY	QUANTITY	QUANTIT
202.17	REMOVING EXISTING STRUCTURAL CONCRETE (48 CY)	LS	/		/
202,202	REMOVING PAVEMENT SURFACE - MAINLINE	SY		1900	1900
202.206	REMOVING RUMBLE STRIPS	LF	1800		1800
403.209	HOT MIX ASPHALT, 9.5 MM (SIDEWALKS, DRIVES & INCIDENTALS)	TON		8	8
403.2101	HOT MIX ASPHALT, 9.5 MM NOMINAL MAXIMUM SIZE (POLYMER MODIFIED)	TON		170	170
409.15	BITUMINOUS TACK COAT	GAL		100	100
502.49	STRUCTURAL CONCRETE CURBS AND SIDEWALKS (48 CY)	LS	/		/
503.14	EPOXY-COATED REINFORCING STEEL, FABRICATED AND DELIVERED	LB	7300		7300
503./5	EPOXY-COATED REINFORCING STEEL, PLACING	LB	7300		7300
507.17	ALUMINUM BRIDGE RAILING REPAIR AND RESET (1250 LF RESET, 30 LF REPAIR)	LS	/		/
508.14	HIGH PERFORMANCE WATERPROOFING MEMBRANE (92 SF)	LS		1	/
5/5.202	CLEAR PROTECTIVE COATING FOR CONCRETE SURFACES	SY	900		900
5/8.60	REPAIR OF VERTICAL SURFACES < 8 INCHES	SF	50		50
5/8.70	REPAIR OF OVERHEAD SURFACES <8 INCHES	SF		60	60
5/8.80	PARTIAL DEPTH CONCRETE DECK REPAIRS	SF		270	270
518.81	FULL DEPTH CONCRETE DECK REPAIRS	SF		60	60
520.23	ASPHALTIC PLUG JOINT	LF		90	90
526.306	TEMPORARY CONCRETE BARRIER, TYPE I - SUPPLIED BY AUTHORITY (2050 LF)	LS	1		1
527.341	WORK ZONE CRASH CUSHIONS, TL-3	UN	1		/
606.24	GUARDRAIL TYPE 3D - SINGLE RAIL	LF	300		300
627.73	TEMPORARY 6 INCH PAVEMENT MARKING TAPE	LF	10500		10500
627.731	TEMPORARY 6 INCH BLACK PAVEMENT MARKING TAPE	LF	5050		5050
627.77	REMOVING EXISTING PAVEMENT MARKING	SF	7800		7800
627.78	TEMPORARY 6" PAVEMENT MARKING LINE, WHITE OR YELLOW	LF	10500		10500
629.05	HAND LABOR, STRAIGHT TIME	HR	10	10	20
631.10	AIR COMPRESSOR (INCLUDING OPERATOR)	HR	10	10	20
631.11	AIR TOOL (INCLUDING OPERATOR)	HR	10	10	20
631.172	TRUCK - LARGE (INCLUDING OPERATOR)	HR	10	10	20
631.36	FOREMAN	HR	10	10	20
652.30	FLASHING ARROW	EΑ	/	2	3
652.33	DRUM	EΑ	34	200	234
652.34	CONE	EΑ	34	200	234
652.35	CONSTRUCTION SIGNS	SF	530	880	1410
652.36	MAINTENANCE OF TRAFFIC CONTROL DEVICES - FOREST AVE. OVERPASS	CD		25	25
652.361	MAINTENANCE OF TRAFFIC CONTROL DEVICES - SACO RIVER OVERPASS	LS	/		/
652.38	FLAGGERS	HR		120	120
652.41	PORTABLE CHANGEABLE MESSGE SIGN	EΑ	/	2	3
652.451	TRUCK MOUNTED ATTENUATOR	EΑ		4	4
659,10	MOBILIZATION	LS	1	1	2

Scale: Designed by: No. Revision By Date CONSULTANT PROJECT MANAGER: Timothy R. Cote, P.E Ву Checked Designed 07\25 In Charge of TRC 07\25

HNTB CORPORATION 82 Running Hill Road, Suite 201 South Portland, ME 04106 TEL (207) 774-5155 FAX (207) 228-0909



THE GOLD STAR MEMORIAL HIGHWAY BRIDGE REPAIRS

GENERAL NOTES AND QUANTITIES


SHEET NUMBER: GN-01

MTA PROJECT MANAGER: Lauren Fleming, P.E.

CONTRACT:2025.17

- I. RAIL ELEMENT SHALL MEET ALL REQUIREMENTS OF AASHTO M-180 EXCEPT AS MODIFIED ON THE PLANS.
- 2. A GAP (APPROXIMATELY 100') IN THE EXISTING GUARDRAIL EXISTS ON BOTH THE OUTSIDE AND MEDIAN SIDE APPROACHES TO ALLOW UN BUTH THE OUTSIDE AND MEDIAN SIDE APPROACHES TO ALLOW LAP IN TEMPORARY BARRIER BEHIND THE GUARDRAIL GUARDRAIL SHALL BE INSTALLED TO CONNECT THE GAP BETWEEN EXISTING SPLICES ON THE OUTSIDE AND MEDIAN SIDE. GUARDRAIL SHALL BE INSTALLED BEFORE REMOVING BARRIER FROM MOT PHASE.




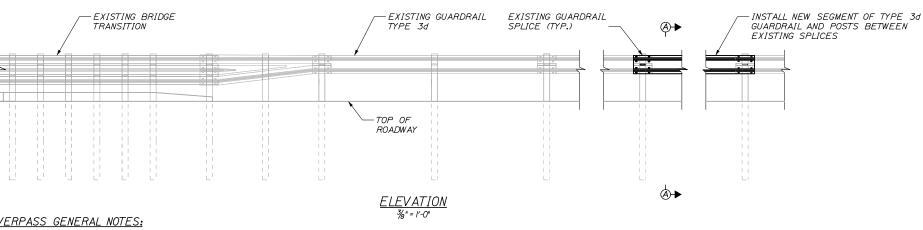

SECTION A-A 3/8" = 1'-0"

SACO RIVER OVERPASS GENERAL NOTES:

- I. LINE STRIPING FOR MAINTENANCE OF TRAFFIC SHALL BE COMPLETED WITH EITHER TEMPORARY TAPE OR TEMPORARY PAINT AS DIRECTED BY THE RESIDENT.
- 2. PAVEMENT MARKINGS SHALL BE LAID OUT BY CONTRACTOR FOR FINAL STRIPING. FINAL STRIPING TO BE COMPLETED BY THE

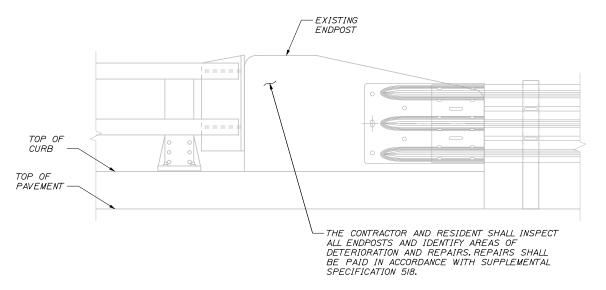

ENDPOST DETAIL

Sc	cale:				Designed by	:				
Sc		AS NOTED						ITB		
No).	Revision	Ву	Date						
					CONSULTANT	PROJEC	T MANAGER:	Timothy R. Cot	e, P.E.	
						Ву	Date		Ву	Date
					Designed	BRG	07\25	Checked	PDB	07\25
					Drawn	ERB	07\25	In Charge of	TRC	07\25

HNTB CORPORATION 82 Running Hill Road, Suite 201 South Portland, ME 04106 TEL (207) 774-5155 FAX (207) 228-0909



THE GOLD STAR **MEMORIAL HIGHWAY**


BRIDGE REPAIRS SACO RIVER OVERPASS


GUARDRAIL DETAILS


SHEET NUMBER: TYP-01


MTA PROJECT MANAGER: Lauren Fleming, P.E.

CONTRACT:2025.17

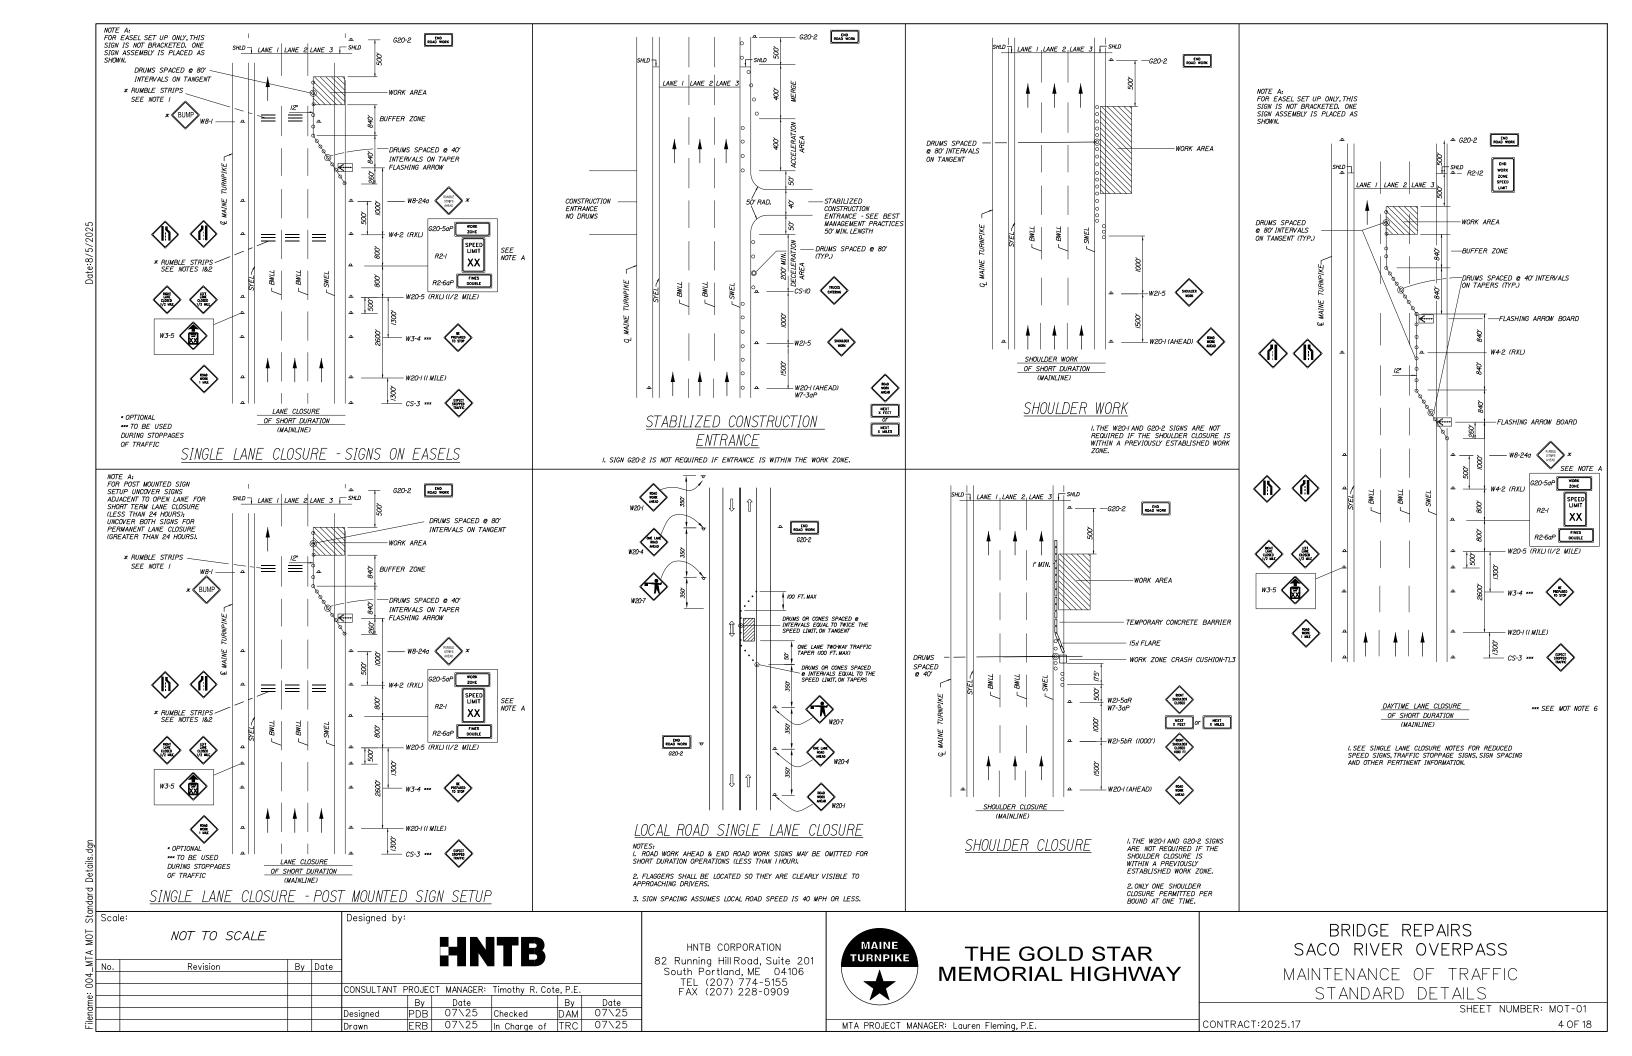


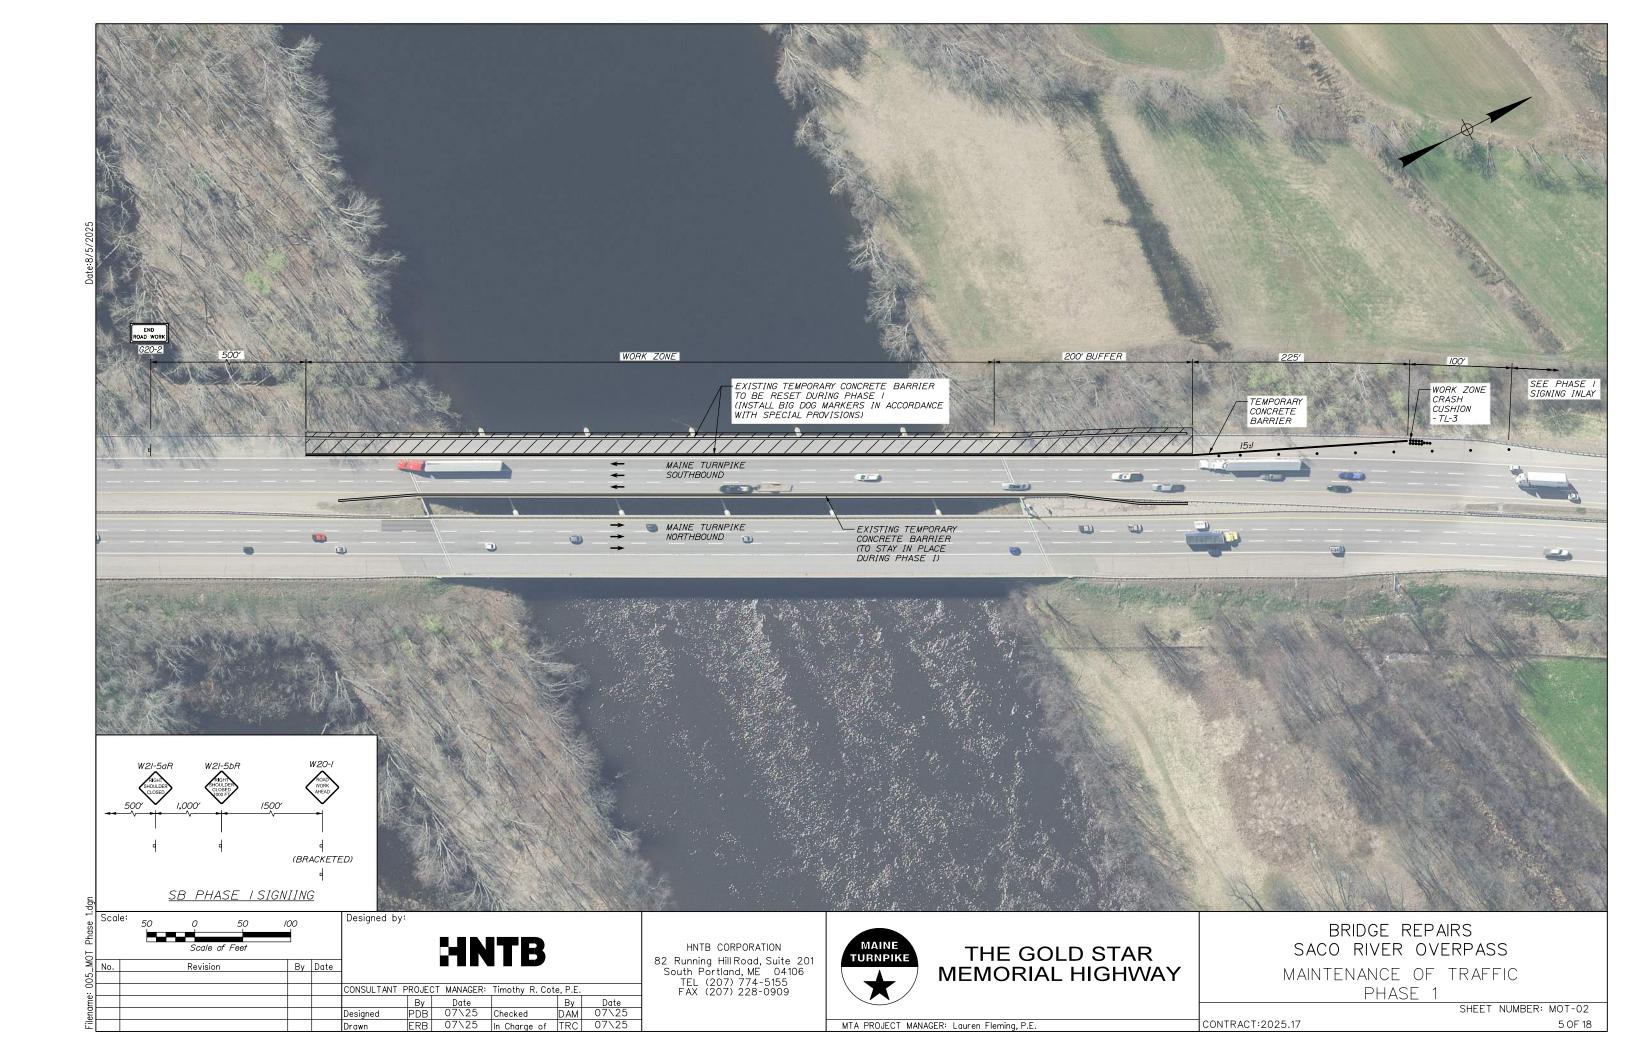

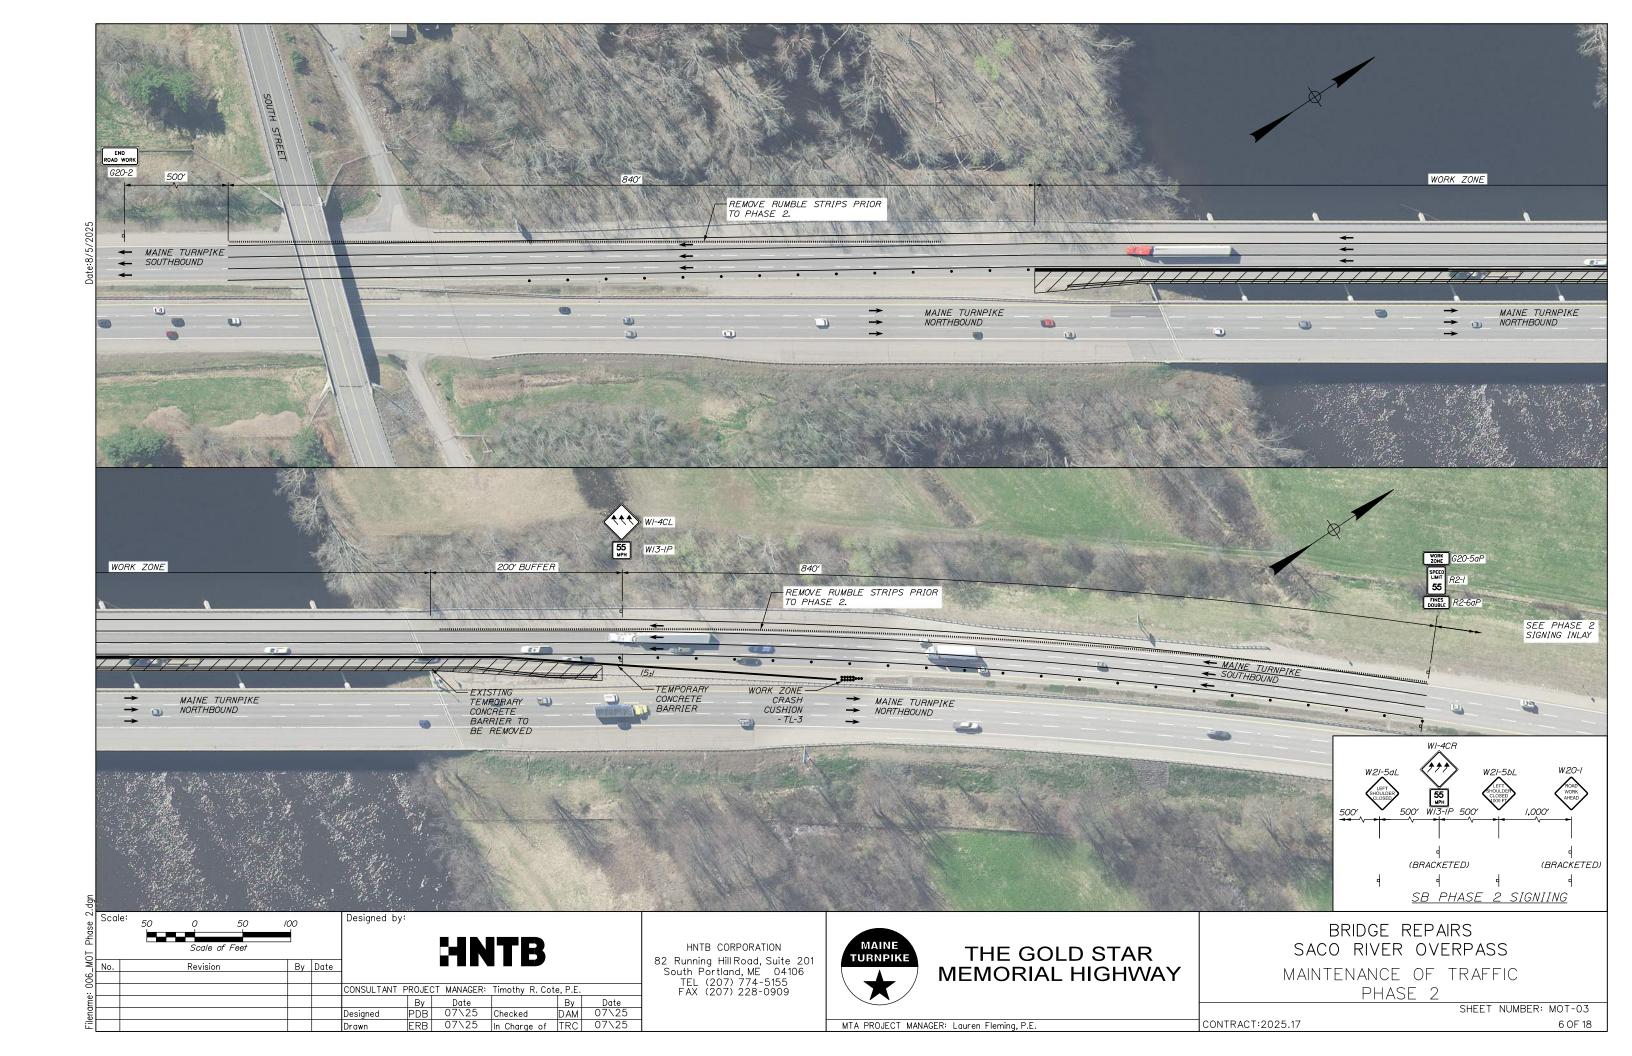


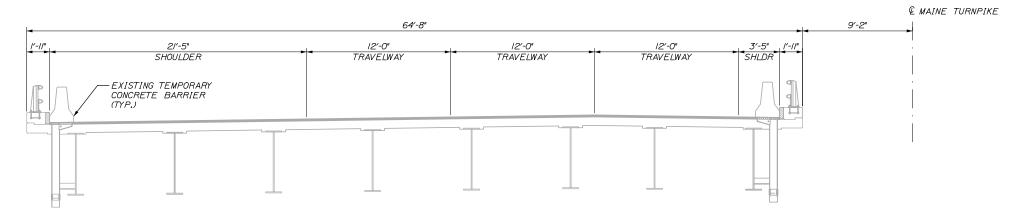

TRANSVERSE SECTION (SB) - EXISTING CONDITION

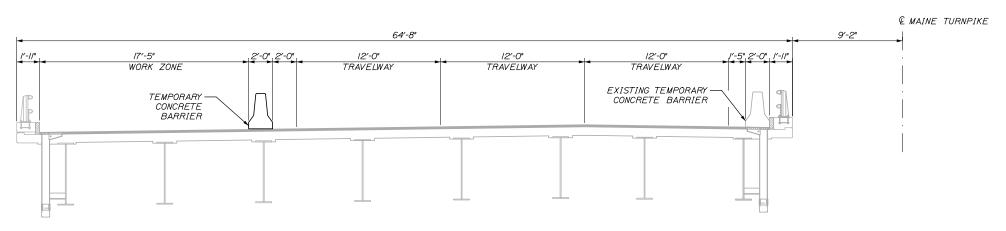

TRANSVERSE SECTION (SB) - PHASE I

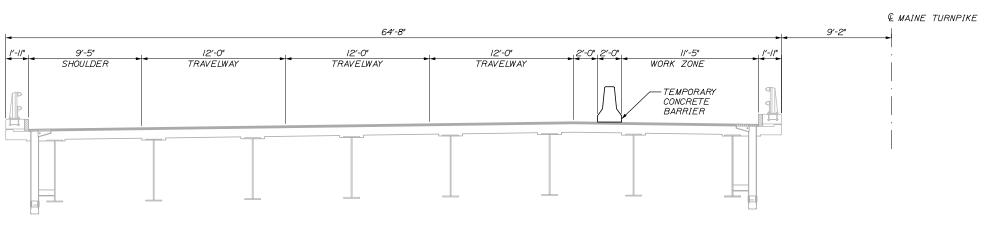

TRANSVERSE SECTION (SB) - PHASE 2

Scal	e:			Designed by	:				
Scal	NOT TO SCALE					-IN	ITB		
No.	Revision	Ву	Date]					
				CONSULTANT	PROJECT	T MANAGER:	Timothy R. Cot	e, P.E.	
					Ву	Date		Ву	Date
				Designed	PDB	07\25	Checked	BRG	07\25
				Drawn	ERB	07\25	In Charge of	TRC	07\25

HNTB CORPORATION 82 Running Hill Road, Suite 201 South Portland, ME 04106 TEL (207) 774-5155 FAX (207) 228-0909



THE GOLD STAR MEMORIAL HIGHWAY BRIDGE REPAIRS
SACO RIVER OVERPASS
MAINTENANCE OF TRAFFIC
TYPICAL SECTION

SHEET NUMBER: MOT-04
CONTRACT:2025.17 7 OF 18

MTA PROJECT MANAGER: Lauren Fleming, P.E.

IDENTIFI-	SIZE C	F SIGN		TE	XT DII	MENSI	ONS (IN	CHES)	NUMBER OF		COL	LOR		BORD	FR	AREA IN
CATION NUMBER	WIDTH	HEIGHT	TEXT	LE7 HE1	TER IGHT	VERT SPAC		ARROW RTE.MKR	SIGNS	BA GRC	CK- UND	LEG BOR	SEND RDER	RADI	<i>ـ</i> ر ، ر ر	SQUARE FEET
G20-2	48"	24"	END ROAD WORK	COI	VFORM ANDAR	TO "20 D HIG	SIONS S OO4 ED HWAY S PLEMEN	ITION - IGNS -	/	CONFORM TO -STANDARD I			RS SHALL "2004 EDITION HIGHWAY SIGNS UPPLEMENT"			8.00 (8)
W2I-5aR	48"	48"	RIGHT SHOULDER CLOSED						/							16.00 (16)
W2I-5aL	48"	48"	LEFT SHOULDER CLOSED						/							16.00 (16)
W2I-5bR	48"	48"	RIGHT SHOULDER CLOSED 000 FT						/							16.00 (16)
W2I-5bL	48"	48"	SHOULDER CLOSED						/							16.00 (16)
W20-I (AHEAD)	48"	48"	ROAD WORK AHEAD						2							16.00 (32)
WI-4cR	48"	48"							2							16.00 (32)
WI-4cL	48"	48"	(1 1)						2							16.00 (32)
W13-1P (60)	30"	<i>30</i> "	55 MPH						4							6.25 (25)

IDENTIFI- CATION	SIZE (OF SIGN	TEVT	TE	XT DI	MENSI	ONS (.	NCHE.	S)	NUMBER OF		COL	OR		BORDER	AREA IN
NUMBER	WIDTH	HEIGHT	TEXT		TER IGHT	VERT SPAC				SIGNS REQUIRED	BACH GROUI		LEGE. BORDI	ND	RADIUS	
G20-5aP	48"	24"	WORK ZONE	COI	VFORM ANDAR	DIMENS TO "20 RD HIG 2 SUPF	004 E HWAY	DITIO SIGNS	N -	2	COLORS SF CONFORM TO "200 -STANDARD HIGHV -2012 SUPPLL				EDITION Y SIGNS	
R2-I	48*	60°	SPEED LIMIT 55							2						20.00 (40)
R2-6aP	48 [#]	24"	FINES DOUBLE							2						8.00 (16)
W3-5	48"	48"	55							2						/6.00 (32)

Scale:

NOT TO SCALE

Revision By Date Designed Drawn

Designed by:

CONSULTANT PROJECT MANAGER: Timothy R. Cote, P.E.
 By
 Date
 By
 Date

 PDB
 07\25
 Checked
 DAM
 07\25

 PDB
 07\25
 In Charge of
 TRC
 07\25

HNTB CORPORATION 82 Running Hill Road, Suite 201 South Portland, ME 04106 TEL (207) 774-5155 FAX (207) 228-0909



THE GOLD STAR MEMORIAL HIGHWAY

BRIDGE REPAIRS SACO RIVER OVERPASS MAINTENANCE OF TRAFFIC SIGN SUMMARY 1 OF 1


CONTRACT:2025.17

SHEET NUMBER: MOT-05

MTA PROJECT MANAGER: Lauren Fleming, P.E.

BRIDGE RAIL AND CURB - PLAN

SCALE = 1/4" = 1/-0"

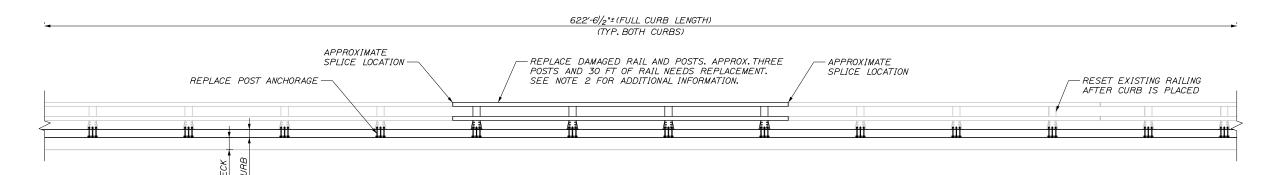

BRIDGE RAIL AND CURB - ELEVATION VIEW

(EXISTING GRANITE CURB NOT SHOWN FOR CLARITY)

SCALE = 1/4" = 1'-0"

GENERAL NOTES:

I. ALL PROPOSED REINFORCING STEEL SHALL BE EPOXY COATED AASHTO M3I GRADE 60, AND SHALL MEET THE REQUIREMENTS OF MAINEDOT STANDARD SPECIFICATION SECTION 503. ANCHORING MATERIAL SHALL BE KELKEN KELIGROUT OR AN APPROVED EQUAL EMBEDMENT DEPTH SHALL BE SUFFICIENT TO DEVELOP THE FULL TENSILE STRENGTH OF THE BAR.

- 2. CURB REPAIRS SHALL BE IN ACCORDANCE WITH SECTION 518 OF THE MAINE TURNPIKE AUTHORITY SUPPLEMENTAL SPECIFICATIONS, 2016. THE CONCRETE USED FOR CURB REPAIRS SHALL BE CLASS AAA IN ACCORDANCE WITH MAINE TURNPIKE AUTHORITY SUPPLEMENTAL SPECIFICATION 502.
- 3. PRIOR TO PLACEMENT OF THE CONCRETE, ALL BONDING SURFACES SHALL BE CLEANED OF DEBRIS AND COATED WITH AN EPOXY BONDING COMPOUND. THE BONDING COMPOUND SHALL BE ATC ULTRABOND I, OR AN APPROVED EQUAL.
- 4. BRIDGE RAIL AND POST INSTALLATION SHALL BE IN ACCORDANCE WITH SECTION 507 OF THE MAINEDOT STANDARD SPECIFICATIONS.
- 5. CLEAR PROTECTIVE COATING FOR CONCRETE SURFACES SHALL BE APPLIED TO THE FOLLOWING AREAS:
 - EXPOSED SURFACES OF THE CURBS AND ENDPOSTS - VERTICAL FACE OF THE DECK FASCIA
 - VERTICAL FACE OF THE DECK FASCIA - UNDERSIDE OF DECK OVERHANG TO GIRDER TOP FLANGE
- 6. ALL ENDPOSTS SHALL BE INSPECTED BY THE CONTRACTOR AND THE RESIDENT FOR CONCRETE DETERIORATION AND REPAIR. REPAIRS SHALL BE AS DIRECTED BY THE RESIDENT IN ACCORDANCE WITH SUPPLEMENTAL SPECIFICATION 518. END POST REPAIRS SHALL BE PAID UNDER ITEM 518.60 REPAIR OF VERTICAL SURFACES < 8 INCHES.

GENERAL NOTES (CONT.):

7. LOOSE CONCRETE ON THE UNDERSIDE OF DECK OVERHANG SHALL BE REMOVED IN THE FOLLOWING LOCATIONS:
- SPAN 2 OUTSIDE OVERHANG - APPROX. 4' LONG

- -SPAN 2 OUTSIDE OVERHANG -APPROX.4 LONG -SPAN 3 OUTSIDE OVERHANG -APPROX.4 LONG
- SPAN 5 OUTSIDE OVERHANG APPROX. 8' LONG
- AREAS ARE APPROXIMATE AND SHALL BE VERIFIED BY THE RESIDENT PRIOR TO REMOVING CONCRETE. CLEAR PROTECTIVE COATING ON THE UNDERSIDE OF OVERHANGS SHALL BE APPLIED AFTER LOOSE CONCRETE IS REMOVED. SPAN I IS THE SOUTHERN MOST SPAN, SPAN 6 IS THE NORTHERN MOST SPAN, PAYMENT FOR REMOVAL OF LOOSE CONCRETE SHALL NOT BE PAID FOR SEPARATELY BUT SHALL BE INCIDENTAL TO RELATED CONTRACT ITEMS. SEE SHEET S-03 FOR REPRESENTATIVE PHOTOS.
- 8. CONTRACTOR SHALL PROVIDE NECESSARY SHIELDING TO PROTECT REMOVED CONCRETE AND NEWLY PLACED CONCRETE FROM ENTERING THE RIVER. PAYMENT SHALL BE INCIDENTAL TO RELATED CONTRACT ITEMS.
- 9. SAND AND DEBRIS SHALL BE COMPLETELY REMOVED FROM BRIDGE FOLLOWING EACH PHASE OF CONSTRUCTION. PAYMENT SHALL BE INCIDENTAL TO CONTRACT ITEMS.

IO. THE ESTIMATED QUANTITY OF TEMPORARY CONCRETE BARRIER, TYPE I SUPPLIED BY THE AUTHORITY, INCLUDES EXISTING TEMPORARY CONCRETE BARRIER ON SITE. IT IS ESTIMATED THAT 1,800 LINEAR FEET OF TEMPORARY BARRIER IS CURRENTLY ON SITE. SEE SPECIAL PROVISION 526 FOR ADDITIONAL INFORMATION.

II. SPEED ZONE DATA COLLECTION DEVICES ARE REQUIRED AT SACO RIVER MAINLINE OVERPASS AND FOREST AVENUE MAINLINE OVERPASS. CONTRACTOR SHALL COORDINATE WITH THE AUTHORITY AND RESIDENT ON PLACEMENT OF DEVICES PRIOR TO LAYING OUT MAINTENANCE OF TRAFFIC CONTROL DEVICES.

BRIDGE RAILING REPAIR NOTES:

I.THE WORK UNDER PAY ITEM 507.17 GENERALLY INCLUDES REMOVING, STACKING AND RESETTING THE EXISTING ALUMINUM BRIDGE RAILING. ALL ANCHORAGES SHALL BE REPLACED.

2. REPLACEMENT RAIL BARS, SPLICES, AND POSTS WILL BE PROVIDED BY THE AUTHORITY. THE CONTRACTOR SHALL FURNISH ALL HARDWARE, ANCHOR RODS, ANCHOR TEMPLATES AND PREFORMED PADS REQUIRED FOR THE INSTALLATION OF THE RAILING COMPONENTS. ALL RAILING COMPONENTS PROVIDED BY THE CONTRACTOR SHALL BE IN ACCORDANCE WITH THE STANDARD RAILING DETAILS INCLUDED IN THIS PLAN SET. THE CONTRACTOR SHALL FIELD VERIFY THE DIMENSIONS FOR ALL COMPONENTS PROVIDED BY THE AUTHORITY TO ENSURE CONTRACTOR FURNISHED COMPONENTS WORK WITH THE AUTHORITY SUPPLIED COMPONENTS. REPLACEMENT RAIL SECTIONS SHALL BE SPLICE TO SPLICE.

- 3. ANCHOR BOLTS SHALL CONFORM TO ASTM F1554 GRADE 105 OR AN APPROVED EQUAL. ANCHOR SPACER PLATES SHALL CONFORM TO SECTION 713.01 OF THE MAINEDOT STANDARD SPECIFICATIONS.
- 4. ALL ANCHOR BOLTS, NUTS AND WASHERS SHALL BE HOT DIP GALVANIZED AFTER FABRICATION. HARDWARE FOR FASTENING RAIL BARS, CLAMP BARS, SET SCREWS, AND OTHER COMPONENTS SHALL BE STAINLESS STEEL CONFORMING TO AASTM F593, ALLOY GROUP I. CONDITION CW.
- 5. PREFORMED PADS SHALL CONFORM TO SECTION 713.03 OF THE MAINEDOT STANDARD SPECIFICATIONS.

CONTROL DEVICES. Scale: AS NOTED No. Revision By Date CONSULTANT PROJECT MANAGER: Timothy R. Cote, P.E. By Date By Date Designed BRG 07\25 Checked JDW 07\25 Drawn ERB 07\25 In Charge of TRC 07\25

HNTB CORPORATION

82 Running Hill Road, Suite 201

South Portland, ME 04106

TEL (207) 774-5155

FAX (207) 228-0909



MTA PROJECT MANAGER: Lauren Fleming, P.E.


THE GOLD STAR MEMORIAL HIGHWAY BRIDGE REPAIRS
SACO RIVER OVERPASS
CURB REPAIR
PLAN & ELEVATION

SHEET NUMBER: S-01


CONTRACT:2025.17

STILL I NOMBLIN 3-01

2025.17

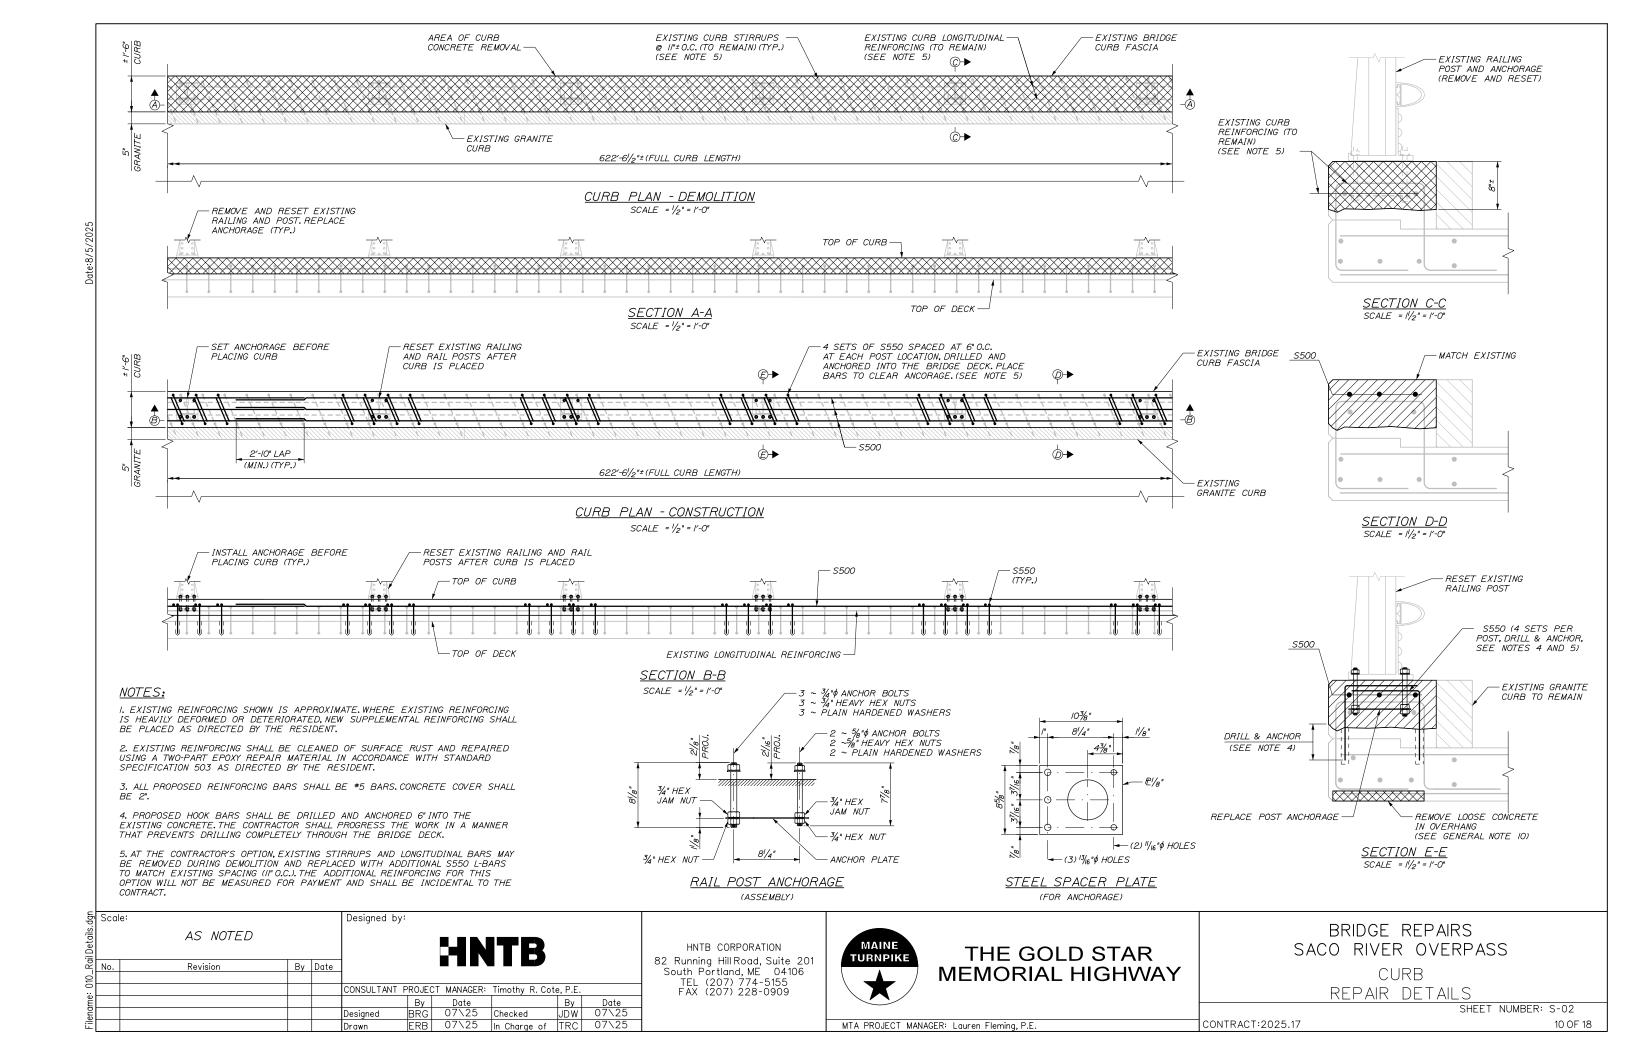

SACO	RIVER	BR	DGE	(SB)	AU											
MARK	SIZE	QTY		NGTH	TYPE	А	В	С	D	E	F	G	н	0	R	REMARKS
SUPERS	SUPERSTRUCTURE															
S500	5	102	40'	0"	Straight											Longitudinal Curb Reinforcing
S550	5	1280	2'	3"	118	1'-0"	1'-3"									Hooked Curb Reinforcing

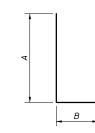

TYPE 118







REPRESENTATIVE PHOTOS OF INCIPIENT SPALLS AND DELAMINATION TO BE REMOVED

Designed by: Scale: By Date Revision CONSULTANT PROJECT MANAGER: Timothy R. Cote, P.E.
 By
 Date
 By
 Date

 BRG
 07\25
 Checked
 JDW
 07\25

 ERB
 07\25
 In Charge of TRC
 07\25
 Designed Drawn

HNTB CORPORATION 82 Running Hill Road, Suite 201 South Portland, ME 04106 TEL (207) 774-5155 FAX (207) 228-0909




THE GOLD STAR MEMORIAL HIGHWAY


BRIDGE REPAIRS SACO RIVER OVERPASS REINFORCING SCHEDULE AND OVERHANG SPALLING PHOTOS


CONTRACT:2025.17

SHEET NUMBER: S-03

MTA PROJECT MANAGER: Lauren Fleming, P.E.

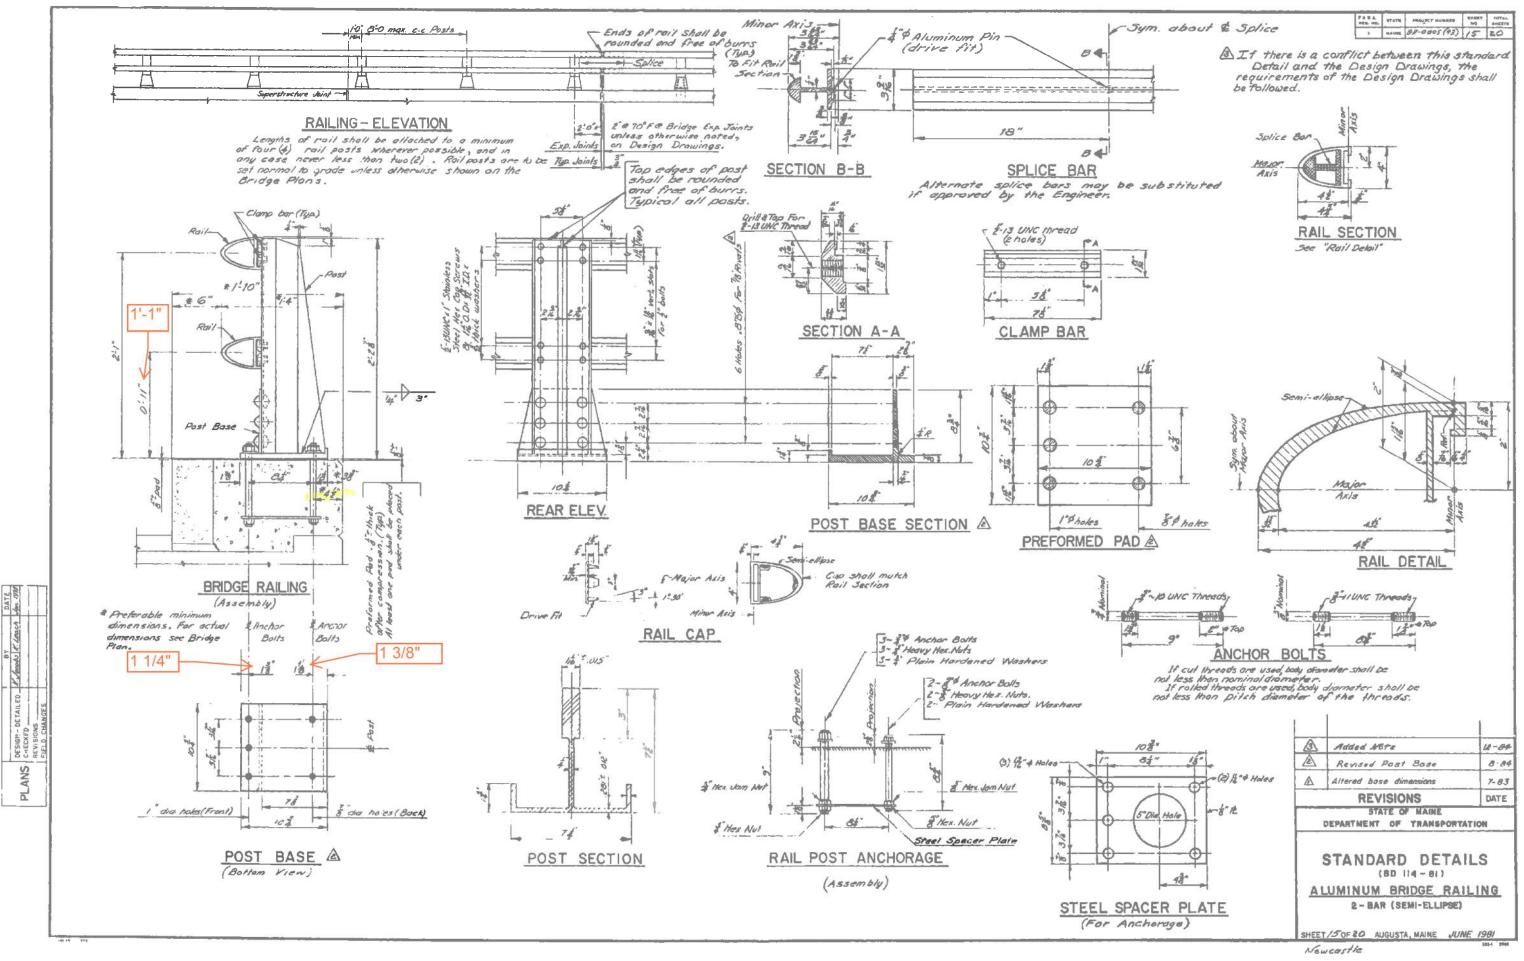


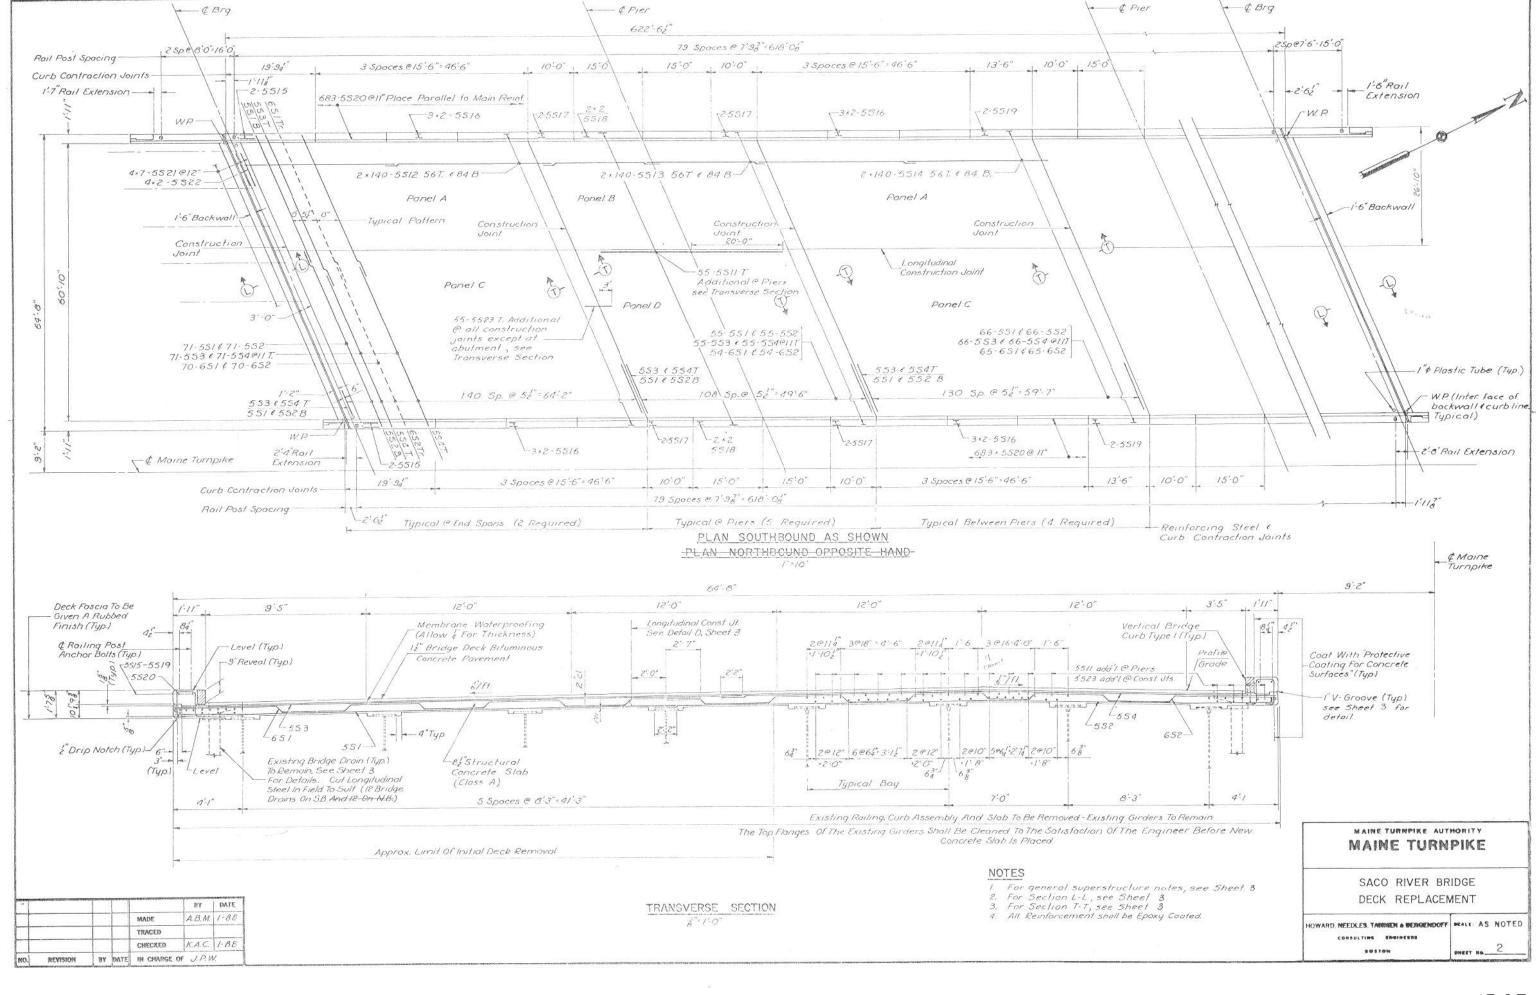

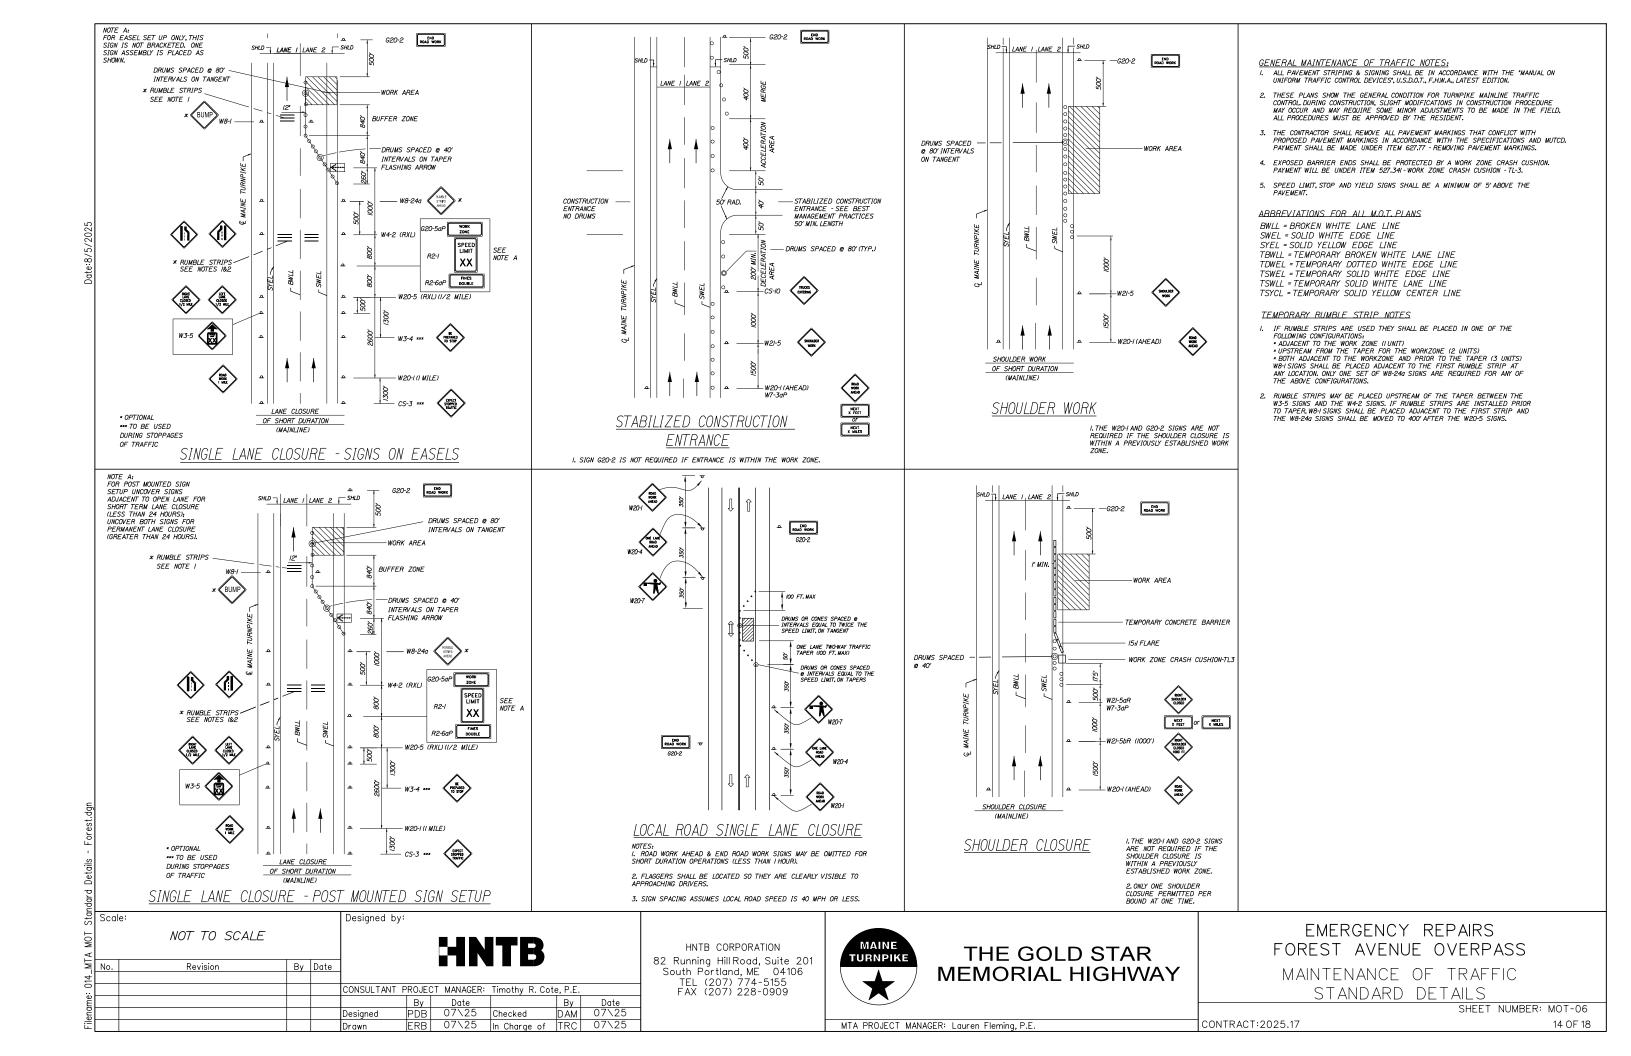

NOTES:

- I. LANE CLOSURES SHALL BE SIGNED FOR 45 MPH AND MAY ONLY OCCUR AT NIGHT AND LANES MUST BE REOPENED FOR THE NEXT DAY. SEE SPECIAL PROVISION 652.
- 2. FOR NIGHT LANE CLOSURES TEMPORARY STRIPING IS NOT REQUIRED.
- 3. LANE SHIFTS ARE SHOWN FOR INFORMATIONAL PURPOSES. ACTUAL LANE SHIFTS SHALL BE DETERMINED IN THE FIELD BASED ON WIDTH LIMITS OF MILLING, LOCATION AND EXTENT OF DECK REPAIRS, AND WIDTH LIMITS OF PAVEMENT REHABILITATION.
- 4. CONTRACTOR SHALL SUBMIT MOT LAYOUT FOR RESIDENT REVIEW AND APPROVAL A MINIMUM OF 7 DAYS PRIOR TO SFTUP.
- 5. PORTABLE CHANGEABLE MESSAGE BOARDS SHALL BE SET UP ONE WEEK IN ADVANCE OF PLANNED LANE CLOSURES AND SHALL BE MAINTAINED DURING TEMPORARY CLOSURES.
- 6. PEDESTRIAN TRAFFIC ON FOREST AVENUE MUST BE MAINTAINED AT ALL TIMES.
- 7. ONE TRUCK MOUNTED ATTENUATOR MINIMUM PER BOUND IS REQUIRED. A SECOND TRUCK MOUNTED ATTENUATOR MAY BE USED IF NECESSARY.

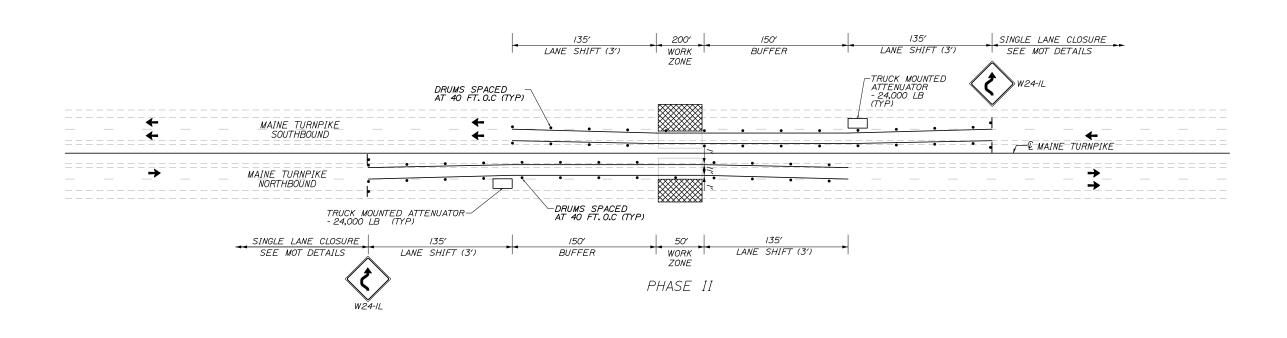

Scale:

NOT TO SCALE

No. Revision

By Date

CONSULTANT PROJECT MANAGER: Timothy R. Cote, P.E.

By Date

Designed PDB 07\25 Checked DAM 07\25

Drawn ERB 07\25 In Charge of TRC 07\25

HNTB CORPORATION 82 Running Hill Road, Suite 201 South Portland, ME 04106 TEL (207) 774-5155 FAX (207) 228-0909



THE GOLD STAR MEMORIAL HIGHWAY FOREST AVENUE OVERPASS

EMERGENCY REPAIRS

MAINTENANCE OF TRAFFIC

CONTRACT:2025.17

SHEET NUMBER: MOT-07

MTA PROJECT MANAGER: Lauren Fleming, P.E.

15 OF 1

IDENTIFI-	SIZE (OF SIGN		TE.	XT DII	MENSIC	NS (II	VCHES))	NUMBER OF	COLOR				BORDE	AREA IN
CATION NUMBER	WIDTH	HEIGHT	TEXT	LET HE I	TER GHT	VERT. SPAC	ICAL ING	ARRO RTE. M	OW IKR.	SIGNS REQUIRED	BA GRO	CK- UND	LEGE BORD	END DER	RADIUS	SQUARE FEET
G20-5aP	48"	24"	WORK ZONE	CON	FORM ANDAR	DIMENSIONS SHALL M TO "2004 EDITION - ARD HIGHWAY SIGNS - NI2 SUPPLEMENT"			-	4	CONFORI -STANDA		COLORS SH PRM TO "200- DARD HIGHW 2012 SUPPLE		EDITIO AY SIGN:	8.00 (32)
R2-I	48"	60"	SPEED LIMIT 45							4						20.00 (80)
R2-6aP	48"	24"	FINES DOUBLE							4						8.00 (32)
R2-I2	48"	6O"	END WORK ZONE SPEED LIMIT							4						20.00 (80)
W4-2L	48"	48"								4						16.00 (64)
W4-2R	48"	48"								4						16.00 (64
W24-IL	48"	48"								5						16.00 (80)
W24-IR	48"	48"								6						16.00 (96)
W3-5	48"	48"	45							4						16.00 (64)

IDENTIFI-	SIZE C	OF SIGN		TE	XT DI	MENSI	ONS (1	NCHE.	S)	NUMBER OF		COL	LOR		ROR	DER	AREA IN
CATION NUMBER	WIDTH	HEIGHT	TEXT -		TER IGHT	VERT SPAC		ARF RTE.		SIGNS REQUIRED		CK- UND	LEG BOR	SEND RDER		DIUS	SQUARE FEET
W2O-I (I MILE)	48"	48"	ROAD WORK 1 MILE	COI	VFORM ANDAR	TO "20 D HIG	ISIONS SHALL 2004 EDITION - GHWAY SIGNS - PLEMENT"			4	COLORS SI CONFORM TO "200 -STANDARD HIGHW -2012 SUPPLI			"2004 I[GHW)	EDI AY S	IGNS	16.00 (64)
W20-5L	48"	48"	RIGHT LANE CLOSED 1/2 MILE							2							16.00 (32)
W20-5R	48"	<i>48</i> "	LEFT LANE CLOSED 1/2 MILE							4							16.00 (64)
W20-7	48"	<i>48</i> "								2							16.00 (32)
W20-4	48"	<i>48</i> "	ONE LANE ROAD AHEAD							2							16.00 (32)
W20-I	48"	<i>48</i> "	ROAD WORK AHEAD	,	,					2							16.00 (32)

CONTRACT:2025.17

Scale:

NOT TO SCALE

Revision By Date

Designed by:

CONSULTANT PROJECT MANAGER: Timothy R. Cote, P.E.
 By
 Date
 By
 Date

 PDB
 07\25
 Checked
 DAM
 07\25

 PDB
 07\25
 In Charge of
 TRC
 07\25
 Designed Drawn

HNTB CORPORATION 82 Running Hill Road, Suite 201 South Portland, ME 04106 TEL (207) 774-5155 FAX (207) 228-0909




THE GOLD STAR **MEMORIAL HIGHWAY**

EMERGENCY REPAIRS FOREST AVENUE OVERPASS MAINTENANCE OF TRAFFIC

SIGN SUMMARY 1 OF 1

MTA PROJECT MANAGER: Lauren Fleming, P.E.

SHEET NUMBER: MOT-08

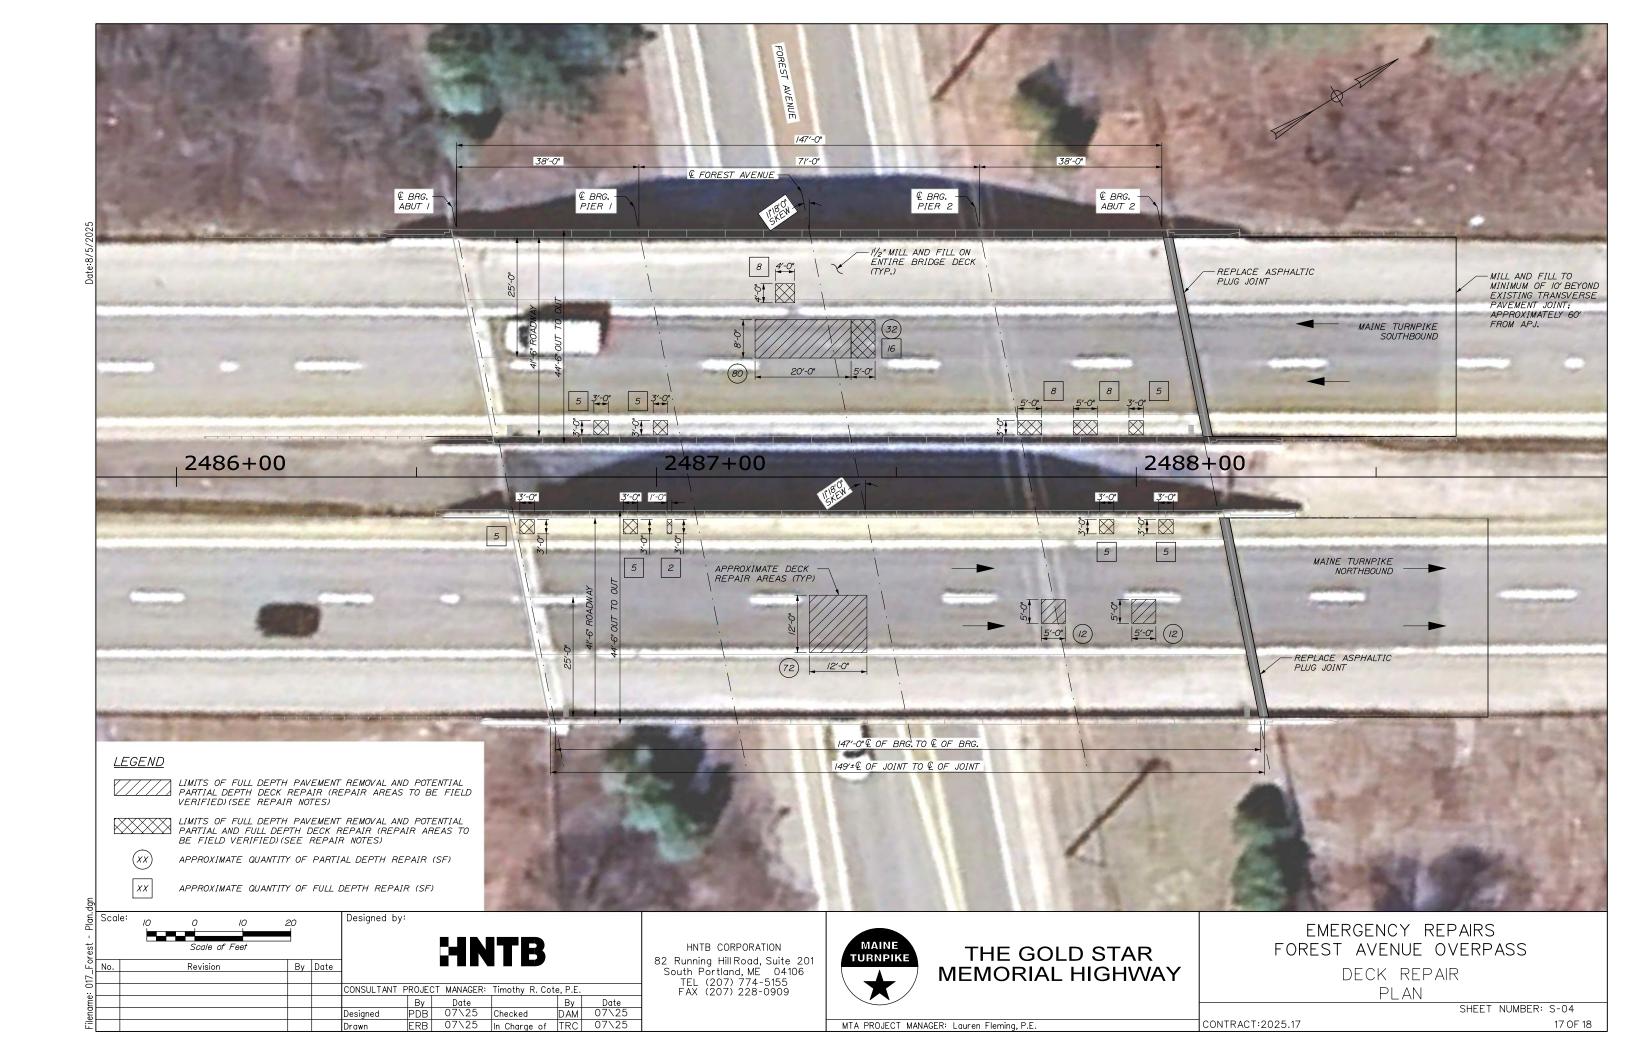

<u>LEGEND</u>

P.

PARTIAL DEPTH DECK REPAIRS



FULL DEPTH DECK REPAIRS

TRANSVERSE SECTION

(NB - LOOKING NORTH) (SB - LOOKING SOUTH)

GENERAL NOTES:

- I. ASSUMED AREAS OF PARTIAL AND FULL DEPTH DECK REPAIRS, AND ESTIMATED QUANTITIES FOR EACH REPAIR AREA, ARE INDENTIFIED IN PLAN VIEW ON THIS SHEET. THE AREAS OF FULL DEPTH PAVEMENT AND MEMBRANE REMOVAL ARE INTENDED TO PROVIDE ACCESS TO THE TOP OF DECK TO SUPPORT INSPECTION AND REPAIR. ACTUAL CONCRETE REPAIR LIMITS WILL BE DETERMINED IN THE FIELD BY THE RESIDENT FOLLOWING THE REMOVAL OF PAVEMENT AND MEMBRANE.
- 2. FULL DEPTH DECK REPAIR AREAS SHOWN ON THE PLAN ARE BASED ON VISUAL INSPECTION OF BOTH THE WEARING SURFACE AND THE UNDERSIDE OF THE DECK, WHERE SIGNIFICANT DETERIORATION IS OBSERVED ON BOTH SIDES, IF TOP SIDE INSPECTION DOES NOT CONFIRM THE NEED FOR FULL-DEPTH REPAIRS IN THE AREAS NOTED, THE CONTRATOR SHALL INSTEAD REPAIR ANY SIGNIFICANT CRACKING AND SPALLING FOUND ON THE UNDERSIDE OF THE DECK. THIS WORK WILL BE PAID UNDER PAY ITEM 518.70 REPAIR OF OVERHEAD SURFACES < 8 INCHES.
- 3. THE ROADWAY SHALL REMAIN CLOSED TO TRAFFIC UNTIL THE NEWLY PLACED CONCRETE REACHES A MINIMUM COMPRESSIVE STRENGTH OF 3,500 PSI. STRENGTH SHALL BE DETERMINED USING THE MANUFACTURER'S STRENGTH GAIN TABLES AND THE AMBIENT TEMPERATURE AT THE TIME OF PLACEMENT. CYLINDER TESTING WILL NOT BE REQUIRED.
- 4. ESTIMATED QUANTITIES FOR PARTIAL AND FULL DEPTH DECK REPAIRS INCLUDE A 50% CONTINGENCY TO ACCOMMODATE POTENTIAL ADDITIONAL AREAS REQUIRING REPAIR, OVERHEAD DECK REPAIR QUANTITIES ARE ASSUMED AND MAY BE ADJUSTED BASED ON FIELD CONDITIONS.
- 5. SHIELDING SHALL BE PROVIDED FOR ALL REPAIR LOCATIONS OVER LIVE TRAFFIC. SHIELDING SHALL EXTEND THE FULL BAY WIDTH UNDERNEATH THE REPAIR AND LONGITUDINALLY TO 3 FT BEYOND THE REPAIR.
- 6. CONTRACTOR SHALL PROVIDE THE NECESSARY SHIELDING TO PROTECT REMOVED CONCRETE AND NEWLY PLACED CONCRETE FROM ENTERING THE TRAVEL LANES AND SIDEWALKS OF FOREST AVENUE. SHIELDING FOR ANY FULL DPETH REPAIR OR UPWARD FACING REPAIR SHALL REMAIN IN PLACE. ALL SHIELDING TO REMAIN IN PLACE SHALL CONSIST ENITRELY OF DIMENSIONMAL LUMBER, AND THE CONTRACTOR SHALL SUBMIT WORKING DRAWINGS WHERE THE SHIELDING IS BRACED VERTICALLY TO THE UNDERSIDE OF THE BRIDGE DECK AND LONGITUDINALLY AGAINST DIAPHRAGM AND CONNECTION PLATES TO ENSURE THE SHEILDING DOES NOT SHIFT OR MOVE OVER TIME. PAYMENT SHALL BE INCIDENTAL TO RELATED CONTRACT

GENERAL NOTES (CONT.):


- SIDEWALKS SHALL REMAIN OPEN DURING CONSTRUCTION UNLESS APPROVED BY THE RESIDENT.
- ALL WORK SHALL BE ACCOMPLISHED USING THE CONSTRUCTION SEQUENCE PRESENTED IN THE MAINTENANCE OF TRAFFIC DETAILS AND THE SPECIFICATION.
- 9. PREFORM I INCH DEEP SAWCUTS ALONG LIMITS OF REMOVAL.
- IO. CHIP CONCRETE TO DEPTH SHOWN AND DESCRIBED IN SPECIFICATION 518.
- II. THE EXISTING WEARING SURFACE AND MEMBRANE SHALL BE REMOVED IN LOCATIONS IDENTIFIED ON SHEET S-04. THE RESIDENT SHALL IDENTIFY AREAS OF DECK REPAIRS BASED ON THE REQUIREMENTS IN SUPPLEMENTAL SPECIFICATION 518 AND DELINEATE AREAS OF THE REPAIR. THE AREAS OF REPAIR DELINEATED BY THE RESIDENT WILL INCLUDE OBVIOUS LOCATIONS OF DETERIORATION (I.E., EXPOSED REINFORCING, SPALLS, OR NOTABLE DETERIORATION). THIS PROJECT IS NOT INTENDED TO ADDRESS ALL AREAS OF DETERIORATION.
- 12. AFTER THE RESIDENT HAS DELINEATED THE REPAIR AREAS, THE CONTRACTOR AND RESIDENT SHALL AGREE ON THE REPAIR LIMITS. SHOULD THE REMOVAL AREA LIMITS CHANGE DURING THE REPAIR PROCESS, THE CONTRACTOR SHALL NOTIFY THE RESIDENT. THE RESIDENT AND CONTRACTOR SHALL AGREE ON THE REVISED PAY LIMITS PRIOR TO THE CONTRACTOR CONTINUING THE REMOVALS. WORK SHALL BE INCIDENTAL TO THE SPECIFIED REPAIR ITEMS IN SPECIFICATION 518.
- 13. PREPARE AND PATCH PARTIAL DEPTH AND FULL DEPTH REPAIR AREAS WITH RAPID SETTING CONCRETE SELECTED FROM THE MAINEDOT QUALIFIED PRODUCTS LIST FOR RAPID SET CONCRETE PATCH MATERIALS. SELECTED PRODUCT SHALL BE APPLICABLE FOR TRAFFIC LOADING AND SUBMITTED FOR APPROVAL TO THE RESIDENT. OVERHEAD REPAIR AREAS SHALL BE COMPLETED WITH A RAPID SETTING REPAIR MATERIAL SPECIFICALLY FORMULATED FOR OVERHEAD LOCATIONS. SEE SPECIFICATIONS FOR MATERIAL MATERIAL PREPERATION, PLACEMENT, AND CURING REQUIREMENTS.
- 14. ALL REPAIRS, WHETHER ON THE TOP OR BOTTOM SIDE OF THE BRIDGE DECK, SHALL EXTEND TO A MINIMUM OF LINCH BEHIND REINFORCING.
- 15. AREAS OF MEMBRANE REMOVAL SHALL BE REPAIRED WITH HIGH PERFORMANCE WATERPROOFING MEMBRANE APPLIED BY THE CONTRACTOR AREAS OF NEW MEMBRANE SHALL LAP THE EXISTING MEMBRANE BY AT LEAST 6 INCHES.

GENERAL NOTES (CONT.):

- IG.INSTALLATION OF THE BASE COURSE OF PAVEMENT OVER THE CONCRETE DECK REPAIRS MAY BE HAND OR MARCHINE PLACED.
- 17. EXISTING HIGH PERFORMANCE WATERPROOFING MEMBRANE
 SHALL BE REMOVED APPROXIMATELY 6" BEYOND THE DECK
 REPAIR AREA.
- 18. SEAL DECK SHOULDERS WITH TWO APPLICATIONS OF EMULSIFIED BITUMINOUS SEALER PER MDOT STANDARD SPECIFICATION 403.03 d AFTER COMPLETING ALL DECK PAVING WORK.

APJ NOTES:

- I. ASPHALTIC PLUG JOINT MATERIALS SHALL MEET THE REQUIREMENTS OF THE PROJECT SPECIFICATIONS AND SHALL BE INSTALLED IN ACCORDANCE WITH THE MANUFATURER'S RECOMMENDATIONS.
- 2. ASPHALTIC PLUG JOINTS SHALL BE INSTALLED AFTER THE SECOND LIFT OF PAVEMENT IS INSTALLED. CARE SHALL BE TAKEN BY THE CONTRACTOR TO AVOID DAMAGING THE MEMBRANE DURING JOINT INSTALLATION AS OUTLINED IN SPECIAL PROVISION SECITON 520.
- 3. THE JOINT AREA SHALL BE CLEANED IN ACCORDANCE WITH THE MANUFACTURER'S RECOMMENDATIONS.
- SAW CUT IN PAVMENT SHALL BE SEALED WITH EMULSIFIED ASPHALT SEALING COMPOUND CONFORMING TO SPECIFICATION 702.12.
- 5. IGD GALVANIZED CENTERING NAILS SHALL BE SPACED AT 12"O.C. MAXIMUM AND PLACED 2" FROM THE JOINTS IN THE BEARING PLATE
- 6. BACKER ROD SHALL BE CLOSED CELL FOAM IN ACCORDANCE WITH THE PROJECT SPECIFICATION. BACKER ROD SHALL BE SIZED AS REQUIRED TO FILL THE OPENING

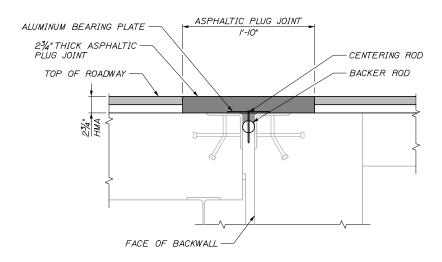

ASPHALTIC PLUG JOINT DETAIL

FOREST AVENUE BRIDGE NB & SB

NORTH ABUTMENT PROPOSED WORK

|//2" = |'-0"

Scale: AS NOTED No. Revision By Date CONSULTANT PROJECT MANAGER: Timothy R. Cote, P.E. By Date Designed PDB 07\25 Checked DAM 07\25 Drawn ERB 07\25 In Charge of TRC 07\25

HNTB CORPORATION 82 Running Hill Road, Suite 201 South Portland, ME 04106 TEL (207) 774-5155 FAX (207) 228-0909



THE GOLD STAR MEMORIAL HIGHWAY EMERGENCY REPAIRS FOREST AVENUE OVERPASS DECK REPAIR SECTIONS

SHEET NUMBER: S-05

MTA PROJECT MANAGER: Lauren Fleming, P.E.

SHEET NUMBER: 5-05

CONTRACT: 2025.17

18 OF 18