
MAINE TURNPIKE AUTHORITY

DANIEL E. WATHEN, CHAIR MICHAEL J. CIANCHETTE, VICE CHAIR JANE L. LINCOLN, MEMBER THOMAS J. ZUKE, MEMBER ANDREW J. MCLEAN, MEMBER BETTYANN SHEATS, MEMBER BRUCE A. VAN NOTE, MEMBER EX-OFFICIO

S. PETER MILLS, EXECUTIVE DIRECTOR

CONTRACT 2023.09 LITCHFIELD MAINTENANCE RESTROOM RENOVATION MILE MARKER 92.7

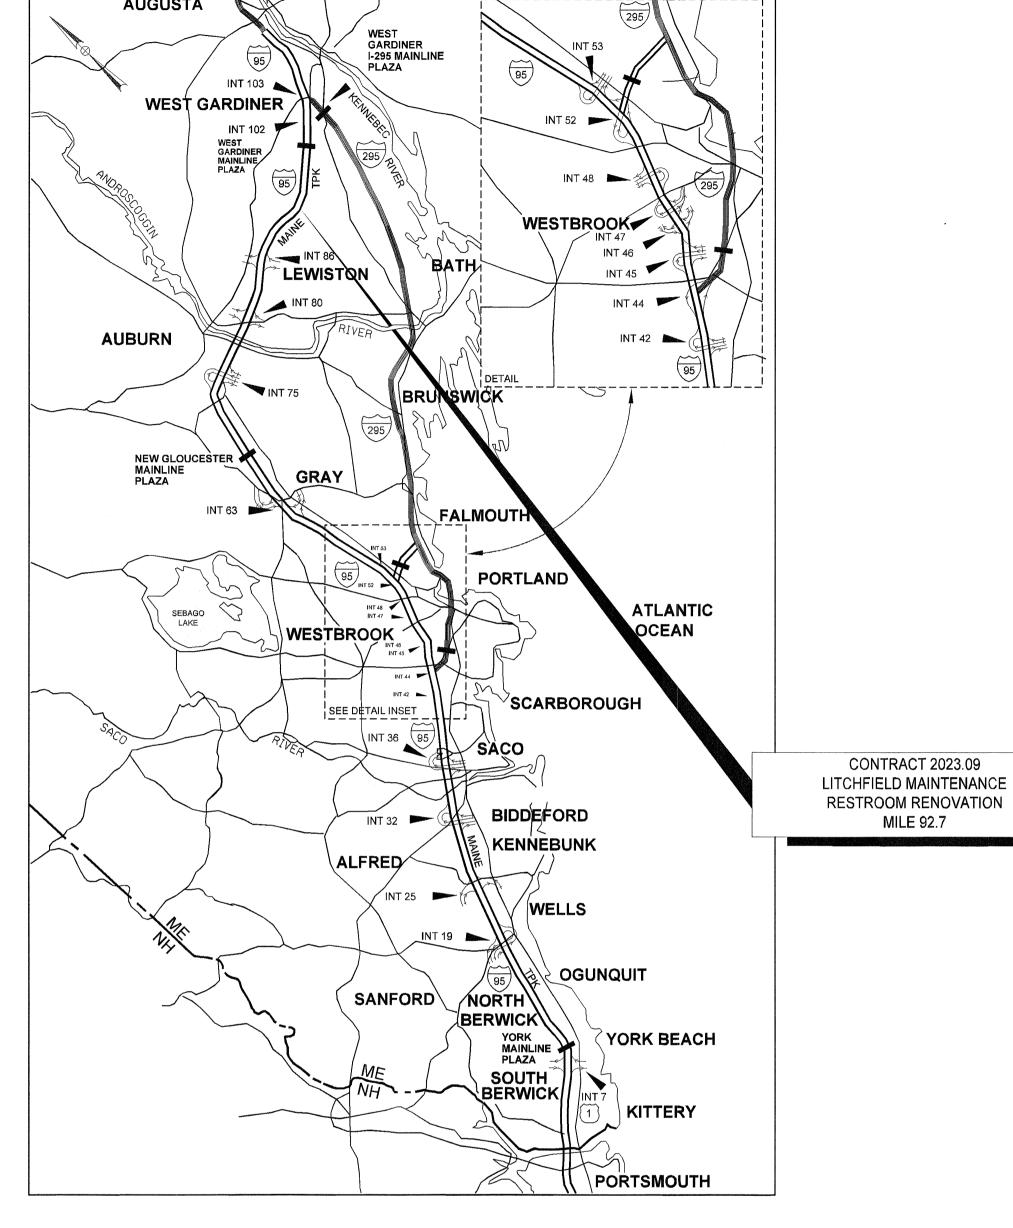

MILE 92.7

LOCATION MAP

HNTB

INDEX OF SHEETS ARCHITECTURAL COVER SHEET ACCESSIBILITY DETAILS & NOTES MECHANICAL SCHEDULES ELECTRICAL GENERAL NOTES **ELECTRICAL PLANS & SCHEDULES**

CODE ANALYSIS

None

None

20'

75'

200'

Not Required

Required

Required

Required

2 Hours

NFPA 101 Life Safety Code - 2021 Edition

Building Classification:

Business/Storage - 5,796 sf

Hazard Classification: Construction Type:

Ordinary Hazard Type III (000)

715 sf Business @ 150 sf/occupant = 5 occupants Occupant Loads: 5,081 sf Storage - 7 occupants (maximum probable)

Storage

Total Occupant Load = 12 occupants

Business

Building Uses Non-Sprinkled Building

200' 200' Max. Allowable Travel Distance: 75' Max. Allowable Common Path: 20' Max. Dead End Corridor Length: Minimum Number of Required Exits

0.5 diagonal' Minimum Separation of exits: 0.5 diagonal' 36" Minimum Egress Door Width:

Exit Lighting: Emergency Lighting: Fire Alarm System: Fire Sprinkler System:

Portable Fire Extinguishers:

Required Required Required Required Not Required Not Required Not Required Not Required Required Required

Interior Wall/Ceiling Finishes Class: Class A or B in Exits or Exit Corridors. Class A, B, or C in all other areas.

Class I or II in Exits or Exit Corridors. Interior Floor Finishes Class:

2018 International Building Code

Use Group Classification:

Business - Use Group B

Storage - Use Group S-1 Construction: Type IIIB - Non-Combustible, Unprotected

715 sf Business @ 150 sf/occupant = 5 occupants5.081 sf Storage @ 500 sf/occ = 11 occupantsOccupant Loads: Total Occupant Load = 16 occupants

Non-Sprinkled Building Limitations Construction Type:

Maximum Height: Maximum Area / Floor: IIB Unprotected 3 stories / 55' at B; 2 stories / 55' at S-1 19,000 sf at B; 17,500 sf at S-I

Not Required (less than 24,000 sf)

None; except 2 Hour at Stairs \$ Elevators (NA)

Fire Resistance Ratings

Primary Structural Frame Load Bearing Exterior Walls: Load Bearing Interior Walls:

Interior Non-Load Bearing Walls: Minimum Number of Exits: Maximum Dead-End Corridor Length: Maximum Common Travel Path: Maximum Travel Distance:

Fire Alarm System: Fire Sprinkler System: Portable Fire Extinguishers:

Exit Lighting Emergency Lighting

2018 International Building Code (cont.)

Building Live Loads

Offices:

125 psf @ light; 250 psf @ heavy Storage:

Interior Finish Requirements Business B - Non-Sprinkled

Exit enclosures/passageways Class A or B Corridors Class B Class C Rooms & enclosed spaces

Maine State Plumbing Code/UPC - 2015 Edition

Occupancy Classification: Business/Storage Occupancy Area: 5,796 sf gross I 6 per IBC Table Method Occupancy Load:

16 Occupants - 8 male \$ 8 female

Section 422.1 WATER CLOSET URINALS LAVS SHOWERS Male NR Female Total Required: Drinking Fountain: 1/150 Occupants - 1 Required

(or water station)

Service Sink: 1 Required

End of Analysis

ABBDEL/IATIONIC

GENERAL NOTES

MATERIALS

SYMBOLS

ROOM NUMBER

NFPA LEGEND

SYMBOL

DESCRIPTION

ABC FIRE EXTINGUISHER W/ BRACKET

		At	3BK	KEVIATION	15	
[AFF	ABOVE FINISH FLOOR	G	GRANITE	PB	PANIC BAR
	ALUM or AL AWP	ALUMINUM ACOUSTICAL WALL PANEL	GA GALV	ĞAÜĞE GALVANIZED	PL PLY WD	PLATE PLYWOOD
	BIT BM	BITUMINOUS BENCH MARK	GB GC	GRAB BARS GENERAL CONTRACTOR	PNL PS P.T.	PANEL PASSAGE LATCH SET PRESSURE TREATED
	BOT BRG	BOTTOM BEARING	GWB	GYPSUM WALL BOARD	PT	PAPER TOWEL \$ WASTE DISPENSER PARTITION
	BRK	BRICK	HC HD WD	HANDICAP HARDWOOD	PTN	PARTITION
	C CAB CB CC CH	CARPET CABINET	HDR HDWE	HEADER HARDWARE	RD RE	ROOF DRAIN REFER
	CB CC	CHALK BOARD CENTER TO CENTER CONCRETE FLOOR	HM HORIZ	HOLLOW METAL HORIZONTAL	REF REINF	REFRIGERATOR REINFORCED
		CONCRETE FLOOR WITH HARDENER	HT	HEIGHT	REQ'D	REQUIRED ROOM
	CL CLG	WITH HARDENER CONTROL JOINT CENTER LINE CELLING	ID IF	INSIDE DIAMETER INSIDE FACE INCHES	RM RO	ROUGH OPENING
	CJ CL CLG CMU CONC	CEILING CONCRETE MASONRY UNIT CONCRETE CONTINUOUS	IN INSUL	INSULATION	S SAT	SOUTH SUSPENDED ACOUSTICAL
	CONT CONST CONTR	CONTINUOUS CONSTRUCTION CONTRACTOR CERAMIC TILE	INT	INTERIOR	SC	TILE CEILING SHOWER CURTAIN
	CT	CERAMIC TILE	JNT or J		SD	SOAP DISPENSER
	DBL DC	DOUBLE DOOR CLOSER	KEC	KITCHEN EQUIPMENT CONSULTANT	SCHED SECT	SCHEDULE SECTION
	DIA DIM	DIAMETER DIMENSION	KP	KICK PLATE LAVATORY	SGB	SUSPENDED GYPSUM BOARD CEILING
	DNA DR	DOES NOT APPLY DOOR	LAB	LABEL (FIRE)	SHT SIM	SHEET SIMILAR
	DTL DWG	DETAIL DRAWING	LNTL LOC	LINTEL LOCATION	SND SPEC	SANITARY NAPKIN DISPOSAL SPECIFICATIONS
		EAST	LS	LOCKSET MARBLE	5Q 555	SQUARE SYNTHETIC SPORTS SURFACE
	E EA EF	EACH EACH FACE	M MAS	MASONRY	STD STL	STANDARD STEEL
	EJ EL	EXPANSION JOINT ELEVATION	MAX MB MECH	MAXIMUM MARKER BOARD	STRUCT STV	
	EL ELEC ELEV	ELECTRICAL ELEVATOR ELECTRONA CNIETIC	MFGR	MECHANICAL MANUFACTURER	SV	SHEET VINYL
	EMHO	ELECTROMAGNETIC HOLD OPEN EQUAL	MIN MISC MO	MINIMUM MISCELLANEOUS MASONRY OPENING	T TB	TEMPERED (GLASS) TACK BOARD
	EQ EW EWC	EACH WAY ELECTRIC WATER COOLER	MR MRGB	MOP OPENING MOISTURE RESISTANT	TH THK	THERMAL (INSULATED) THICKNESS
	EXIST OF (E)	EXISTING EXPANSION	NATI	GYPSUM BOARD	TO TOB	TOP OF BEAM

NOT APPLICABLE

NOMINAL NOT TO SCALE

NUMBER

OPPOSITE

PAINT PAINTED

Drawn

OPNG

OPP

PTD

NOT IN CONTRACT

OVERALL
ON CENTER
OUTSIDE DIAMETER
OUTSIDE FACE
OPENING

Designed by:

Michael F. Hays, RA

EXPANSION

FLOOR DRAIN

FINISH GRADE

FIRE RATING

FRAMING

FOUNDATION FIRE EXTINGUISHER

FLOOR COATING SYSTEM

FINISH FLOOR ELEVATION

FABRIC WALL COVERING

EXTERIOR

FIN FL OR FINISH FLOOR

FD

FDN

FRMG

No.

Scale: NO SCALE

- ALL WORK SHALL CONFORM TO LOCAL AND STATE LAWS. ORDINANCES AND PREVAILING EDITIONS OF ADOPTED BUILDING CODES. IT IS THE CONTRACTOR'S RESPONSIBILITY TO SECURE ALL PERMITS FOR WORK.
- THE CONTRACTOR SHALL VERIFY ALL CONDITIONS AND DIMENSIONS PRIOR TO COMMENCING THE WORK AND REPORT ANY DISCREPANCIES TO THE ARCHITECT. CONTRACTOR SHALL PROCEED WITH THE WORK ONLY AFTER SUCH DISCREPANCIES HAVE BEEN RESOLVED BY THE ARCHITECT. CONTRACTOR SHALL ALLOW A 48 HOUR TIME FRAME FOR RESOLVING DISCREPANCIES ONCE THE ARCHITECT HAS ACKNOWLEDGED THE CONDITION.
- 3. THE CONTRACTOR SHALL REVIEW AND VERIFY ALL EXISTING CONDITIONS PRIOR TO STARTING THE WORK IN ANY GIVEN AREA.
- 4. WORK WITH GIVEN DIMENSIONS AND LARGE SCALE DETAILS. DO NOT SCALE THE DRAWINGS AS THE REPRODUCTIVE PROCESS TENDS TO DISTORT THE ACCURACY OF THE GRAPHIC SCALE INDICATED.
- ALL CONSTRUCTION ACTIVITIES SHALL BE PERFORMED IN A NEAT, SAFE, AND CLEAN MANNER. ALL CONSTRUCTION WASTE SHALL BE REMOVED FROM THE BUILDING. SITE BURNING IS NOT ALLOWED. LEAVE WORK AREA IN A CLEAN, SAFE CONDITION AT THE END OF EACH WORK
- ALL CONSTRUCTION DEBRIS SHALL BE DISPOSED OF AT AN APPROVED OFF-SITE FACILITY IN COMPLIANCE WITH ALL REGULATIONS.
- ALL WOOD IN CONTACT WITH MASONRY OR CONCRETE SHALL BE PRESERVATIVE TREATED.
- 8. INSTALL SOLID BLOCKING AT WALL FRAMING BEHIND ALL SURFACE MOUNTED ITEMS.
- REFER TO THE ACCESSIBILITY DETAIL SHEET FOR AMERICANS WITH DISABILITIES ACT (ADA) AND MAINE HUMAN RIGHTS ACT (MRHA) CONSTRUCTION CRITERIA.

GRANT HAY/

, 4 , 4 , 4 ,	CONCRETE
	CONCRETE MASONRY UNIT
	BRICK
	GRAVEL
	SOII

- STUD PARTITION (EXISTING) STEEL
- WOOD FRAMING
- - WOOD BLOCKING




PLYWOOD




GYPSUM BOARD SUSPENDED ACOUSTICAL TILE



BATT INSULATION

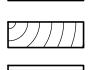

RIGID INSULATION FINISH WOOD

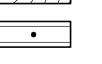


ONE HOUR RATED PARTITION



• •

TWO HOUR RATED PARTITION EXISTING PARTITION (SCREENED)

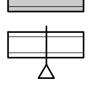

NEW PARTITION

	DOOR NUMBER
A	WINDOW NUMBER
A A7	BUILDING SECTION
A20	WALL SECTION
BAIO	DETAIL SECTION
6-A9	CASEWORK ELEVATION
22/6	INTERIOR ELEVATION
—	- VERTICAL ELEVATION
	PARTITION TYPE

EGRESS SYMBOLS LEGEND

STRUCTURAL CENTERLINE

DIAGONAL DISTANCE EGRESS SEPARATION EGRESS PATH

RESTROOM UPGRADES LITCHFIELD MAINTENANCE YARD ARCHITECTURAL COVER SHEET

SHEET NUMBER: A-0

MTA PROJECT MANAGER: BRIAN TADDEO, P.E.

MAINE TURNPIKE

THE GOLD STAR MEMORIAL HIGHWAY

By Date Revision Michael F. Haus ASSOCIATES CONSULTANT PROJECT MANAGER: TIM COTE, P.E. HNTB ARCHITECTURE & INTERIOR DE/IGN By By Date P.O. BOX 6179 FALMOUTH MAINE 04105 Date 09/11/23 09/11/23 Designed Checked MFH

09/11/23

TOM

VB VCT VERT VWC

WC WD WF

TOP OF BEAM

TOP OF WALL

WATER CLOSET

WOOD WATER FOUNTAIN

WIRE GLASS WOOD PANELING

In Charge of

TOP OF MASONRY


TOILET PAPER DISPENSER


VAPOR BARRIER VINYL COMPOSITION TILE VERTICAL VINYL WALL COVERING


MICHAELF. HAYS No. 1724


207.871.5900 <u>www.granthays.com</u> GHA PROJECT NO. 221124

2 OF 12 CONTRACT: 2023.09

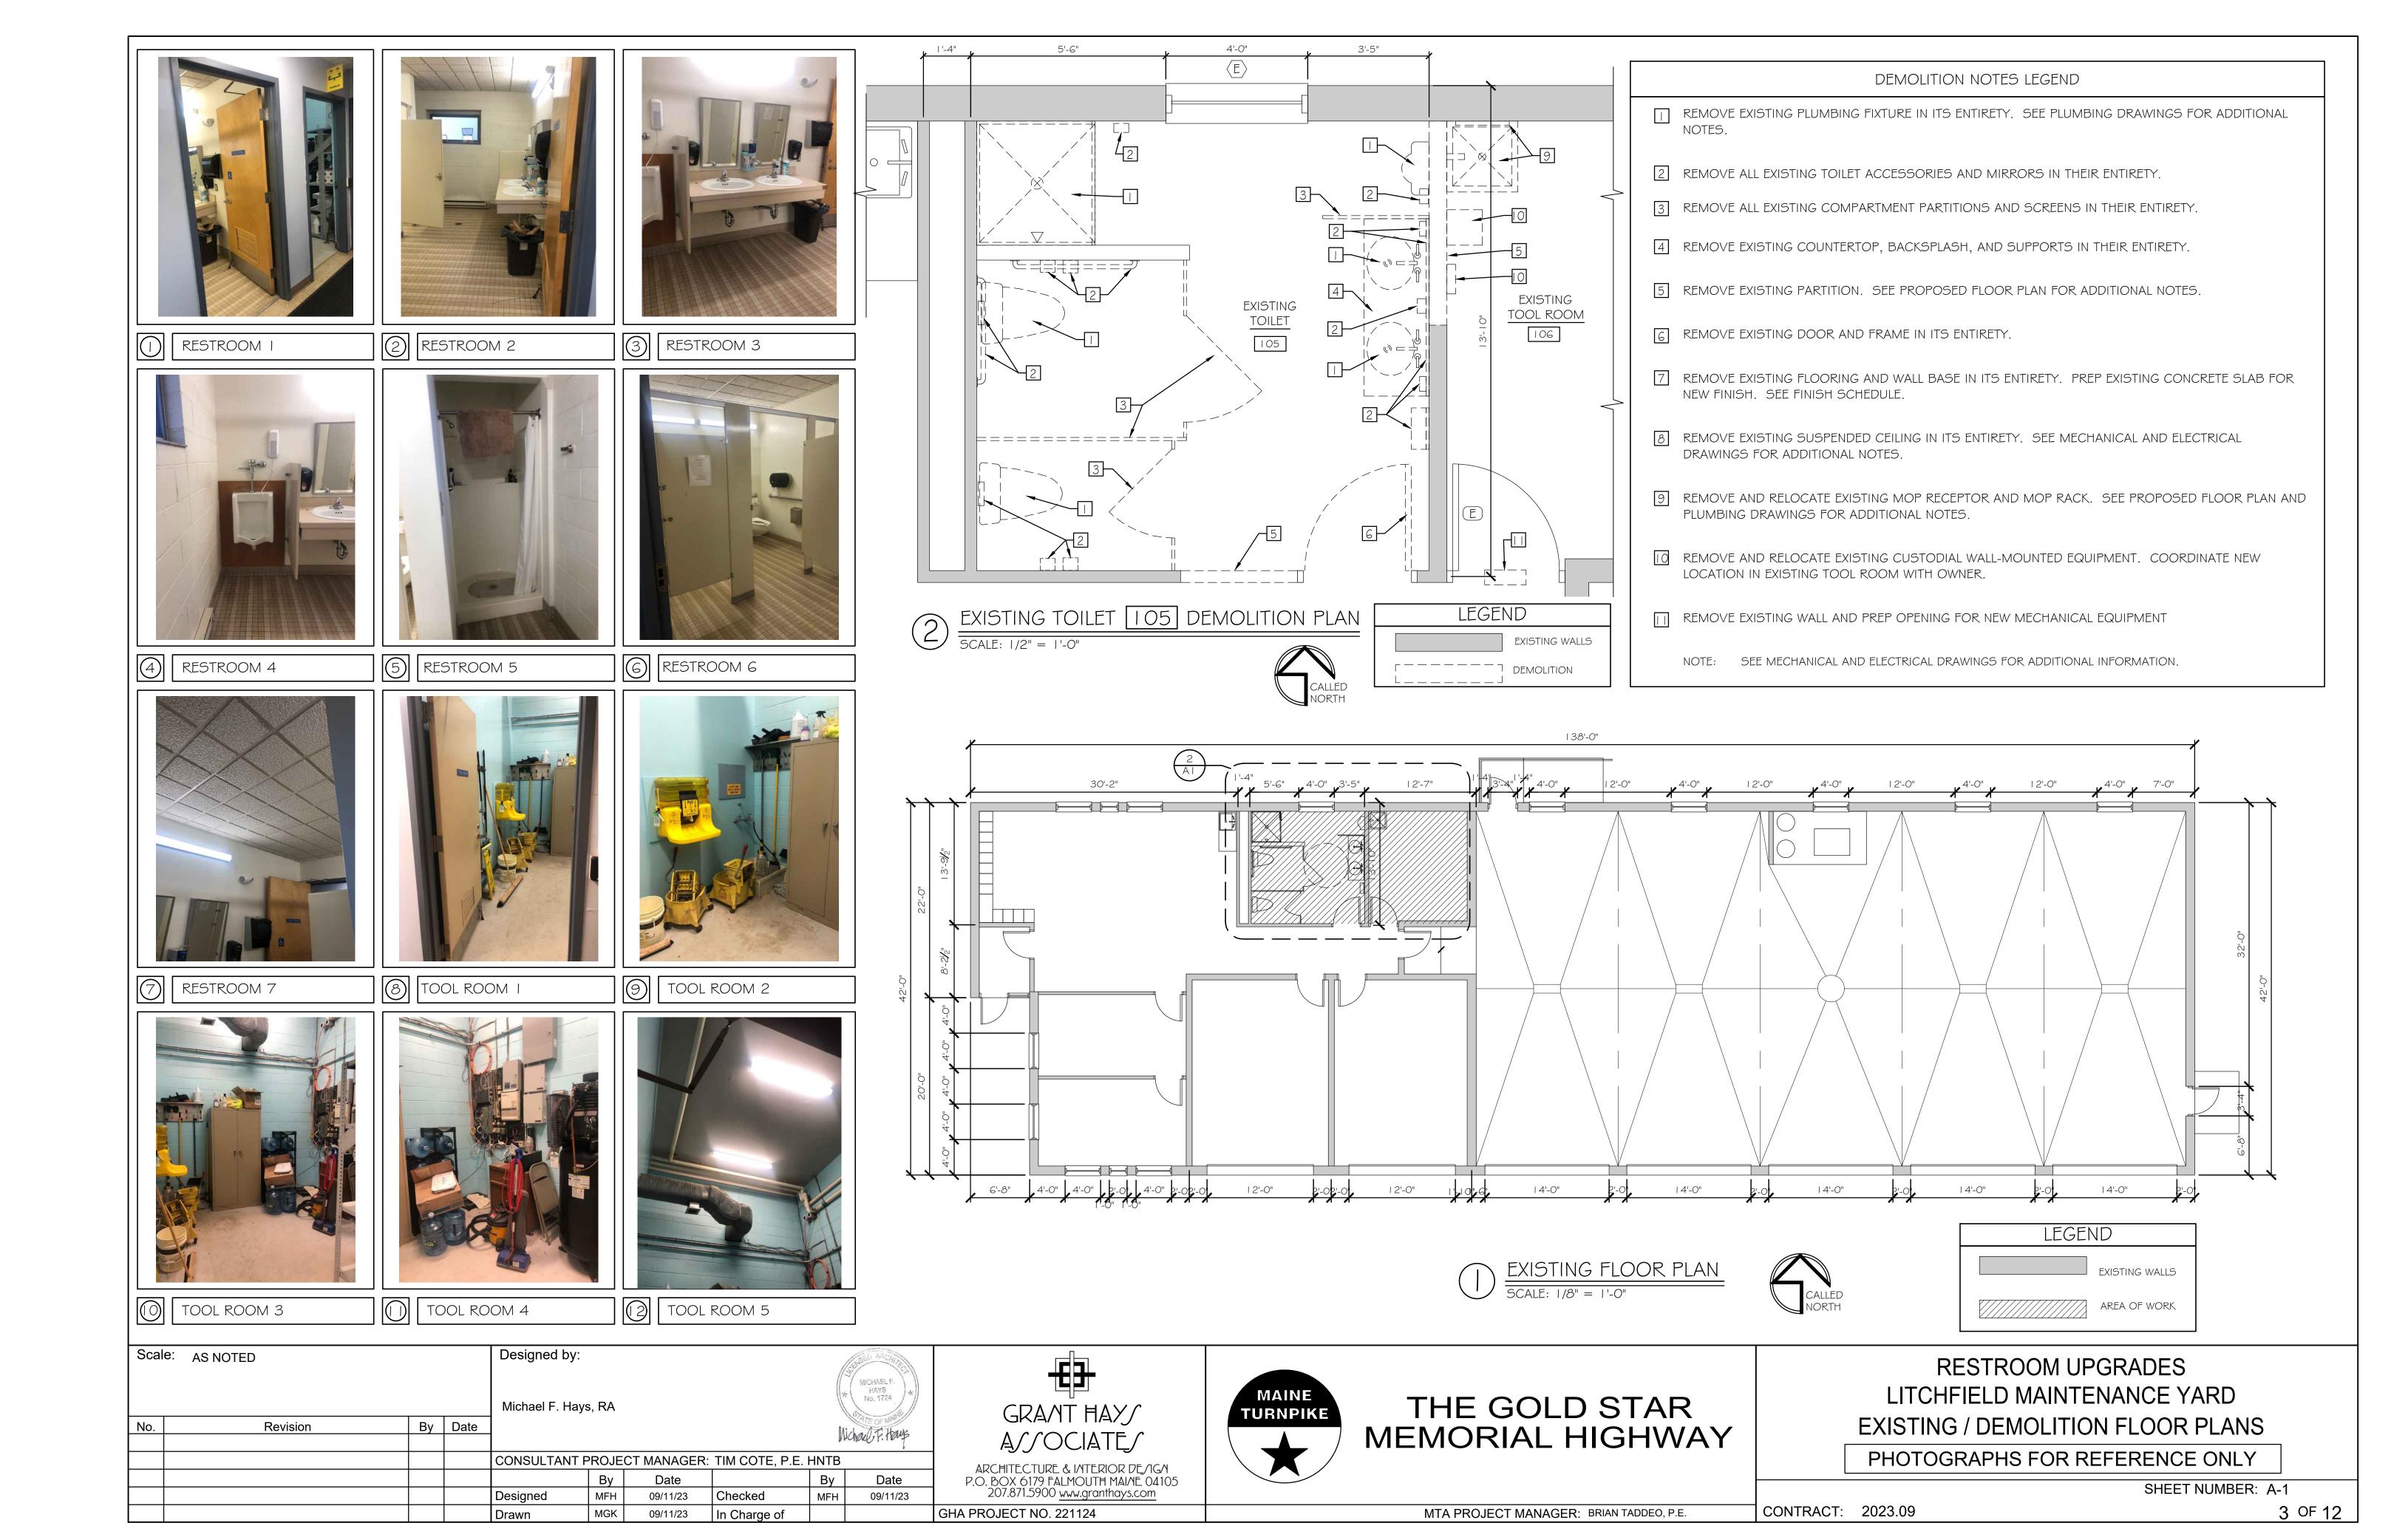

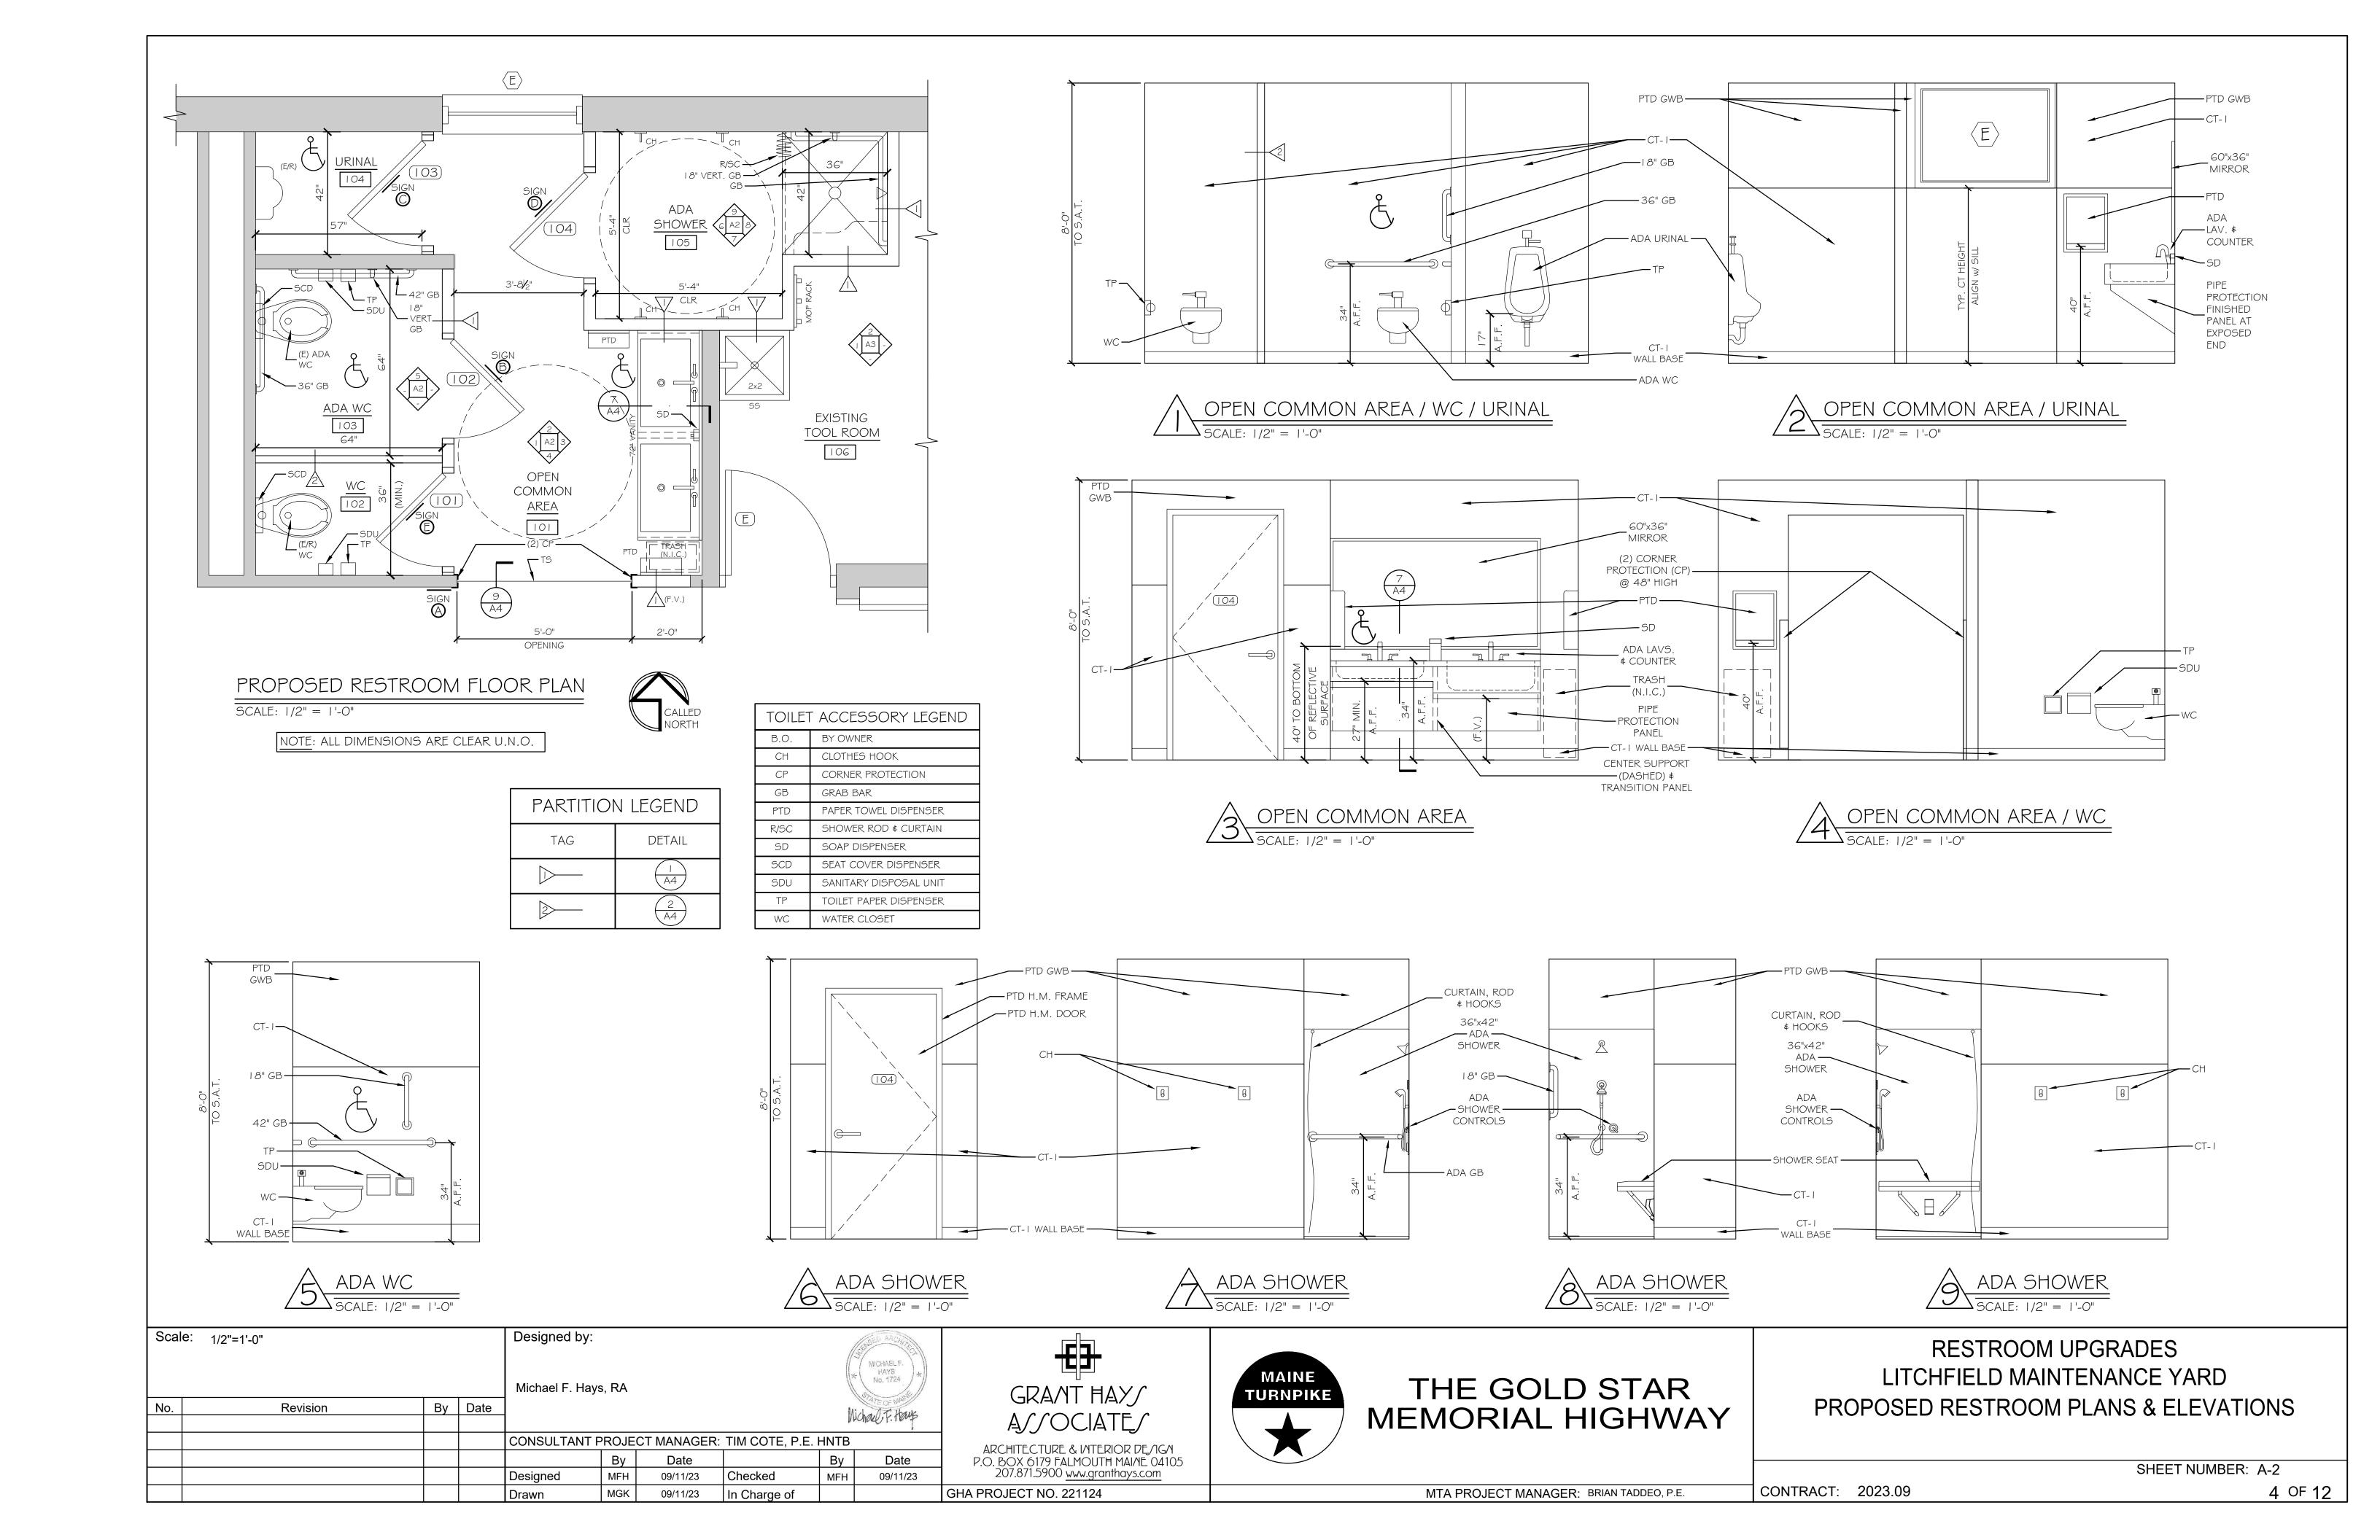

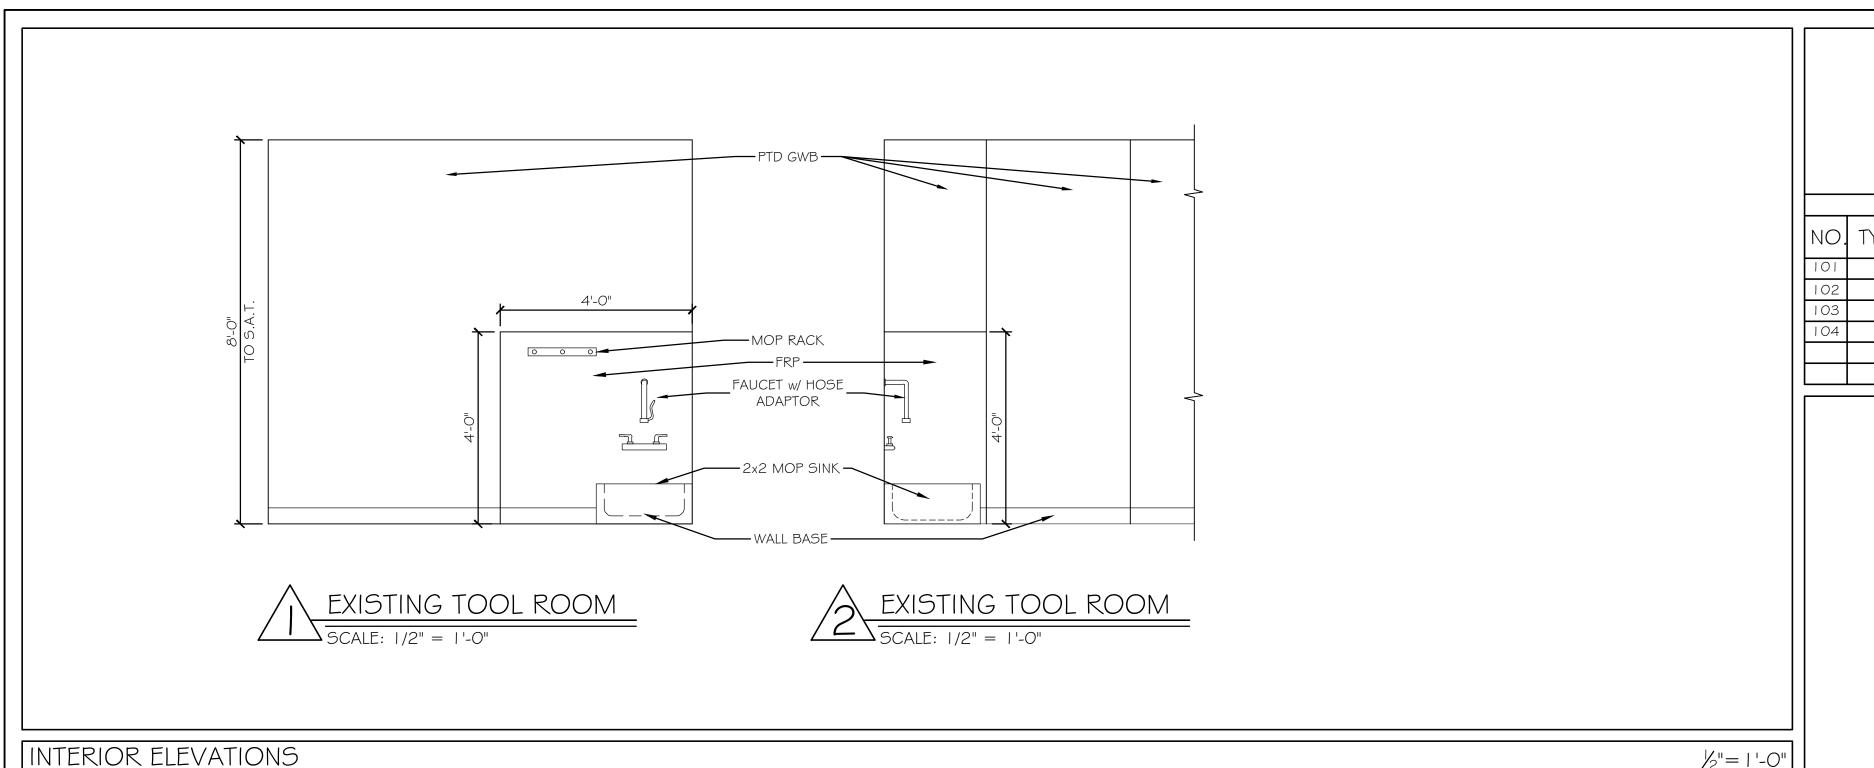

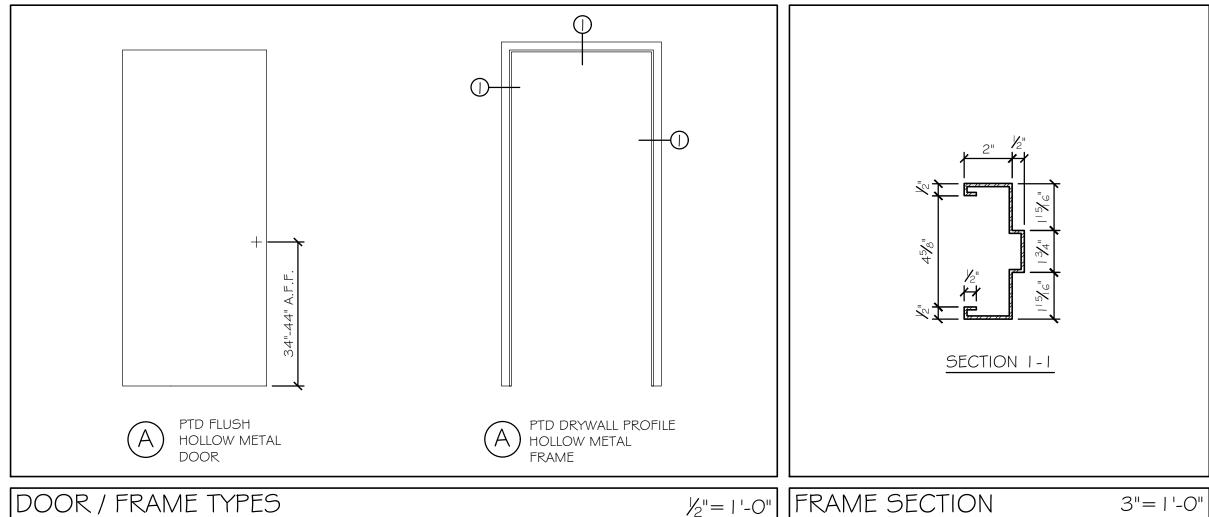

DOOR SCHEDULE

DOORS


HW-I

2870

3070

½"= | '-0'

| 3/4"

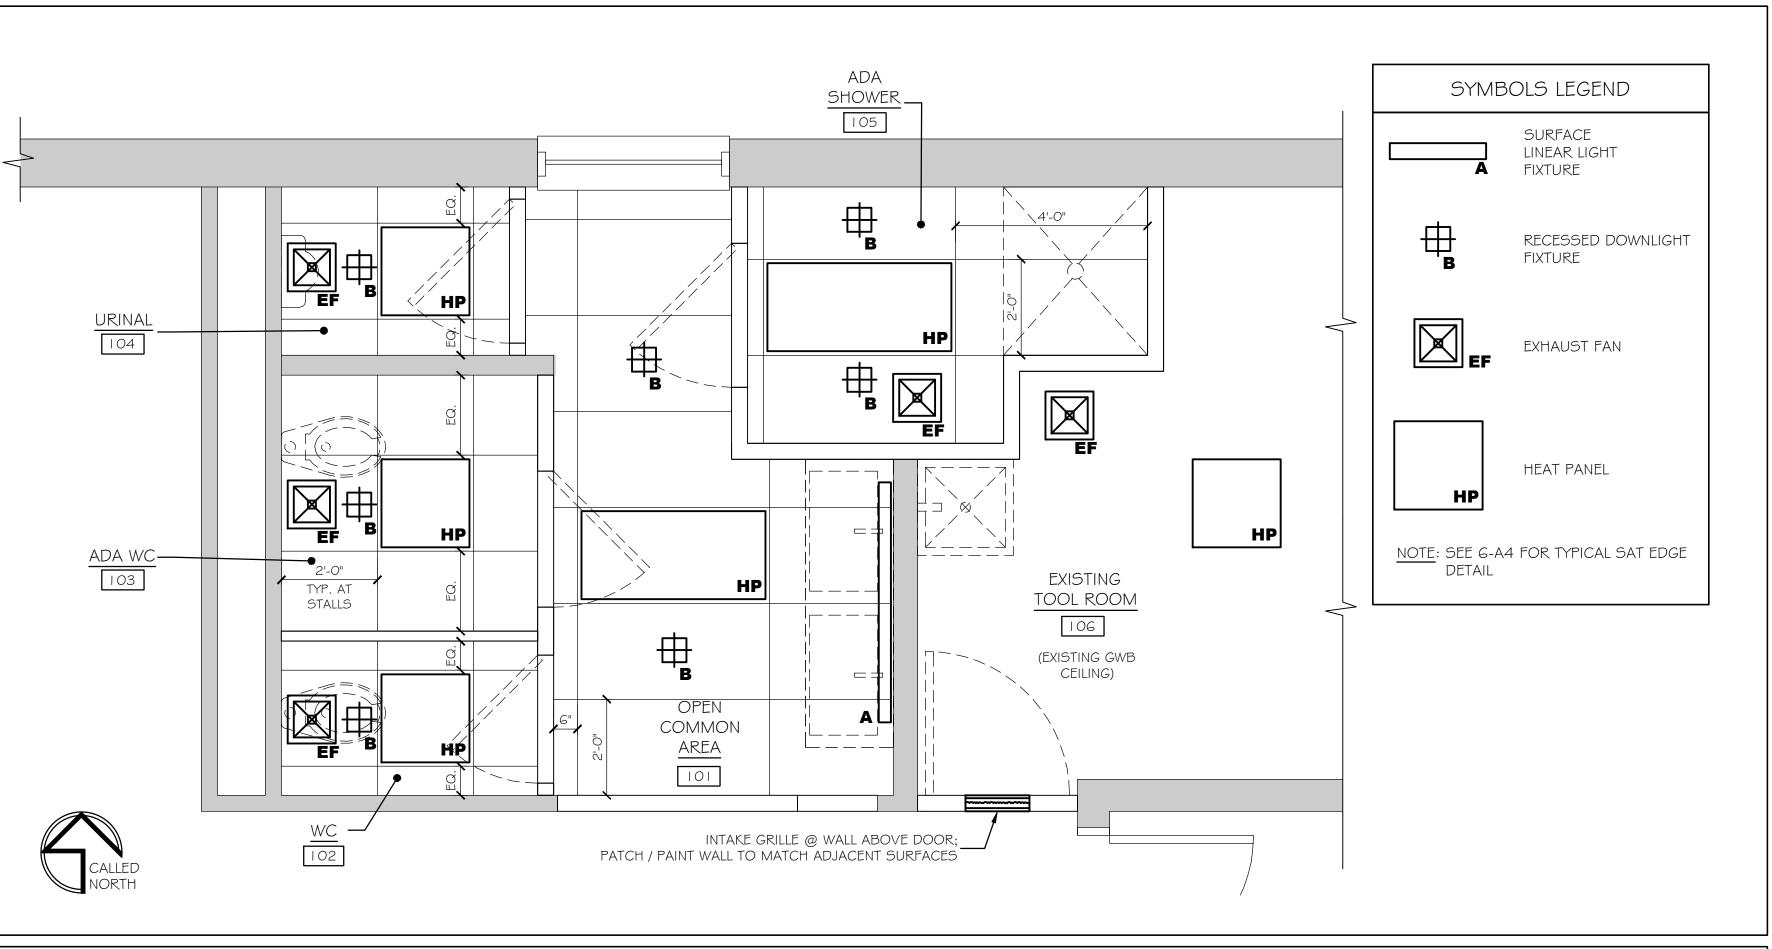

	F	INISH SCHE	EDUL	E.		DF E FV GL GW	EX FIE GL	RY FALL I ISTING ELD VERI ASS PSUM W		A RD	RB RUBBER BASE RT RUBBER TILE SAT SUSPENDED ACOUSTICAL TILE VB VINYL BASE					
	RM	NAME		WAL	LS			FLO	ORS		CE	ILING A	CEILI	NG B	REMARKS	
l L	NO.	·	N	E	5	W	MAT'L	BASE	MAT'L	BASE	TYPE	HT.	TYPE	HT.		
	101	OPEN COMMON AREA	P/CT-I	P/CT-I	P/CT-I	P/CT-I	CT-2	CT-1			SAT	E	—			
	102	WC	P/CT-I	P/CT-I	P/CT-I	CT-I	CT-2	CT-1			SAT	E	_			
	103	ADA WC	P/CT-I	P/CT-I	P/CT-I	CT-1	CT-2	CT-1			SAT	E				
	104	URINAL	P / CT-1	P / CT-1	P / CT-1	CT-I	CT-2	CT-I			SAT	E				
	105	ADA SHOWER	P/CT-I	P / CT-1	P / CT-1	P / CT-1	CT-2	CT-1			SAT	E				
	106	EXIST. TOOL ROOM	P / FRP			P / FRP	E	VB*			E	E			*NEW WALLS	
-																

CERAMIC TILE

REF	FLECTED CEILING PLAN									
Scale	AS NOTED			Designed by:					MSED ARCHITE	
No.	Revision	Ву	Date	Michael F. Hay	rs, RA			(*) Mai	MICHAEL F. HAYS NO. 1724 STATE OF MINISTER Charle F. Hays	GRANT HA
									Charle F. Hemp	A//OCIA ⁻
				CONSULTANT	PROJE	CT MANAGER	: TIM COTE, P.E.	. HNTB		ARCHITECTURE & INTERI
					Ву	Date		By	Date	P.O. BOX 6179 FALMOUTH
				Designed	MFH	09/11/23	Checked	MFH	09/11/23	207.871.5900 <u>www.grant</u>
				Drawn	MGK	09/11/23	In Charge of			GHA PROJECT NO. 221124





½"= | '-O"

RESTROOM UPGRADES LITCHFIELD MAINTENANCE YARD INTERIOR ELEVATIONS, REFLECTED CEILING PLAN, SCHEDULES & DETAILS

SHEET NUMBER: A-3 CONTRACT: 2023.09 5 OF 12

ABBREVIATIONS

DETAILS

3-A5 4-A5

3-A5 4-A5

DW 3-A5 4-A5

3-A5

INSULATED

MASONRY

NONE

NONE

TEMPERED

TRANSITION STRIP

THRESHOLDS

– 5-A5

ALUM AL ALUMINUM

DRYWALL

HOLLOW METAL


FRAMES


DW

ABBREVIATIONS

P PAINT


HARDWARE

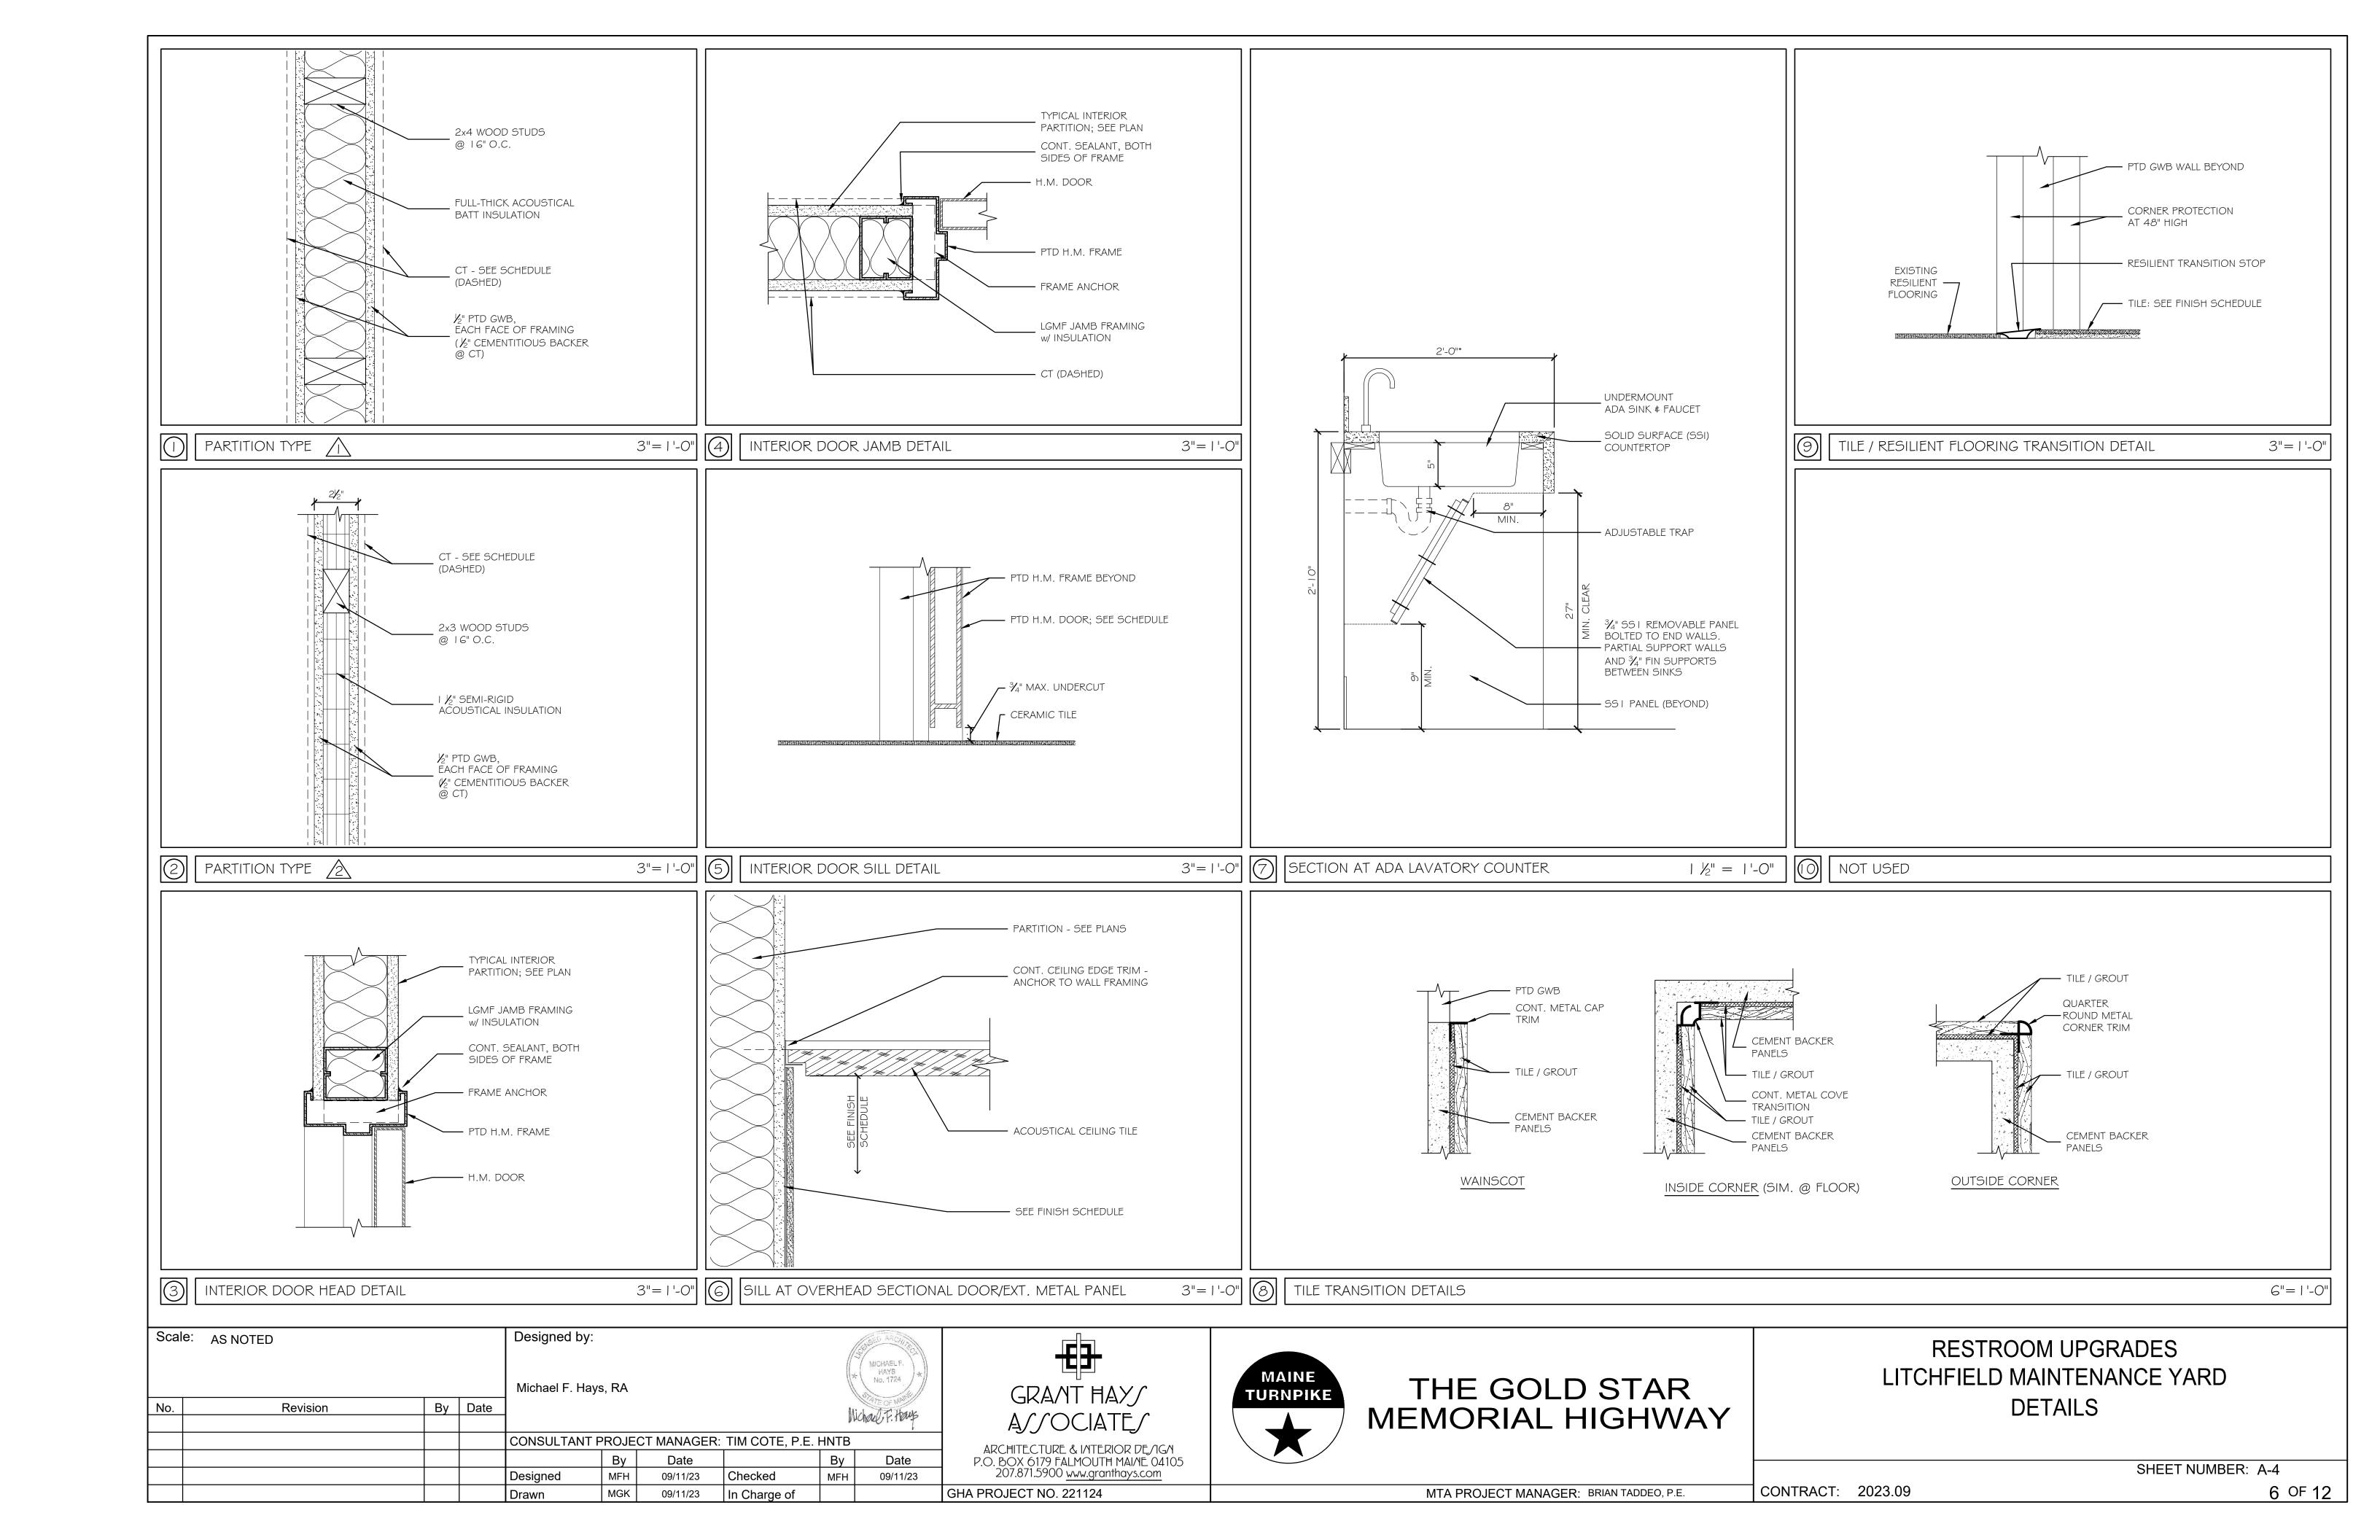

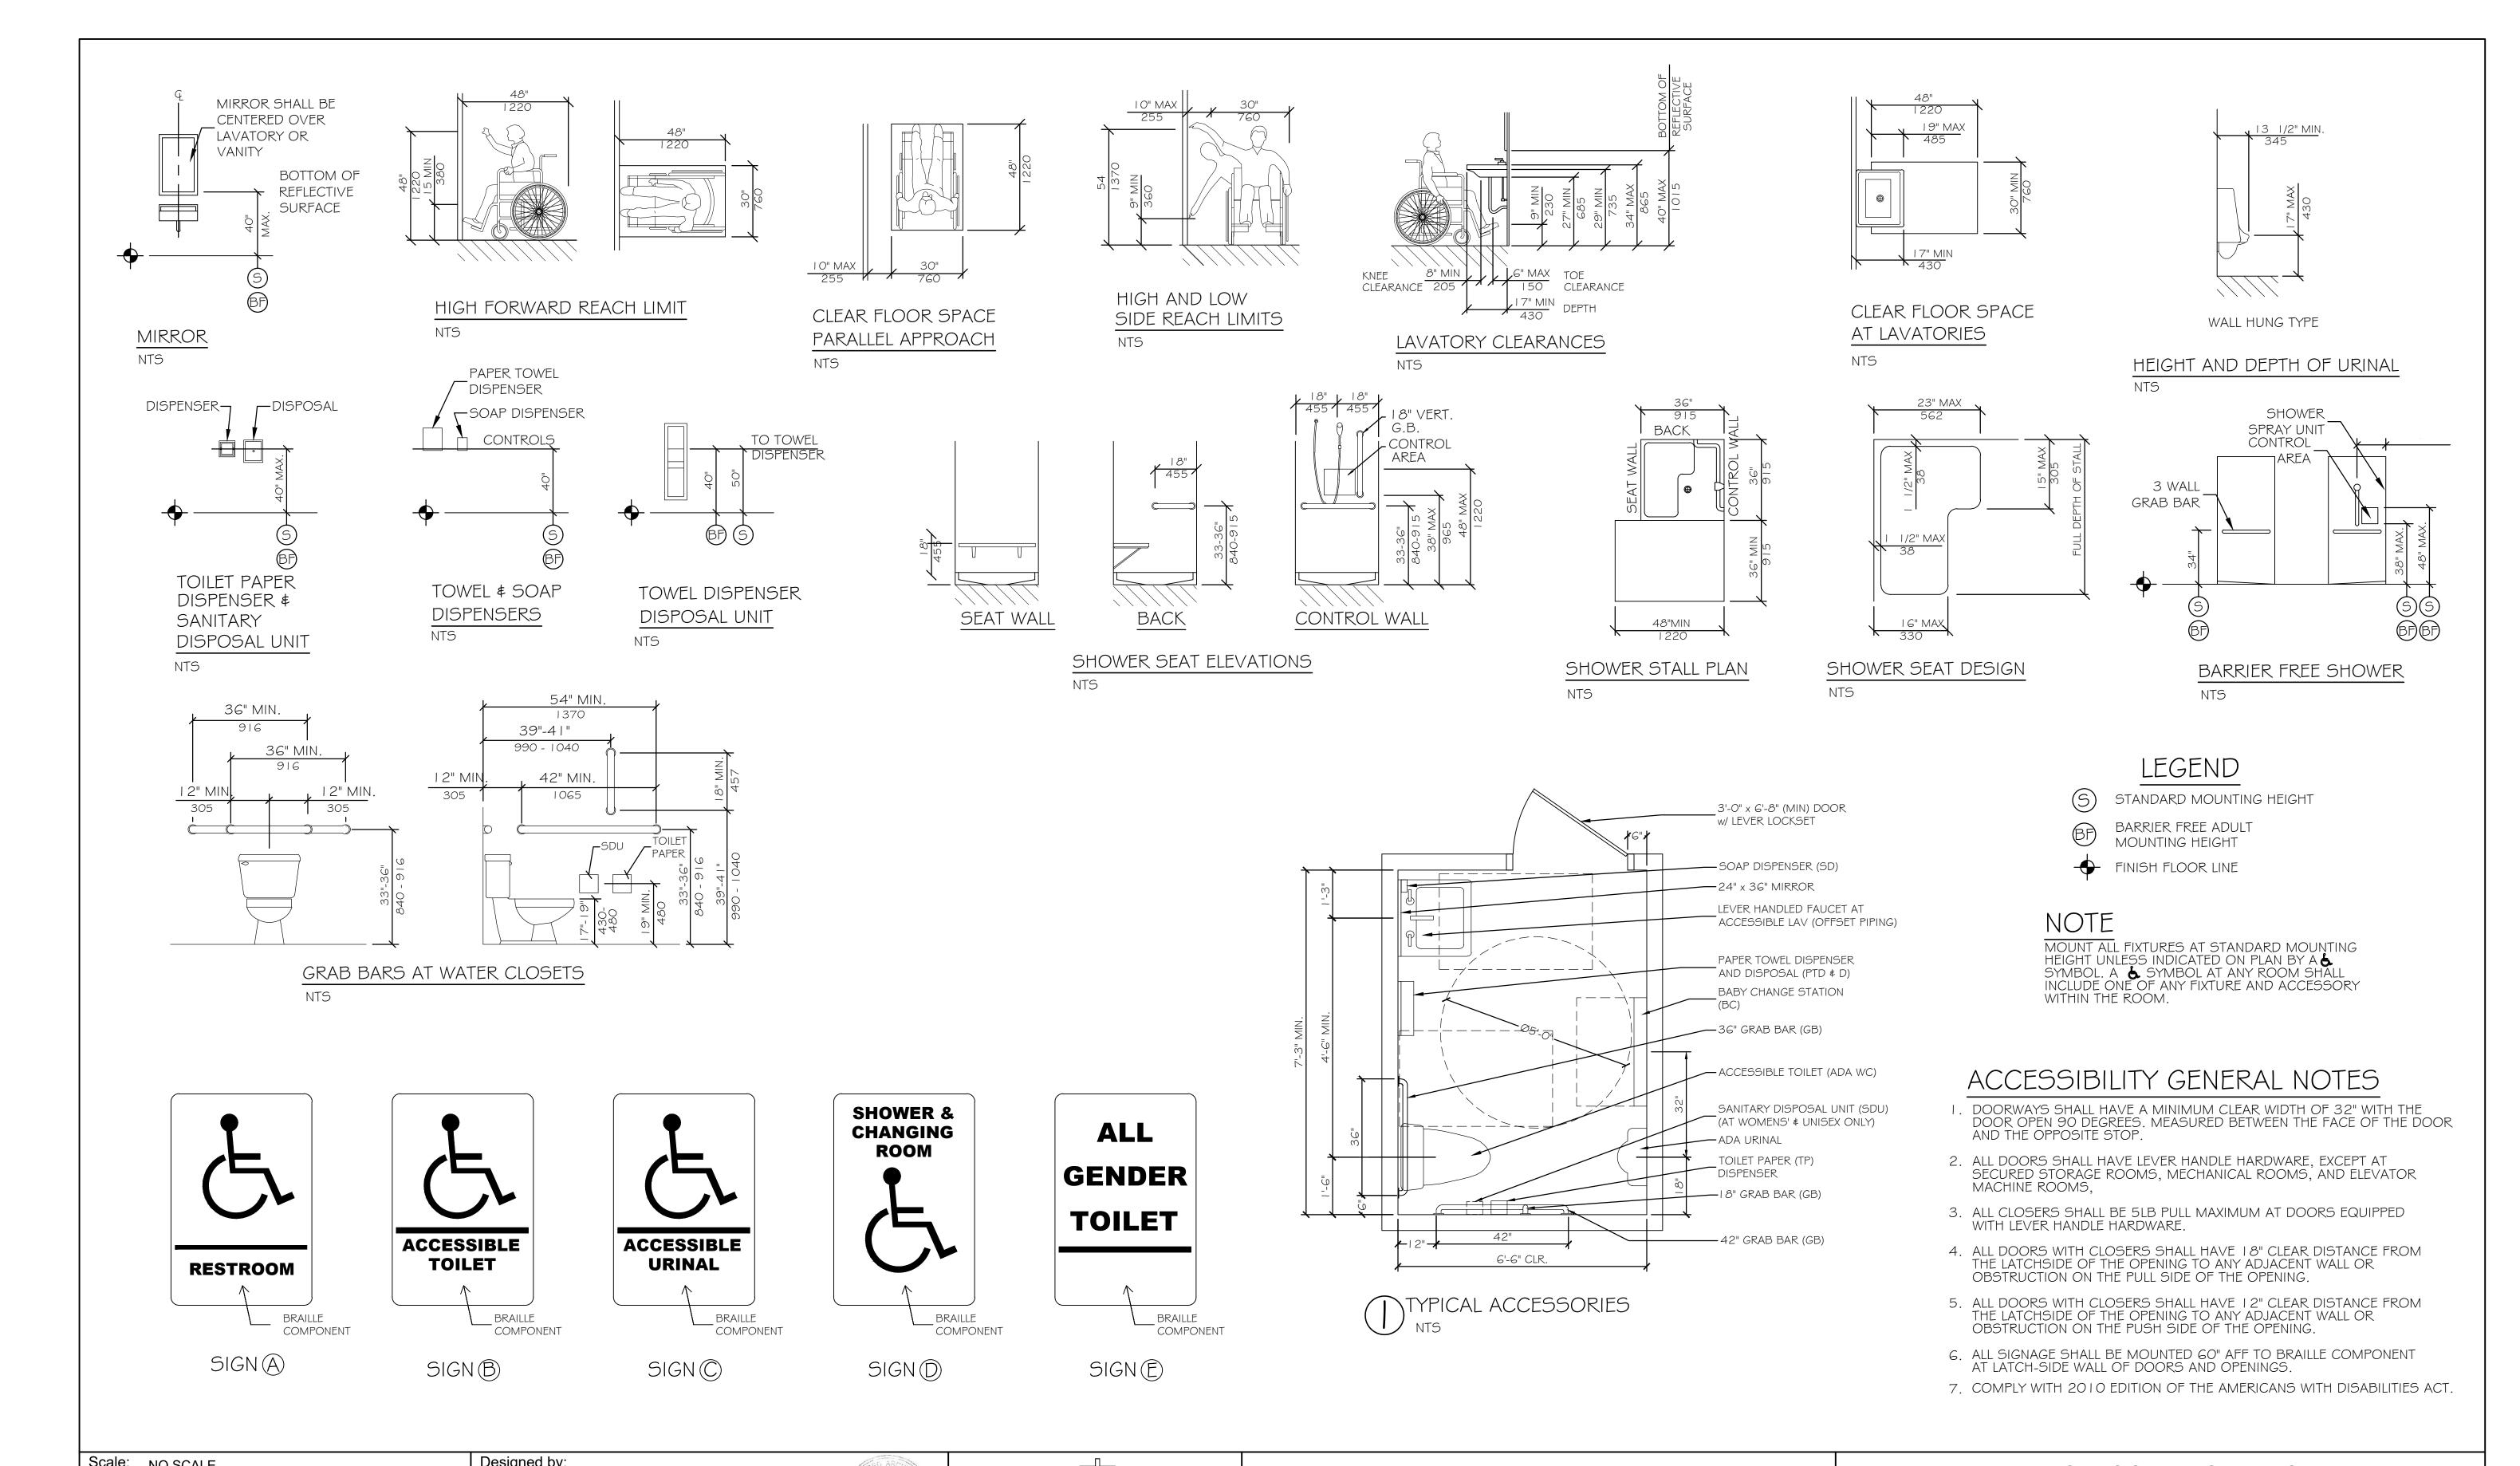

Julia	IE. NO SCALE			Designed by.				//	STREET ANCHURE	
									MICHAEL F. HAYS No. 1724	
No	Davision	T Dv	Data	Michael F. Hay	s, RA			//	OF THE OF MARKE	GRAMT HA
No.	Revision	By	Date	-			ichael F. Haus	A//OCIAT		
				CONSULTANT F	PROJE	CT MANAGER	: TIM COTE, P.E.	HNTB	V	ARCHITECTURE & INTERI
					Ву	Date		Ву	Date	P.O. BOX 6179 FALMOUTH
				Designed	MFH	09/11/23	Checked	MFH	09/11/23	207.871.5900 <u>www.grant</u>
				Drawn	MGK	09/11/23	In Charge of			GHA PROJECT NO. 221124



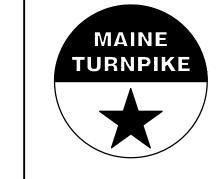


THE GOLD STAR MEMORIAL HIGHWAY

RESTROOM UPGRADES LITCHFIELD MAINTENANCE YARD **ACCESSIBILITY DETAILS & NOTES**

SHEET NUMBER: A-5

MTA PROJECT MANAGER: BRIAN TADDEO, P.E.

CONTRACT: 2023.09

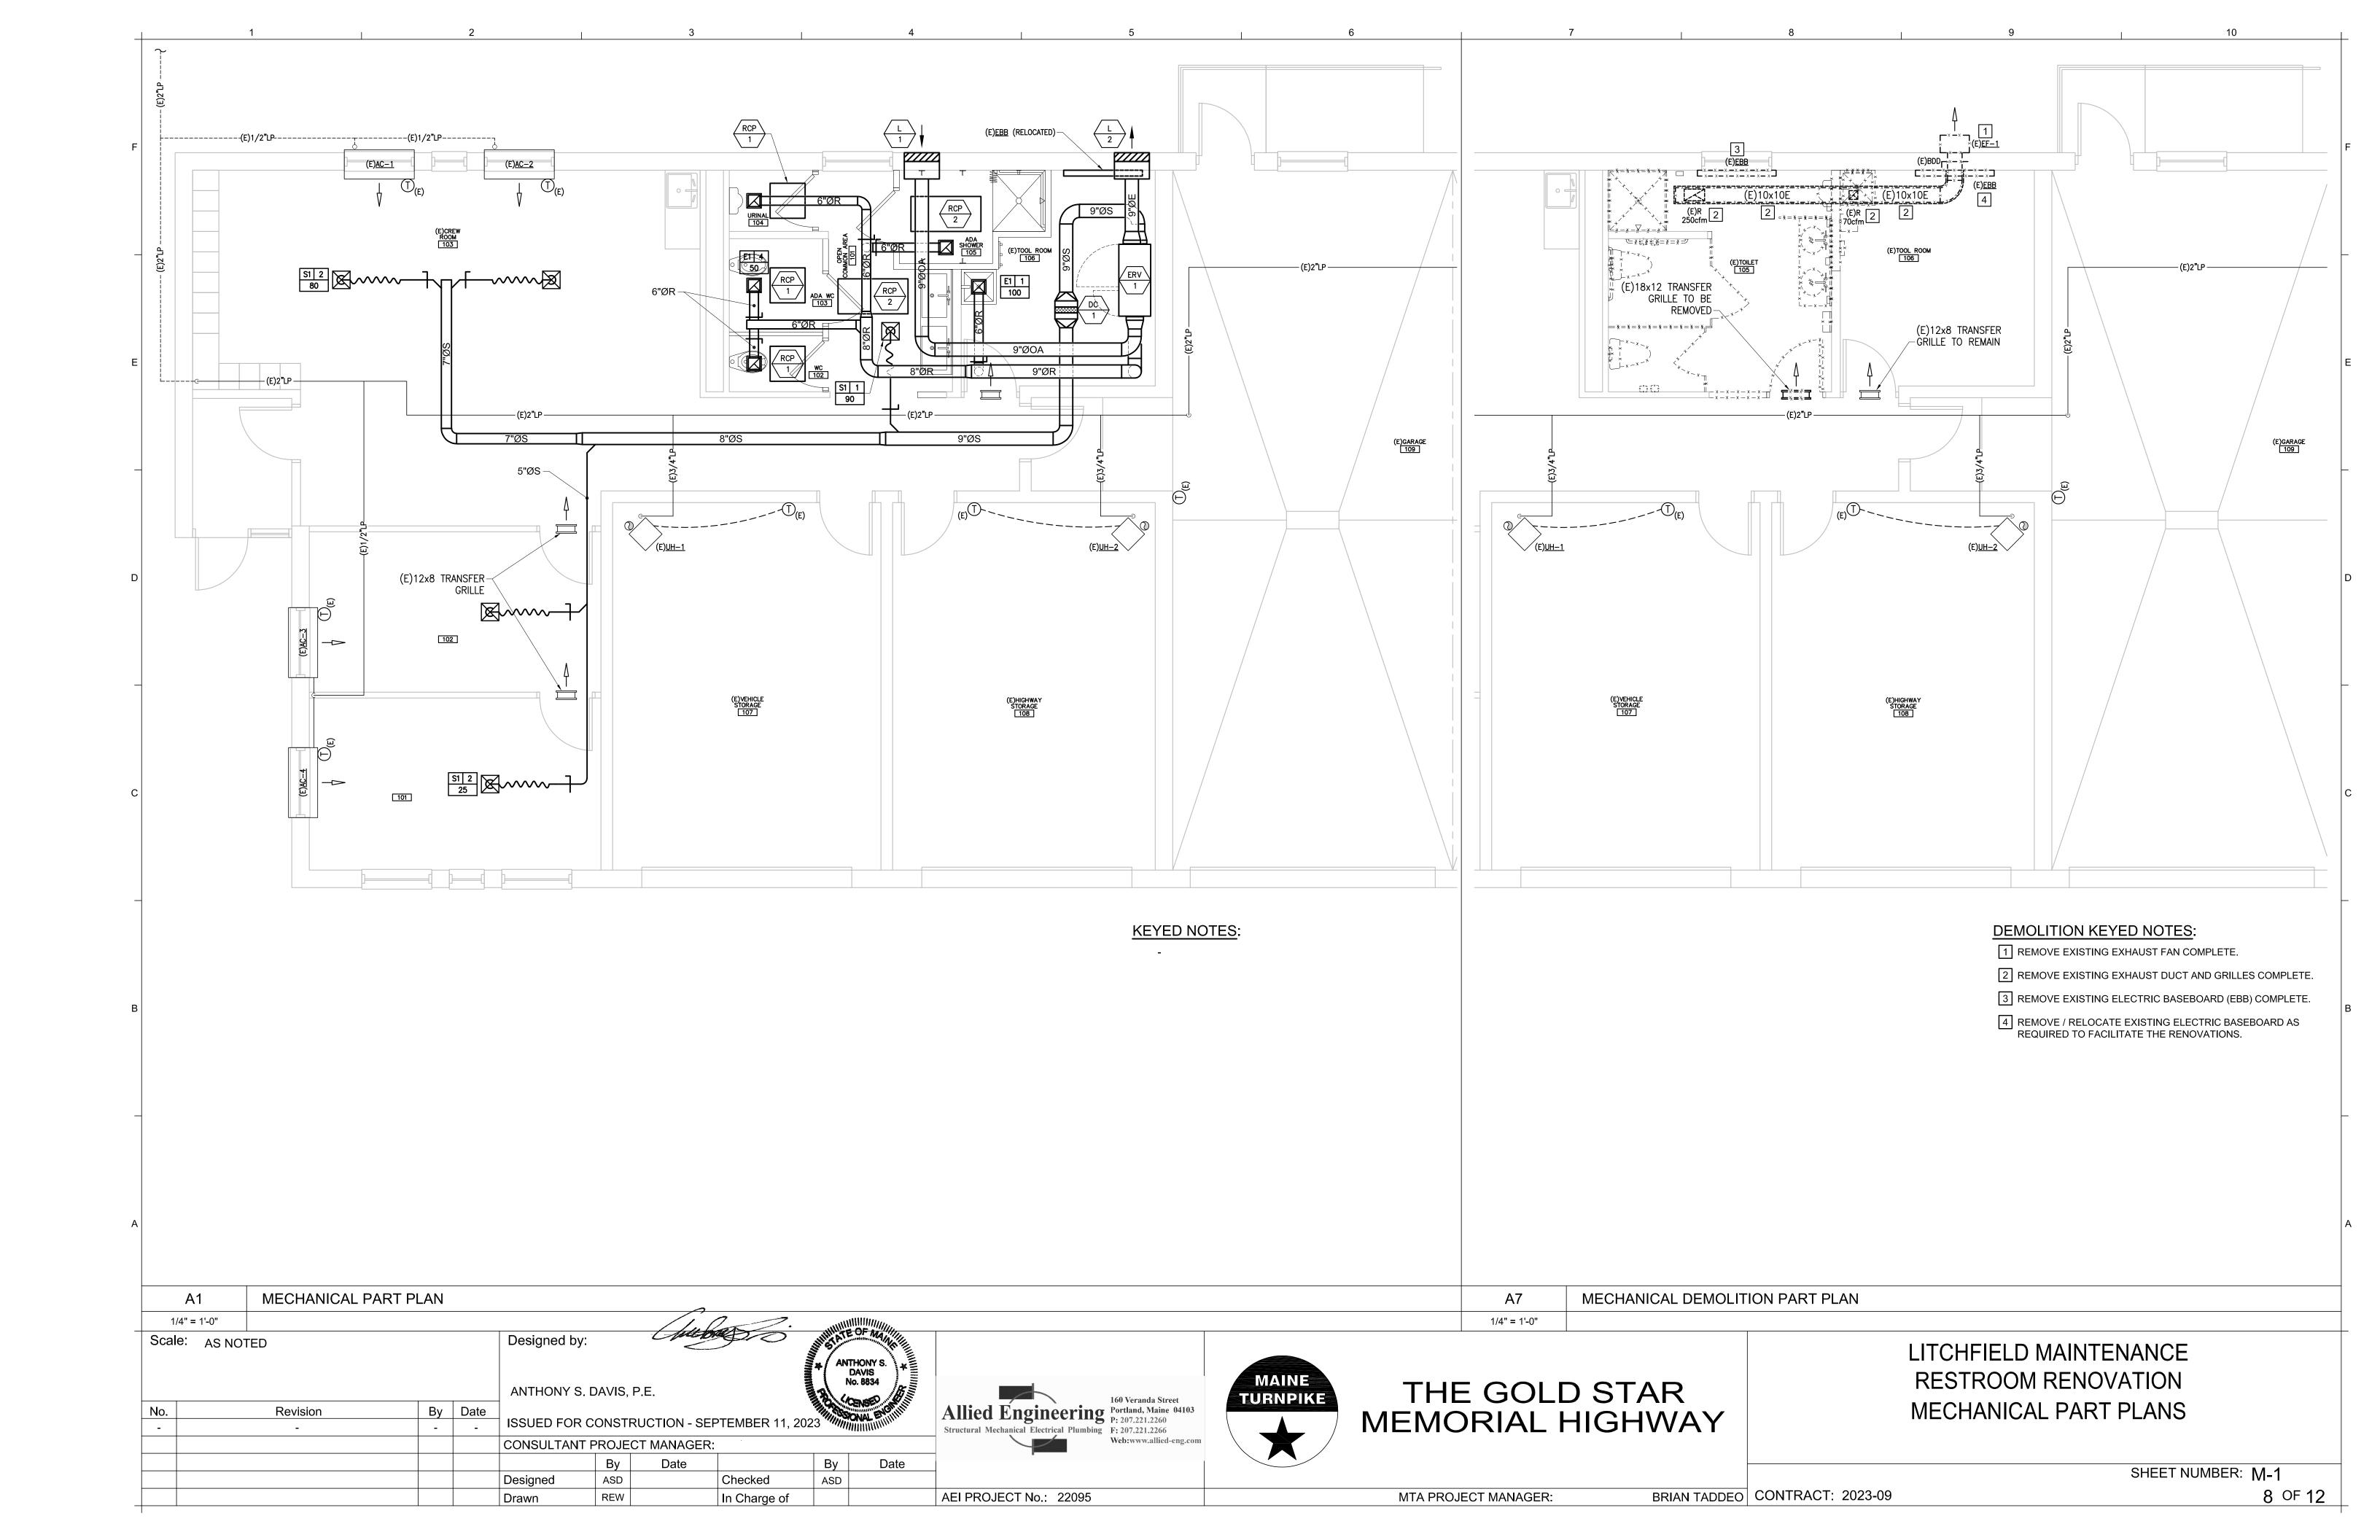

ENERGY RECOVERY UNIT SCHEDULE GENERAL TAG ERV-1								
GENERAL	SERVES	RESTROOMS/ADMIN						
	LOCATION	CORRIDOR						
	TYPE	FIXED-PLATE ENTHALPI						
	MFR	RENEWAIRE						
EIL TED OFOTION	MODEL	HE1XINH						
FILTER SECTION	FILTERS	2" MERV 13						
(TYP-2, SUPPLY & EXH)	MIN. AREA, sf	2.8						
OUTSIDE AID EAN	VELOCITY	108						
OUTSIDE AIR FAN	TYPE	FC						
	AIRFLOW, cfm	300						
	ESP, in.wc.	1"						
	MOTOR SPEEDS	ECM						
	HP	0.5						
EXHAUST AIR FAN	TYPE	FC						
	AIRFLOW, cfm	300						
	ESP, in.wc.	1"						
	MOTOR SPEEDS	ECM						
	HP	0.5						
OVERALL DIMENSIONS	LENGTH	55"						
	WIDTH	24"						
	HEIGHT	35"						
	OPERATING WEIGHT, lbs.	280						
HEAT RECOVERY CORE	SUMMER OA DB/WB	88 / 72						
	WINTER OA DB	-10						
	SUMMER SA DB/WB	77.9 / 66.1						
	WINTER SA DB	52						
	SENSIBLE EFFECTIVENESS	77.0%						
	SUMMER ENTHALPY EFF.	64.0%						
	WINTER ENTHALPY EFF.	77.0%						
	FROST CONTROL	NONE REQUIRED						
ELECTRICAL DATA								
	V-PH-HZ	120/1/60						
	UNIT FLA	16.2						
	UNIT MCA	18.2						
	MAX FUSE SIZE	25 A						
	SUPPLY AND RETURN SMOKE							
	DETECTORS	NA						
	_ =							

F	RADIANT CELING PANEL SCHEDULE (ELECTRIC)											
TAG	QMARK MODEL No.	WATTS	ELECT	PANEL WIDTH	PANEL LENGTH	INSULATION						
RCP-1	CP372	375	240/1	24"	24"	1"						
RCP-2	CP502	500	240/1	24"	48"	1"						
NOTES:												

	PLUMBING FIXTURE SCHEDULE										
	DESCRIPTION		BRANC	NOTEC							
TAG	DESCRIPTION	CW	HW	VENT	WASTE	NOTES					
WC-1	WATER CLOSET-FLUSHTANK, WALL MOUNT-ADA	1/2"		2"	3"						
U-1	URINAL	3/4"		1-1/2"	2"						
P-1	LAVATORY, DROP IN	1/2"	1/2"	1-1/2"	1-1/2"						
P-1A	ADA LAVATORY - UNDERMOUNT	1/2"	1/2"	1-1/2"	1-1/2"						
P-2	ADA TRANSFER SHOWER	1/2"	1/2"	1-1/2"	2"						
P-3	MOP SERVICE BASIN	1/2"	1/2"	1-1/2"	3"						

	PLUMBING PUMP SCHEDULE												
T. C	0ED\/E0	MED	MODEL	TVD5	ODM		00NN 017F0	ELECT	TRICAL	OLIMB	NOTES		
TAG	SERVES	MFR.	MODEL	TYPE	GPM	HEAD		MOTOR HP	VOLTS/PH (60 Hz.)	SUMP	NOTES		
RCP-1	DHW RECIRC	GRUNDFOS	UPS 32-160 FB	3 SPEED CIRCULATOR	2	39	3/4" X 3/4"	625 W	115/1		1		
NOTES: 1. SEE SE	PEC SECTION 22111	16.											

	ELECTRIC DUCT HEATING COIL SCHEDULE													
TAG	MANUFACTURER - MODEL	SERVES	AIRFLOW	LENGTH (IN)	HEIGHT (IN)	DUCT COLLAR (IN)	FACE VEL	EDB	LDB	MAX APD	втин	KW	AMPS	VOLT / PH
DC-1	RENEWAIRE RH	ERV-1	300	15.5	12	10	232	25	75	0.2"	16,200	5.0	20.8	240/1

- 1. Provide SCR Heating Control
- 2. Provide disconnect switch.
- 3. Accessories: Airflow switch, duct thermostat, magnetic contactor, and pilot light.
- 4. Coordinate control box location LH or RH for proper maintenance access.
- 5. Provide duct mounted thermostat

			REGISTERS	- GRILLES -	- DIFFUSE	ERS (F	RGD) SC	CHEDU	LE	
ГAG	MFR.	MODEL	TYPE	NECK SIZE	FACE SIZE	MAX CFM	MAX TOTAL P.D. (IN.W.C.)	MAX NC LEVEL	BLOW	NOTES
S-1	PRICE	SMDA	SQ. CEILING SUPPLY DIFFUSER, ADJUSTABLE	6 X 6 / 6" DIA	12" X 12"	100	0.07"	15		ROUND NECK ADAPTER, SURFACE MOUNT FRAME
E-1	PRICE	530	STEEL RETURN, 3/4" SPACING, 45 DEG VANES	8" X 8"	9.75" X 9.75"	110	0.05"	20		6" DIA RUNOUT, SURFACE MOUNT FRAME
						·	·		·	

LOUVER SCHEDULE																
	MFR.	MODEL	A ID	DUTY	CFM				DIMENSIONS				BEGINNING POINT OF	MAYDD		
TAG			AIR SYSTEM			WIDTH (IN.)	HEIGHT (IN.)	MIN. FREE AREA (SF)	GROSS VELOCITY (FT/MIN)	NET VELOCITY (FT/MIN)	% FREE AREA	BLADE DEPTH	WATER PENETRATION AT 0.01 OZ./SF	MAX P.D. MAX W.C.	SCREEN	NOTES
L-1	RUSKIN	ELF445DX		INTAKE	300	24	24	1.72	75.0	174.4	43.0%	4"	873 FPM	0.06	INSECT	
L-2	RUSKIN	ELF445DX		EXHAUST	300	24	24	1.72	75.0	174.4	43.0%	4"	873 FPM	0.06	INSECT	

NONE			
Scale:	AS NOT	ΓED	Designed

By Date

Designed

Drawn

Revision

MECHANICAL SCHEDULES

ANTHONY S. DAVIS, P.E. CONSULTANT PROJECT MANAGER:

Checked

In Charge of

By ASD

Date

By




AEI PROJECT No.: 22095



THE GOLD STAR MEMORIAL HIGHWAY LITCHFIELD MAINTENANCE RESTROOM RENOVATION MECHANICAL SCHEDULES

SHEET NUMBER: M-2

BRIAN TADDEO CONTRACT: 2023-09 MTA PROJECT MANAGER:

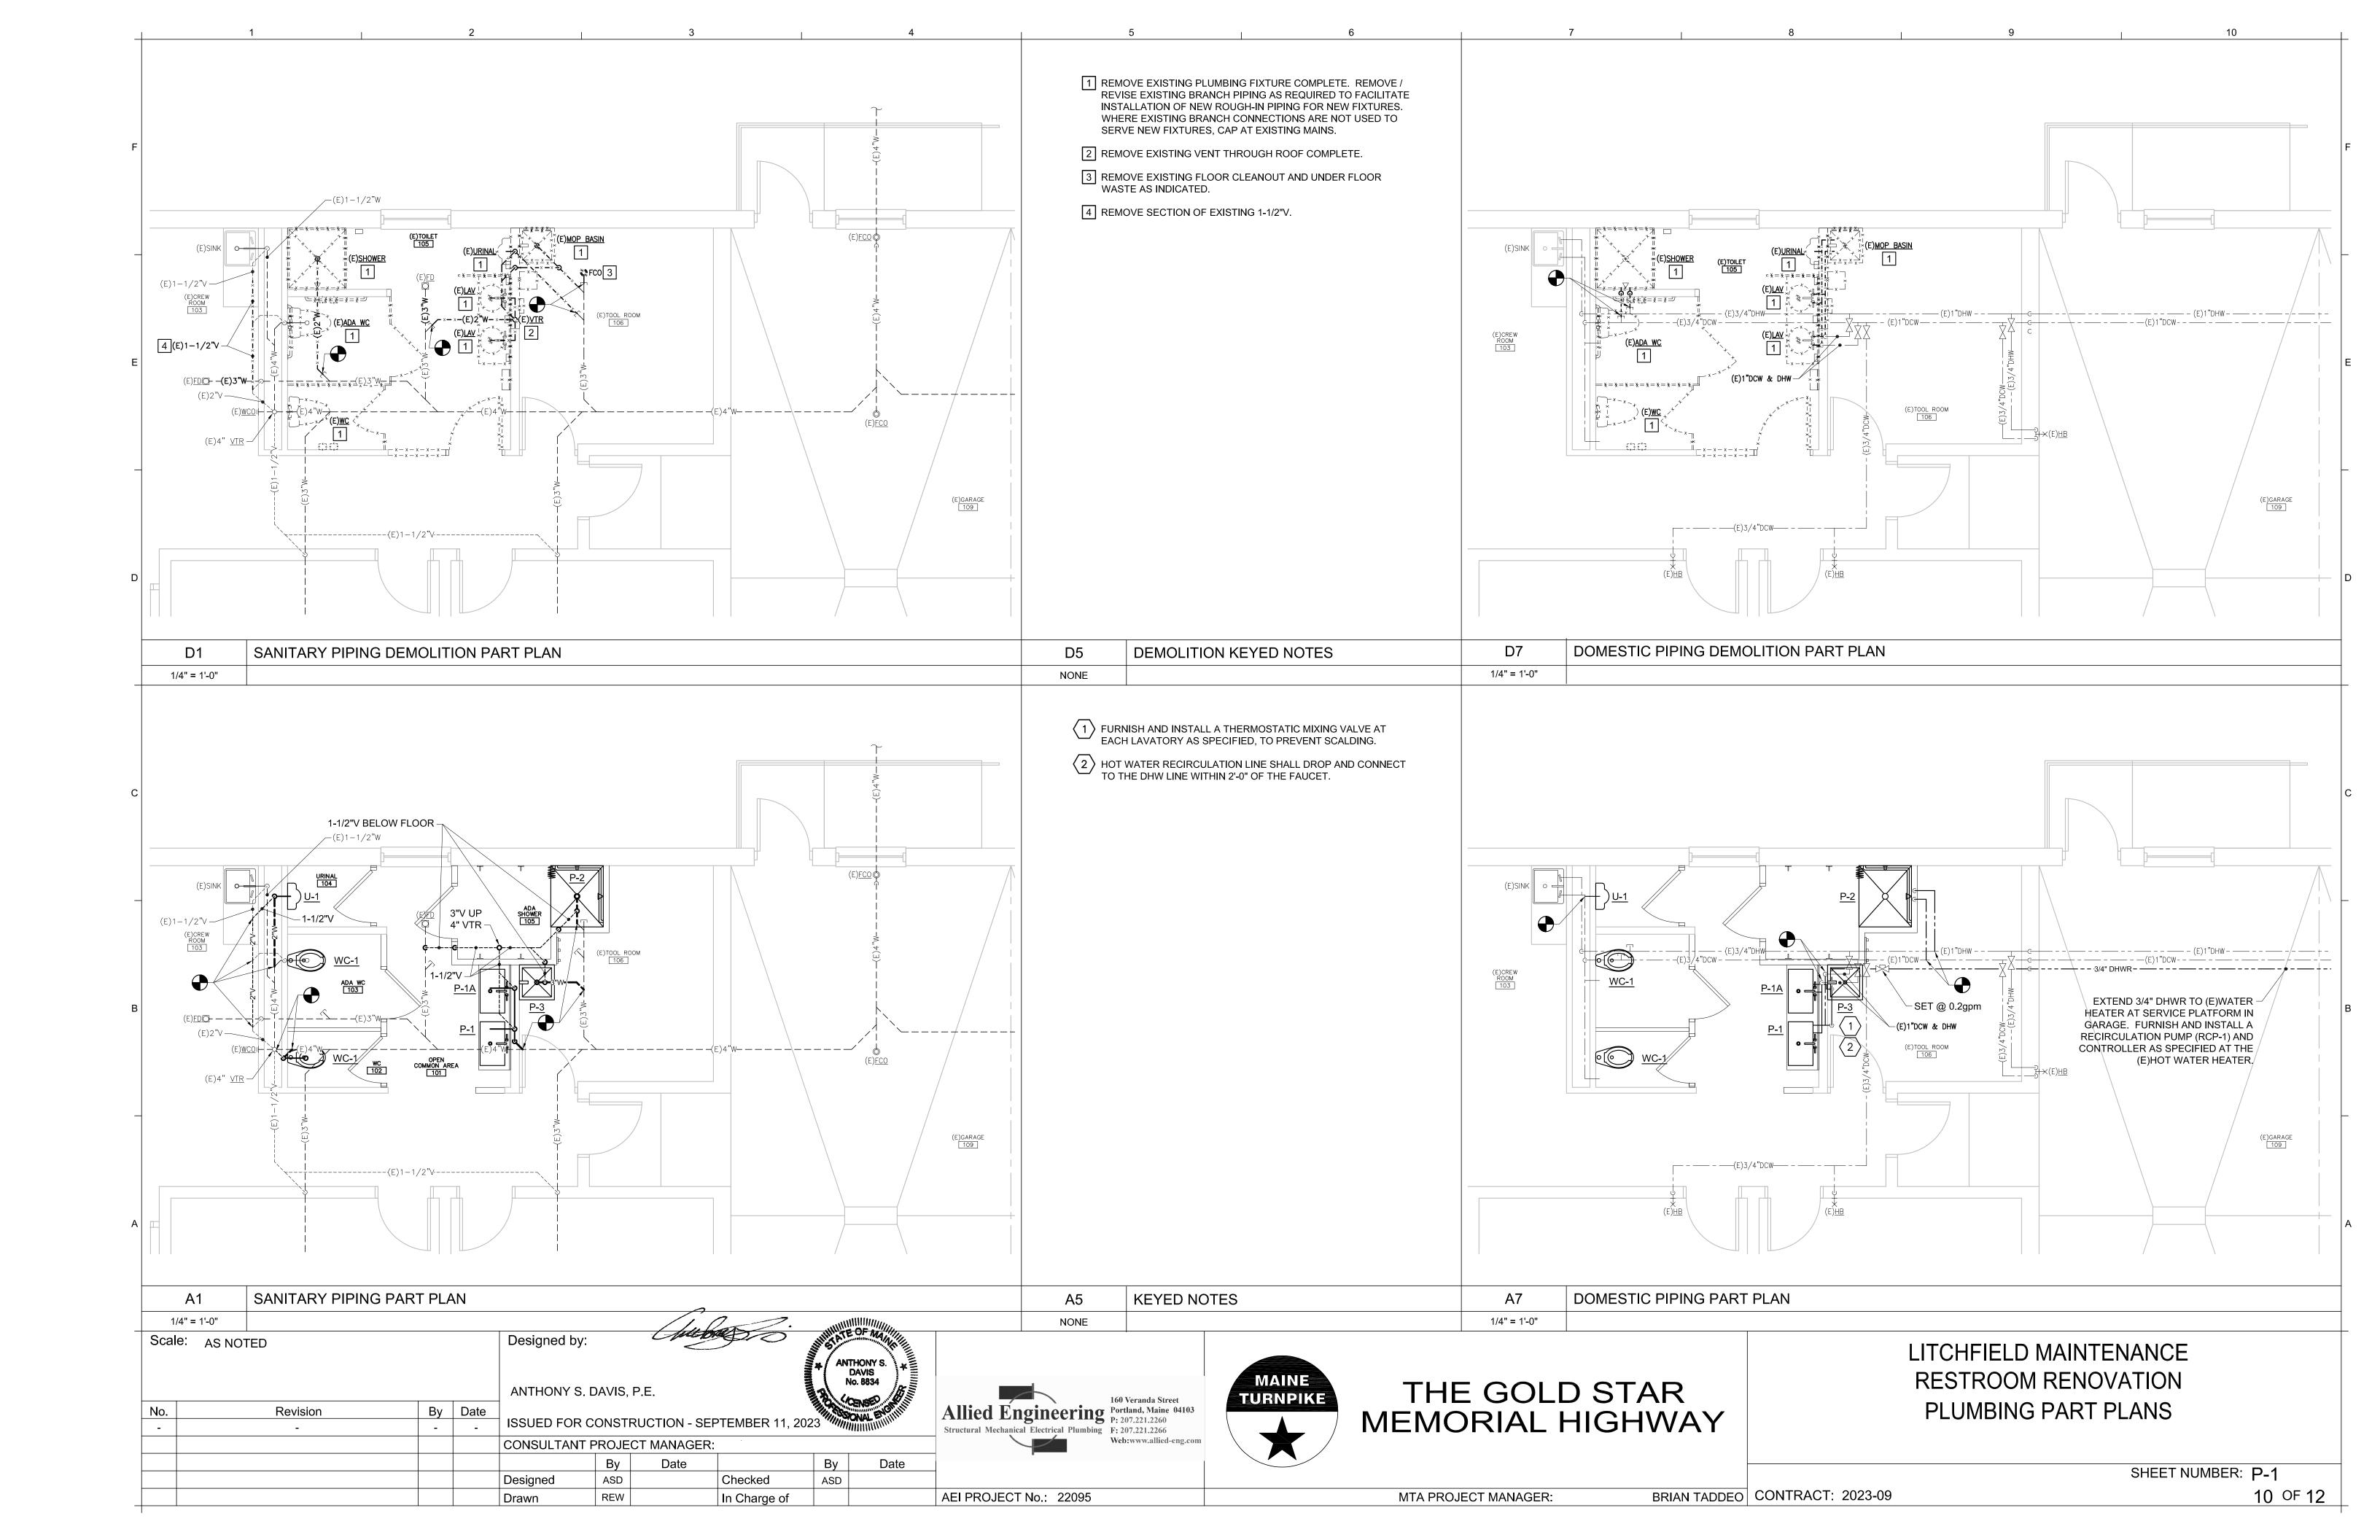

LIGHTING:

DOWN LIGHT

─── WALL MOUNTED FIXTURES

DUAL HEAD EMERGENCY LIGHT BATTERY PACK

Sos OCCUPANCY SENSOR SWITCH
S SINGLE POLE TOGGLE SWITCH

POWER:

GFCI DUPLEX RECEPTACLE, NEMA 5-20R

JUNCTION BOX

LINE TYPES:

EXISTING

____ DEMOLITION

ABBREVIATIONS:

ALTERNATING CURRENT AMPERE ABOVE FINISHED FLOOR ABOVE FINISHED GRADE

AHJ AUTHORITY HAVING JURISDICTION
AIC AMPERE INTERRUPTING CAPACITY
ATS AUTOMATIC TRANSFER SWITCH

AWG AMERICAN WIRE GAUGE BFG BELOW FINISHED GRADE

BLDG BUILDING
BOS BOTTOM OF STEEL
C CONDUIT

CB CIRCUIT BREAKER
CLG CEILING

CT CURRENT TRANSFORMER
CU COPPER
DB DIRECT BURIED

DC DIRECT CURRENT
DISC DISCONNECT

DN DOWN
EMT ELECTRICAL METALLIC TUBING

EQP EQUIPMENT
EXIST EXISTING
FBO FURNISHED BY OTHERS

AFF

AFG

FLR FLOOR
FWE FURNISHED WITH EQUIPMENT

FWE FURNISHEI G GROUND

GEN GENERATOR
GFCI GROUND FAULT CIRCUIT INTERRUPTER

GND GROUND HP HORSEPOWER

HTR HEATER
IMC INTERMEDIATE METAL CONDUIT

K KILO KCMIL THOUSAND CIRCULAR MILS

KV KILOVOLT KVA KILOVOLT-AMPERE KW KILOWATT

KWH KILOWATT-HOUR
LTG LIGHTING
MC METAL CLAD

MCB MAIN CIRCUIT BREAKER
MFR MANUFACTURER
MLO MAIN LUG ONLY

MTD MOUNTED

MV MEDIUM VOLTAGE

NEC NATIONAL ELECTRICAL CODE

NEG NEGATIVE
NEUT NEUTRAL
NIC NOT IN CONTRACT

NTS NOT TO SCALE
P POLE
PH PHASE

PVC POLYVINYL CHLORIDE
RGS RIGID GALVANIZED STEEL CONDUIT

RECEPT RECEPTACLE
RM ROOM
RSC RIGID STEEL CONDUIT
SWBD SWITCHBOARD
SWGR SWITCHGEAR
TOP OF STEEL

TOS TOP OF STEEL
TYP TYPICAL
V VOLT
VA VOLT—AMPERE


VAR VOLT-AMPERE REACTIVE
WM WATT METER
XFMR TRANSFORMER

GENERAL NOTES:

- 1. GENERAL NOTES, SYMBOL LISTS AND DETAILS ARE TO BE CONSIDERED AS APPLICABLE TO ELECTRICAL DRAWINGS FOR THIS PROJECT. SYMBOLS AND ABBREVIATIONS SHOWN ON THIS SHEET ARE FOR REFERENCE ONLY AND DO NOT INDICATE THEIR INCORPORATION IN THE DESIGN.
- 2. DRAWINGS ARE SCHEMATIC AND DIAGRAMMATIC. USE JUDGMENT AND CARE TO INSTALL ELECTRICAL WORK TO FUNCTION PROPERLY AND FIT WITHIN BUILDING CONSTRUCTION AND FINISHES. ELECTRICAL CONDUCTORS, CONDUIT, COMPONENTS, NOT SHOWN OR SPECIFIED, WHICH ARE REQUIRED FOR ANY DEVICE OR SYSTEM TO PRODUCE A COMPLETE AND OPERATIVE SYSTEM ARE REQUIRED TO BE FURNISHED AND INSTALLED.
- 3. PERFORM WORK IN ACCORDANCE WITH NFPA-70, NATIONAL ELECTRICAL CODE (NEC) 2020.
- 4. VERIFY THAT FIELD MEASUREMENTS, SURFACES, SUBSTRATES AND CONDITIONS ARE AS REQUIRED, AND READY TO RECEIVE WORK. DO NOT PROCEED WITH WORK UNTIL UNSATISFACTORY CONDITIONS HAVE BEEN CORRECTED. BY BEGINNING WORK, CONTRACTOR ACCEPTS CONDITIONS AND ASSUMES RESPONSIBILITY FOR CORRECTING UNSUITABLE CONDITIONS ENCOUNTERED AT NO ADDITIONAL COST.
- 5. REMOVE ELECTRICAL EQUIPMENT WHERE INDICATED.
 REMOVE CONDUIT, CIRCUIT CONDUCTORS, SWITCHES,
 LIGHTING FIXTURES AND MISCELLANEOUS APPLIANCES
 BACK TO ENERGIZING SOURCE OR JUNCTION BOX WHERE
 MULTIPLE EQUIPMENT IS POWERED.
- 6. CONDUCTOR MATERIAL, INCLUDING WIRING, PANELBOARD BUSES, TRANSFORMER WINDINGS, AND GROUNDING MUST BE COPPER. ALUMINUM CONDUCTORS ARE NOT ALLOWED.
- 7. UNLESS OTHERWISE NOTED, FOR 20A-1P BRANCH CIRCUIT WIRING USE 2#12 AWG CONDUCTORS AND #12 GND. HOME RUNS FED FROM 20A-1P CIRCUITS IN EXCESS OF 100 FEET USE #10 AWG.
- 8. PROVIDE COMMERCIAL SPECIFICATION GRADE 277/120 VOLT LIGHTING TOGGLE SWITCHES, SIDE WIRED AND WITH GROUNDING SCREW. LEVITON, PASS AND SEYMOUR OR APPROVED EQUAL. COORDINATE COLOR WITH OWNER.
- PROVIDE COMMERCIAL SPECIFICATION GRADE CONVENIENCE RECEPTACLES, GROUNDING TYPE NEMA 5-20R, SIDE WIRED. LEVITON, PASS AND SEYMOUR OR APPROVED EQUAL.
- 10. PROVIDE NYLON SMOOTH WALL PLATES FOR FINISHED PARTITIONED SPACES WIRING DEVICES.
- 11. UNLESS OTHERWISE NOTED, PROVIDE TYPE EMT CONDUIT FOR INTERIOR RACEWAY, TYPE RGS CONDUIT FOR EXTERIOR RACEWAY, LIQUID TIGHT FLEXIBLE METAL CONDUIT FOR FINAL CONNECTIONS TO MOTORS, AND FLEXIBLE METAL CONDUIT FOR CONNECTIONS TO LIGHT FIXTURES (MAXIMUM 6FT LENGTH).
- 12. PROVIDED EQUIPMENT DISCONNECTS AND MANUAL MOTOR STARTERS UNLESS NOTED AS FURNISHED WITH EQUIPMENT (FWE). INCLUDE FUSES RATED FOR PROTECTION OF LOAD SUPPLIED. MOUNT DISCONNECTS AND MOTOR STARTERS IN AN ACCESSIBLE LOCATION WITHIN SIGHT OF THE LOAD SERVED. DISCONNECTS AND MOTOR STARTERS MUST BE LOCKABLE IN THE OPEN POSITION.
- 13. UNLESS OTHERWISE NOTED MOUNT CONVENIENCE RECEPTACLES 18" AFF, LAVATORY GFCI RECEPTACLES 48" AFF, LIGHTING TOGGLE SWITCHES 48" AFF. MEASUREMENTS ARE MADE TO TOP OF DEVICE.
- 14. SEAL PENETRATIONS THROUGH FLOORS, RATED WALLS AND PARTITIONS WITH UL APPROVED FIRE SEALANT MATERIAL TO MAINTAIN THE RATING OF SEPARATION.

GENERAL NOTES CONTINUED:

- 15. EQUIPMENT CONNECTIONS ARE SHOWN FOR BASIS-OF-DESIGN PRODUCTS. COORDINATE EQUIPMENT CONNECTIONS INCLUDING DISCONNECTING MEANS, OVERCURRENT PROTECTION, AND WIRE SIZING WITH SELECTED MANUFACTURER'S RECOMMENDED INSTRUCTIONS.
- 16. COORDINATE FINAL DEVICE LOCATIONS IN PARTITIONED SPACES WITH OWNER'S PROPOSED FURNITURE LAYOUT.
- 17. PROVIDE MOUNTING HARDWARE NECESSARY FOR A COMPLETE INSTALLATION. MOUNT EQUIPMENT AND ROUTE CONDUIT SO AS NOT TO INTERFERE WITH OPERATIONS SUCH AS OVERHEAD DOORS, DOOR SWINGS, ACCESS POINTS, AND OTHER INSTALLATIONS.
- 18. MANUFACTURER'S NAMES AND MODEL NUMBERS ARE USED THROUGHOUT THE PROJECT FOR DESCRIPTIVE PURPOSES ONLY AND ARE INTENDED TO INDICATE THE STANDARD OF MATERIAL OR ARTICLES REQUIRED. DESIGN IS PREDICATED AROUND LISTED MANUFACTURERS AS NOTED ON SCHEDULES AND NOTES AND IS NOT INTENDED TO LIMIT THE CONTRACTOR TO ONE MANUFACTURER.
- 19. SUPPLY DISTRIBUTION EQUIPMENT FROM THE SAME MANUFACTURER. APPROVED MANUFACTURERS INCLUDE SQUARE D, EATON/CUTLER-HAMMER, SIEMENS, OR APPROVED EQUAL.
- 20. UNLESS OTHERWISE NOTED WIRING MUST BE AS FOLLOWS:
 - A. LOW VOLTAGE INTERIOR DISTRIBUTION AND BRANCH WIRING MUST BE 600V, COPPER WITH THHN/THWN INSULATION
 - B. LOW VOLTAGE EXTERIOR DISTRIBUTION AND BRANCH WIRING MUST BE 600V, COPPER WITH XHHW INSULATION.
- 21. EQUIPMENT ENCLOSURES, SWITCHES, RECEPTACLES, AND DEVICES MUST BE LABELED WITH THE SOURCE CIRCUIT AND EQUIPMENT CONTROLLED WHERE APPLICABLE. ALL PANELBOARDS AND SWITCHBOARDS MUST HAVE APPROPRIATE ARC-FLASH LABELS INSTALLED IN ACCORDANCE WITH NFPA 70E REQUIREMENTS.
- 22. CONNECT EXIT SIGNS AND EMERGENCY LIGHTS TO THE UNSWITCHED LEG OF THE LIGHTING CIRCUIT IN THE ROOM THE DEVICE IS LOCATED.

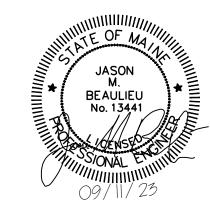

Scale: AS NOTED Designed by: COLBY COMPANY, LLC engineering & design 47A York Street, Portland, ME 04101 207.553.7753 By Date Revision CONSULTANT PROJECT MANAGER: JASON BEAULIEU, PE Ву Date By | Date JMB 09/11/23 Checked JMB | 09/11/23 Designed ISSUED FOR BID JMB | 09/11/23 | Drawn ACY 09/11/23 In Charge of



47A York St Portland, ME 04101 207.553.7753





LITCHFIELD MAINTENANCE
BATHROOM RENOVATION

ELECTRICAL LEGEND, ABBREVIATIONS AND GENERAL NOTES

SHEET NUMBER: E-001

MTA PROJECT MANAGER: BRIAN TADDEO, PE CONTRACT: 2023.09

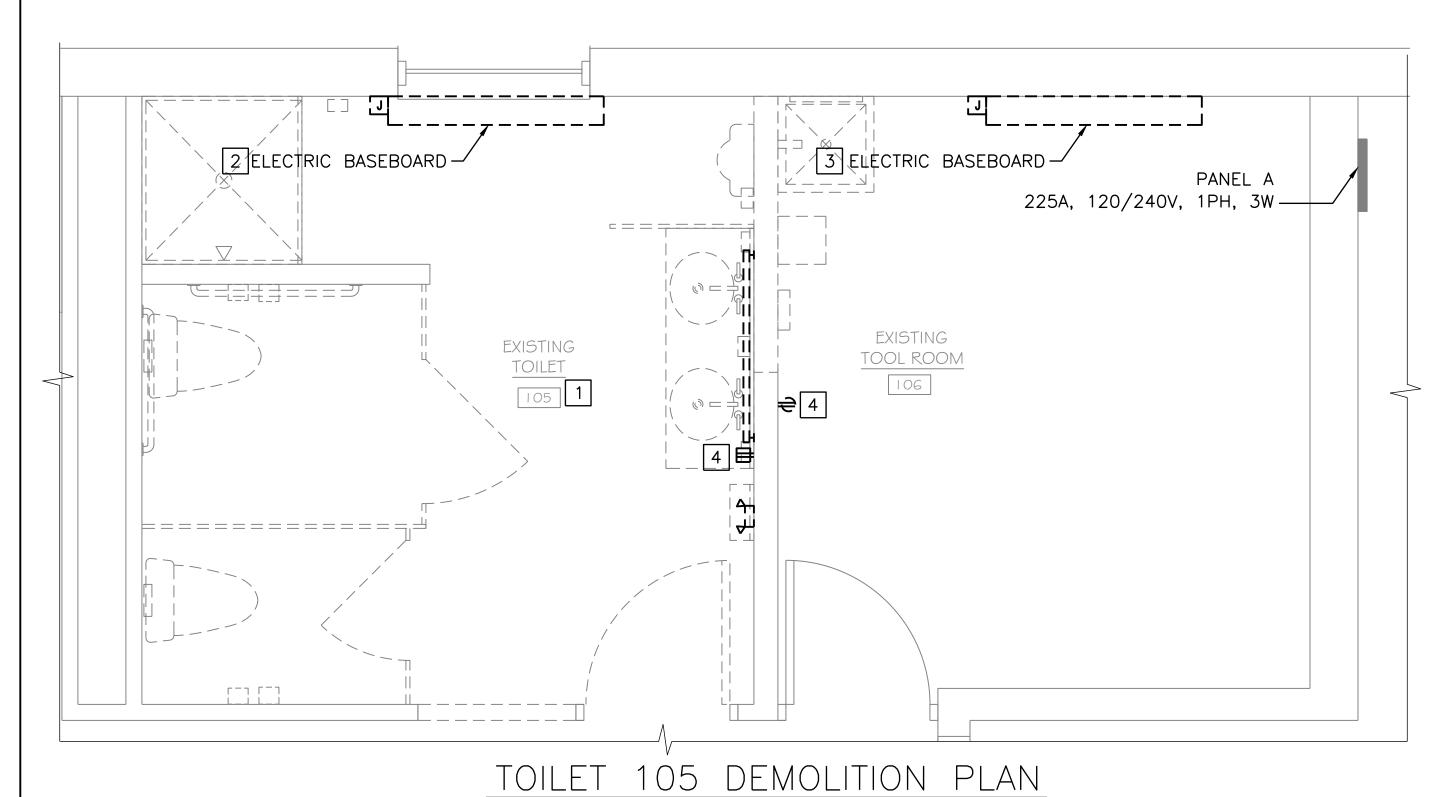

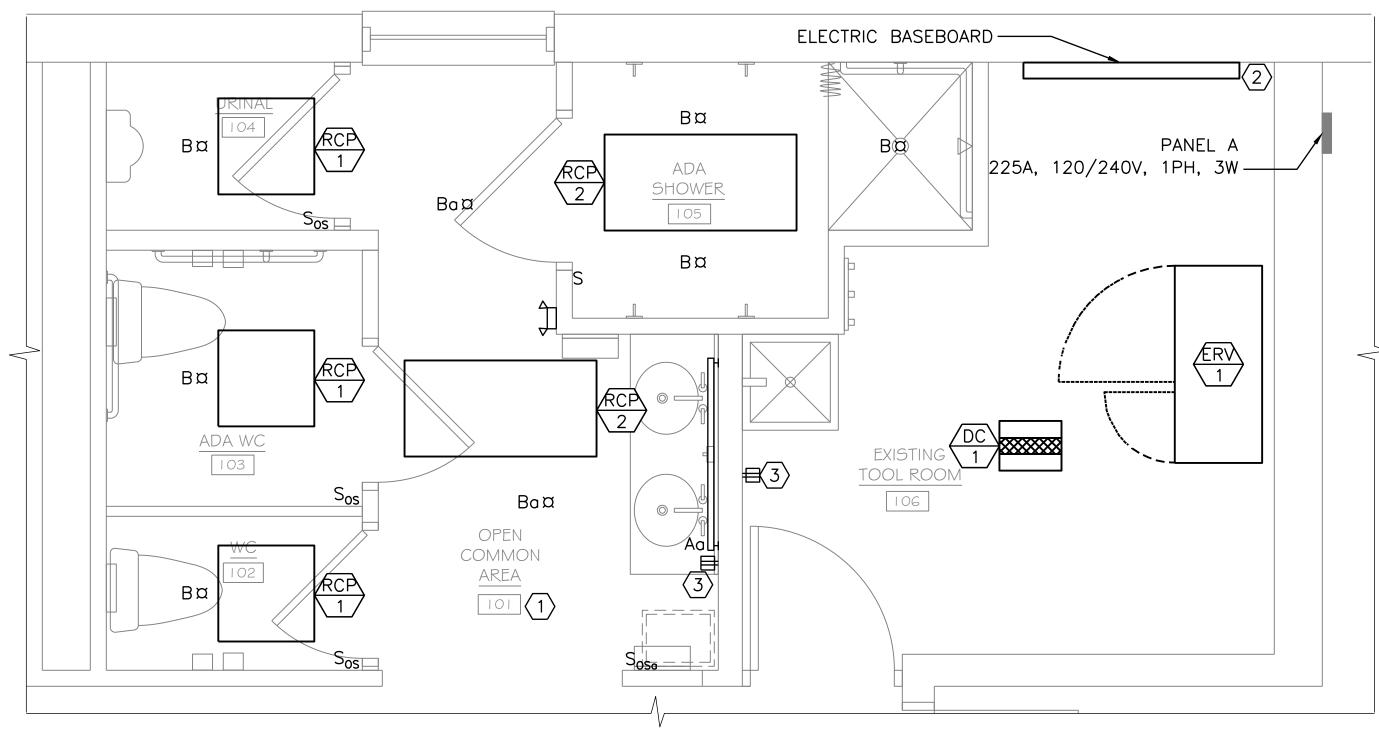

SCALE:1/2" = 1'-0"

TYPE	DESCRIPTION	VOLT	MANUFACTURER (OR EQUAL)	WATTAGE	LUMENS	MOUNTING	NOTES
А	4' LINEAR VANITY LIGHT, SQUARE ACRYLIC LENS, WHITE FINISH, 35K COLOR TEMPERATURE	120	CURRENT LIGHTING 67L-W-D-4-4-SQ-C1-35K-D055- D01-1C-UNV	17	2200	WALL @ 7' AFF	
В	6" SQUARE DOWNLIGHT LED FIXTURE	120	CURRENT LIGHTING LTR-6SQD-H-SL10L-DM1 KTR06SQD-T-SL35K8WD-SS	12	1000	RECESSED	
	DUAL HEAD EMERGENCY FIXTURE PROVIDED WITH THERMOPLASTIC HOUSING, NICKEL METAL HYDRIDE BATTERY, AND SELF-DIAGNOSTIC ELECTRONICS	120	CURRENT LIGHTING CU2SD	1	_	WALL	CONNECT ALL EMERGENCY LIGHTING FIXTURES TO UNSWITCHED LEG OF LOCAL LIGHTING CIRCUIT.

LIGHTING FIXTURE SCHEDULE SCALE: NTS

			OCP							
EQUIPMENT	LOCATION	SOURCE PANEL/ CIRCUIT	(AMP)	WIRE SIZE	CONDUIT SIZE	LOCAL DISC. SWITCH	LOAD	PH	VOLT	NOTES
RCP-1	ROOMS 102-104	PANEL A - 39, 41	20	(2) #12AWG, (1) #12 GND	3/4"	30A NF	375 W	1	240	
RCP-2	ROOMS 101, 105	PANEL A - 39, 41	20	(2) #12AWG, (1) #12 GND	3/4"	30A NF	500 W	1	240	
ERV-1	ROOM 106	PANEL A - 34	25	(2) #10 AWG, (1) #12 GND	3/4"	30S NF	18.2 A	1	120	REPLACE 20A BREAKER
DC-1	ROOM 106	PANEL A - 36,38	30	(2) #10 AWG, (1) #10 GND	3/4"	60A NF	4.7 KW	1	240	
RP-1	SEE NOTES	PANEL A - 40	20	(2) #12AWG, (1) #12 GND	3/4"	30A NF	1.6 KW	1	120	COORDINATE WITH PLUMBING FOR LOCATION

EQUIPMENT SCHEDULE

SCALE: NTS

RESTROOM PLAN SCALE:1/2" = 1'-0"

NOTES:


- 1. SEE SHEET E-001 FOR LEGEND, ABBREVIATIONS AND GENERAL NOTES.
- SEE EQUIPMENT SCHEDULE FOR EQUIPMENT CIRCUITING AND DISCONNECT REQUIREMENTS.


DEMOLITION KEYED NOTES:

- LIGHTING FIXTURES -DEMOLISH AND RETAIN WIRING FOR REUSE JUNCTION ABOVE ACOUSTIC CEILING TILES.
- ELECTRIC BASEBOARD -DEMOLISH AND REMOVE WIRING BACK TO SOURCE.
- ELECTRICAL BASEBOARD -REMOVE AND RETAIN WIRING AND BASEBOARD FOR REUSE.
- RECEPTACLE DEMOLISH, RETAIN WIRING FOR REUSE, PULLBACK WIRING AND JUNCTION ABOVE ACOUSTIC CEILING TILE.

KEYED NOTES:

- LIGHTING FIXTURES REUSE RETAINED WIRING, EXTEND AS NECESSARY USING SAME AWG AND TYPE AS EXISTING.
- ELECTRIC BASEBOARD -REUSE RETAINED BASEBOARD AND WIRING, IF NECESSARY EXTEND WIRING USING SAME TYPE AND AWG.
- RECEPTACLE REUSE RETAINED WIRING, IF NECESSARY EXTEND WIRING USING SAME TYPE AND AWG AS EXISTING.

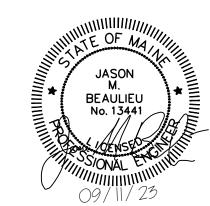

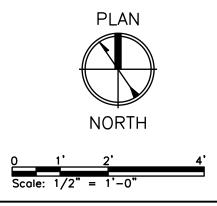

Scal	e: AS NOTED	Designed by:									
		COLBY COMPANY, LLC engineering & design 47A York Street, Portland, ME 04101									
No.	Revision	Ву	Date	207.553.7753							
			CONSULTANT PROJECT MANAGER: JASON BEAULIEU, PE								
					Ву	Date		Ву	Date		
				Designed	JMB	09/11/23	Checked	JMB	09/11/23		

JMB | 09/11/23 | Drawn

0 ISSUED FOR BID

In Charge of

ACY 09/11/23



47A York St Portland, ME 04101 207.553.7753 MAINE

TURNPIKE

MTA PROJECT MANAGER: BRIAN TADDEO, PE

THE GOLD STAR MEMORIAL HIGHWAY

LITCHFIELD MAINTENANCE BATHROOM RENOVATION

ELECTRICAL PLANS & SCHEDULES

SHEET NUMBER: E-101

CONTRACT: 2023.09