**INDEX OF SHEETS** 

Miscellaneous Repair Details Maintenance of Traffic Details

Bridge Plan and Elevation **Bridge Typical Section Bridge Joint Modifications** 

Bridge Plan and Elevation

Bridge Plan and Elevation **Bridge Typical Section** 

**Bridge Joint Modifications** 

**Bridge Typical Section** 

Abutment No. 2 Repairs **Bridge Joint Modifications** 

Structure 3 MCRR Overpass Bridge

**Bridge Typical Section Bridge Joint Modifications** 

Bridge Rail Details


Structure 1 St. Lawrence & Atlantic RR Overpass Bridge

Structure 4 Gray Road (Route 26 & 100) Underpass Bridge

Structure 2 Blackstrap Road Overpass Bridge

Title Sheet

**Estimated Quantities** 

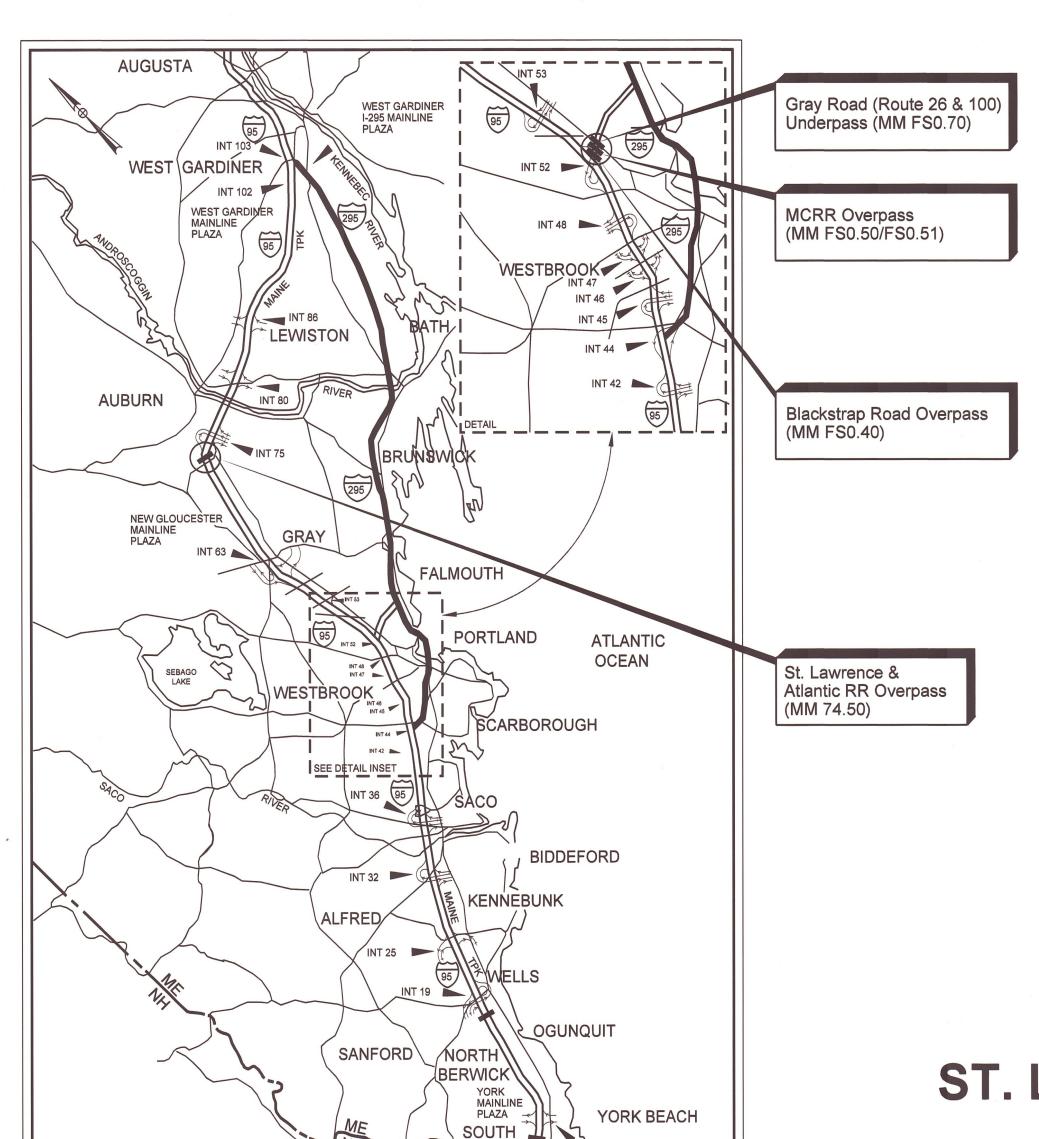

MAINE THE GOLD STAR **TURNPIKE MEMORIAL HIGHWAY** 

MAINE TURNPIKE AUTHORITY

DANIEL E. WATHEN, CHAIR MICHAEL J. CIANCHETTE, VICE CHAIR ANDREW J. MCLEAN, MEMBER JANE L. LINCOLN, MEMBER THOMAS J. ZUKE, MEMBER BRUCE A. VAN NOTE, EX-OFFICIO MEMBER

S. PETER MILLS, EXECUTIVE DIRECTOR

**CONTRACT 2024.07** 

**BRIDGE REPAIRS** 

ST. LAWRENCE & ATLANTIC RR OVERPASS (MM 74.50) **BLACKSTRAP ROAD OVERPASS (MM FS0.40)** MCRR OVERPASS (EB/WB) (MM FS0.50/FS0.51) GRAY ROAD (ROUTE 26 & 100) UNDERPASS (MM FS0.70)



MAINE TURNPIKE AUTHORITY

**LOCATION MAP** 





Consultant Project Manager

3/26/2024

	ESTIMATED QUANTITIES						
ITEM NO.	DESCRIPTION	UNIT	St. Lawrence & Atlantic RR	Blackstrap Road	MCRR	Gray Road (Route 26 & 100)	Quantity Total
202.1211	Removing Existing Girder Haunches	LF				1,350	1 <b>,3</b> 50
202.127	Removing Existing Pavement and High Performance Waterproofing Membrane	SY	800				800
202.202	Removing Pavement Surface	SY	750	I <b>,</b> 670	2,210	245	<b>4,</b> 875
202.206	Removing Rumble Strips	LF	1,700				1,700
202.912	Removing Existing Conduit	LS				1	/
403.208	Hot Mix Asphalt, 12.5 mm Nominal Maximum Size	TON	140	137	186	20	483
409.15	Bituminous Tack Coat RS-I or RSIh - Applied	GAL	95	70	90	10	265
502 <b>.</b> 7011	Weep Drain Extensions	EΑ	24	45		3	72
507 <b>.</b> 812	Aluminum Bridge Rail, 2 Bar Repair (20 LF)	LS	1				/
508.14	High Performance Waterproofing Membrane (780 SY)	LS	1				/
515 <b>.</b> 201	Pigmented Protective Coating for Concrete Surfaces	SY				130	130
5/5 <b>.</b> 202	Clear Protective Coating for Concrete Surfaces	SY	<i>l</i> 65	270	370	180	985
518.10	Abutment Repairs	SF				<i>4</i> 5	<i>4</i> 5
518 <b>.</b> 391	Reparing Granite Curb Joint and Bedding Mortar	LF				50	50
518.4	Epoxy Injection Crack Repair	LF				17	17
<i>518.</i> 70	Repair of Overhead Surfaces < 8 inches	SF	40				40
518 <b>.</b> 80	Partial Depth Concrete Deck Repairs	SF	240				240
518 <b>.</b> 81	Full Depth Concrete Deck Repairs	SF	120				120
518 <b>.</b> 864	Elastomeric Concrete Header Repair *	CF	80	65	70	20	235
520.23	Asphaltic Plug Joint	LF		90	103		193
520.234	Expansion Device - Silicone Coated and Pre-compressed Seal	LF	70		6		76
520.234	Expansion Device - Silicone Coated and Pre-compressed Seal (Gray Road)	LF				45	<i>4</i> 5
520 <b>.</b> 921	Bridge Joint Modification (St. Lawrence & Atlantic)	ΕA	2				2
520.922	Bridge Joint Modification (Gray Road - Abutment 2)	ΕA				1	
<i>526.306</i>	Temporary Concrete Barrier, Type I - Supplied by the Authority (St. Lawrence & Atlantic RR)	LS	1				
<i>526.306</i>	Temporary Concrete Barrier, Type I - Supplied by the Authority (Blackstrap & MCRR)	LS		7			
<i>527.341</i>	Work Zone Crash Cushions - TL-3	Unit	2	4	!		6
606.24	Guardrail Type 3d - Single Rail	LF				15	15
609.13	Vertical Bridge Curb Type I	LF				36	36
652.30	Flashing Arrow	ΕA	2			2	5
652.33	Drum	ΕA	198	10.	2	100	400
652.34	Cone	ΕA	25	50	)	50	125
<i>652.35</i>	Construction Signs	SF	1,038	51	7	6/3	2,168
652 <b>.</b> 361	Maintenance of Traffic Control Devices (St. Lawrence & Atlantic RR)	LS	/				
652 <b>.</b> 361	Maintenance of Traffic Control Devices (Blackstrap & MCRR)	LS					
652.361	Maintenance of Traffic Control Devices (Gray Road)	LS				/	
<i>652.38</i>	Flagger	HR				1,120	1,120
652.41	Portable Changeable Message Sign	EA	2	3	7	2	7
<i>652.4</i> 7	Sequential Flashing Warning Lights	ΕA	44	8	/	30	155
<i>656.</i> 75	Temporary Soil Erosion and Water Pollution Control	LS		1		•	/
659.10	Mobilization	LS		1			

<sup>\*</sup> Elastomeric Concrete Header Repair quantity is based on an average depth of 4" which includes 3" for the header and additional depth for repairs

Scale:				Designed by	<b>/</b> :			L	
No.	Revision	Ву	Date				VII	U	
				CONSULTANT	PROJE(	CT MANAGER:	G. Edington		
					Ву	Date		Ву	Date
				Designed	MFS	3/26/24	Checked	MÉB	3/26/24
				Drawn	TSR	3/26/24	In Charge of	GME	3/26/24

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MTA PROJECT NO. 2024.07
BRIDGE REPAIRS
ESTIMATED QUANTITIES

 VHB: 55729.00
 SHEET NUMBER: 2

 CONTRACT: 2024.07
 2 OF 38

#### **SPECIFICATIONS**

Design: AASHTO LRFD Bridge Design Specifications, 2020.

Construction: State of Maine Department of Transportation Standard Specifications, 2014 Edition, with all revisions thereto.

> State of Maine Department of Transportation Standard Details for Highways and Bridges, 2020 Edition, with all revisions thereto.

> AASHTO LRFD Bridge Construction Specifications, Fourth Edition

#### NFW MATERIALS

NEW WATENIALS	
Concrete (Unless noted otherwise)	
Structural Steel: All Material (except as noted)	
BASIC DESIGN STRESSES (NEW	MATERIALS)
Concrete	f'c = 4,500 psi
Reinforcing Steel	fy = 60,000 psi
Structural Steel: ASTM A 709/A 709M, Grade 36	Fy = 36,000 psi

ASTM A 325..... Fu = 120,000 psi

#### TRAFFIC AND DESIGN LOADING DATA

#### ST LAWRENCE & ATLANTIC RR OVERPASS BRIDGE

SI. LAWRENCE & AILANIIC RR OVERPA	ASS DITIDGE
Design Live Load (for existing components)	Unknown 22 <b>.</b> 250
Design Speed (MPH)(for existing)	65
BLACKSTRAP ROAD OVERPASS BRIDGE	<u>-</u>
Design Live Load (for existing components)	
Design Speed (MPH)(for existing)	60
unchonal class.	
MCRR OVERPASS BRIDGE	
Design Live Load (for existing components)	
AADT	
	Interstate

Design Speed (MPH) (for existing) \_\_\_\_\_\_35

#### GENERAL CONSTRUCTION NOTES

- I. All details shall be in conformance with Maine Department Transportation (MaineDOT) 2020 Standard Details for Highways and Bridges with all updates and MaineDOT Best Management Practices for Erosion and Sediment Control, latest revision unless otherwise noted in these plans.
- 2. All work shall be completed within the Right of Way.
- 3. The Contractor shall submit proposed staging area(s) and field trailer location to the Resident for approval prior to starting work.
- 4. Any portions of the existing bridges removed by the Contractor shall become the property of the Contractor. The steel portions of the existing bridges may be coated with a lead-based paint system. The Contractor is responsible for the containment, proper management and disposal of all lead-contaminated hazardous waste generated by the work of this project.
- 5. Copies of the As-Built plans are posted on the Maine Turnpike Authority website at www.maineturnpike.com/projects/construction-contracts. The completeness and accuracy of these plans is not guaranteed.
- 6. Chamfer all exposed new concrete edges  $\frac{3}{4}$ " unless otherwise noted.
- 7. At all structures pigmented protective coating for concrete surfaces shall be applied to the following areas:
  - Exposed concrete surfaces of the abutments as shown in these plans.
- 8. At all structures clear protective coating for concrete surfaces shall be applied to the following areas:
  - All exposed median concrete.
  - All overhang and fascia concrete as shown in these plans.
  - All bridge curbs, parapets, and transition barriers as shown in these plans.
- 9. At all structures the bridge seat shall be cleaned before applying pigmented protective coatina.
- 10. The Contractor shall place approach pavement at all locations to achieve a smooth transition between existing and proposed pavement.
- II. Prior to the removal of any pavement, the Contractor shall document the location, type and color of all pavement striping and provide that information to the Resident. The Maine Turnpike Authority will place all new striping at no cost to the Contractor.
- 12. A bead of Hot-Applied Rubberized asphalt sealer shall be applied along curb lines after installation of base course pavement. Payment shall not be made directly but shall be considered incidental to related contract items.

#### EROSION CONTROL NOTES

I. All temporary and permanent erosion control devices shall be installed in accordance with the Maine Department of Transportation Best Management Practices.

#### UTILITIES NOTES

- I. Existing utilities were not located for these plans. No work shall be started until the owners of the various utilities are notified by the Contractor of the proposed construction. The Contractor is also required to call Dig Safe at I-888-344-7233 at least 72 hours prior to the start of the work.
- 2. The Contractor shall contact all non-members through www.OKtoDIG.com or as otherwise required by the Maine Public Utilities Commission. All proposed excavation locations shall be marked at the time of notification. No excavation shall be permitted until the authority has located and marked it's underground utilities. The Resident Engineer shall be provided a digital copy of all Dig Safe tickets within 24 hours of their release for project notifications and 3rd party utility locater coordination.
- 3. The Contractor shall notify the Resident IO calendar days prior to submitting a utility locate request through Dig Safe so that the Resident can arrange for Maine Turnpike underground utility location. All proposed sign locations and excavation locations shall be marked at the notification time.
- 4. Contractor shall protect all existing utilities from damage during the construction as approved by the utility owners.

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					CONSULTANT	PROJEC	CT MANAGER:	G. Edington		
r llendrie						Ву	Date		Ву	Date
2					Designed	MFS	3/26/24	Checked	MÉB	3/26/24
<b>≝</b>					Drawn	TSR	3/26/24	In Charge of	GME	3/26/24

VANASSE HANGEN BRUSTLIN, INC. 500 Southborough Dr. Suite 105B South Portland, ME 04106

**TURNPIKE** TEL (207) 889-3150 FAX (207) 253-5596

MTA PROJECT MANAGER: Ryan Barnes, PE, CPESC




MTA PROJECT NO. 2024.07 BRIDGE REPAIRS

GENERAL NOTES

SHEET NUMBER: VHB: 55729.00

CONTRACT: 2024.07 3 OF 38

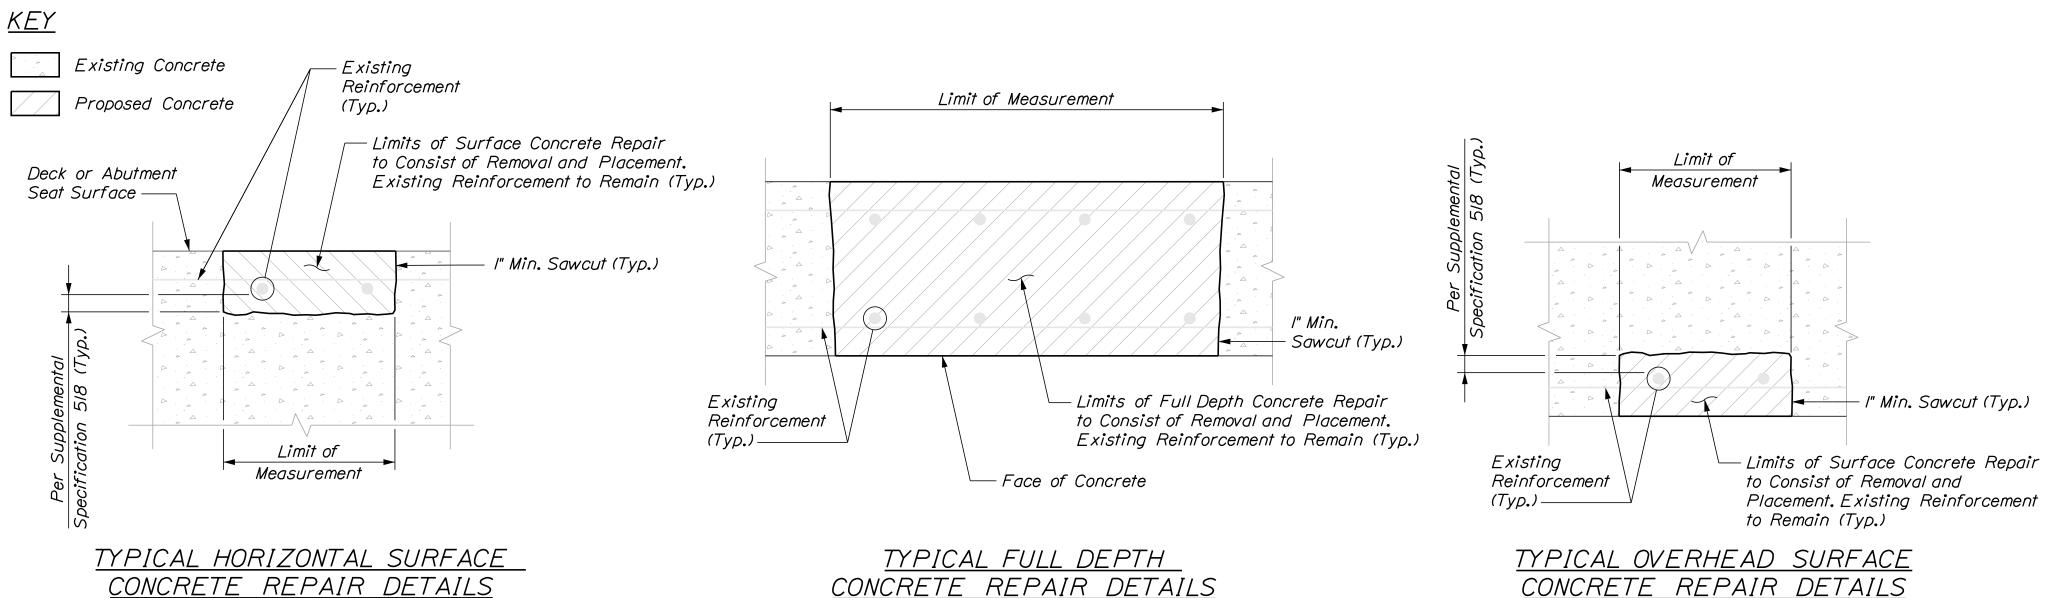

### CONCRETE REPAIR DETAILS

Existing Weep Drain


#### Face of Concrete Per Supplemental - I" Min. Sawcut (Typ.) Specification 518 (Typ.) Limits of Surface Concrete Repair to Consist of Removal and Placement. Existing Reinforcement to Remain (Typ.)

Existing

(Typ.)

Reinforcement

#### TYPICAL VERTICAL SURFACE CONCRETE REPAIR DETAILS

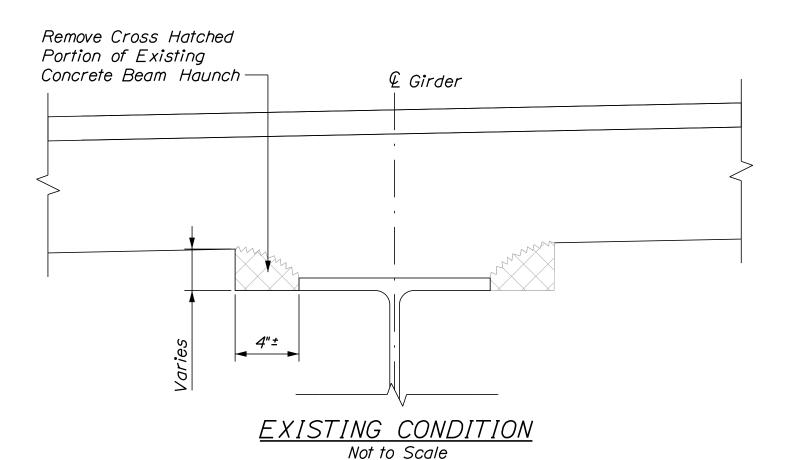


#### CONCRETE REPAIR NOTES

- I. Repair work shall include: surface concrete repairs, epoxy injection crack repair and providing access for inspection.
- 2. Where surface concrete repairs are specified the work shall include removal of unsound concrete and placement and curing of repair materials. Repairs shall be measured for payment under, 202.1211 Removing Existing Girder Haunches, 518.10 Abutment Repairs, 518.70 Repair of Overhead Surfaces <8 inches, 518.81 Full Depth Concrete Deck Repair, 518.80 Partial Depth Concrete Deck Repairs.
- 3. Prior to the start of any concrete repairs the Resident and the Contractor shall sound all concrete surfaces and agree on the repair limits. Estimated repair quantities may increase or decrease at the Resident's discretion.
- 4. The estimated repair quantities are based on inspections completed in September 2023 - October 2023.

#### CONCRETE REPAIR PROCEDURE

- I. Perform I" deep saw cuts along limits of removal.
- 2. Chip concrete to the depth specified in Supplemental Specification 518. If the removal limits change during the demolition process the Contractor shall notify the Resident. The Resident and Contractor shall agree on the revised pay limits prior to the Contractor continuing the removal.
- 3. Prepare and patch repair areas with Class AAA modified concrete or other materials selected from the applicable non-emergency list of materials in Supplemental Specification 518.
- 4. Perform general finishing.

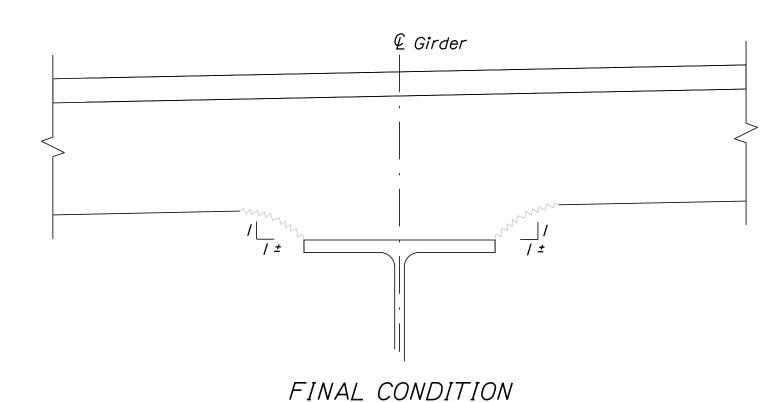

#### CONCRETE HAUNCH REMOVAL DETAILS

for Bituminous W.S. Drain for Bituminous W.S. Existing Concrete Deckmax. See Connection Detail Remove and Replace Concrete if Necessary to Connection Complete Connection Approved by Resident Existing Steel Girder -----Proposed Weep Drain Extension— Note: Deck Reinforcement Not Shown for Clarity

EPOXY INJECTION CRACK REPAIR NOTES

type of repairs proposed.

Crack Repair.

I. All crack repairs shall be completed by an individual qualified and experienced in the

2. All crack repairs shall be completed in accordance with Supplemental Specification 518.

3. Where epoxy injection crack repair is specified the work shall include pressure injection

of cracks I/I6" or more in width. Work shall be paid under Item 518.4 Epoxy Injection

Existing Weep

WEEP DRAIN EXTENSION Not to Scale


WEEP DRAIN CONNECTION DETAIL

#### WEEP DRAIN EXTENSION NOTES:

I. All PVC deck weeps which drain onto piers, abutments or structural steel shall be extended and diverted away from bridge components below deck, and shall extend I ft below bottom flange, as directed by the Resident. Payment shall be made under pay Item 502.70II, Weep Drain Extensions.

#### CONCRETE HAUNCH REMOVAL NOTES

- I. The removal of the portion of the concrete haunch shown shall be paid for at the contract unit price per linear foot under Item 202,1211, Removing Existing Girder Haunch, The Haunch on each side of the girder shall be measured separately for payment.
- 2. If over-removal results, apply two coats of epoxy resin to deck reinforcing steel exposed during haunch removal. All reasonable precautions shall be taken to avoid this condition. Epoxy resin and application shall be incidental to Item 202.1211, Removing Existing Girder Haunch.
- 3. After concrete removal, the exposed concrete shall be sealed with clear protective coating. Clear protective coating and application shall be incidental to Item 202.1211 Removing Existing Girder Haunch.
- 4. Prior to the start of any concrete haunch removal, the Resident and Contractor shall jointly inspect all haunches for removal and agree on the removal limits. Estimated haunch removal quantities may increase or decrease at the Resident's discretion.

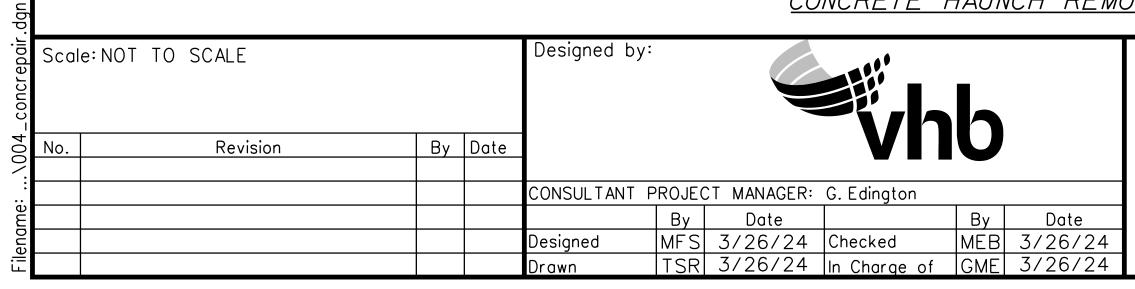

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MTA PROJECT MANAGER: Ryan Barnes, PE, CPESC

Not to Scale



MTA PROJECT NO. 2024.07 BRIDGE REPAIRS

MISCELLANEOUS REPAIR DETAILS

SHEET NUMBER: VHB: 55729.00

CONTRACT: 2024.07 4 OF 38

#### MAINTENANCE OF TRAFFIC GENERAL NOTES

- I. All traffic control equipment and devices shall conform to the 2014 edition of the Maine Department of Transportation (MaineDOT) Standard Specifications, Maine Turnpike Authority (MTA) Supplemental Specifications, contract specifications and applicable traffic control standards and practices.
- 2. Any signs, equipment, or devices found to be damaged or unserviceable shall be replaced at the Contractor's expense.
- 3. Temporary lane closures will be required, with advanced approval, whenever work will occur within four feet of the traveled way. Temporary lane closures shall be removed if no work is occurring. See Special Provisions for more information including available lane closure times.
- 4. Lane closure requests shall be submitted by the Resident by Noon on the Thursday prior to the week of the proposed lane closures. The Contractor shall plan all lane closure requests accordingly.
- 5. Approach ends of temporary concrete barrier shall be placed outside of the highway clear zone (minimum 34 feet from the traveled way) or protected by temporary impact attenuators or with quardrail overlaps as approved by the Resident.
- 6. Maximum spacing for channelizing devices (drums) shall be:
  - 80' on center along tangents
  - 40' on center along tapers
- 7. Work zone speed limits shall only be permitted when temporary lane closures are in place.
- 8. Construction along mainline Falmouth Spur shall not occur for the Gray Road (Route 26 & 100) Underpass at the same time as the Blackstrap Road Overpass/MCRR Overpass.

#### ST. LAWRENCE & ATLANTIC RAILROAD NOTES

- I. Mainline work shall follow the MTA standard details for any shoulder closures.
- 2. A left lane closure and a right lane closure site specific traffic control plans have been shown with temporary barrier.
- 3. With the use of the temporary concrete barrier, the travel lane can only be 13 feet wide, therefore the lane closure must be combined with a wide load detour to avoid the narrow section required for the bridge repairs.
- 4. Work zone speed limit shall be 60 mph.

#### BLACKSTRAP ROAD OVERPASS AND MCRR OVERPASS NOTES

- I. A left lane closure and a right lane closure traffic control plan has been shown with temporary barrier. Due to the proximity of the on-ramp a site specific traffic control plan has been provided.
- 2. If the work at the Blackstrap Road Overpass and MCRR Overpass is completed at different times for both bridges, the temporary barrier for the bridge that is not being worked on may be omitted.
- 3. Work zone speed limit shall be 45 mph.

#### GRAY ROAD (ROUTE 26 & 100) UNDERPASS NOTES

- I. Westbound Falmouth Spur mainline lane closures for haunch removal shall follow standard single lane closures for both the outside and median lanes. See maintenance of traffic details.
- 2. Work zone speed limit along Falmouth Spur mainline shall be 50 mph.
- 3. Eastbound Falmouth Spur mainline lane closure for haunch removal shall follow the site specific plans.
- 4. Gray Road surface repairs shall be completed using flagging traffic control; see attached plan.

#### GRAY ROAD (ROUTE 26 & 100) SINGLE LANE CLOSURE / SHOULDER CLOSURE

CON	STRUCT	ION SIC	GN SUMI	MARY
		mensions hes)		
Sign	Letter Height	Vertical Spacing	Size	Quantity and Color
G20-2 END ROAD WORK	Shall C	mensions Conform andard way	36"x18"	2 - Black on Orange
W20-1 ROAD WORK AHEAD	Signs"	- 2012	36" x 36"	2 - Black on Orange
W20-4 ONE LANE ROAD AHEAD			36"x36"	2 - Black on Orange
W20-7			36"x36"	2 - Black on Orange

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No.	Revision	Ву	Date	1			VII	U	
				CONSULTANT	PROJE(	CT MANAGER:	G. Edington		
					Ву	Date		Ву	Date
				Designed	MLG	3/26/24	Checked	MDS	3/26/24
				Drawn	JAR	3/26/24	In Charge of	GME	3/26/24



MTA PROJECT NO. 2024.07
BRIDGE REPAIRS
MAINTENANCE OF TRAFFIC DETAILS
(01 OF 03)


VHB: 55729.00 SHEET NUMBER: 5
CONTRACT: 2024.07 5 0F 38

MTA PROJECT MANAGER: Ryan Barnes, PE, CPESC


#### TEMPORARY SINGLE LANE CLOSURES (CONT.)

	CON	STRUCT	ION SIC	GN SUMM	ARY
			mensions hes)		
S	ign	Letter Height	Vertical Spacing	Size	Quantity and Color
W4-2L		Shall C to "Sto High	Hensions Conform andard hway	48"x48"	8 - Black on Orange
W4-2R		Signs"	- 2012	48" x 48"	8 - Black on Orange
W4-5aP	NO MERGE AREA			24"x30"	I - Black on Orange
W5-4	RAMP			48" x 48"	2 - Black on Orange
W13-4p	ON RAMP			36"x36"	2 - Black on Orange
W20-1	ROAD WORK 1 MILE			48" x 48"	6 - Black on Orange
W2O-I (AHEAD)	ROAD WORK AHEAD			48" x 48"	4 - Black on Orange
W20-5L	LEFT LANE CLOSED 1/2 MILE			48" x 48"	6 - Black on Orange
W2O-5L (AHEAD)	LEFT LANE CLOSED AHEAD			48" x 48"	4 - Black on Orange
W20-5R	RIGHT LANE CLOSED 1/2 MILE			48" x 48"	6 - Black on Orange
W2O-5R (AHEAD)	RIGHT LANE CLOSED AHEAD	,		48" x 48"	4 - Black on Orange
CS-I	WIDE LOADS OVER 10 FEET PROHIBITED ON SO NORTH USE EXIT 63	See	Detail	78" x78"	I - Black on Orange
CS-2	WIDE LOADS OVER 10 FEET PROHIBITED ON SS NORTH USE 202 EAST	See	Detail	78" x78"	2 - Black on Orange
CS-3	EXPECT STOPPED TRAFFIC	7" 7" 7"	4" 4"	48" x 48"	6 - Black on Orange
CS-4	WIDE LOADS OVER 10 FEET PROHIBITED ON SS SOUTH USE 202 WEST	See	Detail	78" x78"	3 - Black on Orange
CS-5	WIDE LOADS OVER 10 FEET PROHIBITED ON  93 SOUTH USE EXIT 75	See	Detail	78"x78"	I - Black on Orange


#### CS-I GUIDESIGN LAYOUT

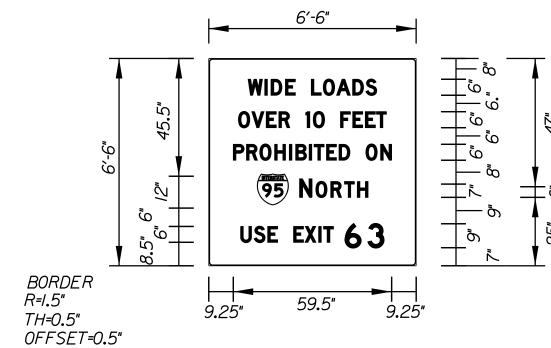


#### CS-5 GUIDESIGN LAYOUT

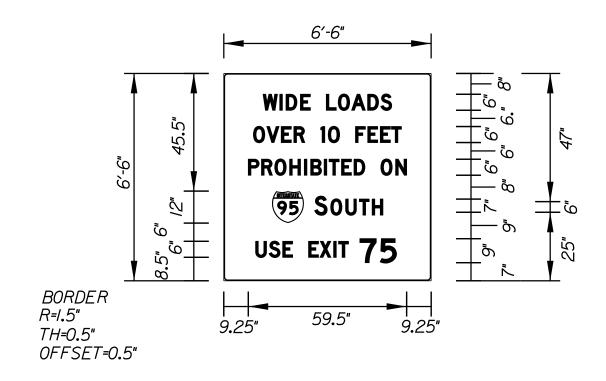


#### CS-2 GUIDESIGN LAYOUT

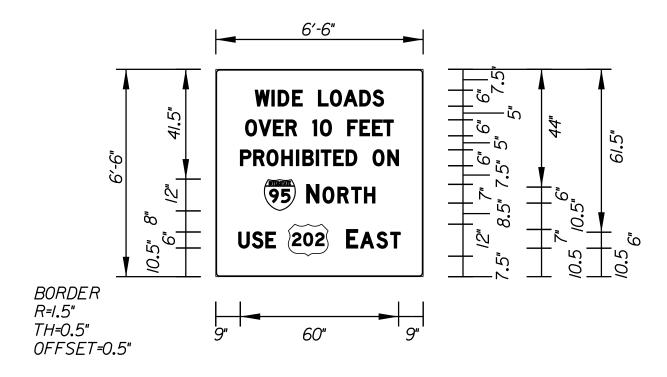

#### CS-4 GUIDESIGN LAYOUT

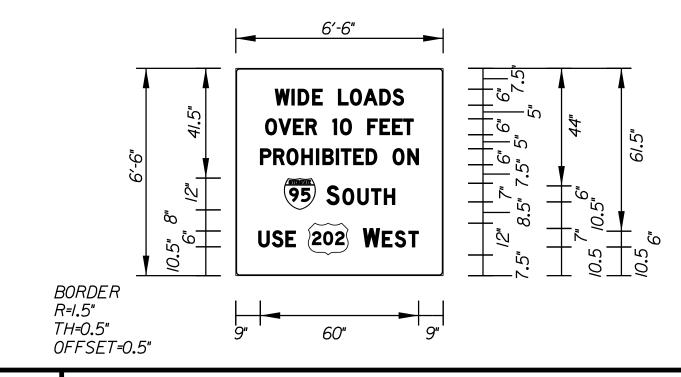

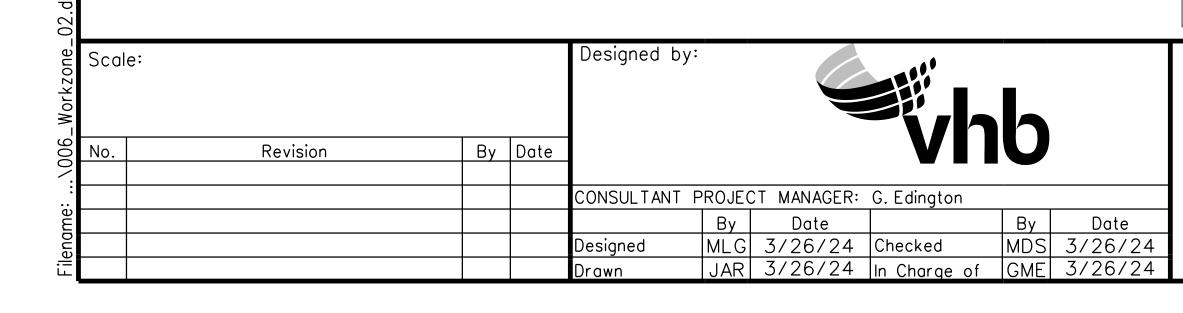


48" x 48"

I - Black on Orange

W4-IR

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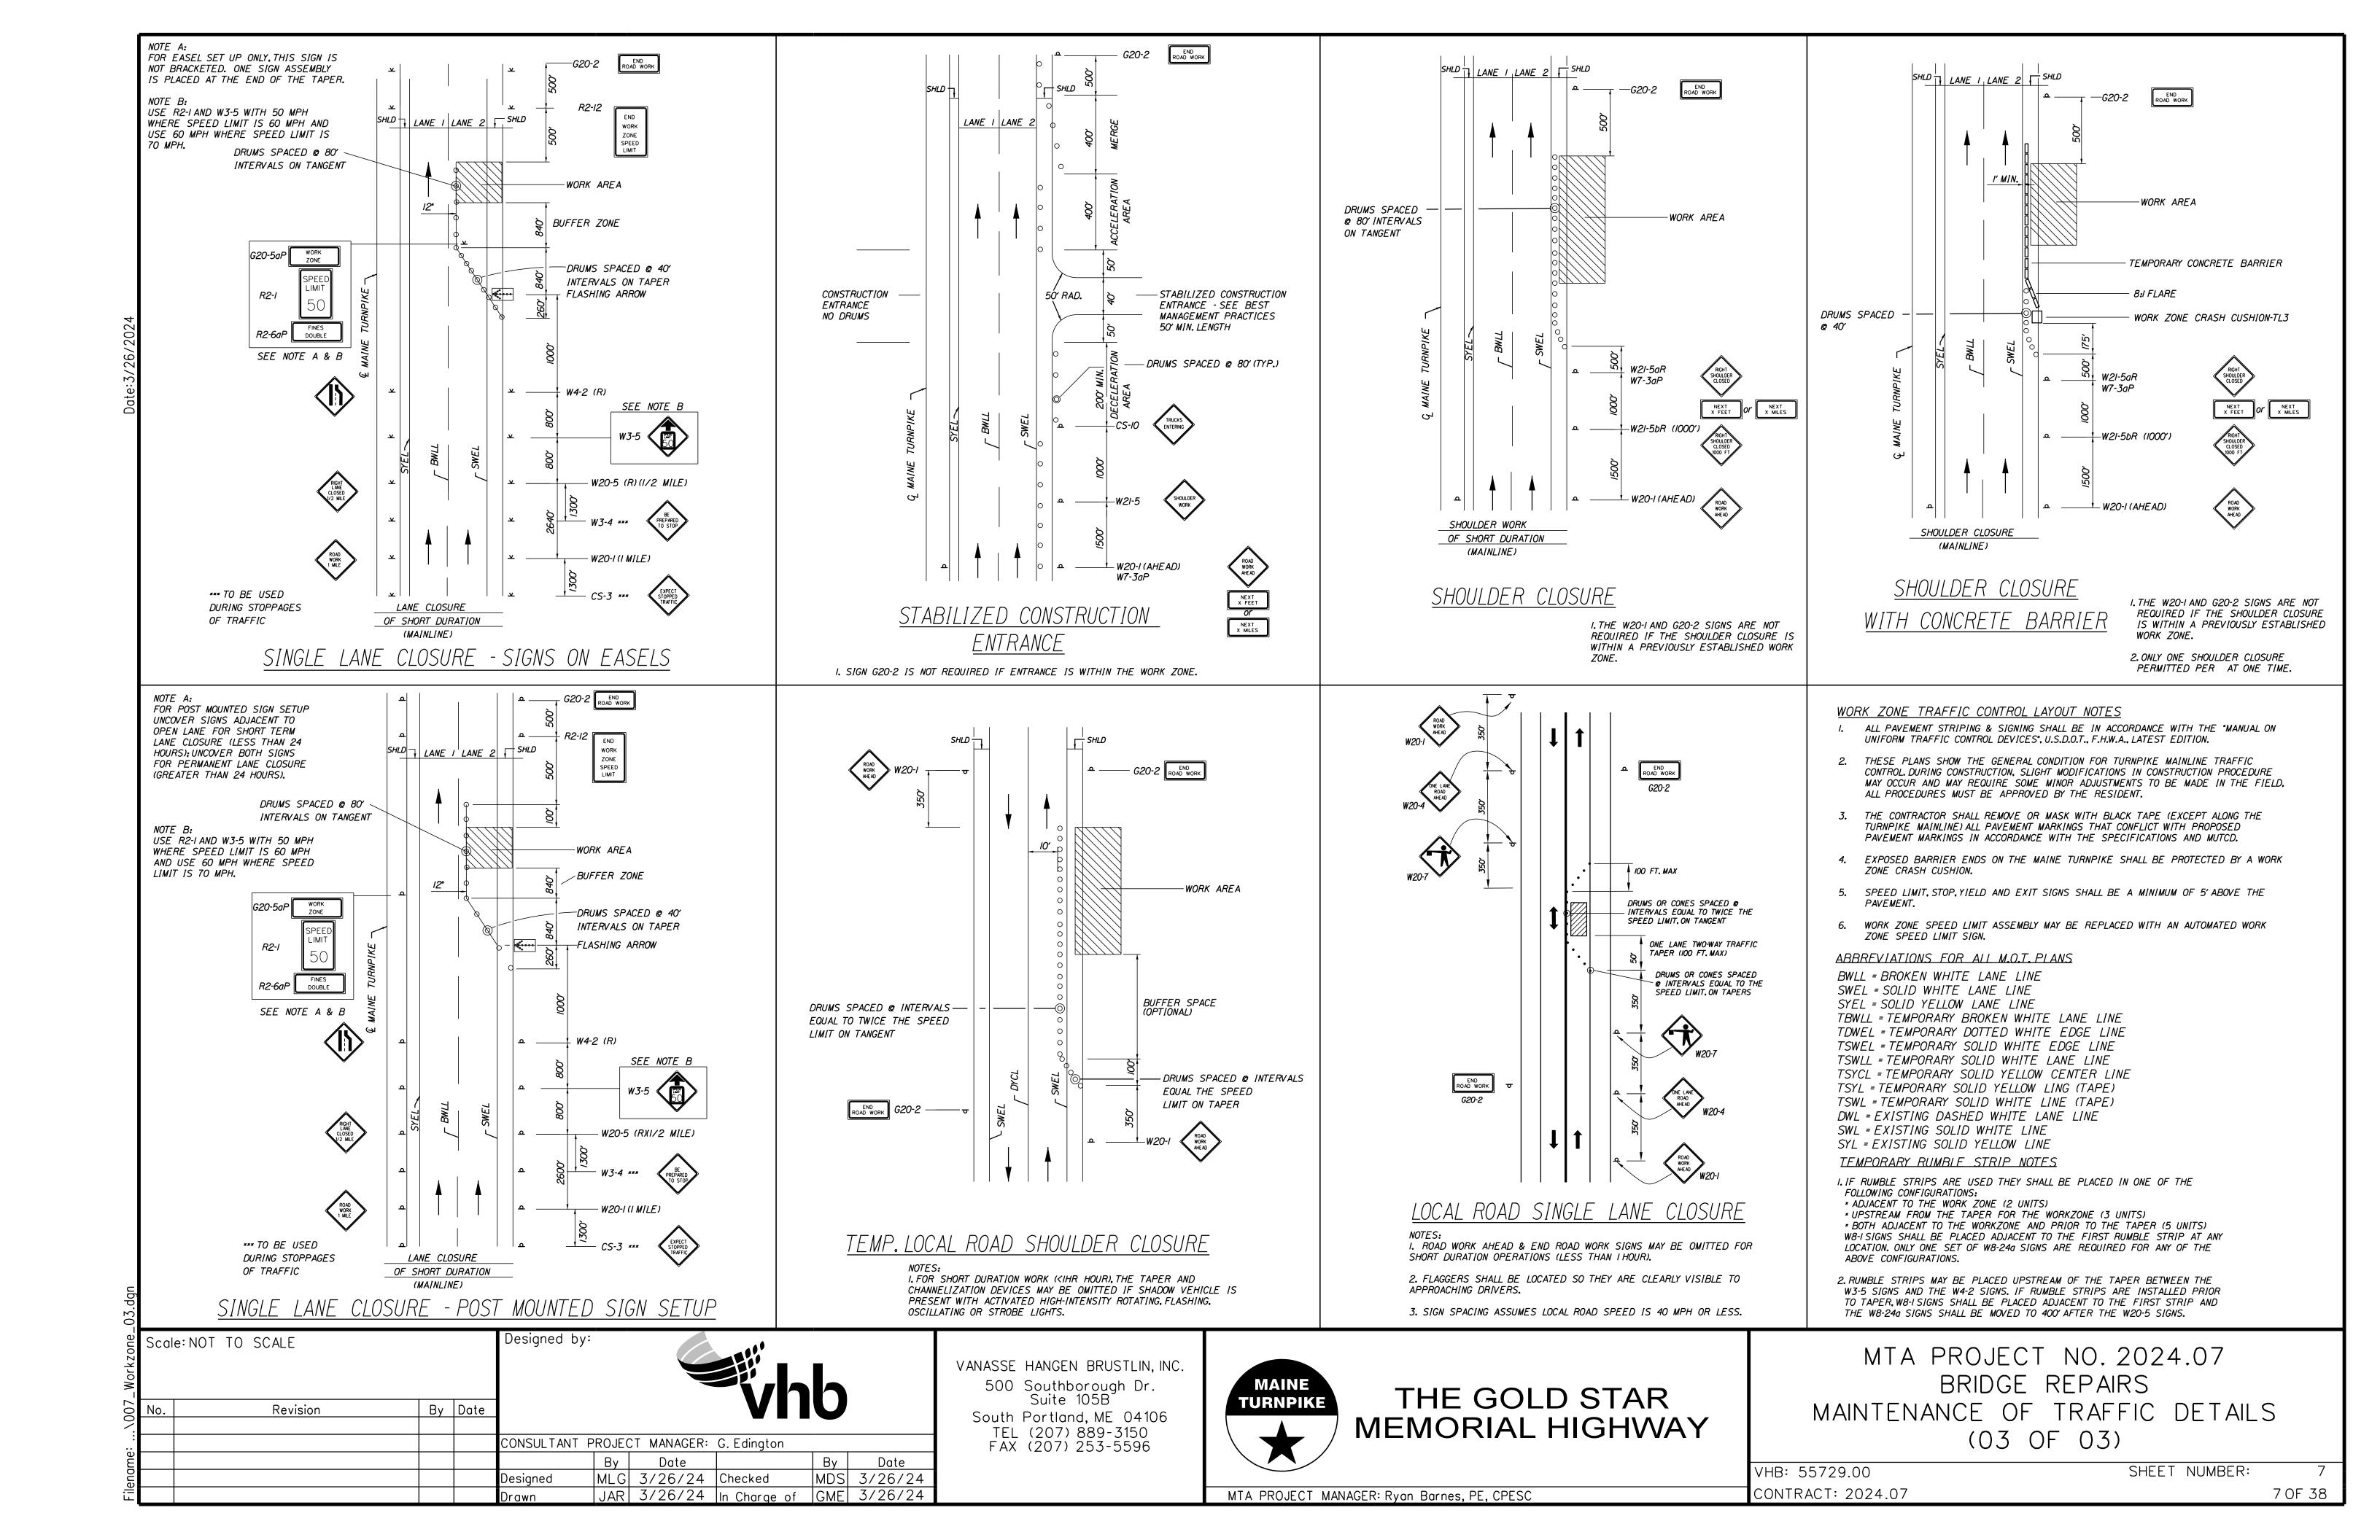



### THE GOLD STAR MEMORIAL HIGHWAY

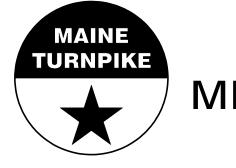MTA PROJECT NO. 2024.07 BRIDGE REPAIRS MAINTENANCE OF TRAFFIC DETAILS (02 OF 03)

SHEET NUMBER: VHB: 55729.00 CONTRACT: 2024.07 6 OF 38

MTA PROJECT MANAGER: Ryan Barnes, PE, CPESC



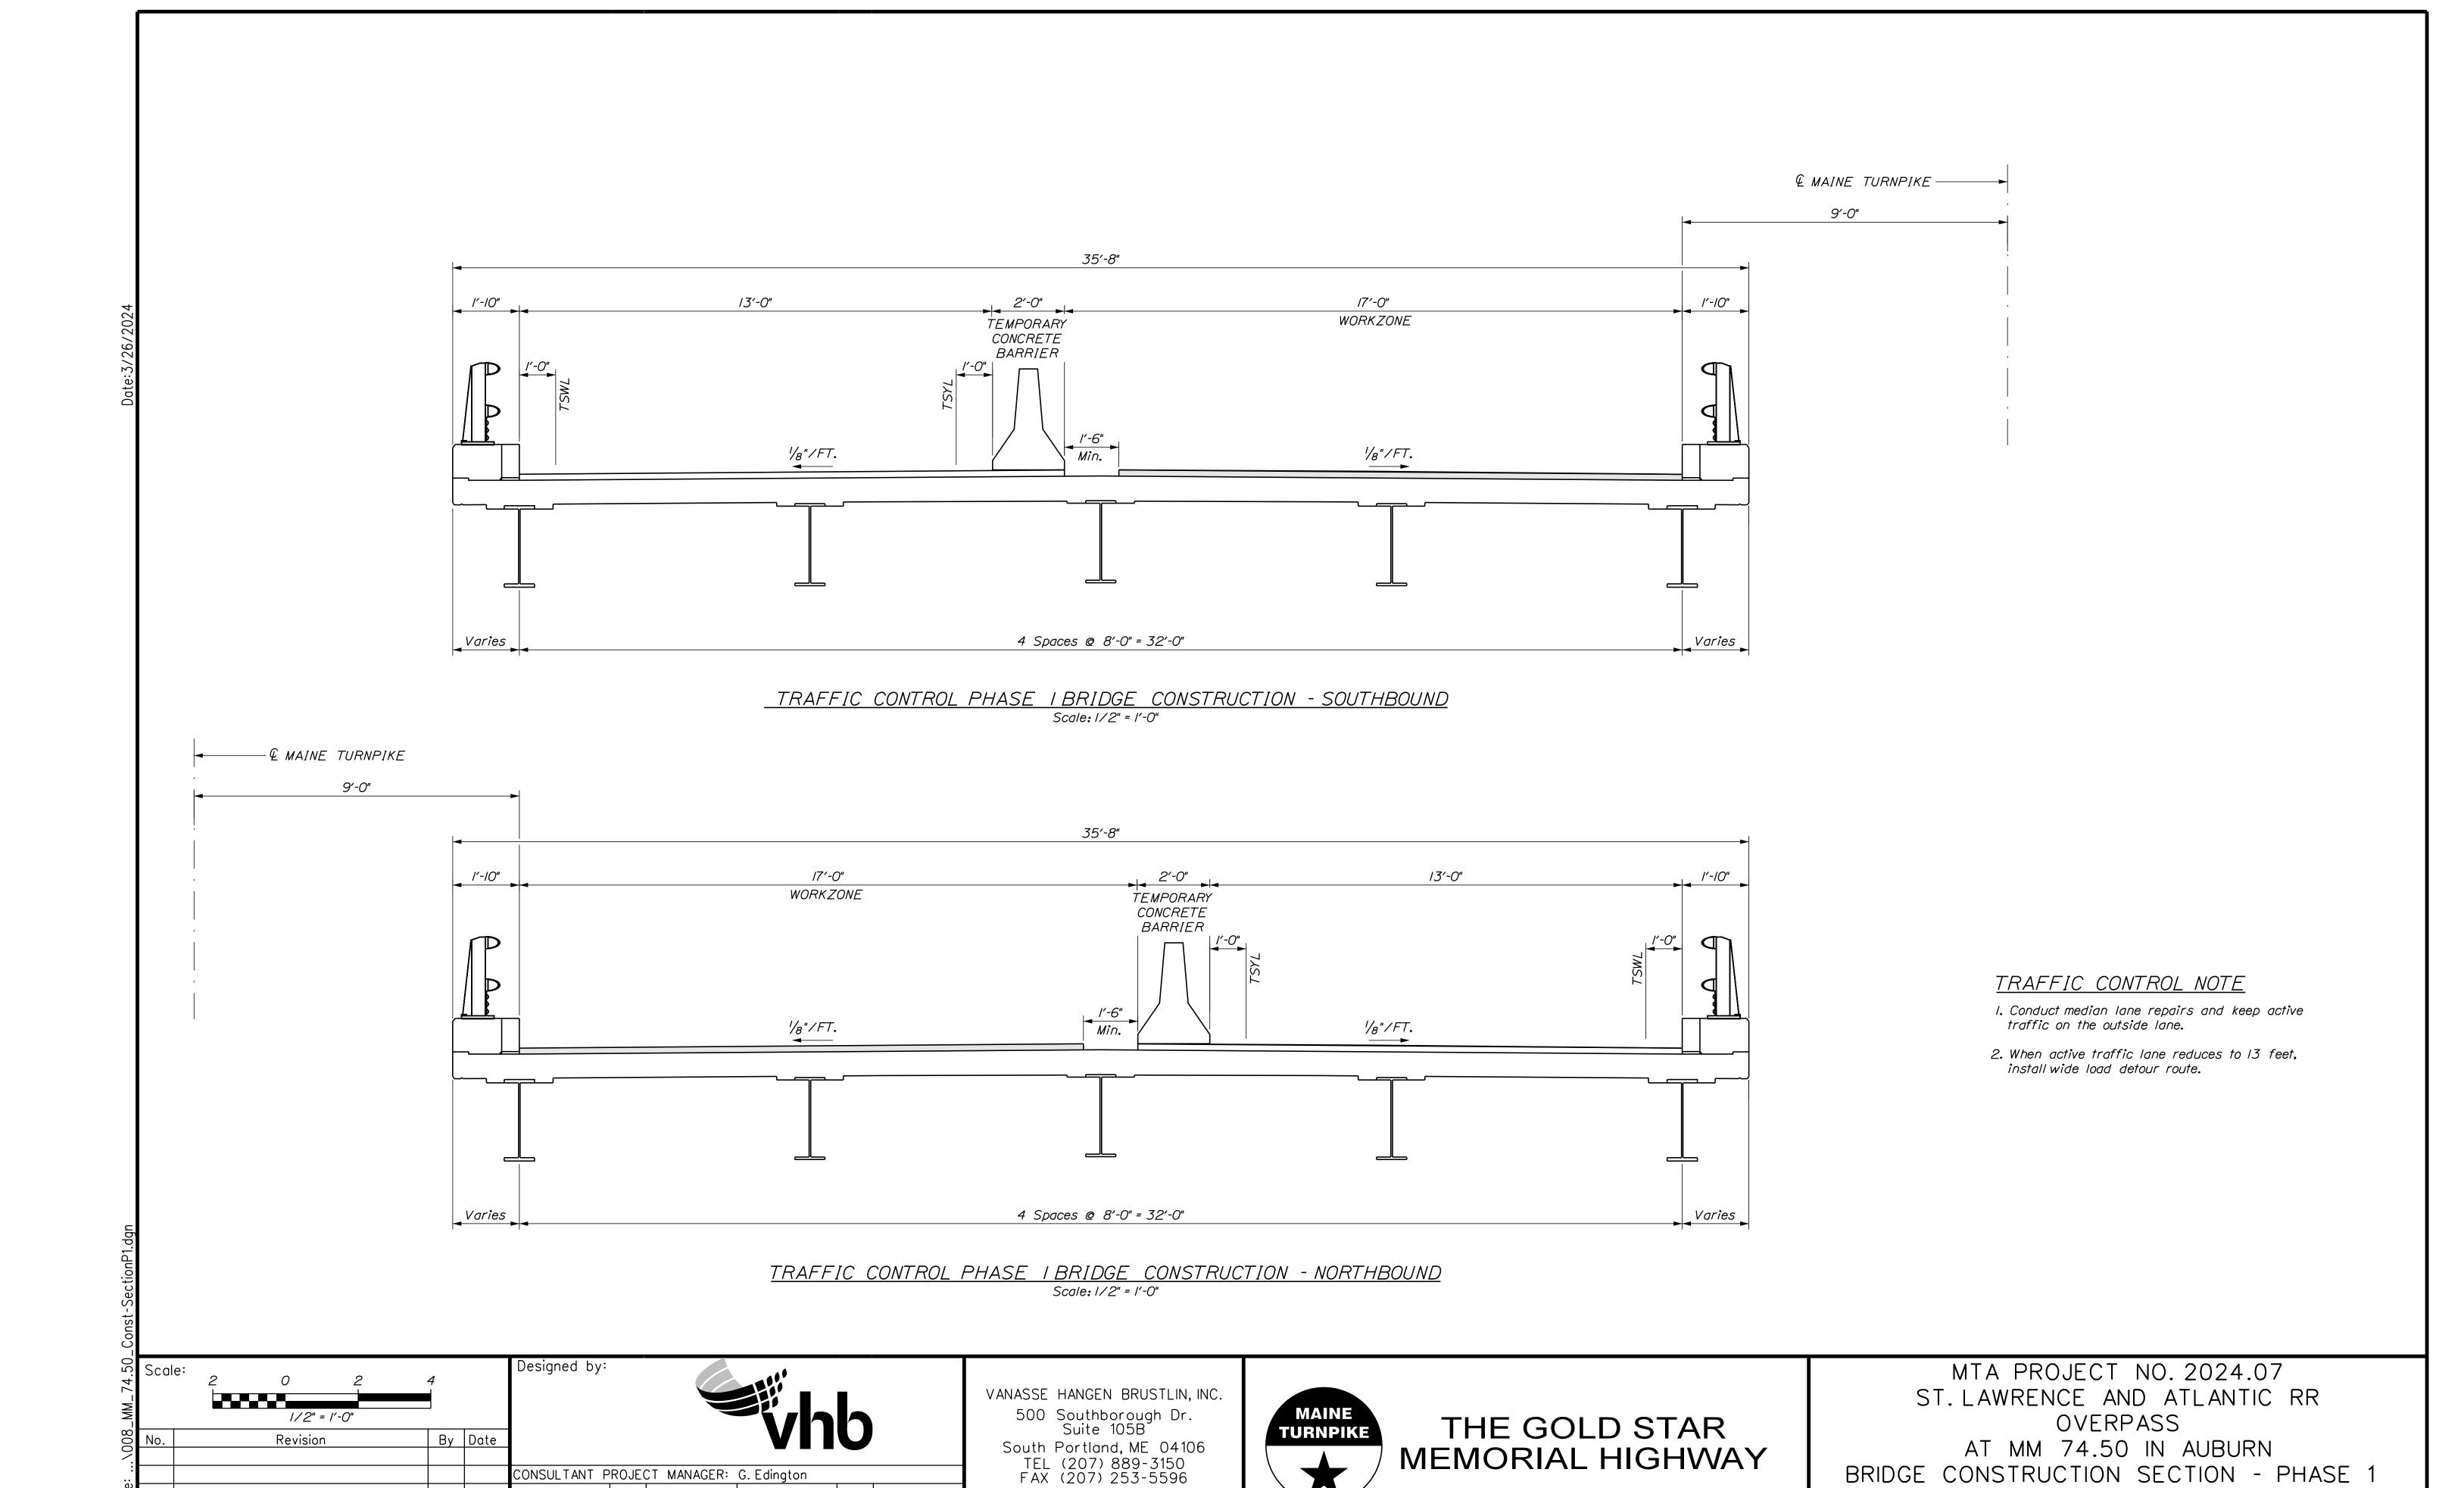

MTA PROJECT MANAGER: Ryan Barnes, PE, CPESC

SHEET NUMBER:

8 OF 38

VHB: 55729.00

CONTRACT: 2024.07

CONSULTANT PROJECT MANAGER: G. Edington


Designed

Date

MLG 3/26/24 Checked

JAR 3/26/24 In Charge of GME 3/26/24

By Date MDS 3/26/24

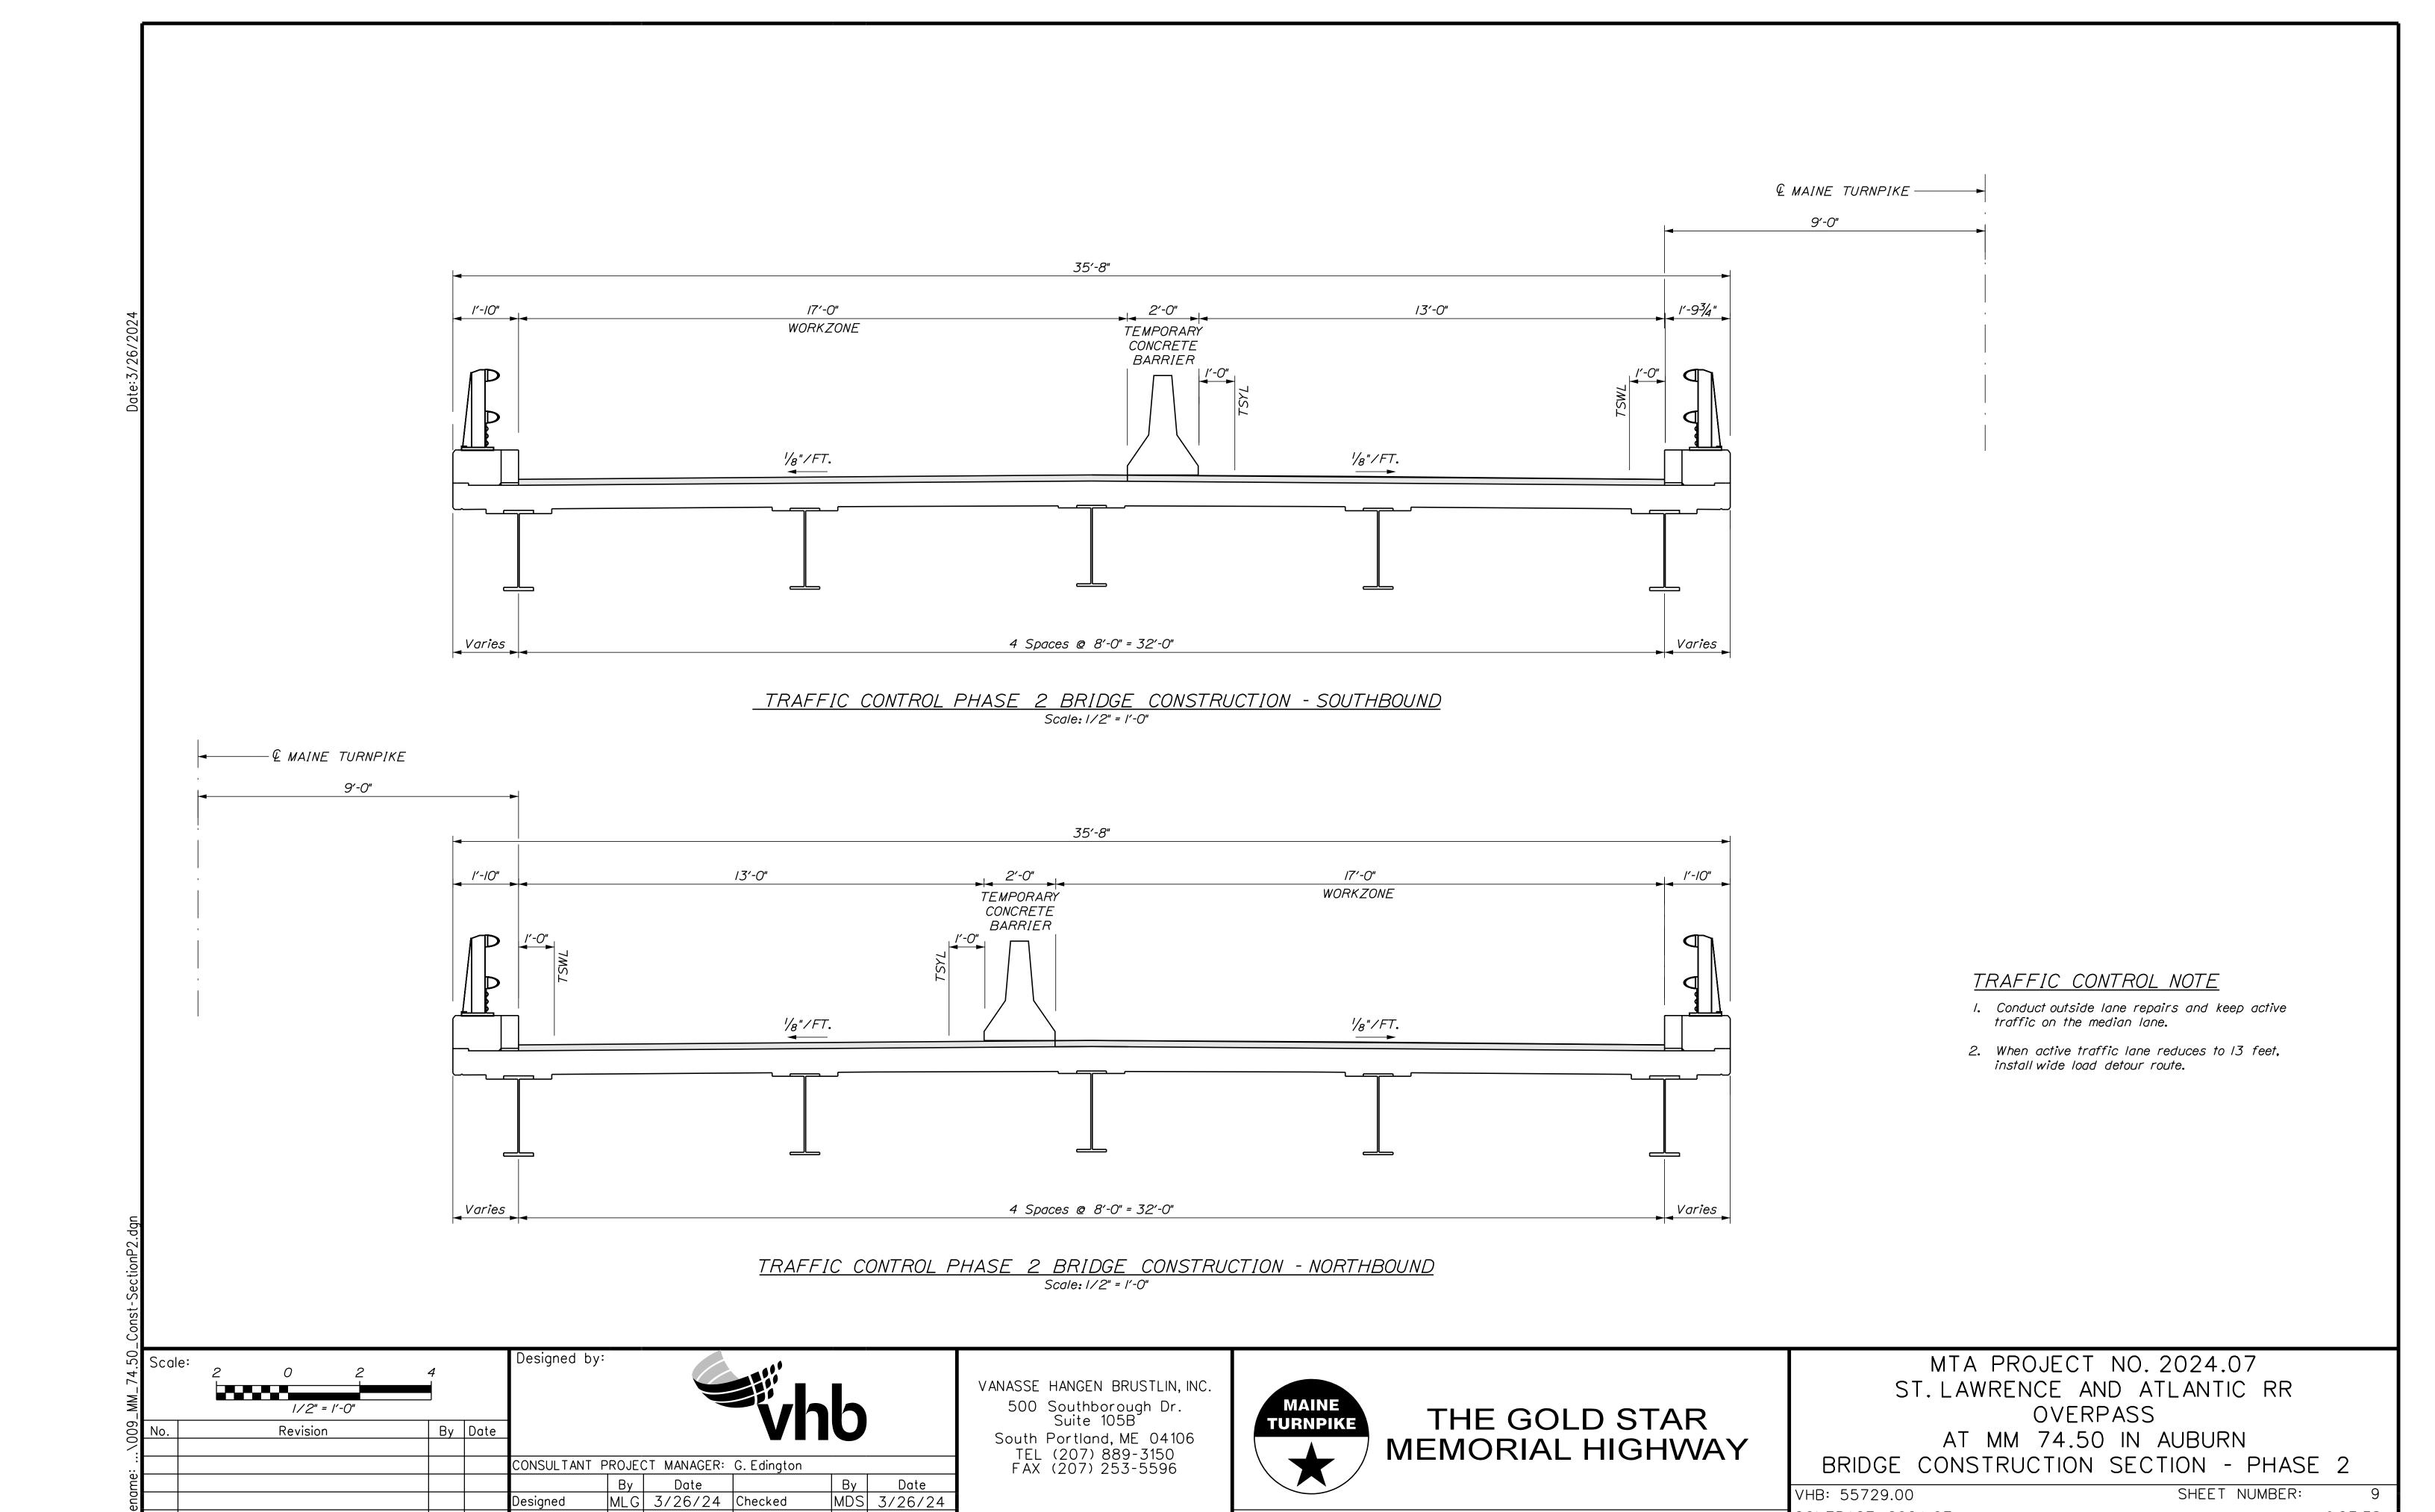



MTA PROJECT MANAGER: Ryan Barnes, PE, CPESC


JAR 3/26/24 In Charge of GME 3/26/24


CONTRACT: 2024.07

9 OF 38

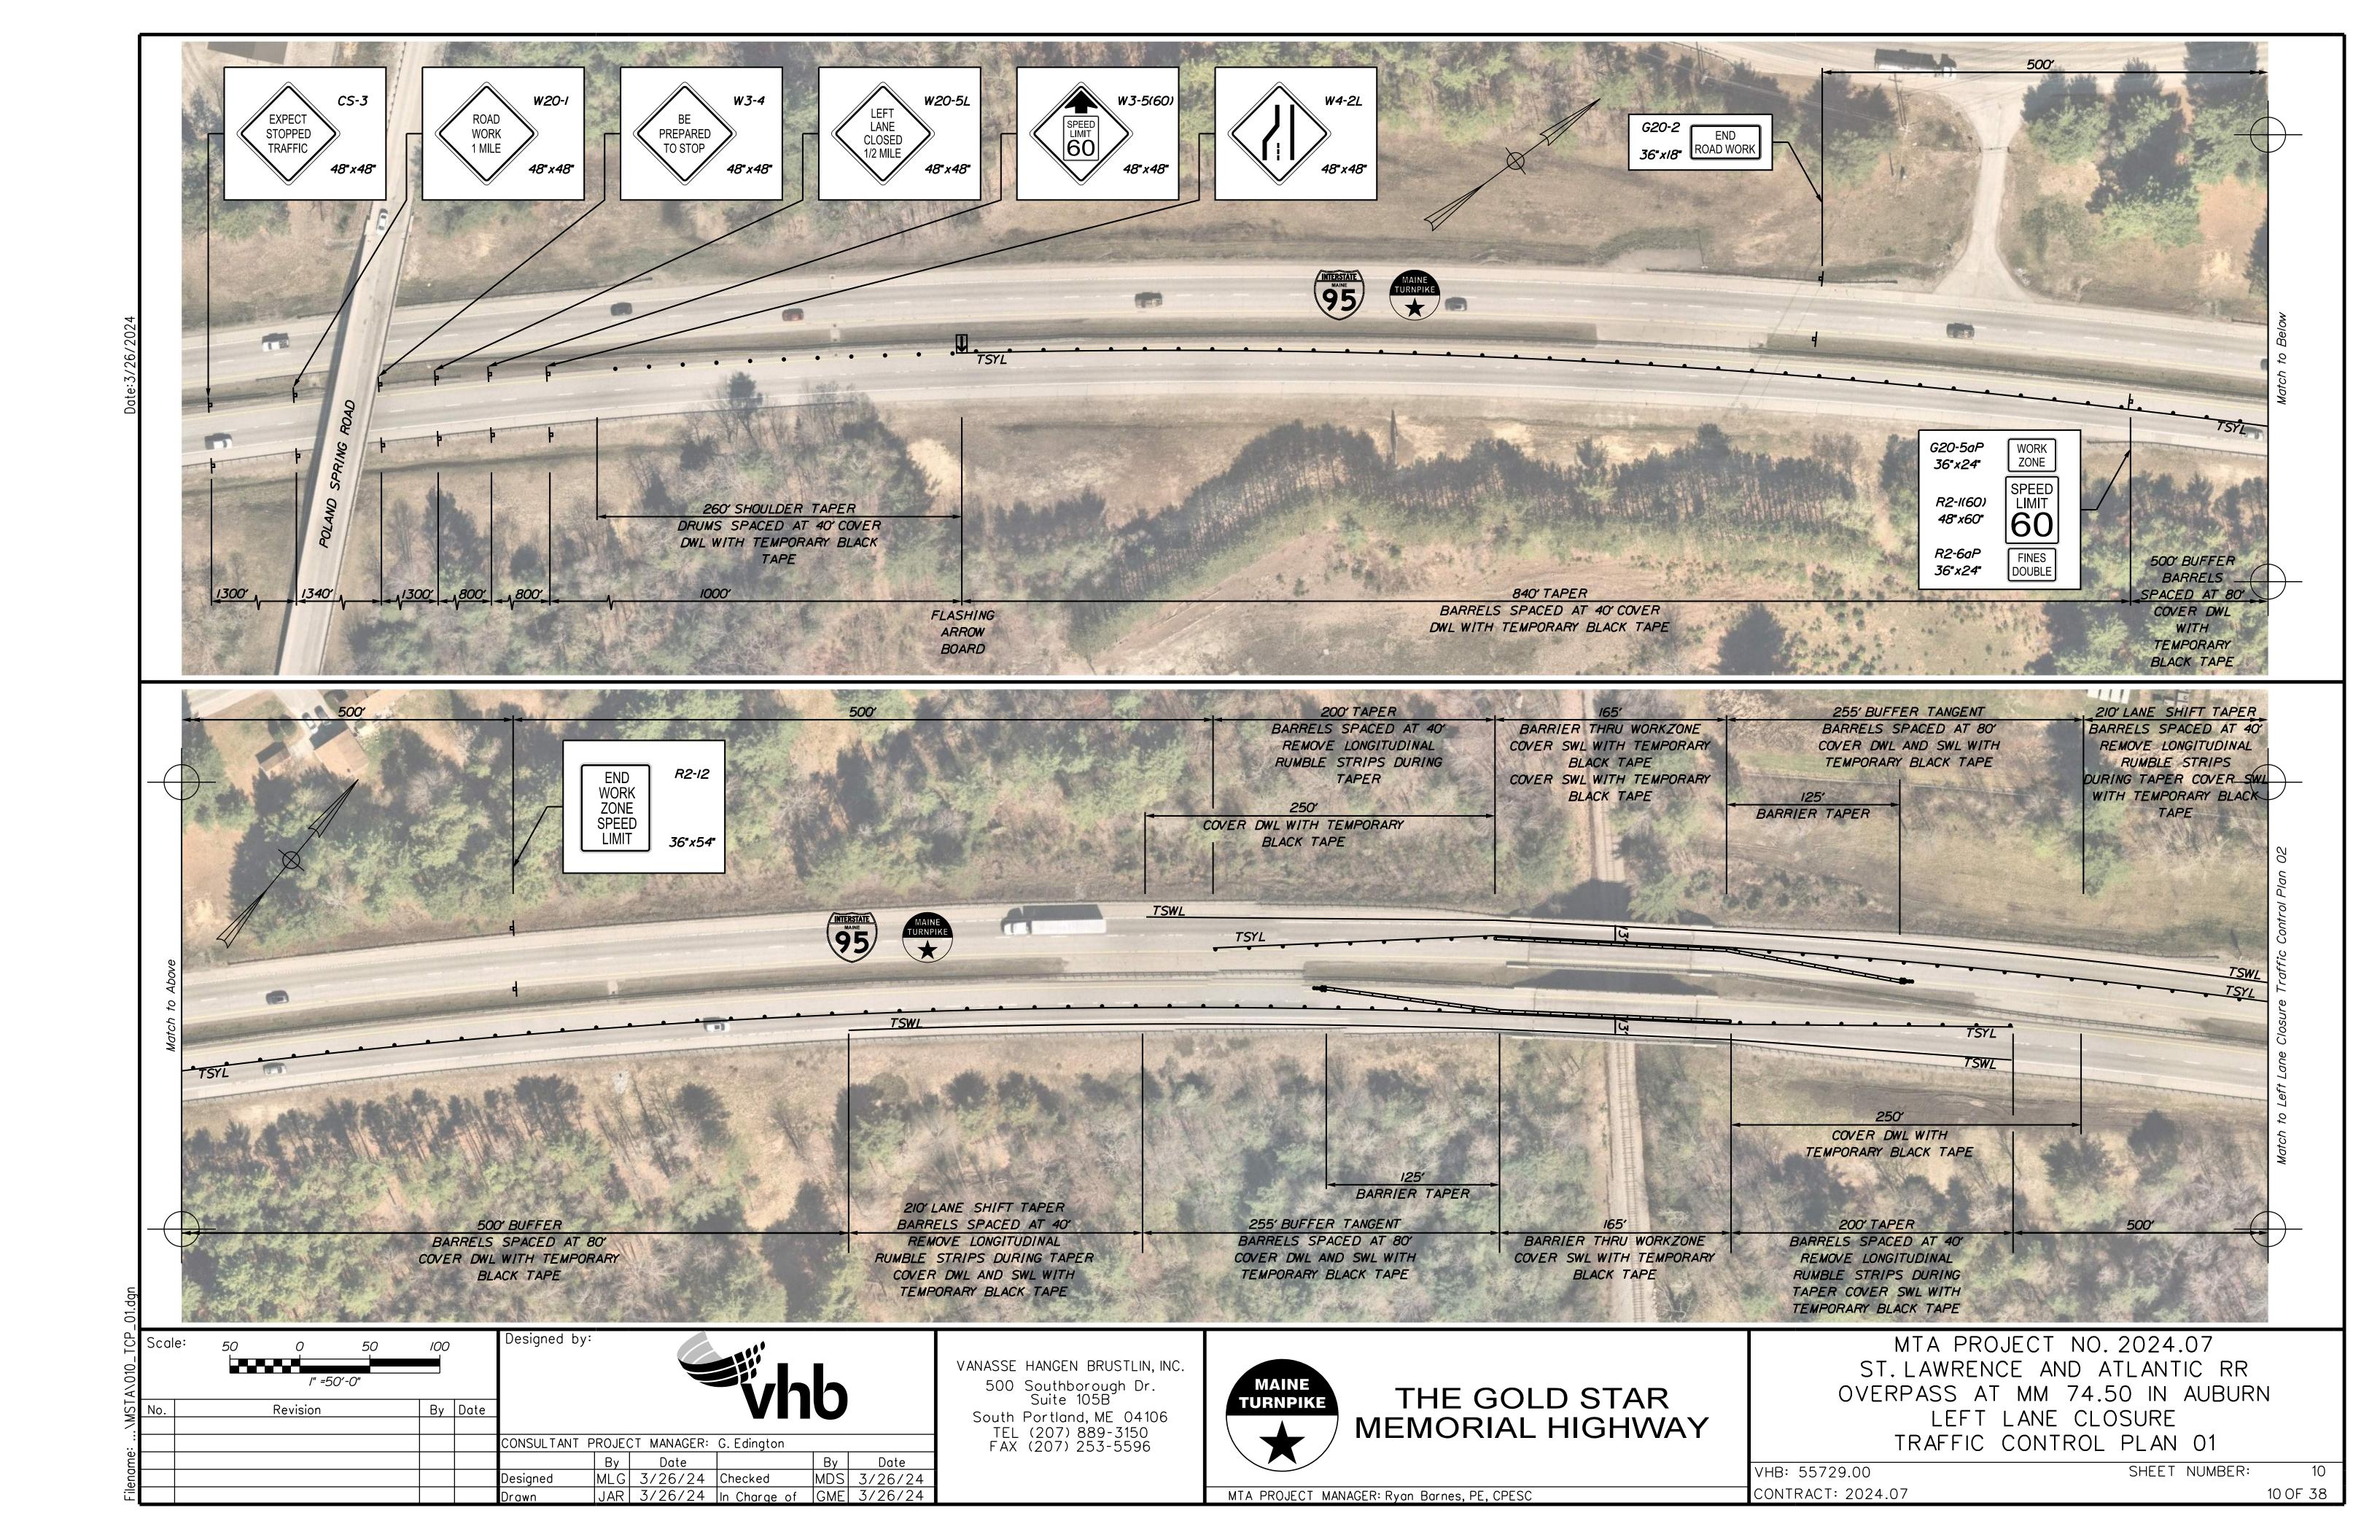

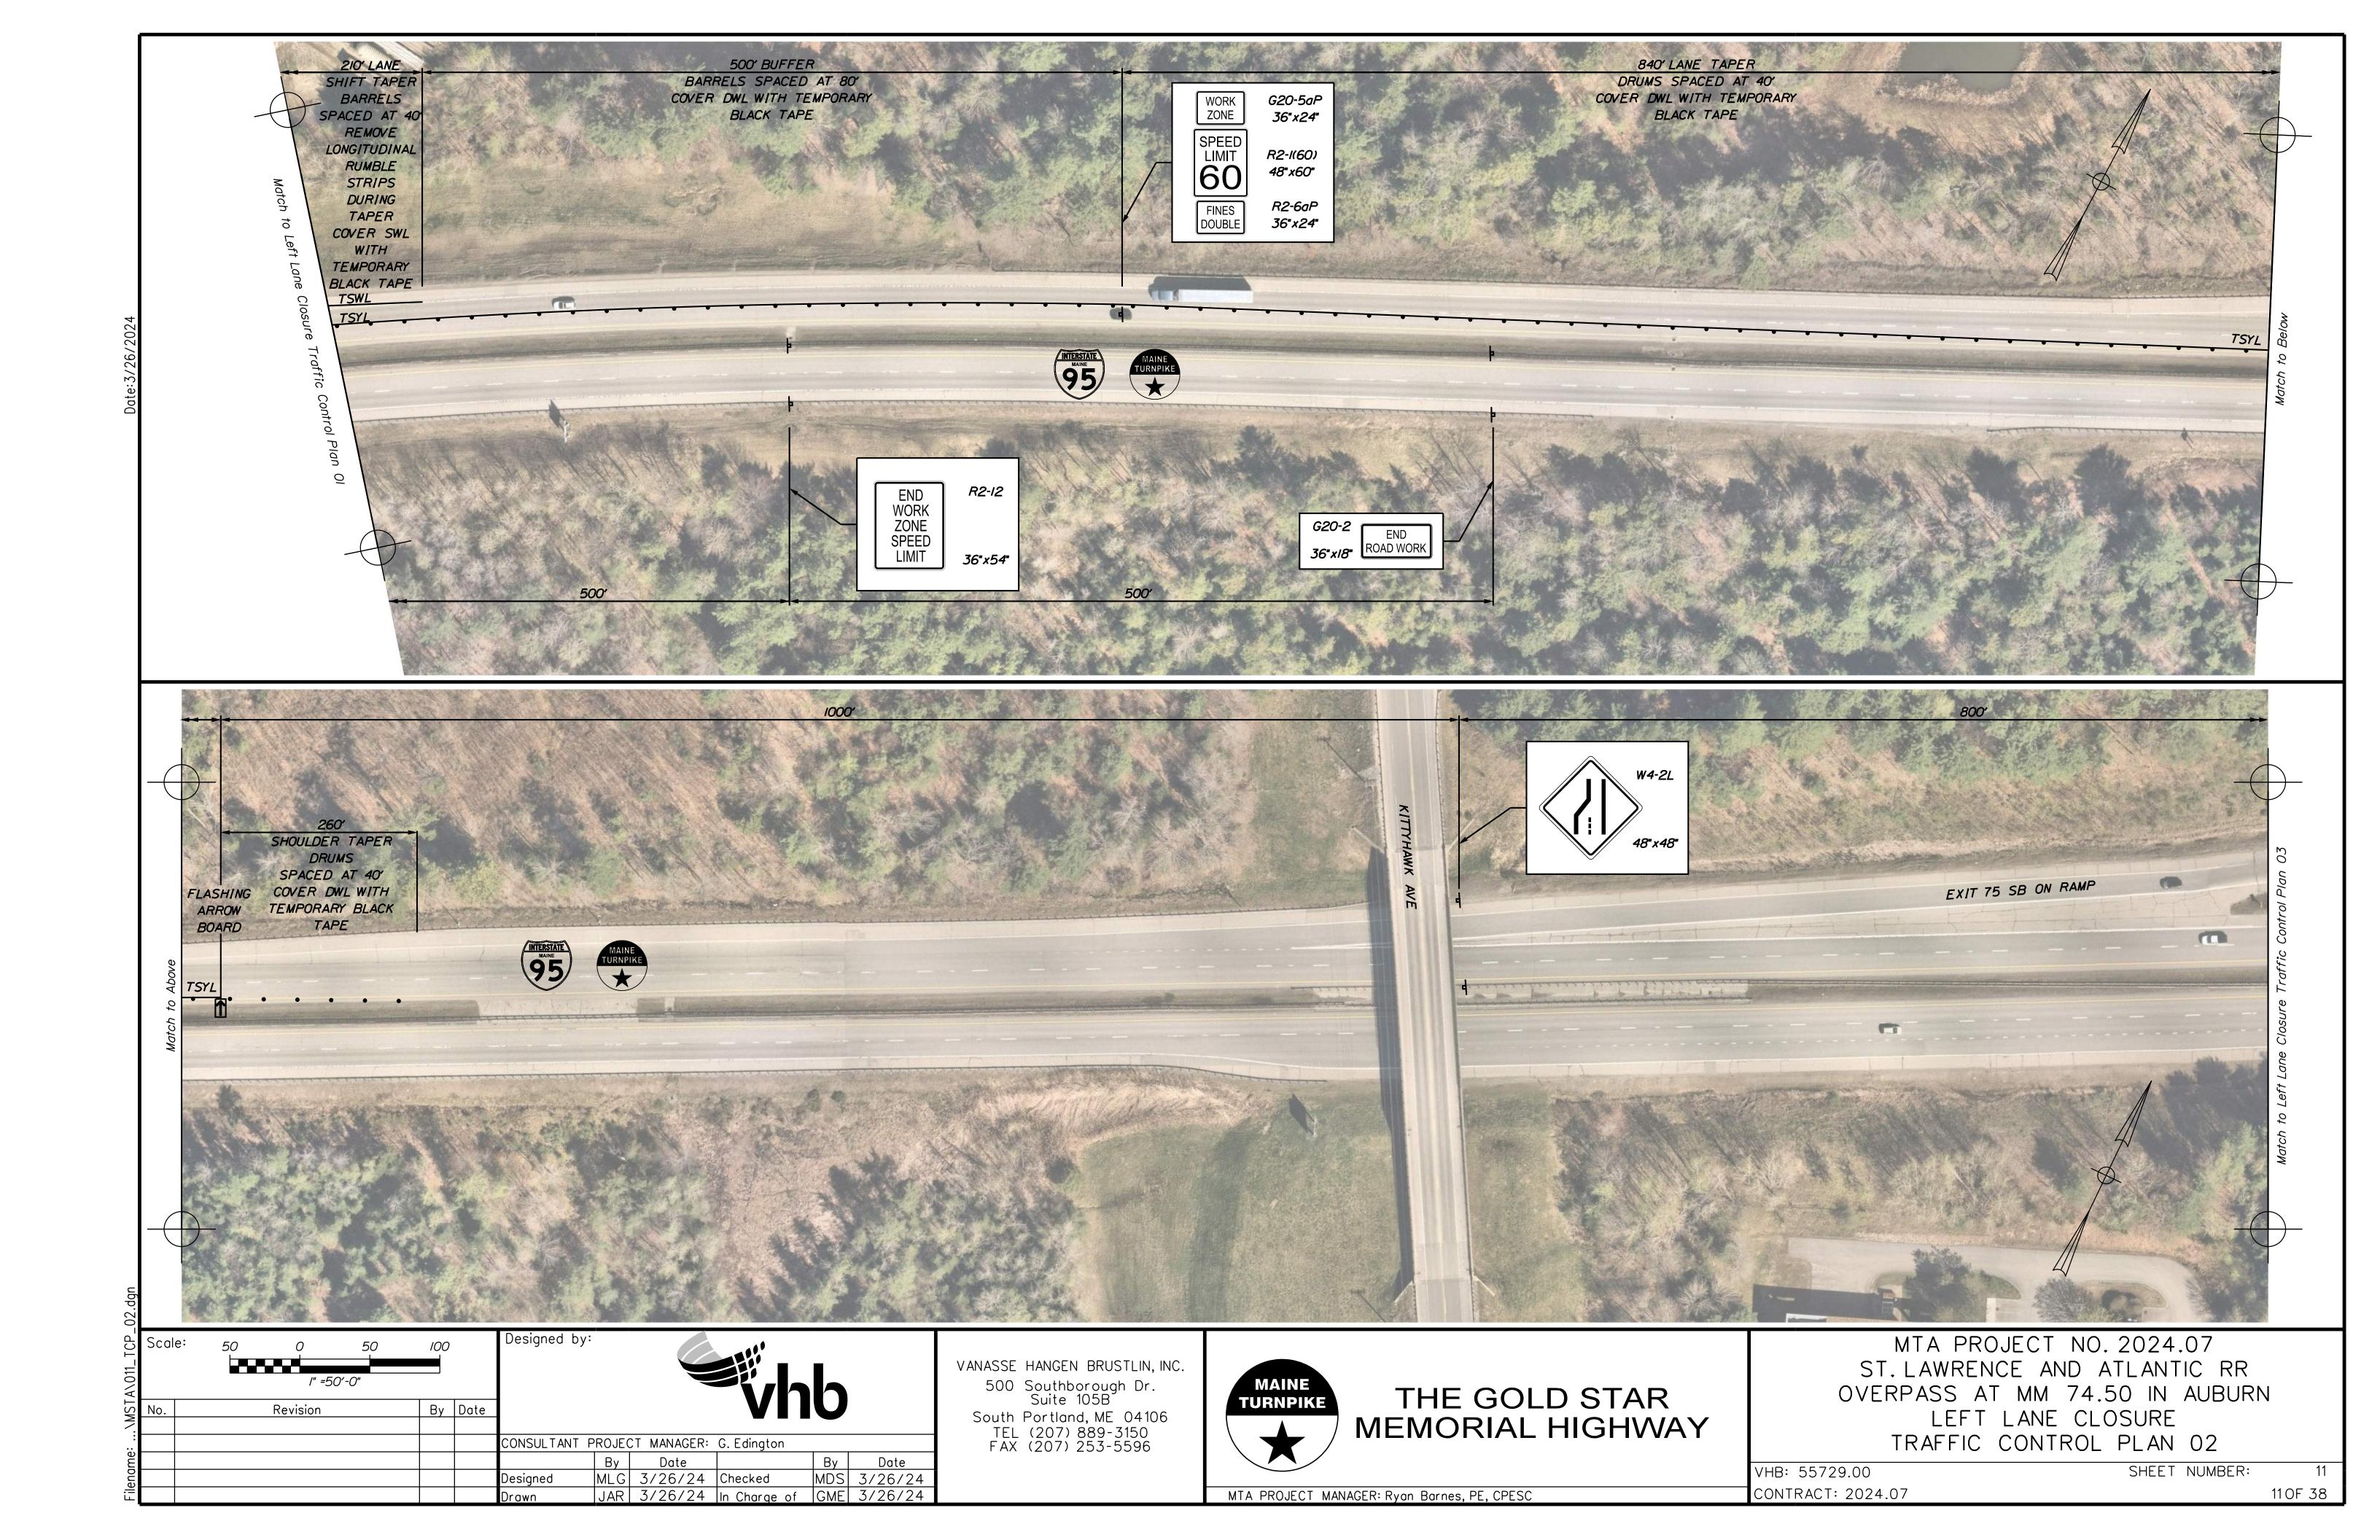

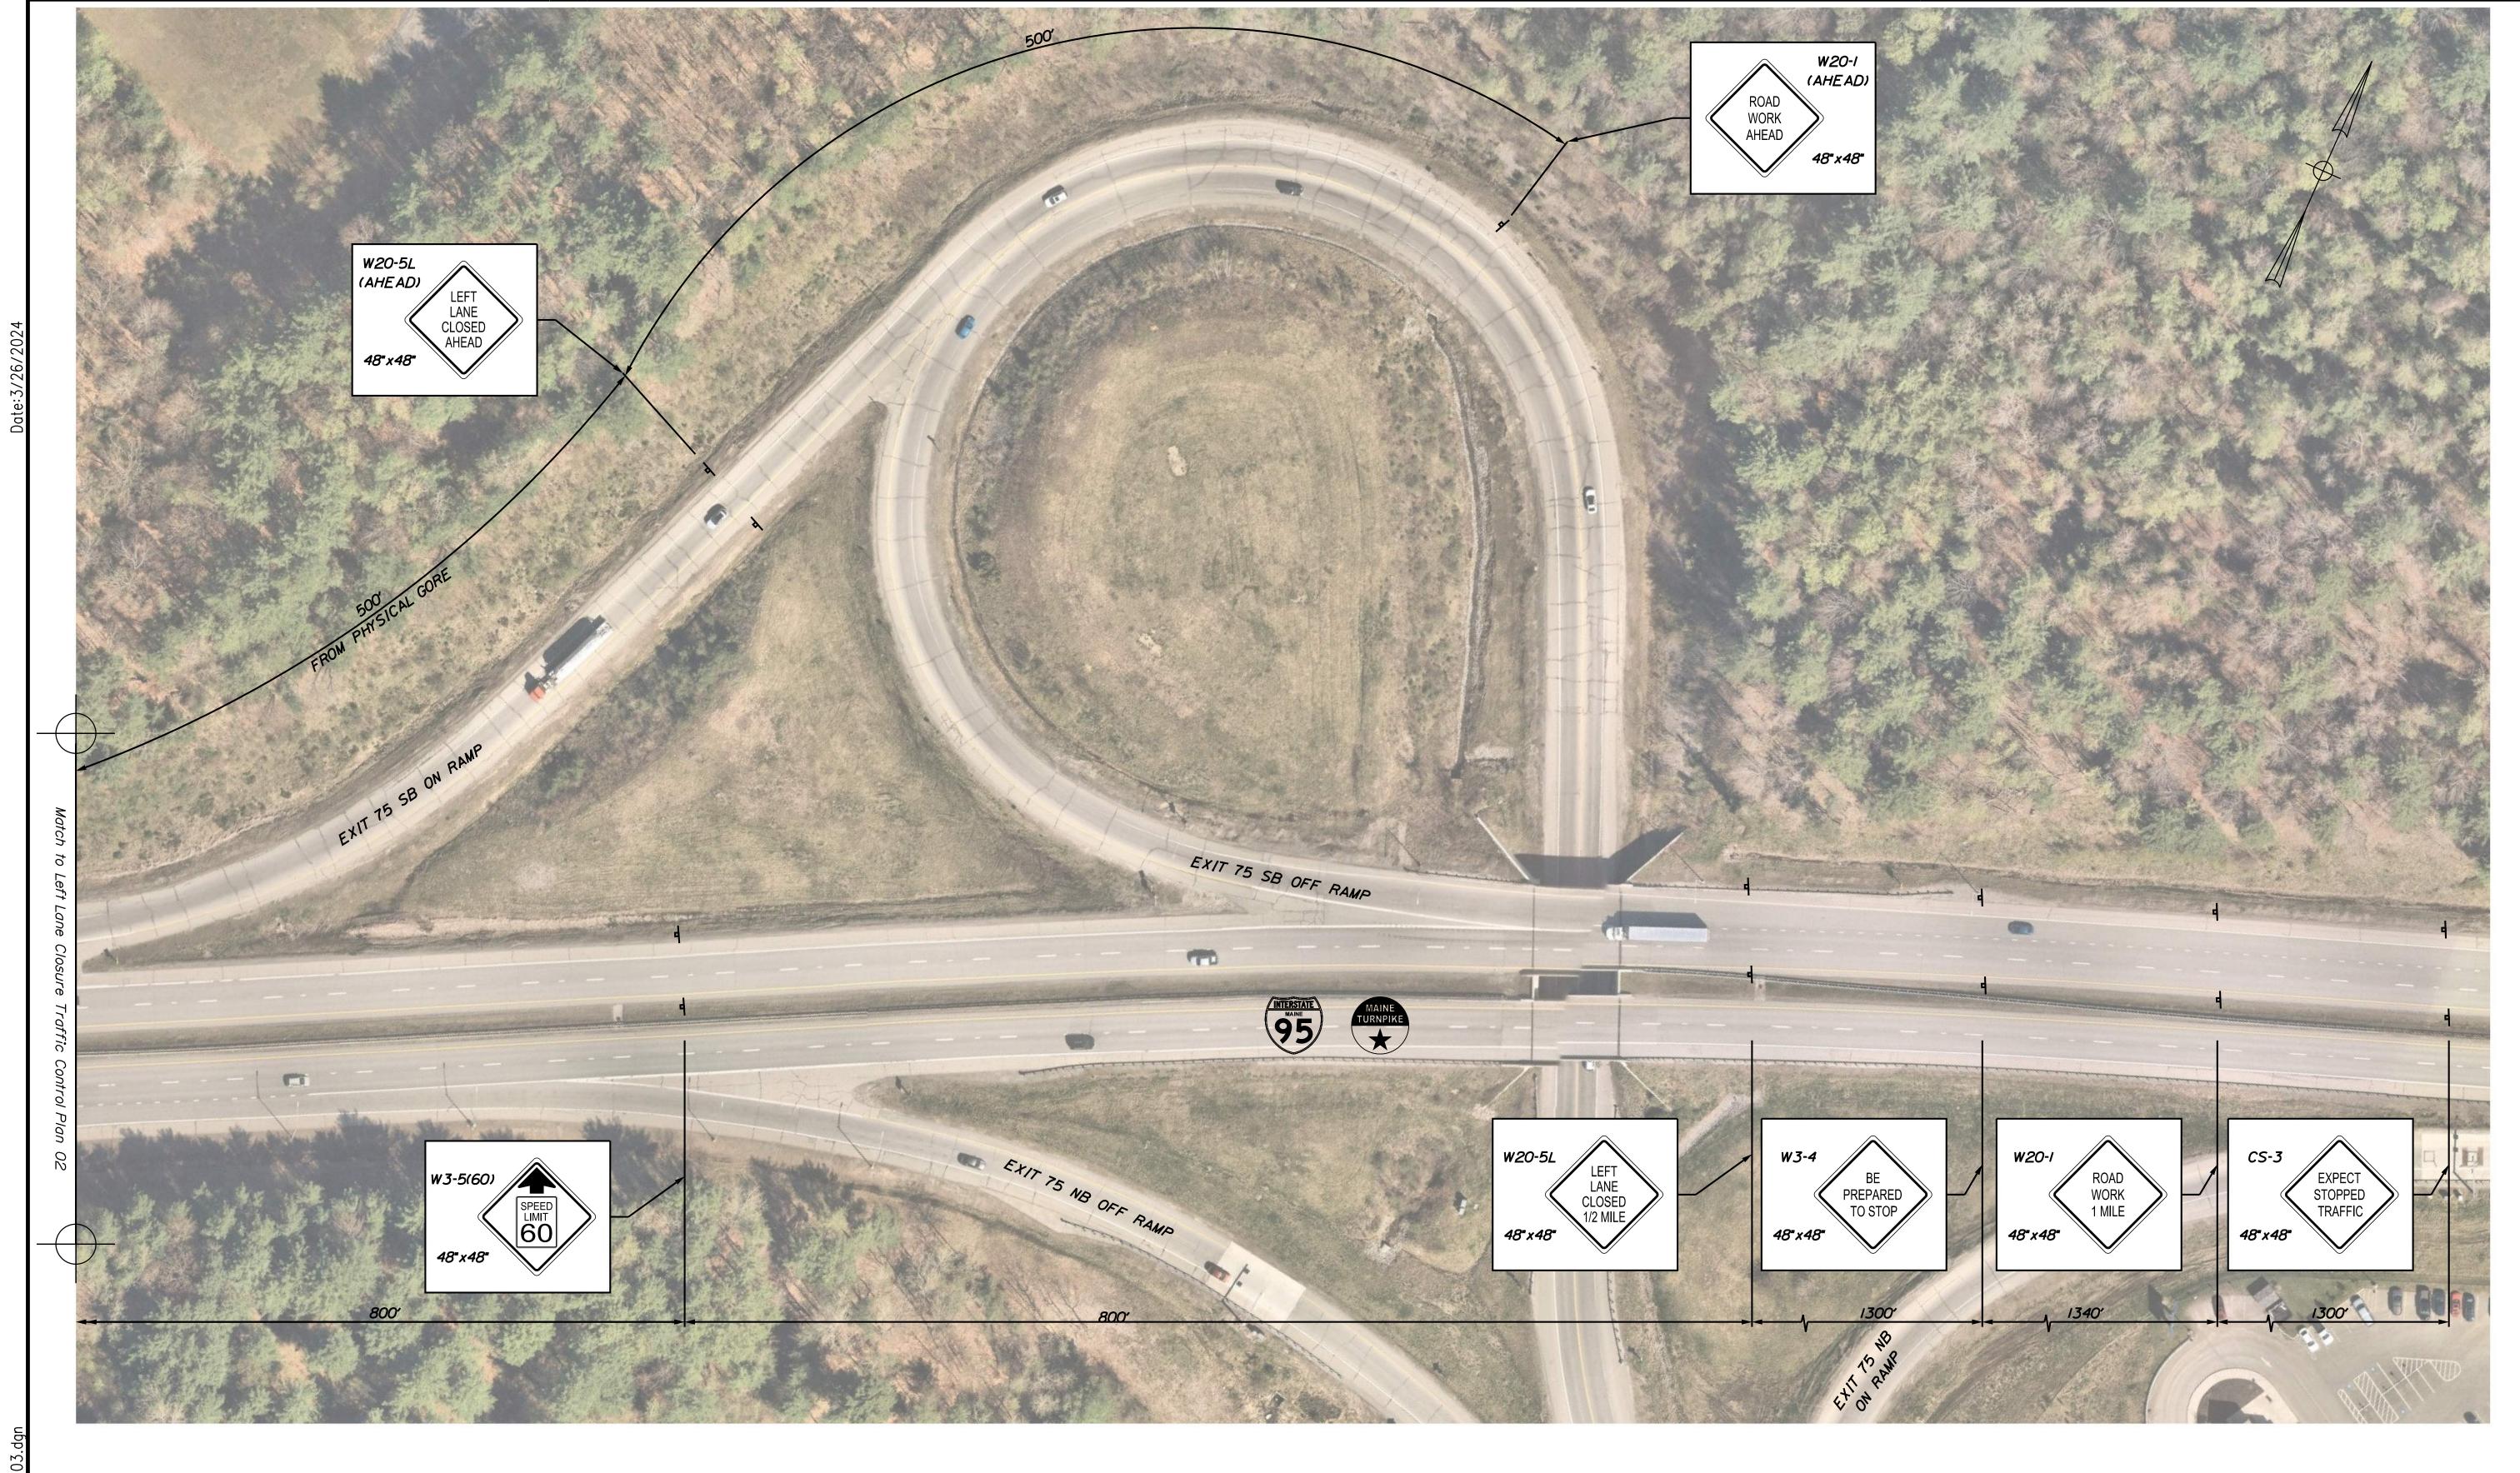

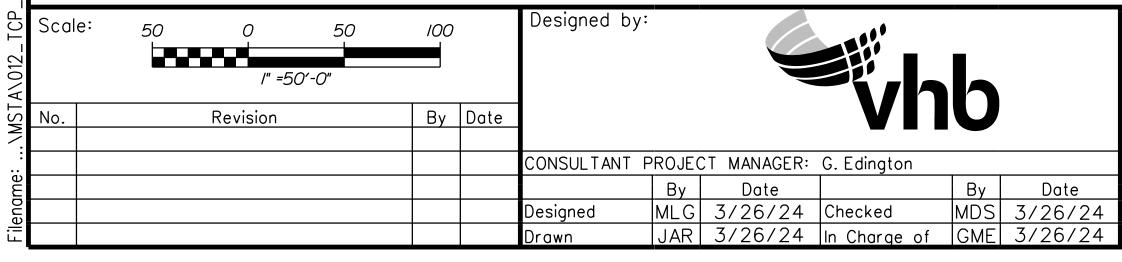

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South Portland, ME 04106 TEL (207) 889-3150 FAX (207) 253-5596





MTA PROJECT MANAGER: Ryan Barnes, PE, CPESC


MTA PROJECT NO. 2024.07
ST. LAWRENCE AND ATLANTIC RR
OVERPASS AT MM 74.50 IN AUBURN
LEFT LANE CLOSURE
TRAFFIC CONTROL PLAN 03


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VANASSE HANGEN BRUSTLIN, INC. 500 Southborough Dr. Suite 105B

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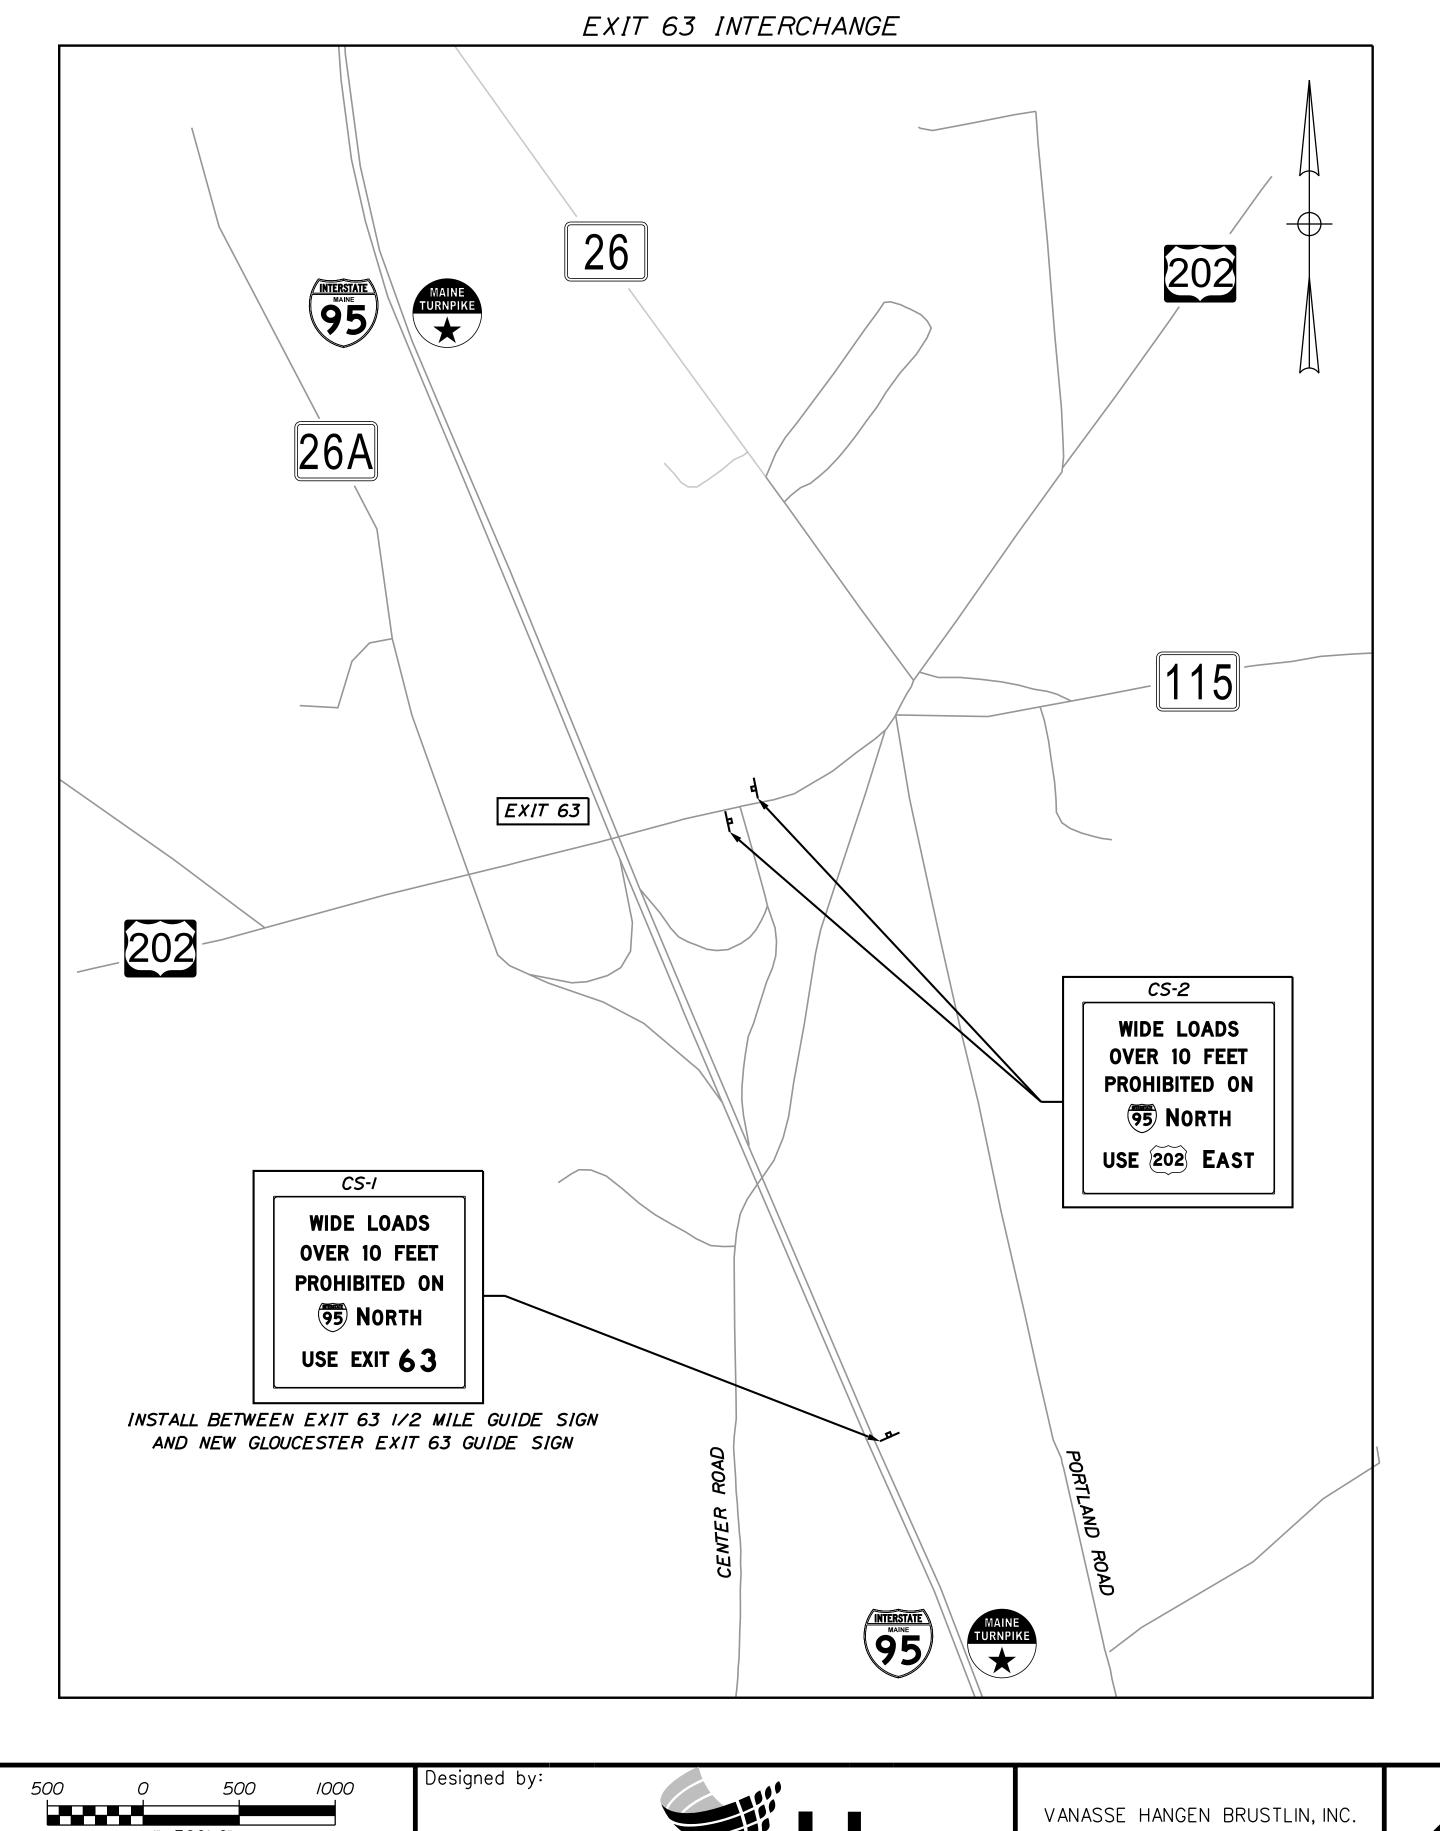


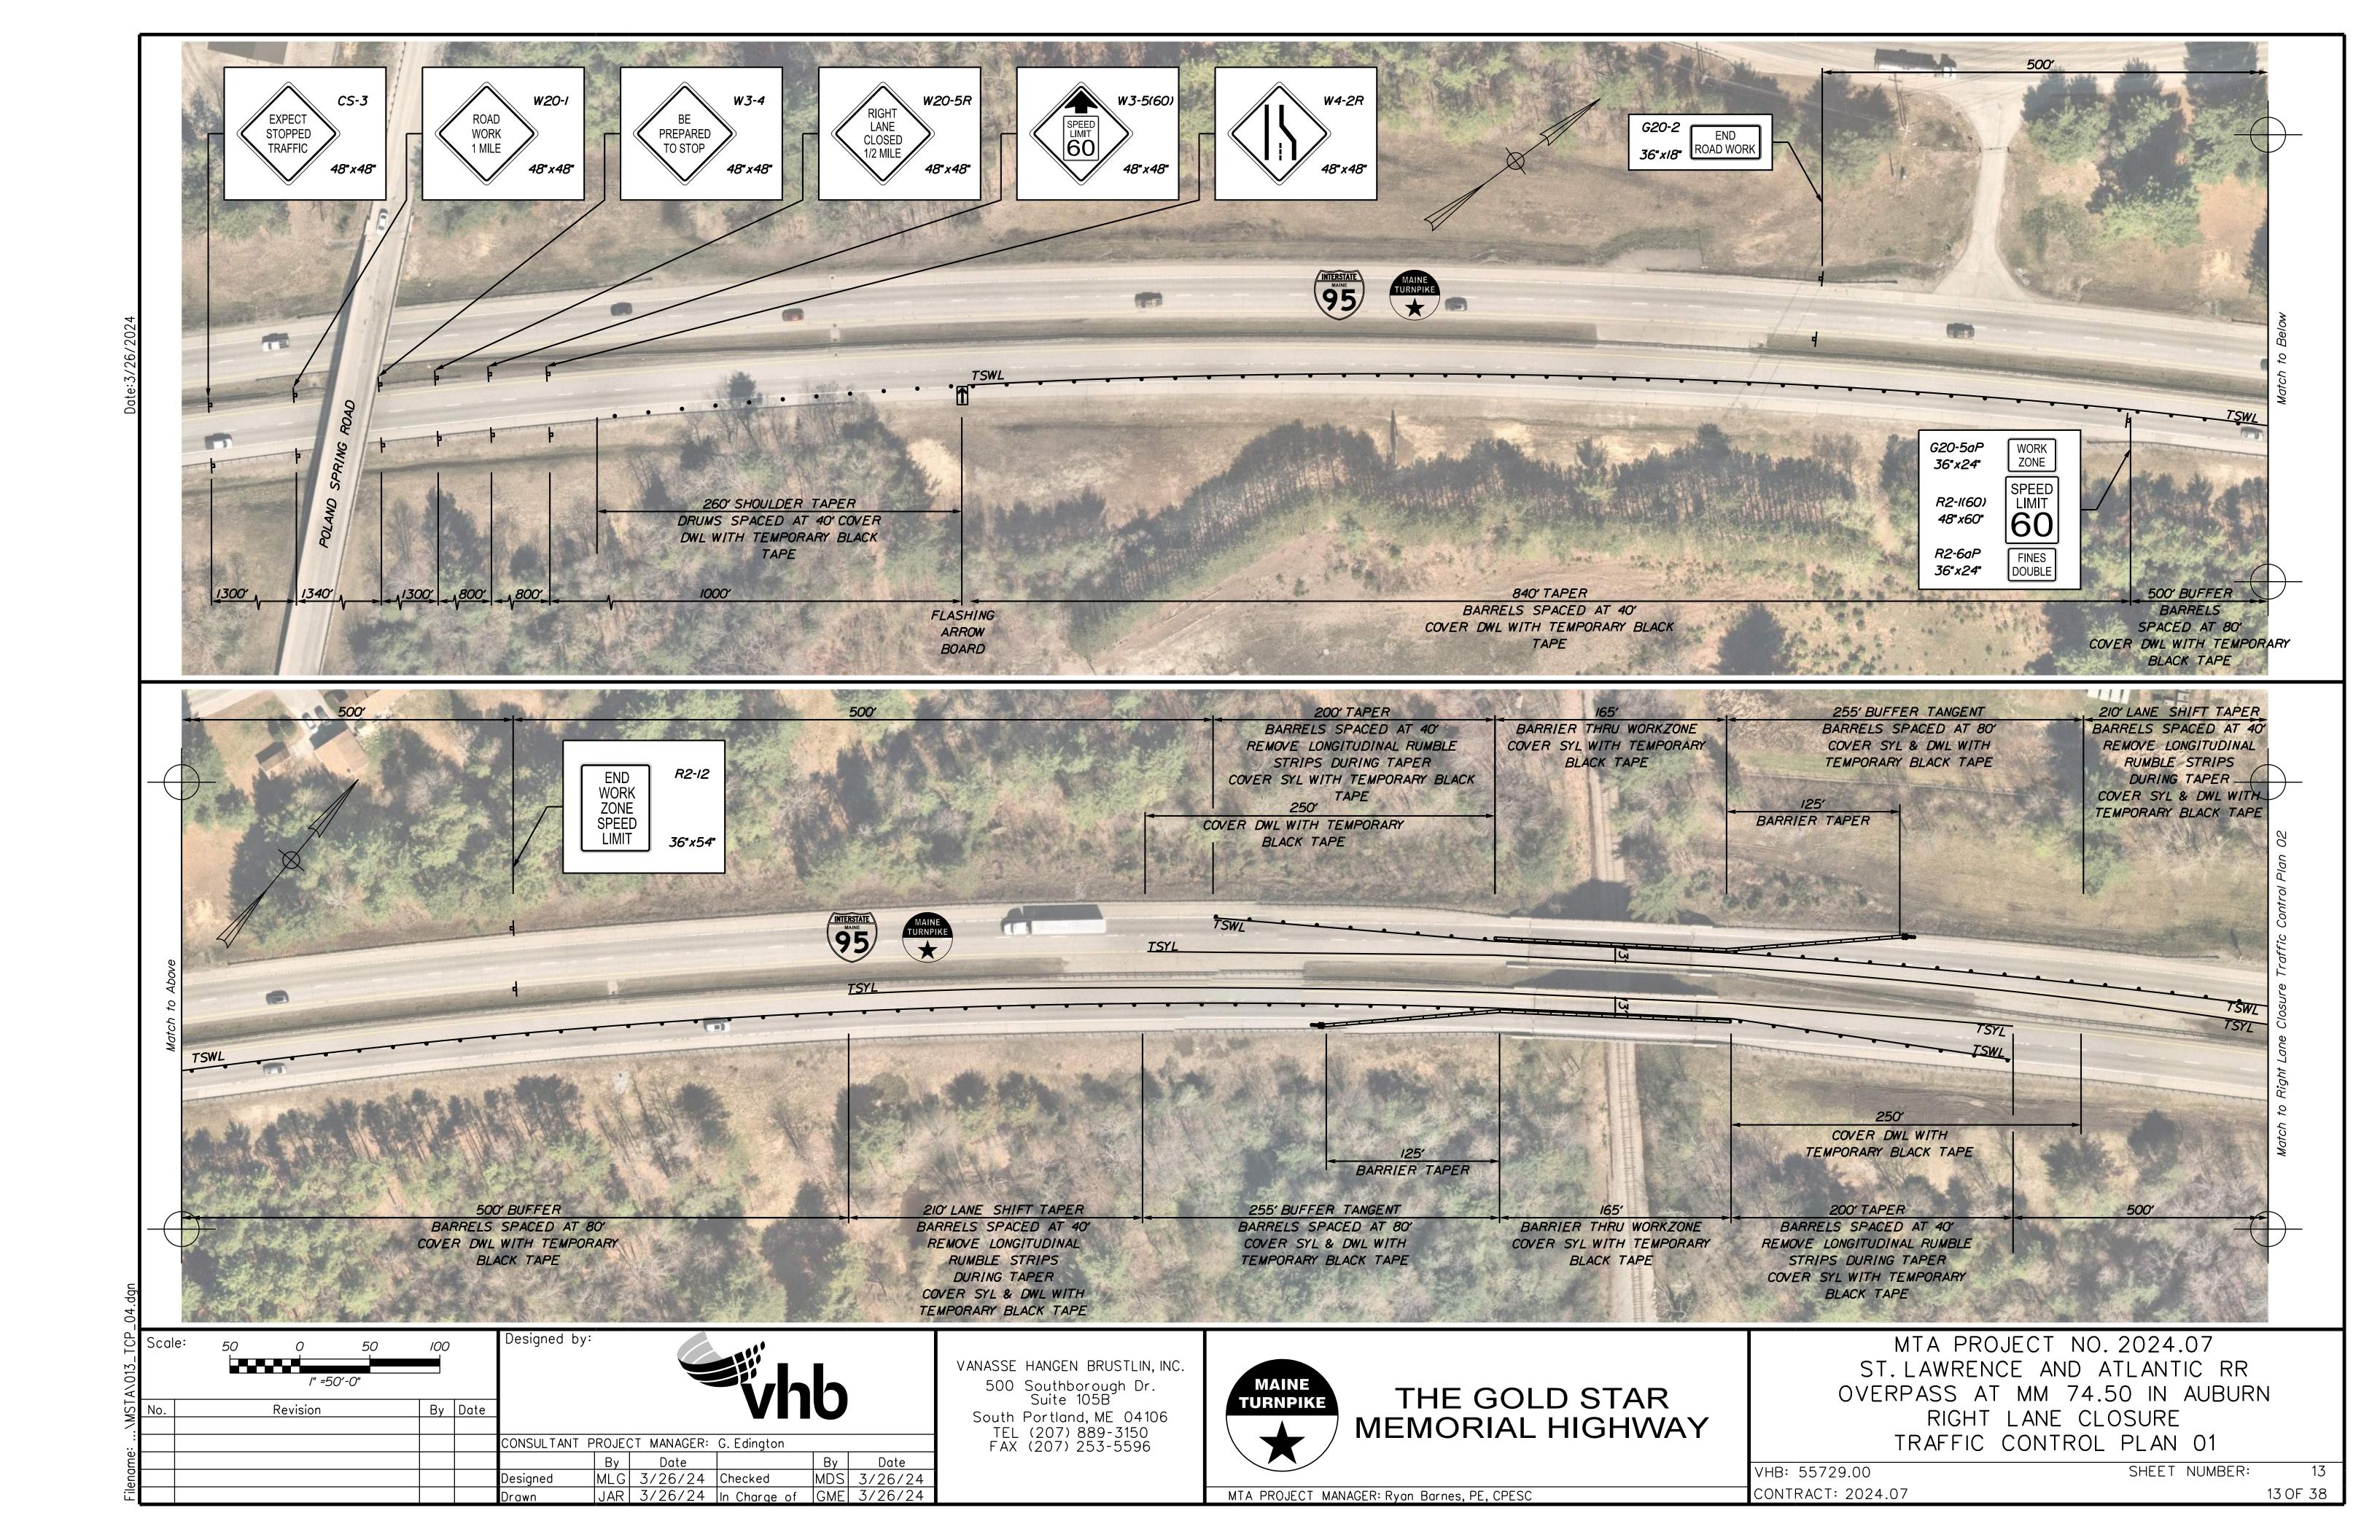
MTA PROJECT MANAGER: Ryan Barnes, PE, CPESC

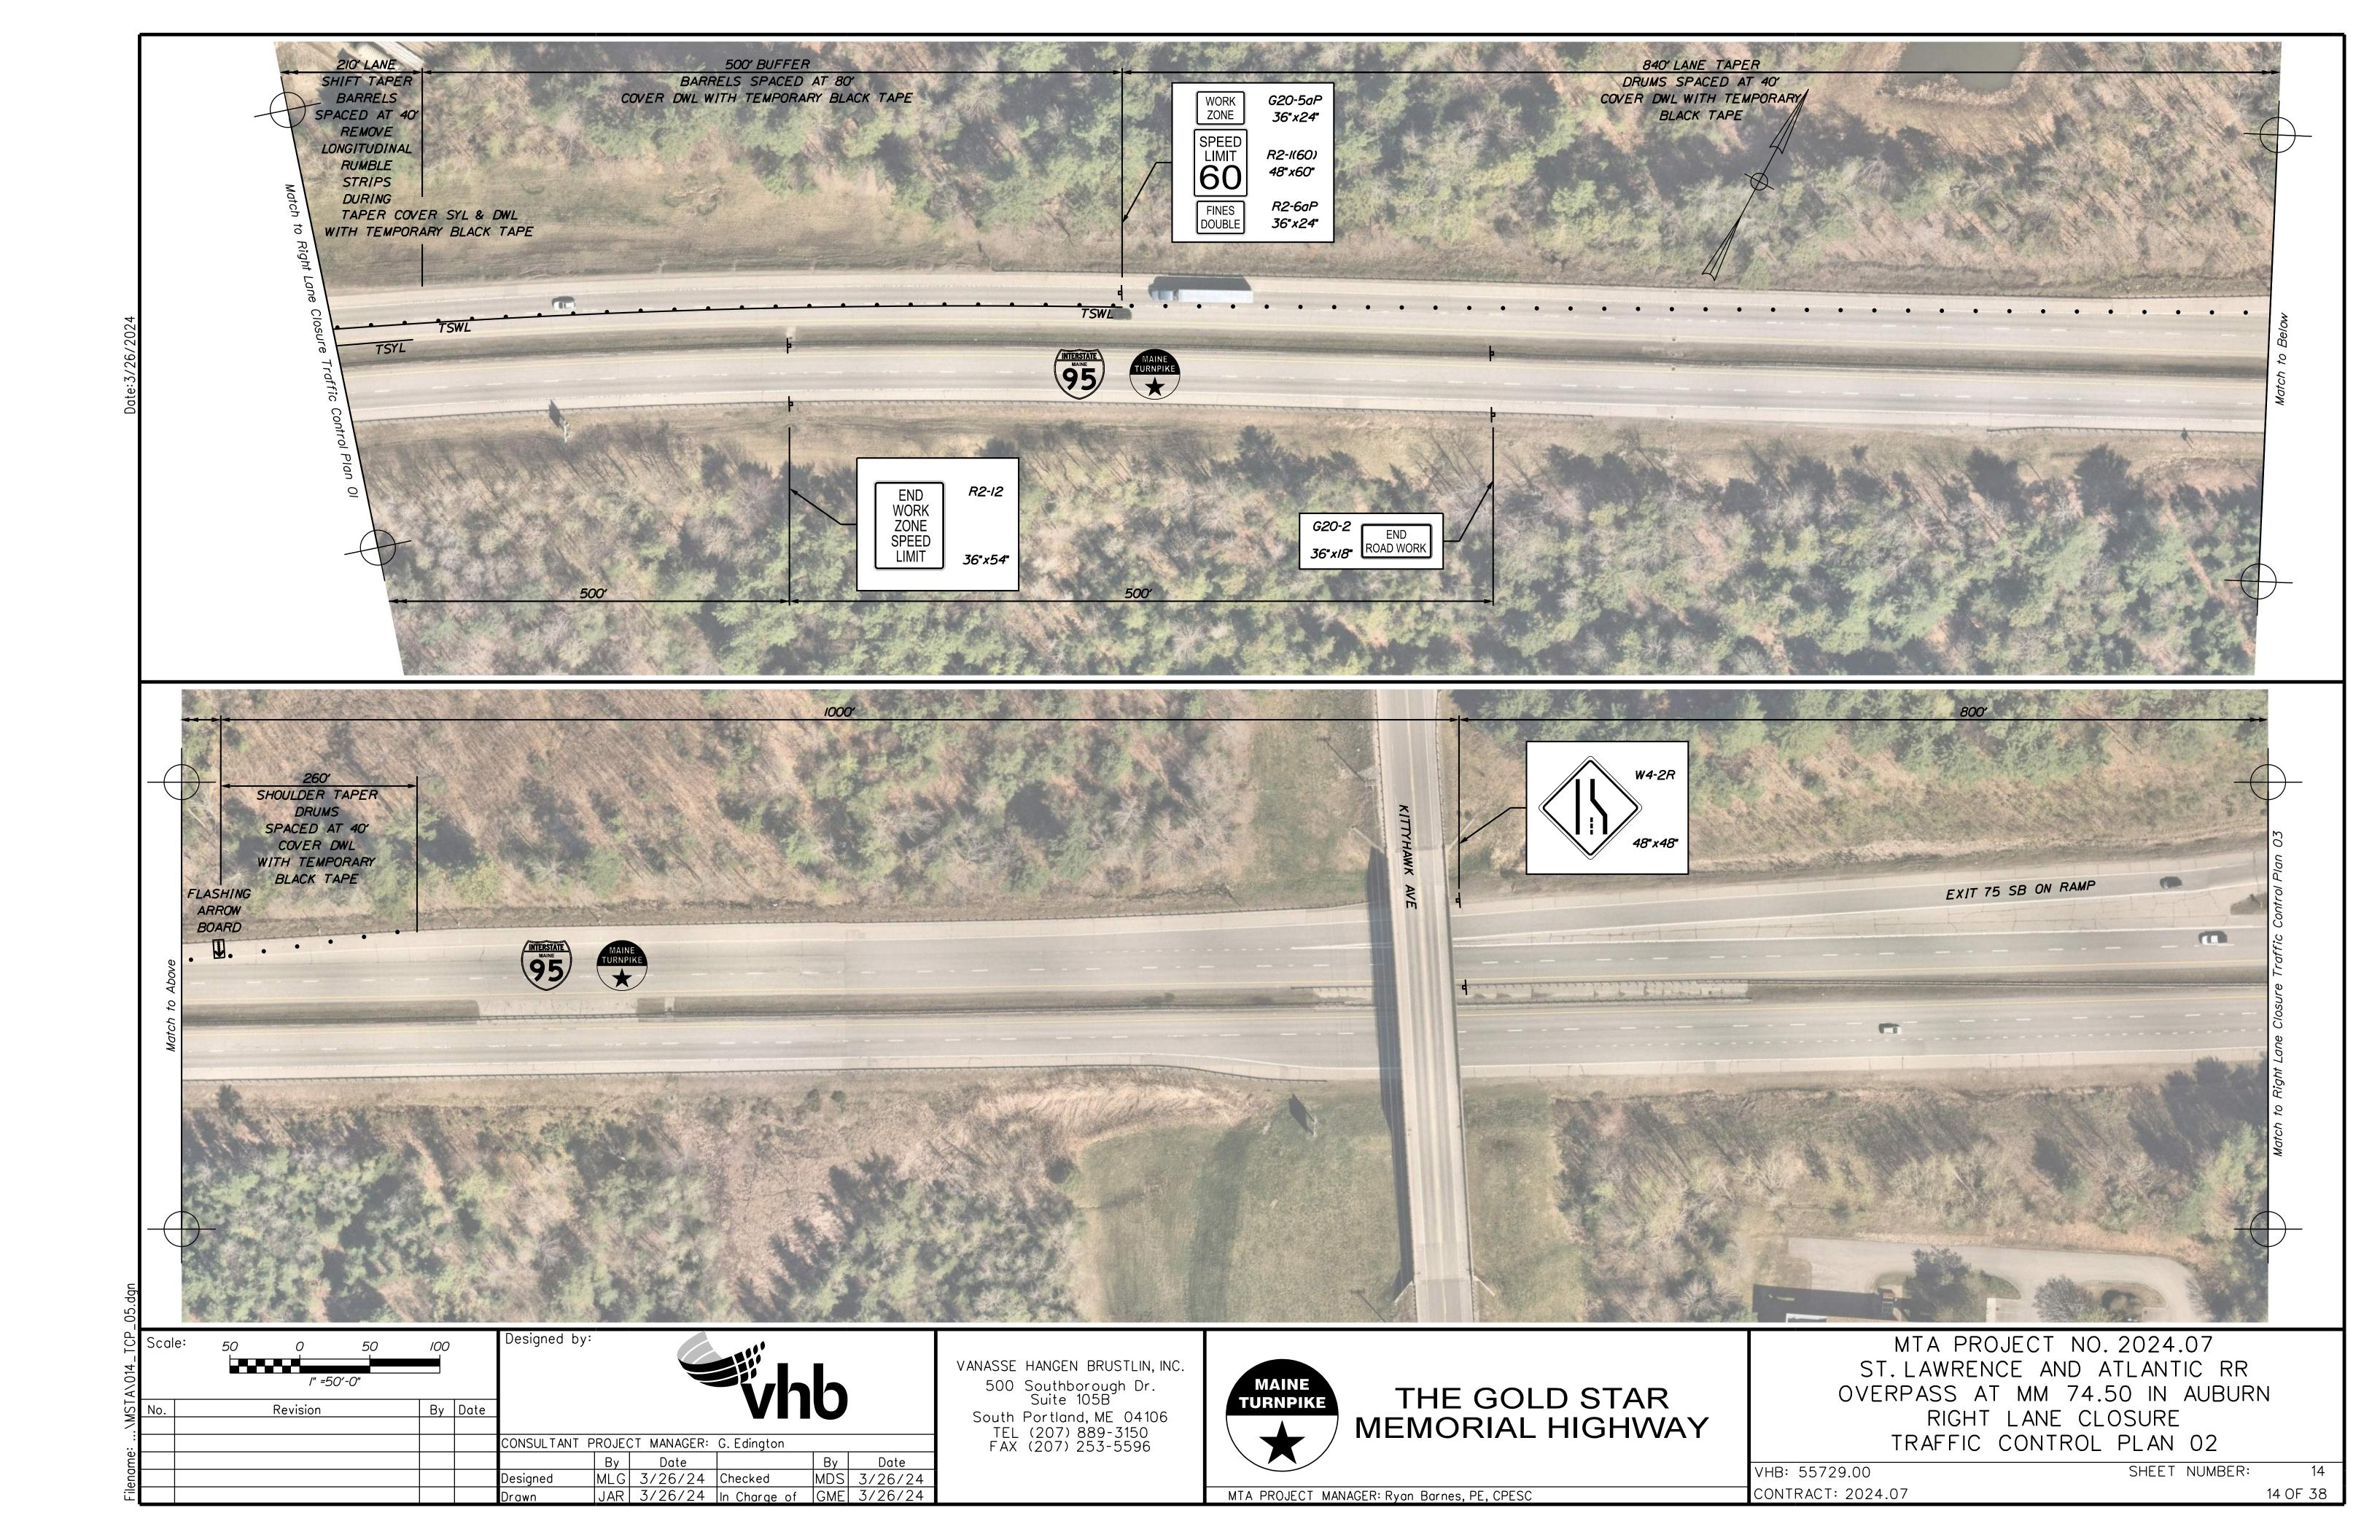
MTA PROJECT NO. 2024.07 ST. LAWRENCE AND ATLANTIC RR OVERPASS AT MM 74.50 IN AUBURN RIGHT LANE CLOSURE TRAFFIC CONTROL PLAN 03
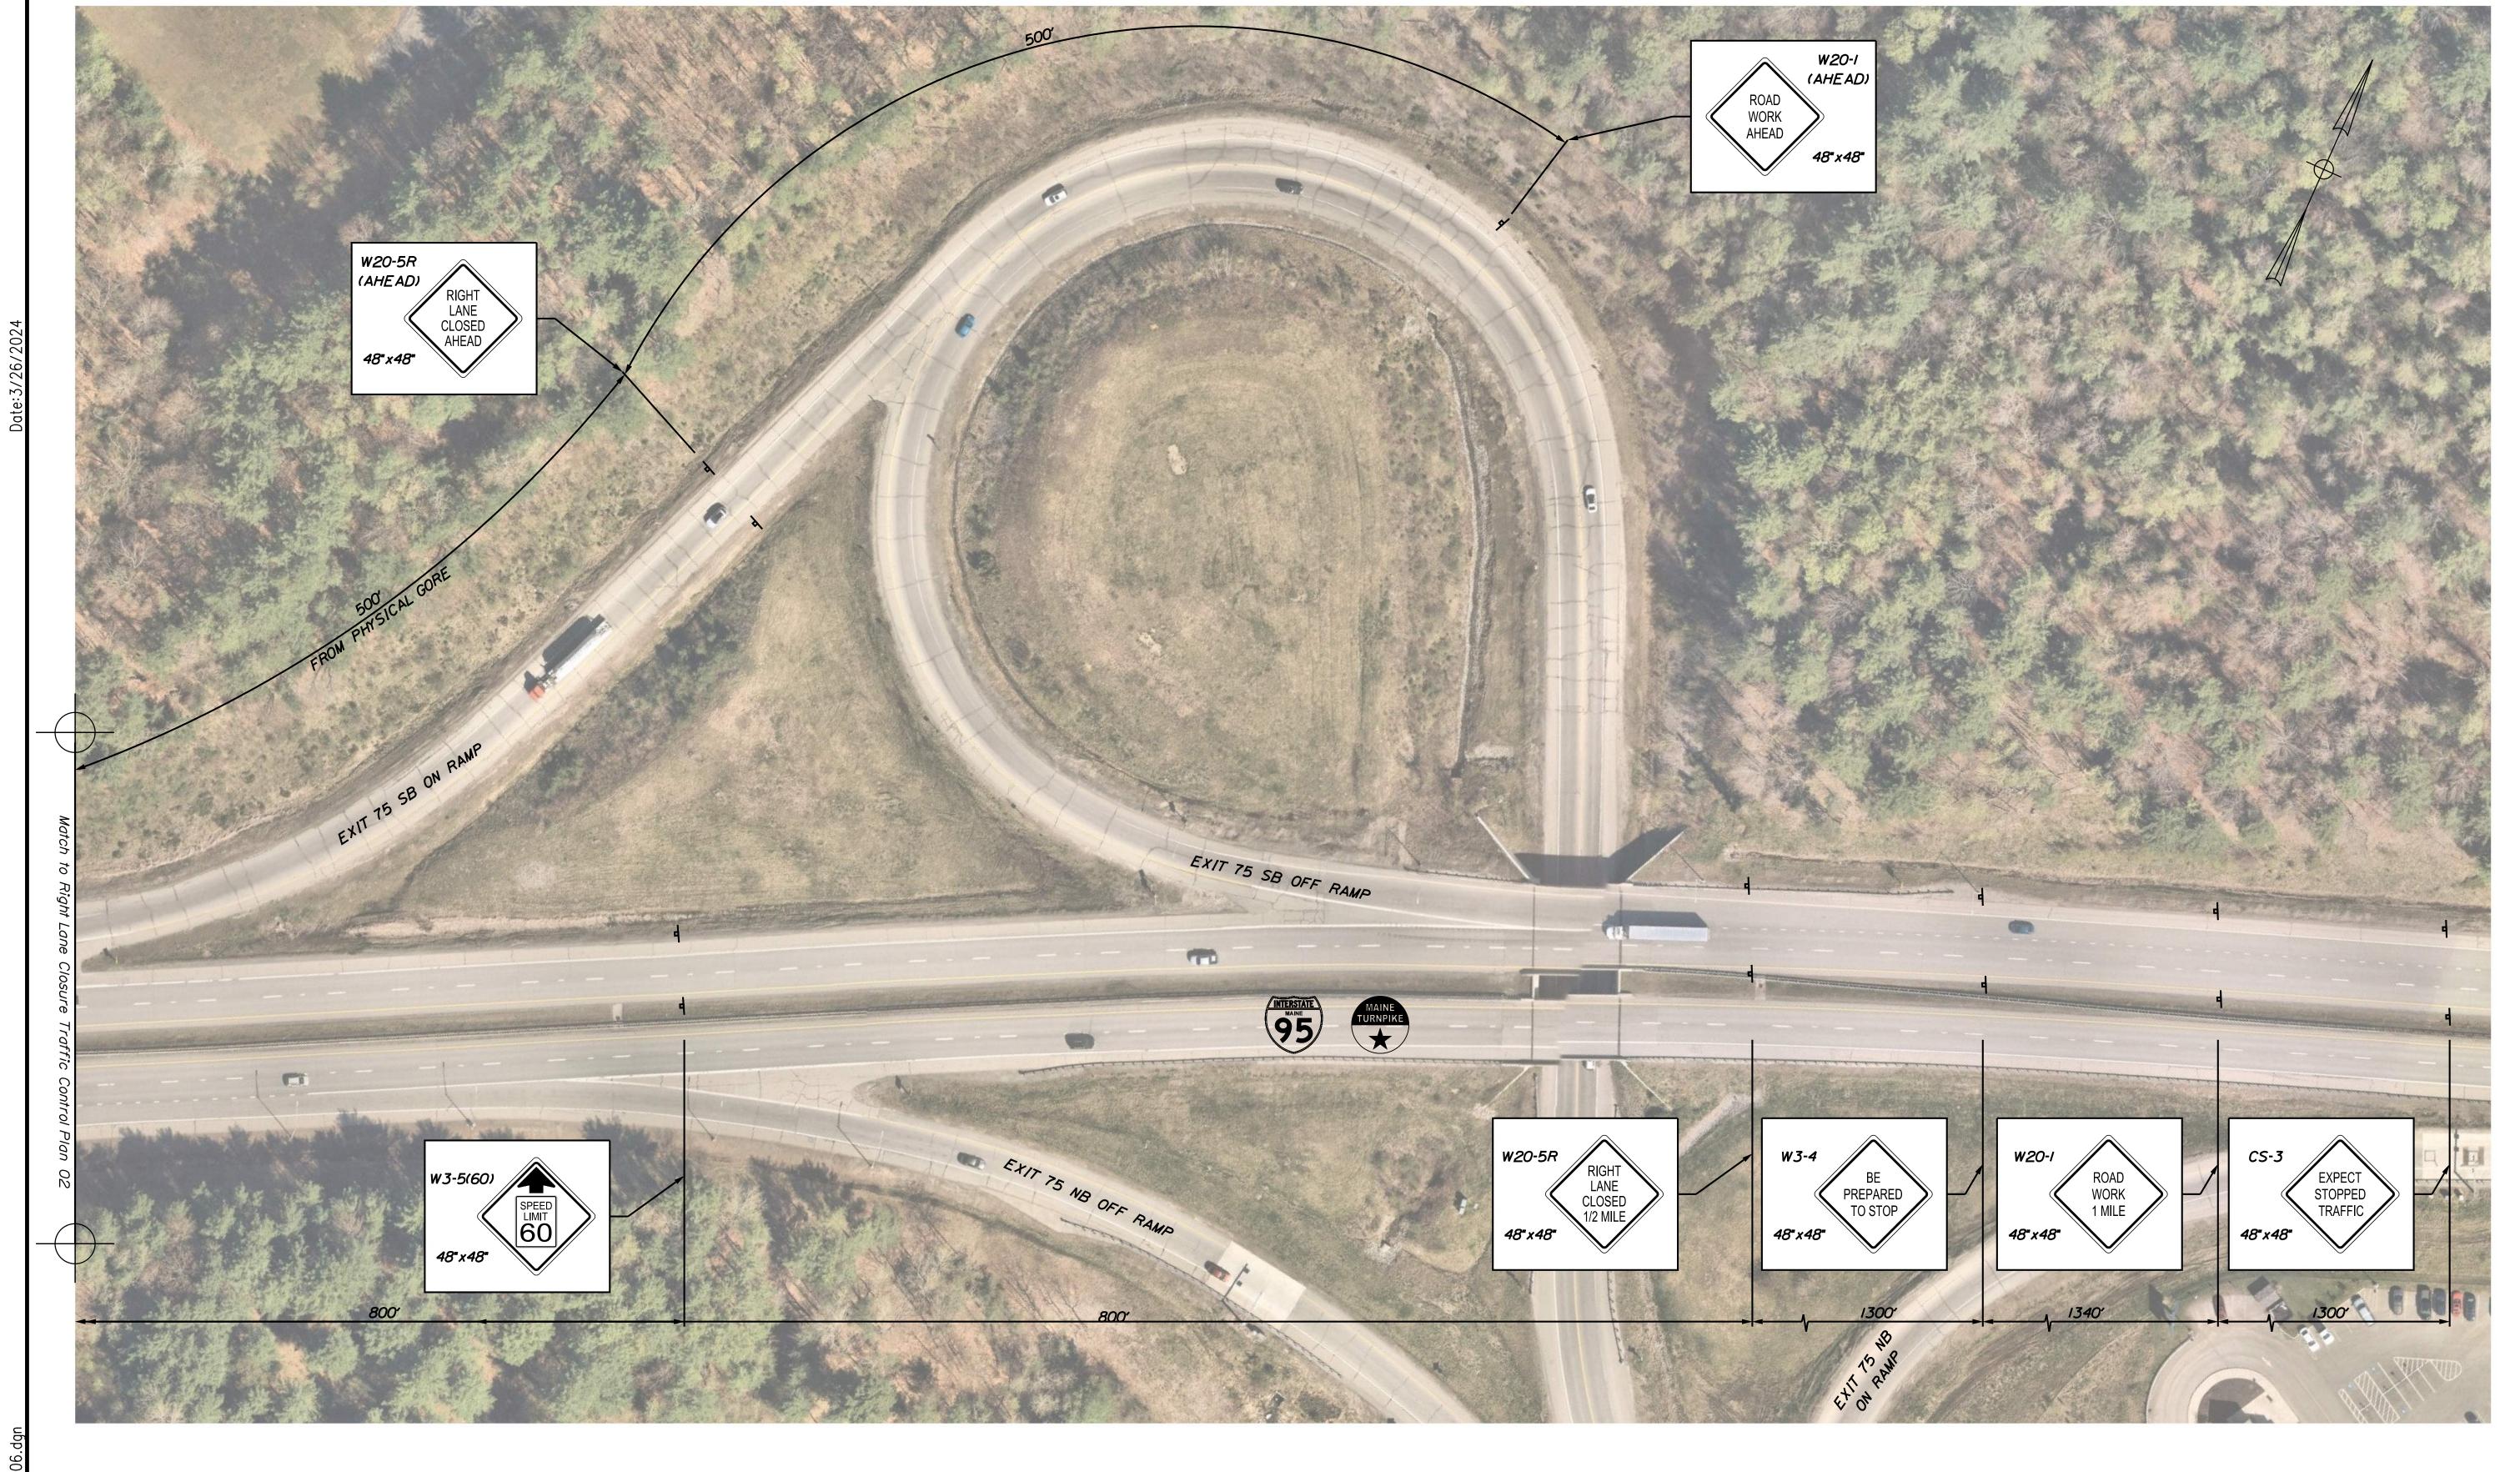
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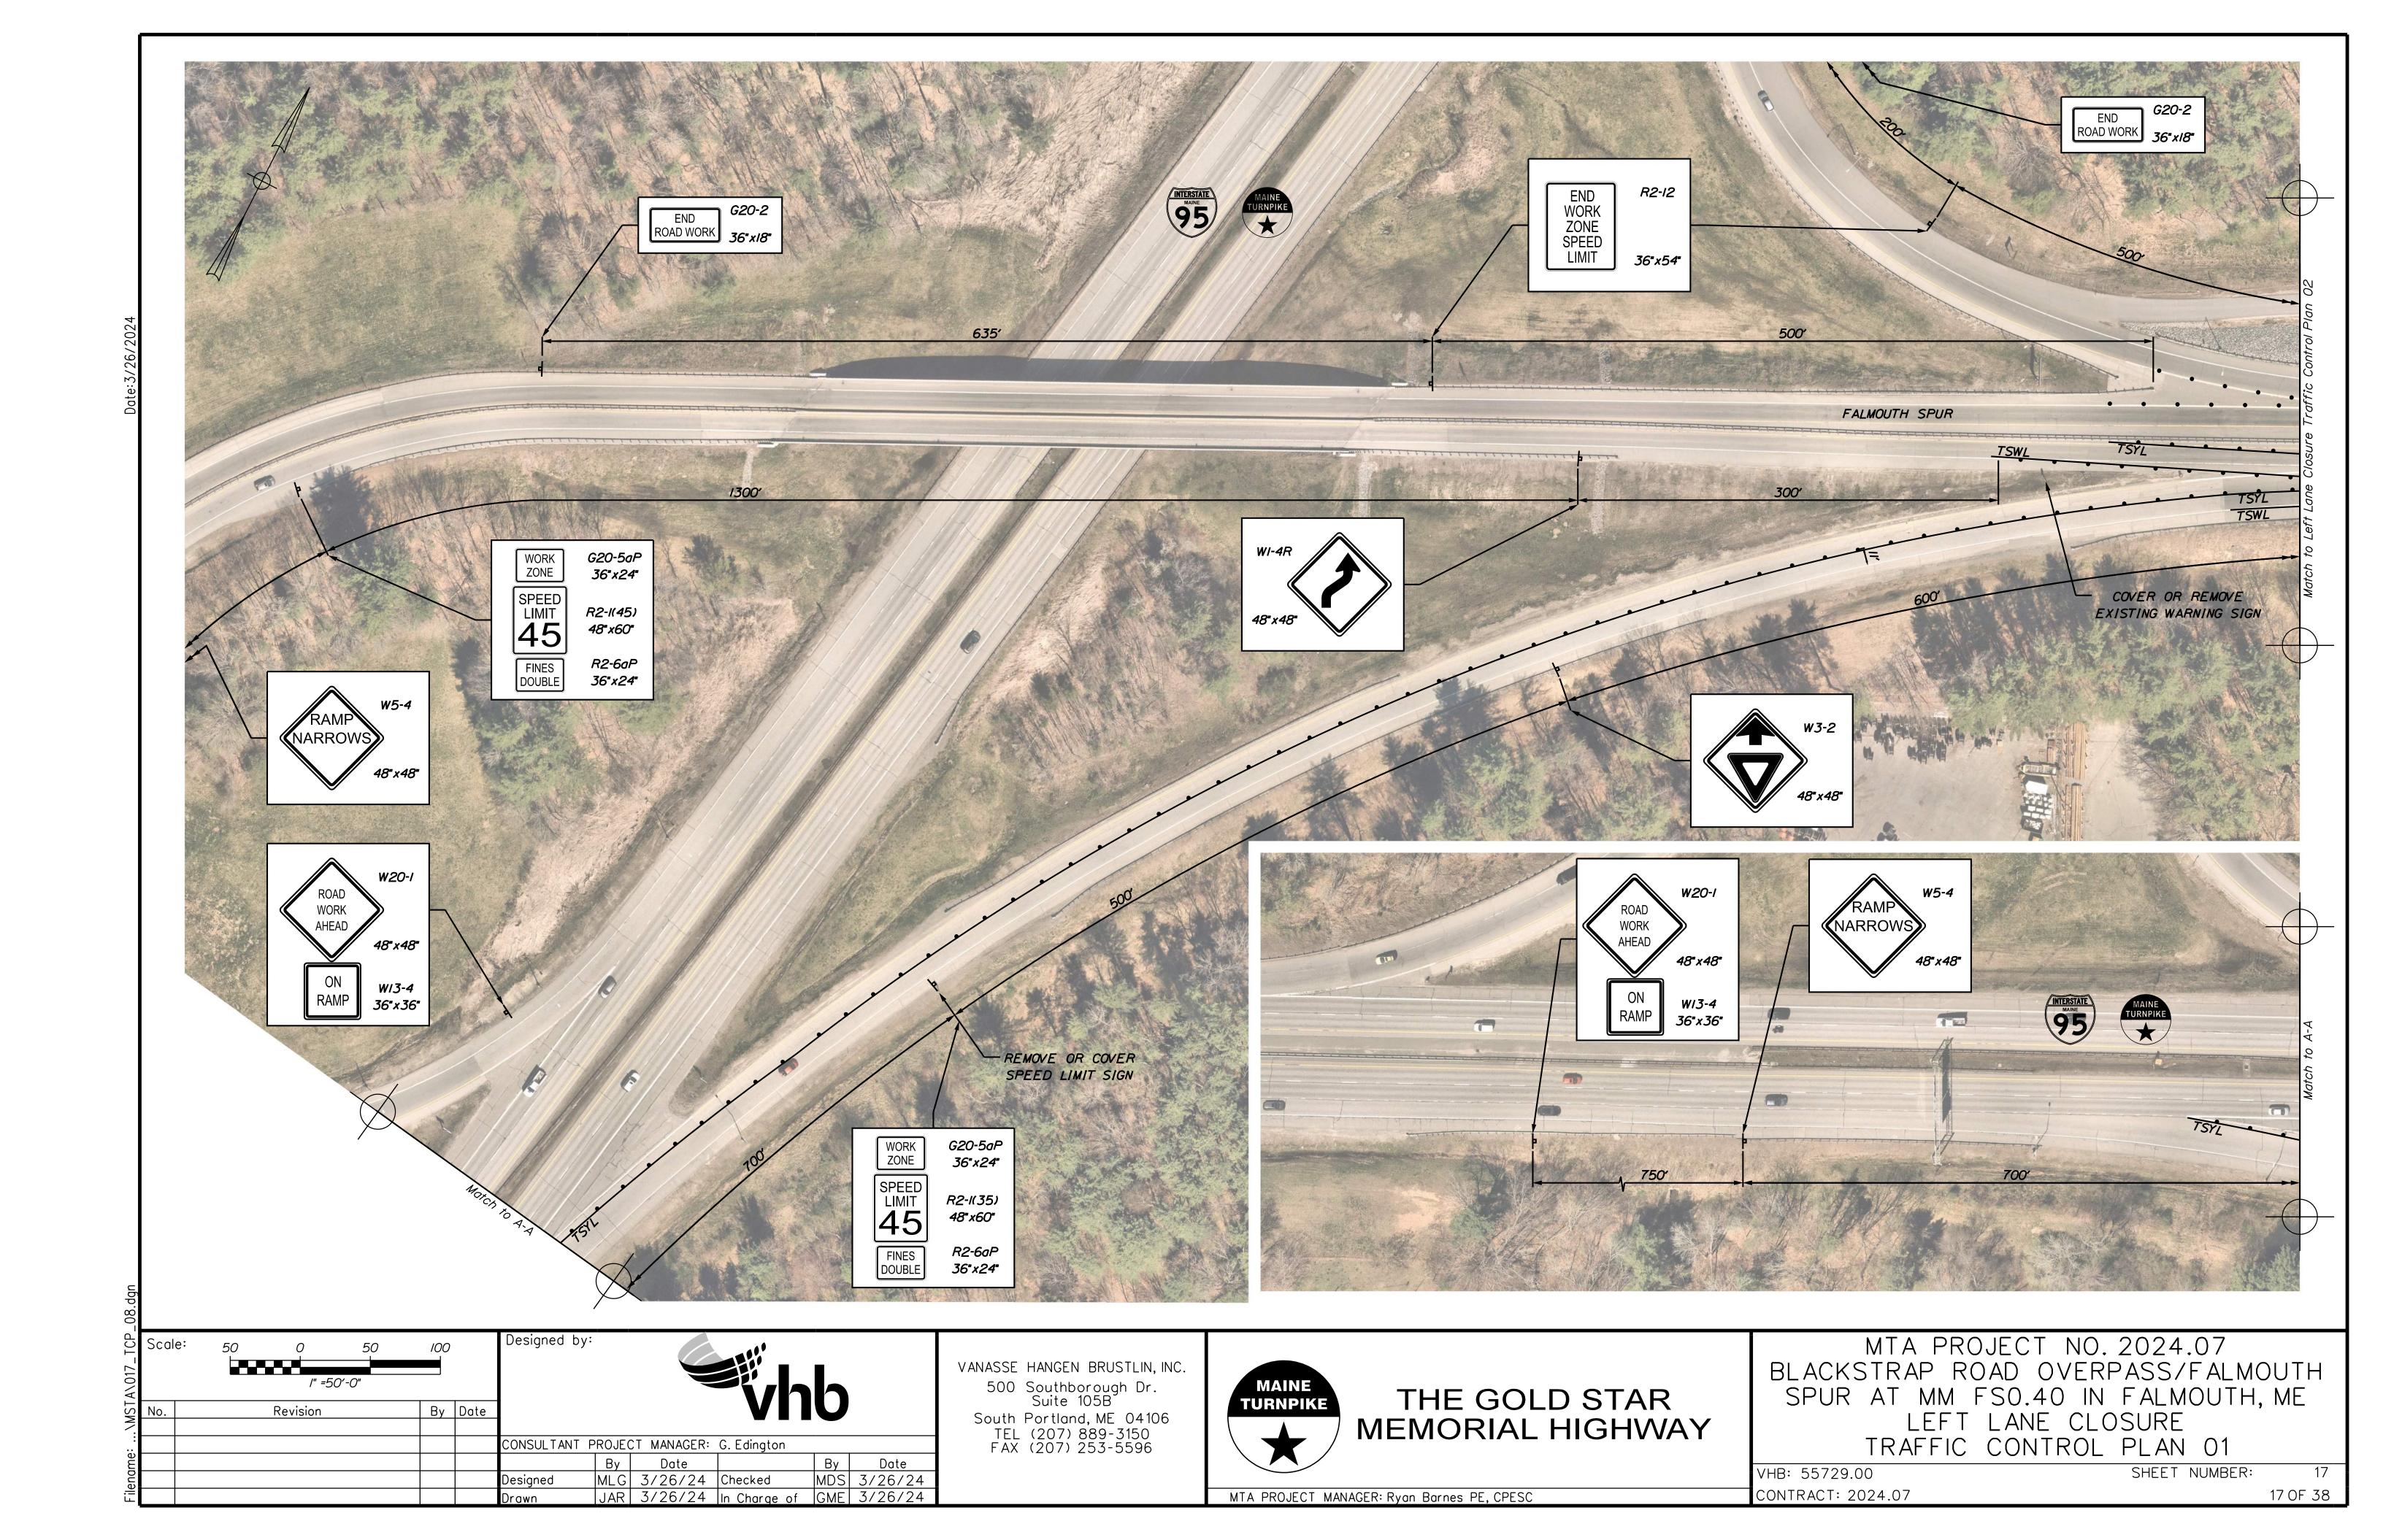


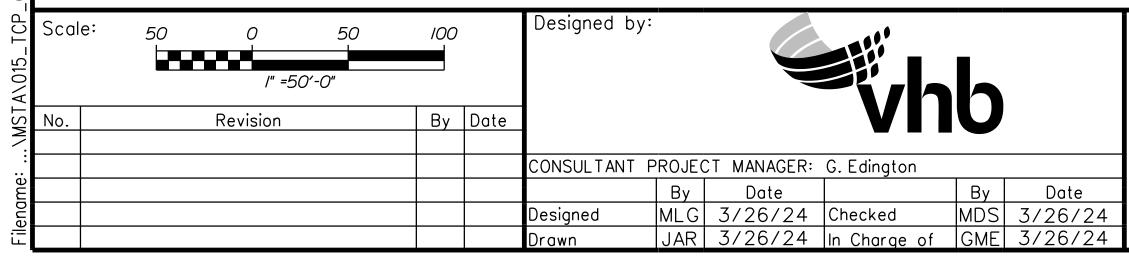
MTA PROJECT MANAGER: Ryan Barnes, PE, CPESC


MTA PROJECT NO. 2024.07 ST. LAWRENCE AND ATLANTIC RR OVERPASS AT MM 74.50 IN AUBURN WIDE LOAD DETOUR TRAFFIC CONTROL PLAN 1

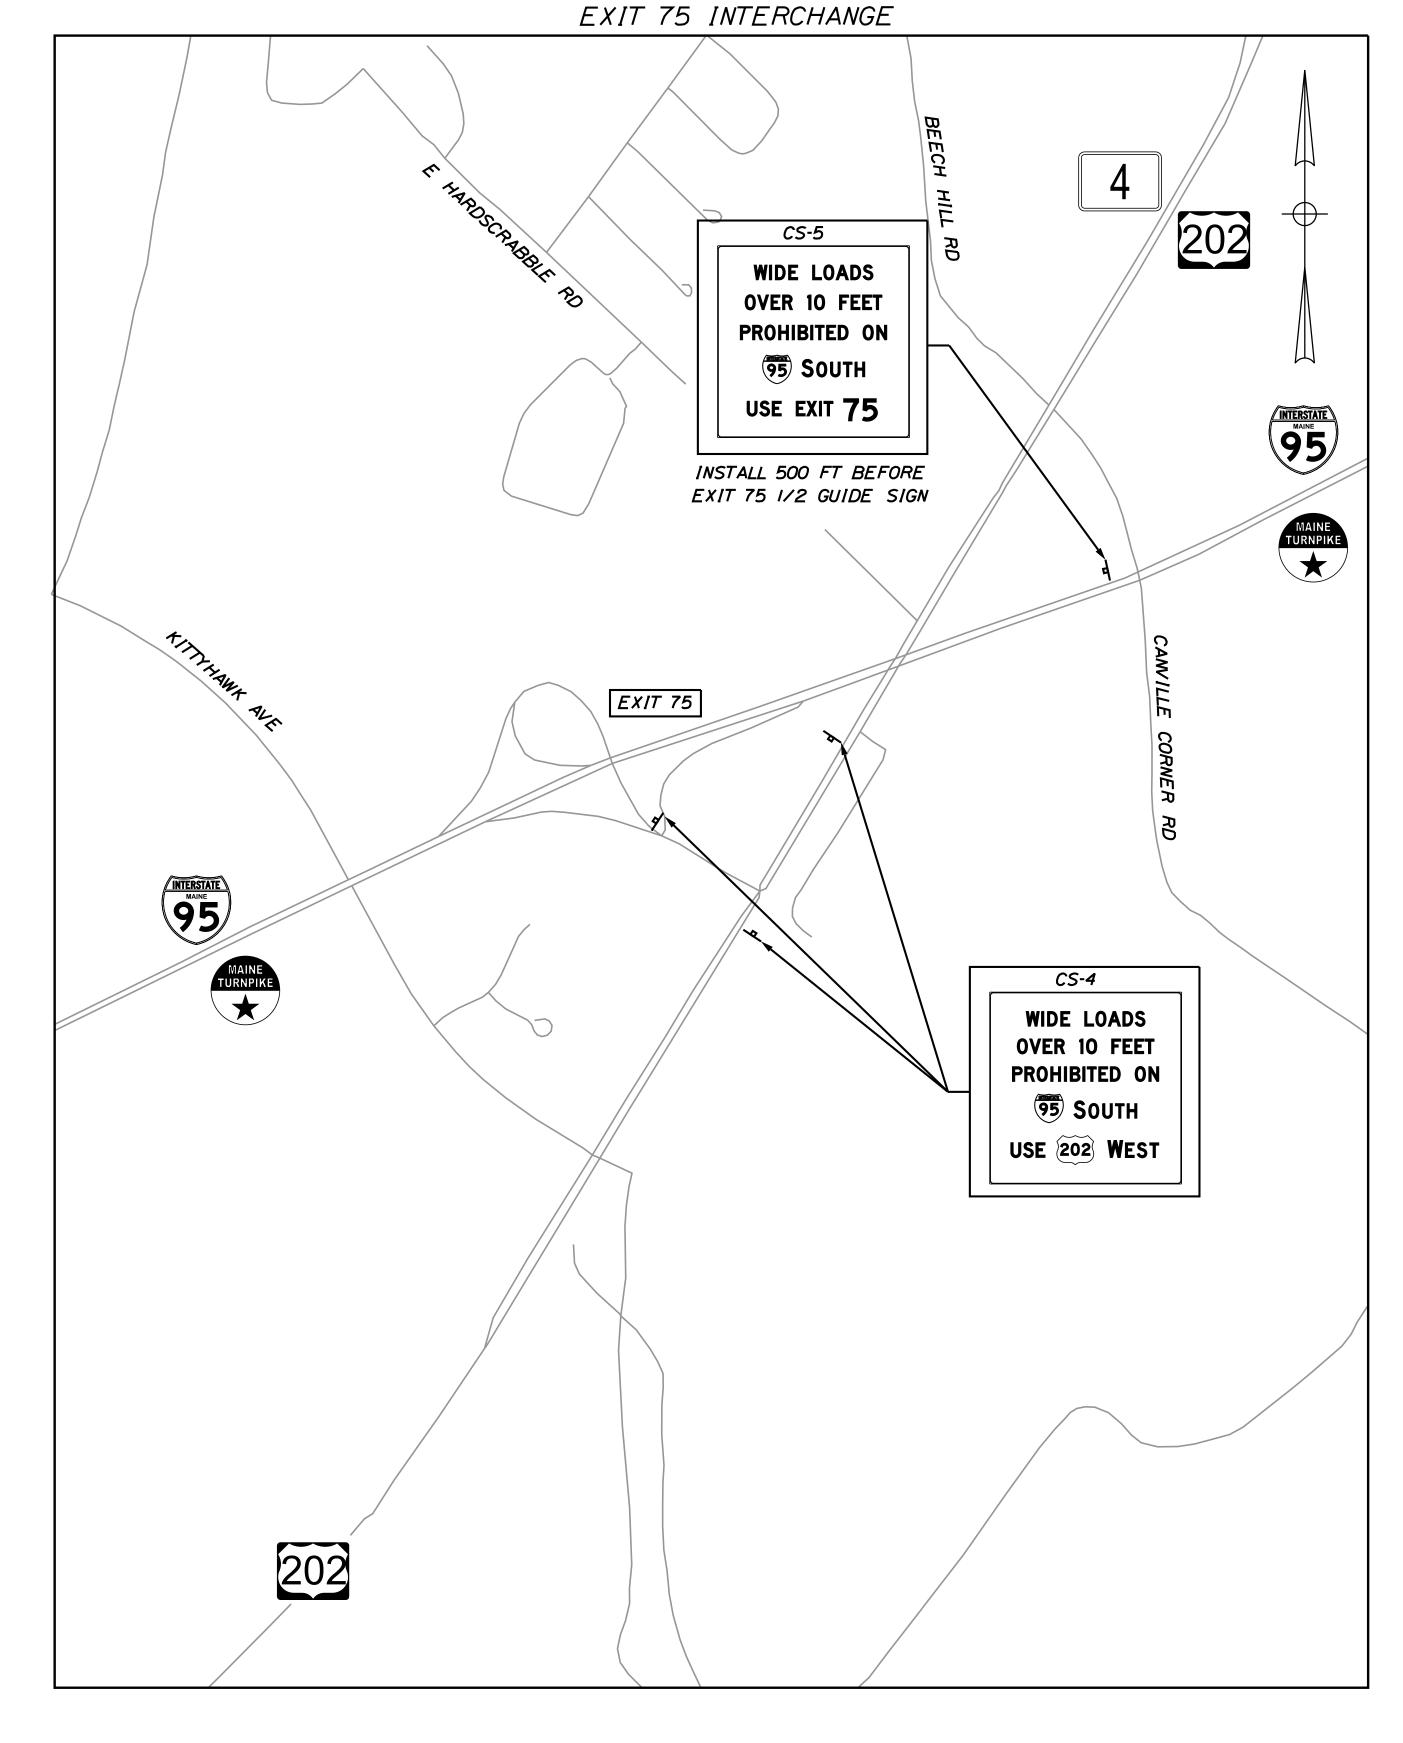
 VHB: 55729.00
 SHEET NUMBER: 16

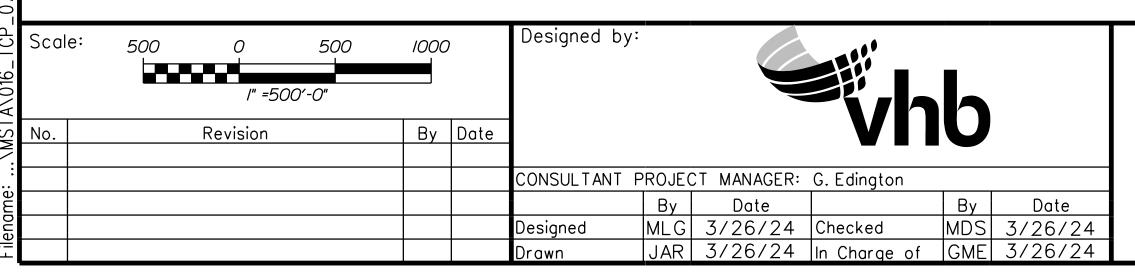
 CONTRACT: 2024.07
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Revision By Date CONSULTANT PROJECT MANAGER: G. Edington 
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 In Charge of GME
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 By Date MLG 3/26/24 Checked Designed

500 Southborough Dr. Suite 105B

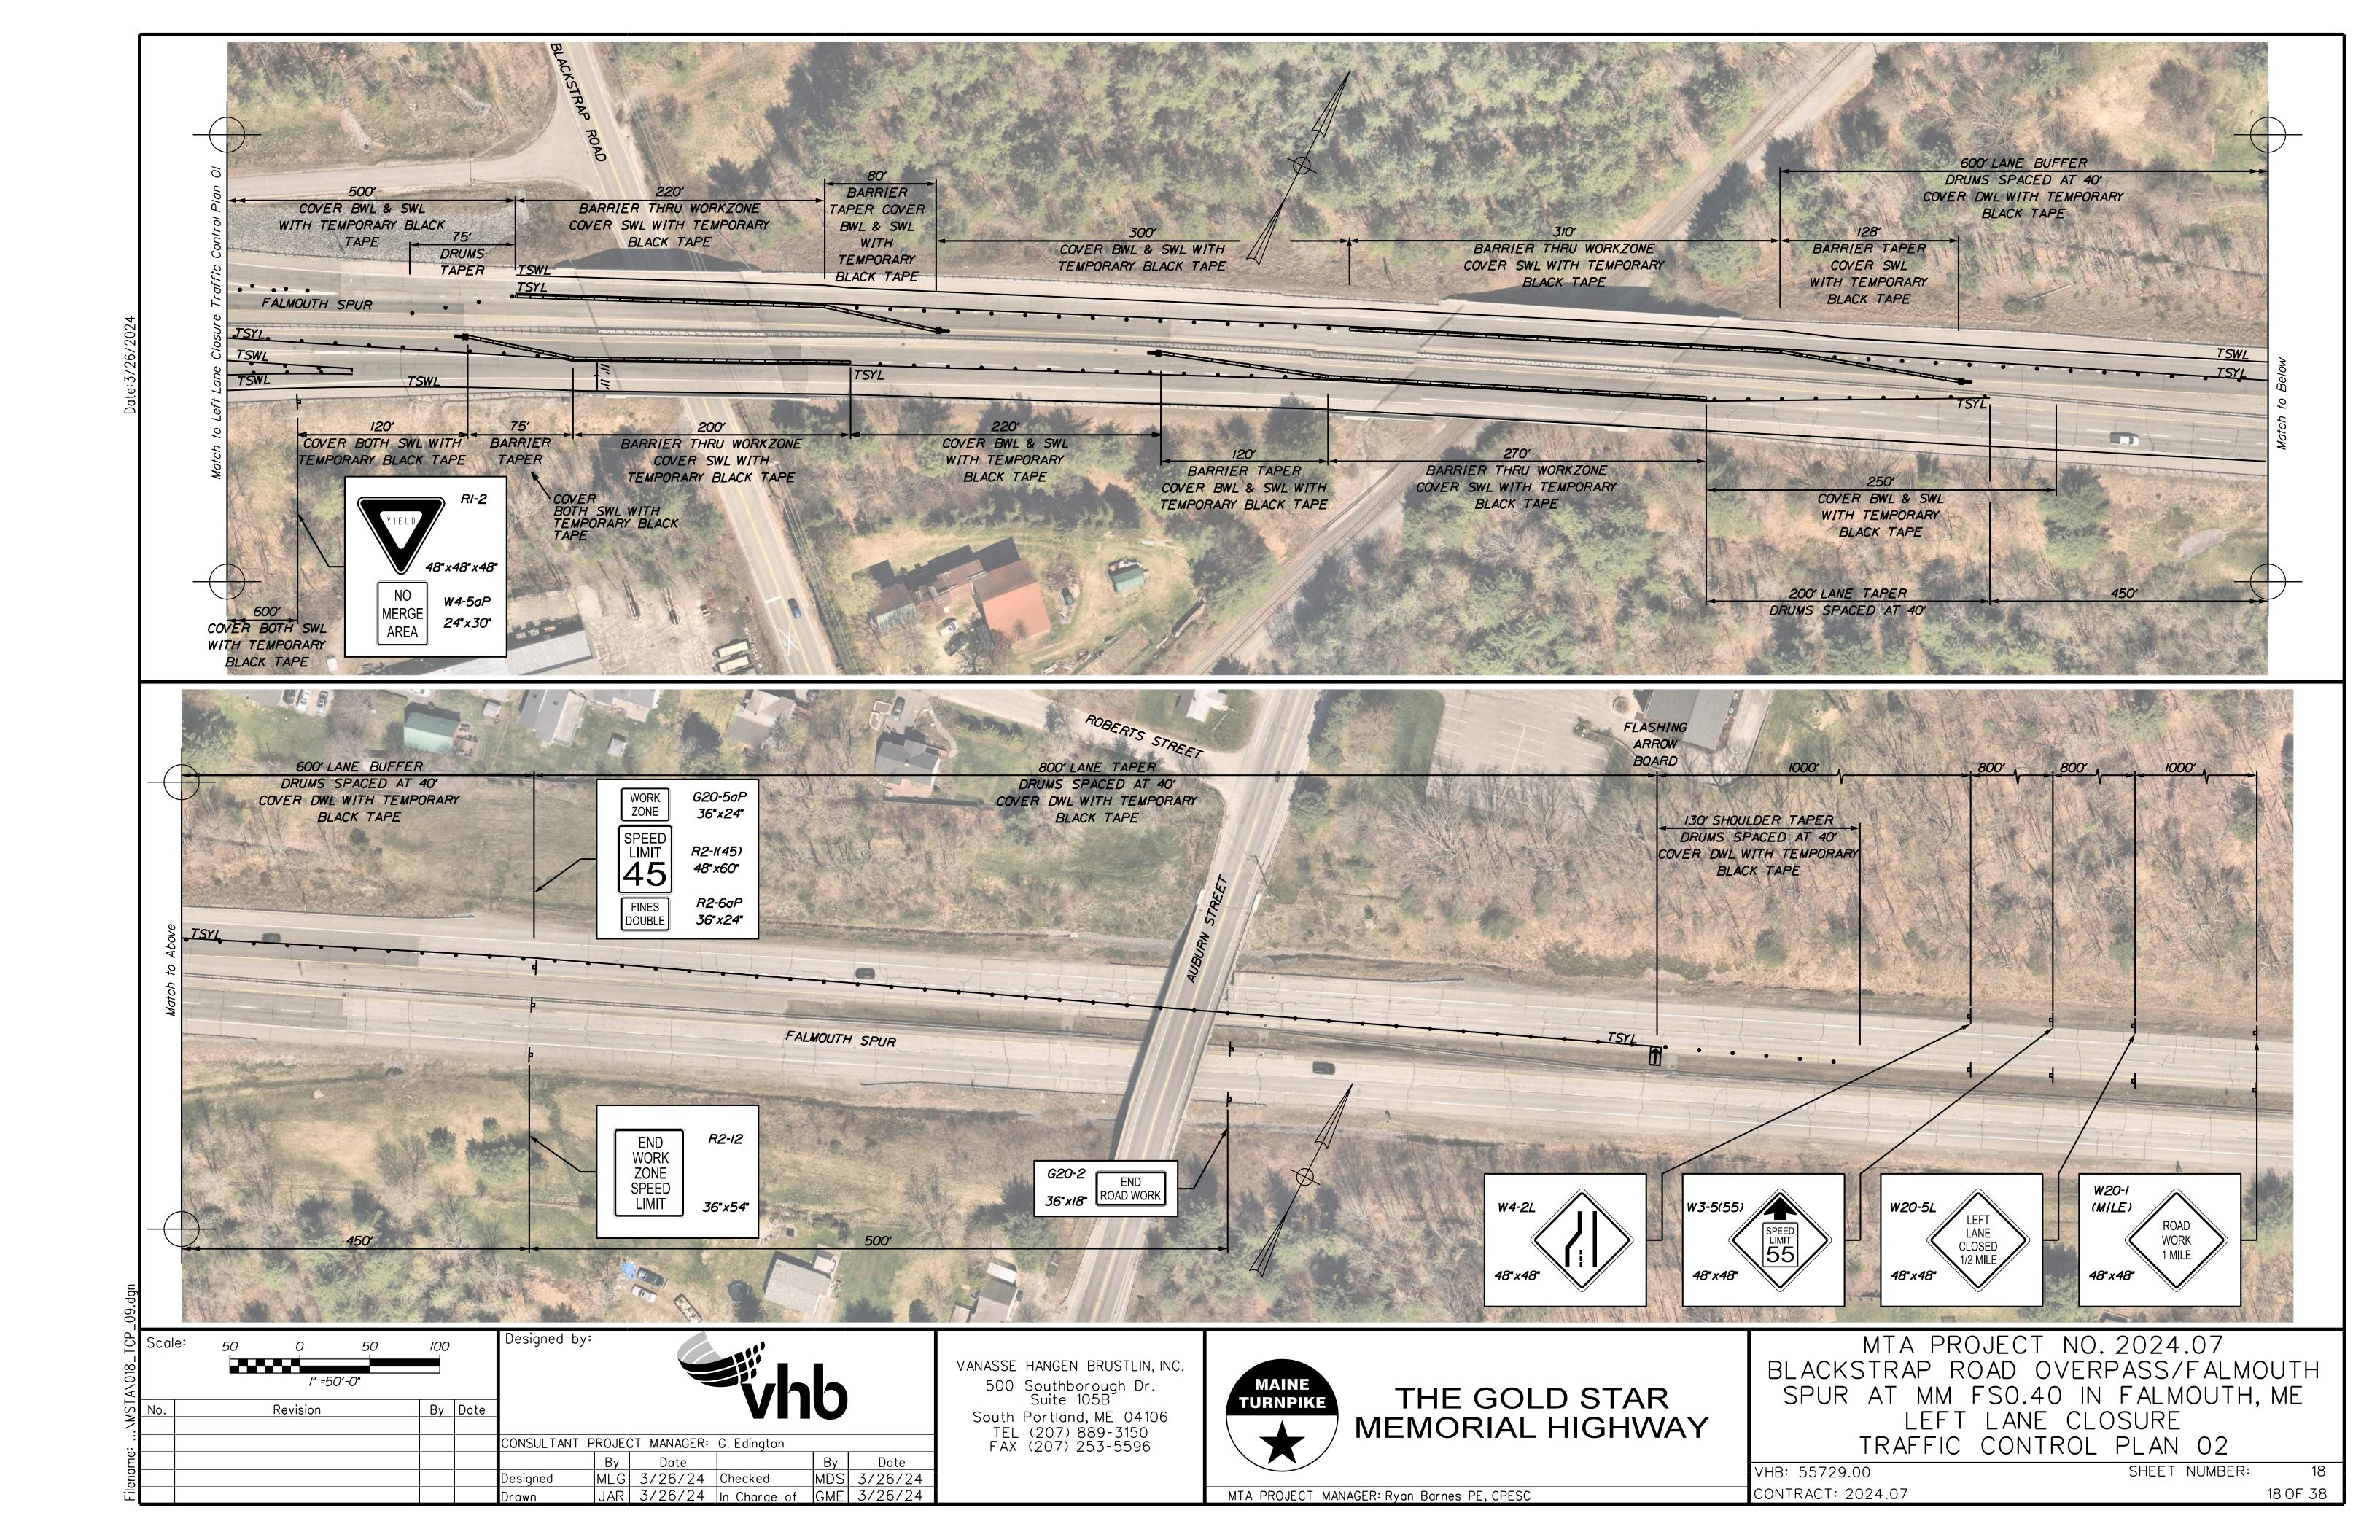
South Portland, ME 04106 TEL (207) 889-3150 FAX (207) 253-5596

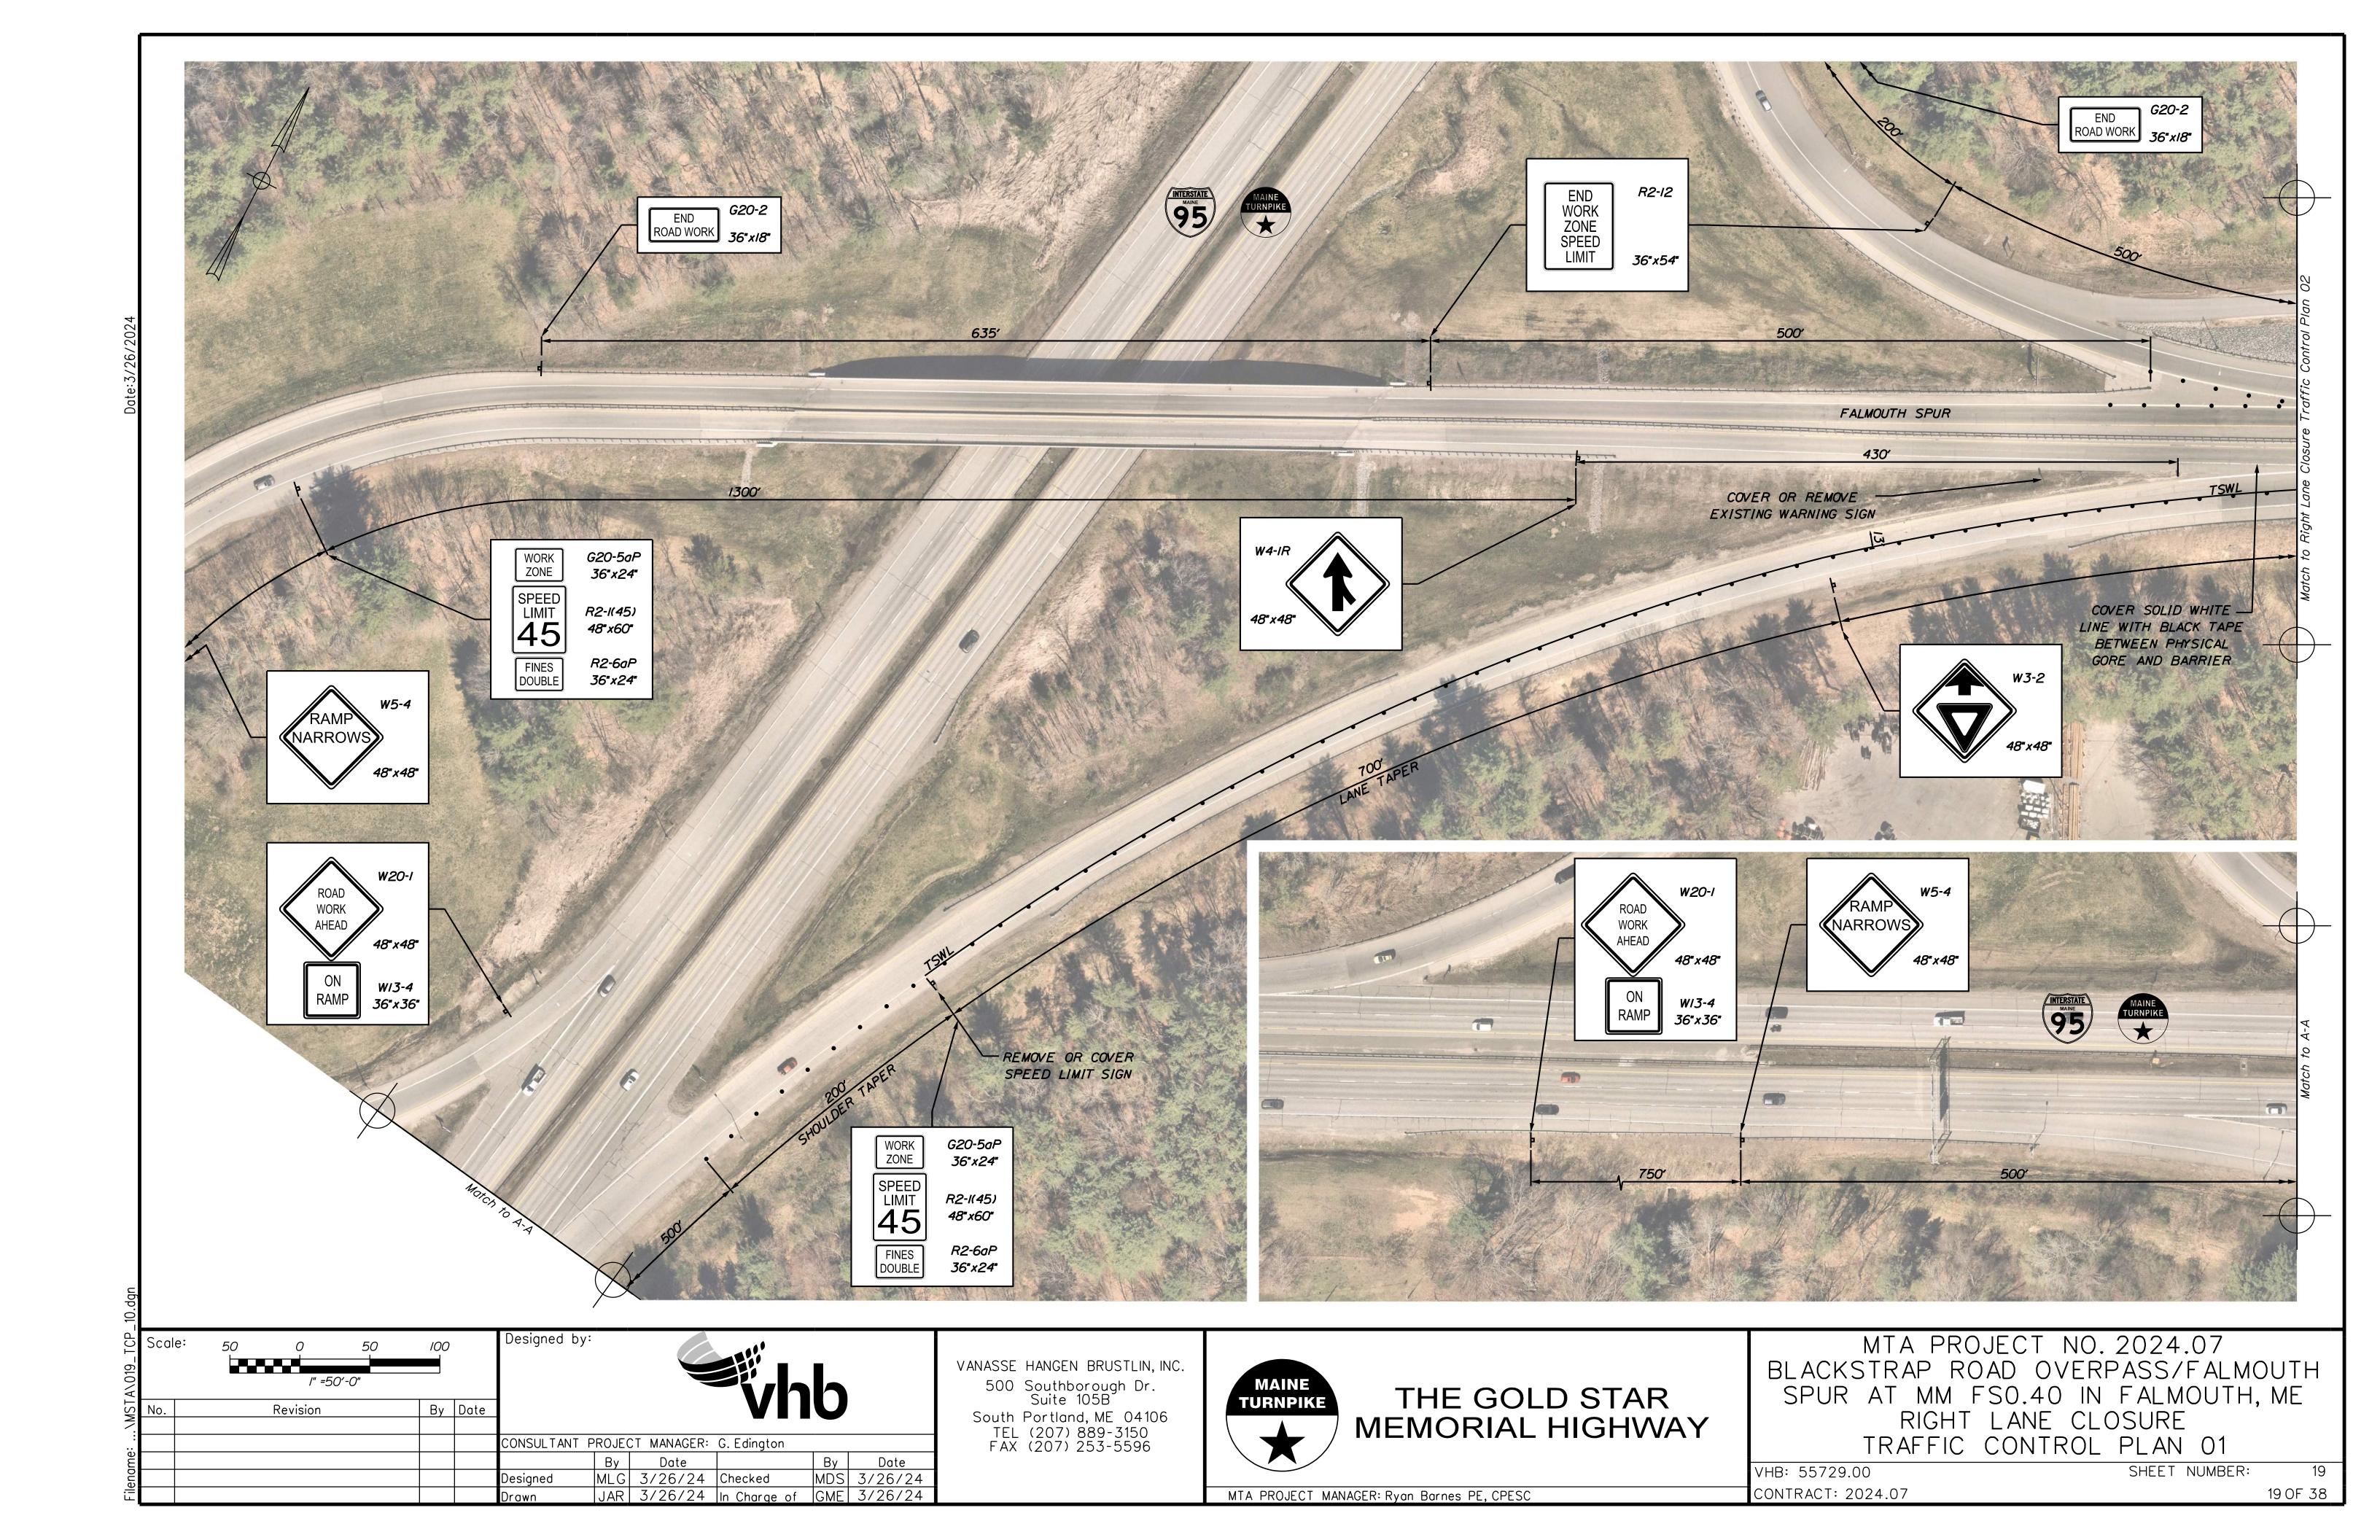


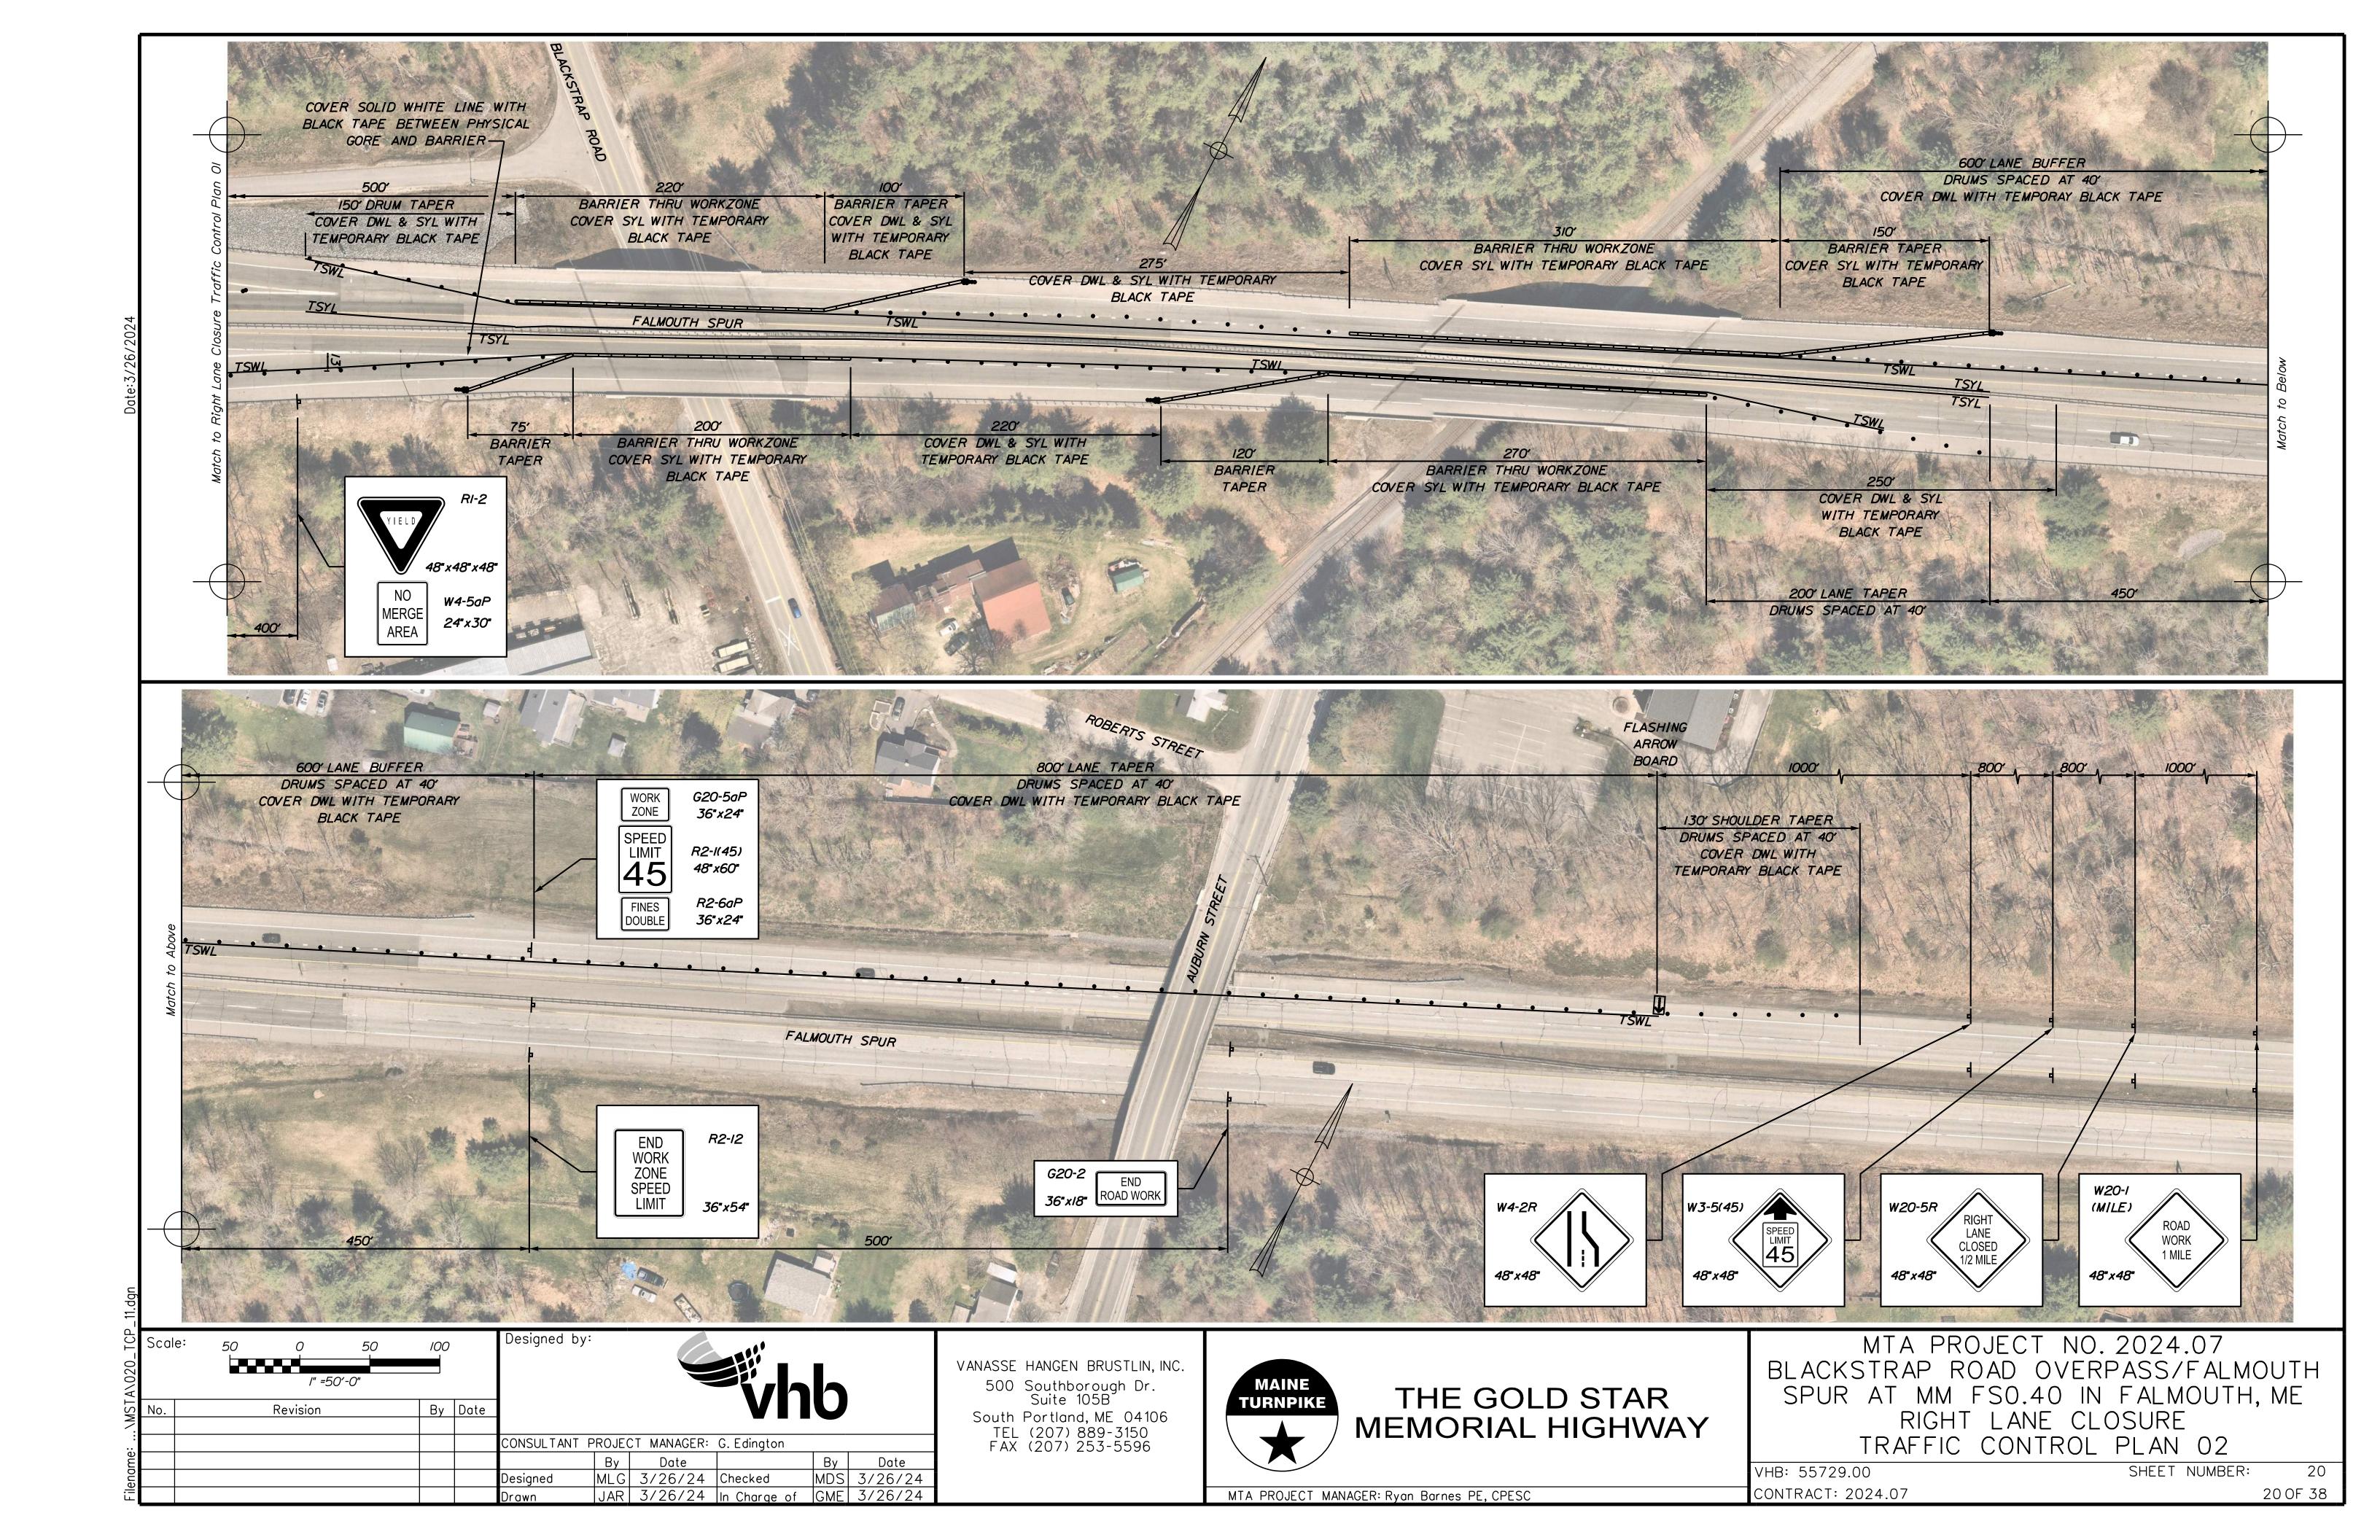
MTA PROJECT MANAGER: Ryan Barnes, PE, CPESC

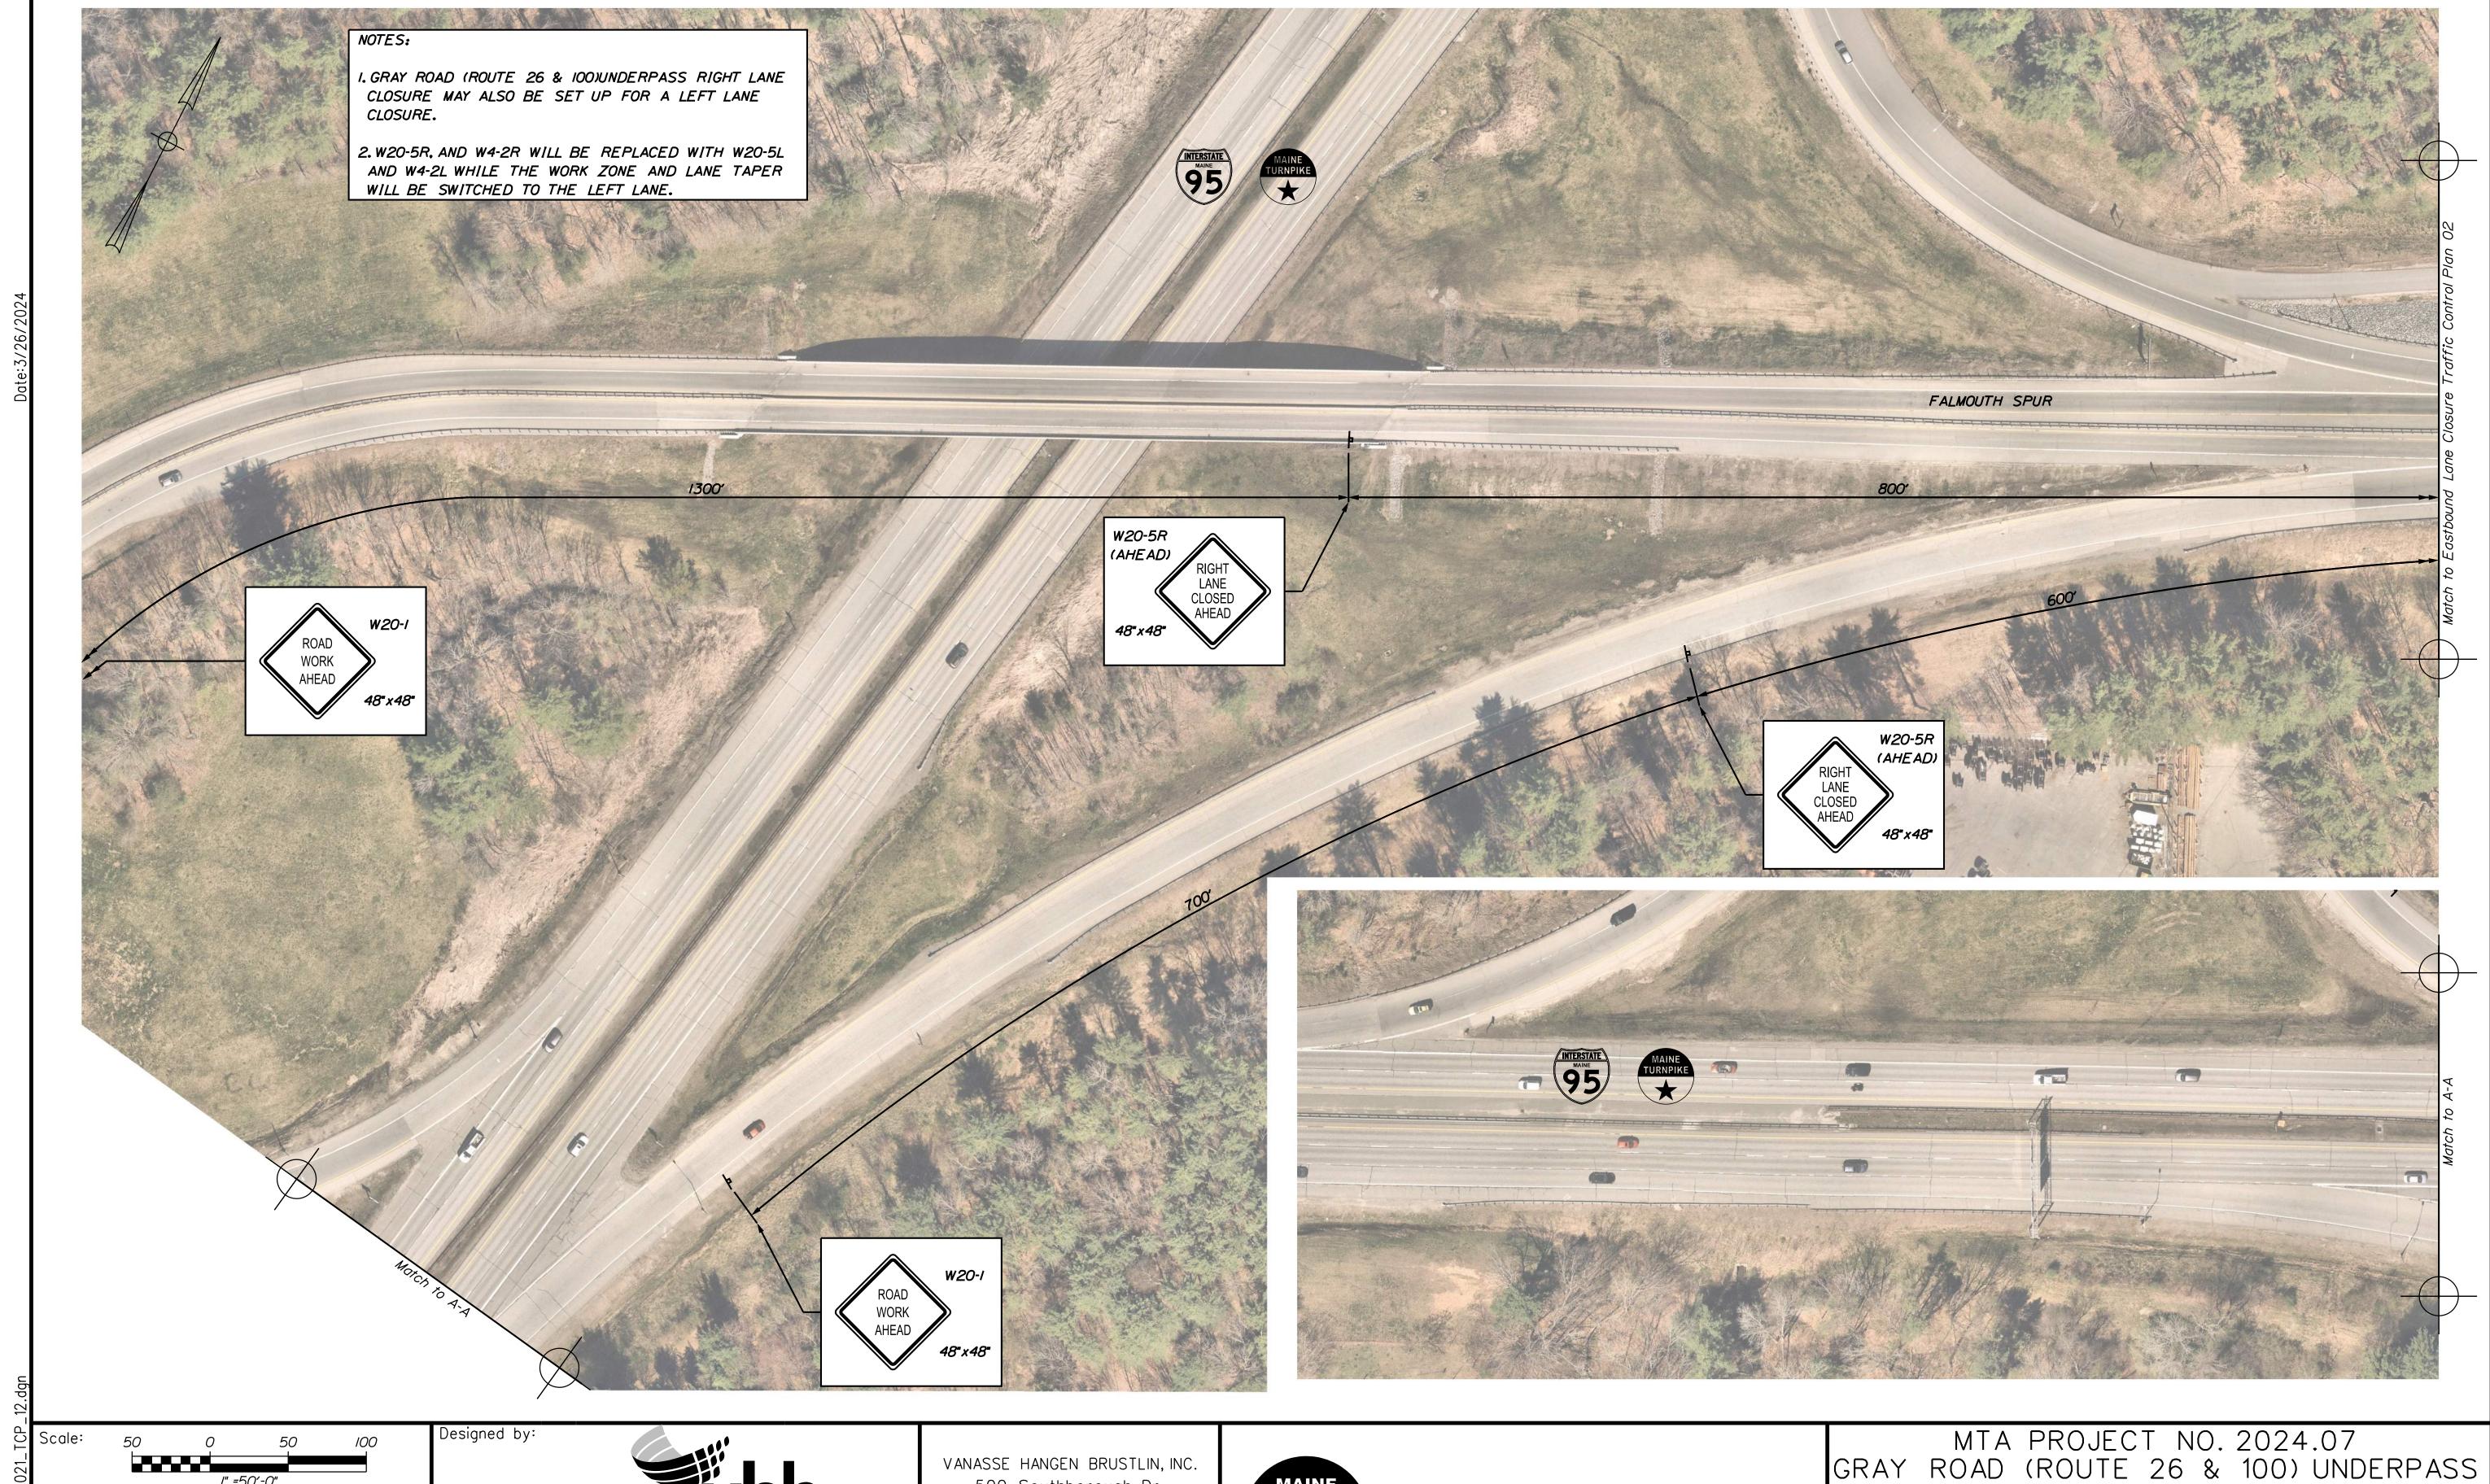
GRAY ROAD (ROUTE 26 & 100) UNDERPASS AT MM FS0.70 IN FALMOUTH EASTBOUND LANE CLOSURE TRAFFIC CONTROL PLAN 01

SHEET NUMBER: VHB: 55729.00 CONTRACT: 2024.07 210F 38

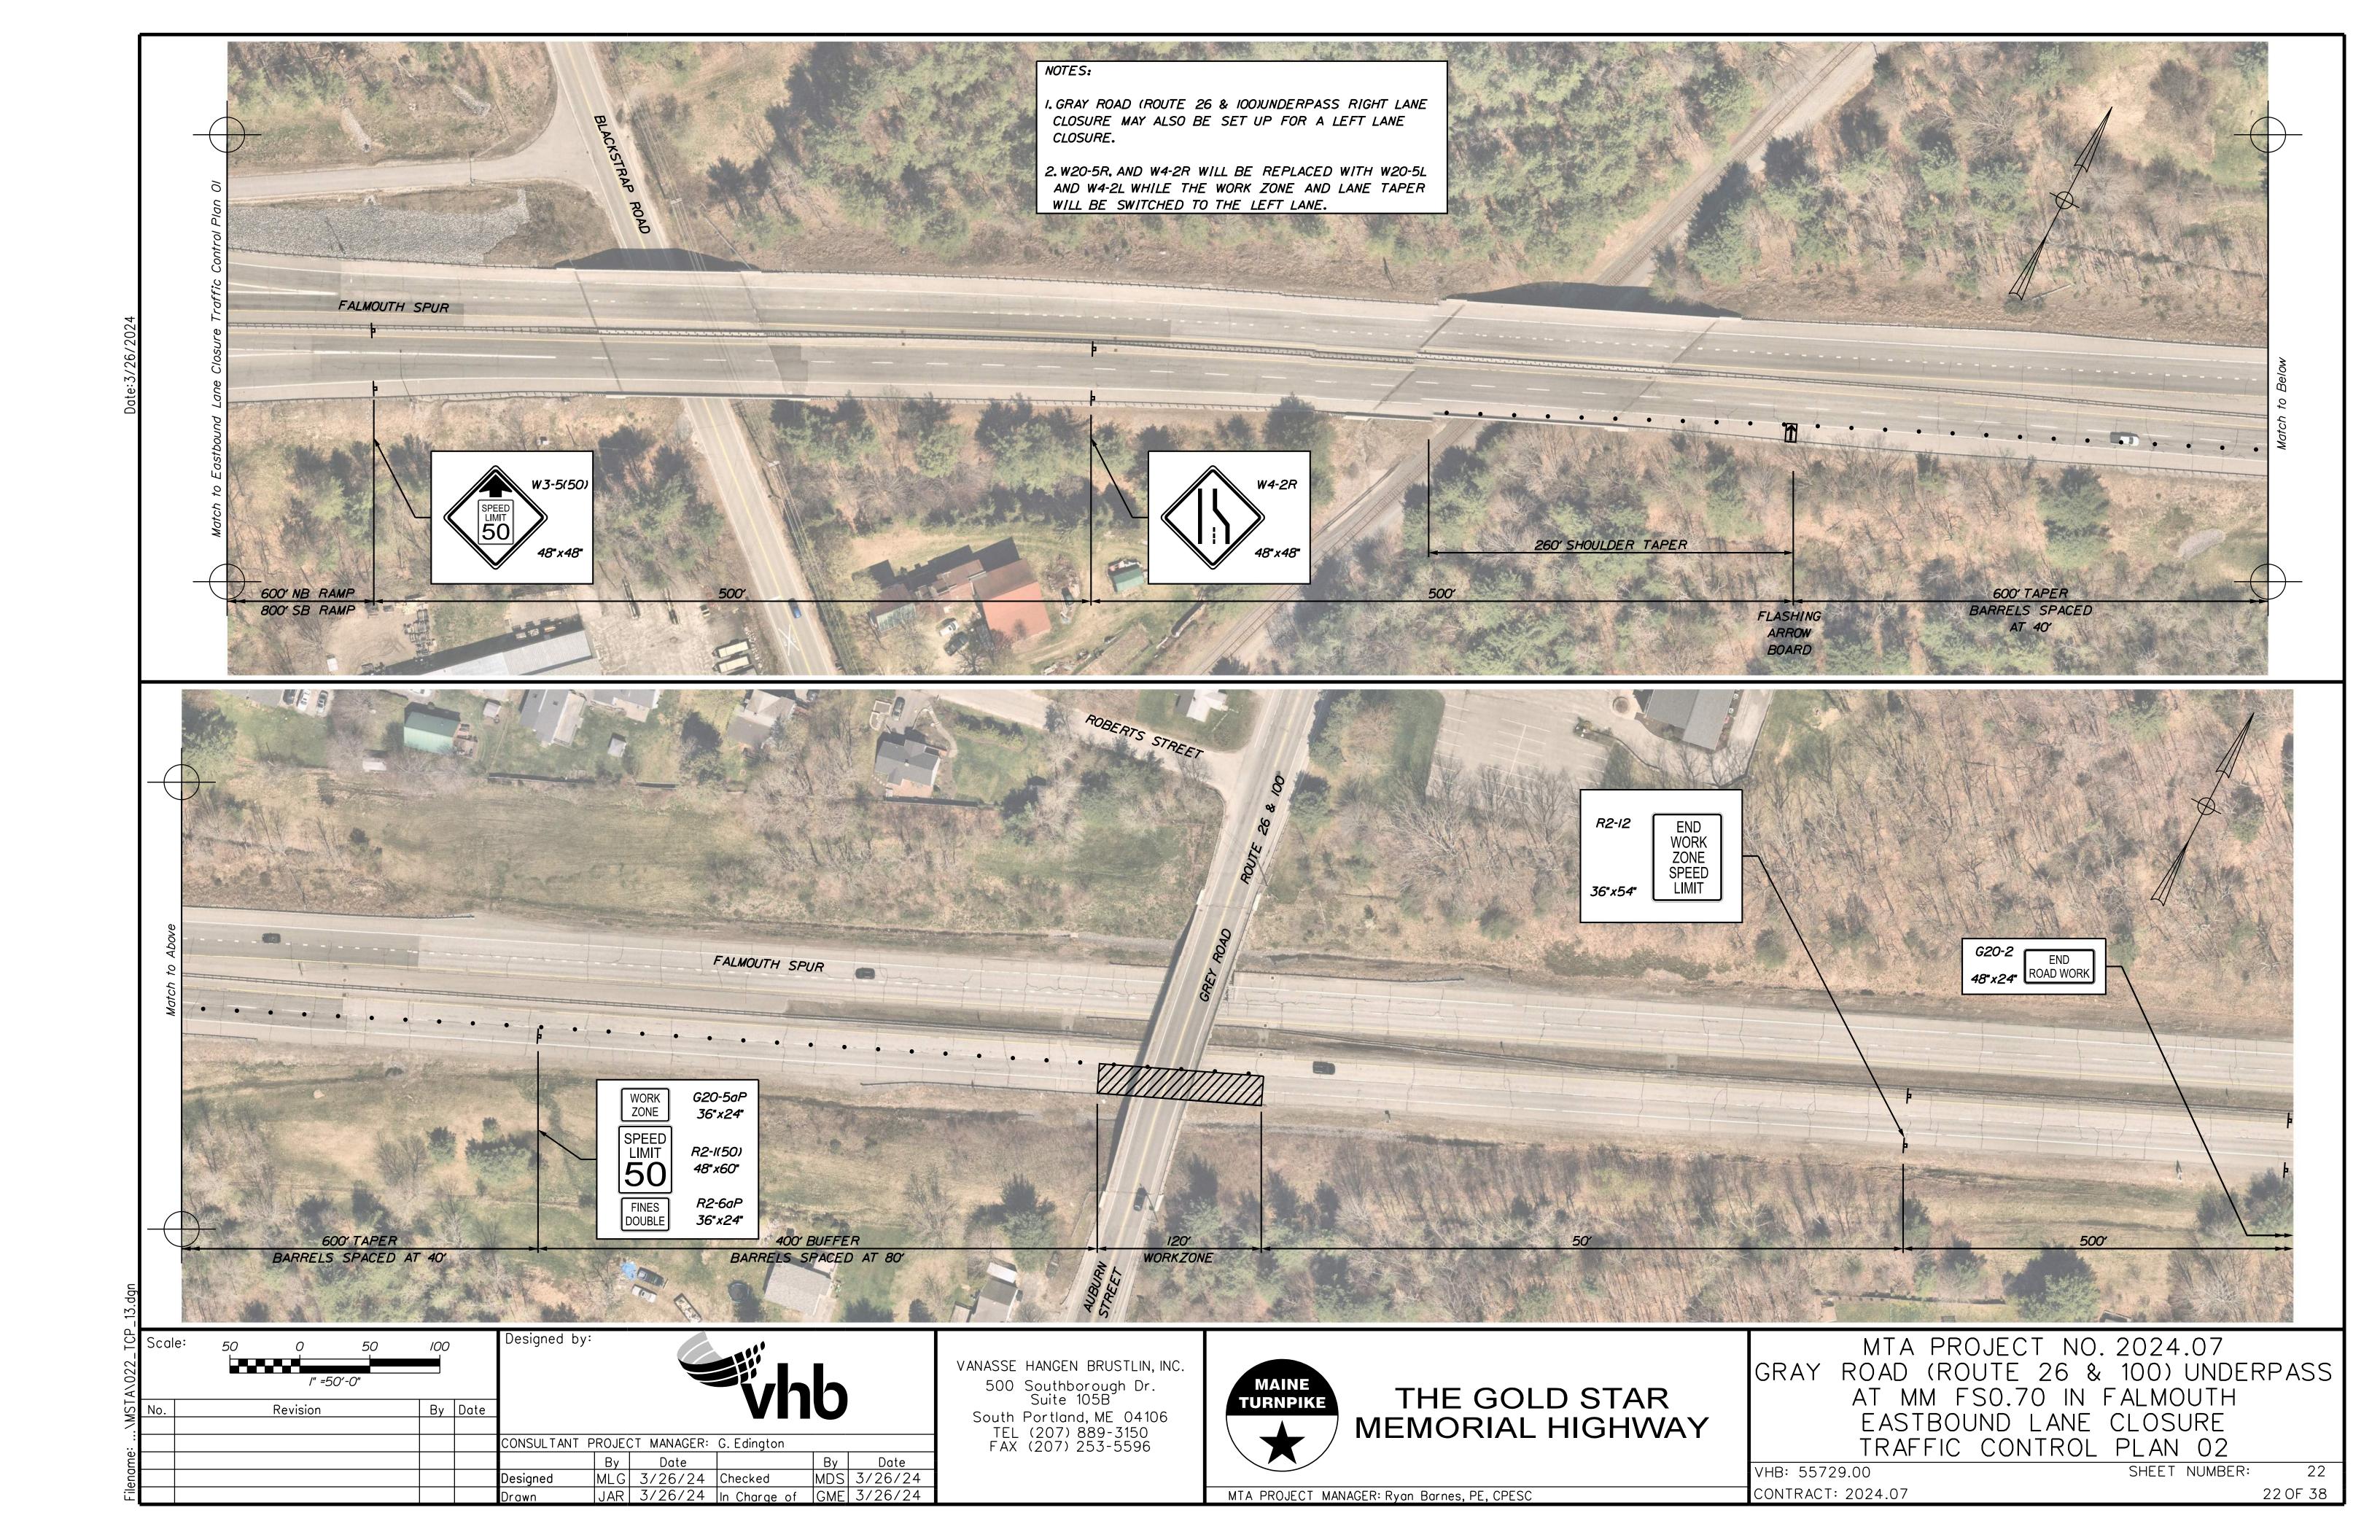

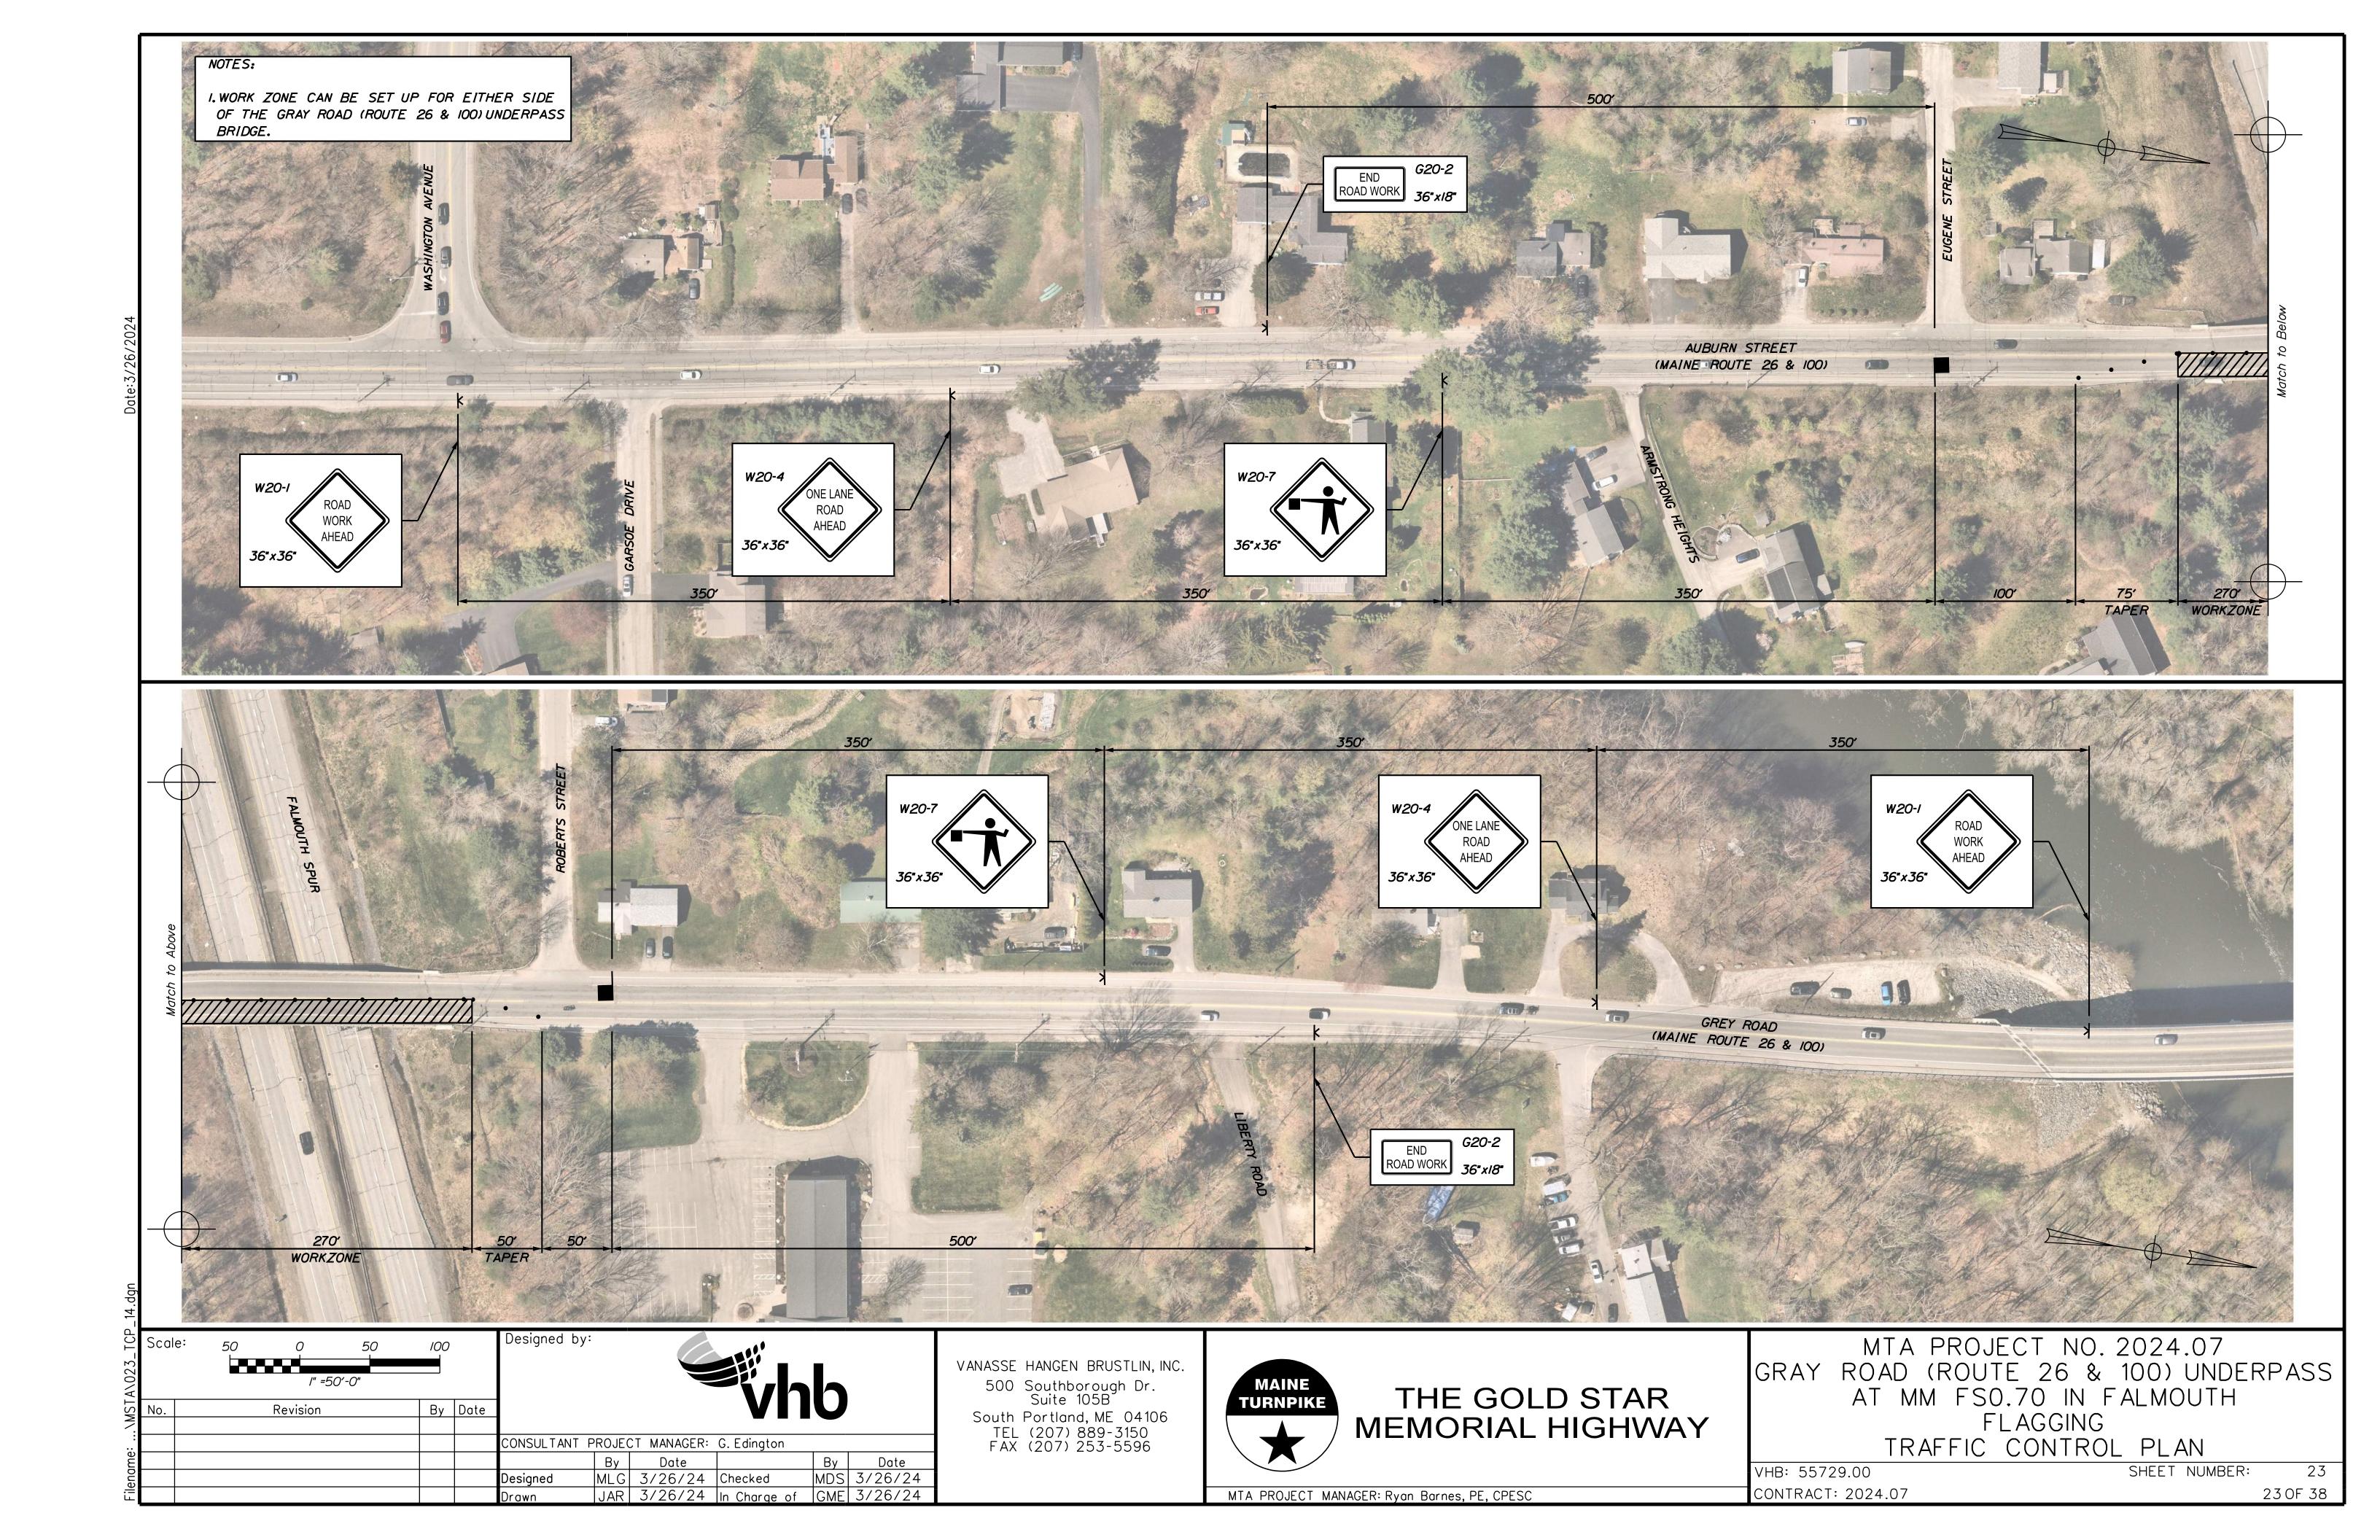

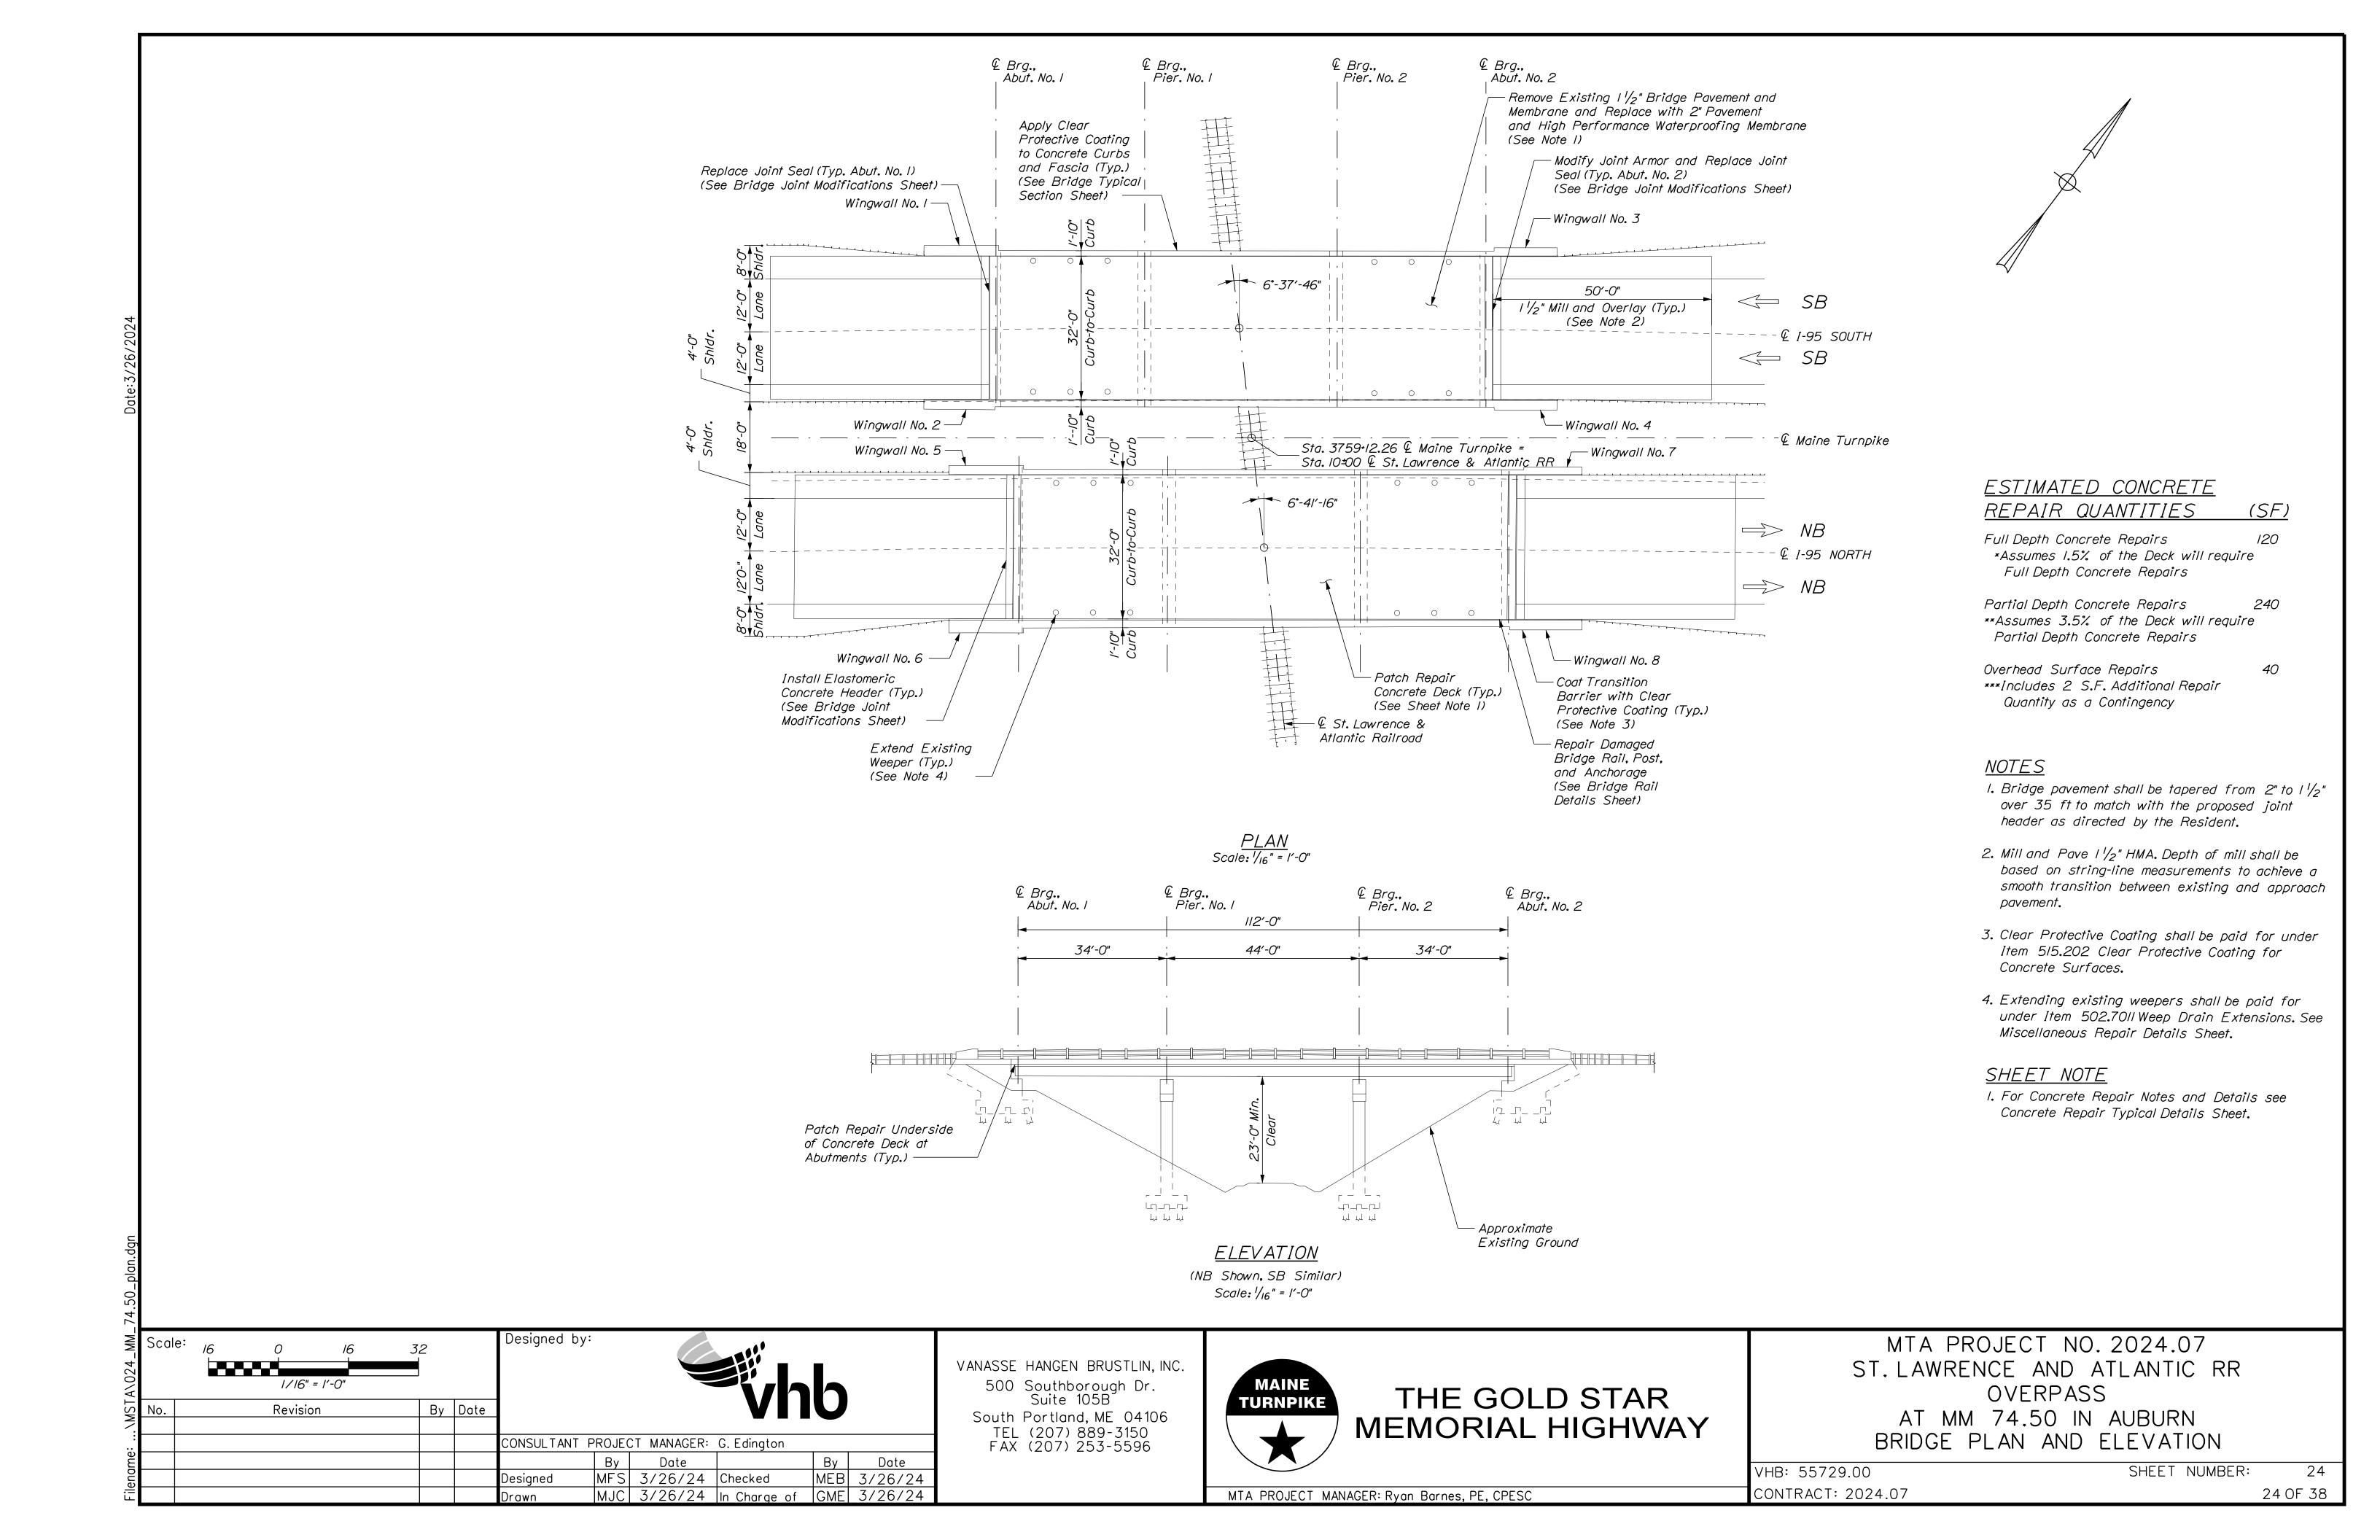

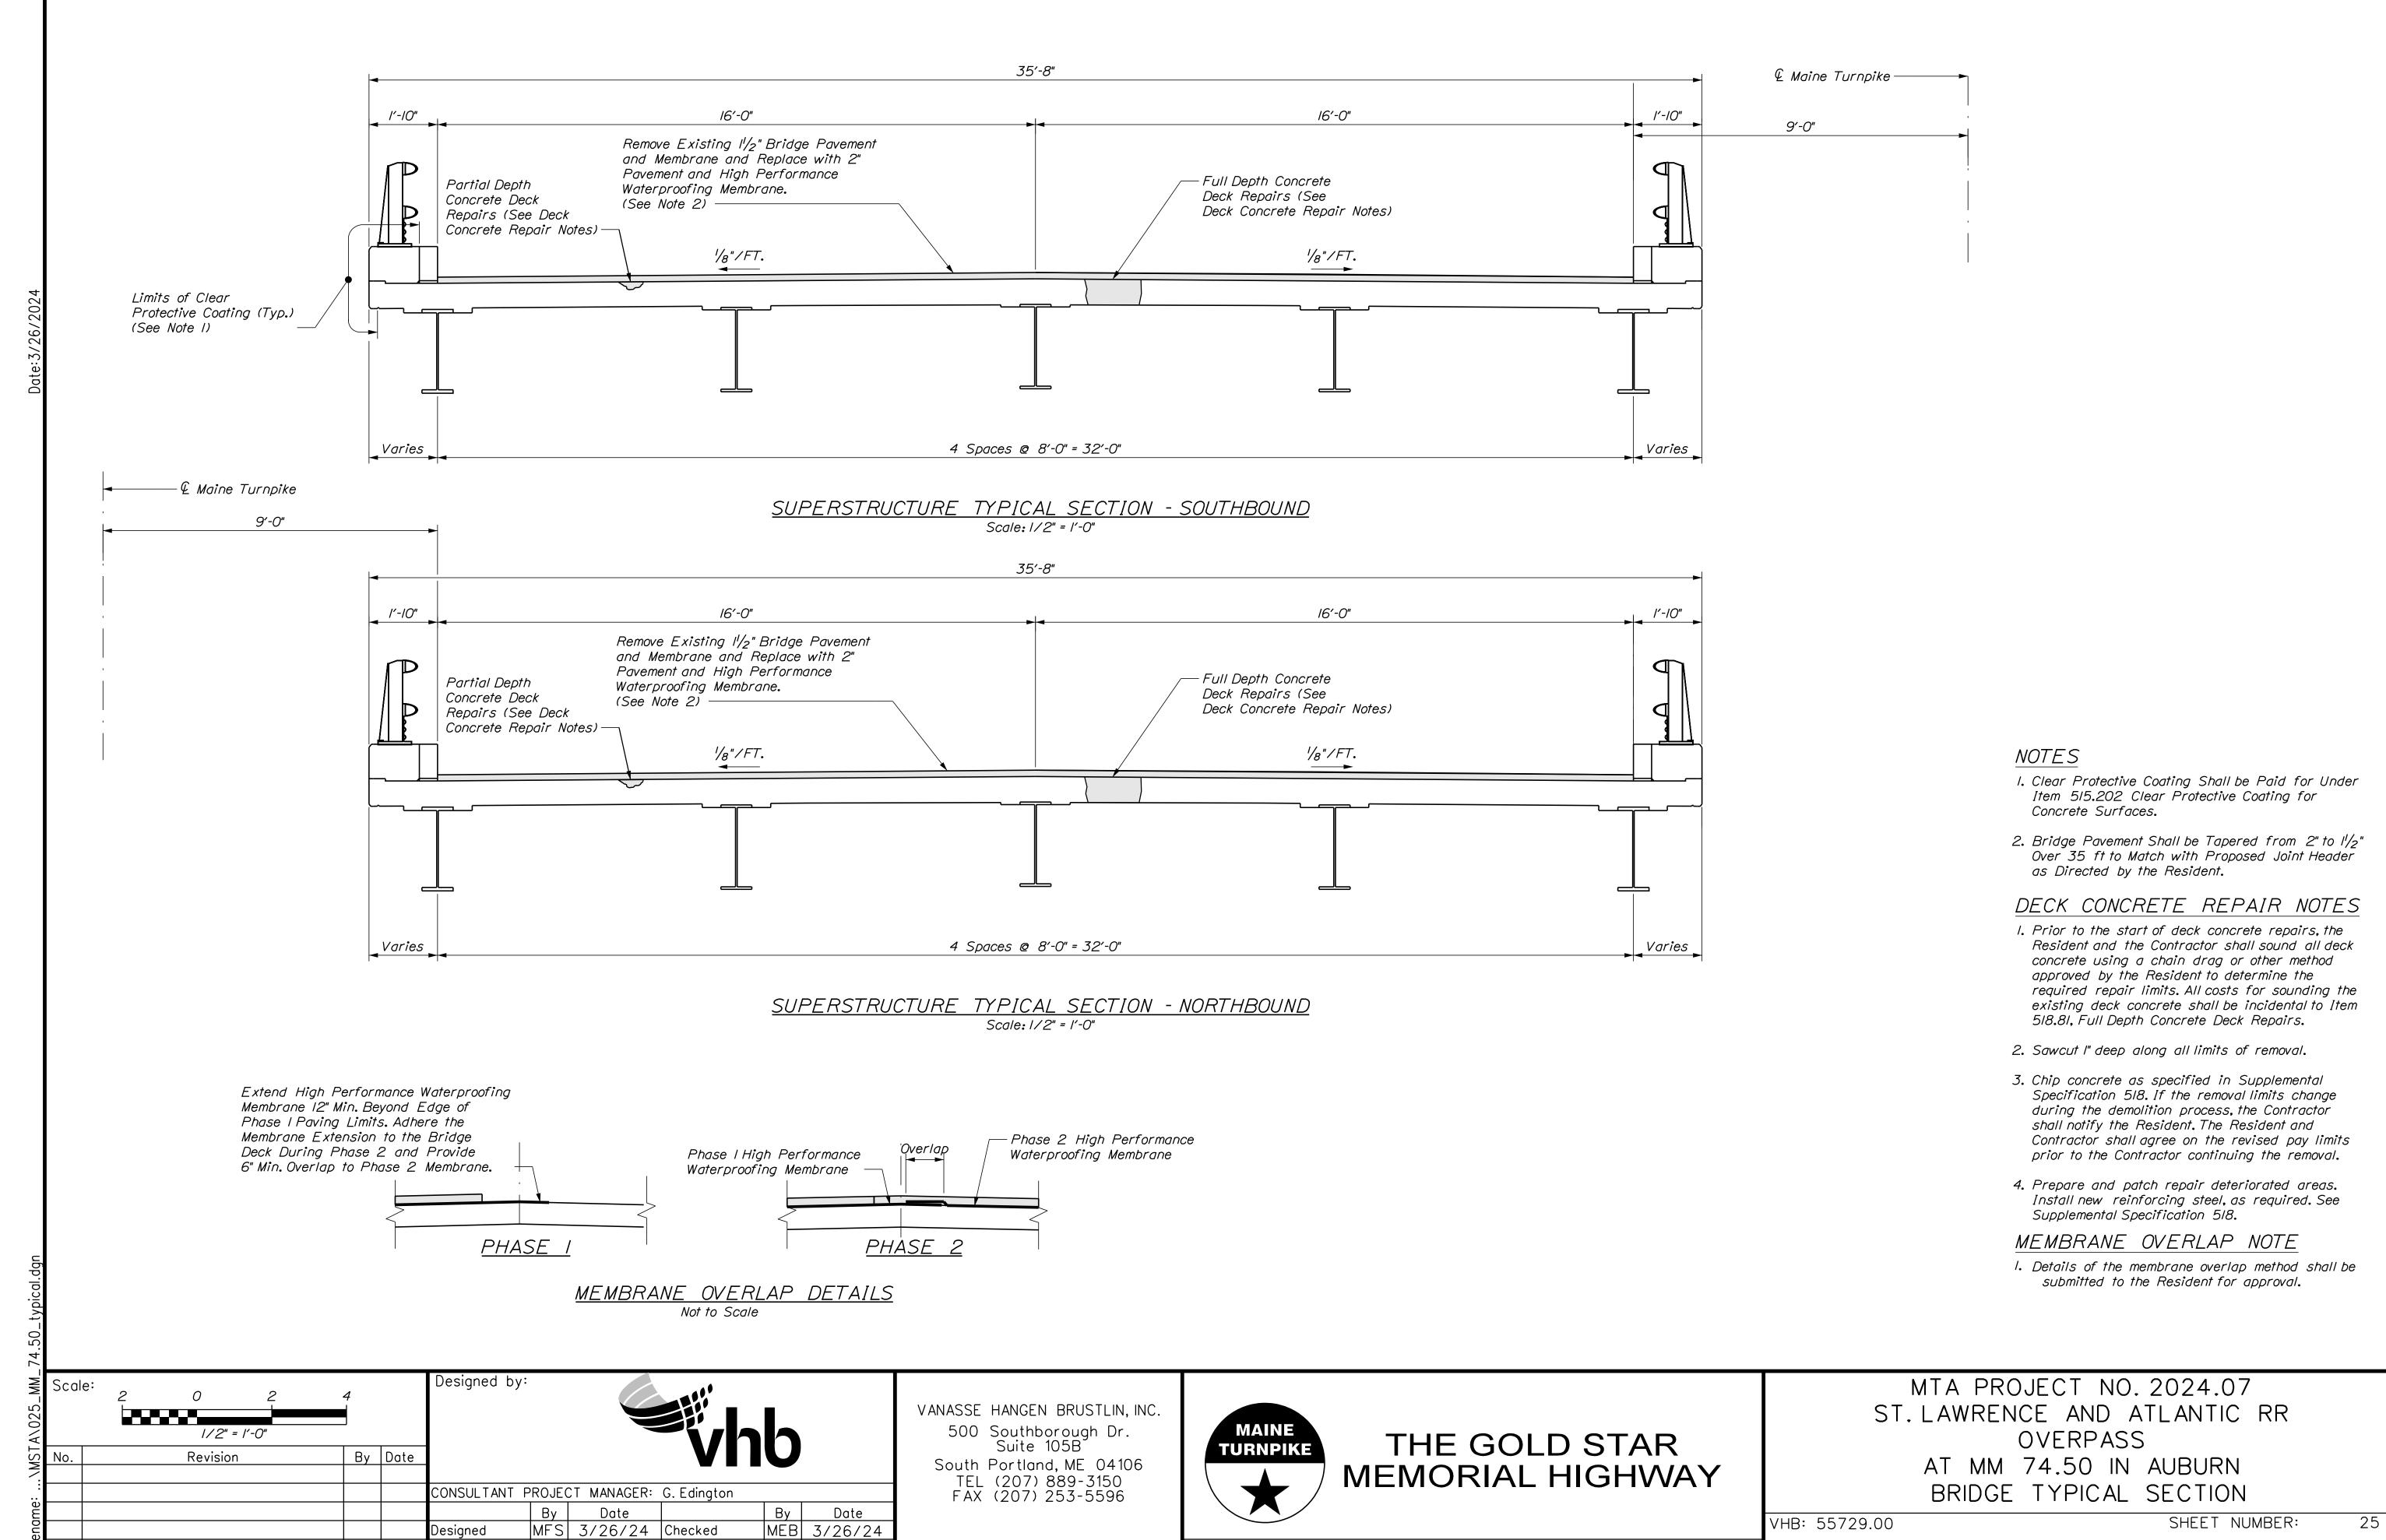


MTA PROJECT MANAGER: Ryan Barnes, PE, CPESC

MJC 3/26/24 In Charge of GME 3/26/24

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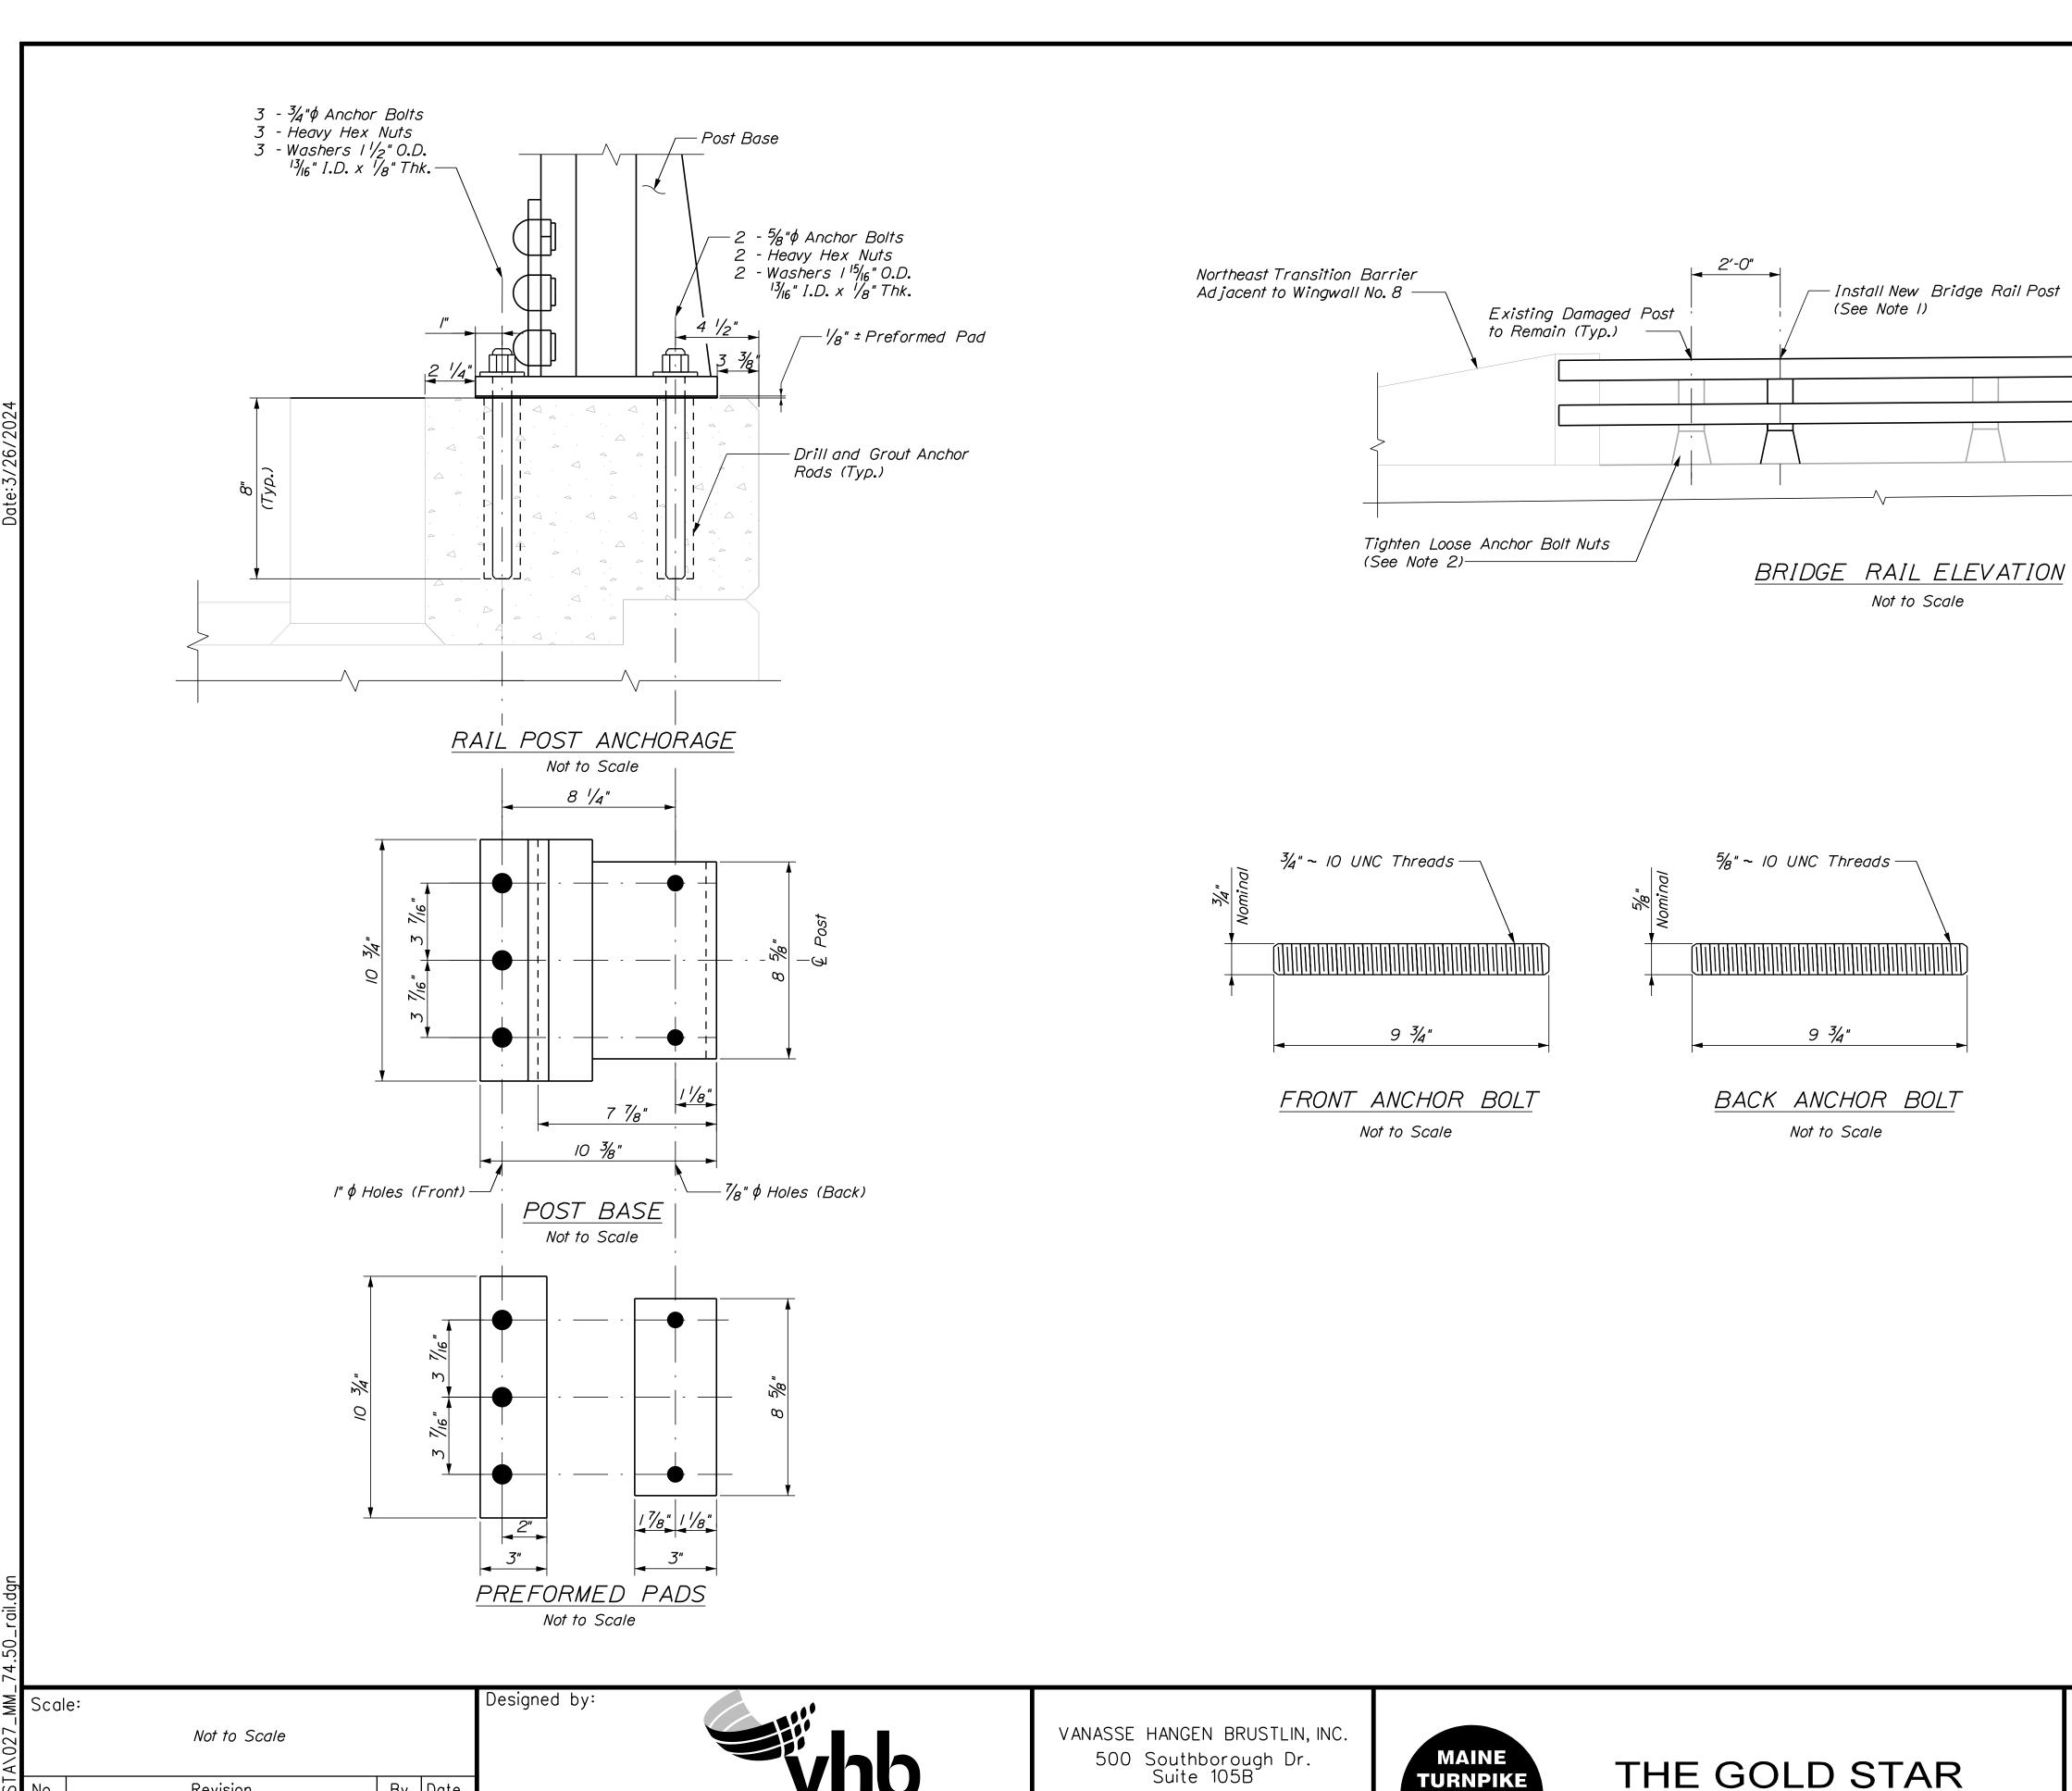
CONTRACT: 2024.07

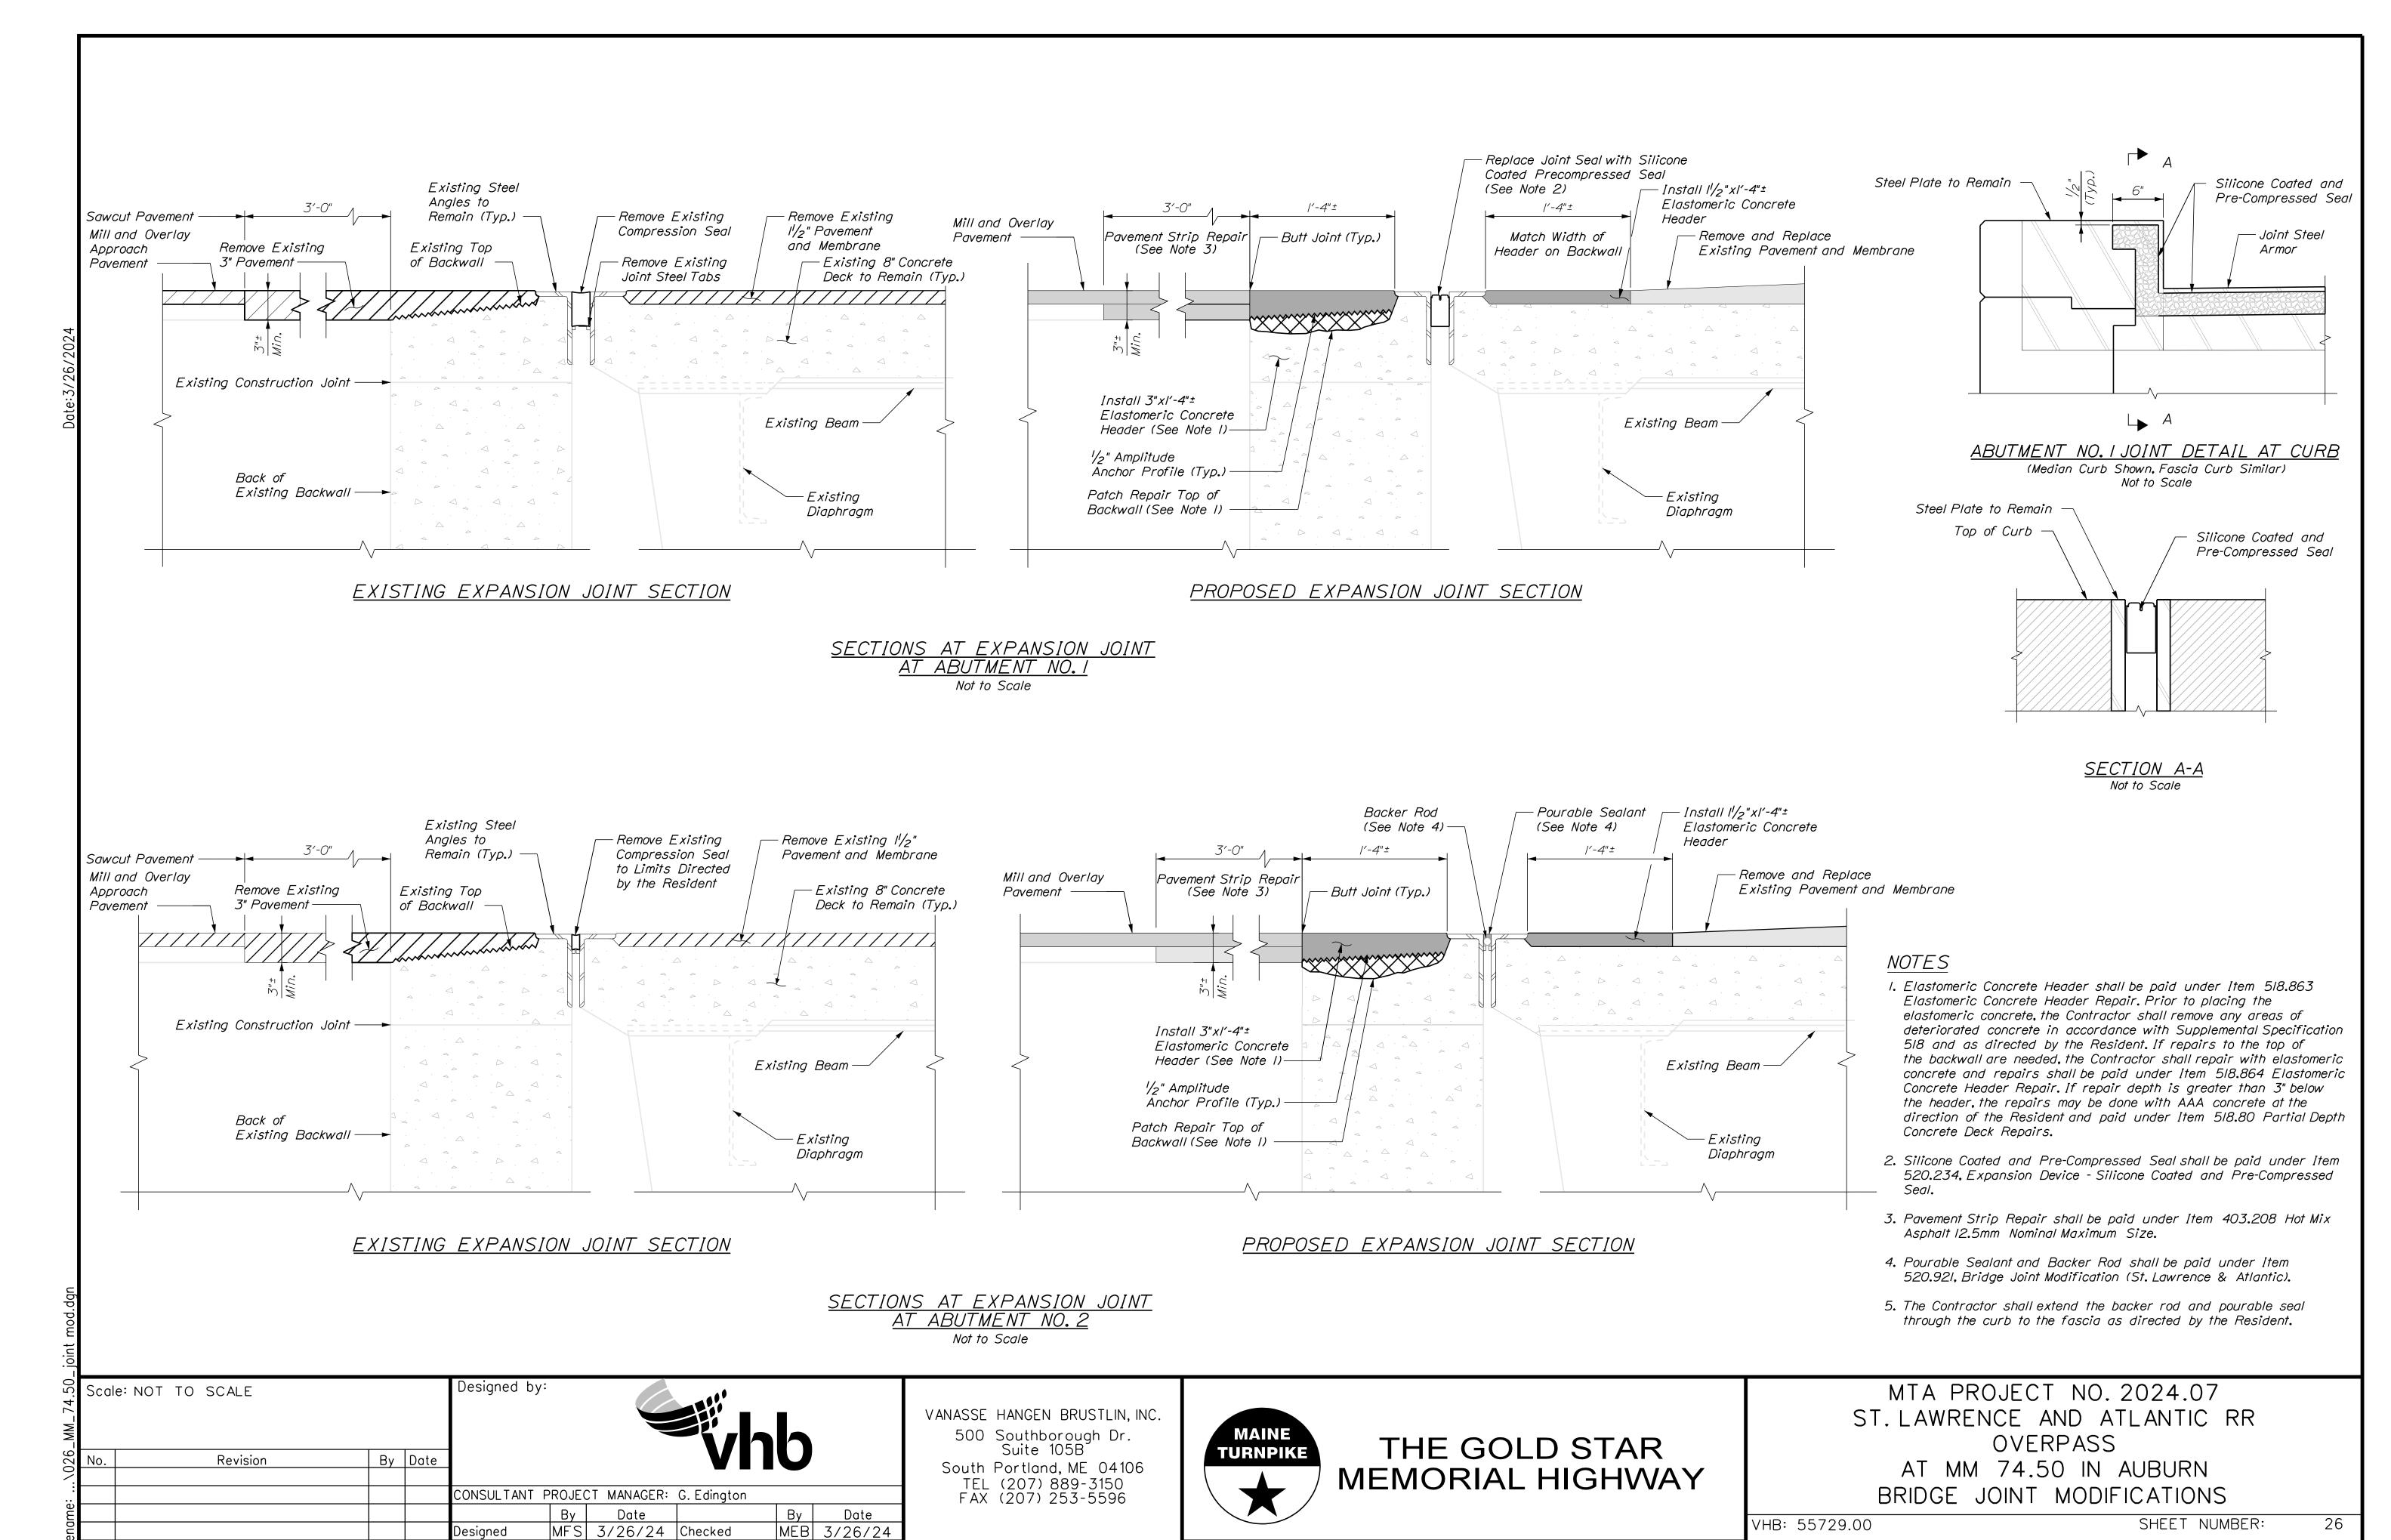

MTA PROJECT MANAGER: Ryan Barnes, PE, CPESC

TSR 3/26/24 In Charge of GME 3/26/24

CONTRACT: 2024.07 26 OF 38



South Portland, ME 04106

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By Date MEB 3/26/24

By Date

Designed

CONSULTANT PROJECT MANAGER: G. Edington

MFS 3/26/24 Checked

MJC 3/26/24 In Charge of GME 3/26/24

Revision

MTA PROJECT NO. 2024.07 ST. LAWRENCE AND ATLANTIC RR OVERPASS

NOTES

AT MM 74.50 IN AUBURN BRIDGE RAIL DETAILS

27

I. Installation of new bridge rail post shall be paid under item 507.812 Aluminum Bridge Rail, 2 Bar Repair.

2. The Contractor shall tighten loose anchor bolt nuts on existing damaged post. This work shall be incidental to item 507.812 Aluminum Bridge Rail, 2 Bar Repair.

I. If cut threads are used, body diameter shall

2. If rolled threads are used, body diameter shall be no less than root diameter of threads.


ANCHOR BOLTS NOTES

be no less than nominal diameter.

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MEMORIAL HIGHWAY

MTA PROJECT MANAGER: Ryan Barnes, PE, CPESC

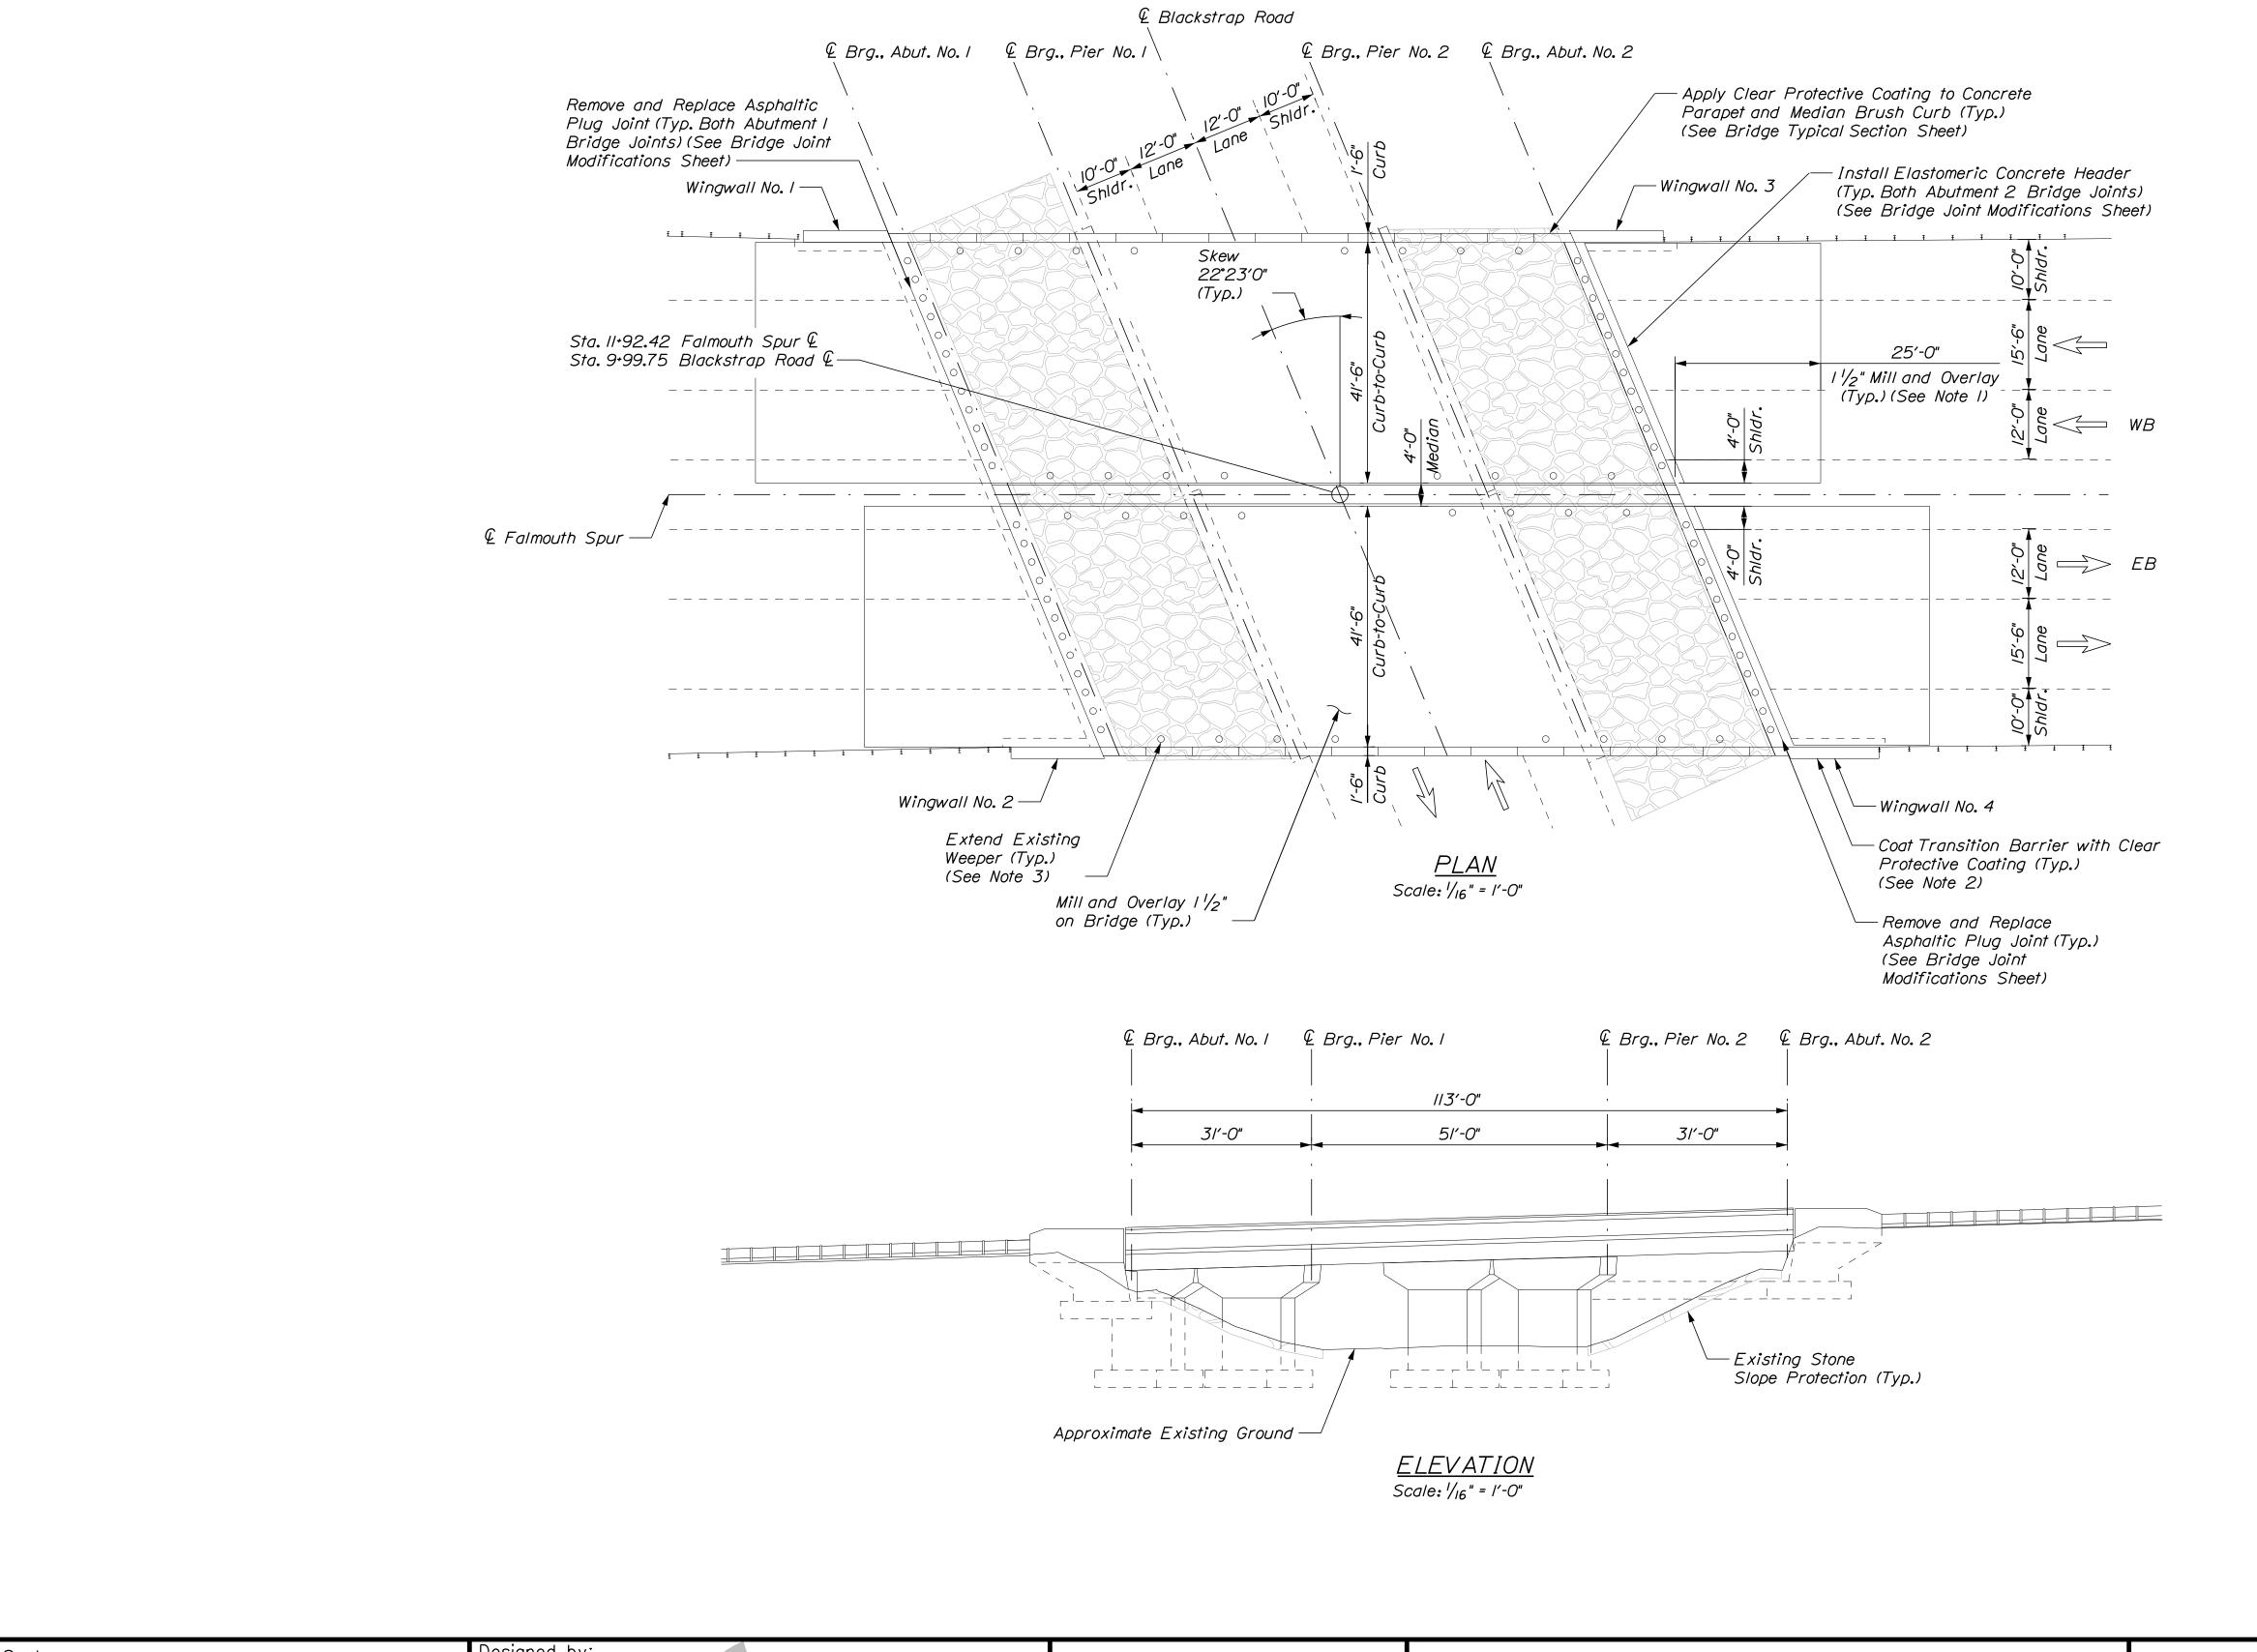

#### <u>NOTES</u>

- I. Mill and pave l'/2" HMA. Depth of mill shall be based on string-line measurements to achieve a smooth transition between existing and approach pavement.
- 2. Clear Protective Coating Shall be Paid for Under Item 515.202 Clear Protective Coating for Concrete Surfaces.
- 3. Extending existing weepers shall be paid for under Item 502.7011 Weep Drain Extensions. See Miscellaneous Repair Details Sheet.

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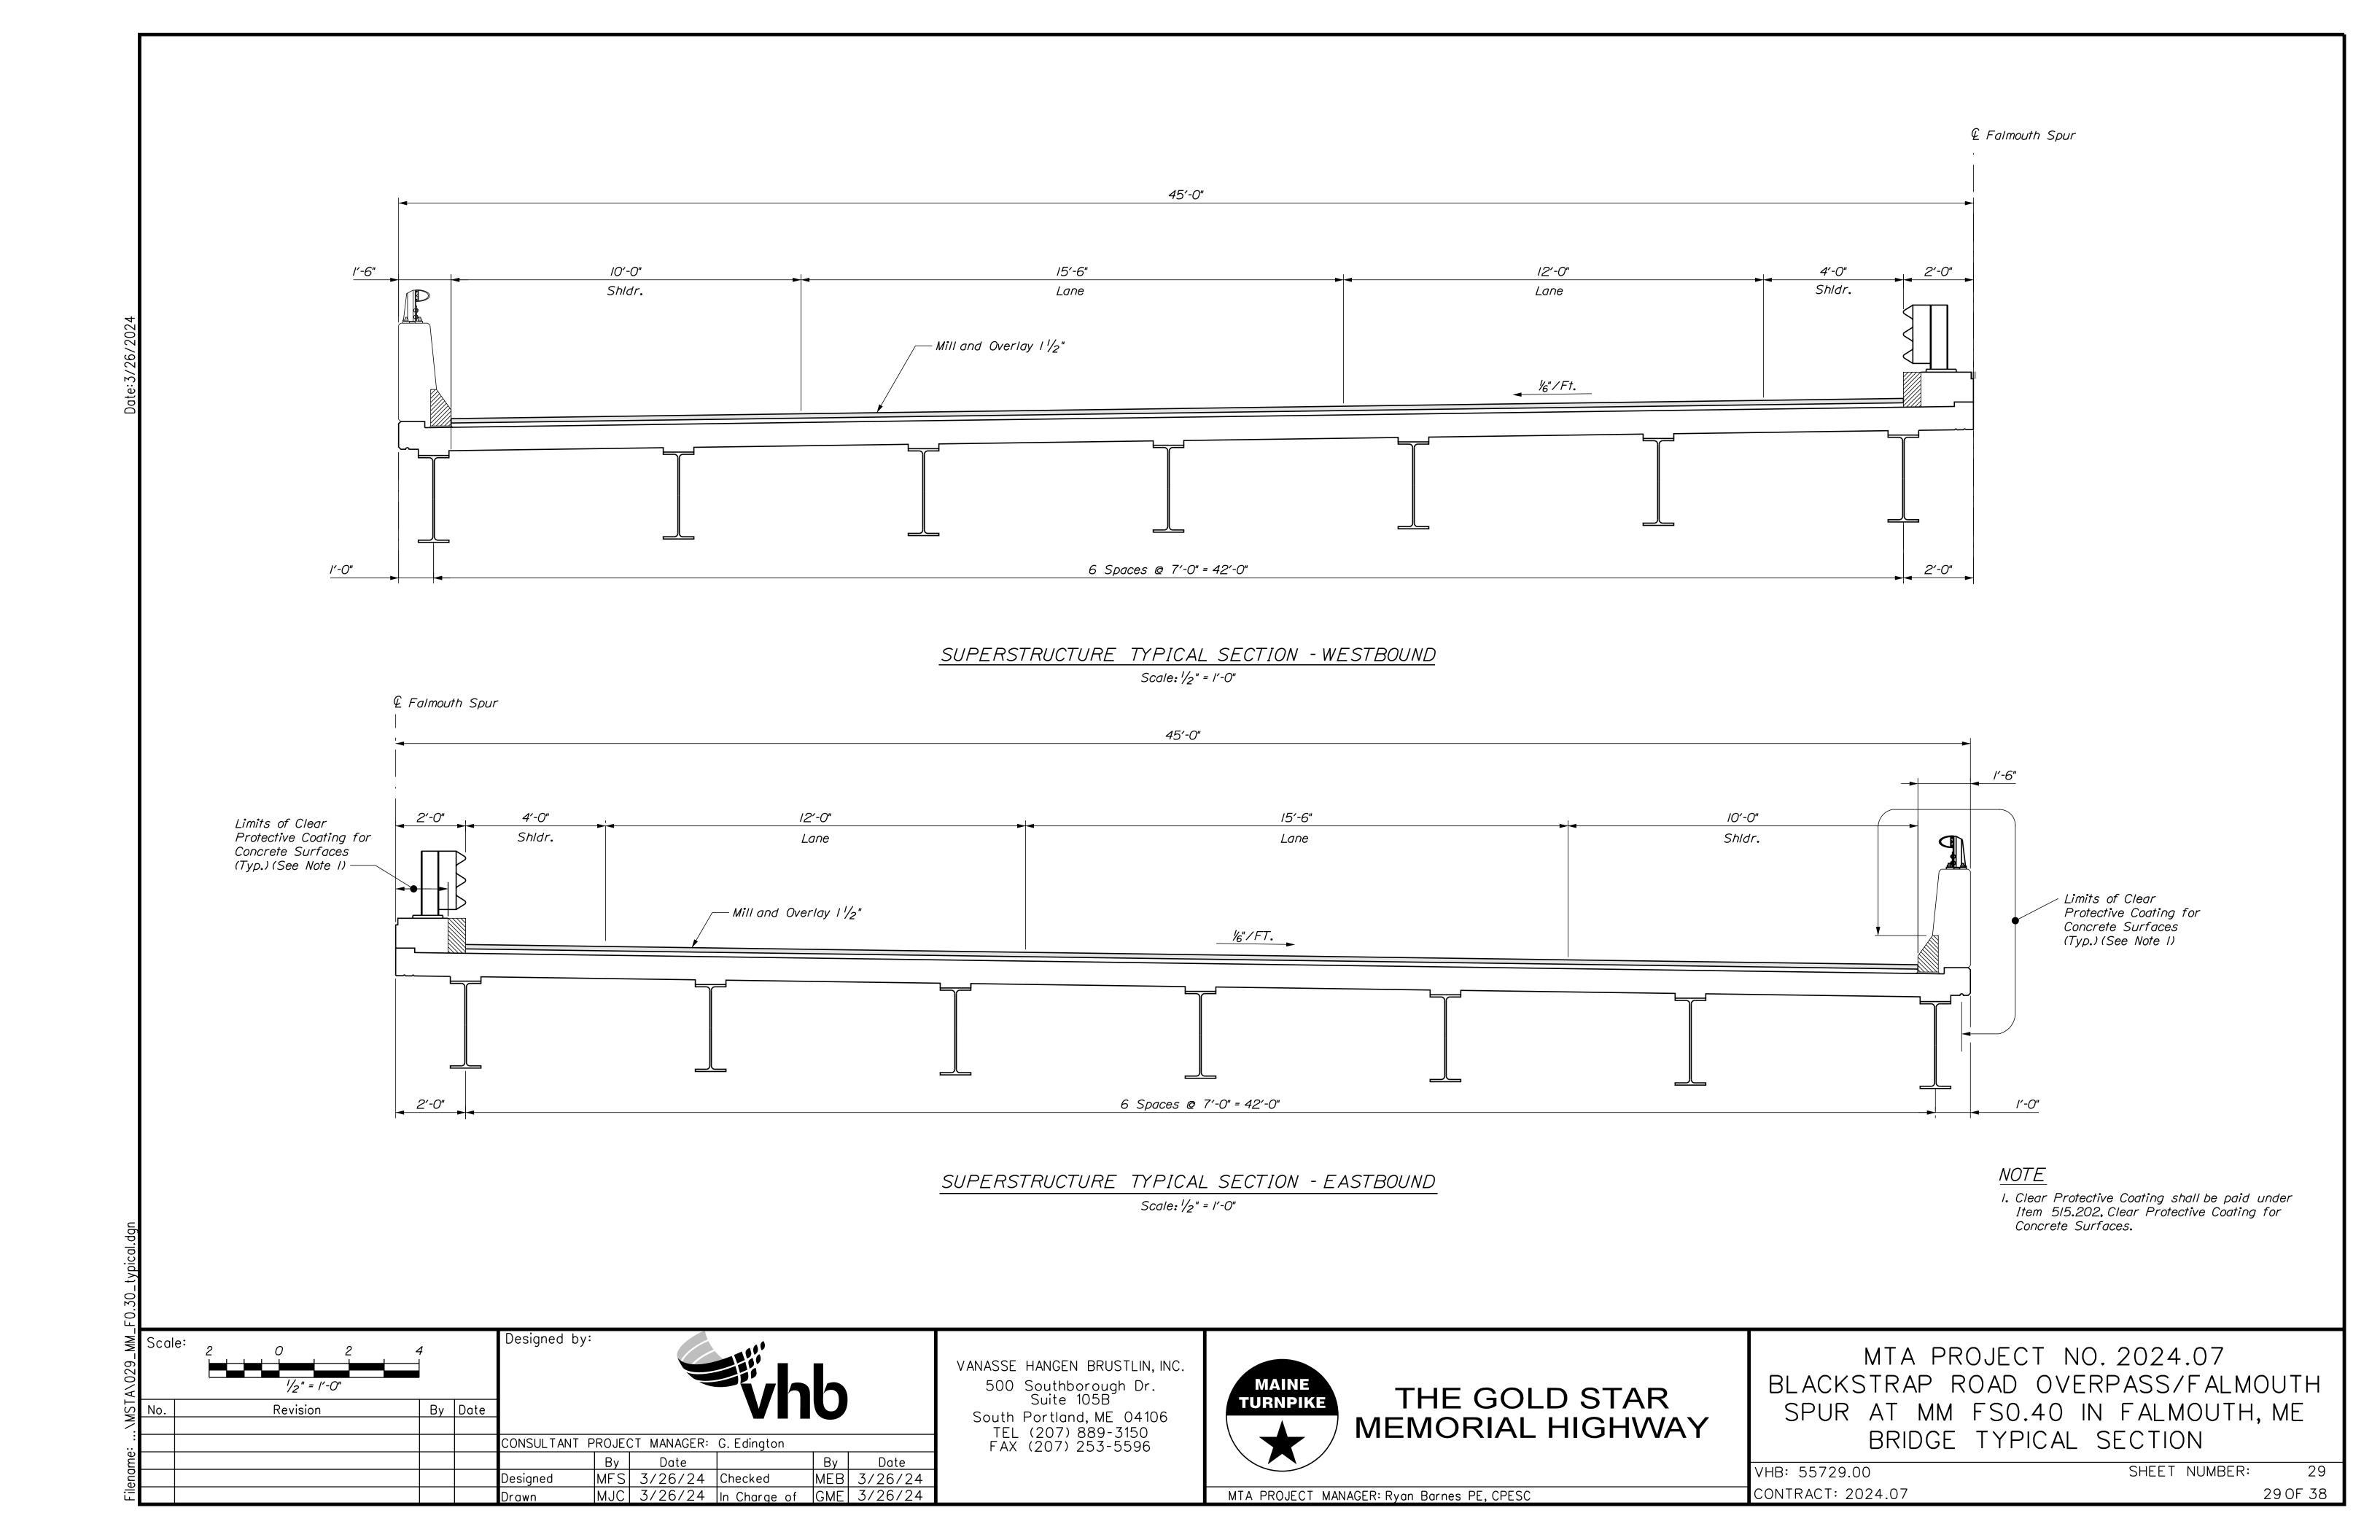
VANASSE HANGEN BRUSTLIN, INC.
500 Southborough Dr.
Suite 105B
South Portland, ME 04106
TEL (207) 889-3150
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THE GOLD STAR MEMORIAL HIGHWAY


MTA PROJECT MANAGER: Ryan Barnes PE, CPESC

MTA PROJECT NO. 2024.07
BLACKSTRAP ROAD OVERPASS/FALMOUTH
SPUR AT MM FSO.40 IN FALMOUTH, ME
BRIDGE PLAN AND ELEVATION

VHB: 55729.00 SHEET NUMBER: 28 CONTRACT: 2024.07 28 OF 38




EXISTING EXPANSION JOINT SECTION

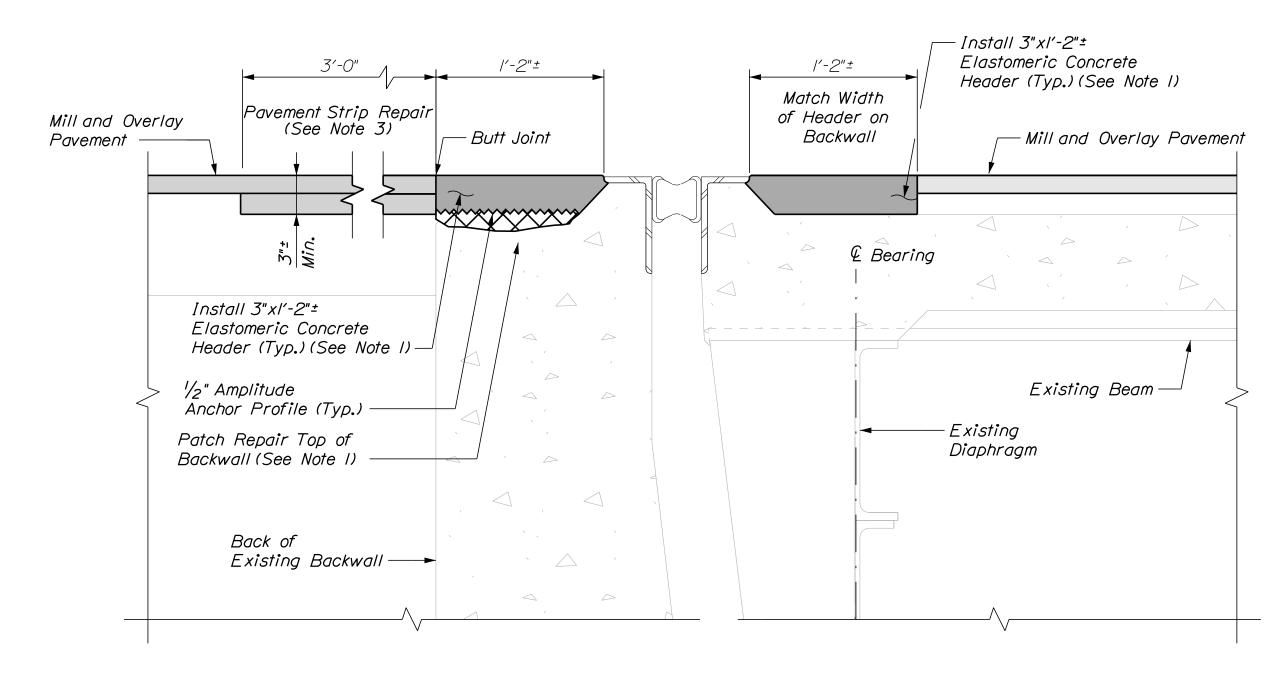

PROPOSED EXPANSION JOINT SECTION

BRIDGE JOINT MODIFICATION (Abutment No. 2) Not to Scale

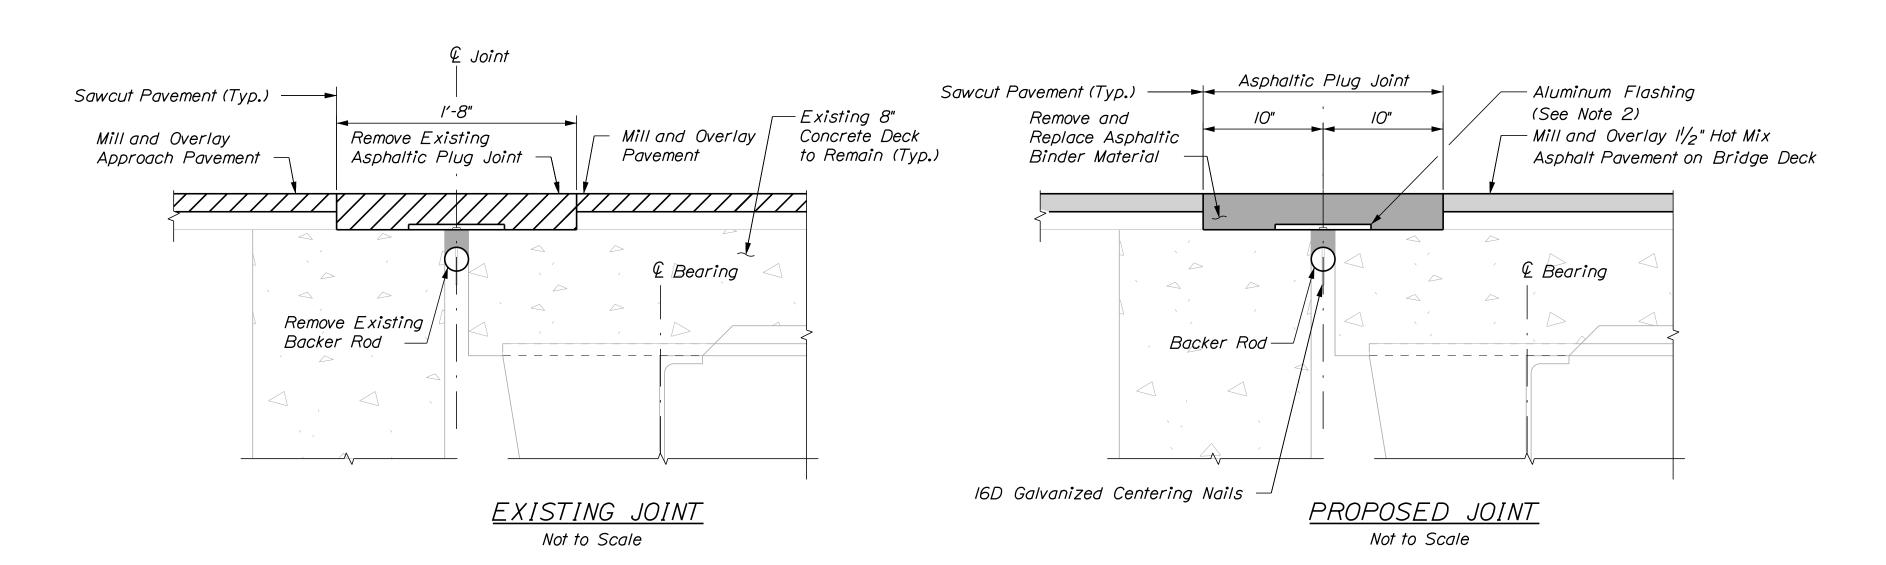

BRIDGE JOINT MODIFICATION (ABUTMENT NO. 1) Not to Scale

#### NOTES

- I. Elastomeric Concrete Header shall be paid under Item 518.864 Elastomeric Concrete Header Repair. Prior to placing the elastomeric concrete, the Contractor shall remove any areas of deteriorated concrete in accordance with Supplemental Specification Section 518 and as directed by the Resident. If repairs to the top of the backwall are needed, the Contractor shall repair with elastomeric concrete and repairs shall be paid under Item 518.864 Elastomeric Concrete Header Repair. If repair depth is greater than 3" below the header, the repairs may be done with AAA concrete at the direction of the Resident and paid under Item 518.80, Partial Depth Concrete Deck Repairs.
- 2. Aluminum Flashing shall be incidental to Item 520.23 Asphaltic
- 3. Pavement Strip Repair shall be paid under Item 403.208 Hot Mix Asphalt 12.5mm Nominal Maximum Size.
- 4. The Contractor shall repair the silicone sealant at the curbs and parapets at Abutment No. I after replacement of the asphaltic plug joint as directed by The Resident. The silicone sealant shall be a product from the MaineDOT Qualified Products List for Silicone and Polyurethane Joint Sealant. Repairs to the sealant shall be incidental to Item 520.23, Asphaltic Plug Joint.

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				Drawn	TSR	3/26/24	In Charge of	GME	3/26/24

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MAINE **TURNPIKE** TEL (207) 889-3150 FAX (207) 253-5596





MTA PROJECT NO. 2024.07 BLACKSTRAP ROAD OVERPASS/FALMOUTH SPUR AT MM FS0.40 IN FALMOUTH, ME BRIDGE JOINT MODIFICATIONS


VHB: 55729.00 SHEET NUMBER: CONTRACT: 2024.07

MTA PROJECT MANAGER: Ryan Barnes PE, CPESC


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Not to Scale

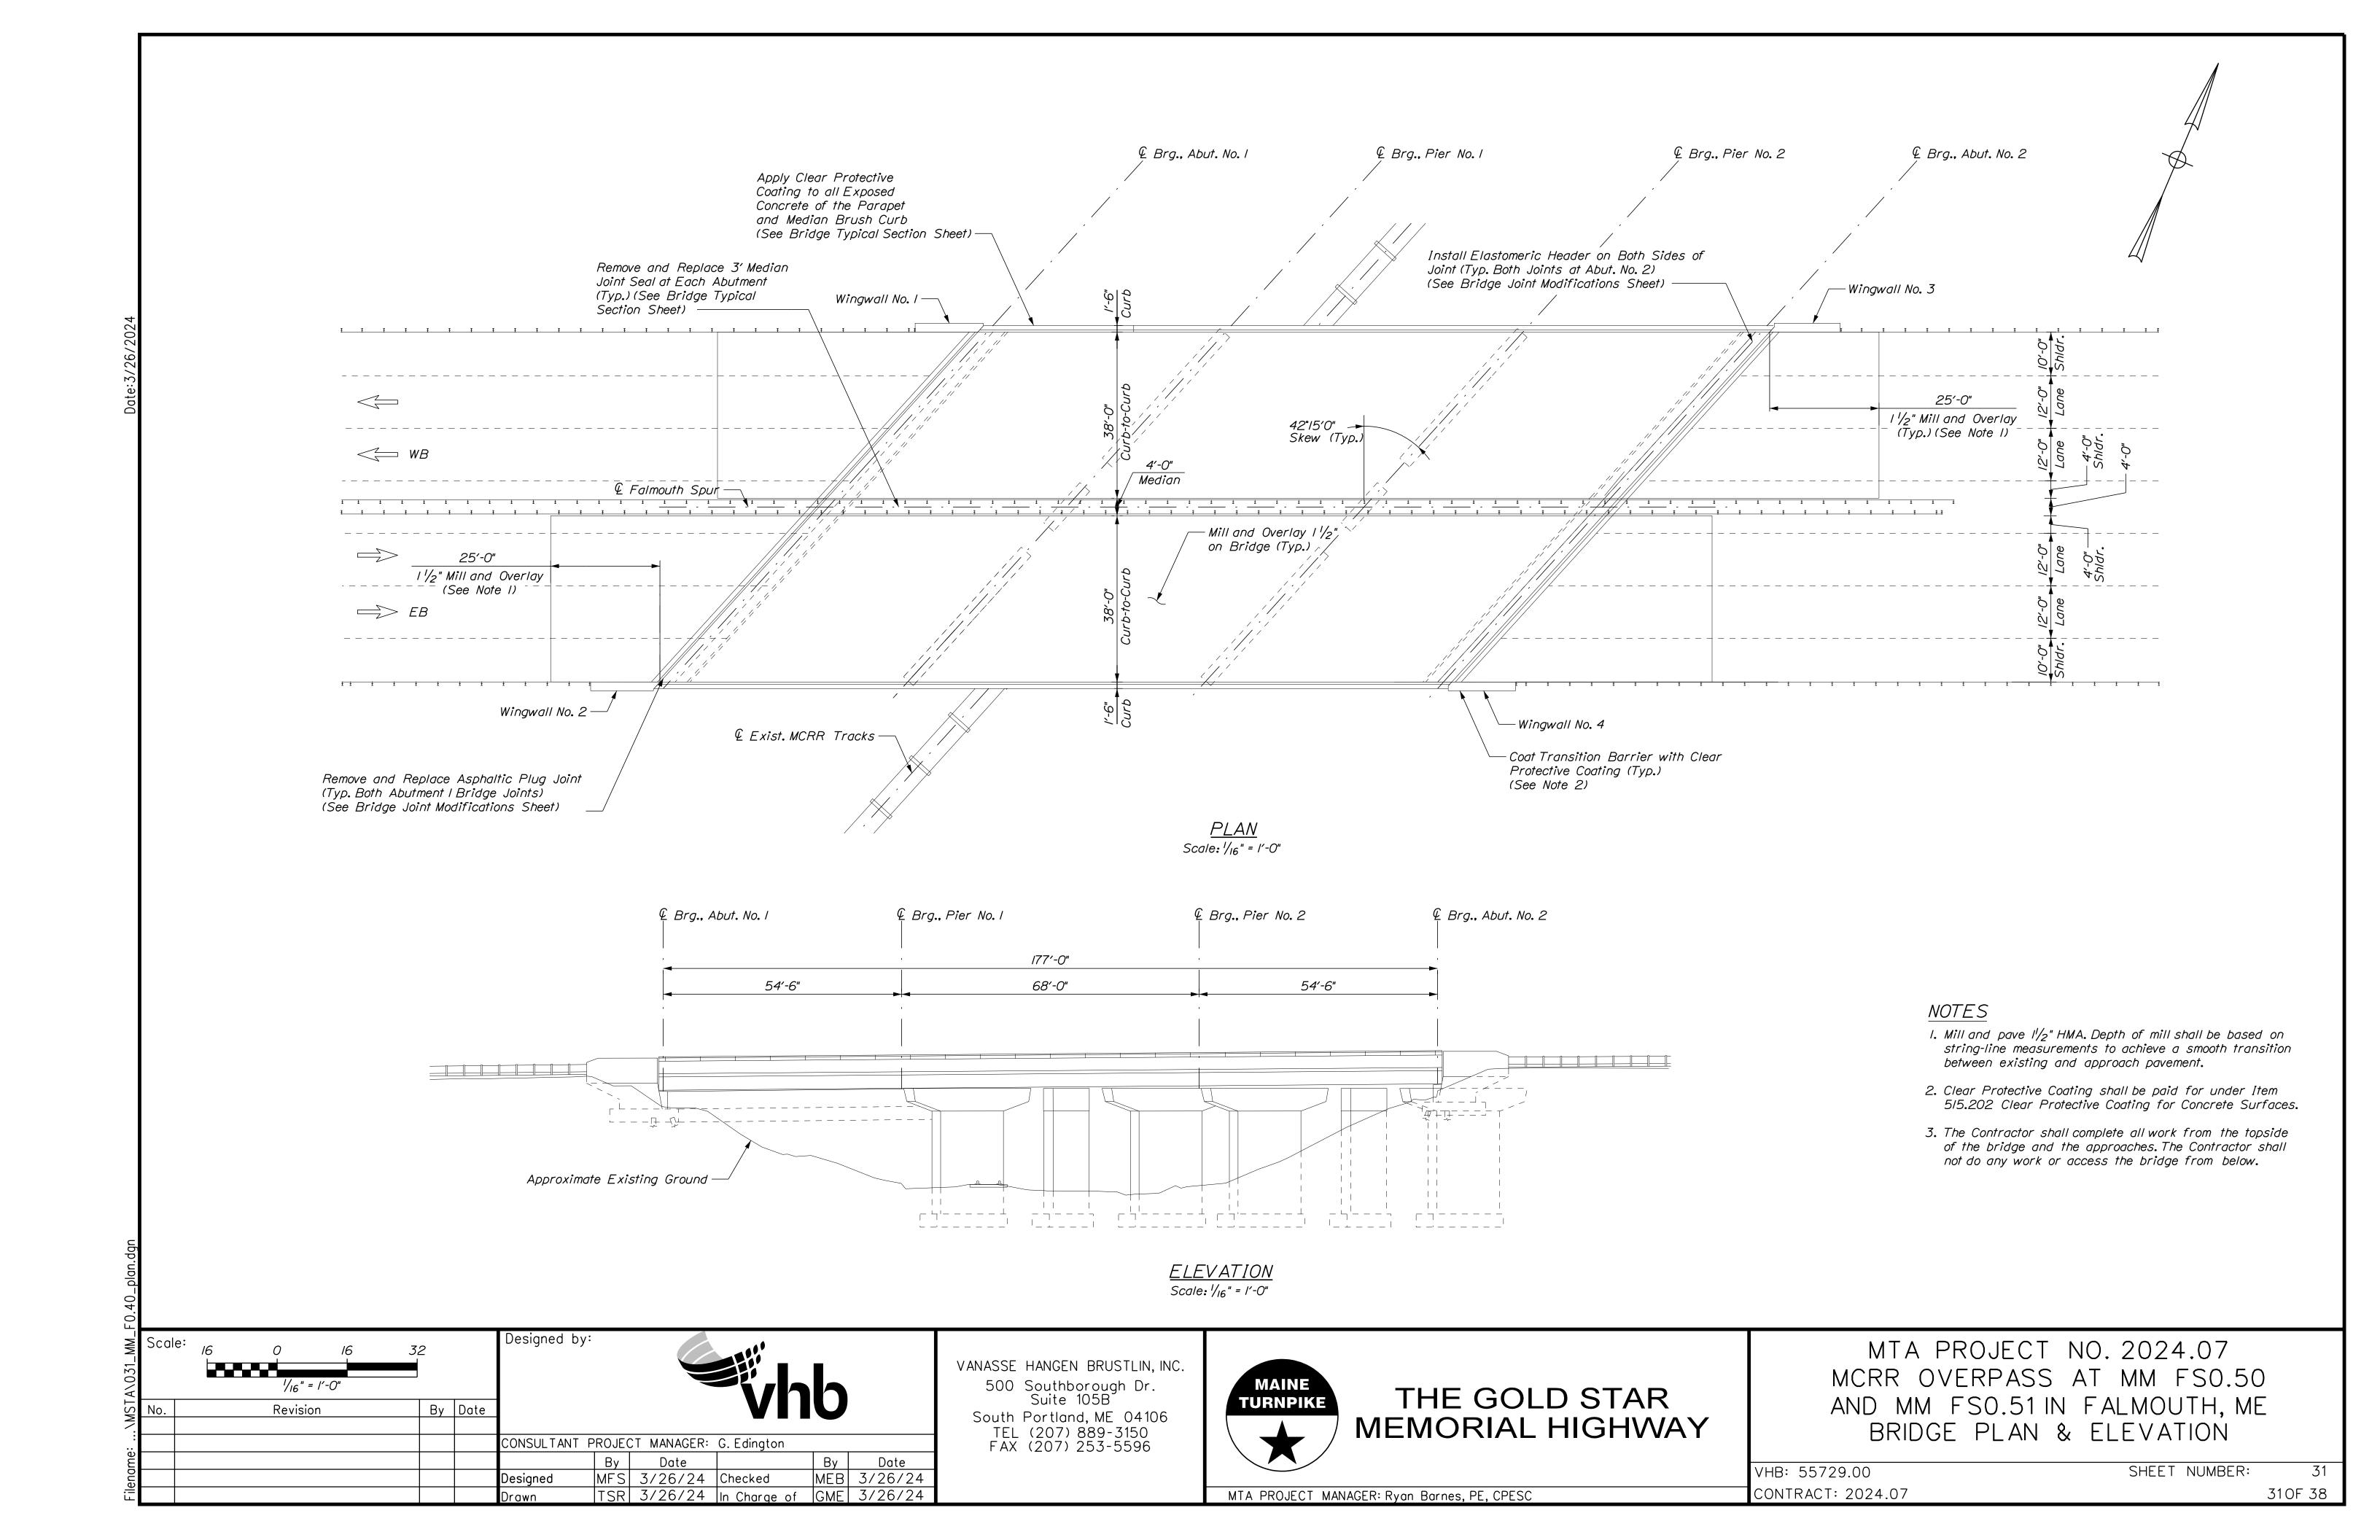


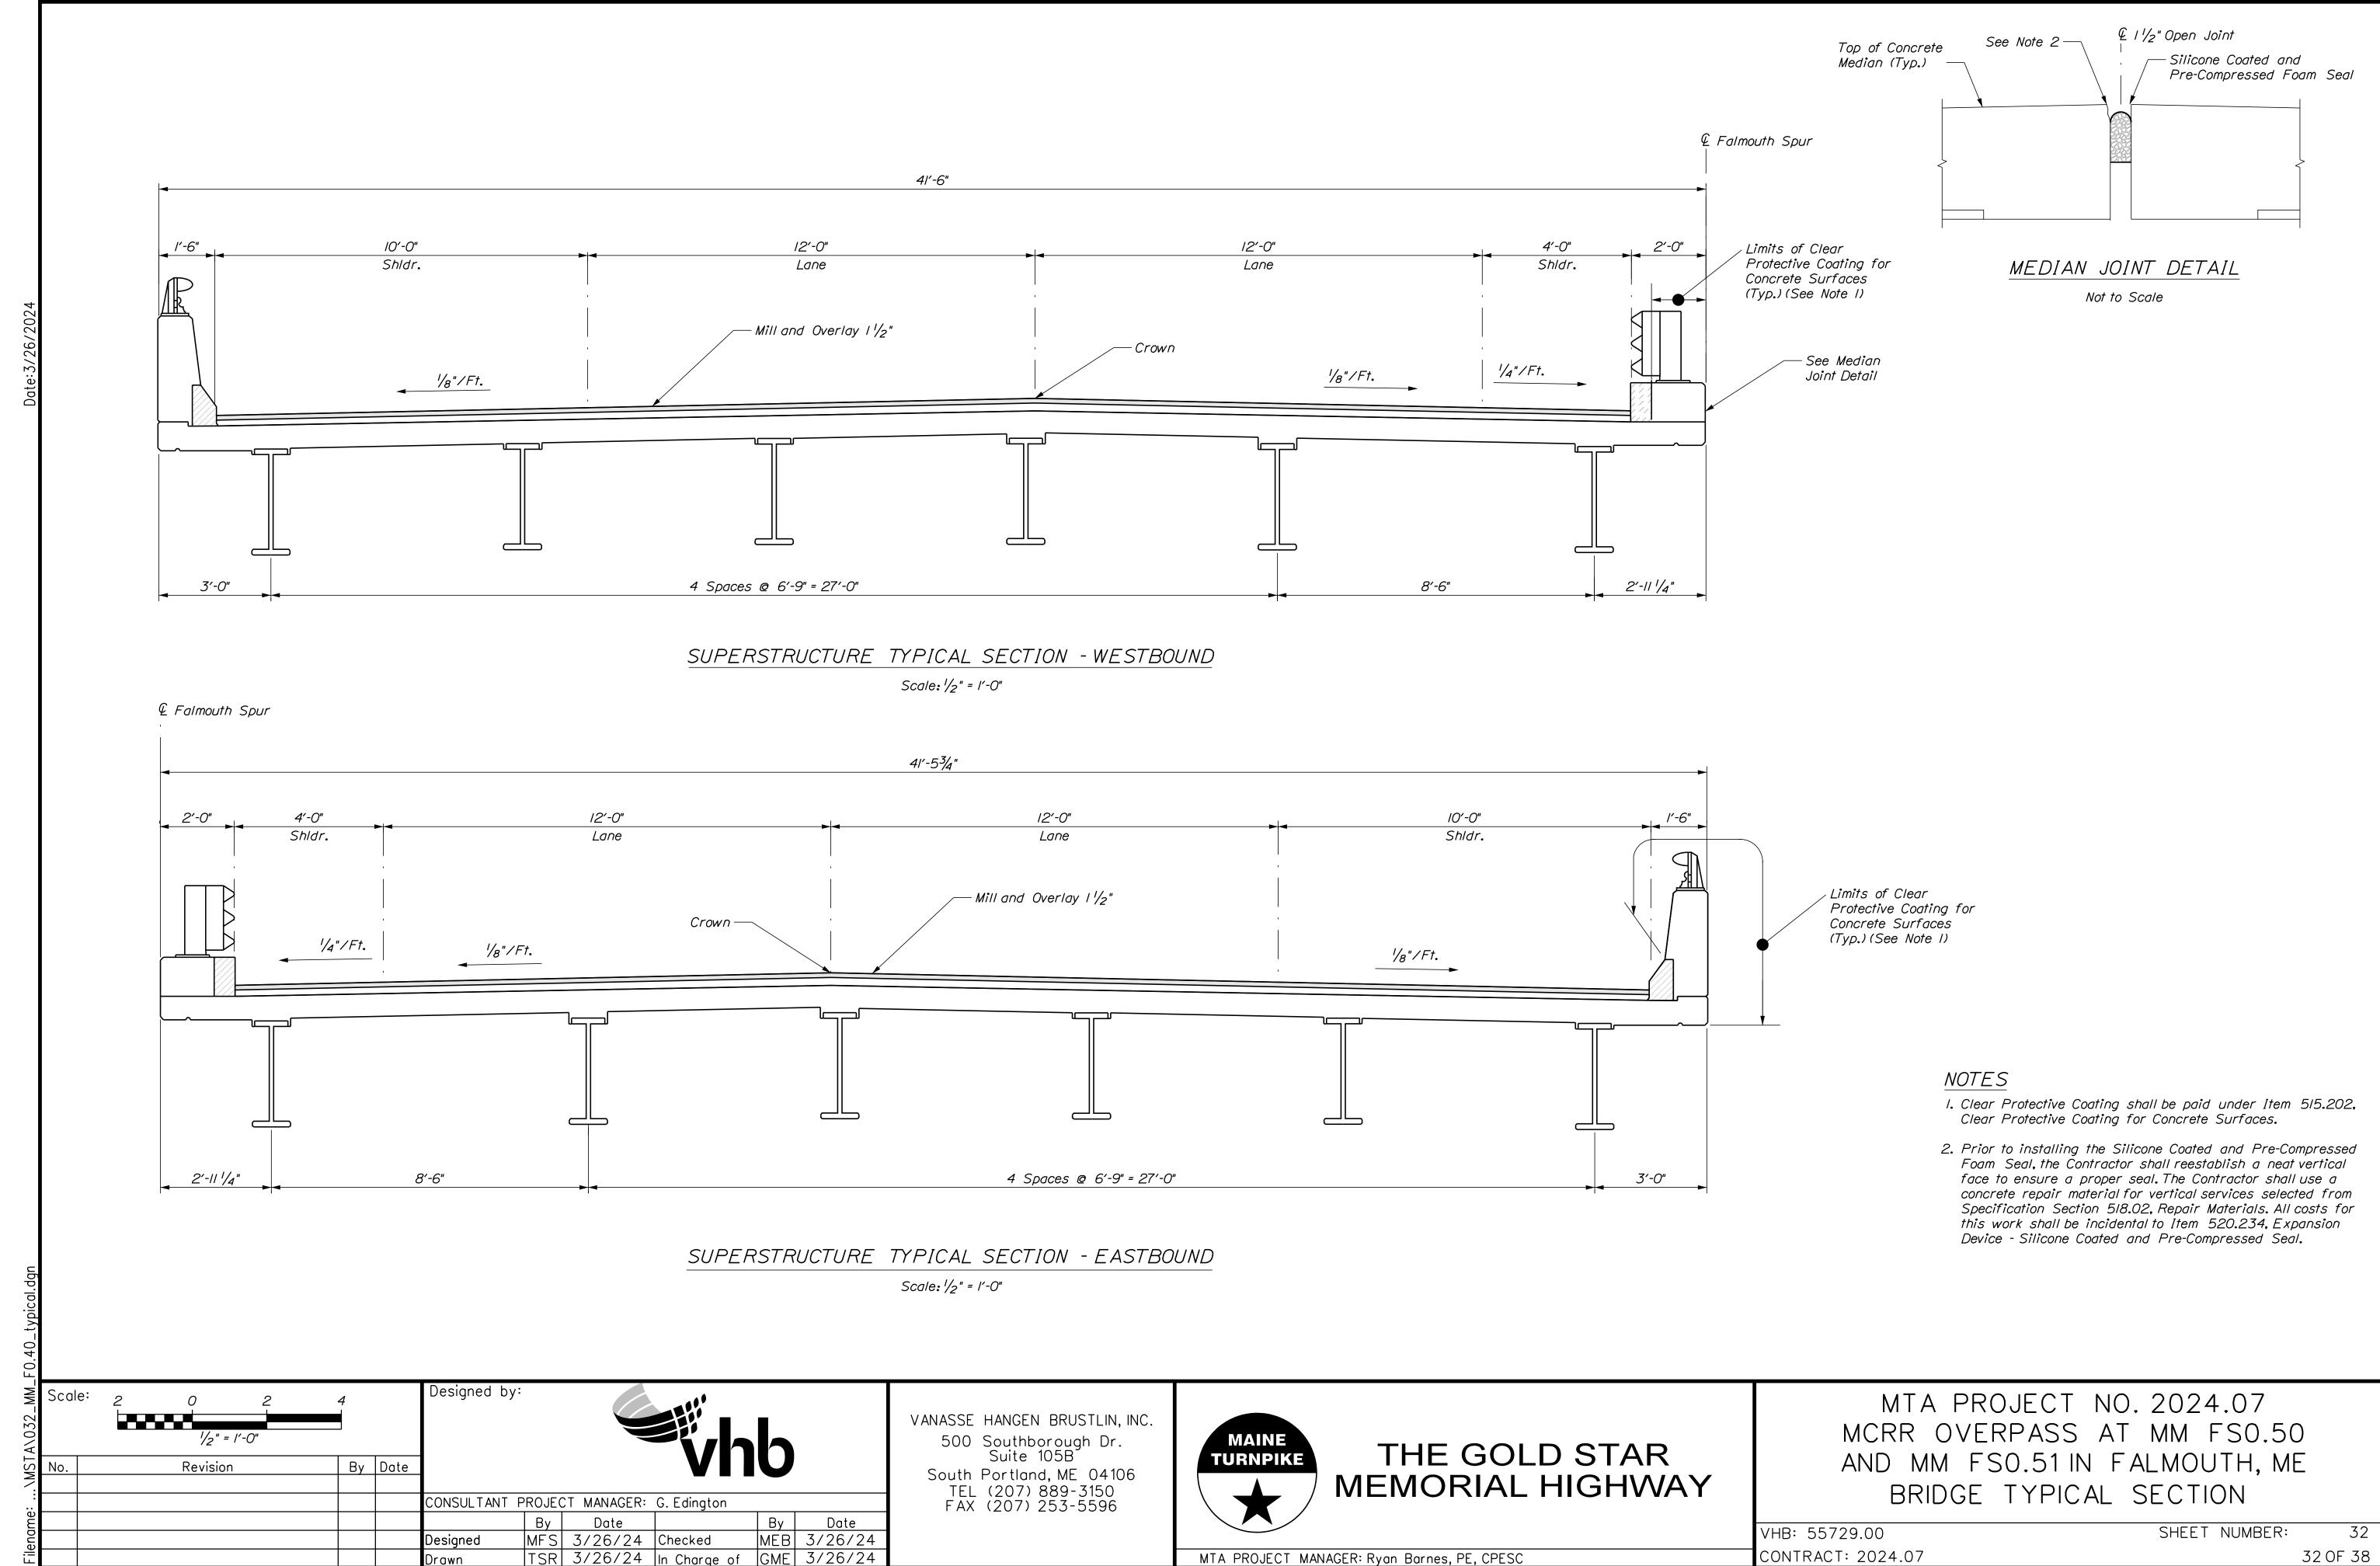PROPOSED EXPANSION JOINT SECTION

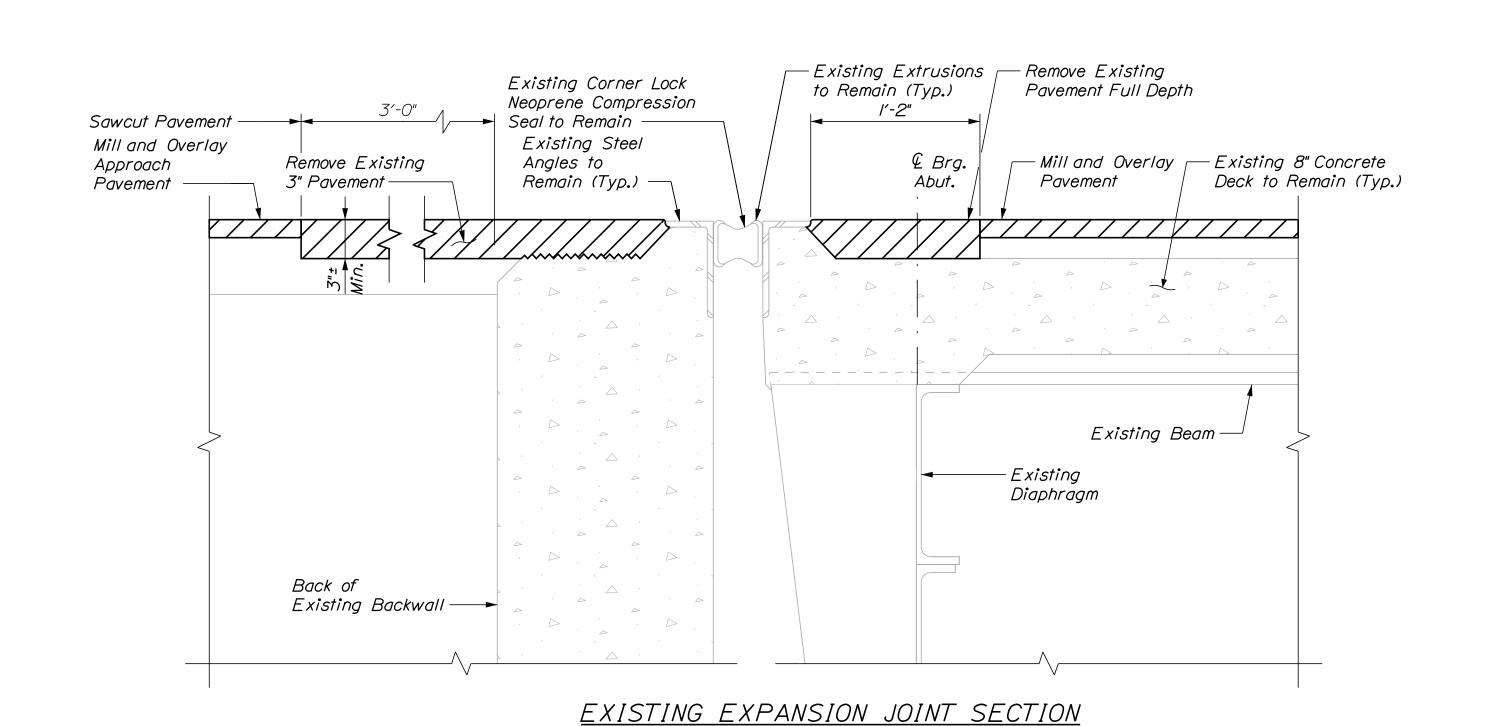Not to Scale

BRIDGE JOINT MODIFICATION
(ABUTMENT NO. 2)

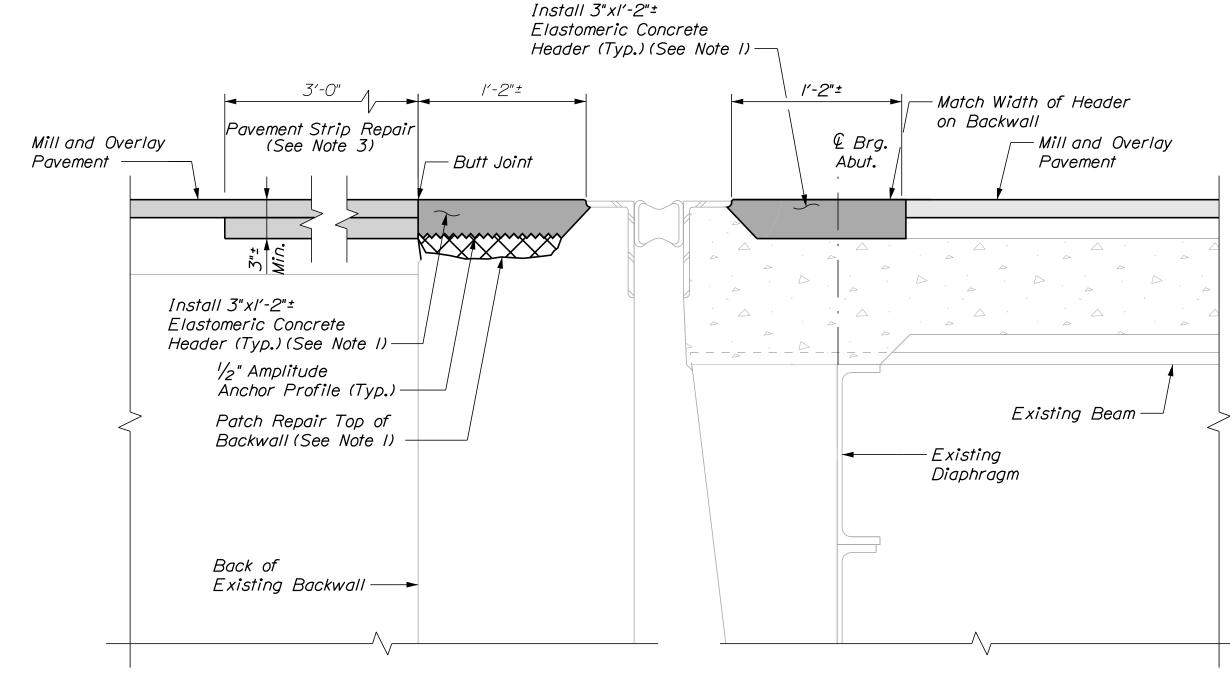Not to Scale

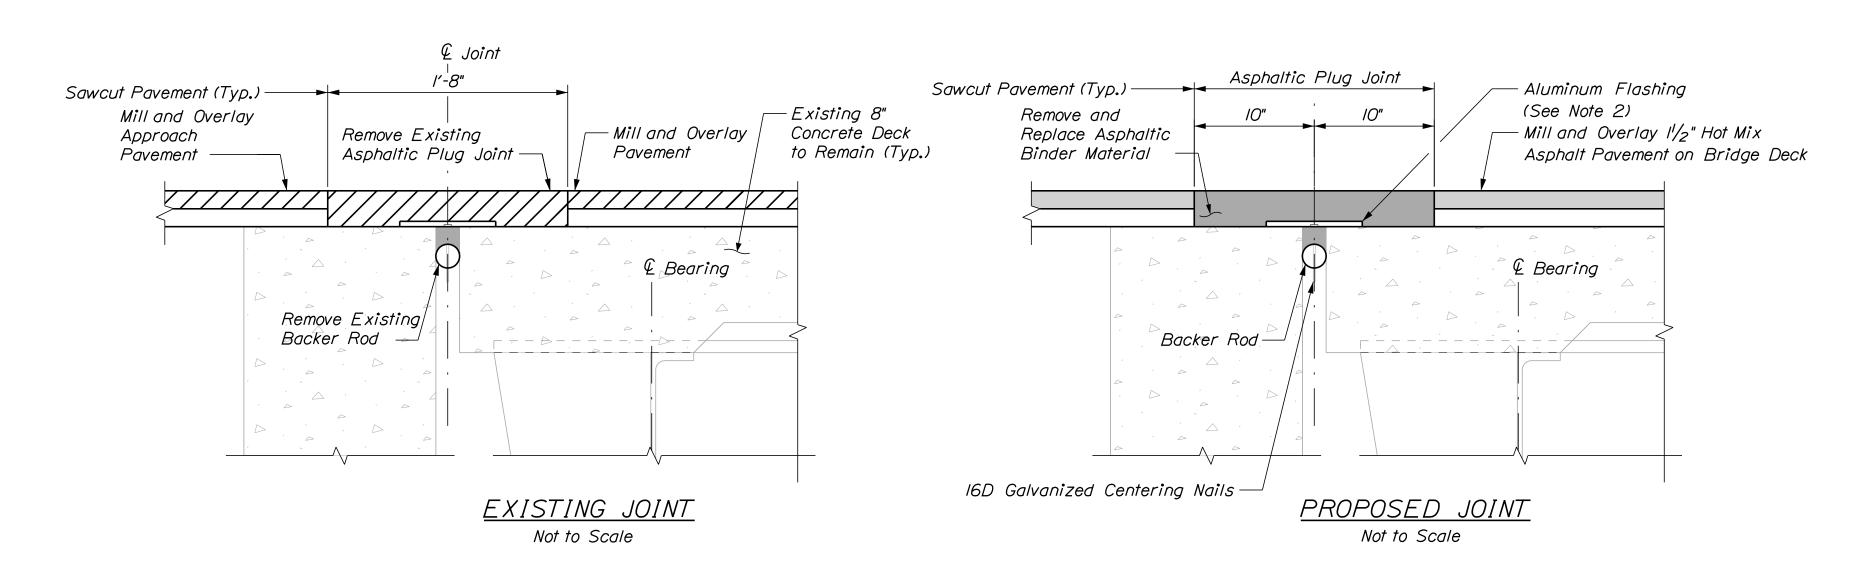

# BRIDGE JOINT MODIFICATION (ABUTMENT NO. I) Not to Scale

#### NOTES

- I. Elastomeric Concrete Header shall be paid under Item 518.864
  Elastomeric Concrete Header Repair. Prior to placing the
  elastomeric concrete, the Contractor shall remove any areas of
  deteriorated concrete in accordance with Supplemental
  Specification Section 518 and as directed by the Resident. If
  repairs to the top of the backwall are needed, the Contractor shall
  repair with elastomeric concrete and repairs shall be paid under
  Item 518.864 Elastomeric Concrete Header Repair. If repair depth
  is greater than 3" below the header, the repairs may be done with
  AAA concrete at the direction of the Resident and paid under Item
  518.80, Partial Depth Concrete Deck Repair.
- 2. Aluminum Flashing shall be incidental to Item 520.23 Asphaltic Plug Joint.
- 3. Pavement Strip Repair shall be paid under Item 403.208 Hot Mix Asphalt 12.5mm Nominal Maximum Size.
- 4. The Contractor shall repair the silicone sealant at the curbs and parapets at Abutment No. I after replacement of the asphaltic plug joint as directed by the Resident. The silicone sealant shall be a product from the MaineDOT Qualified Products List for Silicone and Polyurethane Joint Sealant. Repairs to the sealant shall be incidental to Item 520.23, Asphaltic Plug Joint.

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				Drawn	TSR	3/26/24	In Charge of	GME	3/26/24

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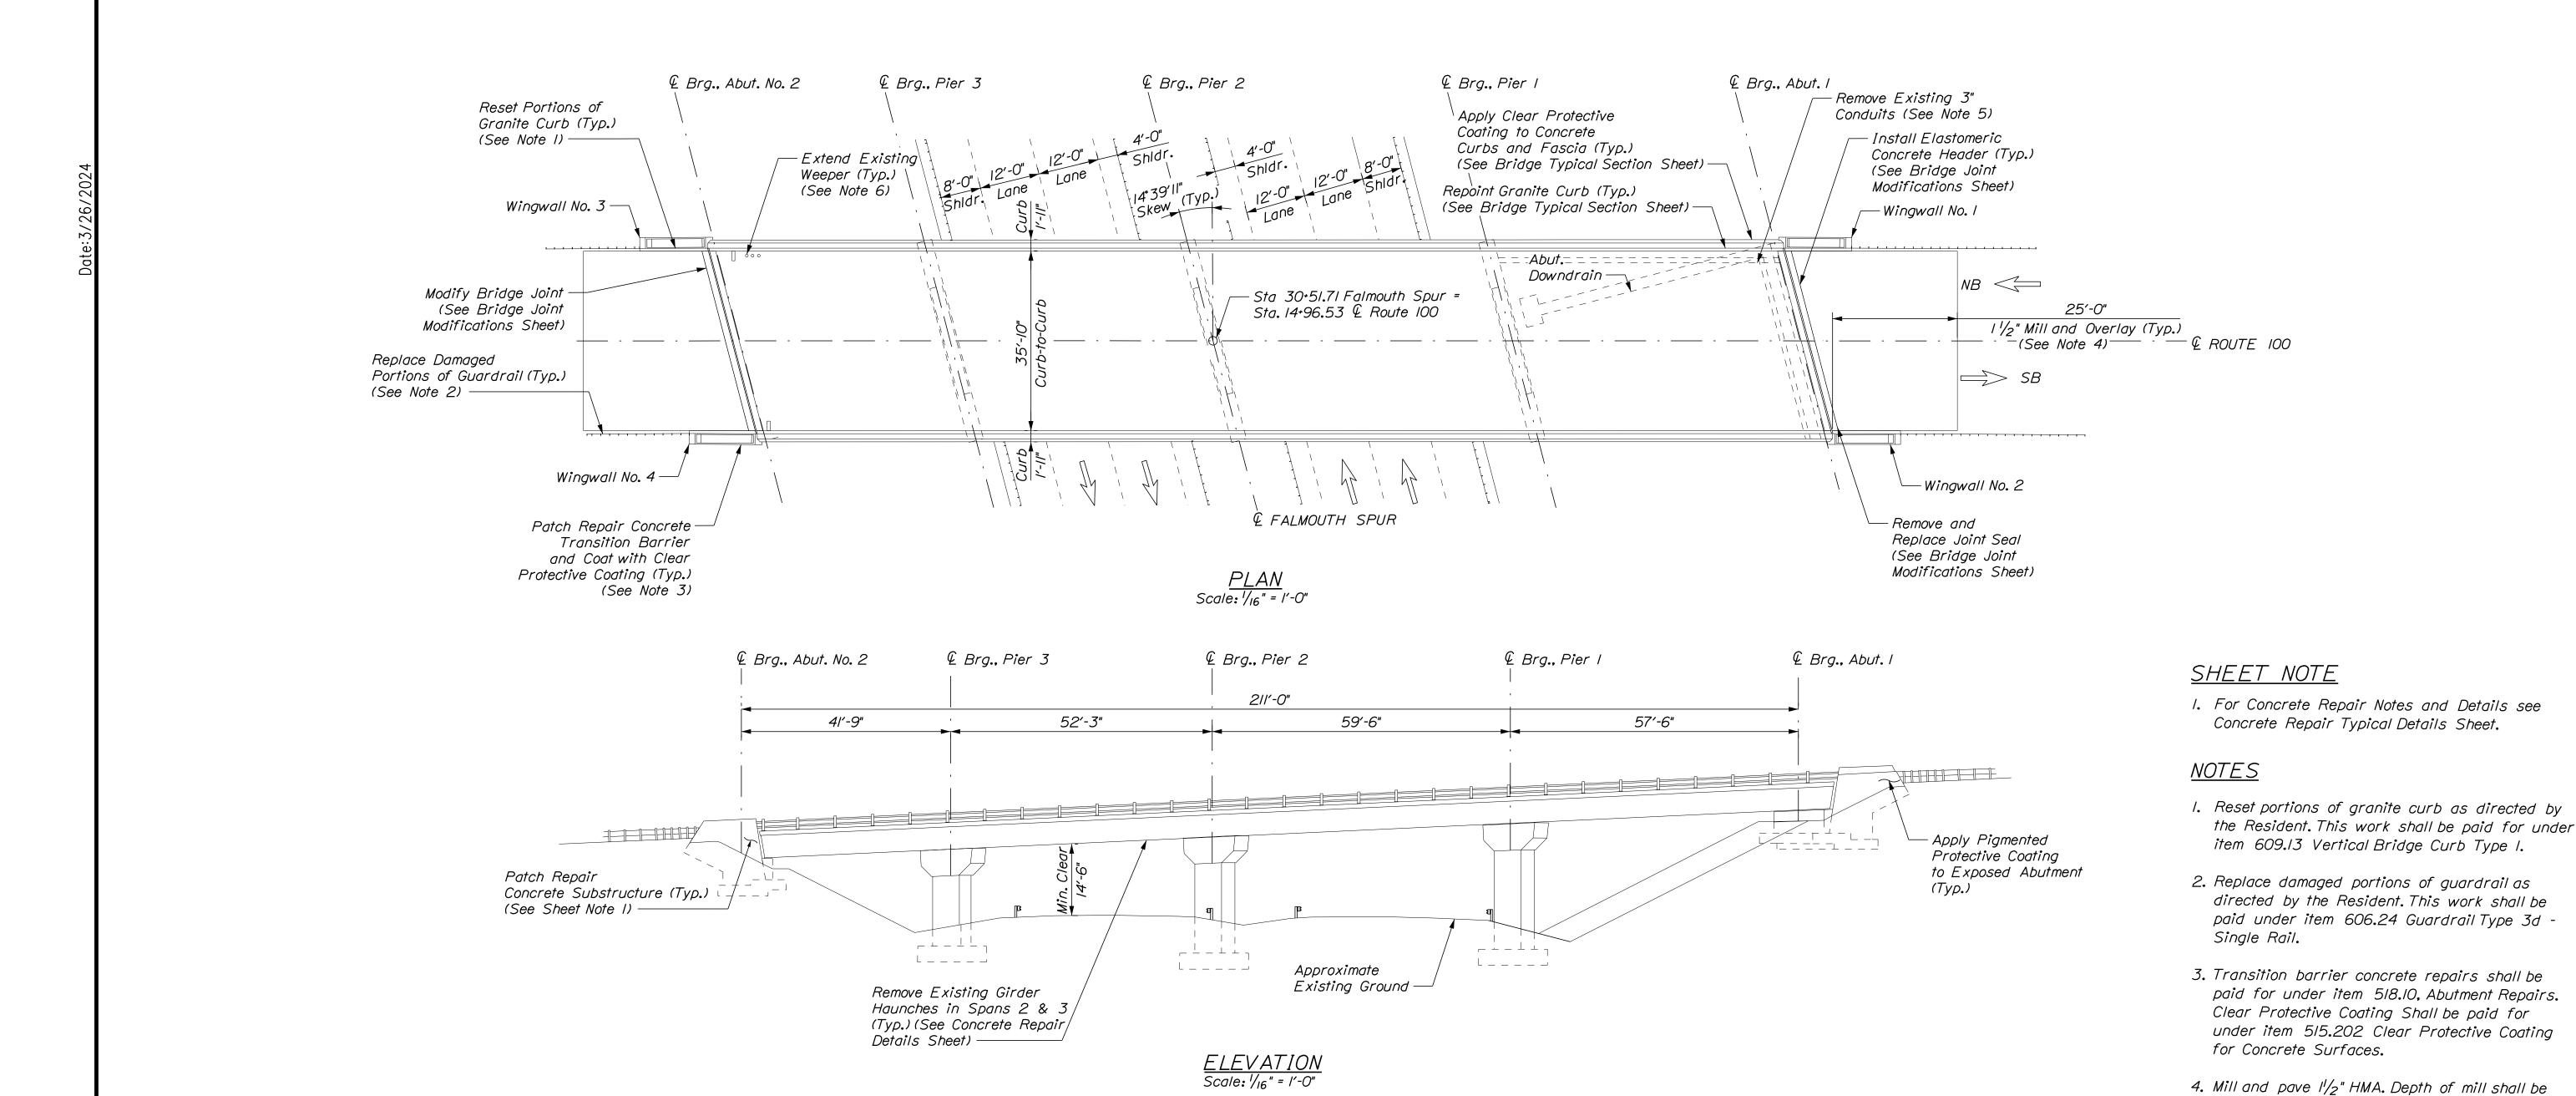
THE GOLD STAR MEMORIAL HIGHWAY MTA PROJECT NO. 2024.07
MCRR OVERPASS AT MM FS0.50
AND MM FS0.51 IN FALMOUTH, ME
BRIDGE JOINT MODIFICATIONS

VHB: 55729.00 SHEET NUMBER:

MTA PROJECT MANAGER: Ryan Barnes, PE, CPESC CONTRACT: 2024.07

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MTA PROJECT NO. 2024.07 GRAY ROAD (ROUTE 26 & 100) UNDERPASS AT MM FS0.70 IN FALMOUTH BRIDGE PLAN & ELEVATION

approach pavement.

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Conduit. 6. Extending existing weepers shall be paid for under item 502.7011 Weep Drain Extensions. See Miscellaneous Repair Details Sheet.

5. Removal of the existing 3" conduit shall be paid for under Item 202.912, Remove Existing


based on string-line measurements to achieve a

smooth transition between existing and

South Portland, ME 04106

MTA PROJECT MANAGER: Ryan Barnes, PE, CPESC

### SUPERSTRUCTURE TYPICAL SECTION Scale: 1/2" = 1'-0"

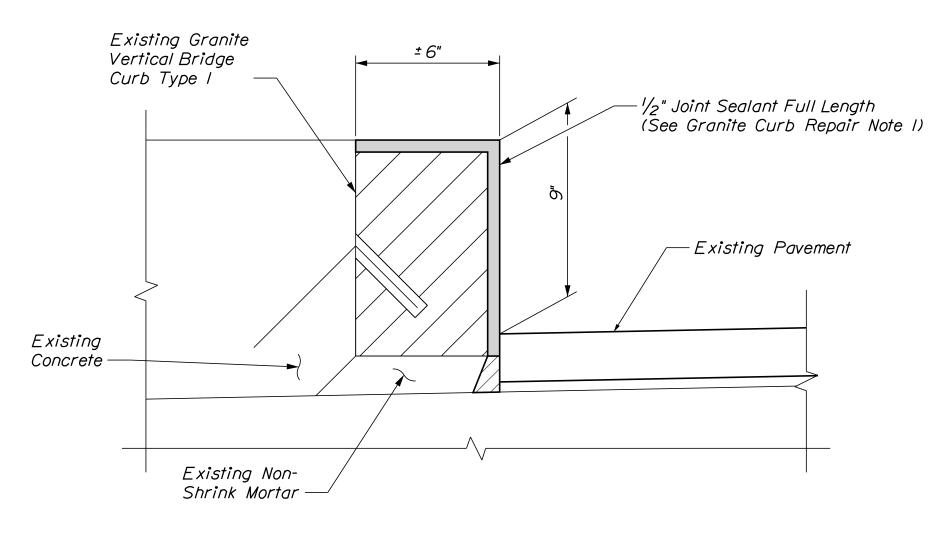

## EXISTING GRANITE CURB DETAIL Scale: 3" = 1'-0"

#### GRANITE CURB REPAIR NOTES

I. Joint sealant shall be a material from the MaineDOT approved products list as approved by the Resident. Joint sealant shall be incidental to item 518.391, Repairing Granite Curb Joint and Bedding Mortar.

#### <u>NOTES</u>

I. Clear Protective Coating shall be paid for under Item 515.202, Clear Protective Coating for Concrete Surfaces.

Scale	3" = 1'-0" /	/			Designed by:				
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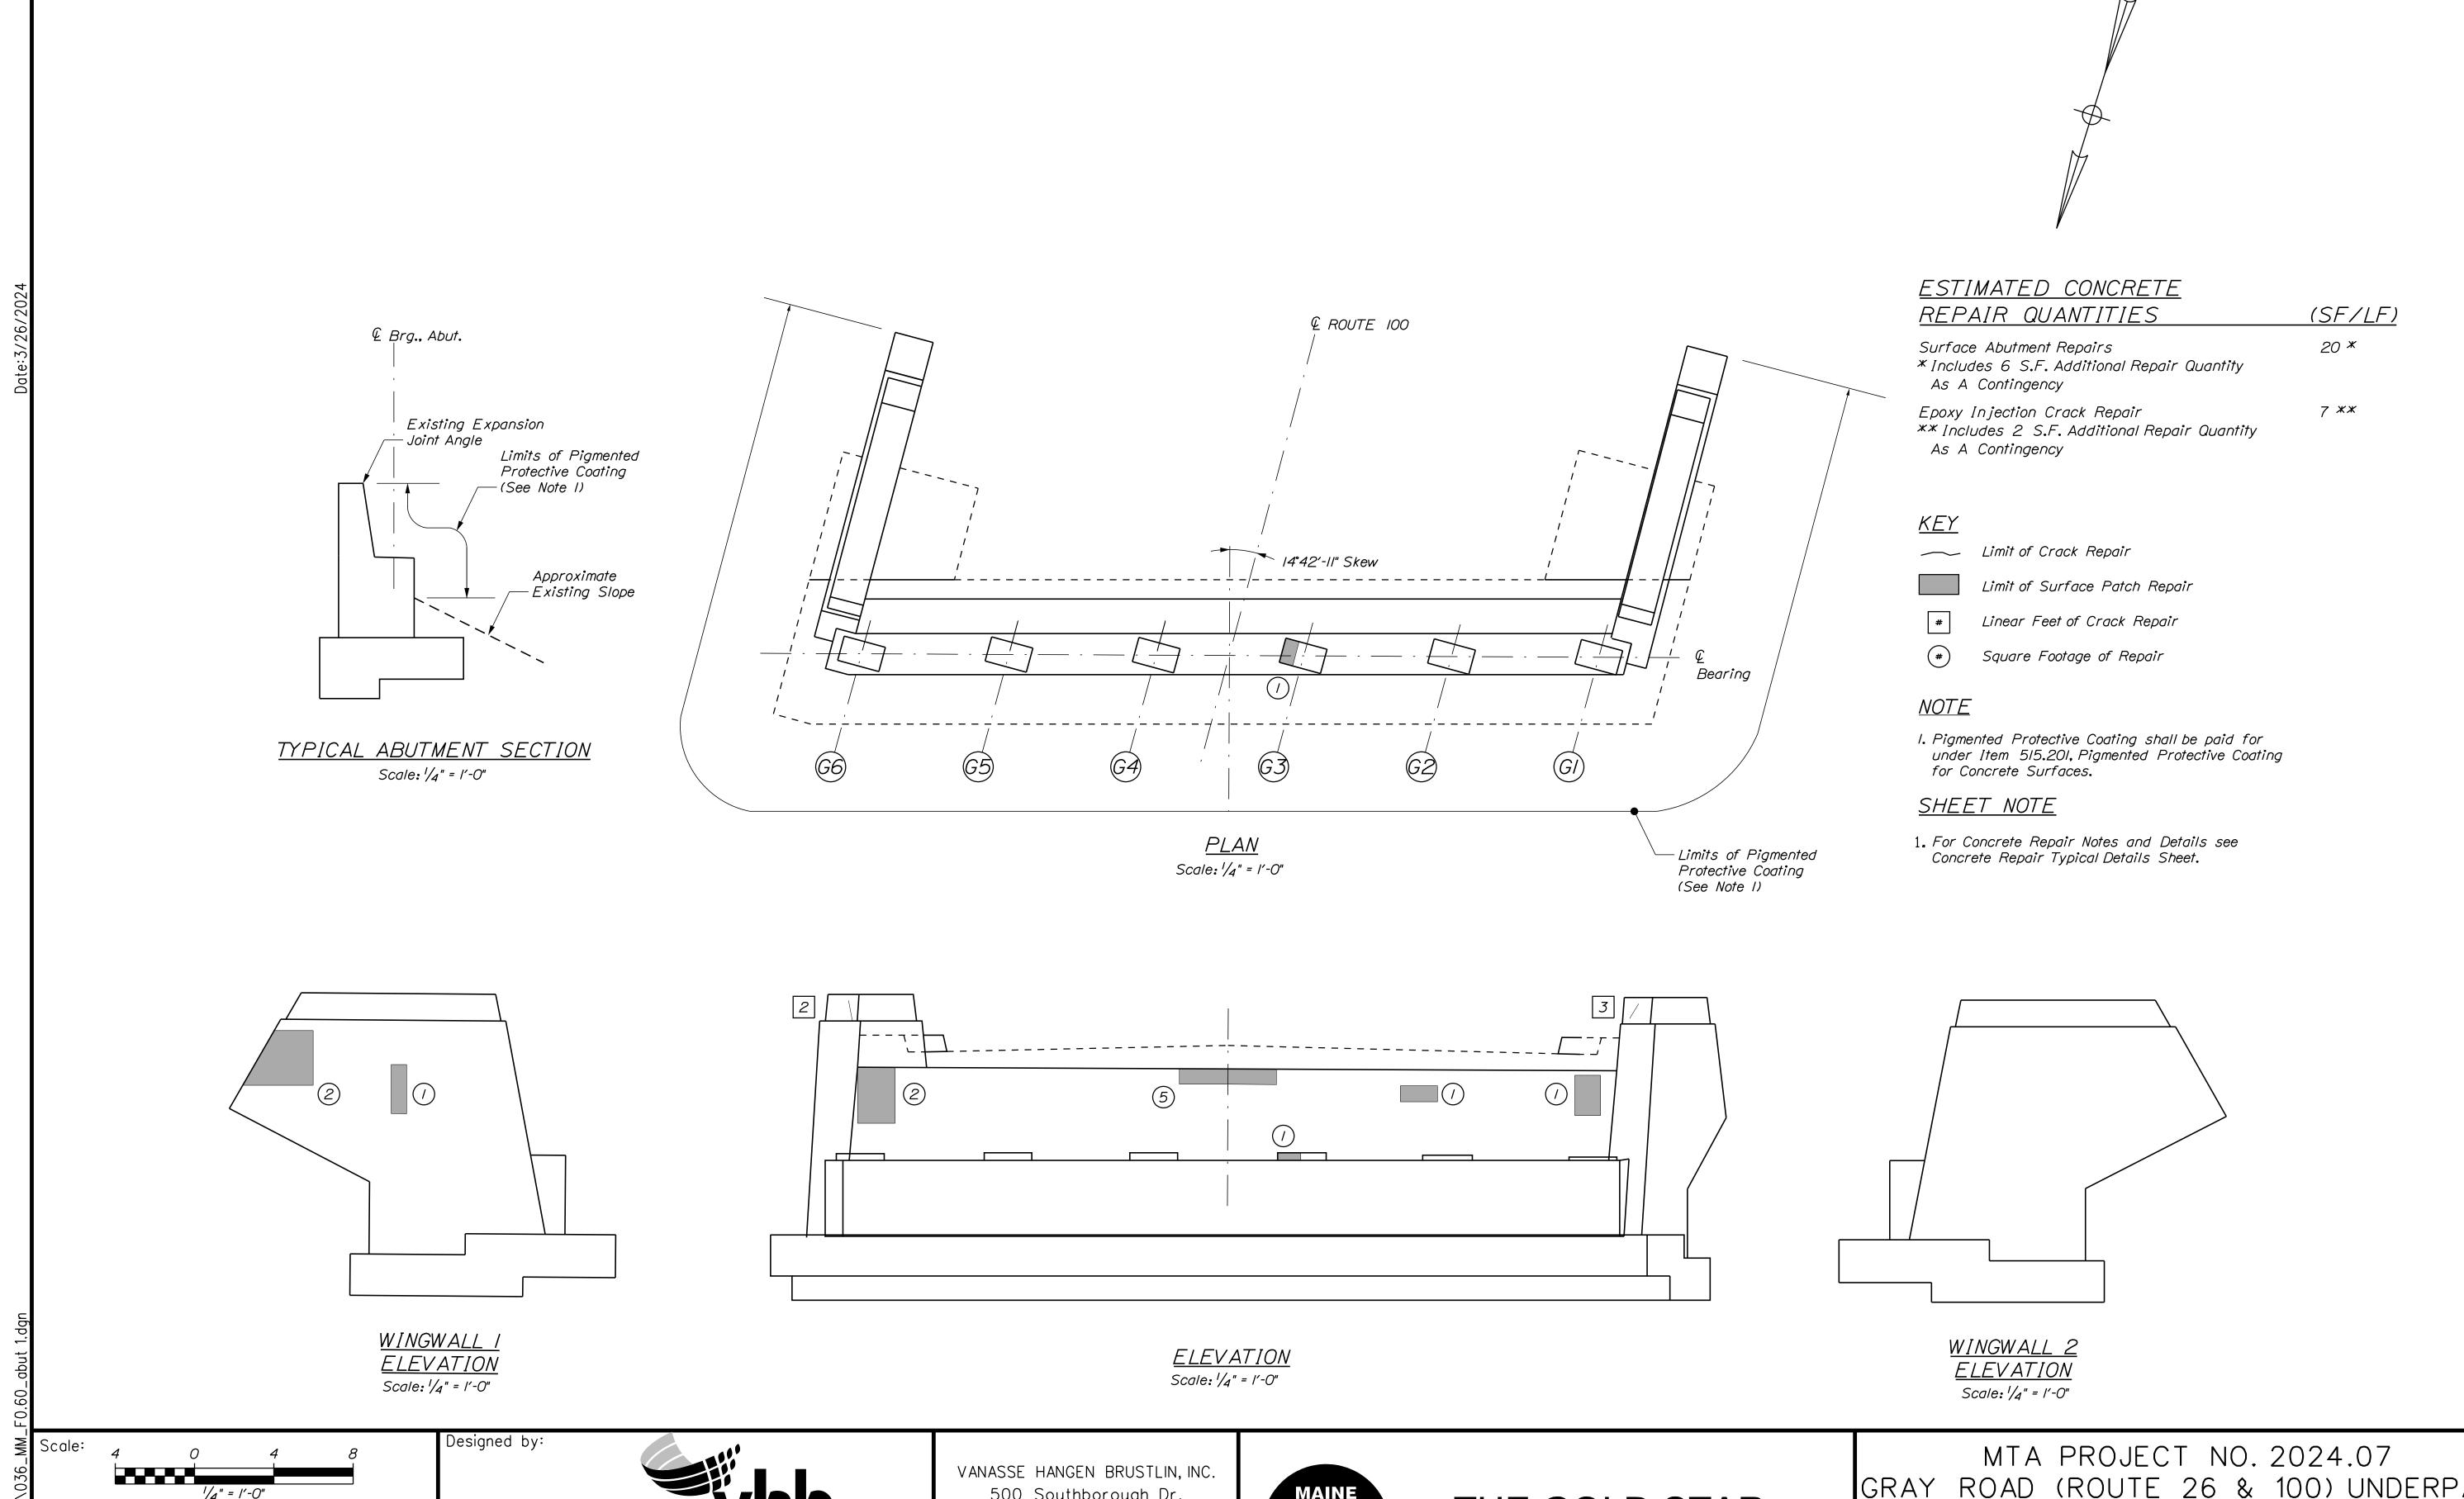
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500 Southborough Dr.
Suite 105B
South Portland, ME 04106
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FAX (207) 253-5596

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MTA PROJECT MANAGER: Ryan Barnes, PE, CPESC

THE GOLD STAR MEMORIAL HIGHWAY MTA PROJECT NO. 2024.07
GRAY ROAD (ROUTE 26 & 100) UNDERPASS
AT MM FS0.70 IN FALMOUTH
BRIDGE TYPICAL SECTION

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CONTRACT: 2024.07 35 OF 38



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FAX (207) 253-5596

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MTA PROJECT MANAGER: Ryan Barnes, PE, CPESC

THE GOLD STAR
MEMORIAL HIGHWAY

GRAY ROAD (ROUTE 26 & 100) UNDERPASS
AT MM FS0.70 IN FALMOUTH
ABUTMENT NO. 1 REPAIRS

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