

CONTRACT 2018.10

BRIDGE REPAIRS.

FISHER FARM ROAD

UNDERPASS MILE 87.5

CONTRACT 2018.10

CURTIS BROOK

CULVERT REPAIRS

MILE 87.49

CONTRACT 2018.10 BRIDGE REPAIRS, DANVILLE CORNER ROAD UNDERPASS MILE 75.6 DANIEL E. WATHEN, CHAIR
ROBERT D. STONE, VICE CHAIR
MICHAEL J. CIANCHETTE, MEMBER
JOHN E. DORITY, MEMBER
ANN R. ROBINSON, MEMBER
THOMAS J. ZUKE, MEMBER
KAREN S. DOYLE, MEMBER EX-OFFICIO

S. PETER MILLS, EXECUTIVE DIRECTOR

CONTRACT 2018.10
BRIDGE AND CULVERT REPAIRS
4 LOCATIONS
DANVILLE CORNER ROAD
UNDERPASS (MILE 75.8)
CURTIS BROOK CULVERT (MILE 87.49)
FISHER FARM ROAD UNDERPASS (MILE 91.9)

WESTBROOK

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WESTBROOK

INT 45

WESTBROOK

INT 45

INT 4

LOCATION MAP

APPROVED: MAINE TURNPIKE AUTHORITY

PETER S. MERFELD, P.E.
CHIEF OPERATIONS OFFICER

CHIEF OPERATIONS OFFICER

STEPHEN R. TARTRE, P.E.

DIRECTOR OF ENGINEERING AND BUILDING MAINTENANCE

12/14/17 DATE

12/14/17 DATE

TY:LININTERNATIONAL

INDEX OF SHEETS

DESCRIPTION

DETOUR PLAN MILE 75.8 DANVILLE CORNER ROAD

DETOUR PLAN MILE 87.5 FISHER FARM ROAD DETOUR PLAN MILE 91.9 CENTER ROAD

SHEET NO.

TITLE SHEET

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TYPICAL DETAILS

TRAFFIC CONTROL DETAILS

LIMITS OF DISTURBANCE PLAN

TYPICAL DECK PLAN & SECTION

JOINT REPAIRS CENTER ROAD

JOINT REPAIRS FISHER FARM ROAD

SUBSTRUCTURE REPAIRS MILE 75.8

SUBSTRUCTURE REPAIRS MILE 87.5

SUBSTRUCTURE REPAIRS MILE 91.9

CURTIS BROOK CULVERT REPAIRS

JOINT REPAIRS DANVILLE CORNER ROAD



CONSULTANT PROJECT MANAGER

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			DANVILLE CORNER	CURTIS BROOK	FISHER FARM	CENTER ROAD	
ITEM NO.	ITEM DESCRIPTION	UNIT	RD UNDERPASS	CULVERT REPAIRS	RD UNDERPASS	UNDERPASS	TOTAL
			(MILE 75.8)	(MILE 87.49)	(MILE 87.5)	(MILE 91.9)	
202.127	REMOVING OF EXISTING BITUMINOUS PAVEMENT (2075 SY)	LS	0.28		0.37	0.35	1
202.191	REMOVING EXISTING DRAIN TROUGHS	LS	0.25		0.50	0.25	1
202,202	REMOVING PAVEMENT SURFACE	SY	410		425	455	1290
203.24	COMMON BORROW	CY		5			5
403.208	HOT MIX ASPHALT, 12.5MM NOMINAL MAXIMUM SIZE	TON	82		98	98	278
403.213	HOT MIX ASPHALT, 12.5MM NOMINAL MAXIMUM SIZE (BASE AND INTERMEDIATE COURSE)	TON	48		63	60	171
409.15	BITUMINOUS TACK COAT - APPLIED	GAL	63		78	77	218
507.095	ALUMINUM BRIDGE RAILING - SPLICE MODIFICATION	EA	10		16	12	38
508.14	HIGH PERFORMANCE WATERPROOFING MEMBRANE (2075 SY)	LS	0.28		0.37	0.35	1
511.07	COFFERDAM	LS		1			1
515.201	PIGMENTED PROTECTIVE COATING FOR CONCRETE SURFACES	SY	320		340	355	1015
515.202	CLEAR PROTECTIVE COATING FOR CONCRETE SURFACES	SY	470		655	595	1720
518.10	ABUTMENT REPAIRS	SF	15	10	25	20	70
518.20	PIER REPAIRS	SF	80		100	80	260
518.39	GRANITE CURB JOINT MORTAR AND BEDDING MORTAR REPAIR	LF	120			150	270
518.40	EPOXY INJECTION CRACK REPAIR	LF		40	20	5	65
518.43	PARAPET JOINT REPAIR	LF	400		500	410	1310
518.75	FASCIA AND OVERHANG REPAIRS	SF	45		55	5	105
518.80	PARTIAL DEPTH CONCRETE DECK REPAIRS	SF	160		210	200	570
518.81	FULL DEPTH CONCRETE DECK REPAIRS	SF	10		10	10	30
520,2211	EXPANSION DEVICE MODIFICATIONS (DANVILLE CORNER ROAD)	EA	2				2
520.2211	EXPANSION DEVICE MODIFICATIONS (FISHER FARM ROAD)	EA			2		2
520.2211	EXPANSION DEVICE MODIFICATIONS (CENTER ROAD)	EA				2	2
526.306	TEMPORARY CONCRETE BARRIER, TYPE I - SUPPLIED BY AUTHORITY	LS	0.33		0.33	0.33	1
527.341	WORK ZONE CRASH CUSHIONS - TL-3	UNIT	2		2	2	6
603.91	PRESSURE TREATED WOOD DRAIN TROUGH	LF			70		70
607.17	CHAIN LINK FENCE - 6 FOOT	LF			355		355
607.171	CHAIN LINK FENCE - 6 FOOT PVC PRIVACY FENCE	LF			1750		1750
607.23	CHAIN LINK FENCE GATE	EA			2		2
607.34	BRACING ASSEMBLY CHAIN LINK FENCE	EA			20		20
610.08	PLAIN RIPRAP	CY		8			8
6/5.07	LOAM	CY	10		25	25	60
618.14	SEEDING METHOD NUMBER 2	UNIT	1		2	2	5
619.1201	MULCH - PLAN QUANTITY	UNIT	1		2	2	5
619.1202	TEMPORARY MULCH	LS	0.2		0.4	0.4	1
619.1401	EROSION CONTROL MIX	CY	20		15	15	50
620.58	EROSION CONTROL GEOTEXTILE	SY		24			24
627.733	4" WHITE OR YELLOW PAINTED PAVEMENT MARKING LINE	LF	350		440	1200	1990
639.19	FIELD OFFICE, TYPE B	EA	0.33		0.33	0.33	1
643.712	FLASHING BEACON - SOLAR POWERED	EA	1				1
652.30	FLASHING ARROW BOARD	EA	2		2	2	6
652.312	TYPE III BARRICADES	EA	4		4	4	12
652.331	DRUM	LS	0.33		0.33	0.33	1
652.35	CONSTRUCTION SIGNS	SF	1850		1500	1500	4850
652.361	MAINTENANCE OF TRAFFIC CONTROL DEVICES	LS	0.33		0.33	0.33	1
652.41	PORTABLE-CHANGEABLE MESSAGE SIGN	EA	2		2	2	6
652.45	TRUCK MOUNTED ATTENUATOR	CD	14		14	14	42
652.45/	AUTOMATED TRAILER MOUNTED SPEED LIMIT SIGN	CD	14		14	14	42
652.46	TEMPORARY PORTABLE RUMBLE STRIPS	UNIT	42		42	42	126
656.632	30 INCH TEMPORARY SILT FENCE	LF	100	25	100	100	325
659.10	MOBILIZATION	LS	0.29	0.02	0.40	0.29	1

TY-LININTERNATIONAL

No. Revision By Date

CONSULTANT PROJECT MANAGER: Norman L. Baker

By Date By Date

Designed DSM 11/2017 Checked BLT 11/2017

Drawn DSM 11/2017 In Charge of DSM 11/2017

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THE GOLD STAR MEMORIAL HIGHWAY

BRIDGE AND CULVERT REPAIRS
4 LOCATIONS (MILE 75.8, 87.49, 87.5, & 91.9)

QUANTITIES

SHEET NUMBER: QT-01

MTA PROJECT MANAGER: R. NORWOOD

CONTRACT: 2018.10 2 OF 28

CONSTRUCTION

STATE OF MAINE, DEPARTMENT OF TRANSPORTATION STANDARD SPECIFICATIONS NOVEMBER, 2014

STATE OF MAINE DEPARTMENT OF TRANSPORTATION STANDARD DETAILS, NOVEMBER 2014, WITH LATEST REVISIONS

AASHTO LRFD BRIDGE CONSTRUCTION SPECIFICATIONS, THIRD EDITION WITH 2016

MATERIALS:

<u>CONCRETE</u>

ALL PATCHING AND REPAIR AREAS SHALL BE CLASS AAA-MODIFIED.

REINFORCING STEEL

AASHTO M31, GRADE 60 EPOXY-COATED.

BASIC DESIGN STRESSES:

CONCRETE

CLASS AAA - MODIFIED, f' = 4,500 P.S.I.

REINFORCING STEEL

f_y = 60,000 P.S.I.

GENERAL NOTES:

- THE CONTRACTOR IS REQUIRED TO CALL DIG SAFE AT 1-888-344-7233 AT LEAST 72 HOURS PRIOR TO THE START OF THE WORK.
- 2. ALL DETAILS SHALL BE IN CONFORMANCE WITH MAINE DEPARTMENT OF TRANSPORTATION (MDOT) STANDARD DETAILS, HIGHWAYS AND BRIDGES, LATEST REVISION AND MDOT BEST MANAGEMENT PRACTICES FOR EROSION AND SEDIMENT CONTROL, LATEST REVISION UNLESS OTHERWISE INCLUDED IN THESE PLANS.
- 3. IN AREAS OF PROPOSED PIPE ENTRY GATES AND CHAIN LINK FENCE, EXISTING CHAIN LINK OR WIRE FENCE SHALL BE REMOVED. REMOVING AND DISPOSING OF EXISTING FENCE SHALL BE INCIDENTAL TO PIPE ENTRY AND CHAIN LINK BID ITEMS. PROPOSED CHAIN LINK FENCE AND PIPE ENTRY GATE SHALL BE INSTALLED CONTINUOUSLY WITH NO GAPS. CHAIN LINK FENCE MAY NEED TO BE CUT OR ADDITIONAL POSTS, BRACING ASSEMBLIES OR FABRIC MAY NEED TO BE INSTALLED.
- 4. CONNECTION FOR PROPOSED FENCE TO EXISTING FENCE SHALL BE INCIDENTAL TO THE CONTRACT INCLUDING ANY REQUIRED ADDITIONAL BRACING FOR THE EXISTING
- 5. NO SEPARATE PAYMENT FOR SUPERINTENDENT OR FOREMAN WILL BE MADE FOR THE SUPERVISION OF EQUIPMENT BEING PAID FOR UNDER THE EQUIPMENT
- 6. THE PROPOSED ELEVATIONS ARE BASED ON THE NAVD 88 DATUM. THE AS-BUILT PLANS ARE BASED ON NGVD 29 DATUM.
- 7. FOR ADDITIONAL DETAILS REFERENCED OR NOT SHOWN IN THESE DRAWINGS, SEE THE STATE OF MAINE, DEPARTMENT OF TRANSPORTATION STANDARD DETAILS, HIGHWAYS AND BRIDGES, NOVEMBER 2014 WITH UPDATES.
- 8. COPIES OF THE AS-BUILT PLANS ARE ON FILE AT THE MAINE TURNPIKE AUTHORITY. A PORTION OF THESE PLANS ARE INCLUDED IN THIS CONTRACT FOR THE CONTRACTOR'S CONVENIENCE. THE COMPLETENESS AND ACCURACY OF THESE
- 9. REINFORCING STEEL SHALL HAVE A CLEAR COVER OF 2" MIN., UNLESS OTHERWISE
- 10. CHAMFER ALL EXPOSED CONCRETE EDGES 3/4" UNLESS OTHERWISE NOTED.
- II. ALL PROPOSED CONCRETE CURB FACES AND INSIDE AND TOP FACES OF THE ENDPOSTS SHALL RECEIVE A RUBBED FINISH PRIOR TO THE APPLICATION OF THE CLEAR PROTECTIVE COATING FOR CONCRETE SURFACE.
- 12. SHIELDING REQUIRED DURING CONSTRUCTION SHALL NOT PROJECT BELOW THE BOTTOM FLANGES OF GIRDERS.
- 13. ALL PAINT ON EXISTING STEEL, DAMAGED BY CONTRACTOR'S OPERATIONS, SHALL BE REPAIRED TO THE SATISFACTION OF THE RESIDENT AT THE CONTRACTOR'S EXPENSE.THE CONTRACTOR SHALL NOTE THAT THE EXISTING BRIDGE STRUCTURES CONTAIN LEAD BASED PAINT.THE CONTRACTOR SHALL INSTITUTE EVERY PRECAUTION WHEN WORKING WITH MATERIALS COATED WITH LEAD PAINT.
- 14. WHERE DRILLING AND ANCHORING OF REINFORCING STEEL IS REQUIRED, THE CONTRACTOR SHALL USE A MATERIAL LISTED ON THE MAINEDOT PREQUALIFIED LIST OF CHEMICAL ANCHORING MATERIALS. THE DEPTH OF EMBEDMENT SHALL BE SUFFICIENT TO DEVELOP 125% OF THE YIELD STRENGTH OF THE BAR, BUT SHALL BE NO LESS THAN THE MINIMUM DEPTH OF EMBEDMENT WHEN SPECIFIED. WHERE MINIMUM EMBEDMENT DEPTH HAVE NOT BEEN SPECIFIED, BAR LENGTHS HAVE BEEN DEVELOPED BASED ON AN ASSUMED EMBEDMENT DEPTH OF 9" FOR #5 BARS AND II" FOR #6 BARS. THE CONTRACTOR SHALL VERIFY THE REQUIRED DEPTH OF EMBEDMENT AND ADJUST THE REQUIRED BAR LENGTHS AS
- 15. PAYMENT FOR DRILLING AND ANCHORING OF REINFORCING STEEL IS INCIDENTAL TO ITEM 503.15, EPOXY-COATED REINFORCING STEEL, PLACING.

UTILITY:

DSM 10/2017 In Charge of DSM 11/2017

- I. THE CONTRACTOR SHALL NOTIFY THE RESIDENT IO DAYS PRIOR TO CONSTRUCTION SO THE RESIDENT CAN ARRANGE FOR MAINE TURNPIKE UNDERGROUND UTILITY LOCATION, ALL PROPOSED SIGN LOCATIONS AND EXCAVATIONS LOCATIONS SHALL BE MARKED AT THE NOTIFICATION TIME. EXCAVATING WILL NOT BE PERMITTED UNTIL THE AUTHORITY HAS LOCATED AND MARKED ITS' UNDERGROUND UTILITIES, OR NOTIFIED THE RESIDENT THAT THERE ARE NO UNDERGROUND UTILITES IN THE
- 2. THE AUTHORITY AS PROGRAMMED TWO FIELD VISITS FOR MAINE TURNPIKE UTILTY COORDINATION ON THIS PROJECT, SHOULD THE CONTRACTOR NEED ADDITIONAL SIGN LOCATIONS AND/OR ADDITIONAL EXCAVATION LOCATIONS MARKED, OR SHOULD THE CONTRACTOR FAIL TO MAINTAIN THE AUTHORITY'S PERVIOULY ESTABLISHED DIG SAFE MARKS, THE AUTHORITY SHALL DEDUCT THE ADDED MARKINGS COSTS FROM THE CONTRACTOR'S PAYMENTS.

EARTHWORK & EROSION CONTROL:

- WASTE MATERIALS SHALL BE DISPOSED OF OFF THE PROJECT SITE, IN ACCORDANCE WITH CHAPTER 404, DEPARTMENT OF ENVIRONMENTAL PROTECTION SOLID WASTE MANAGEMENT
- EXCAVATIONS ACCOMPLISHED AS PART OF THIS PROJECT SHALL BE CONSTRUCTED IN ACCORDANCE WITH OSHA SUBPART P OF 29 CFR PART 1926.650-652 (CONSTRUCTION STANDARDS FOR EXCAVATION)
- THE ANTICIPATED EROSION CONTROL DEVICES FOR THE CONTRACT LIMIT OF DISTURBANCE AREAS ARE SHOWN ON THE PLANS. THE CONTRACTOR SHALL PROPOSE ACTUAL TYPE AND LOCATON OF DEVICES FOR APPROVAL BY THE RESIDENT. ADDITIONAL MEASURES MAY BE PROPOSED BY THE CONTRACTOR DUE TO SITE OR WEATHER CONDITIONS. THE RESIDENT MAY DIRECT THE CONTRACTOR TO IMPLEMENT ADDITIONAL MEASURES. ANY ADDITIONAL MEASURES APPROVED BY THE RESIDENT WILL BE MEASURED FOR PAYMENT.
- 4" LOAM HAS BEEN ESTIMATED FOR 100% OF THE DISTURBED SLOPE AREAS UNLESS OTHERWISE SPECIFIED ON THE PLANS. ACTUAL PLACEMENT OF THE LOAM SHALL BE AS
- ALL SLOPES SHALL BE SEEDED WITH SEEDING METHOD NO. 2 UNLESS OTHERWISE DIRECTED BY THE RESIDENT.
- MULCH SHALL BE APPLIED IN AREAS SEEDED EXCEPT WHERE EROSION CONTROL BLANKET IS APPLIED.

CONCRETE REPAIR PROCEDURAL NOTES:

- CONCRETE REPAIRS, INCLUDING THE ASSOCIATED REMOVALS, WILL BE PAID UNDER 518 ITFMS
- ANY REINFORCING STEEL REQUIRED TO REPLACE DETERIORATED EXISTING REINFORCEMENT SHALL BE EPOXY COATED AND WILL BE PAID FOR UNDER ITEM 503.14, "EPOXY-COATED REINFORCING STEEL, FABRICATED AND DELIVERED" AND ITEM 503,15. "EPOXY-COATED REINFORCING STEEL, PLACING."

REMOVAL PROCEDURE:

- CONTRACTOR SHALL REMOVE TECTYL COATING WHERE PRESENT PRIOR TO WORK. PAYMENT SHALL BE INCIDENTAL TO THE SPECIFIED 518 ITEMS.
- PRIOR TO THE START OF THE CONCRETE REMOVAL, THE RESIDENT AND THE CONTRACTOR SHALL SOUND ALL EXPOSED SURFACES OF CONCRETE AND AGREE ON THE REMOVAL LIMITS. SHOULD THE REMOVAL AREA LIMITS APPEAR TO CHANGE DURING THE DEMOLITION PROCESS, THE CONTRACTOR SHALL NOTIFY THE RESIDENT. THE RESIDENT AND CONTRACTOR SHALL AGREE ON THE REVISED PAY LIMITS PRIOR TO THE CONTRACTOR CONTINUING THE REMOVAL.
- 3. PERFORM LINCH DEEP SAWCUTS ALONG LIMITS OF REMOVAL.
- 4. CHIP CONCRETE TO DEPTH REQUIRED PER SPECIFICATIONS.

CONCRETE SURFACE PATCH/REPAIR PROCEDURE:

PREPARE AND PATCH REPAIR AREAS WITH CLASS AAA - MODIFIED CONCRETE. SEE SPECIFICATIONS FOR MATERIAL, PREPARATION, PLACEMENT, AND CURING REQUIREMENTS.

GENERAL FINISHING:

ALL EXPOSED CONCRETE SURFACES SHALL BE COATED WITH A PROTECTIVE COATING IN ACCORDANCE WITH THE SPECIAL PROVISIONS AFTER PATCHING IS COMPLETE AND PATCH MATERIALS HAVE CURED. PIGMENTED PROTECTIVE COATING SHALL BE APPLIED TO ALL ABUTMENT FACES, ALL WINGWALL FACES, AND ALL END POST OUTSIDE FACES. CLEAR PROTECTIVE COATING SHALL BE APPLIED TO ALL CONCRETE CURB FACES, ALL FASCIAS AND FASCIA OVERHANGS, AND ALL END POST INSIDE AND TOP FACES.

EPOXY INJECTION CRACK REPAIR:

- PREPARE CONCRETE SURFACE AND CRACK AREA BY CLEANING SUBSTRATE WITH WIRE BRUSH TO REMOVE LAITANCE AND CONTAMINANTS. BLAST CLEAN THE CRACK AND CONCRETE SURFACE; DO NOT USE WATER.
- SET INJECTION PORTS ALONG THE LENGTH OF THE CRACK USING A HIGH-MODULUS EPOXY ADHESIVE. ONCE SET, SEAL PORTS AND CRACK WITH SAME EPOXY ADHESIVE.
- 3. WHEN THE EPOXY ADHESIVE SEAL HAS CURED, INJECT A HIGH-MODULUS, LOW-VISCOSITY EPOXY SUCH AS SIKADUR 35, SIKADUR 55, OR APPROVED EQUAL.

LIST OF ABBREVIATIONS

ALT.

APPROX

ABUTMENT ADDL. **ADDITIONAL** ASCG. AGGREGATE SUBBASE COURSE GRAVEL

AITERNATE

APPROXIMATE BOTTOM BOT. BRG. RFARING CLEARCL. CENTERLINE CONC. CONCRETE CONSTR. CONSTRUCTION DEMO. DEMOLITION DIAMETER DIA. DIAPH. DIAPHRAGM EA. EΒ EASTBOUND

EACH FACE ELEVATION EL. EQUAL EXIST. EXISTING EXP. FXPANSION F.F. FAR FACE JOINT $M\Delta X$ MAXIMIIM MIN. MINIMUM

MAINE TURNPIKE AUTHORITY MTA*NORTHBOUND* NB

NEAR FACE N.F. N.T.S. NOT TO SCALE

ORDINARY HIGH WATER O.H.W. PED. PEDESTAL PGLPROFILE GRADE LINE

PROP. PROPOSED RDWY. ROADWAY SHLD. SHOULDER SB SOUTHBOUND SP. STA. SPACES STATION T.&B. TOP & BOTTOM TPKF TURNPIKE

TYPICAL TYP. UNLESS OTHERWISE NOTED $II \cap N$

VFRT. VFRTICAL WESTBOUND WBW.P. WORKING POINT

Scale: Designed by: NOT TO SCALE **TY-LIN**INTERNATIONAL By Date Revision

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THE GOLD STAR MEMORIAL HIGHWAY

BRIDGE AND CULVERT REPAIRS 4 LOCATIONS (MILE 75.8, 87.49, 87.5, & 91.9)


GENERAL NOTES

SHEET NUMBER: GN-01

CONTRACT:2018.10

ONSULTANT PROJECT MANAGER: Norman L. Baker Date DSM 10/2017 Checked NLB 10/2017 esigned

MTA PROJECT MANAGER: R. NORWOOD

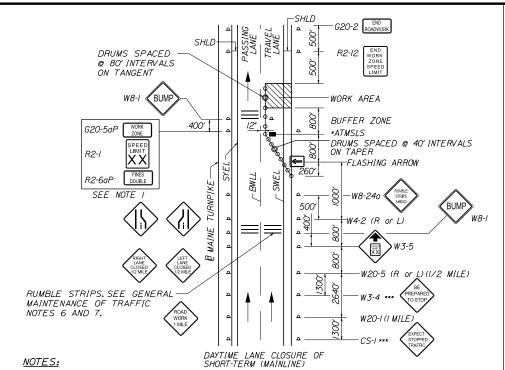

I. FOR EASEL SET UP ONLY, THIS SIGN IS NOT BRACKETED. ONE SIGN ASSEMBLY IS PLACED AT THE END OF THE TAPER.

2. SIGNS DESIGNATED WITH *** SHALL BE USED DURING STOPPAGES OF TRAFFIC.

SHI D

400'

SIGNS DESIGNATED WITH *** SHALL BE USED DURING STOPPAGES OF TRAFFIC.

* AUTOMATED TRAILER MOUNTED SPEED LIMIT SIGN (ATMSLS)

DRUMS SPACED

ON TANGENT

G20-5aP WORK ZONE

R2-I

R2-6aP

RUMBLE STRIPS.SEE GENERAL MAINTENANCE OF TRAFFIC

NOTES 6 AND 7.

@ 80' INTERVALS

SINGLE LANE CLOSURE-SIGNS ON EASELS

100'

500°

- G20-2 ROADWORK

WORK AREA

*ATMSLS


BUFFER ZONE

DRUMS SPACED @ 40' INTERVALS ON TAPER

W20-5 (R or L)(I/2 MILE)

FLASHING ARROW

W20-1 (I MILE)

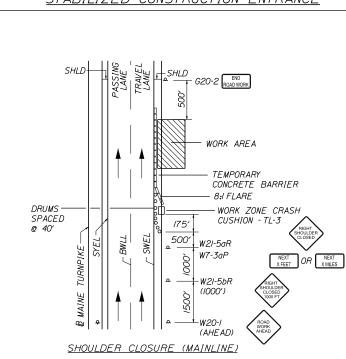

NOTE:

THE W20-I AND G20-2 SIGNS ARE NOT REQUIRED IF THE SHOULDER CLOSURE IS WITHIN A PREVIOUSLY ESTABLISHED WORK ZONE.

SHOULDER CLOSURE

ACCELERATION AREA CONSTRUCTION -50' RAD. Q STABILIZED CONSTRUCTION ENTRANCE-SEE BEST MANAGEMENT PRACTICES FNTRANCE NO DRUMS 50' MIN. LENGTH -200' MIN. DECELERATION AREA DRUMS —— SPACED @ 80' (TYP) NOTES:

I. SIGN G20-2 IS NOT REQUIRED IF ENTRANCE IS WITHIN THE WORK ZONE.

2. "TRUCKS ENTERING" SIGN SHALL ALSO BE USED AT LOCATIONS WHERE TRUCKS ENTER THE WORK ZONE FROM THE TRAVEL LANE.

STABILIZED CONSTRUCTION ENTRANCE

DRUMS SPACED — @ 80'INTERVALS ON TANGENT WORK ARFA

SHOULDER WORK OF SHORT-TERM (MAINLINE) NOTE:

THE W20-I AND G20-2 SIGNS ARE NOT REQUIRED IF THE SHOULDER CLOSURE IS WITHIN A PREVIOUSLY ESTABLISHED WORK ZONE.

SHOULDER WORK

GENERAL MAINTENANCE OF TRAFFIC NOTES:

- I. ALL PAVEMENT STRIPING & SIGNING SHALL BE IN ACCORDANCE WITH THE "MANUAL ON UNIFORM TRAFFIC CONTROL DEVICES", U.S.D.O.T., F.H.W.A., LATEST EDITION. NOTE THERE IS A 2009 EDITION OF MUTCD.
- 2. THESE PLANS SHOW THE GENERAL CONDITION FOR TURNPIKE MAINLINE TRAFFIC CONTROL DURING CONSTRUCTION, SLIGHT MODIFICATIONS IN CONSTRUCTION PROCEDURE MAY OCCUR AND MAY REQUIRE SOME MINOR ADJUSTMENTS TO BE MADE IN THE FIELD. ALL PROCEDURES MUST BE APPROVED BY THE RESIDENT.
- 3. THE CONTRACTOR SHALL REMOVE ALL PAVEMENT MARKINGS THAT CONFLICT WITH PROPOSED PAVEMENT MARKINGS IN ACCORDANCE WITH THE SPECIFICATIONS AND MUTCD. PAYMENT SHALL BE MADE UNDER ITEM 627.77 -REMOVING PAVEMENT MARKINGS
- 4. EXPOSED BARRIER ENDS SHALL BE PROTECTED BY A WORK ZONE CRASH CUSHION. PAYMENT WILL BE UNDER ITEM 527.341 - WORK ZONE CRASH CUSHION - TL-3.
- 5. NO SIGNS SHALL BE PLACED ON 4' SHOULDERS WITH GUARDRAIL. SIGNS REQUIREDAT THESE LOCATIONS SHALL BE PLACED ON TALLER EASELS ON THE MEDIAN SIDE OF THE GUARDRAIL.
- 6. IF RUMBLE STRIPS ARE USED THEY SHALL BE PLACED IN ONE OF THE FOLLOWING CONFIRGURATIONS;

ADJACENT TO THE WORK ZONE (LUNIT)

• UPSTREAM FROM THE TAPER FOR THE WORKZONE (2 UNITS) • BOTH ADJACENT TO THE WORKZONE AND PRIOR TO THE TAPER (3 UNITS)

W8-ISIGNS SHALL BE PLACED ADJACENT TO THE FIRST RUMBLE STRIP AT ANY LOCATION. ONLY ONE SET OF W8-24a SIGNS ARE REQUIRED FOR ANY OF THE ABOVE CONFIGURATIONS.

7. RUMBLE STRIPS MAY BE PLACED UPSTREAM OF THE TAPER BETWEEN THE W3-5 SIGNS AND THE W4-2 SIGNS. IF RUMBLE STRIPS ARE INSTALLED PRIOR TO TAPER, W8-I SIGNS SHALL BE PLACED ADJACENT TO THE FIRST STRIP AND THE W8-24a SIGNS SHALL BE MOVED TO 400' AFTER THE W20-5 SIGNS.

<u>ABBREVIATIONS FOR ALL M.O.T. PLANS:</u> BWLL = BROKEN WHITE LANE LINE

SWEL = SOLID WHITE EDGE LINE SYEL = SOLID YELLOW EDGE LINE

TBWLL = TEMPORARY BROKEN WHITE LANE LINE TSWEL = TEMORARY SOLID WHITE EDGE LINE TSYEL = TEMPORARY SOLID YELLOW EDGE LINE

*AUTOMATED TRAILER MOUNTED SPEED LIMIT SIGN (ATMSLS) SINGLE LANE CLOSURE-POST MOUNTED SIGN SETUP Scale

FOR POST MOUNTED SIGN SETUP, UNCOVER SIGNS ADJACENT TO OPEN LANE FOR SHORT TERM LANE CLOSURE (LESS THAN 24 HRS); UNCOVER BOTH SIGNS FOR PERMANENT LANE CLOSURE (GREATER THAN 24 HRS)

NOT TO SCALE **TY:LIN**INTERNATIONAL By Date Revision ONSULTANT PROJECT MANAGER: Norman L. Baker Date JRH 8/2017 Checked KSD 9/2017 esigned) In Charge of DSM 11/2017

DAYTIME LANE CLOSURE OF

SHORT-TERM (MAINLINE)

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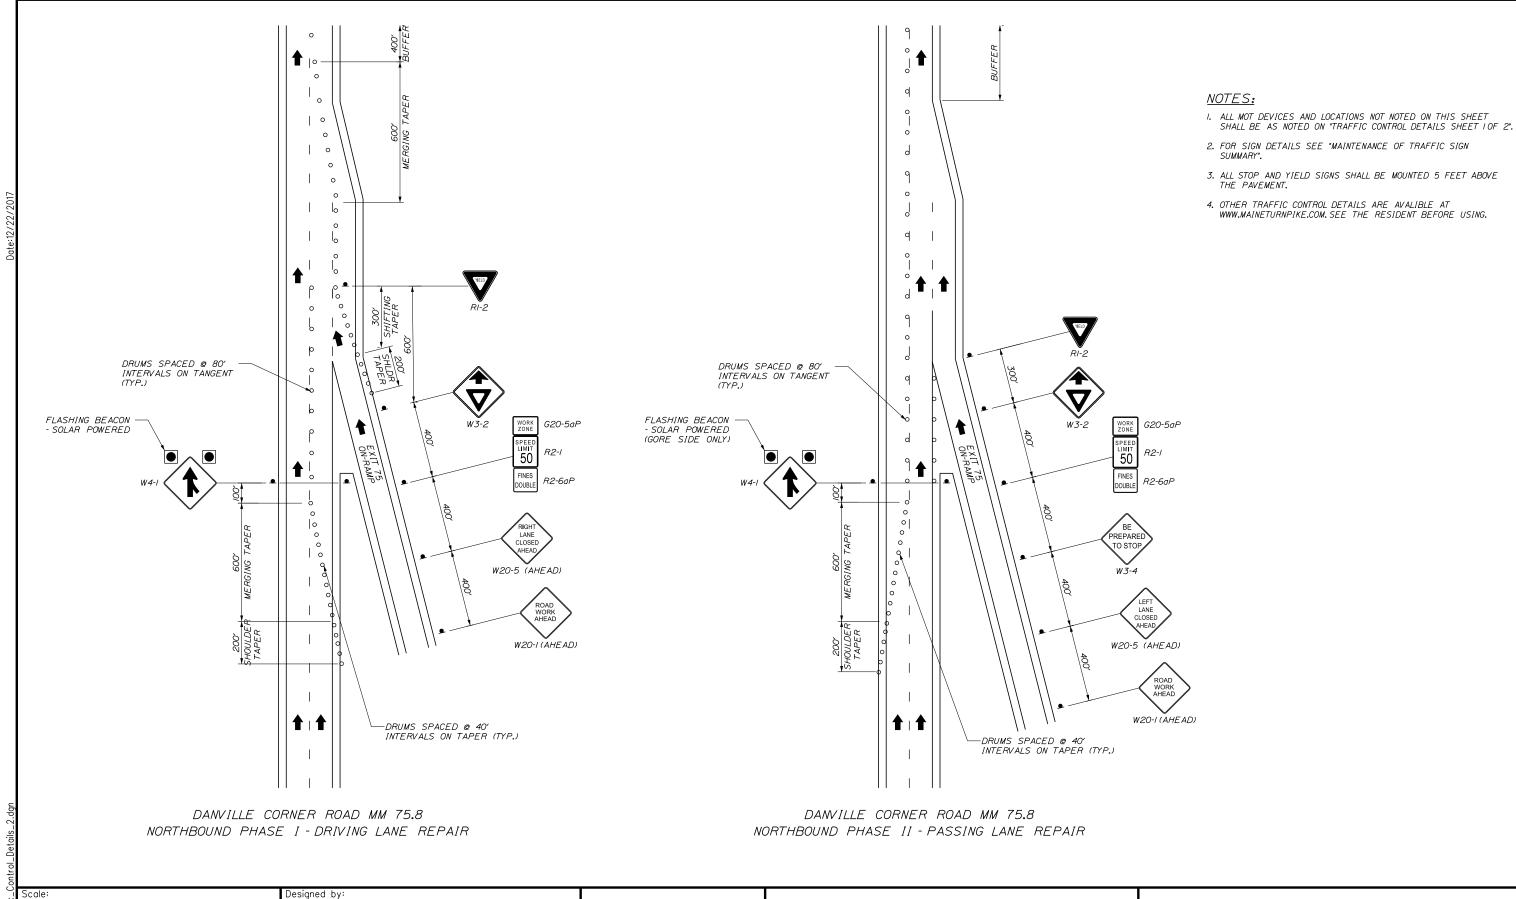
BRIDGE AND CULVERT REPAIRS 4 LOCATIONS (MILE 75.8, 87.49, 87.5, & 91.9)

TRAFFIC CONTROL DETAILS SHEET 1 OF 2

SHEET NUMBER: MT-01

CONTRACT:2018.10

MTA PROJECT MANAGER: R. NORWOOD



BRIDGE AND CULVERT REPAIRS 4 LOCATIONS (MILE 75.8, 87.49, 87.5, & 91.9)

TRAFFIC CONTROL DETAILS

SHEET 2 OF 2

SHEET NUMBER: MT-02 5 OF 28

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TY:LININTERNATIONAL

9/2017 Checked

SAM 9/2017 In Charge of DSM 11/2017

Date 9/2017

ONSULTANT PROJECT MANAGER: Norman L. Baker

Date

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By Date


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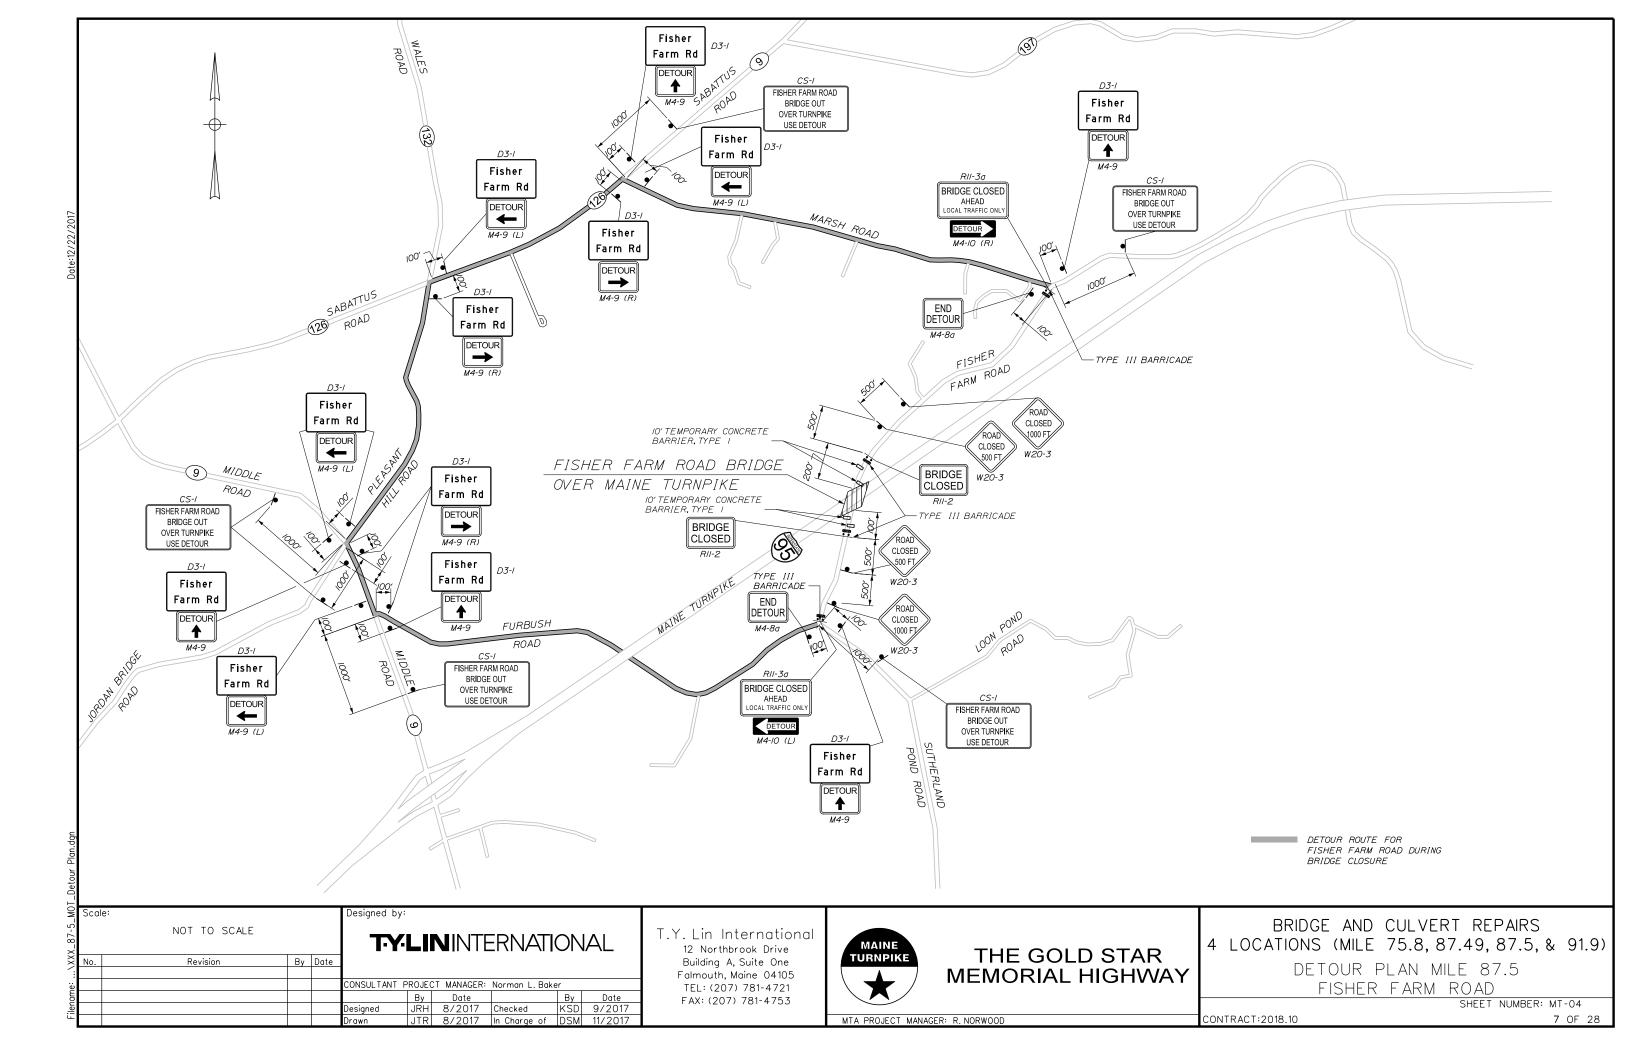
MAINE **TURNPIKE**


THE GOLD STAR **MEMORIAL HIGHWAY**

MTA PROJECT MANAGER: R. NORWOOD

CONTRACT:2018.10



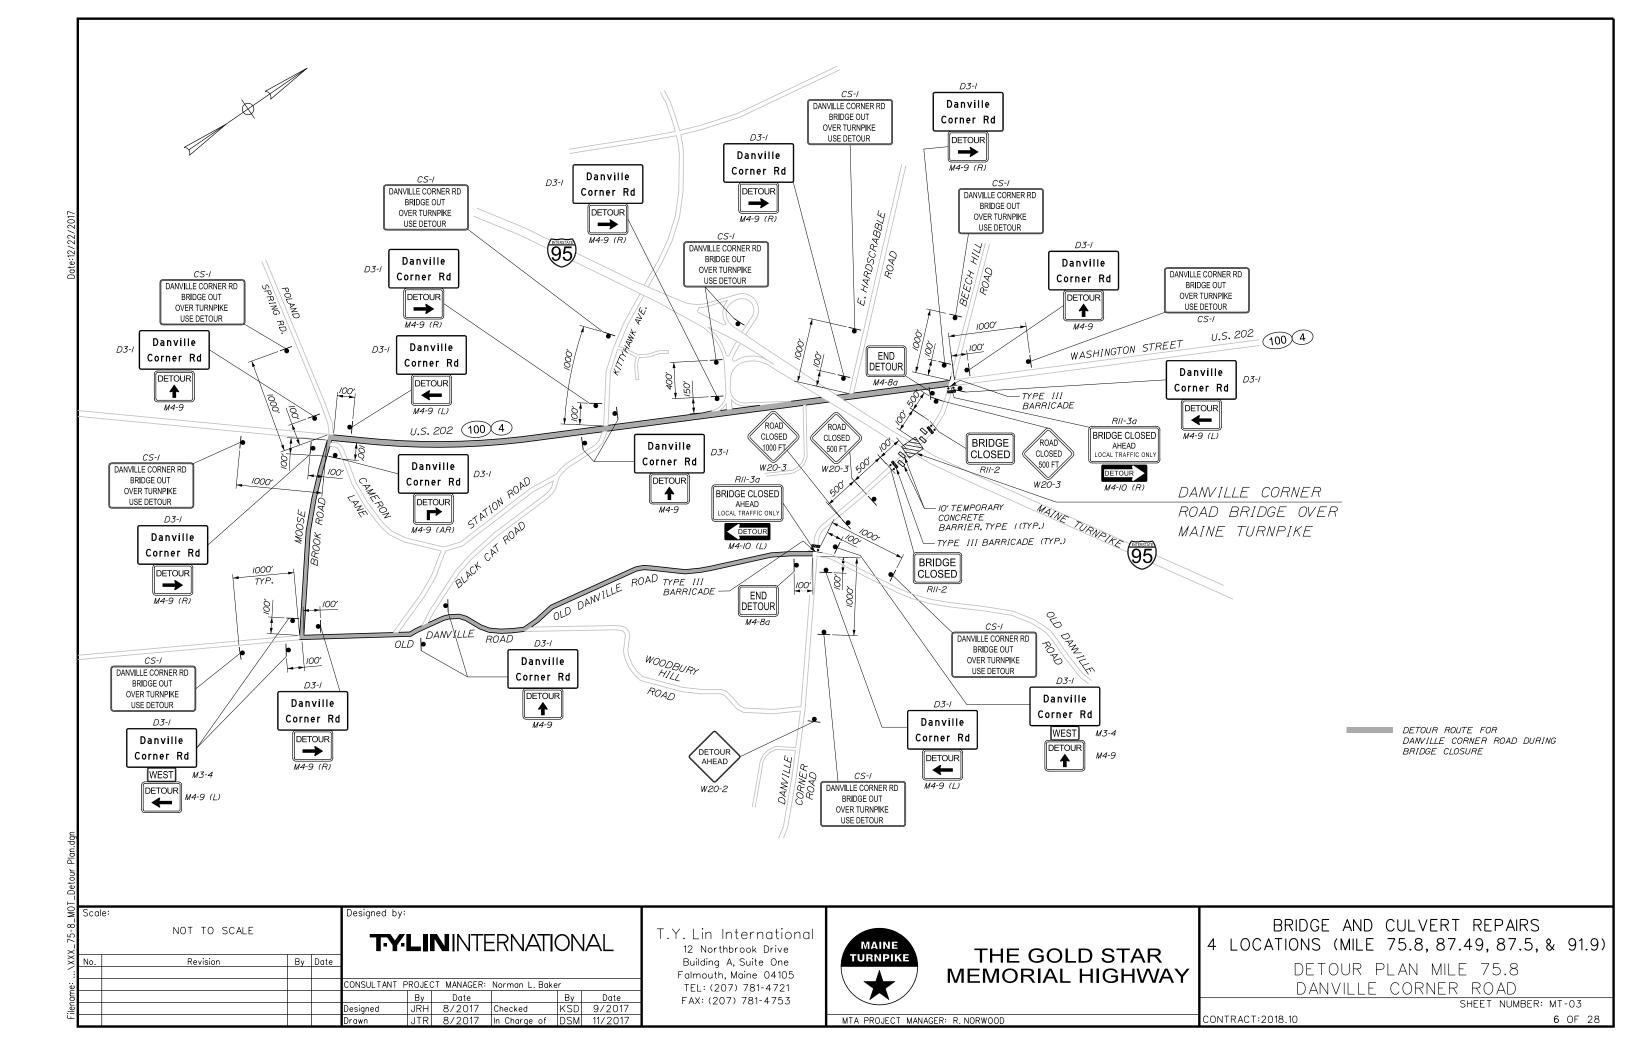

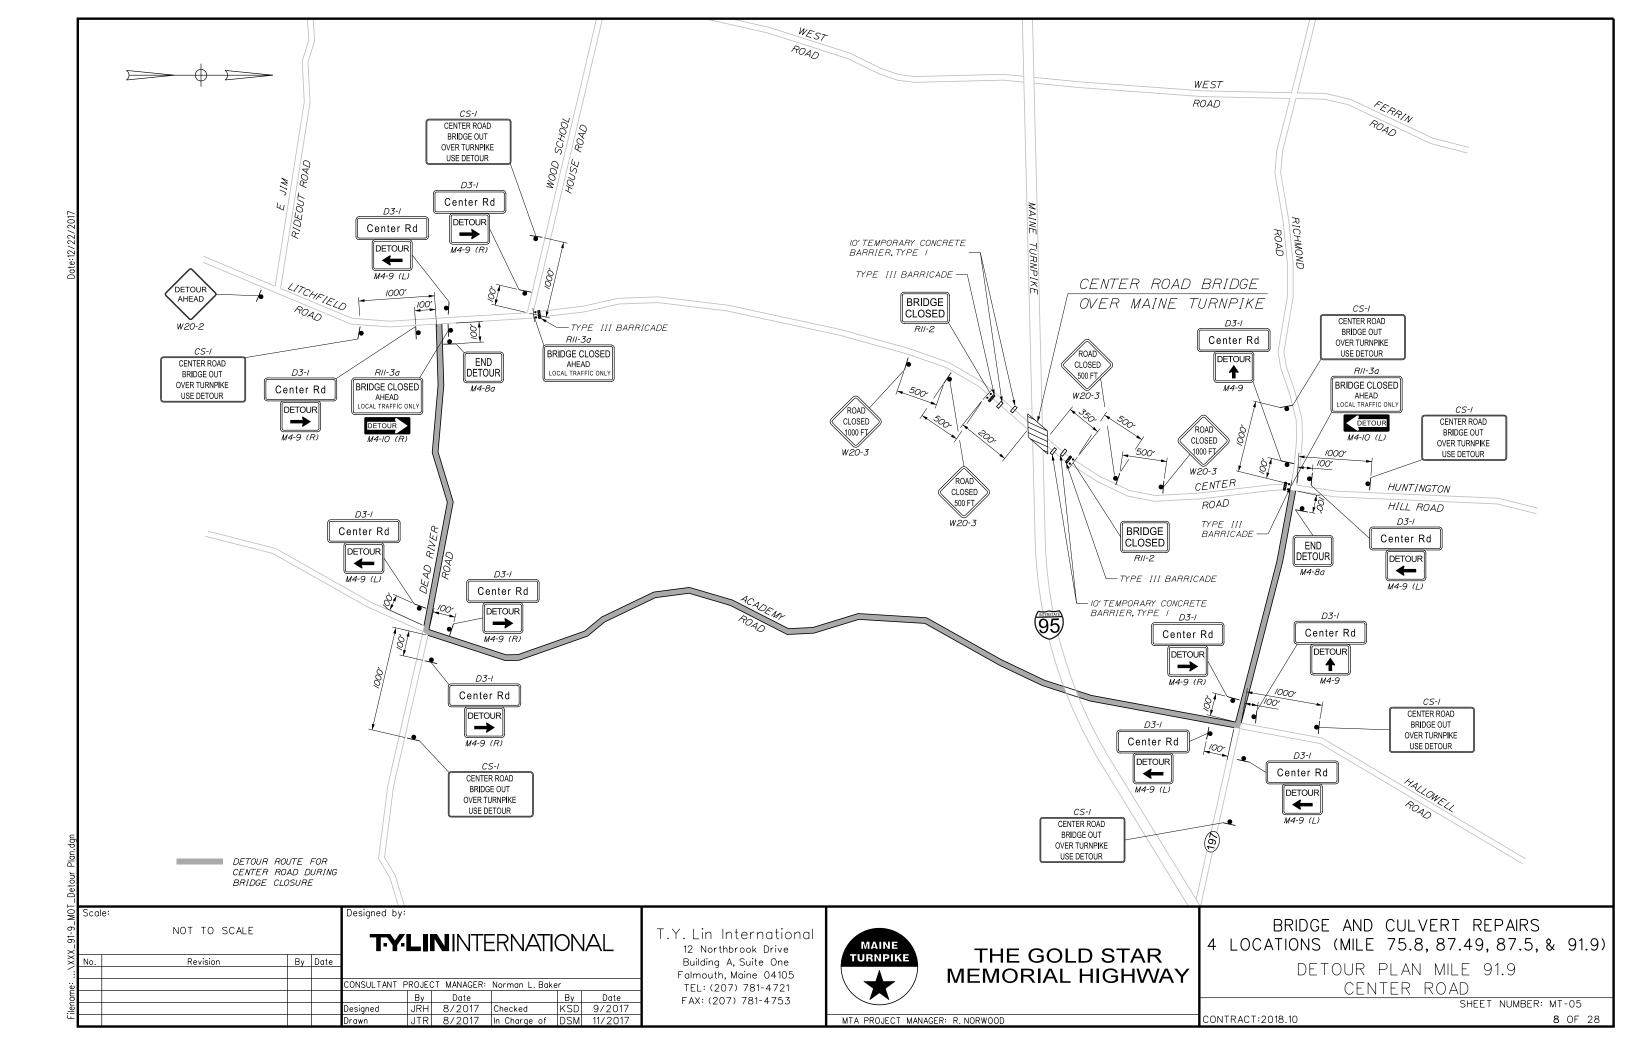

	IDENTIFI- CATION NUMBER	SI	OF 'GN HEIGHT	TEXT	LETTER	VERTICAL	(INCHES) NUMBER OF ARROW SIGNS RTE. MKR. REQUIRED	BACK- GROUND	LEGEND BC	ORDER AREA IN SQUARE FEET NOTES	IDENTIFI- CATION NUMBER	Si	E OF IGN HEIGHT	TEXT	IFTTER V	ENSIONS (INCHES) ERTICAL ARROW SPACING RTE.MKR	OF	I MALA-	LOR LEGEND BORDER	BORDER AREA IN SQUARE FEET	NOTES
	CS-I (DAWILLE CORNER RD) (FISHER FARM ROAD) (CENTER ROAD)	66" 60" 60"	36" 36" 36"	CENTER ROAD BRIDGE OUT OVER TURNPIKE USE DETOUR	5C 5C 5C 5C	4" 4" 4"	// 6 7	ORANGE	BLACK	16.50 (181.5) 15.00 (90) 15.00 (105)	RI-2	60"	60"	YIELD	CONFORM HIGHWAY	MENSIONS SHALL TO "STANDARD SIGNS" - 2009 SUPPLEMENT	,	WHITE	RED	10.80 (10.8)	
Date:12/22/2017	CS-3	48"	48"	EXPECT STOPPED TRAFFIC	6" 6" 6"	4" 4"	12	ORANGE	BLACK	16.00 (192)	R2-I	48"	60°	SPEED LIMIT 50			/3	WHITE	BLACK	20.00 (260)	
Dat					7"									FINES						8.00	
	CS-10	48"	48"	TRUCKS ENTERING	7" 7"	6"	6	ORANGE	BLACK	16.00 (96)	R2-6aP	48"	24"	DOUBLE			/3	WHITE	BLACK	(104)	
	D3-I (DAWILLE CORNER RD)	48"	24"	Danville Corner Rd	CONFOI HIGHW	DIMENSION RM TO "ST AY SIGNS" 2 SUPPLEM	TANDARD - 2009	ORANGE	BLACK	8.00 (152)	R2-I2	36"	54"	END WORK ZONE SPEED LIMIT			12	WHITE	BLACK	/3.5 (/62)	
	D3-I (FISHER FARM RD)	40"	24"	Fisher Farm Rd			15	ORANGE	BLACK	6.67	RII-2	48"	30"	BRIDGE CLOSED			6	WHITE	BLACK	10.00 (60)	
	D3-I (CENTER RD)	48"	12"	Center Rd			12			4.00 (48)											
	G20-2	48"	24"	END ROAD WORK			12	ORANGE	BLACK	8.00 (96)	RII-3a	60"	30"	BRIDGE CLOSED AHEAD LOCAL TRAFFIC ONLY			7	WHITE	BLACK	/2.50 (87.5)	
	G20-5aP	48"	24"	WORK ZONE			/3	ORANGE	BLACK	8.00 (104)	w3-2	48"	48"				,	ORANGE	BLACK	16.00 (16)	
	M3-4	24"	12"	WEST			2	ORANGE	BLACK	2.00 (4)											
	M4-8a	24"	18"	END DETOUR			6	ORANGE	BLACK	3.00 (18)	W3-4	48"	48"	BE PREPARED			13	ORANGE	BLACK	16.00 (208)	
	M4-9 (THRU) (LEFT) (RIGHT)	30"	24"	DETOUR			14 15 15	ORANGE	BLACK	5.00 (70) (75) (75)				TO STOP							
1.dgn	M4-9 (AR)	30"	24"	DETOUR			ı	ORANGE	BLACK	5.00 (5)	W3-5	48"	48"	SPEED			12	ORANGE	BLACK	16.00 (192)	
_Summary_01.dgn	M4-IO (LEFT) (RIGHT)	48"	18"	DETOUR	₩	 	3 3	ORANGE	BLACK	6.00 (18) (18)				SPEED LIMIT X X	₩	\ \ \ \ \ \ \ \ \ \ \ \ \ \ \ \ \ \ \	,,_			(132)	
Filename:\XXX_MOT_Sign_	o.	NOT	ΓΟ SCALE	By Dote	ULTANT PROJECT	CT MANAGE Date 9/2017	R: Norman L. Baker By Checked KS In Charge of DS	Date 9/201	1: B Fc T F	Lin International 12 Northbrook Drive Building A, Suite One almouth, Maine 04105 TEL: (207) 781-4721 FAX: (207) 781-4753	MAINE TURNPIKE MTA PROJECT MANA		EMO	GOLD STAF RIAL HIGHW	VAY	4 LOCATI	IONS (MAINT SIGN	(MILE Enan	75.8, CE Of	ERT REPAIRS 87.49, 87.5 F TRAFFIC 1 OF 2 SHEET NUMBER	, & 91.9)

IDENTIFI-	CIZI	E OF		TEXT	DIMENS	IONS	(INCHES)	NUMBER	COL	OR	I	1051 111	
CATION NUMBER	SI	HEIGHT	TEXT	LETTE	R VERT	ICAL	ARROW RTF MKR	NUMBER OF SIGNS REQUIRED	BACK- GROUND	LEGEND BORDER	BORDER RADIUS	AREA IN SQUARE FEET	NOTES
W4-I (RIGHT)	48"	48"		TEX CONI HIGH	T DIMENS FORM TO HWAY SIG OI2 SUPF	SIONS "STA "NS" -	S SHALL NDARD 2009	2	ORANGE	BLACK		16.00 (32)	
W4-2 (LEFT) (RIGHT)	48"	48"						12 12	ORANGE	BLACK		16.00 (192) (192)	
W7-3aP	36"	30"	NEXT X FEET					12	ORANGE	BLACK		7.50 (90)	
W2O-I (I MILE) (AHE AD)	48"	48"	ROAD WORK 1 MILE					12 13	ORANGE	BLACK		16.00 (192) (208)	
W20-2	36"	36"	DETOUR AHEAD					2	ORANGE	BLACK		9.00 (18)	
W20-3 (1000') (500')	36"	36"	ROAD CLOSED XX FT					5 6	ORANGE	BLACK		9.00 (45) (54)	
W20-5 (LEFT) (RIGHT)	48"	48"	LEFT LANE CLOSED 1/2 MILE					12 12	ORANGE	BLACK		16.00 (192) (192)	
W2O-5 (LEFT) (RIGHT)	48"	48"	LEFT LANE CLOSED AHEAD	₩	7	,		//	ORANGE	BLACK		16.00 (16) (16)	

IDENTIFI- CATION NUMBER	SI	OF GN HEIGHT	TEXT		T DIN TER SHT	MENSI VERT	ONS ICAL	(INCH ARF RTF	ES) ROW MKR	NUMBER OF SIGNS REQUIRED	COL BACK- GROUND	OR LEGEND BORDER	BORDER RADIUS	AREA IN SQUARE FEET	NOTES
W2I-5	48"	48"	SHOULDER	TE CO HI	XT D NFOR GHWA	IMENS M TO Y SIGN SUPF	SIONS "STAI NS" - 2	SHA. VDARI 2009	LL	6	ORANGE	BLACK		16.00 (96)	
W2I-5a (LEFT) (RIGHT)	48"	48"	LEFT SHOULDER CLOSED							6 6	ORANGE	BLACK		16.00 (96) (96)	
W2I-5b (LEFT) (RIGHT)	48"	48"	LEFT SHOULDER CLOSED 1000 FT							66	ORANGE	BLACK		16.00 (96) (96)	
W8-I (BUMP)	48"	48"	BUMP							12	ORANGE	BLACK		16.00 (192)	
W8-24A (RUMBLE STRIPS AHEAD)	48"	48"	RUMBLE STRIPS AHEAD	7	,	V	,	V		6	ORANGE	BLACK		16.00 (96)	

CONTRACT:2018.10

Scale: TY-LININTERNATIONAL NOT TO SCALE Revision By Date CONSULTANT PROJECT MANAGER: Norman L. Baker
 By
 Date
 By
 Date

 JRH
 9/2017
 Checked
 KSD
 9/2017

 JRH
 9/2017
 In Charge of
 DSM
 11/2017

T.Y. Lin International 12 Northbrook Drive Building A, Suite One Falmouth, Maine 04105 TEL: (207) 781-4721 FAX: (207) 781-4753




THE GOLD STAR MEMORIAL HIGHWAY

BRIDGE AND CULVERT REPAIRS 4 LOCATIONS (MILE 75.8, 87.49, 87.5, & 91.9)


MAINTENANCE OF TRAFFIC SIGN SUMMARY 2 OF 2

SHEET NUMBER: MT-07

MTA PROJECT MANAGER: R. NORWOOD

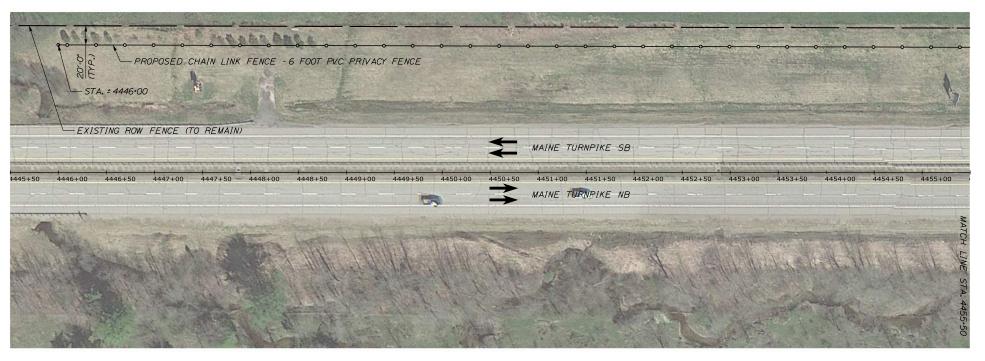

PLAN VIEW

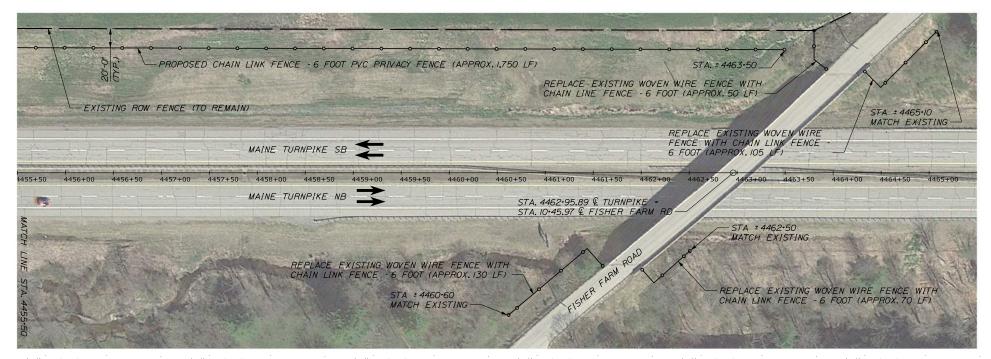

PLAN VIEW

NOTES:

- I. NO ADDITIONAL PAYMENT WILL BE MADE FOR LONGER POSTS NECESSITATED BY LARGE GRADE DIFFERENTIAL.
- 2. CHAIN LINK FENCE SHALL BE INSTALLED WITH BARBS DOWN.
- 3. PVC PRIVACY SLATS SHALL BE INSTALLED AND SHALL CONFORM TO THE REQUIREMENTS OF SPECIAL PROVISION SECTION 607 FENCES OF THE PROJECT SPECIFICATIONS.
- 4. ONE (1) 3'-O" SINGLE GATE SHALL BE INSTALLED IN PROPOSED CHAIN LINK 6 FOOT, ADJACENT TO EACH ABUTMENT (2 GATES TOTAL), FINAL GATE LAYOUT SHALL BE DETERMINED BY RESIDENT.
- 5. EXISTING AND PROPOSED FENCING SHOWN IS APPROXIMATE ONLY. FINAL LIMITS AND LAYOUT FOR ALL REMOVAL AND INSTALLATION SHALL BE DETERMINED BY RESIDENT.
- 6. REMOVAL AND DISPOSAL OF EXISTING WOVEN WIRE FENCING BEING REPLACED WITH CHAIN LINK FENCING SHALL BE INCIDENTAL TO ITEM 607.17, CHAIN LINK FENCE - 6 FOOT.

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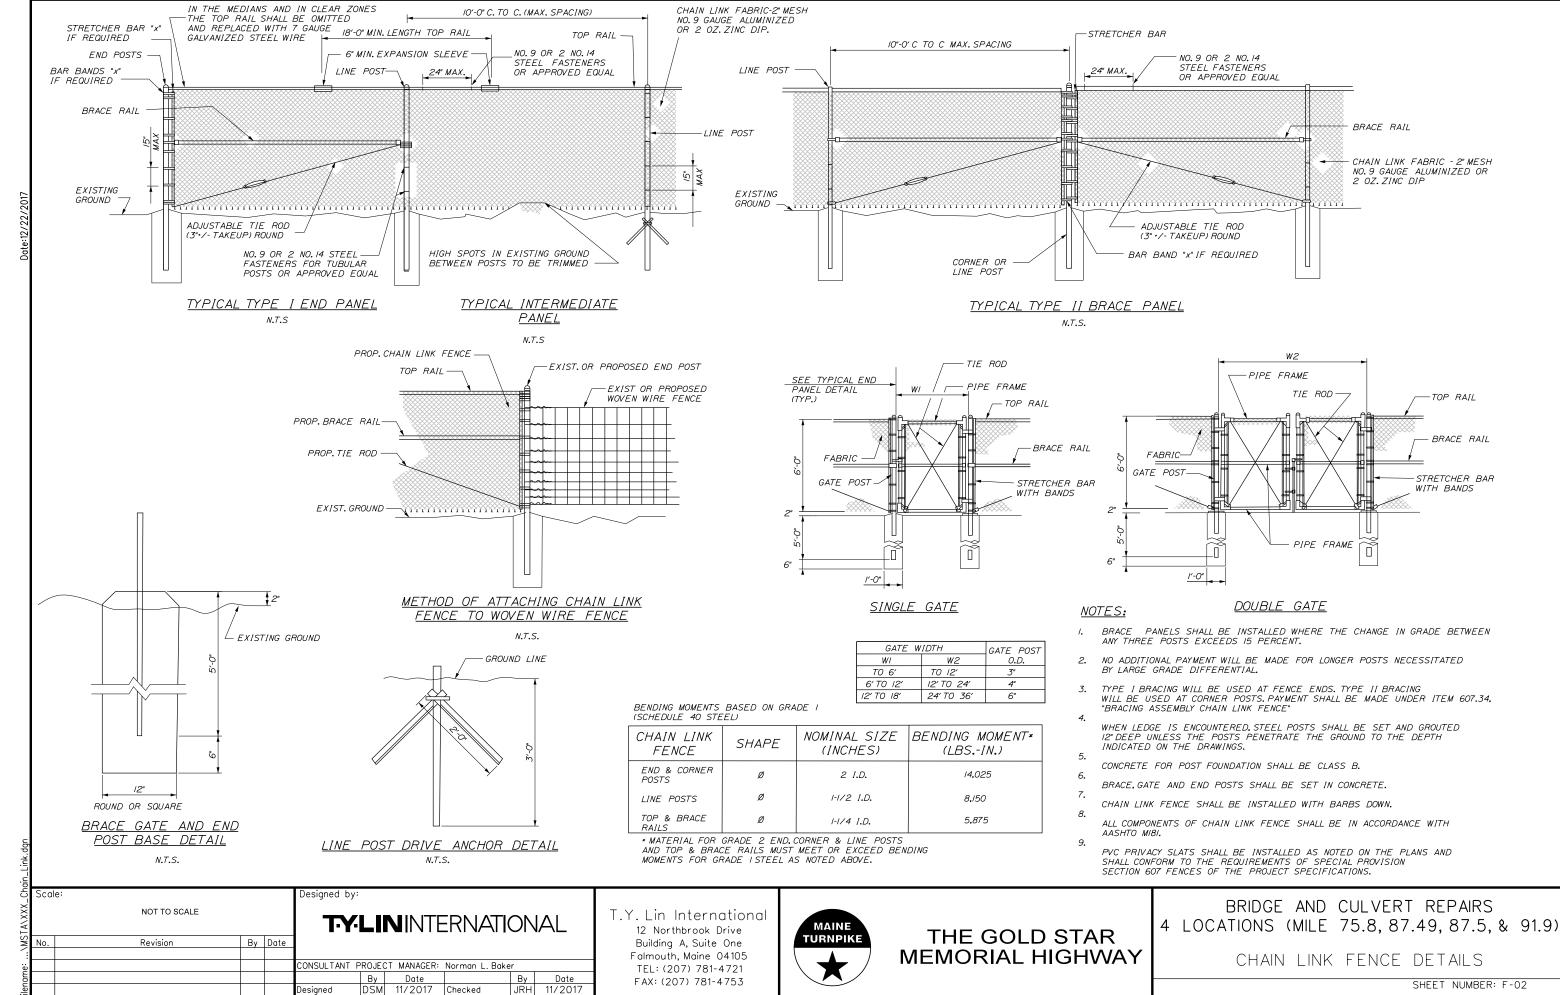


THE GOLD STAR MEMORIAL HIGHWAY BRIDGE AND CULVERT REPAIRS
4 LOCATIONS (MILE 75.8, 87.49, 87.5, & 91.9)

FENCING PLAN MILE 87.5

SHEET NUMBER: F-01


CONTRACT:2018.10




MTA PROJECT MANAGER: R. NORWOOD

PWM 11/2017 In Charge of DSM 11/2017

CONTRACT: 2018.10 12 OF 28

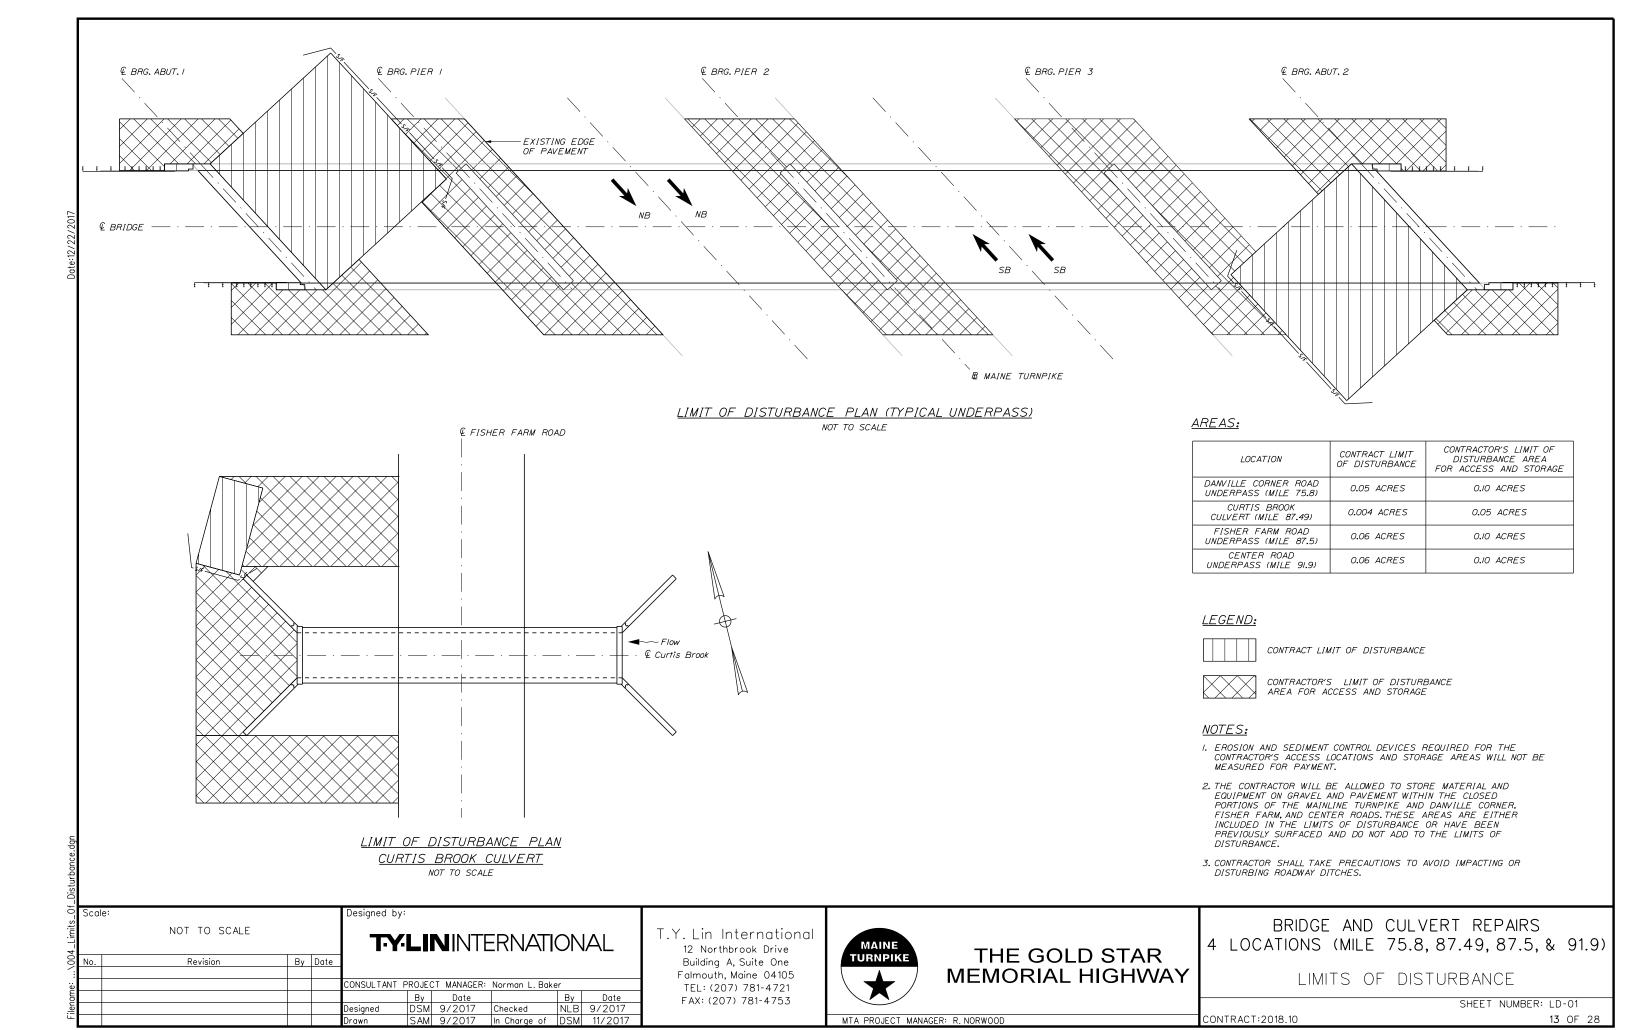

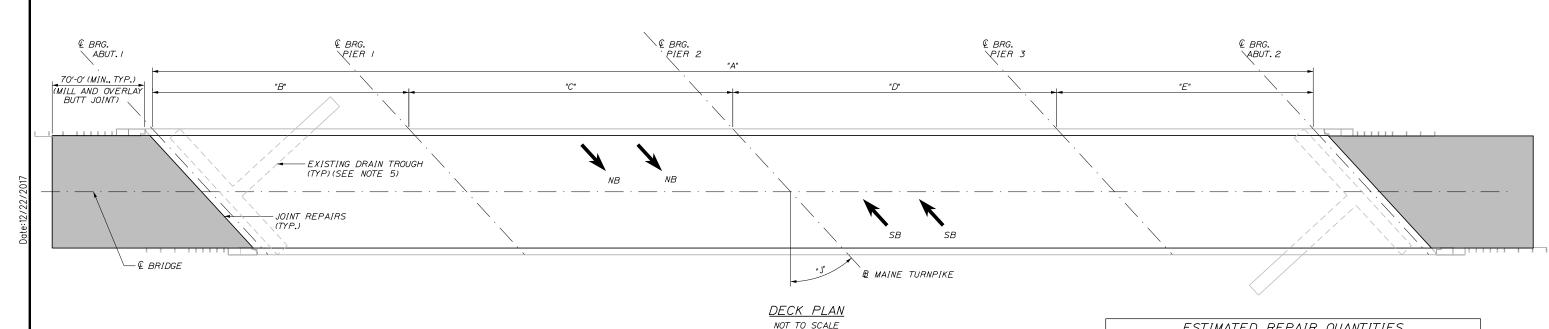

42*35′00"


BRIDGE DIMENSION TABLE BRIDGE "A" "B" "J" DANVILLE CORNER ROAD UNDERPASS (MILE 75.8) 207'-0" 44'-0" 54'-0" 59'-0' 50'-0" 28'-0' 12'-6" l'-6" 8" 13°24′30" FISHER FARM ROAD UNDERPASS (MILE 87.5) 76′-0" 73′-0" 71/2" 47°58′00" //'-6"

57'-0"

28'-0"

12'-6"

ESTIMATED REPAIR QUANTITIES FULL DEPTH PARTIAL DEPTH FASCIA AND CONCRETE DECK CONCRETE DECK **OVERHANG** REPAIRS (S.F.) REPAIRS (S.F.) REPAIRS (S.F.) DANVILLE CORNER ROAD UNDERPASS (MILE 75.8) 10 160 45 FISHER FARM ROAD UNDERPASS (MILE 87.5) 10 210 55 CENTER ROAD UNDERPASS (MILE 91.9) 5 10

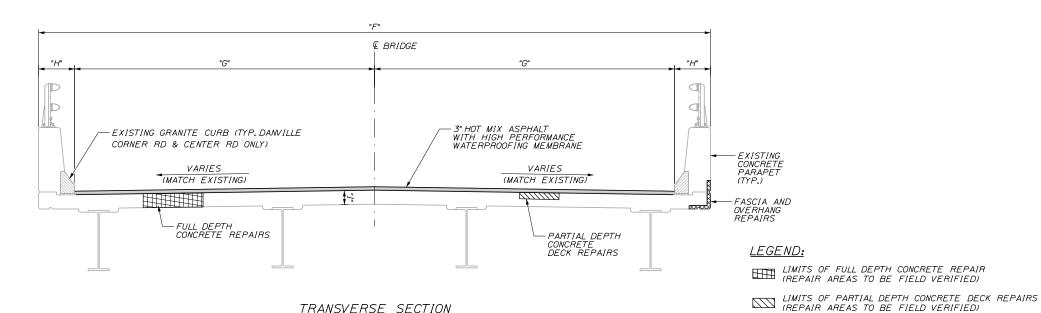

SAM 9/2017 In Charge of DSM 11/2017

TRANSVERSE SECTION NOT TO SCALE

72'-0"

NOTES:

- I. CONTRACTOR SHALL REPAIR AREAS OF CONCRETE DECK DETERIORATION AS IDENTIFIED BY THE RESIDENT, RESIDENT SHALL IDENTIFY AND MARK AREAS FOR DECK REPAIR AFTER THE WEARING SURFACE AND MEMBRANE ARE REMOVED. CONTRACTOR SHALL ALSO REPAIR DETERIORATED AREAS OF FASCIA, FASCIA OVERHANGS, AND PARAPET JOINTS. COORDINATE WORK WITH THE RESIDENT. PAYMENT FOR REPAIR WORK SHALL BE UNDER THE 518 PAY ITEMS.
- 2. CONTRACTOR SHALL REPAIR AREAS OF DETERIORATED GRANITE CURB BEDDING AND JOINT MORTAR ON THE DECK AS REQUIRED. LOCATIONS OF GRANITE CURB BEDDING AND JOINT MORTAR SHALL BE FIELD DETERMINED BY THE RESIDENT. PAYMENT SHALL BE UNDER THE 518 PAY ITEMS.
- ALL PVC DECK WEEPS WHICH DRAIN ONTO PIERS, ABUTMENTS OR STRUCTURAL 3. STEEL SHALL BE EXTENDED AND DIVERTED AWAY FROM BRIDGE COMPONENTS BELOW DECK, AND SHALL EXTEND IFT BELOW BOTTOM FLANGE, AS DIRECTED BY THE RESIDENT. PAYMENT SHALL BE BY THE VARIOUS LABOR AND EQUIPMENT ITEMS.
- 4. REMOVAL OF EXISTING GRANITE CURB BEDDING AND JOINT MORTAR, AS SPECIFIED BY THE RESIDENT, SHALL BE INCIDENTAL TO ITEM 202.2021, "REMOVING PAVEMENT SURFACE - BRIDGE DECK".
- 5. FOR WORK REQUIRED AT DRAIN TROUGHS, SEE SHEET "TYPICAL DETAILS".
- 6. A BEAD OF HOT-APPLIED RUBBERIZED ASPHALT SEALER SHALL BE APPLIED ALONG CURB LINES AFTER INSTALLATION OF BASE COURSE. PAYMENT SHALL NOT BE MADE DIRECTLY BUT SHALL BE CONSIDERED INCIDENTAL TO RELATED CONTRACT ITEMS.

Scale: AS NOTED **TY-LIN**INTERNATIONAL Revision By Date ONSULTANT PROJECT MANAGER: Norman L. Baker Date Designed DSM 9/2017 Checked NLB 9/2017

57′-0"

72'-0"

258'-0"

CENTER ROAD UNDERPASS (MILE 91.9)

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1'-6"



THE GOLD STAR MEMORIAL HIGHWAY

BRIDGE AND CULVERT REPAIRS 4 LOCATIONS (MILE 75.8, 87.49, 87.5, & 91.9)


TYPICAL UNDERPASS DECK PLAN & SECTION

SHEET NUMBER: S-01

CONTRACT:2018.10 **14** OF 28


LIMITS OF FASCIA AND OVERHANG REPAIRS (REPAIR AREAS TO BE FIELD VERIFIED)

ABUTMENT PLAN - DANVILLE CORNER ROAD SCALE: 3/8" = 1'-0"

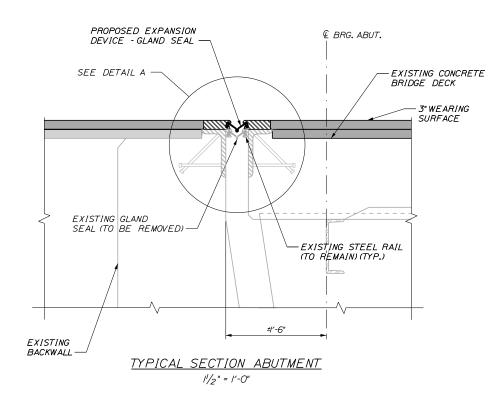

EXPANSION JOINT NOTES:

- I. ALL STEEL COMPONENTS SHALL BE AASHTO M270 GRADE 36, UNLESS OTHERWISE NOTED.
- 2. CONTRACTOR SHALL FIELD MEASURE EXISTING CURB PLATE AND JOINT DIMENSIONS PRIOR TO DEVELOPMENT OF SHOP DRAWINGS.
- 3. EXPANSION JOINT MODIFICATIONS AT EACH ABUTMENT SHALL BE PAID UNDER ITEM 520.2211, EXPANSION DEVICE MODIFICATIONS.

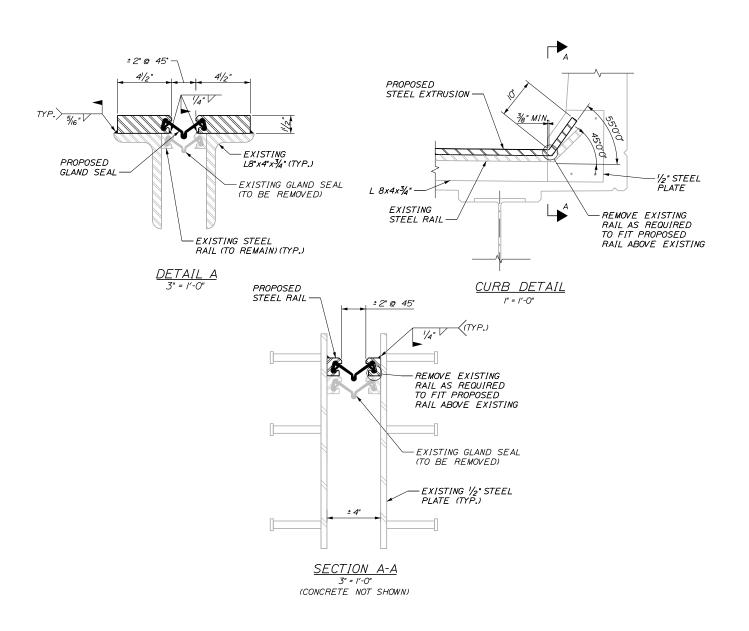

CONTRACT:2018.10

Scale: AS NOTED TY:LININTERNATIONAL By Date Revision CONSULTANT PROJECT MANAGER: Norman L. Baker Date Designed DSM 9/2017 Checked NLB 9/2017 PEM 9/2017 In Charge of DSM 11/2017

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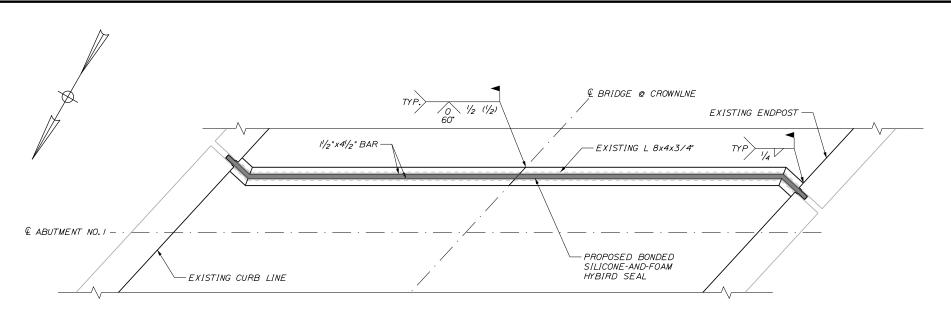


THE GOLD STAR **MEMORIAL HIGHWAY**


BRIDGE AND CULVERT REPAIRS 4 LOCATIONS (MILE 75.8, 87.49, 87.5, & 91.9) JOINT REPAIRS DANVILLE CORNER ROAD

SHEET NUMBER: S-02

MTA PROJECT MANAGER: R. NORWOOD




<u>PLAN</u> SCALE: 3/8" = 1'-0" (ABUTMENT | SHOWN, ABUTMENT 2 SIMILAR)

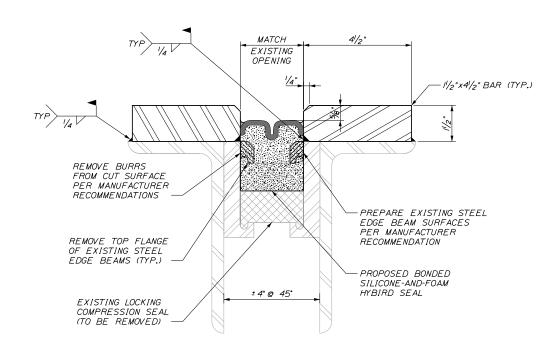


EDGE BEAM MODIFICATIONS AND PROPOSED SEAL TYPICAL SECTION SCALE: 6" = 1'-0"

JOINT REPAIR NOTES:

- 1. ALL STEEL COMPONENTS SHALL BE AASHTO M270 GRADE 36, UNLESS OTHERWISE NOTED.
- 2. CONTRACTOR SHALL FIELD MEASURE EXISTING CURB PLATE AND JOINT DIMENSIONS PRIOR TO DEVELOPMENT OF SHOP DRAWINGS.
- 3. EXPANSION JOINT MODIFICATIONS AT EACH ABUTMENT SHALL BE PAID UNDER ITEM 520.2211, EXPANSION DEVICE MODIFICATIONS.
- 4. CONTRACTOR SHALL REPLACE EXISTING NEOPRENE COMPRESSION SEALS WITH NEW BONDED SILICONE-AND-FOAM HYBRID SEALS.
- 5. THE BONDED SILICONE-AND-FOAM HYBRID SEALS TO BE FURNISHED SHALL HAVE A MINIMUM MOVEMENT RANGE OF 1/2 INCHES.

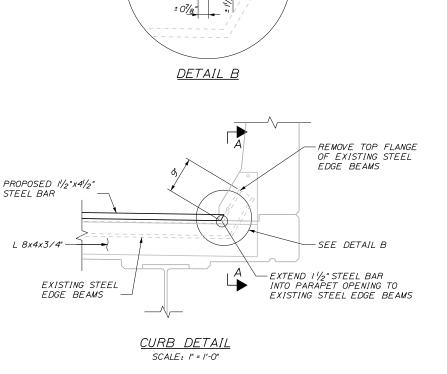

±0%".

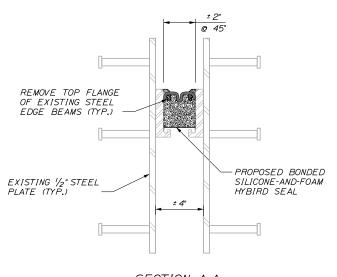

SECTION A-A SCALE: 3" = 1'-0" (CONCRETE NOT SHOWN)

CONTRACT:2018.10

.Repo	Scal	e:			Designed by:					
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e:					CONSULTANT F	PROJEC	CT MANAGER:	Norman L. Bake	er	
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ie					Designed	DSM	9/2017	Checked	NLB	9/2017
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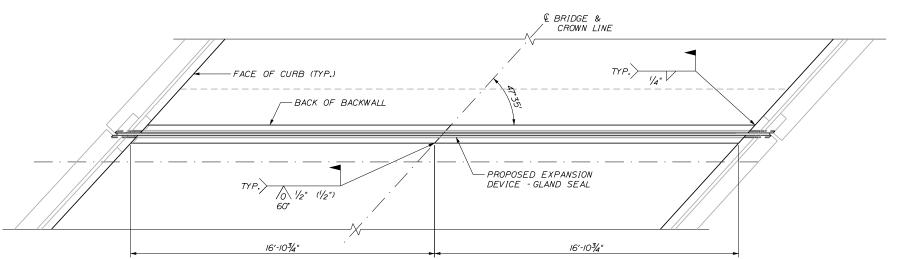
THE GOLD STAR **MEMORIAL HIGHWAY**

BRIDGE AND CULVERT REPAIRS 4 LOCATIONS (MILE 75.8, 87.49, 87.5, & 91.9)

JOINT REPAIRS FISHER FARM ROAD

SHEET NUMBER: S-03


MTA PROJECT MANAGER: R. NORWOOD




EXPANSION JOINT NOTES:

- I. ALL STEEL COMPONENTS SHALL BE AASHTO M270 GRADE 36, UNLESS OTHERWISE NOTED.
- 2. CONTRACTOR SHALL FIELD MEASURE EXISTING CURB PLATE AND JOINT DIMENSIONS PRIOR TO DEVELOPMENT OF SHOP DRAWINGS.
- 3. EXPANSION JOINT MODIFICATIONS AT EACH ABUTMENT SHALL BE PAID UNDER ITEM 520.2211, EXPANSION DEVICE MODIFICATIONS.

<u>ABUTMENT PLAN - CENTER ROAD</u> SCALE: ¾" = 1'-0"

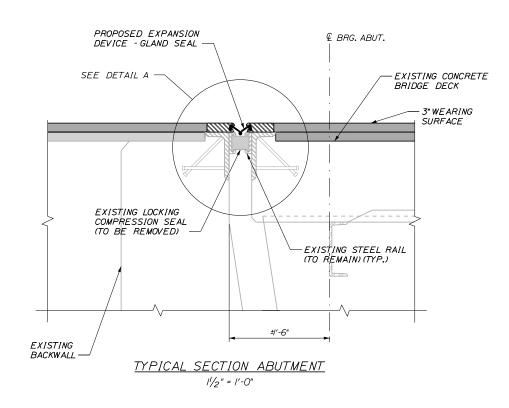

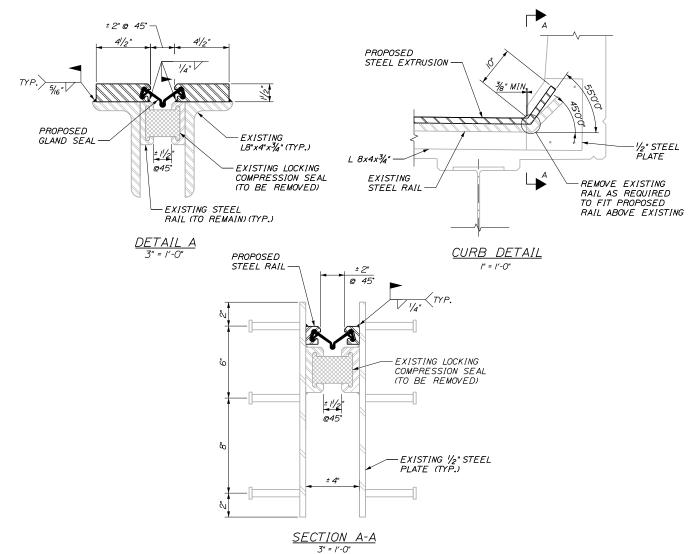

-Repo	Scal	e:			Designed by:					
x_Joint_		AS NOTED			T:Y:	LII	NINTE	ERNATI	ON	AL
\XX	No.	Revision	Ву	Date						
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E						Ву	Date		Ву	Date
ilen					Designed	DSM	9/2017	Checked	NLB	9/2017
ш.					Drawn	SAM	9/2017	In Charge of	DSM	11/2017

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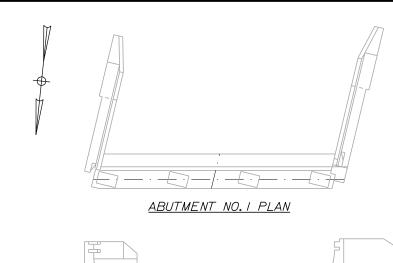
THE GOLD STAR MEMORIAL HIGHWAY

BRIDGE AND CULVERT REPAIRS
4 LOCATIONS (MILE 75.8, 87.49, 87.5, & 91.9)

JOINT REPAIRS


CENTER ROAD


SHEET NUMBER: S-04 CONTRACT:2018.10 17 OF 28



ABUTMENT NO. 2 PLAN

ABUTMENT NO. 2 ELEVATION

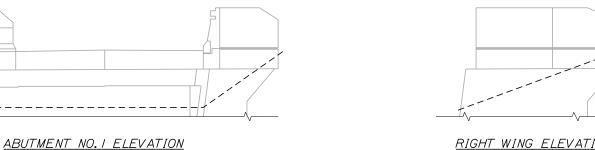

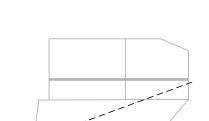

RIGHT WING ELEVATION

DANVILLE CORNER ROA	D (MILE 7	5.8) ABUTME	ENTS
ESTIMATED QUA	NTITY OF F	REPAIRS	
	ABUT. NO. 1	ABUT. NO. 2	TOTAL
ABUTMENT REPAIRS	0 S.F.	25 S.F.	25 S.F.


NOTE:


I. FOR PROCEDURAL NOTES SEE SHEET "GENERAL NOTES"

LEGEND:


LIMIT OF CONCRETE SURFACE REPAIRS ---- LIMIT OF EPOXY INJECTED CRACK REPAIR ---- EXISTING CONCRETE

--- EXISTING AND PROPOSED GROUND

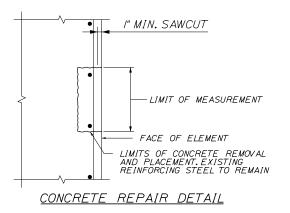

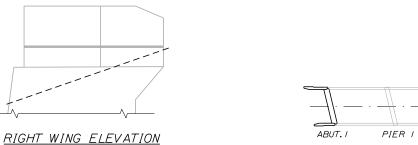

CONTRACT:2018.10

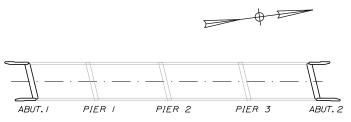

b_Repairs_										
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ē			-			Ву	Date	_	Ву	Date
<u>.e</u>					Designed	DSM	8/2017	Checked	BLT	9/2017
ᄔ					Drawn	SAM	8/2017	In Charge of	DSM	11/2017

LEFT WING ELEVATION

LEFT WING ELEVATION

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THE GOLD STAR MEMORIAL HIGHWAY


BRIDGE AND CULVERT REPAIRS 4 LOCATIONS (MILE 75.8, 87.49, 87.5, & 91.9)

SUBSTRUCTURE REPAIRS MILE 75.8 SHEET 1 OF 3

SHEET NUMBER: S-05 18 OF 28

MTA PROJECT MANAGER: R. NORWOOD

LOCATION PLAN

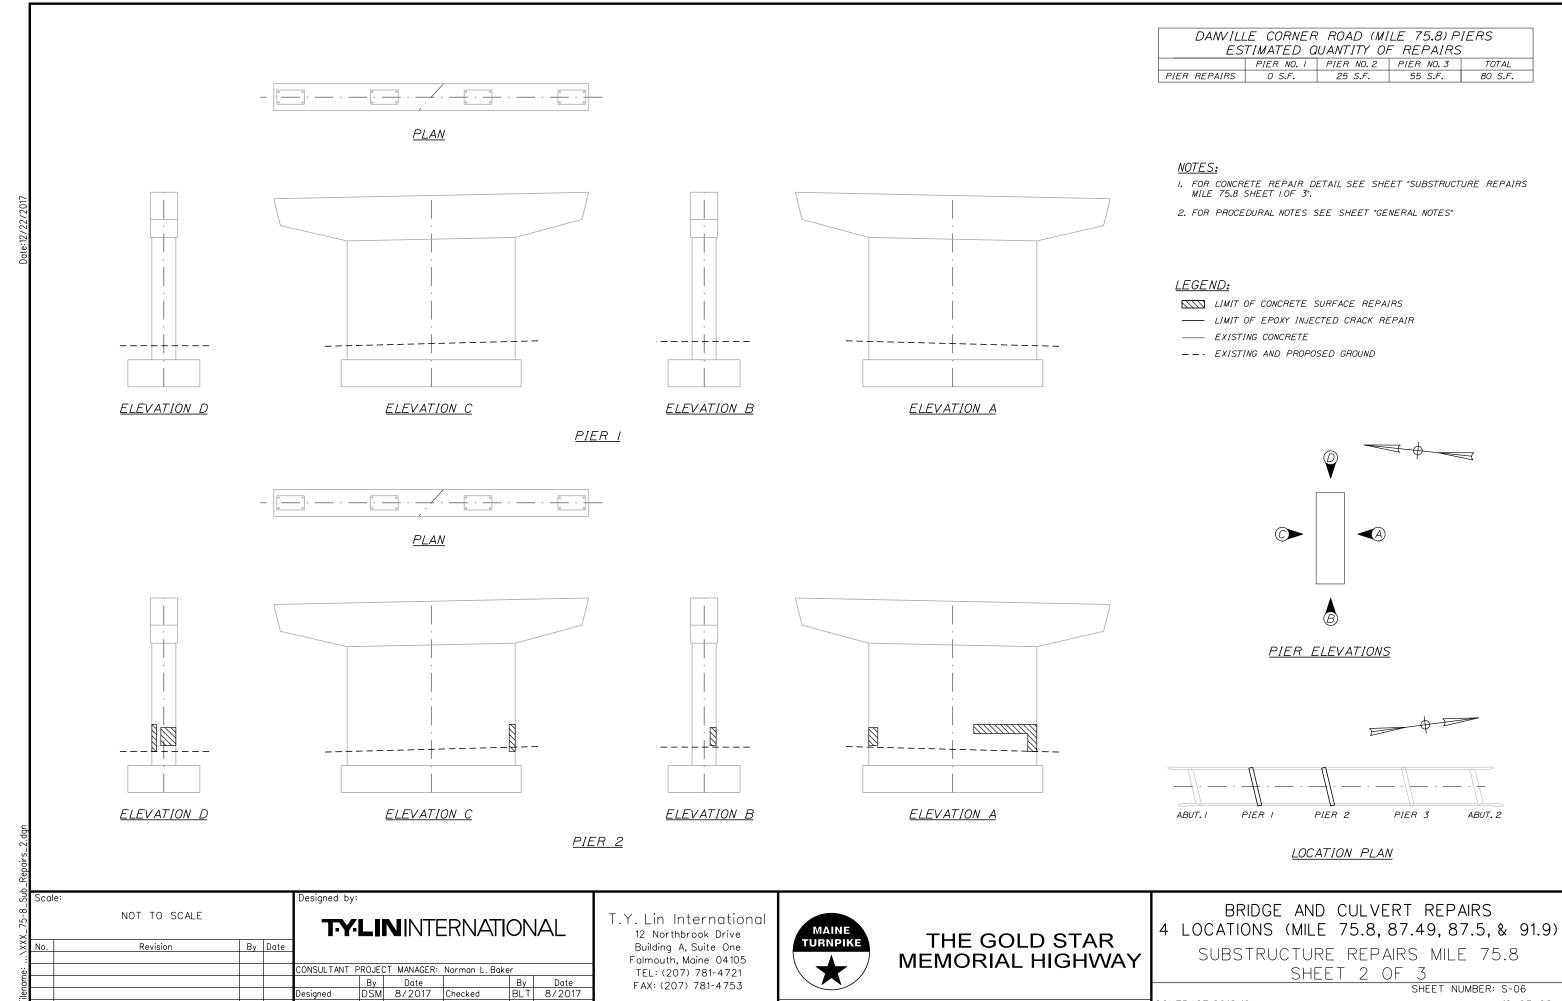


MTA PROJECT MANAGER: R. NORWOOD


SAM 8/2017 In Charge of DSM 11/2017


CONTRACT:2018.10 **19** OF 28



<u>PLAN</u>

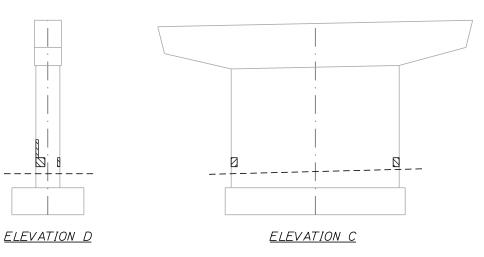

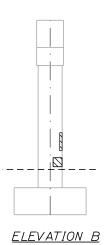

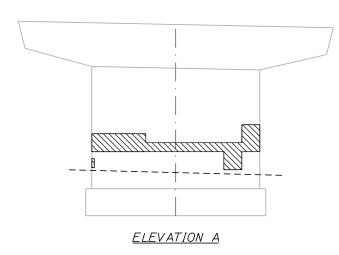

<u>PIER 3</u>

<u>NOTES:</u>

- I. FOR CONCRETE REPAIR DETAIL SEE SHEET "SUBSTRUCTURE REPAIRS MILE 75.8 SHEET FOR 3".
- 2. FOR PROCEDURAL NOTES SEE SHEET "GENERAL NOTES"


<u>LEGEND:</u>

LIMIT OF CONCRETE SURFACE REPAIRS


---- LIMIT OF EPOXY INJECTED CRACK REPAIR

---- EXISTING CONCRETE

--- EXISTING AND PROPOSED GROUND

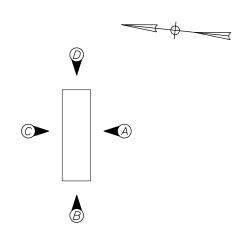

PIER ELEVATIONS

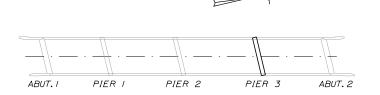

LOCATION PLAN

	Scal	le:				Designed by	:				
x_75-8_			NOT TO SCALE			T:Y:	LII	NINTE	ERNATI	ON	AL
·\XX	No.		Revision	Ву	Date						
: :						CONSULTANT	PROJEC	T MANAGER:	Norman L. Bak	er	
딍							Ву	Date		Ву	Date
llename:						Designed	DSM	8/2017	Checked	BLT	8/2017
-						Drawn	SAM	8/2017	In Charge of	DSM	11/2017

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Falmouth, Maine 04105
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FAX: (207) 781-4753



THE GOLD STAR MEMORIAL HIGHWAY

BRIDGE AND CULVERT REPAIRS
4 LOCATIONS (MILE 75.8, 87.49, 87.5, & 91.9)
SUBSTRUCTURE REPAIRS MILE 75.8

SUBSTRUCTURE REPAIRS MILE 75.8 SHEET 3 OF 3

SHEET NUMBER: S-07
20 OF 28


MTA PROJECT MANAGER: R. NORWOOD

CONTRACT:2018.10


ABUTMENT NO. I PLAN





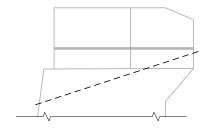

RIGHT WING ELEVATION

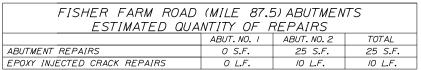


NOTES:

- I. FOR CONCRETE REPAIR DETAIL SEE SHEET "SUBSTRUCTURE REPAIRS MILE 87.5 SHEET 10F 3".
- 2. FOR PROCEDURAL NOTES SEE SHEET "GENERAL NOTES"


LEGEND:

LIMIT OF CONCRETE SURFACE REPAIRS


- --- LIMIT OF EPOXY INJECTED CRACK REPAIR
- ---- EXISTING CONCRETE
- --- EXISTING AND PROPOSED GROUND

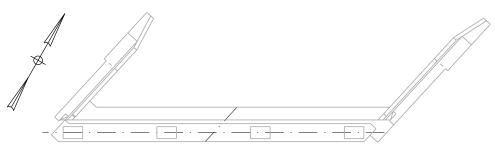


ABUTMENT NO. 2 PLAN

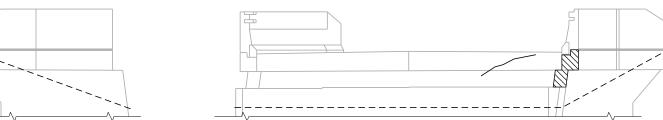

LEFT WING ELEVATION ABUTMENT NO. 2 ELEVATION

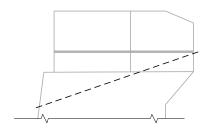

RIGHT WING ELEVATION

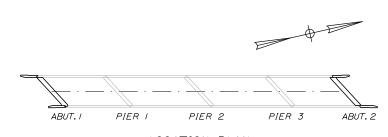

LOCATION PLAN

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5						Ву	Date		Ву	Date
ומווחוום					Designed	DSM	8/2017	Checked	BLT	9/2017
-					Drawn	SAM	8/2017	In Charge of	DSM	11/2017

Designed by:

T.Y. Lin International 12 Northbrook Drive Building A, Suite One Falmouth, Maine 04105 TEL: (207) 781-4721 FAX: (207) 781-4753



THE GOLD STAR MEMORIAL HIGHWAY

BRIDGE AND CULVERT REPAIRS 4 LOCATIONS (MILE 75.8, 87.49, 87.5, & 91.9)

SUBSTRUCTURE REPAIRS MILE 87.5 SHEET 1 OF 3


SHEET NUMBER: S-08

CONTRACT:2018.10

21 OF 28


<u>LEFT WING ELEVATION</u>

MTA PROJECT MANAGER: R. NORWOOD

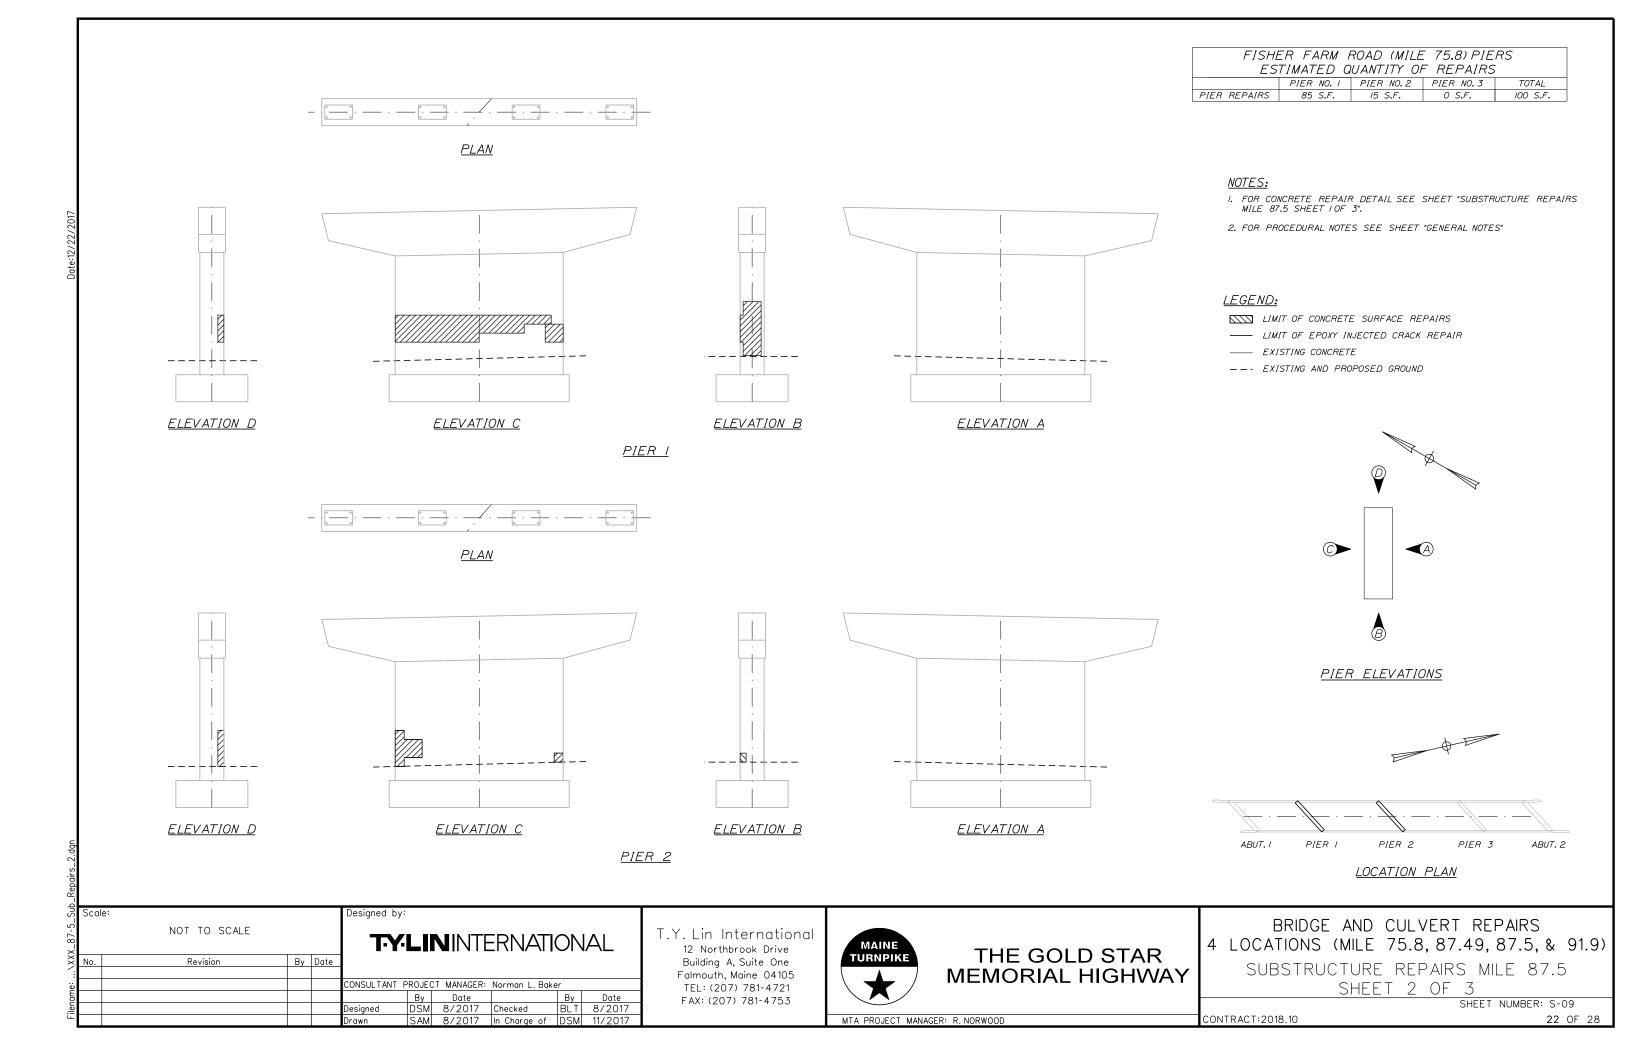





ELEVATION C

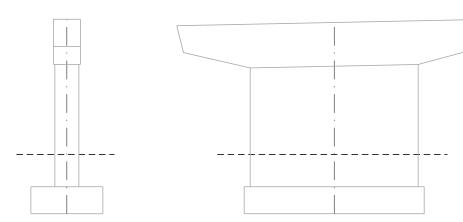

ELEVATION D

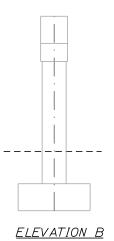

PIER 3

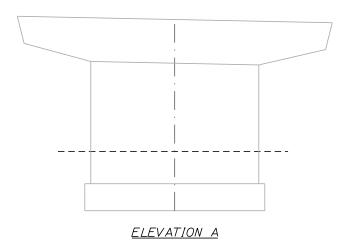


NOTES:


- I. FOR CONCRETE REPAIR DETAIL SEE SHEET "SUBSTRUCTURE REPAIRS MILE 87.5 SHEET FOR 3".
- 2. FOR PROCEDURAL NOTES SEE SHEET "GENERAL NOTES"

<u>LEGEND:</u>

- LIMIT OF CONCRETE SURFACE REPAIRS --- LIMIT OF EPOXY INJECTED CRACK REPAIR
- ---- EXISTING CONCRETE
- --- EXISTING AND PROPOSED GROUND

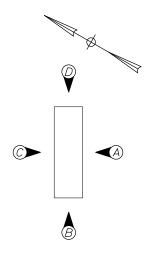

PIER ELEVATIONS

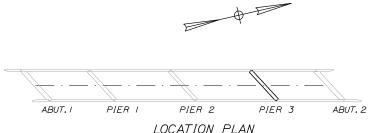

LOCATION PLAN

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į.					CONSULTANT	PROJEC	T MANAGER:	Norman L. Bak	er	
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1					Drawn	SAM	8/2017	In Charge of	DSM	11/2017

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THE GOLD STAR MEMORIAL HIGHWAY


BRIDGE AND CULVERT REPAIRS 4 LOCATIONS (MILE 75.8, 87.49, 87.5, & 91.9) SUBSTRUCTURE REPAIRS MILE 87.5


SHEET 3 OF 3

SHEET NUMBER: S-10

MTA PROJECT MANAGER: R. NORWOOD

CONTRACT:2018.10

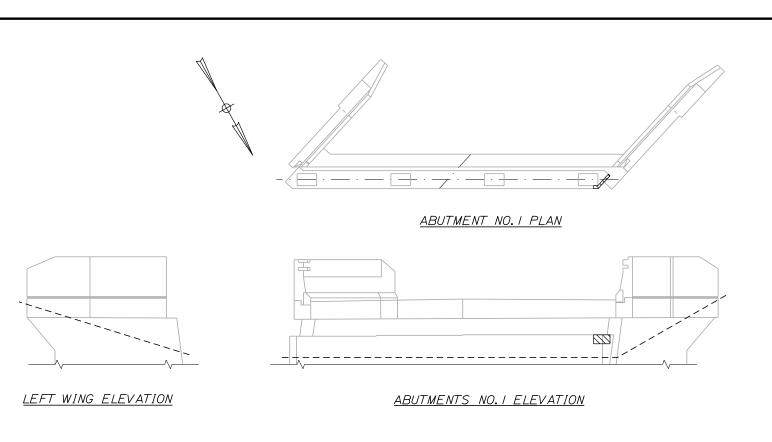

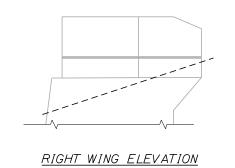

CENTER ROAD (MILE 91.9) ABUTMENTS ESTIMATED QUANTITY OF REPAIRS ABUT. NO. 1 ABUT. NO. 2 TOTAL ABUTMENT REPAIRS 5 S.F. 15 S.F. 20 S.F. EPOXY INJECTED CRACK REPAIRS 0 L.F. 5 L.F.


NOTES:

- FOR CONCRETE REPAIR DETAIL SEE SHEET "SUBSTRUCTURE REPAIRS MILE 91.9 SHEET LOF 3".
- 2. FOR PROCEDURAL NOTES SEE SHEET "GENERAL NOTES"


LEGEND:


LIMIT OF CONCRETE SURFACE REPAIRS


- ---- LIMIT OF EPOXY INJECTED CRACK REPAIR
- ---- EXISTING CONCRETE
- --- EXISTING AND PROPOSED GROUND

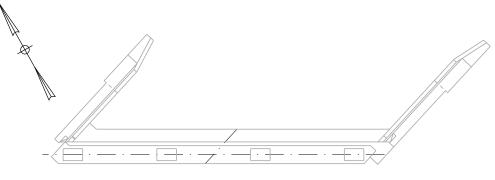


ABUTMENT NO. 2 PLAN

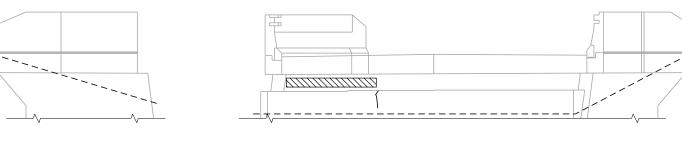

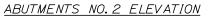

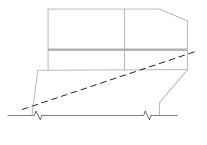

RIGHT WING ELEVATION

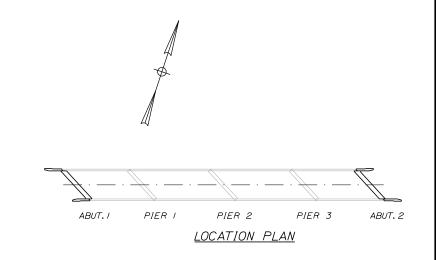

Sub	Scal	; :			Designed by:					
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ë					CONSULTANT PROJECT MANAGER: Norman L. Baker					
E						Ву	Date		Ву	Date
Filename:		·			Designed	DSM	8/2017	Checked	BLT	9/2017
ᄔ		·			Drawn	SAM	8/2017	In Charge of	DSM	11/2017

LEFT WING ELEVATION

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THE GOLD STAR MEMORIAL HIGHWAY


BRIDGE AND CULVERT REPAIRS
4 LOCATIONS (MILE 75.8, 87.49, 87.5, & 91.9)

SUBSTRUCTURE REPAIRS MILE 91.9 SHEET 1 OF 3

CONTRACT:2018.10

SHEET NUMBER: S-11

MTA PROJECT MANAGER: R. NORWOOD

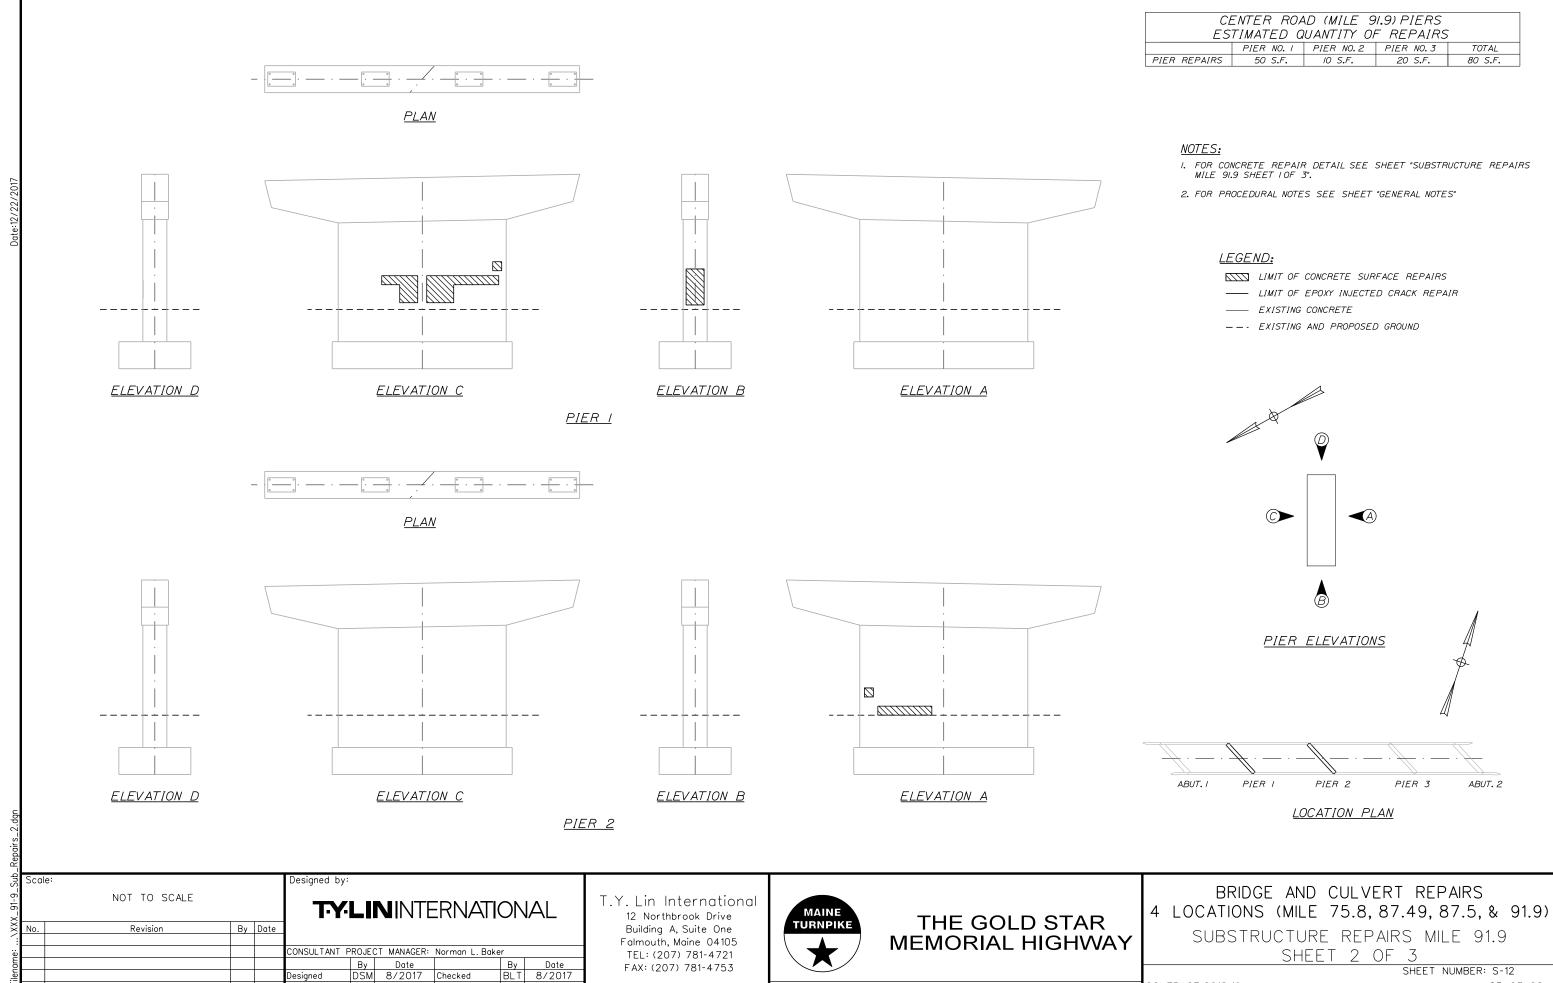

MTA PROJECT MANAGER: R. NORWOOD


SAM 8/2017 In Charge of DSM 11/2017


25 OF 28


CONTRACT:2018.10



<u>PLAN</u>

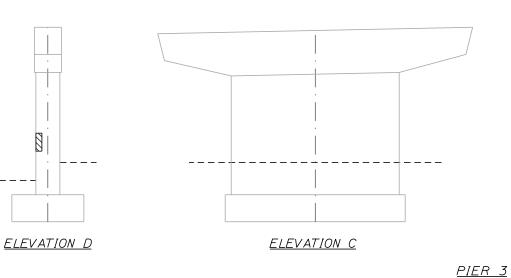

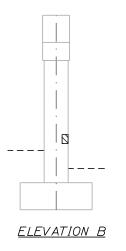

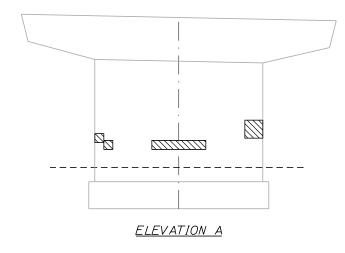


NOTES:

- I. FOR CONCRETE REPAIR DETAIL SEE SHEET "SUBSTRUCTURE REPAIRS MILE 91.9 SHEET 1 OF 3".
- 2. FOR PROCEDURAL NOTES SEE SHEET "GENERAL NOTES"

<u>LEGEND:</u>

- LIMIT OF CONCRETE SURFACE REPAIRS
- --- LIMIT OF EPOXY INJECTED CRACK REPAIR
- ---- EXISTING CONCRETE
- --- EXISTING AND PROPOSED GROUND

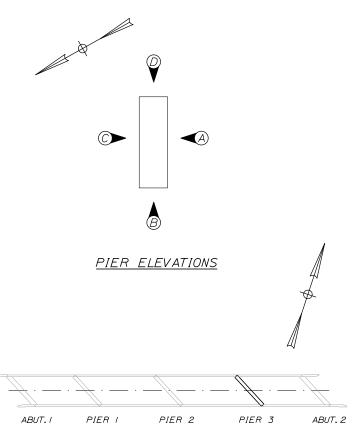

LOCATION PLAN

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						CONSULTANT	PROJEC	T MANAGER:	Norman L. Bake	er	
llename							Ву	Date		Ву	Date
le						Designed	DSM	8/2017	Checked	BLT	8/2017
-[Drawn	SAM	8/2017	In Charge of	DSM	11/2017

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THE GOLD STAR MEMORIAL HIGHWAY


BRIDGE AND CULVERT REPAIRS
4 LOCATIONS (MILE 75.8, 87.49, 87.5, & 91.9)


SUBSTRUCTURE REPAIRS MILE 91.9 SHEET 3 OF 3


SHEET NUMBER: S-13 26 OF 28

MTA PROJECT MANAGER: R. NORWOOD


CONTRACT:2018.10 2

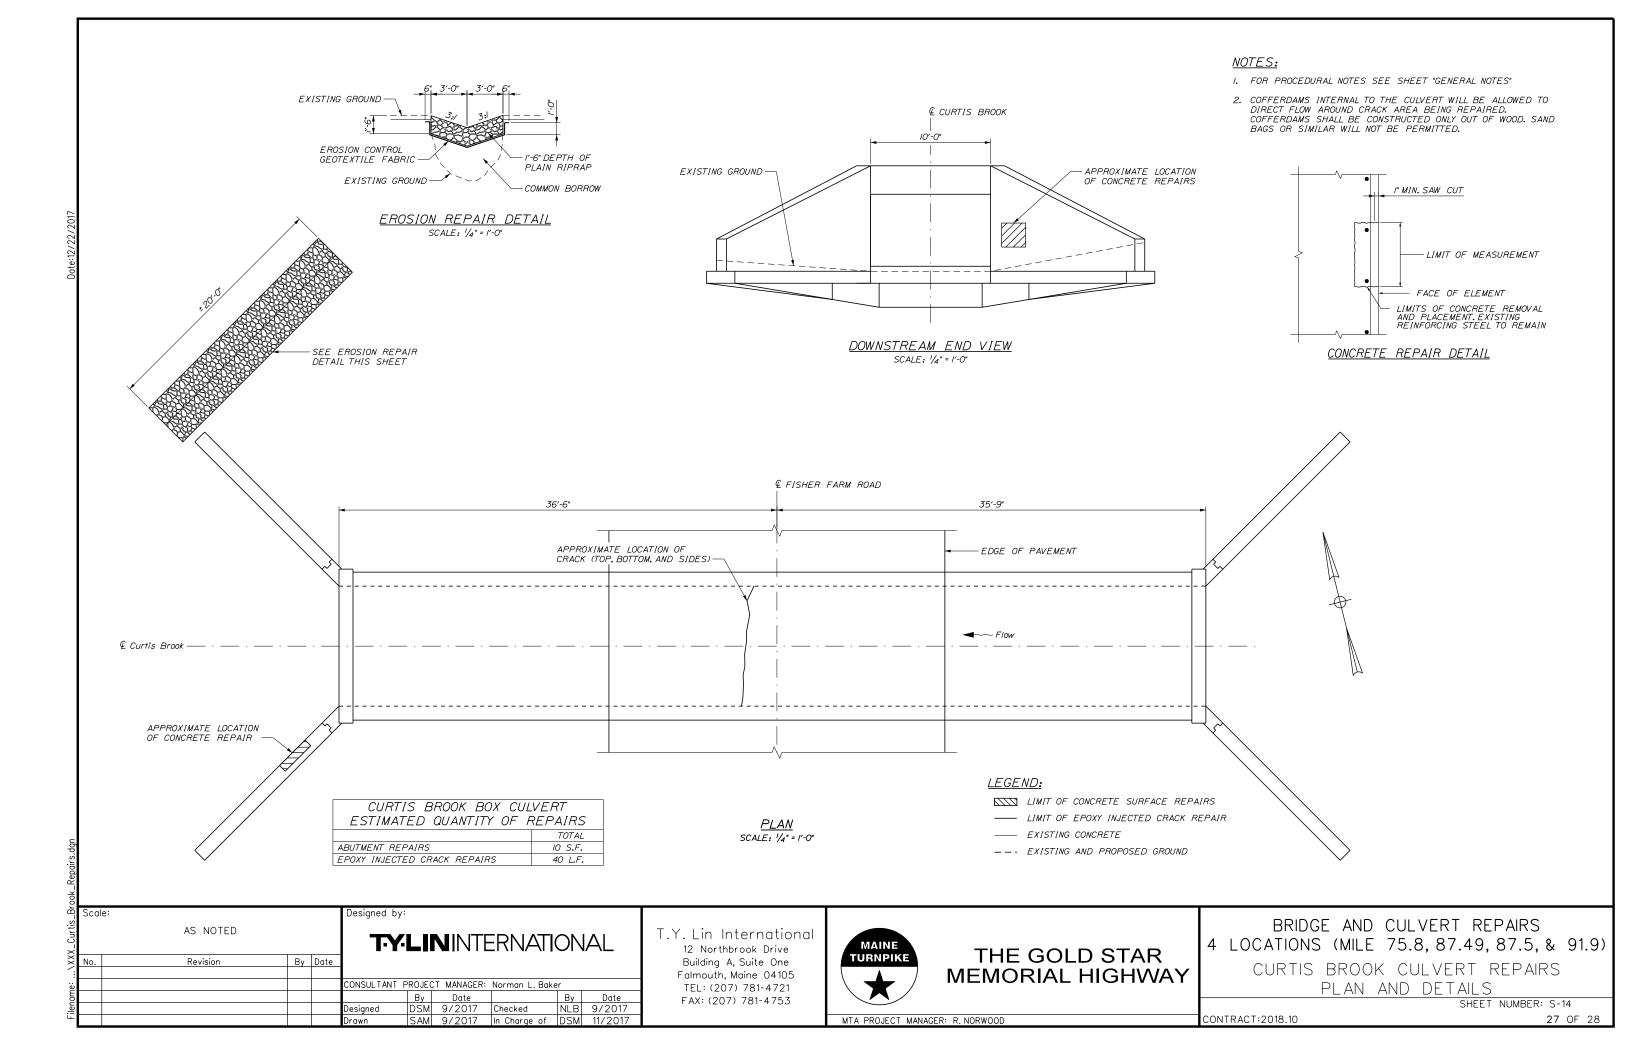

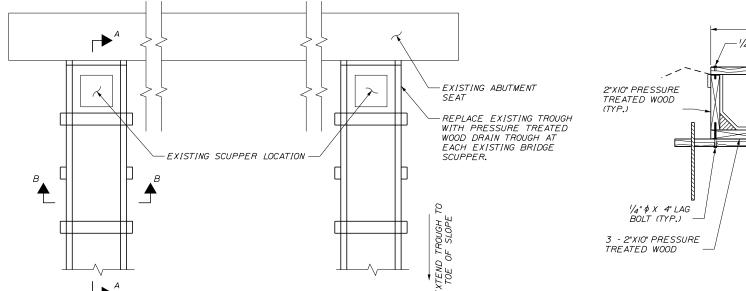

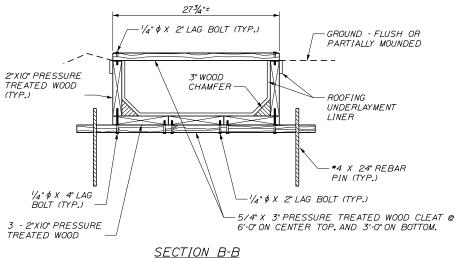

LOCATION OF DRAIN TROUGH WORK TABLE									
LOCATION	ABUTMENT I	ABUTMENT 2							
DANVILLE CORNER ROAD (MILE 75.8)	REMOVE & REGRADE SLOPE (NOTE 6)	REPAIR EXISTING (NOTE 7)							
FISHER FARM ROAD (MILE 87.5)	REMOVE & REPLACE (NOTES 1-5)	REMOVE & REGRADE SLOPE (NOTE 6)							
CENTER ROAD (MILE 91.9)	REMOVE & REGRADE SLOPE (NOTE 6)	REPAIR EXISTING (NOTE 7)							

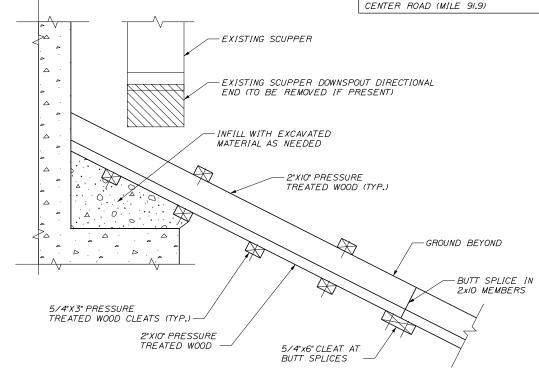

SECTION A-A

By Date

Designed by:

Date

9/2017

Scale:

NOT TO SCALE

Revision

TROUGH PLAN VIEW

TY-LININTERNATIONAL SAM 9/2017 In Charge of DSM 11/2017

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THE GOLD STAR **MEMORIAL HIGHWAY**


BRIDGE AND CULVERT REPAIRS 4 LOCATIONS (MILE 75.8, 87.49, 87.5, & 91.9)

SHEET NUMBER: S-15

CONTRACT:2018.10


TROUGH NOTES:

- WOOD DRAIN TROUGH AND ROOFING UNDERLAYMENT LINER SHALL BE PAID UNDER ITEM 603.91, "PRESSURE TREATED WOOD DRAIN TROUGH."
- 2. REMOVAL SHALL BE PAID UNDER ITEM 202.191, "REMOVING EXISTING DRAIN TROUGHS".
- 3. MECHANICALLY ATTACH WOOD DOWNSPOUT TO ABUTMENT WITH TWO ¾" \$\phi X6" BOLTS INTO DROP IN ANCHORS.
- 4. BUTT SPLICE 2"XIO" PRESSURE TREATED WOOD MEMBERS AT CLEATS (PROVIDE 5/4"X6" CLEATS AT BUTT SPLICES); OR USE 2"XIO"XI6" PRESSURE TREATED WOOD SPLICE BOARDS, SPIKE WITH 10-P GALVANIZED NAILS OR SCREWS.
- 5. INSTALL ROOFING UNDERLAYENT (ICE AND WATER SHIELD) LINER AND SECURE WITH GALVANIZED ROOFING NAILS PRIOR TO INSTALLING TOP CLEATS.
- 6. AT LOCATIONS SPECIFIED, NO REPLACEMENT TROUGH SHALL BE INSTALLED. REGRADE EXISTING SLOPE AS DIRECTED BY THE RESIDENT. PAYMENT SHALL BE INCIDENTAL TO ITEM 202.191, REMOVING EXISTING DRAIN TROUGHS.
- 7. AT LOCATIONS SPECIFIED, THE EXISTING PRECAST CONCRETE DRAIN TROUGH SHALL REMAIN, RESEAL JOINTS AS DIRECTED BY THE RESIDENT. PAYMENT SHALL BE INCIDENTAL TO THE CONTRACT.
- 8. DISTURBED SLOPES BENEATH THE BRIDGE THAT ARE UNLIKELY TO GROW SIGNIFICANT VEGETATION DUE TO SHADE SHALL BE COVERED WITH EROSION CONTROL MIX AS DIRECTED BY THE RESIDENT.

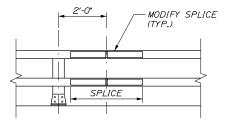

SPLICE MODIFICATION RAILING - ELEVATION

SCALE: 1/2" = 1'-0" (TWO BAR RAILING SHOWN. THREE BAR RAILING SIMILAR)

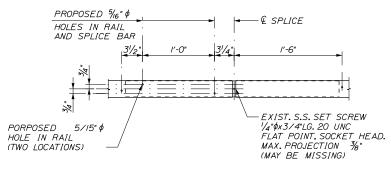

SPLICE MODIFICATION DETAIL

SCALE: 11/2" = 1'-0" (ELEVATION VIEW FROM BACK SIDE OF RAIL)

TYPICAL DETAILS

28 OF 28

ONSULTANT PROJECT MANAGER: Norman L. Baker Checked NLB 9/2017

MTA PROJECT MANAGER: R. NORWOOD