**INDEX OF SHEETS** 

**HIGHWAY** 

DESCRIPTION

SHEET NO.

THE GOLD STAR **MEMORIAL HIGHWAY** 

# MAINE TURNPIKE AUTHORITY

DANIEL E. WATHEN, CHAIR ROBERT D. STONE, VICE CHAIR MICHAEL J. CIANCHETTE, MEMBER ANN R. ROBINSON, MEMBER THOMAS J. ZUKE, MEMBER BRUCE A. VAN NOTE, MEMBER EX-OFFICIO

S. PETER MILLS, EXECUTIVE DIRECTOR

EXIT 44 BUILDING RENOVATION

**CONTRACT 2019.16** 

**EXIT 44 BUILDING RENOVATION** MM 44.3

# Stantec

SHEET 2 SHEETS 9-11


11/14/19 CHRIS PIIK, P.E. DATE STANTEC DAVID M. GLENNON 11/14/19 DAVID GLENNON, P.E. DATE STANTEC MICHAEL F. No. 1724

Nichael F. Have

CHRISTOPHER

**GRANT HAYS** 

MICHAEL F. HAYS, R.A. - PRINCIPAL

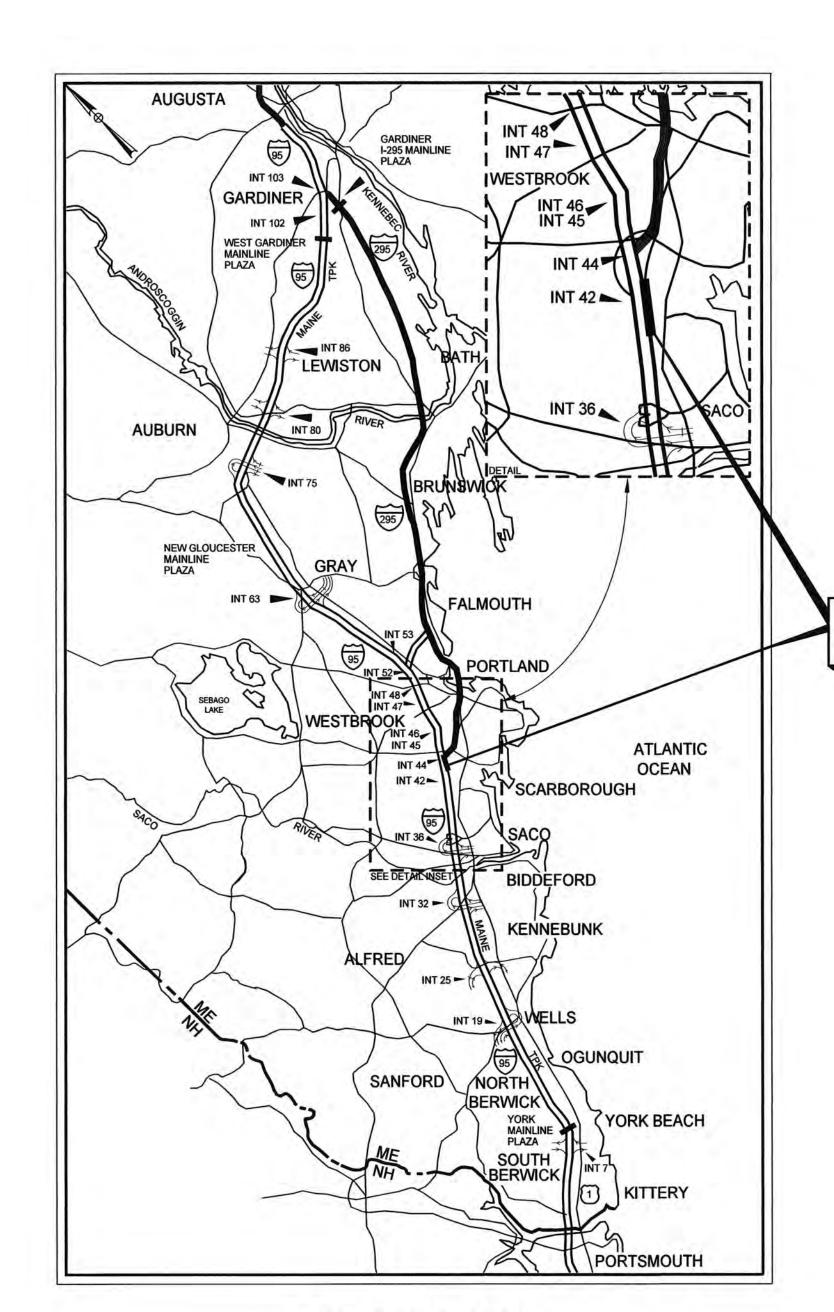

**LOCATION MAP** 

APPROVED:

MAINE TURNPIKE AUTHORITY


PETER S. MERFELD, P.E. - CHIEF OPERATIONS OFFICER


# GRANT HAY/


ASSOCIATES

SHEETS 3-5

11/14/19 DATE

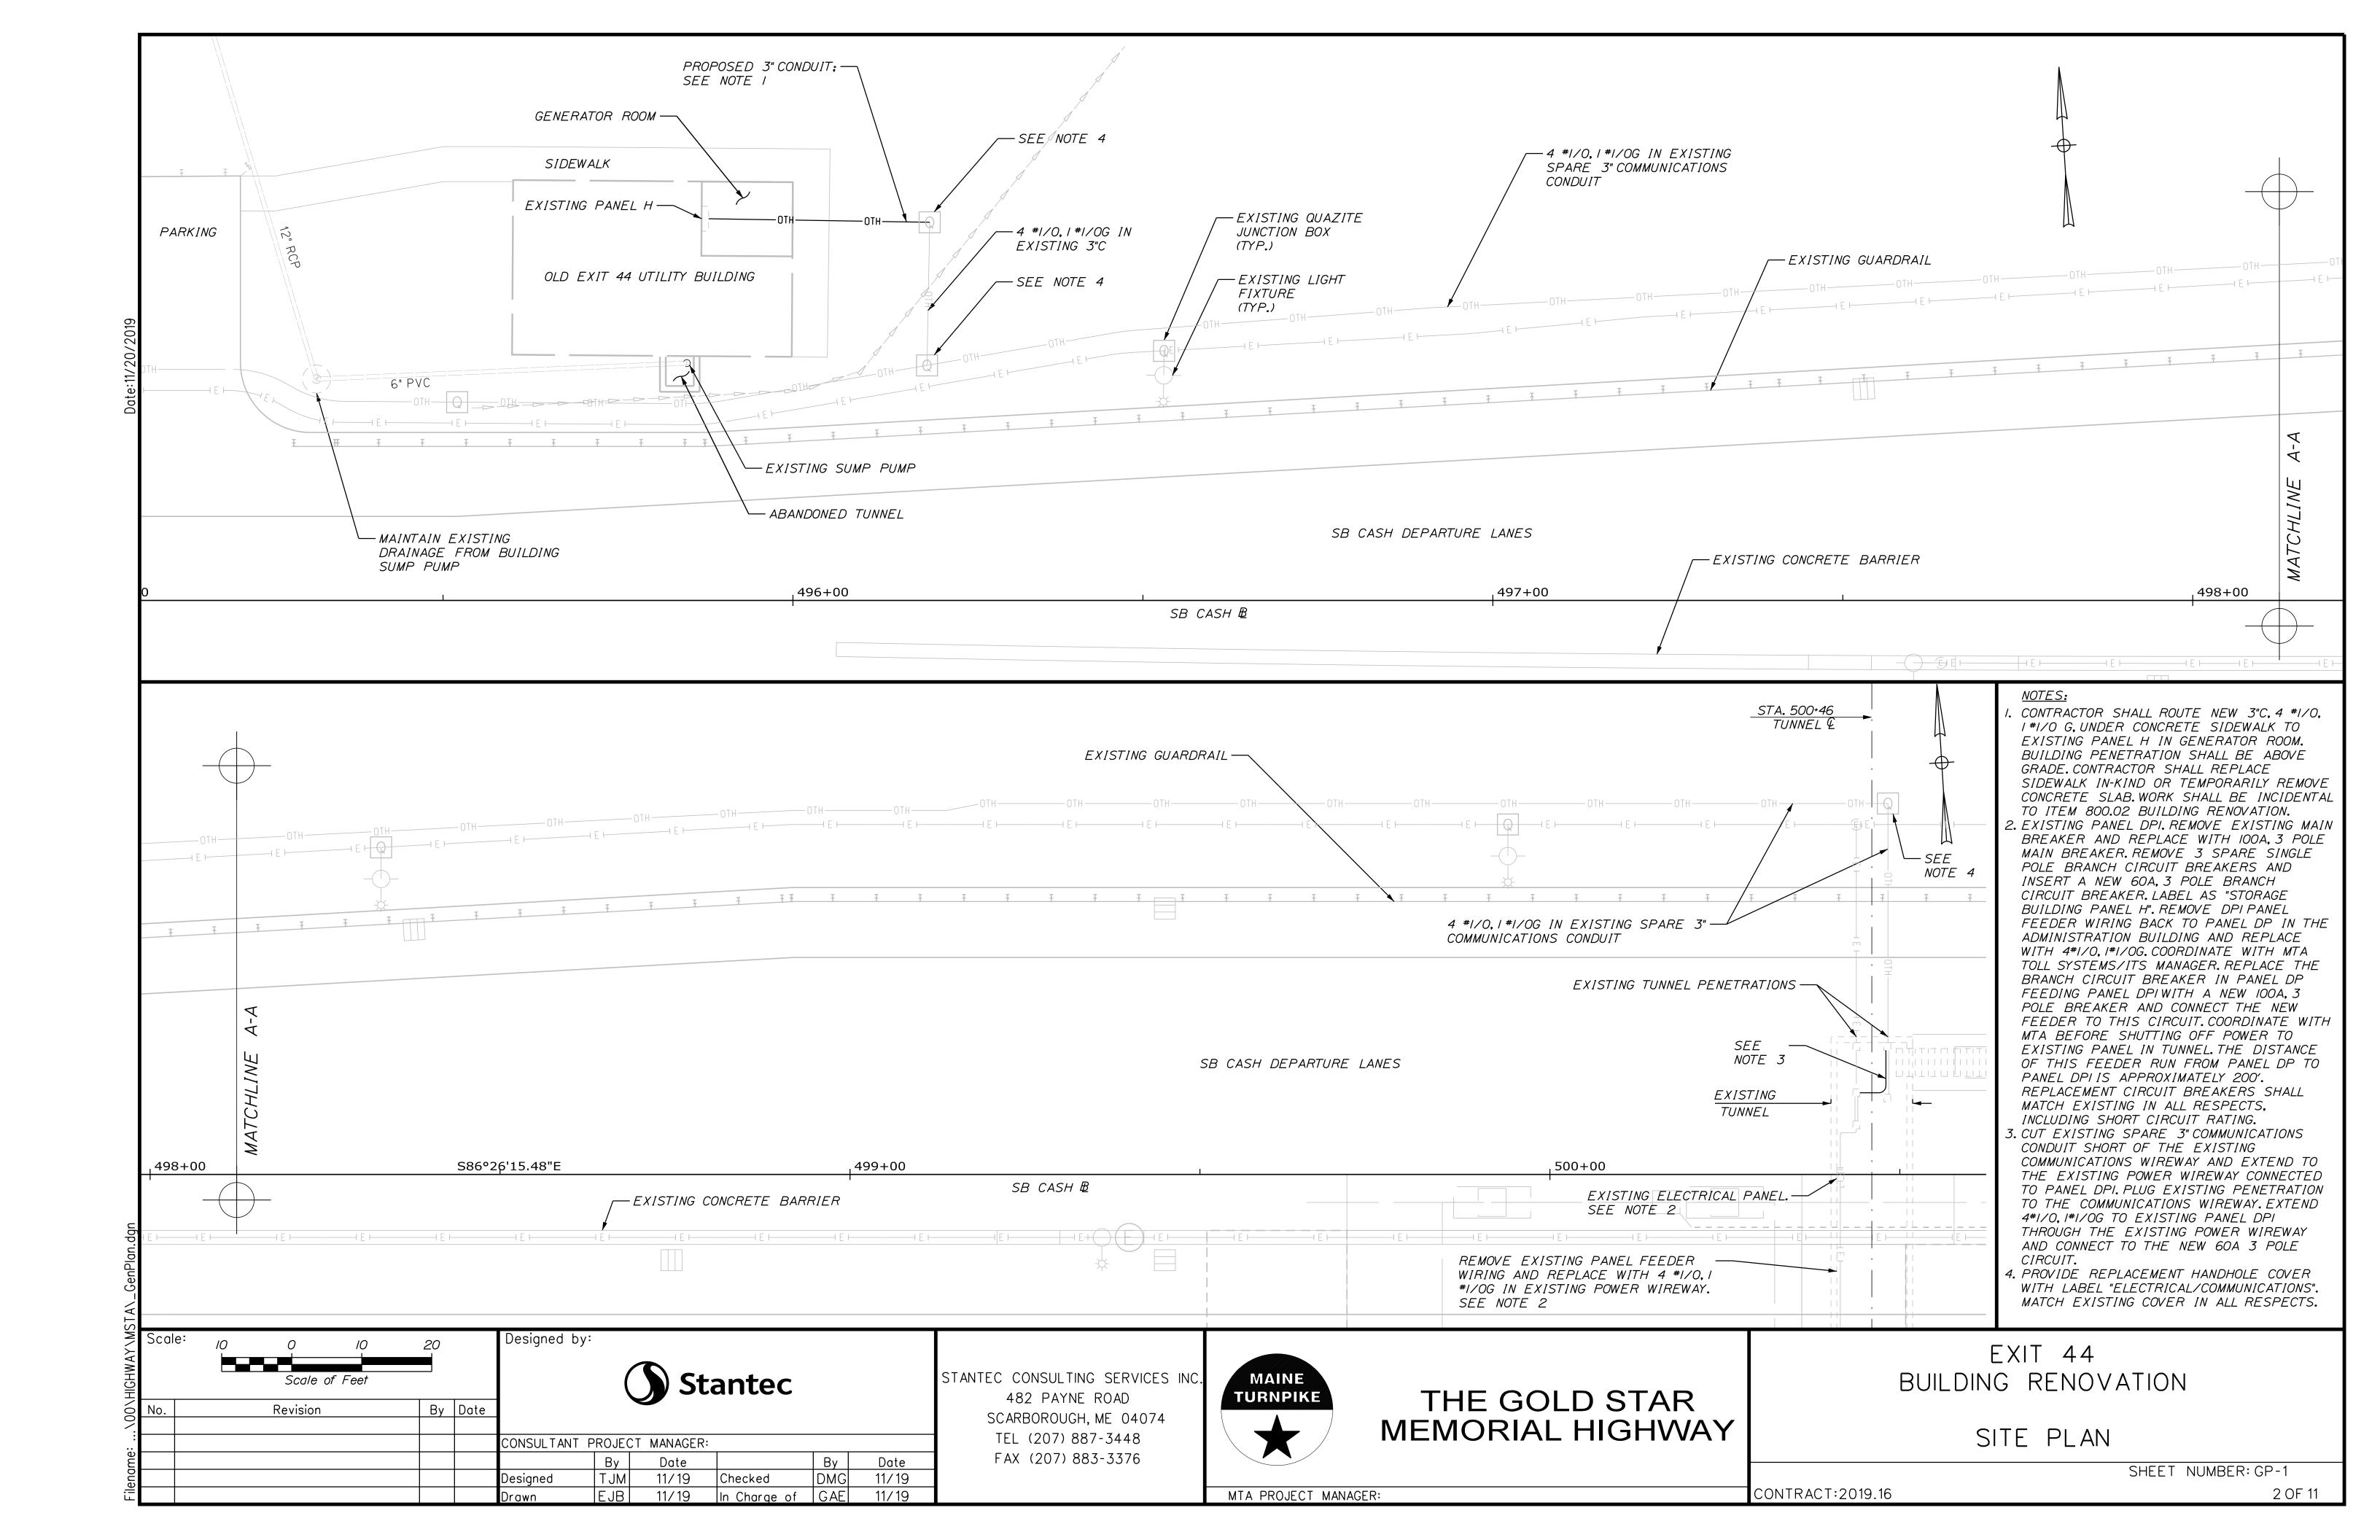

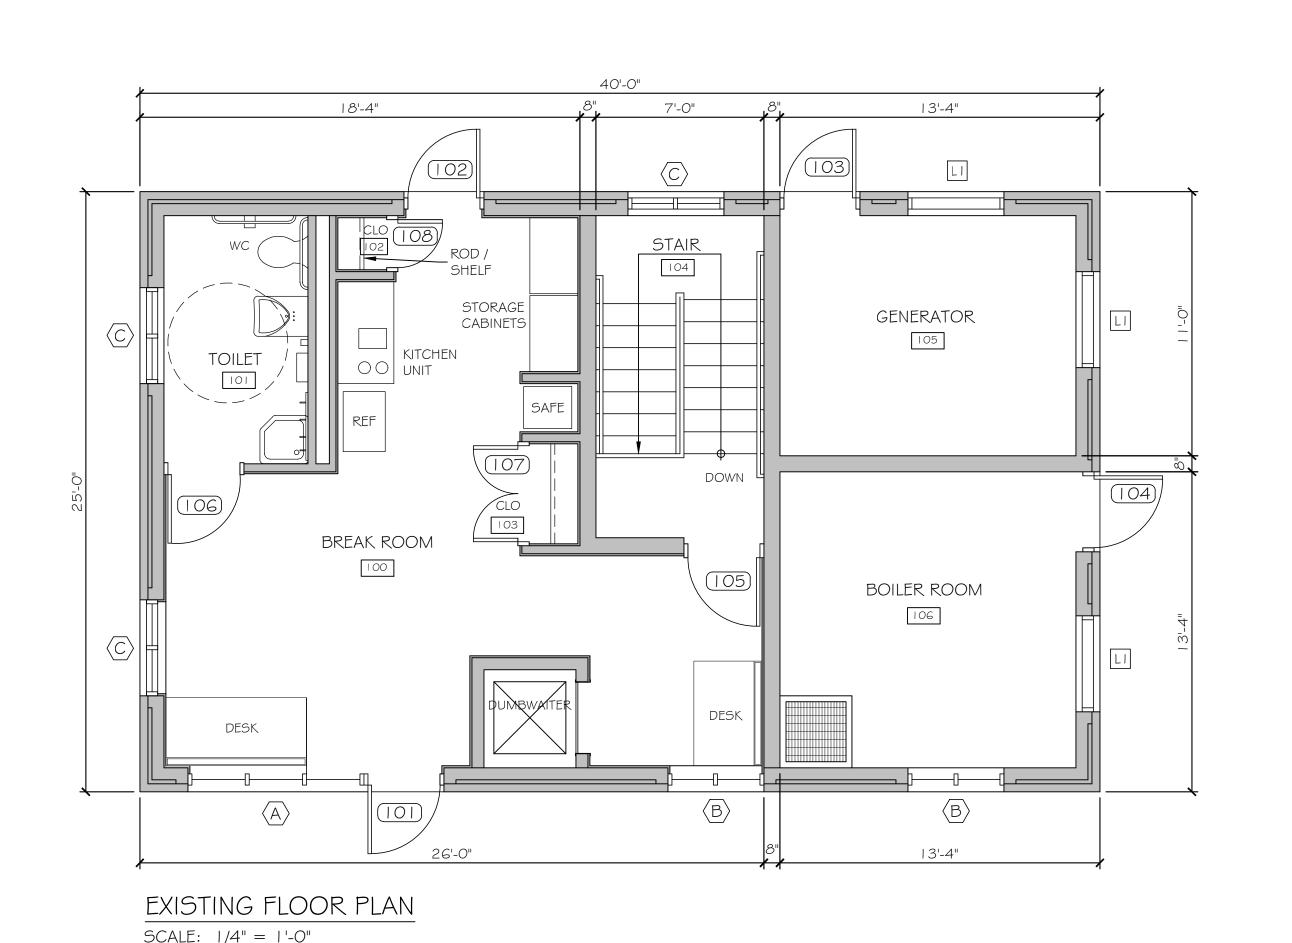

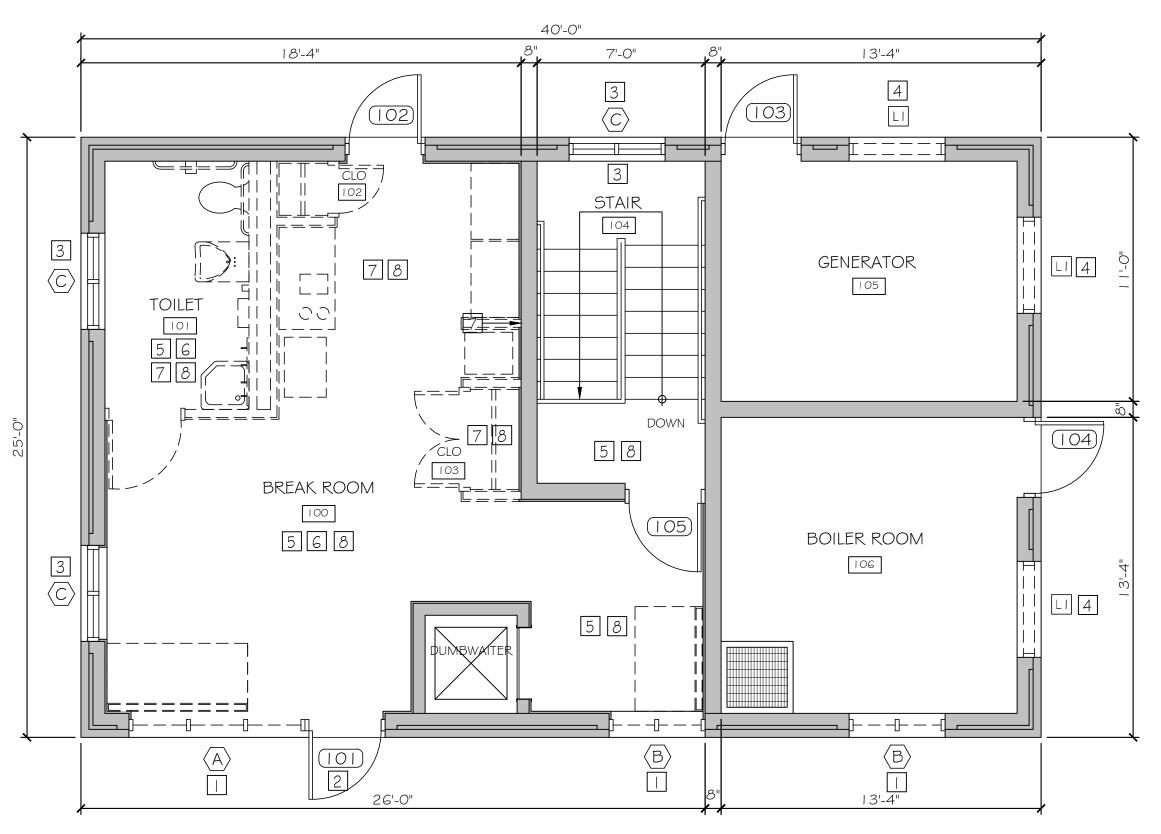

By

11/14/19

11/14/19

MFH

MGK

DEMOLITION FLOOR PLAN SCALE: 1/4" = 1'-0"

NEW WORK NOTES LEGEND


INSTALL PRIVACY FILM AT INSIDE FACE OF EXISTING GLASS (WINDOWS / DOORS).

2 INSTALL INSULATED METAL PANEL AT EXISTING WINDOWS AND DOORS.

3 INSTALL INFILL WALLS AT ALL REMOVED LOUVER MASONRY OPENINGS.

PATCH ALL VOIDS AT ENTIRE FIRE RATED SHEETROCK CEILING WITH UL FIRE RATED PENETRATION ASSEMBLIES AT EXISTING I HOUR RATED SHEETROCK / ROOF TRUSS ASSEMBLY.

5 INSTALL NEW FIRE EXTINGUISHER W/ BRACKET.

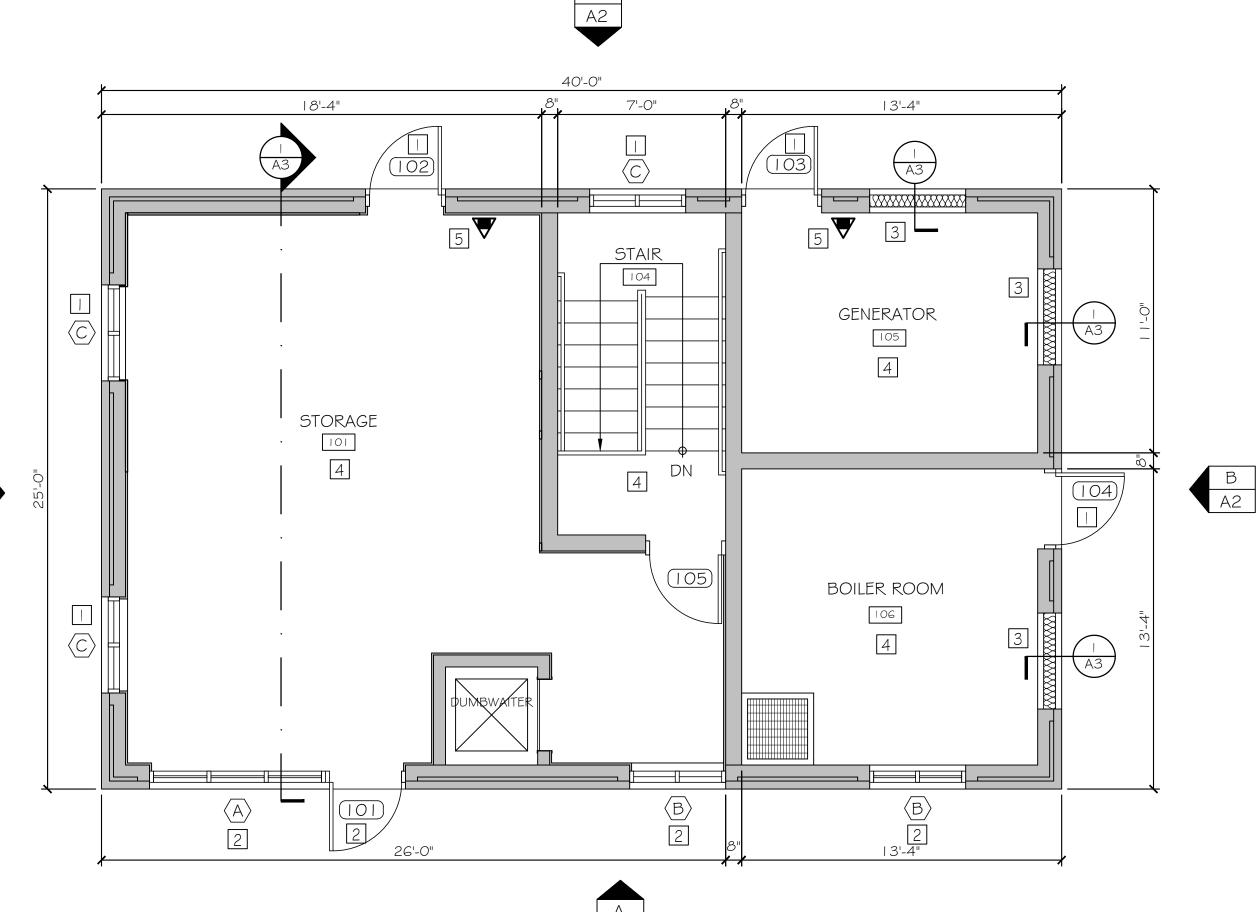

NEW WORK FLOOR PLAN

SCALE: 1/4" = 1'-0"

# DEMOLITION NOTES LEGEND

D A2

- REMOVE EXISTING INSULATED GLASS \$ WINDOW TREATMENT. INSTALL NEW INSULATED PANELS.
- REMOVE EXISTING INSULATED GLASS AND EXTERIOR HARDWARE. INSTALL NEW INSULATED PANELS. INSTALL BLANK PLATES AT REMOVED HARDWARE.
- REMOVE EXISTING WINDOW TREATMENT. INSTALL WINDOW FILM AT EXISTING GLASS.
- REMOVE EXISTING LOUVER. PREPARE OPENING FOR NEW INFILL PANEL; SEE PLAN.
- REMOVE EXISTING SUSPENDED CEILING IN ITS ENTIRETY. PATCH I HR FIRE RATED GWB CEILING AT UNDERSIDE OF ROOF TRUSSES AS REQUIRED FOR NEW I HR FIRE RATING CONTINUITY.
- REMOVE ALL FIXTURES, ACCESSORIES, SHELVING, RODS AND RELATED APPURTENANCES. PATCH REMAINING FINISHES TO MATCH ADJACENT PARTITION MATERIAL.
- REMOVE PARTITIONS, DOORS, FRAMES AND RELATED BRACING. PATCH REMAINING SURFACES TO MATCH EXISTING ADJACENT MATERIAL.
- REMOVE OFFICE FURNITURE, APPLIANCES, EQUIPMENT, SAFE, CABINETS, COUNTERS, AND ALL PRE-DEMOLITION DEBRIS AT ENTIRE FIRST FLOOR OF BUILDING.

## CODE ANALYSIS

NFPA 101 LIFE SAFETY CODE - 2015 Edition

Building Classification: Storage (1,000 sf) Construction Type: Hazard Classification: Ordinary Hazard Storage - Not applicable Occupant Loads: Mınımum Headroom: 7'-6" at occupied areas

Building Uses

Max. Allowable Travel Distance: Max. Allowable Common Path: Max. Dead End Corridor Length: Minimum Egress Corridor Width: Minimum Number of Required Exits Mınımum Egress Door Width:

Portable Fire Extinguishers:

Exit Lighting: Emergency Lighting: Fire Alarm/ Detection System: Fire Sprinkler System:

Not Required Not Required Not Required Required

2015 INTERNATIONAL BUILDING CODE

Use Group Classification: Storage (S-1) 1,000 sf Occupant Loads: 300 sf/occupant @ Storage = 4 occupants

Building Limitations
Construction Type: Maximum Height:

Maximum Area / Floor:

40' / I Story above grade plane

Fire Resistance Ratings Structural Frame Load Bearing Exterior Walls: None Load Bearing Interior Walls:

None Mechanical Rooms: l hour Exit Corridors: I hour Roof/Floor Structure None Minimum Number of Exits: I - less than 30 occupants

Maxımum Exit Travel Distance: Maxımum Common Travel Path: Mınımum Corridor Width:

Maximum Dead End Corridor Length: 20' 100' - under 30 occupants Not Required

Fire Alarm/Detection System: Fire Sprinkler System: Portable Fire Extinguishers: Exit Lights Emergency Lighting Building Live Loads
Storage:
Corridors:

Required Required 125 psf

80 psf


End of Analysis

Not Required

Required

Scale:	Designed by:

Michael F. Hays, RA By Date Revision No. Designed: Drawn:

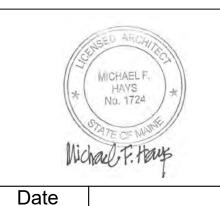

Checked:

Date

11/14/19

MFH

<del>-</del> GRANT HAY ASSOCIATES ARCHITECTURE & INTERIOR DE/IGN P.O. BOX 6179 FALMOUTH MAINE 04105 207.871.5900 www.granthays.com

MAINE

THE GOLD STAR MEMORIAL HIGHWAY


# EXIT 44 **BUILDING RENOVATION** EXISTING CONDITIONS/DEMOLITION PLANS

SHEET NUMBER: A-1

10

MTA PROJECT MANAGER: RALPH NORWOOD, IV, PE, PTOE


CONTRACT: 2019.16

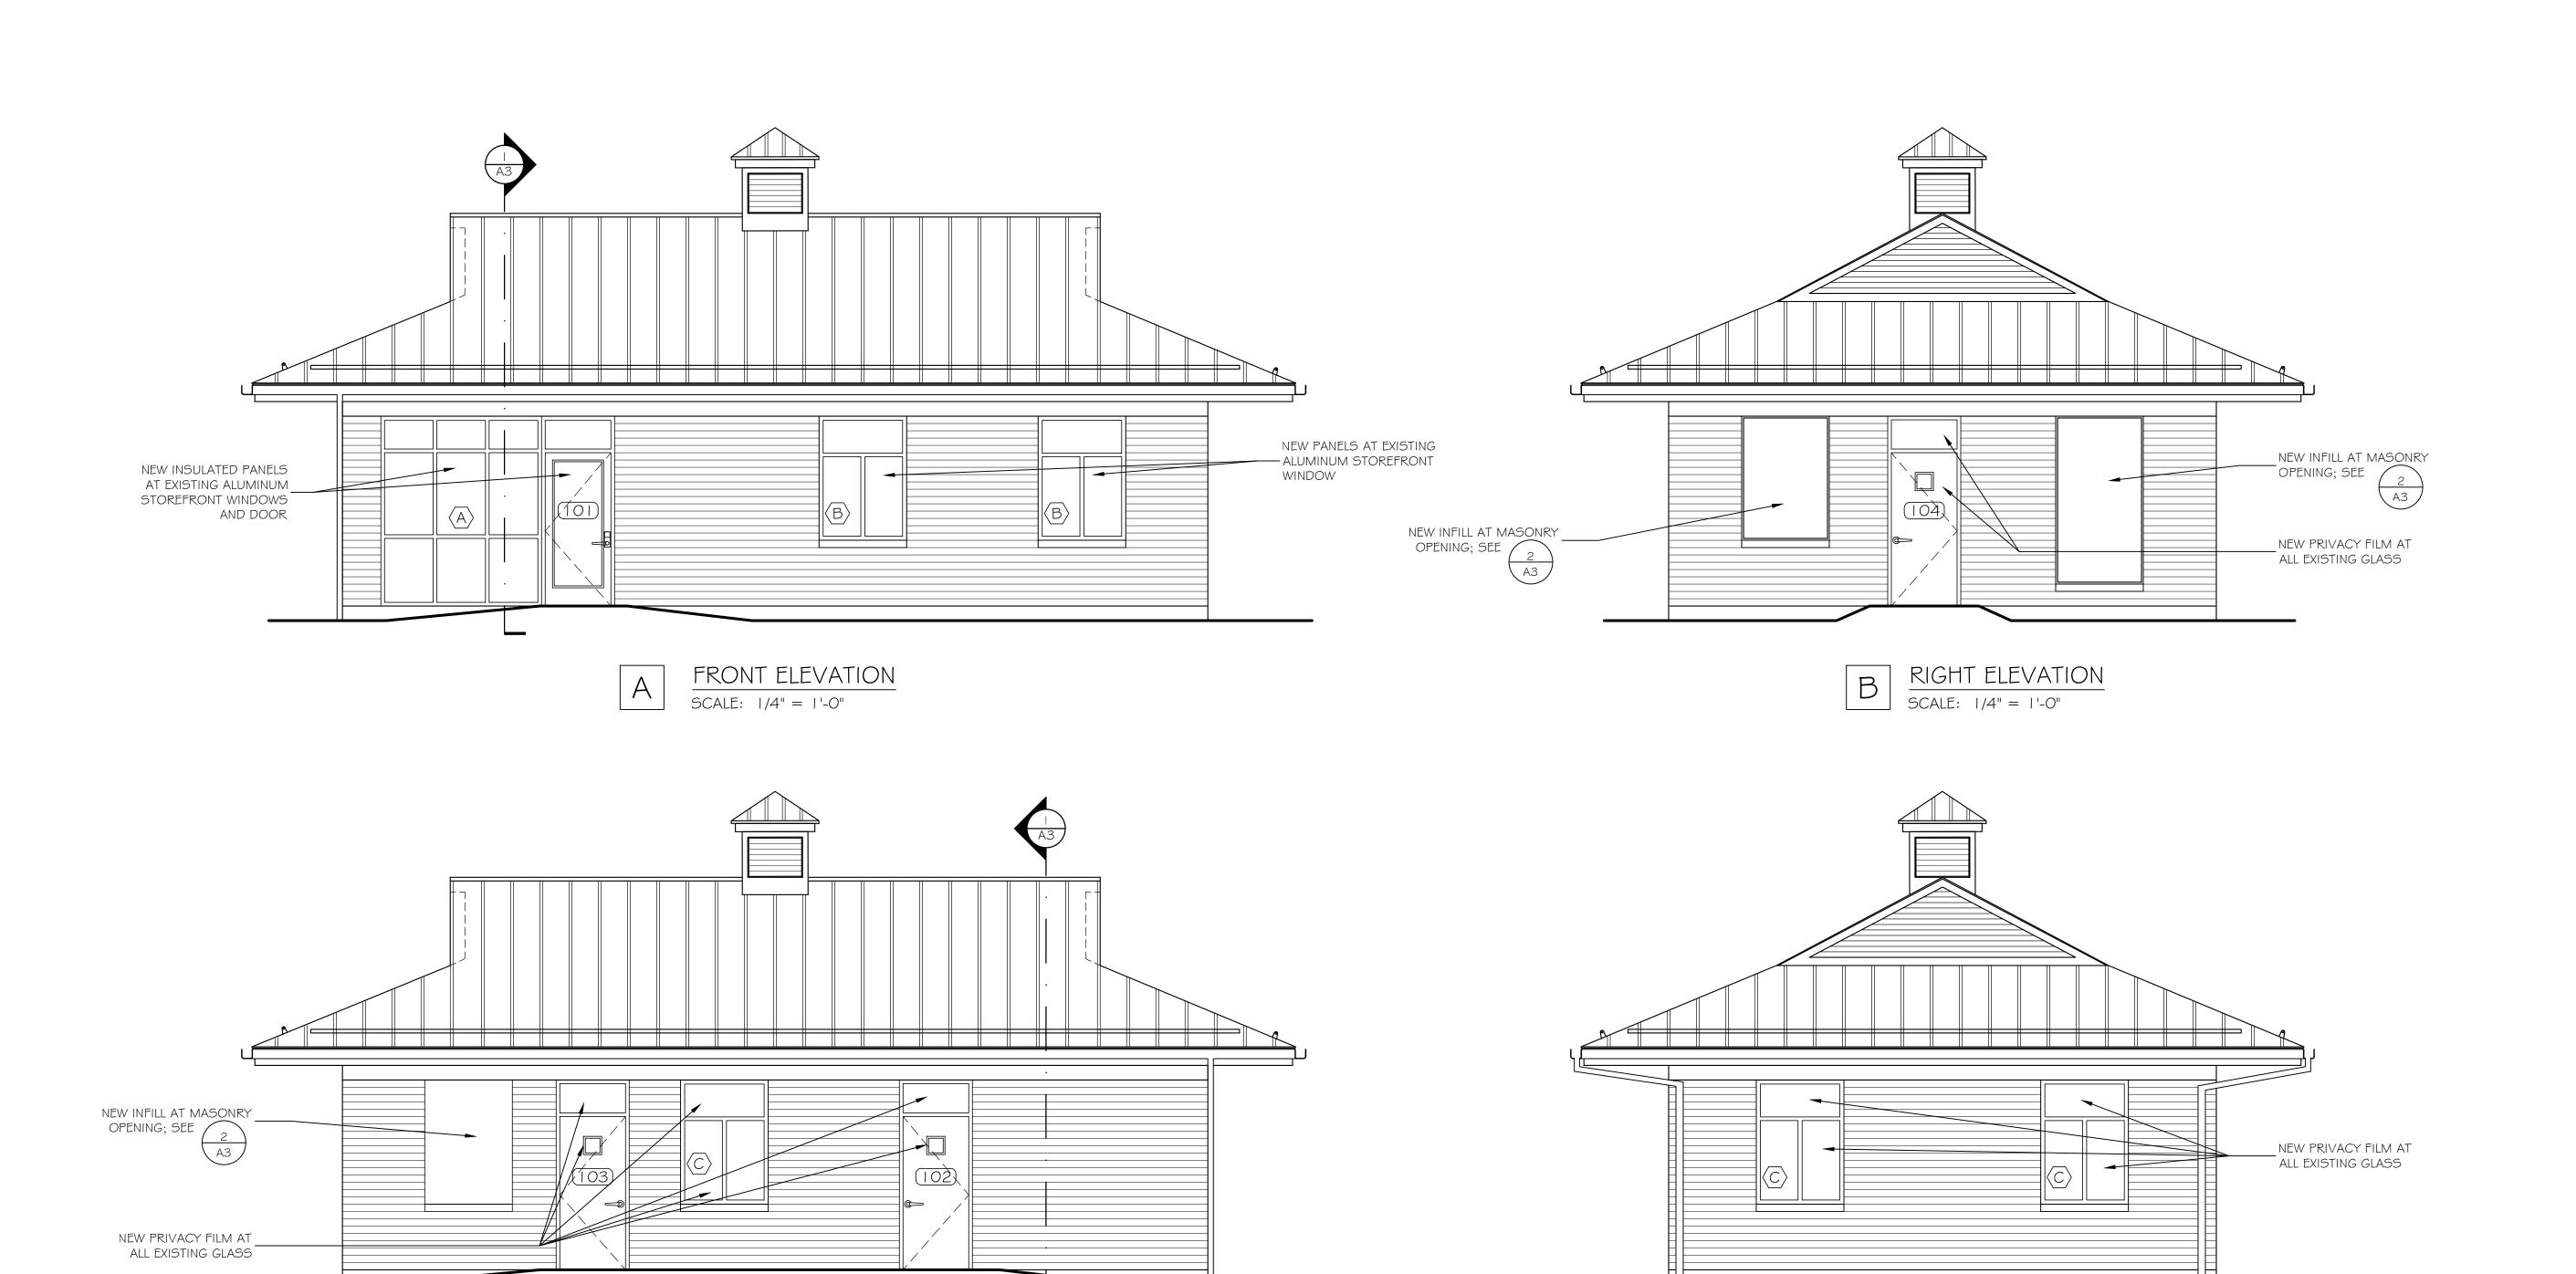


REAR ELEVATION

D LEFT ELEVATION


Scale:  A No. Revision		esigned by: ⁄lichael F. Hays		MICHAEL F. HAYS NO. 1724  WICHAEL F. HAYS NO. 1724  WICHAEL F. HAWS			GRANT HAY/ A//OCIATE/	MAINE TURNPIKE		OLD STAR AL HIGHWAY			BUILDING F	T 44 ENOVATION ELEVATIONS		
			By Date		By	Date	ARCHITECTURE & INTERIOR DE/IGN P.O. BOX 6179 FALMOUTH MAINE 04105							OUEET	NII IMPED:	
	De	esigned: M	FH 11/14/19	Checked:	MFH	11/14/19	207.871.5900 <u>www.granthays.com</u>							SHEET	NUMBER: A-2	
	Dr	rawn:	GK 11/14/19	)				MTA PROJE	CT MANAGER: RALP	H NORWOOD, IV, PE, PTOE	CONTRA	CT: <sub>2019.16</sub>			4 OF	11
1	2	1	3		<u> </u>	4	5	6		7	8		9	10		

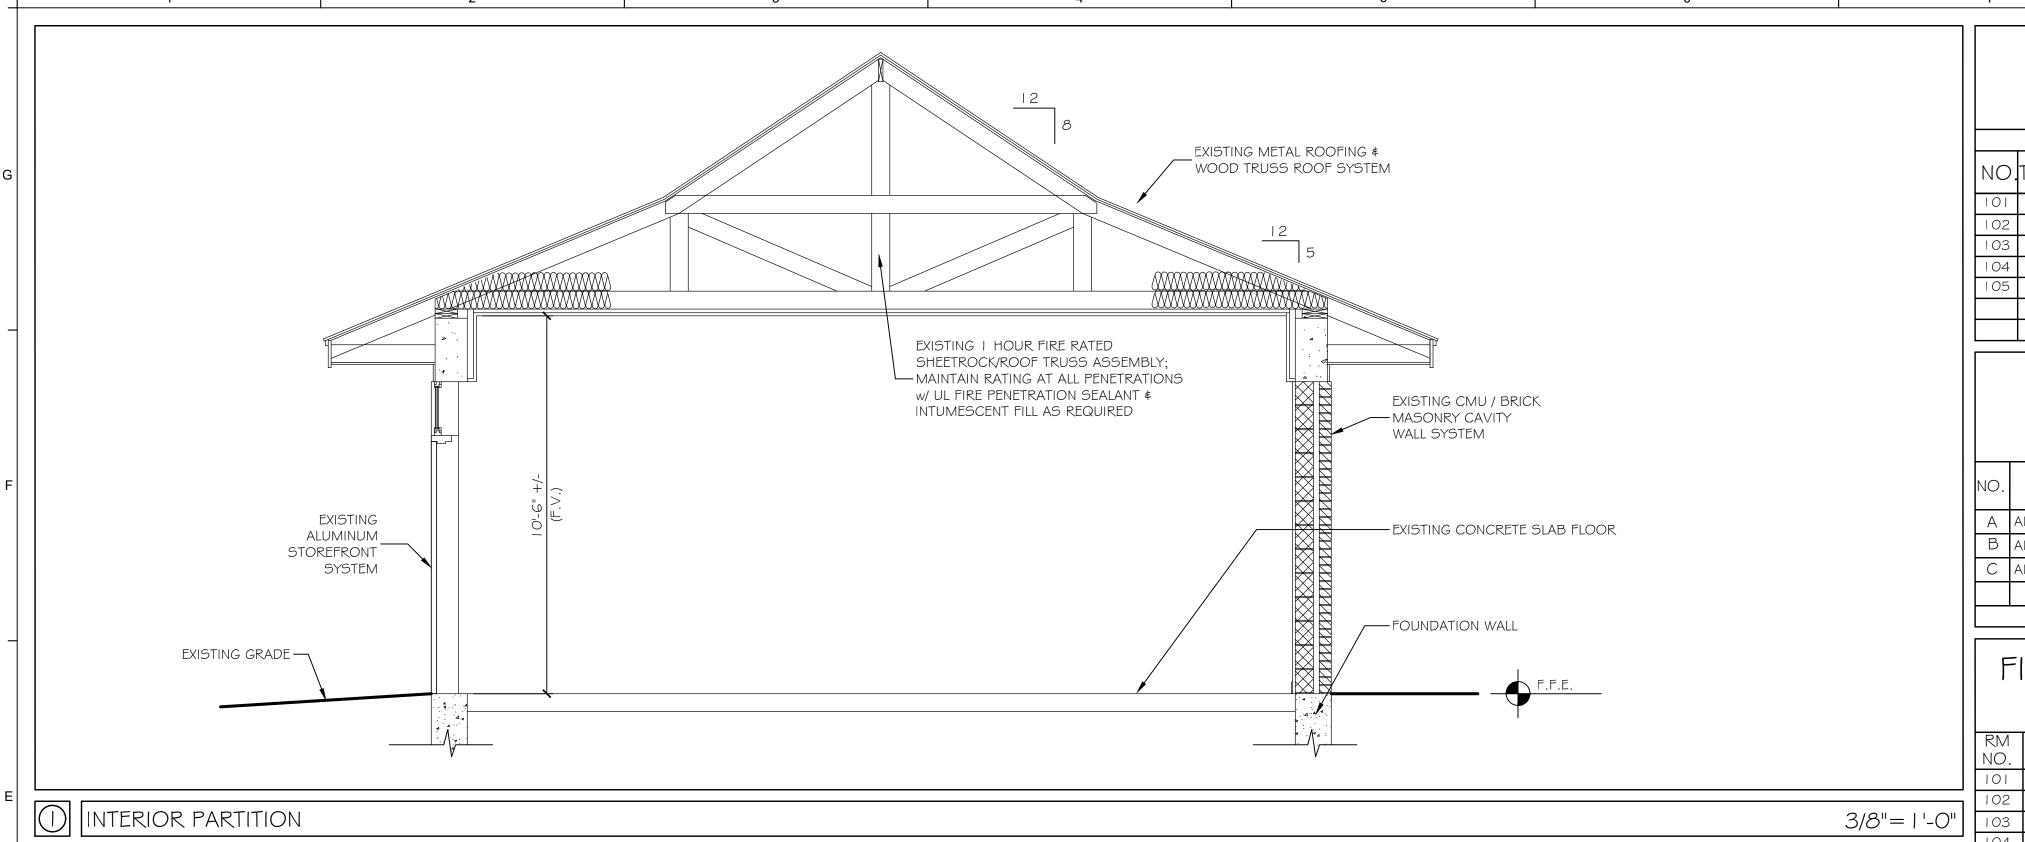


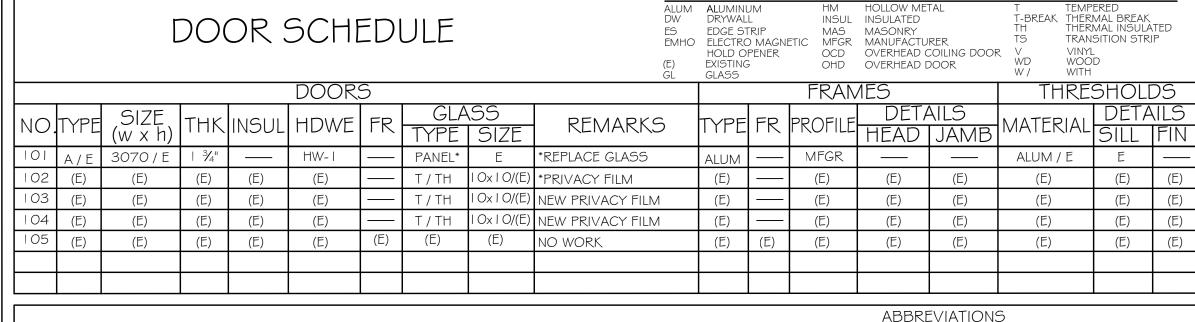


ABBREVIATIONS


#### WINDOW ALUM ALUMINUM CMT CASEMENT DH DOUBLE HUNG DW DRYWALL (E) EXISTING FIX FIXED SASH METAL TEMPERED WG WIRE GLASS WD WOOD W / WITH MANUFACTURER NOMINAL SIZE DETAILS TYPE REMARKS SILL | MUNT | MULL MODEL WIDTH HEIGHT HEAD JAMB | MFGR REPLACE GLASS W/ INSULATED PANEL A ALUM STOREFRONT (E) 10'-8" 8'-8" B ALUM REPLACE GLASS W/ INSULATED PANEL 4'-0" (E) (E) 5'-8" NEW INTERIOR PRIVACY FILM ALUM (E) (E) 4'-0" 5'-8"

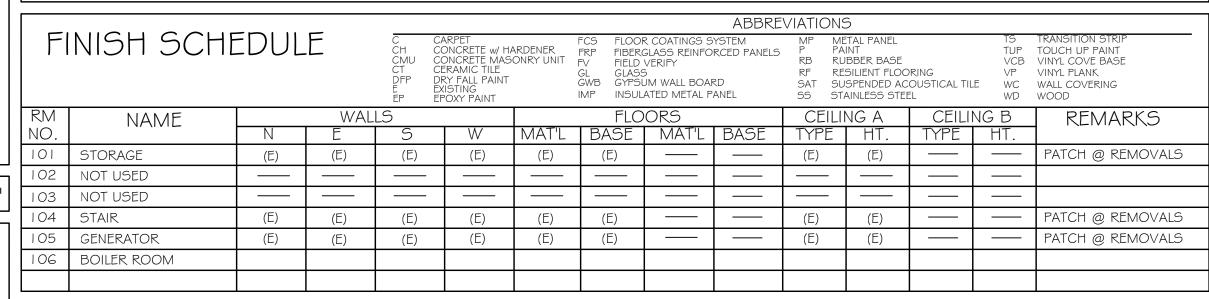

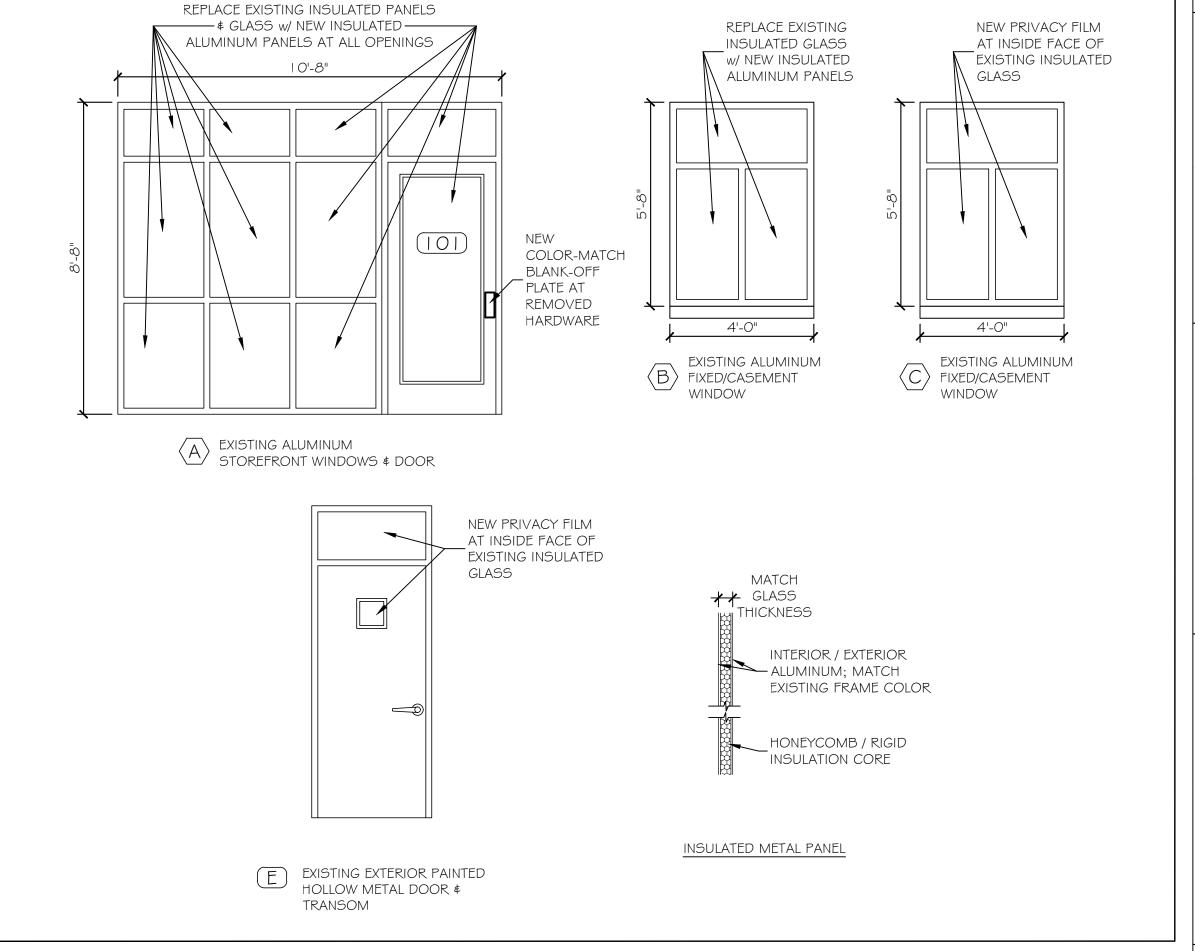

- EXISTING EXTERIOR WALL

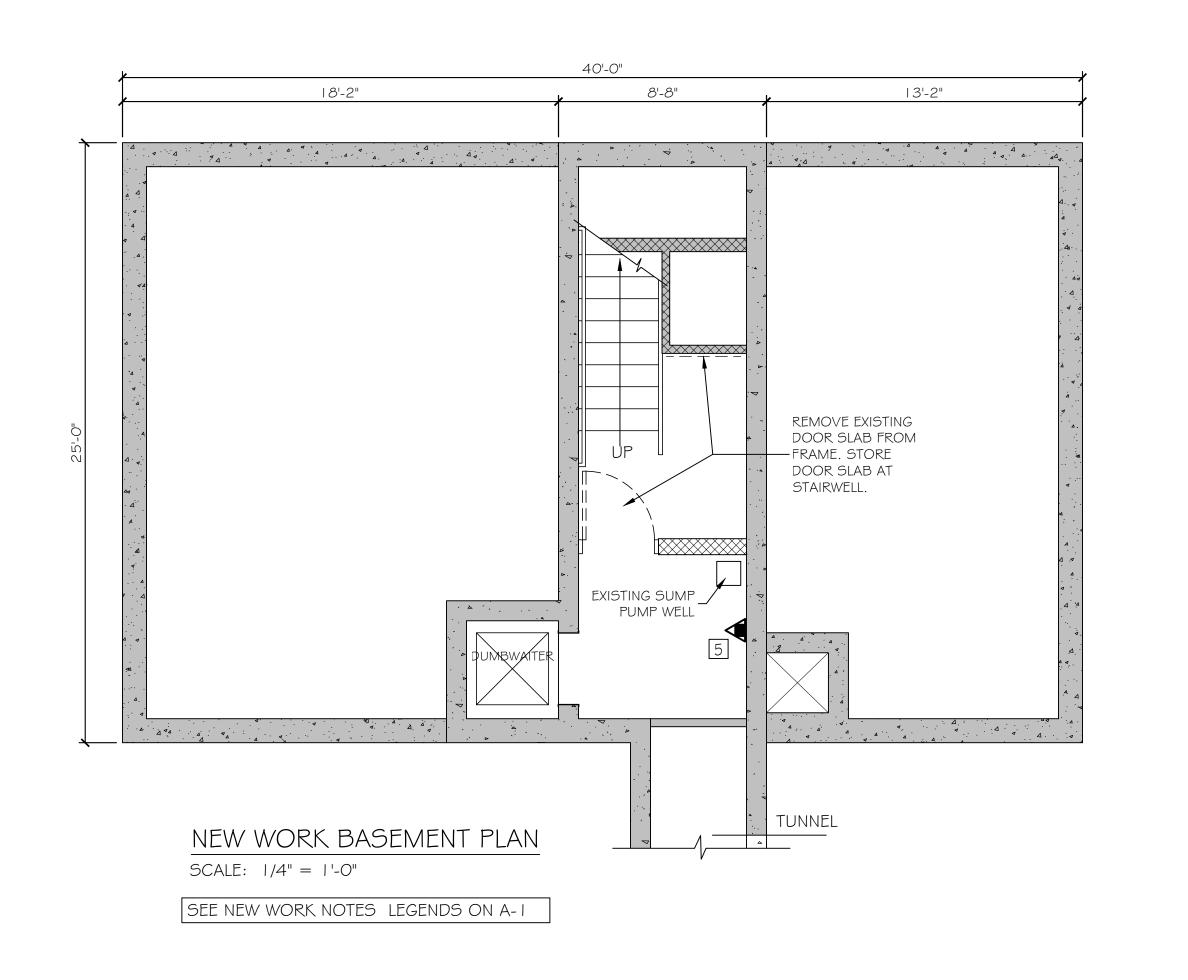

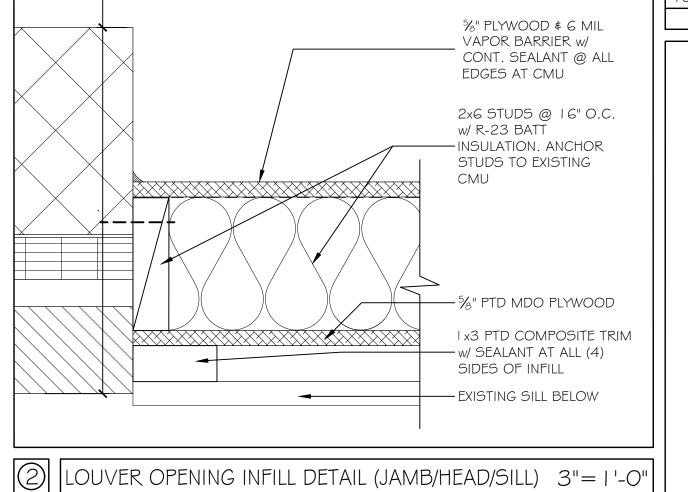

HW-I

- I. REMOVE EXTERIOR DOOR HARDWARE. INSTALL BLANK-OFF PLATE AT VOID(S). PLATE COLOR SHALL MATCH COLOR OF EXISTING ALUMINUM DOOR.
- 2. BALANCE OF HARDWARE TO REMAIN.

3 HARDWARE SET / NOTES

DOOR \$ WINDOW TYPES

3/8"=1'-0"

Scale:				Designed by:		7	JUSED ARCHITE		
No.	Revision	Ву	Date	Michael F. H	ays, RA		MICHAEL F. HAYS NO. 1724		
					Ву	Date	Charl F. Haus	By	Date
				Designed:	MFH	11/14/19	Checked:	MFH	11/14/19

Drawn:


<del>-</del> GRANT HAY ASSOCIATES ARCHITECTURE & INTERIOR DE/IGN P.O. BOX 6179 FALMOUTH MAINE 04105 207.871.5900 www.granthays.com




MTA PROJECT MANAGER: RALPH NORWOOD, IV, PE, PTOE

EXIT 44 **BUILDING RENOVATION** BUILDING SECTION, SCHEDULES & DETAILS

SHEET NUMBER: A-3 CONTRACT: 2019.16 5<sub>OF</sub> 11

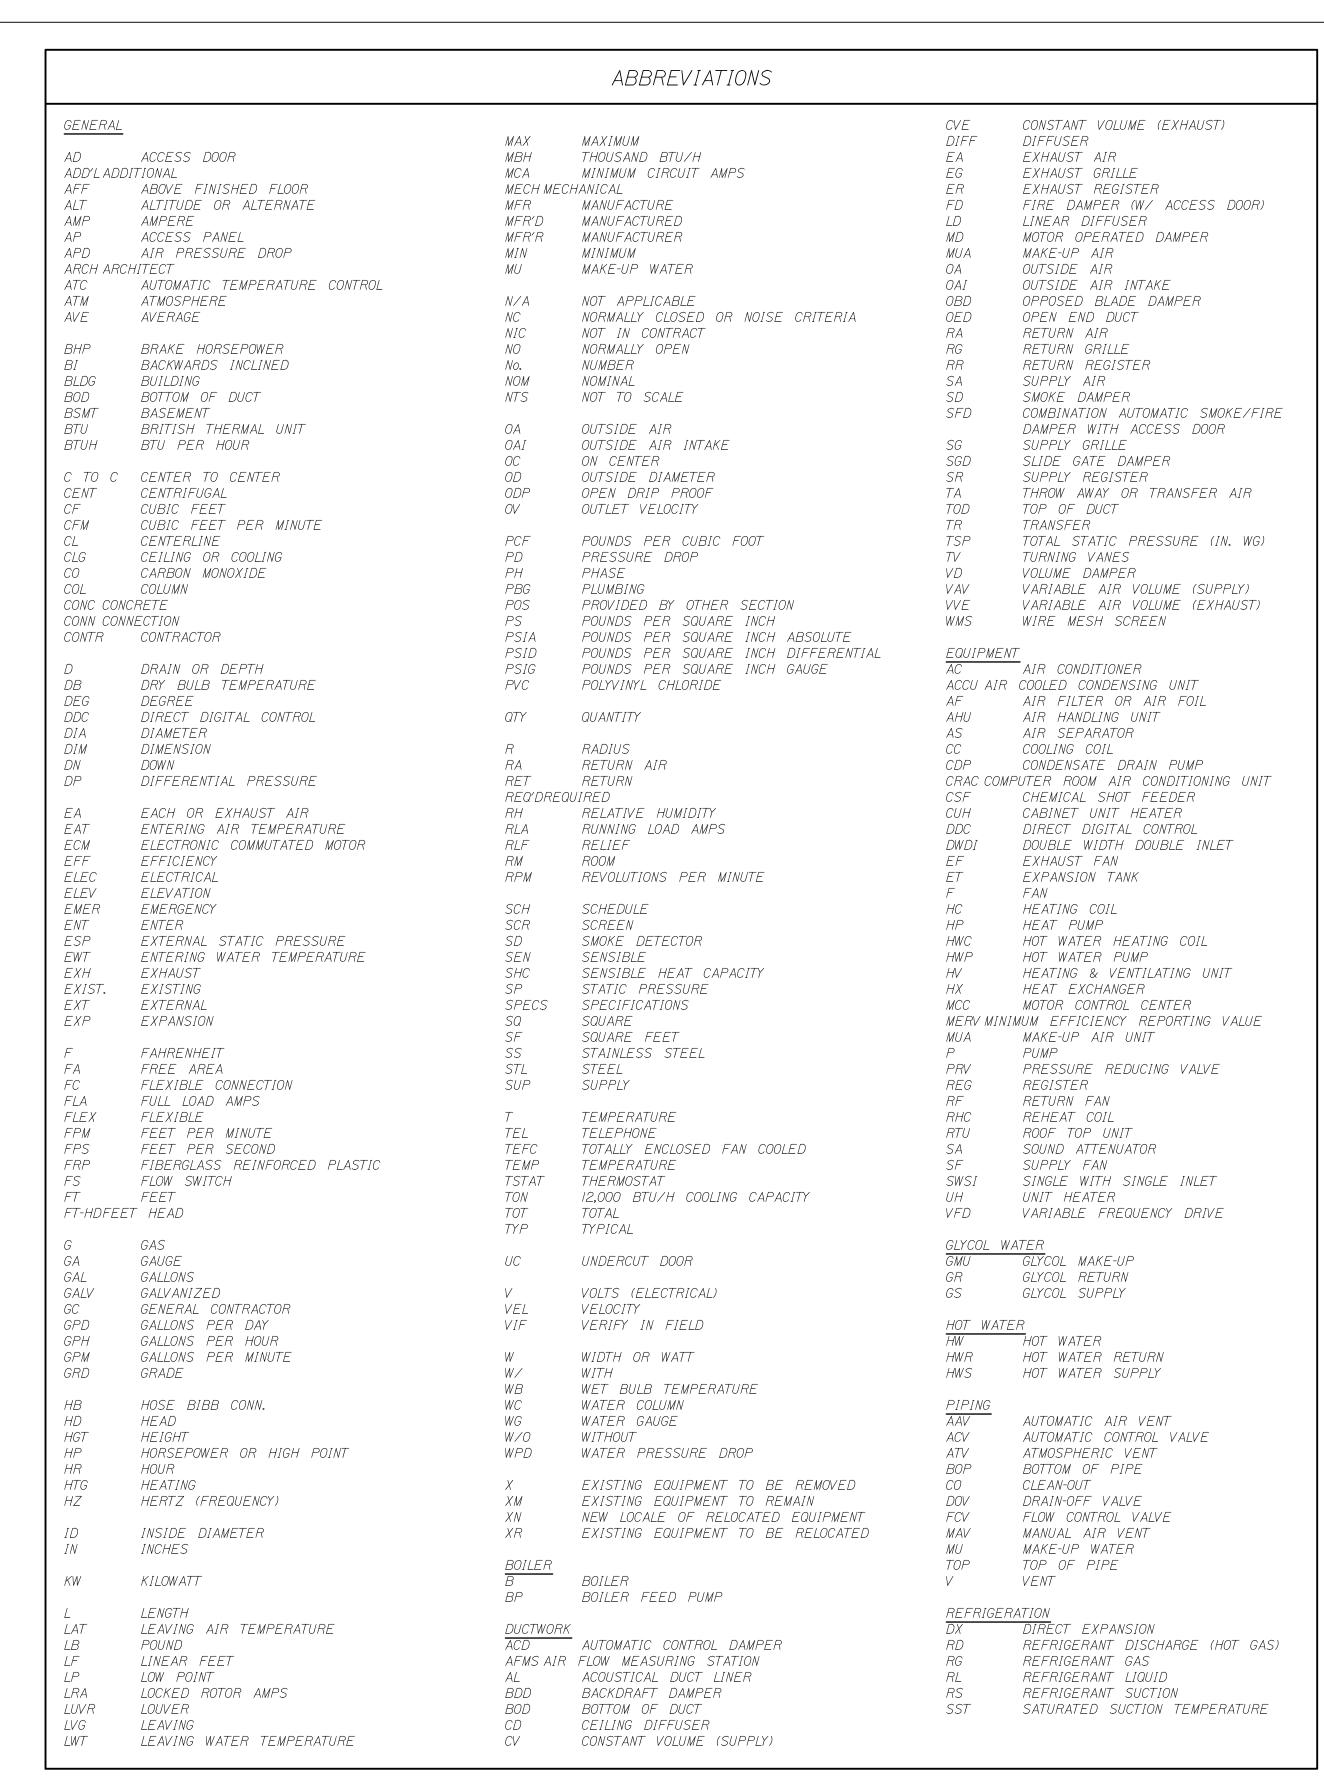


## GENERAL SYMBOLOGY CONNECT NEW TO EXISTING — SECTION DESIGNATION SHEET NUMBER LIMIT OF SECTION REVISION NUMBER TEMPERATURE SENSOR OR THERMOSTAT HUMIDITY SENSOR OR HUMIDISTAT *MANUAL SWITCH* CARBON MONOXIDE DETECTOR OCCUPANCY SENSOR CARBON DIOXIDE DETECTOR TYPICAL CONTROL WIRING DEMOLITION HATCHING - ITEM AND ASSOCIATED SUNDRIES TO BE REMOVED IN THIER ENTIRITY UNLESS OTHERWISE NOTED NEW WORK INDICATED BY A HEAVY LINEWIEGHT EXISTING WORK INDICATED BY A MEDIUM LINEWIEGHT HIDDEN WORK INDICATED BY A LIGHT LINEWIEGHT \_\_\_\_\_

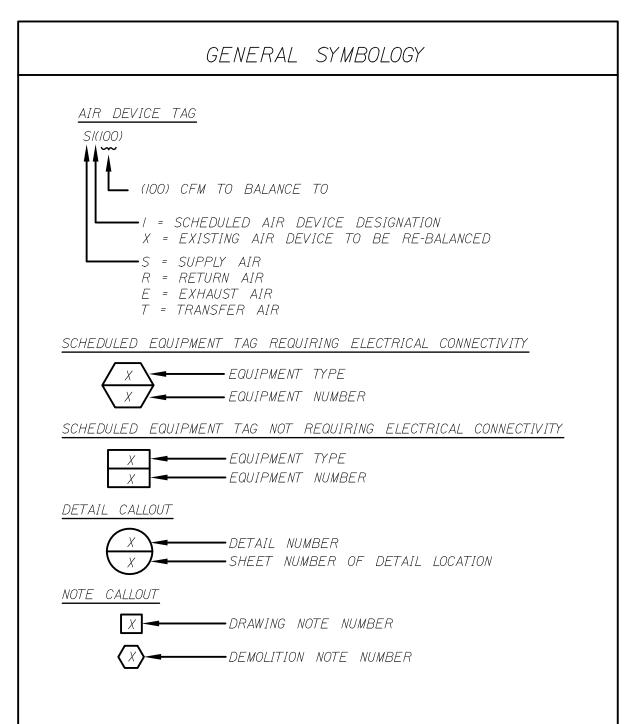

#### GENERAL NOTES

- I. PROVIDE ALL MATERIALS AND EQUIPMENT AND PERFORM ALL LABOR REQUIRED TO INSTALL COMPLETE AND OPERABLE MECHANICAL SYSTEMS AS INDICATED ON THE DRAWINGS, SPECIFIED AND AS REQUIRED BY CODE.
- 2. CONTRACT DOCUMENT DRAWINGS FOR MECHANICAL WORK ARE DIAGRAMMATIC AND ARE INTENDED TO CONVEY SCOPE AND GENERAL ARRANGEMENT ONLY.
- 3. INSTALL ALL MECHANICAL EQUIPMENT AND APPURTENANCES IN ACCORDANCE WITH MANUFACTURERS' RECOMMENDATIONS, CONTRACT DOCUMENTS, AND APPLICABLE CODES AND REGULATIONS.
- 4. PURCHASE AND INSTALL VIBRATION ISOLATION FOR ALL MECHANICAL EQUIPMENT TO PREVENT TRANSMISSION OF VIBRATION TO BUILDING STRUCTURE.
- 5. PURCHASE AND INSTALL VIBRATION ISOLATORS FOR ALL PIPING SUPPORTS CONNECTED TO, AND WITHIN 50 FT. OF, ISOLATED EQUIPMENT (EXCEPT AT BASE ELBOW SUPPORTS AND ANCHOR POINTS) THROUGHOUT MECHANICAL EQUIPMENT ROOMS.
- 6. COORDINATE CONSTRUCTION OF ALL MECHANICAL WORK WITH ARCHITECTURAL, STRUCTURAL, CIVIL, ELECTRICAL WORK, ETC., SHOWN ON OTHER CONTRACT DOCUMENT DRAWINGS.
- 7. MAINTAIN A MINIMUM 6'-8" CLEARANCE TO THE UNDERSIDE OF PIPES, DUCTS CONDUITS, SUSPENDED EQUIPMENT, ETC., THROUGHOUT ACCESS ROUTES IN MECHANICAL ROOMS.
- 8. ALL TESTS SHALL BE COMPLETED BEFORE INSULATING ANY MECHANICAL EQUIPMENT OR PIPING.
- 9. LOCATE ALL TEMPERATURE, PRESSURE, AND FLOW MEASURING DEVICES IN ACCESSIBLE LOCATIONS WITH THE STRAIGHT SECTION OF PIPE OR DUCT UP/DOWNSTREAM AS RECOMMENDED BY THE MFR.
- IO. TESTING, ADJUSTING, AND BALANCING AGENCY SHALL BE A MEMBER OF THE ASSOCIATED AIR BALANCE COUNCIL (AABC) OR THE NATIONAL ENVIRONMENTAL BALANCING BUREAU (NEBB). TESTING, ADJUSTING, AND BALANCING SHALL BE PERFORMED IN ACCORDANCE WITH THE AABC STANDARDS.
- II. WHERE TWO OR MORE ITEMS OF THE SAME TYPE OF EQUIPMENT ARE REQUIRED, THE PRODUCT OF ONE MANUFACTURER SHALL BE USED.
- I2. COORDINATE ALL EQUIPMENT CONNECTIONS WITH MFRS' CERTIFIED DRAWINGS. COORDINATE AND INSTALL ALL DUCT AND PIPING TRANSITIONS REQUIRED FOR FINAL EQUIPMENT CONNECTIONS TO FURNISHED EQUIPMENT. FIELD VERIFY AND COORDINATE ALL DUCT AND PIPING DIMENSIONS BEFORE FABRICATION.
- I3. ALL CONTROL WIRE AND CONDUIT SHALL COMPLY WITH THE NATIONAL ELECTRIC CODE AND DIVISION 16 OF THE SPECIFICATION.
- 14. CONCRETE HOUSEKEEPING PADS TO SUIT MECHANICAL EQUIPMENT SHALL BE SIZED AND LOCATED BY THE CONTRACTOR. PAD SHALL EXTEND BEYOND EQUIPMENT A MINIMUM OF 6" ON EACH SIDE.
- IS. THE LOCATIONS OF ALL ITEMS SHOWN ON THE DRAWINGS OR CALLED FOR IN THE SPECIFICATIONS THAT ARE NOT DEFINITELY FIXED BY DIMENSIONS ARE APPROXIMATE ONLY. THE EXACT LOCATIONS NECESSARY TO SECURE THE BEST CONDITIONS AND RESULTS MUST BE DETERMINED BY THE PROJECT SITE CONDITIONS AND SHALL HAVE THE APPROVAL OF THE ENGINEER PRIOR TO INSTALLATION, DO NOT SCALE DRAWINGS.
- 16. ALL MISCELLANEOUS STEEL REQUIRED TO ENSURE PROPER INSTALLATION AND AS SHOWN IN DETAILS FOR PIPING, DUCTWORK, AND EQUIPMENT (UNLESS OTHERWISE NOTED) SHALL BE FURNISHED AND INSTALLED BY THE CONTRACTOR.
- I7. PURCHASE AND INSTALL ACCESS PANELS FOR INSTALLATION IN WALLS AND CEILINGS WHERE REQUIRED, TO SERVICE DAMPERS, VALVES, SMOKE DETECTORS, AND OTHER CONCEALED MECHANICAL EQUIPMENT.
- 18. ALL EQUIPMENT, PIPING, DUCTWORK, ETC., SHALL BE SUPPORTED AS DETAILED, SPECIFIED, AND REQUIRED TO PROVIDE A VIBRATION-FREE INSTALLATION.
- 19. MECHANICAL EQUIPMENT, DUCTWORK, AND PIPING SHALL NOT BE SUPPORTED FROM A METAL DECK.
- 20. LOCATIONS AND SIZES OF ALL FLOOR, WALL, AND ROOF OPENINGS SHALL BE COORDINATED WITH ALL OTHER TRADES INVOLVED.
- 21. ALL OPENINGS IN FIRE WALLS DUE TO DUCTWORK, PIPING, CONDUIT, ETC., SHALL BE FIRE STOPPED.
- 22. ALL AIR CONDITIONING CONDENSATE DRAIN LINES FOR EACH AIR HANDLING UNIT AND IDU UNIT SHALL
  BE PIPED FULL SIZE OF THE UNIT DRAIN OUTLET, WITH "P" TRAP, AND PIPE TO THE NEAREST DRAIN.
  SEE THE DETAILS SHOWN IN THE DRAWINGS OR CONTRACT SPECIFICATIONS FOR THE DEPTH OF THE
  AIR CONDITIONING CONDENSATE TRAP.
- 23. REFER TO TYPICAL DETAILS FOR DUCTWORK, PIPING, AND EQUIPMENT INSTALLATION.
- 24. CONTRACTOR SHALL FIELD VERIFY SIZE OF EQUIPMENT PRIOR TO PURCHASE AND INSTALLATION.

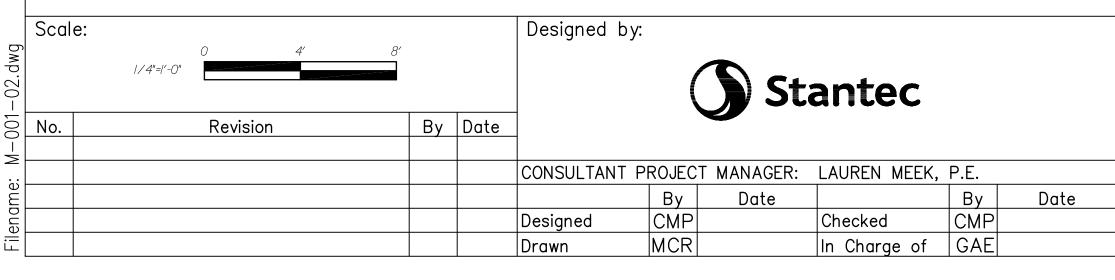

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# THE GOLD STAR MEMORIAL HIGHWAY


EXIT 44 BUILDING RENOVATION

MECHANICAL GENERAL NOTES, ABBREVIATIONS AND LEGEND

SHEET NUMBER: M-001

MTA PROJECT MANAGER: RALPH C. NORWOOD, IV, PE, PTOE

CONTRACT: 2019.16

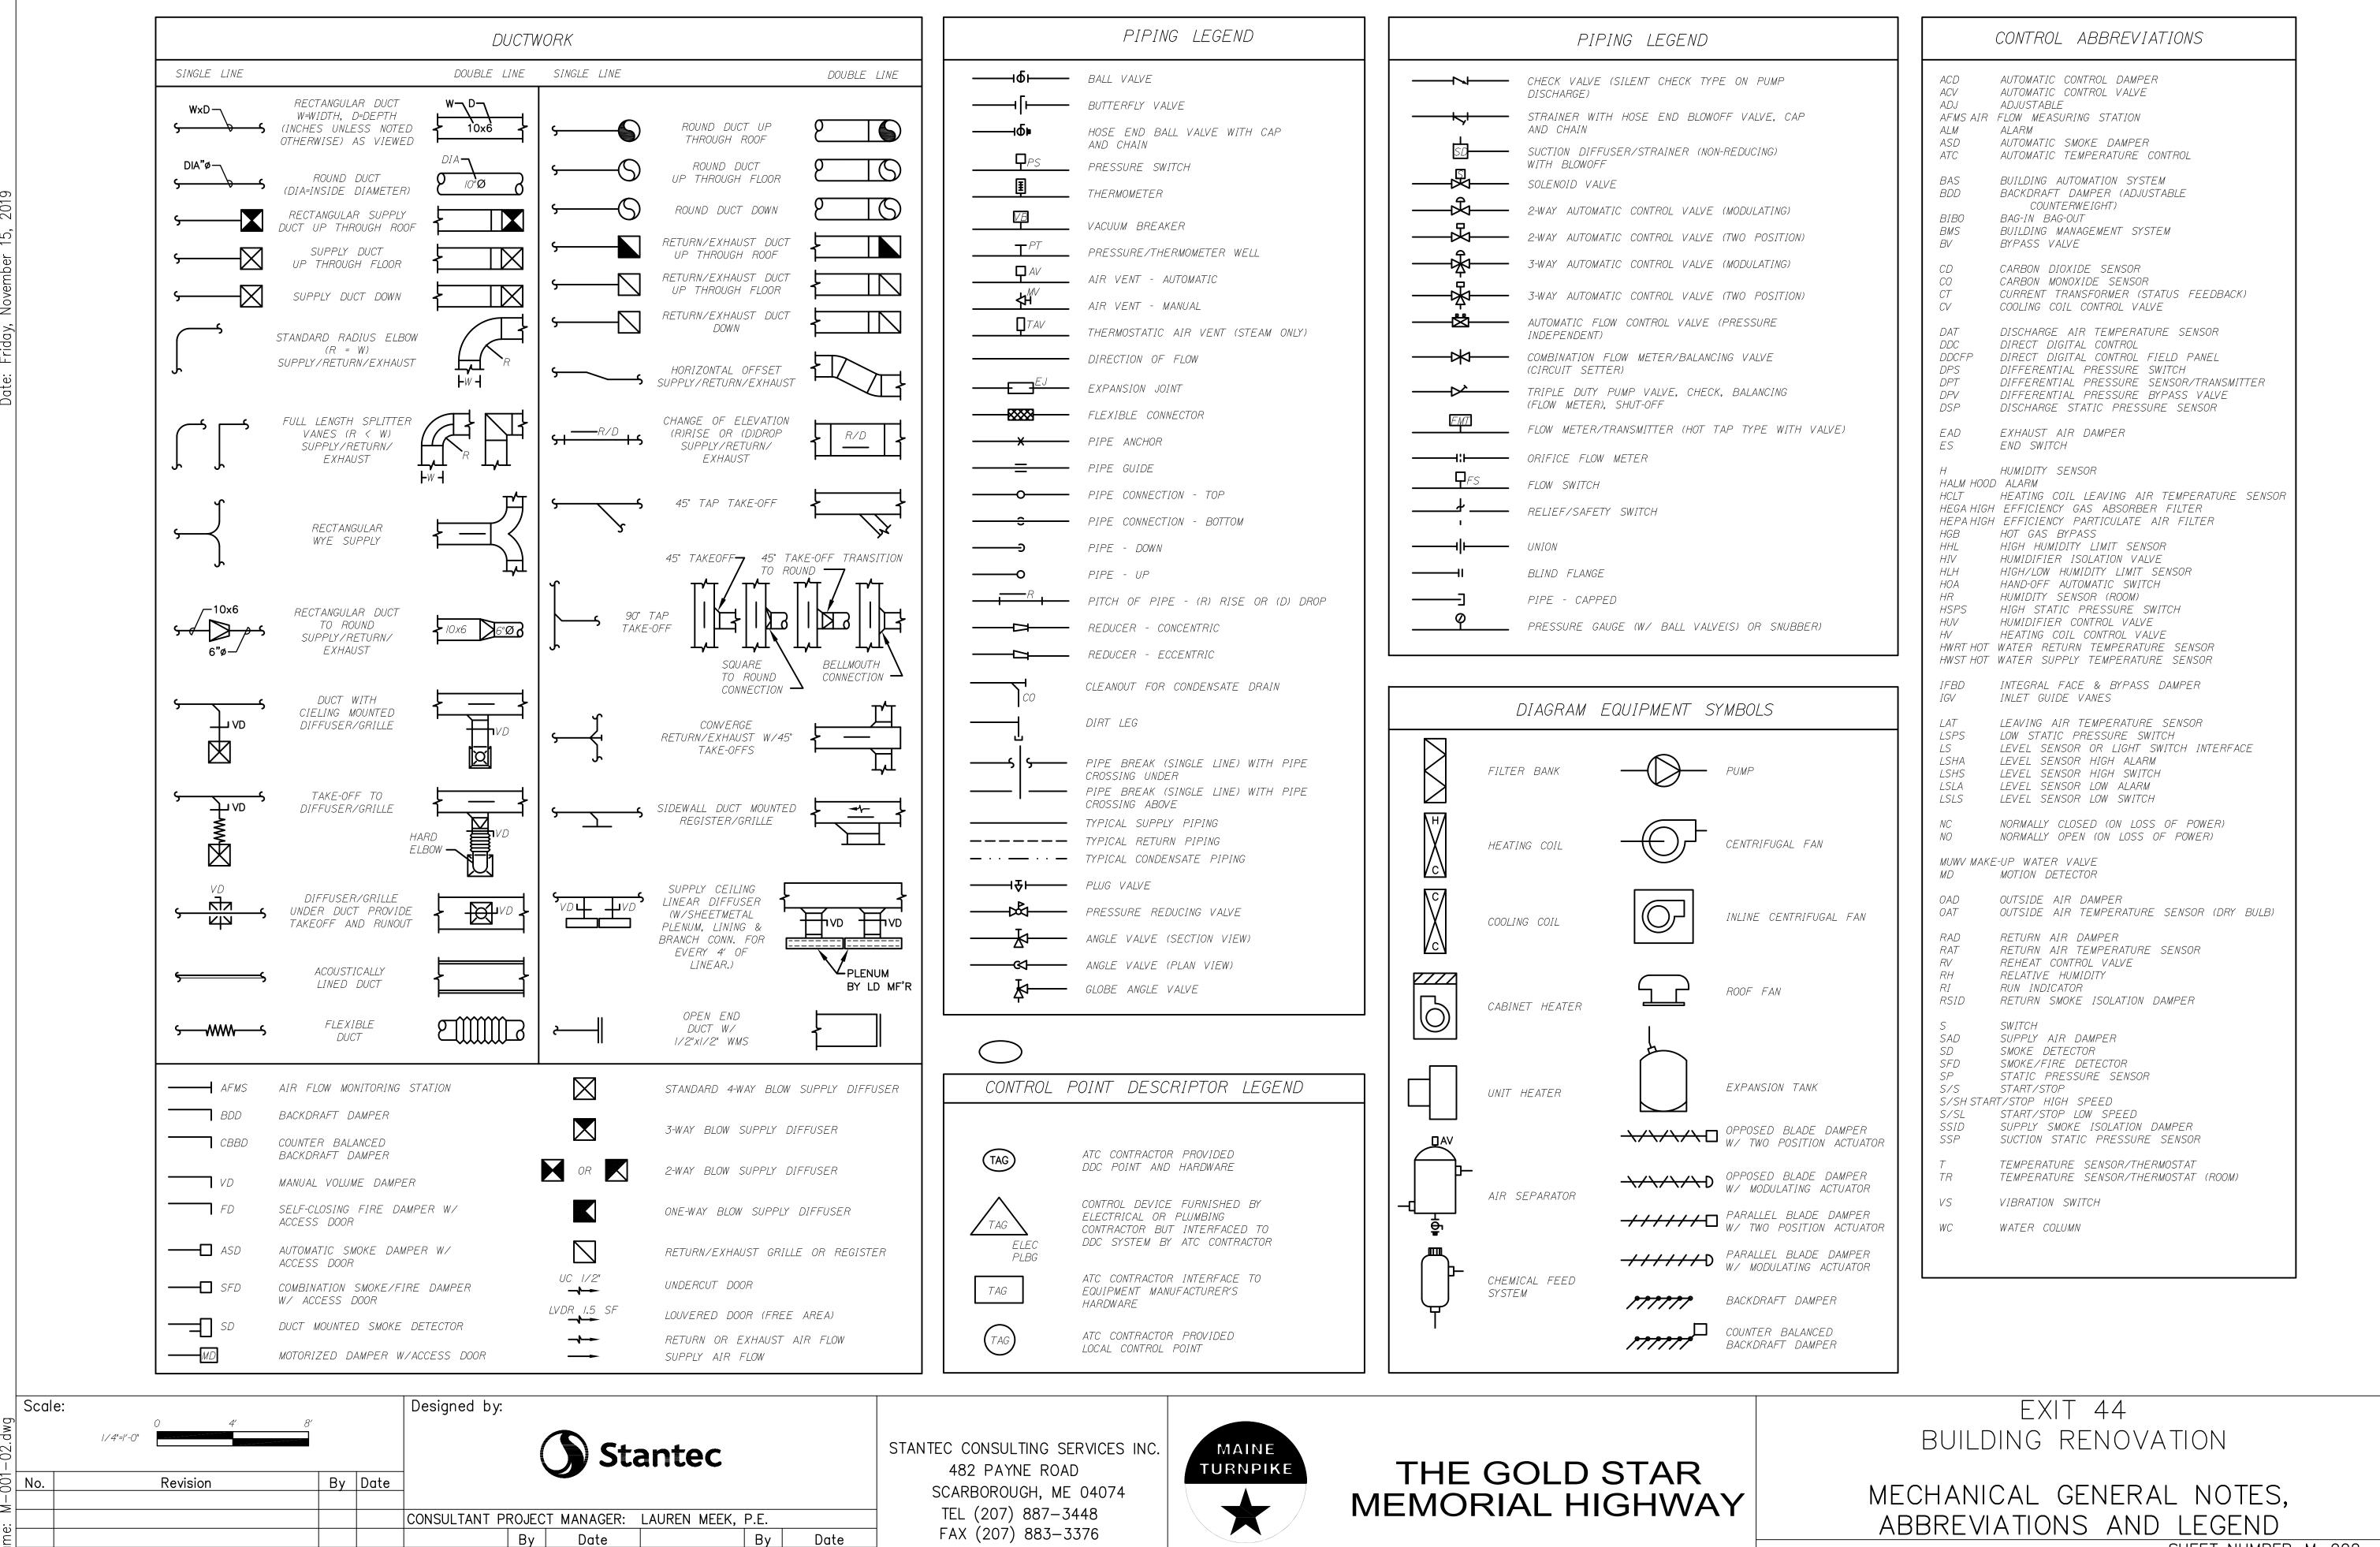

MTA PROJECT MANAGER: RALPH C. NORWOOD, IV, PE, PTOE

|CMP|

|MCR|

Designed


Drawn

**ICMP** 


Checked

In Charge of GAE

SHEET NUMBER: M-002 CONTRACT: 2019.16 7 OF 11

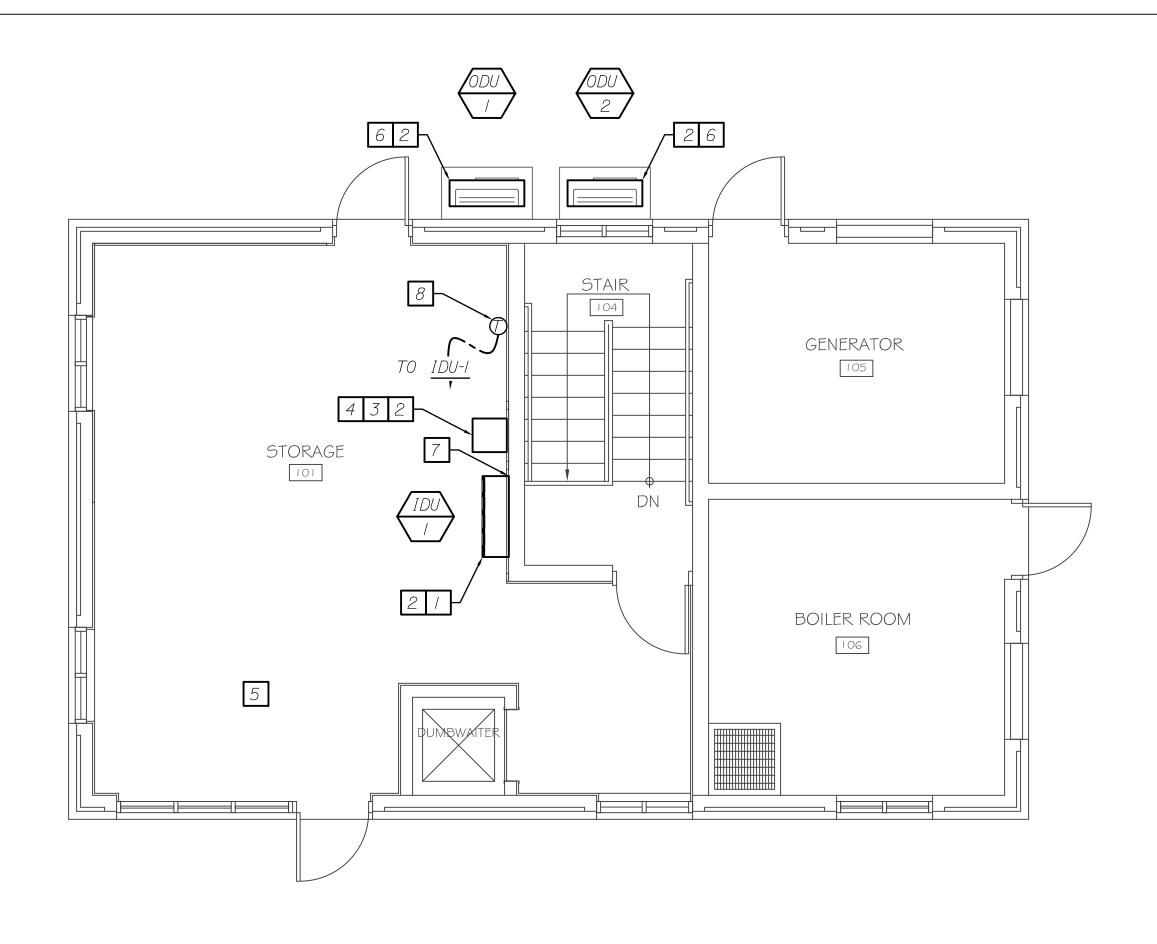



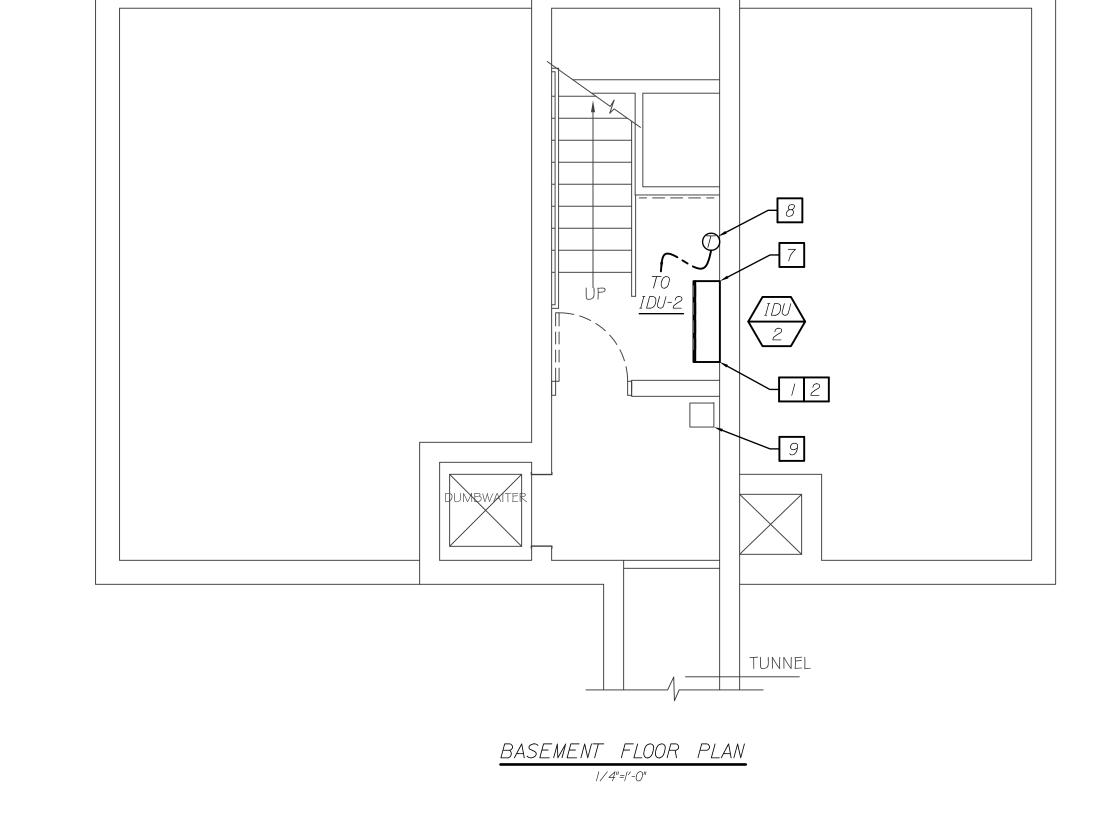

TAG	MATCHING OUTDOOR UNIT	LOCATION	TYPE	COOL DATA	FAN	HEATING DATA @ -13°F TOTAL BTU/H	V	E PH	LECTRIC HZ	CAL DAT		MOCP	NOTES	BASED ON MFR/MODEL
IDU-1	ODU-1	FIRST FLOOR STORAGE	WALL	15,000	400	14,580	208	1	60	0.67	1	20	1,2,3	MITSUBISHI/MSZFH15NAH
IDU-2	ODU-2	BASEMENT	WALL	15,000	400	14,580	208	1	60	0.67	1	20	1,2,3	MITSUBISHI/MSZFH15NAH

- NOTES: 1. PROVIDE UNITS WITH UNIT MOUNTED CONDENSATE PUMP IF IT IS NOT POSSIBLE TO GRAVITY DRAIN. COORDINATE WITH ELECTRICAL CONTRACTOR FOR DISCONNECT.
  - 2. PROVIDE WITH WIRED/WIRELESS THERMOSTATIC CONTROLS.
  - 3. PROVIDE REFRIGERANT LINE CONNECTIONS FROM OUTDOOR UNIT TO INDOOR UNIT PER MANUFACTURER'S RECOMMENDATION.

		DUCTLESS	SPLIT S	YSTEM	OUTI	DOOF	R UNI	r sci	IEDU	LE		
			PERFOR	RMANCE		ELEC	TRICAL	DATA		MIN.		
TAG	LOCATION		EER/SEER	COP	W	PH	HZ	MCA	MOCP	OPER.	NOTES	BASED ON MFR/MODEL
			LLIVOLLIN	COF	V	ГП	112	MCA	WOCF	AMB.		
ODU-1	OUTSIDE NORTH	MINISPLIT OUTDOOR UNIT	12.5/22	NA	208	1	60	16	20	-13	1,2,3,4	MITSUBISHI/MUZ-FH15NAH
ODU-2	OUTSIDE NORTH	MINISPLIT OUTDOOR UNIT	12.5/22	NA	208	1	60	16	20	-13	1,2,3,4	MITSUBISHI/MUZ-FH15NAH

- NOTES: 1. QUANTITY & SIZE OF REFRIGERANT LINES SHALL BE PER MANUFACTURER'S RECOMMENDATIONS.
  - 2. PROVIDE REFRIGERANT LINE CONNECTIONS FROM OUTDOOR UNIT TO INDOOR UNIT PER MANUFACTURER'S RECOMMENDATION.
  - 3. PROVIDE REFRIGERANT CHARGE PER MANUFACTURERS REMCOMMENDATION, UTILIZING ACTUAL INSTALLED LINE LENGTHS FOR CALCULATIONS
  - 4. PROVIDE UNITS WITH BASE PAN HEATER.


#### DEMO NOTES:

- I ALL EXISTING PLUMBING FIXTURES AND PIPING TO BE REMOVED UNLESS OTHERWISE NOTED.
- ALL EXISTING HVAC EQUIPMENT, PIPING, CONTROLS, AND ACCESSORIES TO BE REMOVED UNLESS OTHERWISE NOTED. EXISTING SUMP PUMP TO BE MADE OPERATIONAL AND REMAIN IN SERVICE.

#### *KEYNOTES:*

- ROUTE CONDENSATE DRAIN WITH AIR GAP TO SUMP PUMP IN BASEMENT.
- INSTALL PER MANUFACTURER'S RECOMMENDATIONS.
- PROVIDE SHELF 24" AFF SUITABLE TO SUPPORT DEHUMIDIFIER. PROVIDE 3/4" RIGID PIPE WITH FUNNEL FITTING ON TOP FOR DRAIN TO SUMP PUMP. INSTALL DEHUMIDIFIER DRAIN WITH HOSE TO FUNNEL WITH AIR GAP. COORDINATE ELECTRICAL REQUIREMENTS AND RECEPTACLE LOCATION WITH ELECTRICAL CONTRACTOR.
- PROVIDE DEHUMIDIFIER SUITABLE FOR 70 PINTS PER 24 HOURS WITH HOSE CONNECTION FOR GRAVITY DRAINING WITHOUT THE NEED FOR A PUMP.

- PROVIDE CLEANOUTS FOR ALL SEWER DRAINS PIPING TO REMAIN IN SLAB.
- PROVIDE STANDS MOUNTED TO EXISTING SIDEWALK FOR ODU. PROVIDE RAIN COVERS.
- FIELD ROUTE LINESET EXPOSED PIPING ON INTERIOR OF BUILDING SHALL BE SECURELY MOUNTED TO WALL SURFACE. INSULATE ENTIRETY OF LINESET SEPARATELY TO AHJ RECOMMENDATIONS AND MANUFACTURER'S REQUIREMENTS.
- PROVIDE THERMOSTATS CAPABLE OF PROVIDING 45 DEG F HEATING AND 80 DEG F COOLING.
- EXISTING SUMP PUMP TO REMAIN AND BE OPERATIONAL.

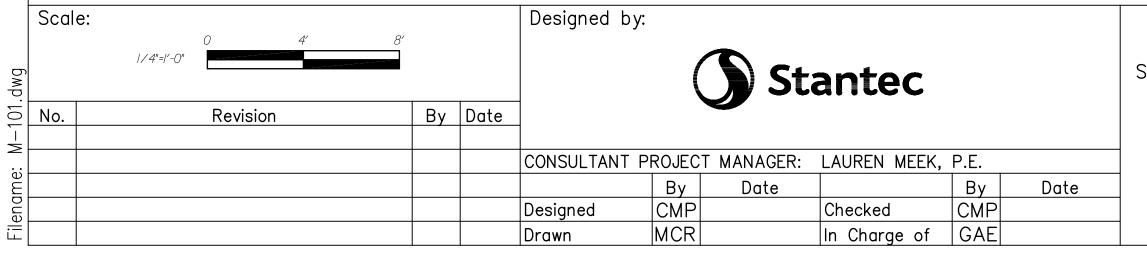

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THE GOLD STAR MEMORIAL HIGHWAY

EXIT 44 BUILDING RENOVATION

MECHANICAL BASEMENT AND FIRST FLOOR HVAC PLANS

MTA PROJECT MANAGER: RALPH C. NORWOOD, IV, PE, PTOE

CONTRACT: 2019.16

SHEET NUMBER: M-101

NEW LIGHT SWITCH IN EXISTING DEVICE BOX

a = CONTROL DESIGNATION

*ABBREVIATIONS*: ABOVE FINISHED FLOOR *AMMETER AMMETER SWITCH AUXILIARY* AUXBKRBREAKER COCUT OFF SWITCH CPCONTROL PANEL CONTROL POWER TRANSFORMER CS CONTROL SWITCH CTCURRENT TRANSFORMER DATA ACQUISITION SYSTEM IP TO VIDEO ENCODER ER ELECTRIC RESET ETSW ETHERNET SWITCH FIRE ALARM CONTROL PANEL FULL VOLTAGE NON-REVERSING FPP FIBER PATCH PANEL GALV*GALVANIZED* GROUNDING ELECTRODE CONDUCTOR GROUND HVHIGH VOLTAGE INTRUSION ALARM INTERCOM INFORMATION TECHNOLOGY KIRK INTERLOCK KW KILOWATT *ISOLATING SWITCH* LOAD BREAK SWITCH LINEAR FOOT LIGHTING PANEL *LOW VOLTAGE* MAXMAXIMUMMINMINIMUM *MEDIUM VOLTAGE* MICRO-PROCESSOR METERING UNIT OVERHEAD TELEPHONE/COMMUNICATIONS OTHPAAPERSONNEL ACKNOWLEDGMENT ALARM POWER PANEL FIBER OPTIC CABLE PAIR I PT OR VT POTENTIAL OR VOLTAGE TRANSFORMER

PROGRAMMABLE CONTROLLER

PHOTOVOLTAIC

TIME METER

TRAP PRIMER

*TYPICAL* 

VOLTMETER

WATTMETER WEATHER PROOF

RECEP RECEPTACLE

POLYVINYLCHLORIDE

POWER QUALITY METER

RIGID GALVANIZED STEEL

*VARMETER (ON LINE)* 

WATTHOUR DEMAND METER

VOLTMETER SWITCH

WATTHOUR METER

REDUCED VOLTAGE NON-REVERSING

PVC

PQM

#### PROJECT NOTES:

- I. THE CONTRACTOR SHALL FURNISH ALL LABOR, MATERIALS, TOOLS AND ALL OTHER EQUIPMENT REQUIRED TO INSTALL THE WORK SHOWN AND SPECIFIED. THE CONTRACTOR SHALL FURNISH AND INSTALL ALL ITEMS NECESSARY FOR A COMPLETE ELECTRICAL SYSTEM AND PLACE ALL EQUIPMENT IN PROPER WORKING ORDER, ALL MATERIALS SHALL BE NEW AND SHALL BEAR THE REGISTERED UL MARK. ALL WORK SHALL CONFORM WITH THE THE NATIONAL ELECTRICAL CODE (NEC, NFPA 70), AND ALL APPLICABLE FEDERAL, STATE AND LOCAL CODES. CONTRACTOR SHALL SECURE ALL PERMITS AND PAY THE FEES REQUIRED TO CARRY OUT HIS WORK. THE CONTRACTOR SHALL FURNISH COPIES OF ALL CERTIFICATES AND PERMITS TO THE ENGINEER.
- 2. THE DRAWINGS AND SPECIFICATIONS INDICATE THE INTENT OF THE DESIGN AND SHALL BE CONSIDERED AS DIAGRAMMATIC ONLY. EXACT LOCATIONS FOR ALL OUTLETS AND EQUIPMENT SHALL BE DETERMINED AT THE SITE AS WORK PROGRESSES. ALL DIMENSIONS AND CONDITIONS SHALL BE CHECKED AND VERIFIED BY THE CONTRACTOR AT THE SITE. ALL FINAL WORK SHALL BE DOCUMENTED ON AS BUILT RECORD DRAWINGS.
- 3. ALL EXISTING WIRING AND WIRING DEVICES SHALL BE REMOVED, ALL EXISTING DEVICE BOXES WITH REMOVED DEVICES SHALL HAVE COVERS
- 4. THE CONTRACTOR SHALL UTILIZE ANY EXISTING CONDUITS TO THE EXTENT POSSIBLE TO REACH ANY EQUIPMENT OR DEVICES TO BE INSTALLED.
- 5. THE CONTRACTOR SHALL PROVIDE NEW CIRCUIT BREAKERS IN EXISTING PANEL H PER THE PANEL SCHEDULE ON THE PLANS.
- 6. ALL PIPING, CONDUITS AND EQUIPMENT OF ALL TRADES SHALL BE PROPERLY COORDINATED AND SET TO MAINTAIN THE CLEARANCES REQUIRED BY ALL APPLICABLE FEDERAL, STATE AND LOCAL CODES.
- 7. ALL CONDUITS SHALL BE TERMINATED SO AS TO PERMIT NEAT CONNECTIONS TO MOTORS AND OTHER EQUIPMENT.
- 8. NO CONDUIT SMALLER THAN 3/4" PIPE SIZE NOR WIRE SMALLER THAN #12 AWG SHALL BE USED UNLESS OTHERWISE NOTED.
- 9. CONDUIT AND/OR WIRE (NOT SHOWN) INTERCONNECTING THE LIGHTING FIXTURES AND/OR RECEPTACLES SHALL BE FURNISHED AND INSTALLED BY THE ELECTRICAL CONTRACTOR AND SHALL BE:
  - a. 3/4" (MIN.) CONDUIT RUN I. EXPOSED IN UNFINISHED AREAS.
    - 2. CONCEALED ABOVE HUNG CEILINGS AND IN WALLS IN FINISHED
  - b. No. 12 CU. WIRE (MIN.) TYPE THWN, NUMBER OF WIRES AS REQUIRED. c. SEE SPECIFICATION FOR USE OF TYPE MC CABLE.
- 7. ALL CONDUIT RUNS CROSSING EXPANSION JOINTS SHALL HAVE EXPANSION OR EXPANSION AND DEFLECTION TYPE FITTINGS AS REQUIRED, VERIFY EXISTING JOINTS BY FIELD MEASUREMENTS.
- 8. ALL CONDUITS SHALL HAVE PROPERLY SIZED EQUIPMENT GROUNDING CONDUCTORS.
- 9. ALL CONDUIT AND EQUIPMENT SHALL BE INSTALLED AND GROUNDED IN ACCORDANCE WITH THE LATEST RULES AND REGULATIONS OF THE NATIONAL ELECTRICAL CODE.
- 10. THE WIRING DIAGRAMS, QUANTITY AND SIZE OF WIRES AND CONDUIT REPRESENT A SUGGESTED ARRANGEMENT BASED UPON SELECTED STANDARD COMPONENTS OF ELECTRICAL EQUIPMENT. MODIFICATIONS ACCEPTABLE TO THE ENGINEER MAY BE MADE BY THE CONTRACTOR TO ACCOMMODATE EQUIPMENT ACTUALLY PURCHASED, THE BASIC SEQUENCE AND METHOD OF CONTROL MUST BE MAINTAINED AS INDICATED ON THE DRAWINGS AND/OR SPECIFICATIONS.
- II. EXIT SIGNS AND EMERGENCY LIGHTING UNITS SHALL BE UNSWITCHED.
- 12. ALL CIRCUITS SHALL HAVE THEIR OWN NEUTRAL CONDUCTOR. COMMON NEUTRALS WILL NOT BE ALLOWED.
- 13. RECEPTACLES, SWITCHES, LIGHTING FIXTURES, SMOKE DETECTORS, ETC. INDICATE QUANTITY, EXACT LOCATIONS OF ALL DEVICES SHALL BE DETERMINED IN THE FIELD.
- 14. CONTRACTOR SHALL FURNISH AND INSTALL ARC-FLASH HAZARD WARNING LABELS AND AVAILABLE FAULT CURRENT VALUES, REFER TO SPECIFICATIONS FOR REQUIREMENTS.

Scale:				Designed b	oy:	<b>D</b> C+	antec		
No.	Revision	Ву	Date	_			antec		
				CONSULTANT	PROJECT	MANAGER:	LAUREN MEEK,	P.E.	
					Ву	Date		Ву	Date
				Designed	TJM		Checked	DMG	
				Drawn	TJM		In Charge of	DMG	

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# THE GOLD STAR MEMORIAL HIGHWAY


EXIT 44 BUILDING RENOVATION

ELECTRICAL GENERAL NOTES, ABBREVIATIONS AND LEGEND

SHEET NUMBER: E-001

MTA PROJECT MANAGER: RALPH C. NORWOOD, IV, PE, PTOE

CONTRACT: 2019.16

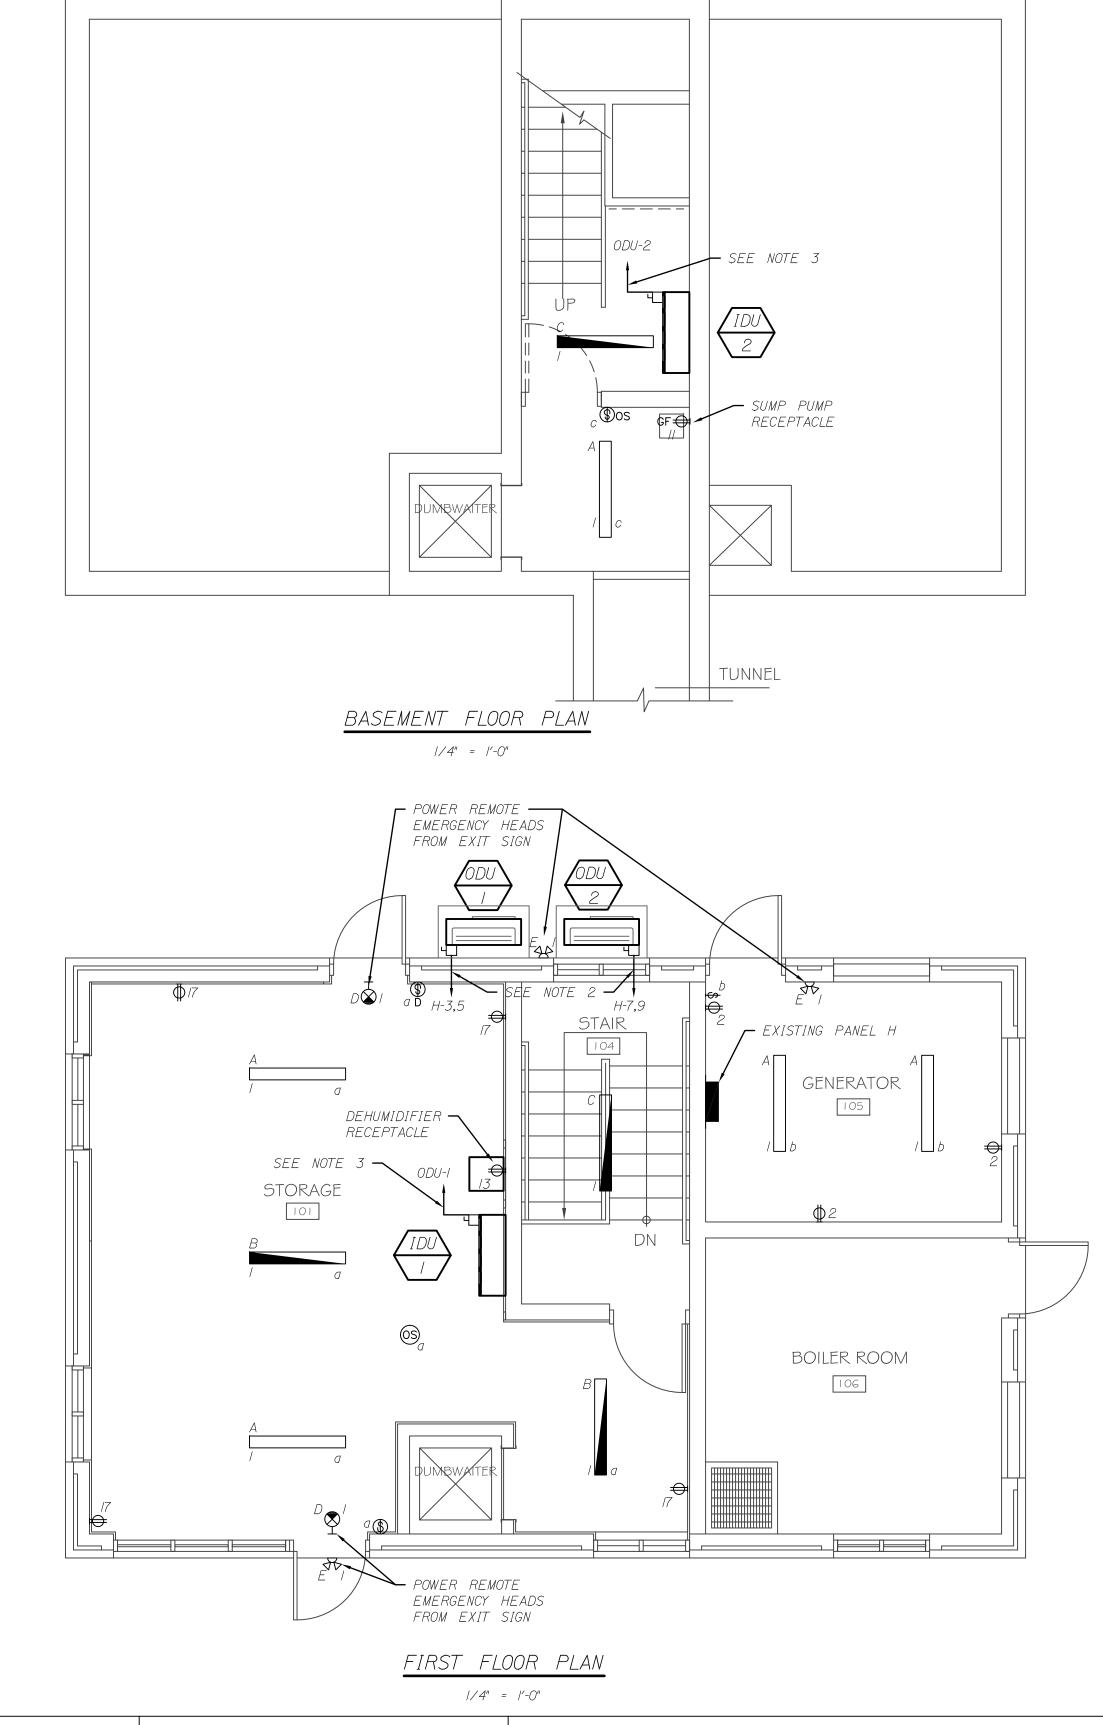

#### NOTES:

- I. CONNECT ALL CIRCUITS TO PANEL H UNLESS OTHERWISE NOTED. PROVIDE DEDICATED CIRCUITS WITH NO SHARED NEUTRALS. 120V, 20A CIRCUITS TO BE 2#12, 1#12 GND, 3/4"C.
- 2. PROVIDE 208V, 20A/2P CIRCUIT (3#10, 1#10G, 3/4"C) FROM EXISTING PANEL H.
- 3. PROVIDE 3/4"C, 3#12, I#12G BETWEEN INTERIOR AND EXTERIOR UNITS UNLESS REQUIRED OTHERWISE BY ACTUAL ITEM FURNISHED, COORDINATE WITH THE HVAC CONTRACTOR.

Scale: Designed by: **Stantec** By Date Revision 5 No. CONSULTANT PROJECT MANAGER: LAUREN MEEK, P.E. By Date DMG By TJM Checked Designed In Charge of DMG

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# THE GOLD STAR MEMORIAL HIGHWAY

ELECTRICAL BASEMENT AND FIRST FLOOR POWER PLANS

EXIT 44

BUILDING RENOVATION

SHEET NUMBER: E-101 CONTRACT: 2019.16 10 OF 11


MTA PROJECT MANAGER: RALPH C. NORWOOD, IV, PE, PTOE


					P	ANEL:	Н						
LOC	ATION: COMPUTER/UPS ELECTE	RICAL R	OOM	FEED	ER BRA	ANCH:	NORM	AL		DESCI	RIPTION: MAIN	DISTRIBUTION	PANEL
SER'	VICE - 120V/208V, 3PH, 4W + 0	G		BUS	S CAPA	CITY:	225A				ENCLOSURE:	NEMA-1	
AIC	RATING: 22000 A	_		MAIN	D.C. RA	TING:	100A N	MCB			MOUNTING:	SURFACE	
CKT	LOAD DESCRIPTION	VA - A	VA-B	VA -C	CB	PH	CB	VA - A	VA-B	VA -C	LOAD DESCRI	PTION	CK
1	LIGHTING	270			20/1	Α	20/1	540			ELEC ROOM R	ECEPTACLE	2
3	ODU-1		1600		20/2	В	20/1				SPARE		4
5				1600		С	20/1				SPARE		6
7	ODU-2	1600			20/2	Α	20/1				SPARE		8
9			1600			В	20/1				SPARE		10
11	SUMP PUMP RECEPTACLE			828	20/1	С	20/1				SPARE		12
13	DEHUMIDIFER RECEPTACLE	565			20/1	Α	20/1				SPARE		14
15	SPARE				20/1	В	20/1				SPARE		16
17	RECEPTACLES			720	20/1	С	20/1				SPARE		18
19					20/1	Α	20/1						20
21					20/1	В	20/1						22
23					20/1	С	20/1						24
25					20/1	Α	20/1						26
27					20/1	В	20/1						28
29					20/1	С	20/1						30
31					20/1	Α	20/1						32
33					20/1	В	20/1						34
35					20/1	С	20/1						36
37					20/1	Α	20/1						38
39					20/1	В	20/1						40
41					20/1	С	20/1						42
	SUBTOTALS (VA	2435	3200	3148				540	0	0			CONN
		·											ECTE
CO	NNECTED TOTALS KVA		AMPS	1								DEMAND	LOAD
	PHASE-A 3.0		24.8	1				9.32				TYPE	(VA)
	PHASE-B 3.2	1	26.7	1	TOTA	AL DEI	MAND:	9.39	-KVA	26.1 <b>-A</b>		HVAC	7793
	PHASE-C 3.		26.2	J								RECEPTACLE	
												LIGHTING	270
													<u> </u>
NOTI													
1. PF	ROVIDE "HACR" RATED TYPE BE	REAKER	SFOR	MECHA	NICAL	MOTO	R LOAI	DS SUC	CHASE	EXHAUS	ST FANS		

### NOTES:

2. PROVIDE GFCI BREAKERS FOR THE FOLLOWING CIRCUITS:

I. FOR SELECTION OF CIRCUIT BREAKER TYPES, REFER TO SPECIFICATION SECTION 262416.

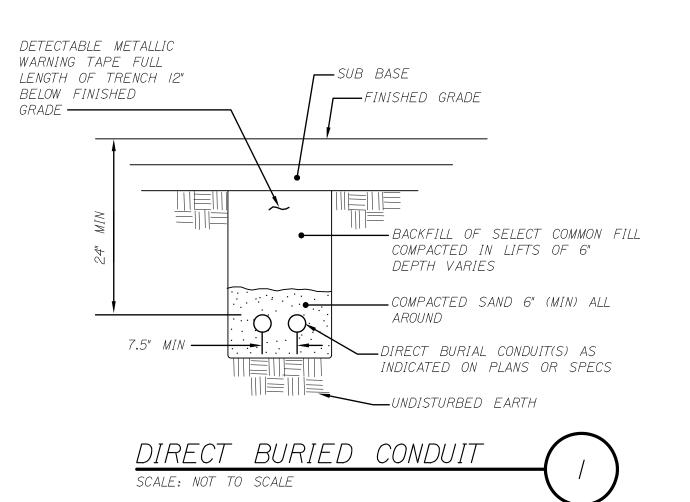

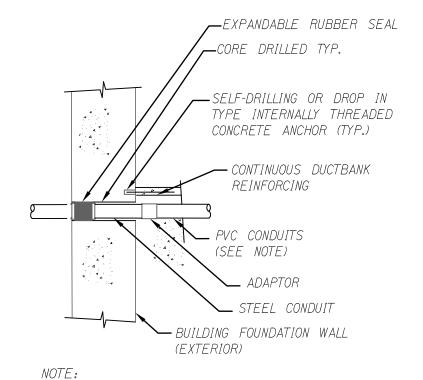

I. WHERE PVC CONDUIT IS USED IN DUCTLINE, CONVERT TO STEEL CONDUIT USING AN APPROPRIATE ADAPTER FITTING WITHIN 3'-0" OF WALL.


/ WATERTIGHT MECHANICAL CONDUIT -SEAL AS SPECIFIED FINISHED GRADE ----WATER STOP -STRUCTURAL FLOOR SLAB —— GALV STEEL SLEEVE, DIAMETER AS REQUIRED BY SEAL MANUFACTURER


SCALE: NOT TO SCALE

CONCRETE INSERT OR SUPPLEMENTAL STEEL

ENTRANCE SEAL SCALE: NOT TO SCALE

36" MAX.

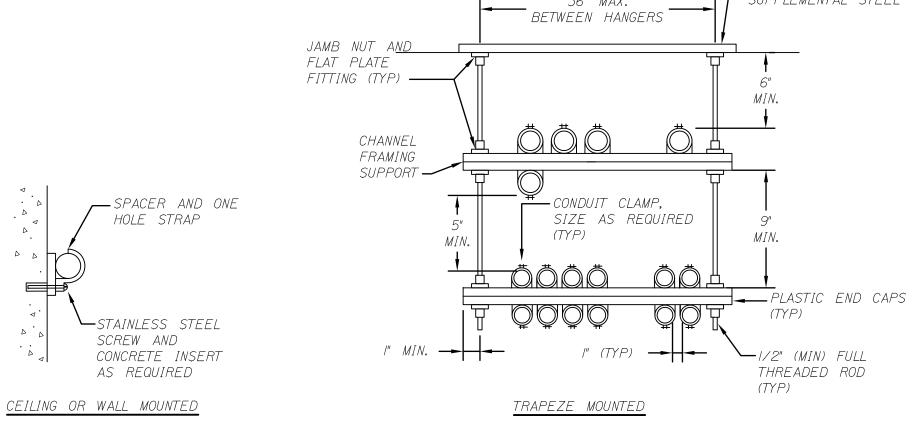

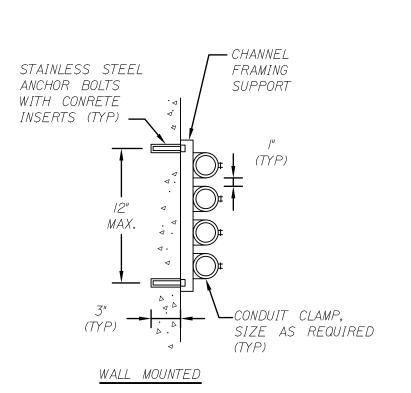

CONDUIT MOUNTING SCALE: NOT TO SCALE

		LUMINAIRE SCHEDULE						
TYPE	DESCRIPTION	CONTROLS	LAMP	MINIMUM RATED LIFE (L70)	MOUNTING	LUMENS/ WATT	MINIMUM LUMENS	MANUFACTURER - CATALOG NUMBER
А	4' CHAIN HUNG AMBIENT LUMINAIRE - 4000K CCT, MIN 80 CRI, DAMP LOCATION RATED, DLC QUALIFIED, 5 YEAR WARRANTY, HANG AT 9'AFF	HARDWIRED SWITCH, OCCUPANCY SENSING	LED	50,000 HRS	CHAIN HUNG	130	4000	BASIS OF DESIGN - LITHONIA ZLID L48 3000LM FST MVOLT 40K 80CRI
В	4' CHAIN HUNG AMBIENT LUMINAIRE - 4000K CCT, MIN 80 CRI, DAMP LOCATION RATED, DLC QUALIFIED, 1400 LUMEN OUTPUT EMERGENCY BATTERY PACK, 5 YEAR WARRANTY, HANG AT 9'AFF	HARDWIRED SWITCH, OCCUPANCY SENSING	LED	50,000 HRS	CHAIN HUNG	130	4000	BASIS OF DESIGN - LITHONIA ZLID L48 3000LM FST MVOLT 40K 80CRI EI5WLCP
С	4' CHAIN HUNG AMBIENT LUMINAIRE - 4000K CCT, MIN 80 CRI, DAMP LOCATION RATED, DLC QUALIFIED, 1400 LUMEN OUTPUT EMERGENCY BATTERY PACK, 5 YEAR WARRANTY, INTEGRAL OCCUPANCY SENSOR HANG AT 9'AFF	INTEGRAL OCCUPANCY SENSING	LED	50,000 HRS	CHAIN HUNG	130	4000	BASIS OF DESIGN - LITHONIA ZLID L48 3000LM FST MVOLT 40K 80CRI EI5WLCP LB0ZU
D	BATTERY BACK-UP REMOTE CAPABLE EXIT SIGN, 5W, INJECTION MOLDED ENGINEERING-GRADE UV-STABLE THERMOPLASTIC, UL94V-O FLAME RATING, 90 MINUTE WATT OUTPUT RATED FOR CONNECTED REMOTE EMERGENCY LIGHTING AS SHOWN ON PLAN, 5 YEAR WARRANTY	ALWAYS ON	LED	NA	UNIVERSAL	NA	NA	BASIS OF DESIGN - LITHONIA LHQM LED R HORO SD
Ε	REMOTE DUAL HEAD EMERGENCY LIGHT, POWERED BY LUMINAIRE TYPE D, SEALED AND GASKETED CAST ALUMINUM, SEALED AND GASKETED JUNCTION BOX COVER, W LOCATION RATED, 5 YEAR WARRANTY	EMERGENCY	LED	NA	WALL	NA	NA	BASIS OF DESIGN - LITHONIA ELA T QWP LO309 SD

(	Scale:	0 4/	0/		Designed b	y:				
		0 4'	8' 			(	St	antec		
	No.	Revision	Ву	Date						
					CONSULTANT	PROJECT	MANAGER:	LAUREN MEEK,	P.E.	
						Ву	Date		Ву	Date
					Designed	TJM		Checked	DMG	
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# THE GOLD STAR MEMORIAL HIGHWAY

EXIT 44 BUILDING RENOVATION

ELECTRICAL DETAILS

SHEET NUMBER: E-501

MTA PROJECT MANAGER: RALPH C. NORWOOD, IV, PE, PTOE

CONTRACT: 2019.16