#### MAINE TURNPIKE AUTHORITY

#### ADDENDUM NO. 3

#### <u>CONTRACT</u> <u>2021.02</u>

WATER LINE AND UTILITY VAULTS MM 47.1, 47.6, AND 48.5

#### The bid opening date is July 08, 2021 at 11:00 am.

The following changes are made to the Proposal, Specifications and Plans.

#### **GENERAL**

Utility Vault design at Station 2360+02 is revised and reflected in the plans and specifications.

Contractor shall submit any final questions by noon on July 01, 2021.

#### **PROPOSAL**

Revised Proposal P-sheets are attached. The following Item(s) are revised.

827.38 Sta. 2360+02 Vault Pipe Modification; Item added to the contract.

#### **SPECIFICATIONS**

- Notice To Contractor
  - Page N-1 is revised to change Bid Opening Date. See Attached.
- Special Provision 604 Manholes, Inlet, and Catch Basins (Utility Vault Extensions)
  - Page SP-41 through SP-43 are revised to include buttress wall construction and wall widening at the 2360+02 Vault.
- Special Provision 652 Maintenance of Traffic
  - Page SP-83 is revised to change the allowable merge with mainline times. See attached.
- Special Provision Section 01250 Measurement and Payment (Appendix D)
  - Page SP-101 is revised to add Pay Item 827.38 Sta. 2360+02 Vault Pipe Modification. See Attached.

#### **PLANS**

The complete plan set is reissued under this Addendum #3. Following is a brief summary of actual changes.

- Plan sheet 1, Index of Sheets, is revised to include additional 8" cast iron pipe removal and abandonment at the Station 2360+02 Vault. See attached.
- Plan sheet 2, Estimate of Quantities, is revised to add Item 827.38 Vault Pipe Modification. See attached.
- Plan sheets 26 through 31, Structural Plans, are revised and plan sheet 29 added to include thickened wall construction and updated vault dimensions based on field conditions. See attached.
- Plan sheet 35, 8" Piping Modification, is added to the plan set. See attached.

#### **OUESTIONS**

The following are questions submitted to the Maine Turnpike Authority in writing or general comments. Answers to the questions are noted. Bidders shall utilize this information in preparing their bid.

- Question 1: SP 83 6th paragraph states construction vehicles are prohibited from merging with mainline traffic between 6:00 AM and 10:00AM and 3pm and 7pm. Are pick-up trucks, single axle rack trucks, and employee vehicles considered a "construction vehicle" or is the MTA's intent that concrete trucks, dump trucks, tractor trailers, or similar large vehicle not be allowed to merge during these times.
  - Answer: Special Provision 652, page SP-83, paragraph six, second sentence shall be deleted and replaced with the following: "Construction vehicles are prohibited from merging with mainline traffic between 7:00 a.m. and 8:30 a.m. and between 4:00 p.m. and 5:30 p.m. unless approved in writing from the MTA." This applies to all vehicles. The MTA will consider a request by the Contractor to allow pick-up trucks and personal vehicles to enter/exit during the above times if the Contractor proposes to provide adequate acceleration/deacceleration areas for merging."
- <u>Question 2:</u> Sheet 23 note 2 states "stainless steel strap shall be ASTM A666, type 201 and be installed at 2'-0" O.C. along the watermain pipe." What are the limits of this work, is it just the new extensions or is it also the existing vault? The typical section shows the straps bolting to the cradles although the cradles are not every 2'.
  - <u>Answer:</u> Stainless steel straps are required for the new extension only. Stainless steel straps are required at all cradles in lieu of 24" O.C.

#### **ATTACHMENTS**

•	Addendum No. 3	(3 pages)
•	Proposal Sheets	(6 pages)
•	Specifications	(6 pages)
•	Plans	(42 pages)

**Notes:** The above items shall be considered as part of the bid submittal.

The total number of pages included with this addendum is fifty-seven pages (57).

All bidders are requested to acknowledge the receipt of the Addendum No. 3 by signing below and faxing this sheet to Nathaniel Carll, Purchasing Department, Maine Turnpike Authority at 207-871-7739. Bidders are also required to acknowledge receipt of this Addendum No. 3 on Page P-8 of the bid package.

**Business Name** 

Print Name and Title

Signature

Date

Very truly yours,

#### MAINE TURNPIKE AUTHORITY

Nathaniel Carll Purchasing Department Maine Turnpike Authority

#### SCHEDULE OF BID PRICES CONTRACT NO. 2021.02 WATER LINE AND UTILITY VAULTS MM 47.1, MM 47.6, AND MM 48.5

Item No	Item Description	Units	Approx. Quantities	Unit Price in Numbe		Bid Amount in Numbers	
		onito		Dollars	Cents	Dollars	Cents
202.12	Remove Existing Structural Concrete	Cubic Yard	50				
203.20	Common Excavation	Cubic Yard	980				
203.25	Granular Borrow	Cubic Yard	280				   
304.14	Aggregate Base Course - Type A	Cubic Yard	850				   
403.213	Hot Mix Asphalt, 12.50 mm Nominal Maximum Size (Base and Intermediate Base Course)	Ton	80				     
409.15	Bituminous Tack Coat RS1 or RS1h - Applied	Gallon	15				   
419.30	Sawing Bituminous Pavement	Linear Foot	450				   
501.231	Dynamic Load Test	Each	2				   
501.40	Steel H-beam Piles, 53 lb/ft, delivered	Linear Foot	865				
501.401	Steel H-beam Piles, 53 lb/ft, in place	Linear Foot	865				
501.90	Pile Tips	Each	10				   

	1	1			CONTR	ACT NO: 2021	.02
ltem No	Item Description	Units	Approx. Quantities	Unit Prices in Number		Bid Amount in Numbers	
				Dollars	Cents	Dollars	Cents
				BROUGHT FOR	WARD:		
501.91	Pile Splices	Each	10				
501.92	Pile Driving Equipment Mobilization	Lump Sum	1				
511.091	Temporary Earth Support Systems	Lump Sum	1				
514.06	Curing Box for Concrete Cylinders	Each	1				
526.306	Temporary Concrete Barrier, Type I - Supplied by Authority (1,760 LF)	Lump Sum	1				
527.341	Work Zone Crash Cushions - TL-3	Unit	5				
603.175	18 inch Reinforced Concrete Pipe - Class III	Linear Foot	37				
603.195	24 inch Reinforced Concrete Pipe - Class III	Linear Foot	20				
603.28	Concrete Collar	Each	1				
603.281	Concrete Collar for Watermain	Each	1				
604.1581	Utility Vault Extension - STA 2360+02.55 NB	Lump Sum	1				
604.1582	Utility Vault Extension - STA 2340+52.81 NB	Lump Sum	1				

	T	1			CONTR	ACT NO: 2021	.02	
ltem No	Item Description	Units	Approx. Quantities	Unit Price in Number		Bid Amou in Numbe		
				Dollars	Cents	Dollars	Cents	
	·		·	BROUGHT FOR	WARD:			
604.1583	Utility Vault Extension - STA 2340+52.81 SB	Lump Sum	1					
606.366	Guardrail, Removed and Reset, Type 3c	Linear Foot	540					
610.08	Plain Riprap	Cubic Yard	11					
610.18	Stone Ditch Protection	Cubic Yard	5					
613.319	Erosion Control Blanket	Square Yard	200				   	
615.07	Loam	Cubic Yard	170				   	
618.14	Seeding Method Number 2	Unit	15					
619.1201	Mulch - Plan Quantity	Unit	15					
619.1202	Temporary Mulch	Lump Sum	1					
620.58	Erosion Control Geotextile	Square Yard	54					
627.712	White or Yellow Pavement Marking Line	Linear Foot	300					
627.73	Temporary 6 inch Pavement Marking Tape	Linear Foot	600				+	

			_		CONTR	ACT NO: 2021.	02
Item No	Item Description	Units	Approx. Quantities	Unit Prices in Numbers		Bid Amoui in Number	
				Dollars	Cents	Dollars	Cents
	•	•		BROUGHT FOR	WARD:		•
629.05	Hand Labor, Straight Time	Hour	15				
631.12	All Purpose Excavator (Including Operator)	Hour	15				+
631.172	Truck-Large (Including Operator)	Hour	15				+
631.22	Front End Loader (Including Operator)	Hour	15				+
631.36	Foreman	Hour	15				+
652.30	Flashing Arrow	Each	1				+   
652.312	Type III Barricades	Each	2				+ 
652.33	Drum	Each	110				+
652.35	Construction Signs	Square Foot	660				+
652.361	Maintenance of Traffic Control Devices	Lump Sum	1				
652.41	Portable-Changeable Message Sign	Each	2				
652.45	Truck Mounted Attenuator	Calendar Day	15				
		<u> </u>					

					CONTR	ACT NO: 2021	.02
ltem No	Item Description	Units	Approx. Quantities	Unit Prices in Number		Bid Amou in Numbe	
				Dollars	Cents	Dollars	Cents
				BROUGHT FOR	WARD:		
656.50	Bailed Hay, In Place	Each	15				
656.632	30 Inch Temporary Silt Fence	Linear Foot	900				
659.10	Mobilization (Utility Vaults)	Lump Sum	1				
659.11	Mobilization (Waterline)	Lump Sum	1				
822.3405	8" Class 52 DI Pipe Push On Joint	Linear Foot	10				
822.3605	12" Class 52 DI Pipe Push on Joint	Linear Foot	160				
823.311	12" Gate Valve	Each	2				
823.333	1" Air Release Valve	Each	2				
825.60	12" DR 11 HDPE Pipe	Linear Foot	390				
827.303	Unsuitable Material Below Trench Grade	Cubic Yard	50				
827.38	Sta. 2360+02 Vault Pipe Modification	Lump Sum	1				
845.211	Stone Pipe Support in Casing - NB, SB, & SB On Ramp	Lump Sum	1				

ltem No	Item Description	Units	Approx. Quantities	Unit Prices in Numbers		Bid Amount in Numbers		
				Dollars	Cents	Dollars	Cents	
BROUGHT FORWARD:								
845.212	Stone Pipe Support in Casing - NB Off Ramp	Lump Sum	1		   			
				тс	OTAL:			

#### MAINE TURNPIKE AUTHORITY

#### NOTICE TO CONTRACTORS

Sealed Proposals will be received by the Maine Turnpike Authority for:

#### CONTRACT 2021.02

#### WATER LINE AND UTILITY VAULTS MM 47.1, MM 47.6, AND MM 48.5

at the office of the Maine Turnpike Authority, 2360 Congress Street, Portland, ME, until 11:00 a.m., prevailing time as determined by the Authority on July 08, 2021 at which time and place the Proposals will be publicly opened and read. Bids will be accepted from Contractors **prequalified** by the Maine Department of Transportation for Highway Construction Projects. All other bids may be rejected. This Project includes a wage determination developed by the State of Maine Department of Labor.

The work consists of constructing utility vault extensions and watermain replacement on the Maine Turnpike in the City of Portland, Maine. The work includes embankment excavation, shoulder gravels and pavement construction, utility vault extension, watermain replacement, guardrail and culvert removal and replacement, maintenance of traffic and all other work incidental thereto in accordance with the Plans and Specifications.

Plans and Contract Documents may be examined by prospective Bidders weekdays between 8:00 a.m. and 4:30 p.m. at the office of the Maine Turnpike Authority, 2360 Congress Street, Portland, Maine. **The half size Plans** and Contract Documents may be obtained from the Authority upon payment of Seventy-Five (\$75.00) Dollars for each set, which payment will not be returned. Checks shall be made payable to: Maine Turnpike Authority. The Plans and Contract Documents may also be downloaded from a link on our website at <u>http://www.maineturnpike.com/project-and-planning/Construction-Contracts.aspx</u>.

For general information regarding Bidding and Contracting procedures, contact Nate Carll, Purchasing Manager, at (207)482-8115. For information regarding Schedule of Items, plan holders list and bid results, visit our website at <u>http://www.maineturnpike.com/project-and-planning/Construction-Contracts.aspx</u>. For Project specific information, fax all questions to Nate Carll, Purchasing Manager, at (207) 871-7739 or email ncarll@maineturnpike.com. Responses will not be prepared for questions received by telephone. Bidders shall not contact any other Authority staff or Consultants for clarification of Contract provisions, and the Authority will not be responsible for any interpretations so obtained.

All work shall be governed by the Specifications entitled "State of Maine, Department of Transportation, Standard Specifications, Revision of November 2014", "Standard Details, Revision of November 2014" and "Best Management Practices for Erosion and Sediment Control", latest issue. Copies and recent updates to these publications can be downloaded at: <u>http://www.maine.gov/mdot/contractors/publications/</u>.

N - 1 (Revised 6/30/2021)

#### SPECIAL PROVISION

#### SECTION 604

#### MANHOLES, INLETS, AND CATCH BASINS

#### (Utility Vault Extensions)

#### 604.01 Description

The following sentences are added:

This work shall also include the partial demolition of the existing utility vaults and manholes and construction of the utility vault extensions as shown on the Contract Plans. This work shall also include developing and submitting for approval, a construction procedure, temporary water main support system, and temporary earth support to protect the water main, and coordination with Portland Water District as described in the Contract Plans and these Specifications. This work also includes the installation of new manholes as Manufactured by Neenah Foundry Company, Catalog Number R-6660-NH. This work also includes construction of buttress walls and thickening of the wall of the existing utility vault at station 2360+02.

#### 604.02 Materials

The following sentence is added:

Except as otherwise provided on the plans, reinforcing steel shall be epoxy coated reinforcing bars meeting the requirements of Section 503 – Reinforcing Steel. All concrete work shall be in accordance with the requirements of Section 502 – Structural Concrete.

#### 604.03 Construction Requirements

The following sentences are added:

The Contractor shall develop a construction procedure, temporary water main support, and temporary support systems that will protect, at all times, the 42" Cast Iron Pipe (1912, leaded joint) – at station 2360+02.55 and the 42" Reinforced Concrete Cylinder Pipe (1931, rubber and steel joint) – at station 2340+50.81, during construction of the tunnel extensions. Each water main will be removed from service by Portland Water District (PWD) during the work by closing valves on each side of the work area.

The Contractor is required to fully complete the work on one utility vault before work can begin on the other utility vault. Water mains can be removed from service between April 15<sup>th</sup> and December 10<sup>th</sup> and all work shall be completed within those dates. Winter shut offs are not permitted.

The maximum pipe support spacing shall be 6' along the pipeline. The temporary watermain support system and temporary earth support shall be designed by a professional engineer licensed in the State of Maine and reviewed by the Resident Engineer and PWD prior to the start of construction.

SP - 41 (Revised 6/28/2021) Page 11 of 57 PWD shall receive at least 30-days advance notice of work to be performed within the PWD's easements or Rights-of-Way. No work shall be performed within the PWD pipeline easements or Rights-of-Way without prior approval of PWD and a PWD representative being on-site for inspection purposes.

The vault structure shall follow the horizontal alignment of the existing water main.

Bars broken during removal of existing concrete shall be replaced at the Contractors expense by drilling and anchoring. Material used for drilling and anchoring dowels shall be selected from MaineDOT's Qualified Products list of Epoxy and Resin Bonding Agents.

Concrete demolition required to construct the utility vault extensions, as shown in the Contract Plans, shall be completed in accordance with Standard Specification 202 Removing Existing Structural Concrete. The Contractor shall use extreme care during demolition to avoid damaging components to remain. Any damage to components to remain shall be repaired to MTA's and PWD's satisfaction at no additional cost to the MTA. Structural Excavation and backfill, as shown in the Contract Plans, shall be completed in accordance with Standard Specification 206 Structural Earth Excavation – Drainage & Minor Structures Below Grade.

#### 604.05 Method of Measurement

The following sentences are added:

Utility vault extensions shall be measured as one lump sum, per location, satisfactorily completed and in place as shown on the Contract Plans.

Where required on the Plans, installation of steel H-piles and all related pay items shall be paid for under their respective 501 pay items.

Where required on the Plans, removal of the existing concrete buttress wall shall be paid for under item 202.12 Remove Existing Structural Concrete.

#### 604.06 Basis of Payment

The following sentences are added:

Payment shall be full compensation for partial demolition of existing utility vaults and manholes, furnishing all labor, equipment and materials including excavation, foundation material, backfill material, temporary supports, structural concrete, epoxy coated reinforcing, and all incidentals required to complete the construction of the Utility Vault Extensions and modifications to the existing Utility Vault in accordance with the Plans and these Specifications.

Payment will be made under:

### Pay Item

### <u>Pay Unit</u>

604.1581	Utility Vault Extension – STA 2360+02.55 NB	Lump Sum
604.1582	Utility Vault Extension – STA 2340+52.81 NB	Lump Sum
604.1583	Utility Vault Extension – STA 2340+52.81 SB	Lump Sum

Where space is available pavement striping for all tapers shall create a minimum buffer of 250 feet to the point where the temporary concrete barrier taper ends and becomes parallel to the travelway. Temporary concrete barrier shall be tapered at a minimum 8:1 unless space is available and then it should be tapered at 15:1 or 100 feet whichever is longest.

Lane shifts and maintenance of traffic layouts merging with Adjacent Contracts, including the layouts contained in this Contract, shall be coordinated with the Adjacent Contractor and the Resident Engineer to ensure work zones are not impacted and that traffic is shifted smoothly from one work zone to the other. Contractor shall provide a 30-day notice to the Resident of all proposed changes to the maintenance of traffic layouts affecting Adjacent Work Zones. Precedence will be given to the Contract(s) executed before this contract, for all potential work zone overlaps.

Sawcutting and paving of mainline shoulders and interchange ramps shall be done between 9:00 p.m. and 5:00 AM, unless otherwise shown on the Maintenance of Traffic Phasing Plans or as directed by the MTA. Only a single ramp at an interchange may be closed at once. Ramp closures will not be permitted the day before or after holidays, on holidays, or on Saturdays or Sundays. The Contractor shall request approval from the Resident/Authority two weeks prior for all closures. Portable changeable message signs shall be used to provide advance notice and warning of the ramp closure. PCMS's shall be operational a minimum of 1 week prior to ramp closure to notify Patrons. The contractor shall coordinate PCMS locations with the Resident and the MTA.

Construction vehicles will not be allowed to cross active ramps. Equipment moves across ramps will require a short-term ramp closure (i.e. 5-minute maximum timeframe) utilizing State Police and must be approved by the Authority in advance. Ramp closures for equipment moves will not be permitted between 6:00 a.m. and 10:00 a.m. and between 3:00 p.m. and 7:00 p.m. All State Police shall be coordinated through the Maine Turnpike Authority. The Authority will make payment for the State Police officers and vehicles directly to the State Police.

Lane and/or ramp closure setup may not begin until the beginning time specified. Closures that are setup early or that remain in place outside of the approved time period shall be subject to a lane rental fee of \$1,000 per five minutes for every five minutes outside of the approved time. The installation of the construction signs will be considered setting up the lane closure. Removal of the last construction sign will be considered removal of the closure. Construction signs shall be installed immediately prior to the start of the closure and shall be promptly removed when no longer required. The installation and removal of a closure, including signs, channelizing devices, and arrow boards shall be a continuous operation. The Authority reserves the right to order the removal of an approved closure.

Access to, and egress from, the construction area shall be with the direction of travel without crossing traffic. Construction vehicles are prohibited from merging with mainline traffic between 7:00 a.m. and 8:30 a.m. and between 4:00 p.m. and 5:30 p.m. unless approved in writing from the MTA. The contractor shall develop work zone access/egress with acceleration and deacceleration areas and should utilize interchange ramp areas whenever feasible.

Loading/unloading trucks shall not be closer than six feet from an open travel lane.

Portable light towers will be required to illuminate the night construction work area(s) and shall be incidental to the Contract.

B. Basis of Payment: Payment of the unit price established in the Bid shall be full compensation for removing unsuitable excavated material below trench grade and replacing with granular bedding material as directed by the MTA resident.

#### 2.09 ITEM NO. 827.38 Sta. 2360+02 Vault Pipe Modification


- A. Method of Measurement: Lump Sum
- B. Basis of Payment: Payment of the unit price established in the Bid shall be full compensation for installation of fittings, removal and disposal of fittings, preparation of pipe and abandoning, and all associated work as specified and shown on Drawings.

#### **SECTION 01300 - SUBMITTALS**

#### PART 1 - GENERAL

#### 1.01 GENERAL REQUIREMENTS

- A. For all products to be incorporated into the Work submit to the M.T.A. resident who will distribute to Owner (Portland Water District) for approval sufficient information in the form of shop drawings, product data and/or samples such that the Owner can determine that the product is in compliance with the Technical Specifications and Drawings.
- B. Submit two (2) copies of each submittal. One (1) copy will be returned to the Contractor. Each copy shall include a cover sheet which clearly identifies the product and corresponding specification section. Each cover sheet shall bear the Contractor's stamp and signature certifying that the submittal is in full compliance with the Contract Documents or that any deviations from the Contract Documents are clearly identified on a separate sheet(s) labeled "Deviations From Contract Documents" and attached to the cover sheet.
- C. The Owner (P.W.D.) shall review the submittals and indicate their status as:
  - 1. "A" Approved Subject to the Requirements of the Contract
  - 2. "B" Approved as Noted, Subject to the Requirements of the Contract
  - 3. "C" Revise as Noted, Resubmittal Required
  - 4. "D" Not Approved
- D. Owner's review is only for general conformance with the design concept and general conformance with the information given in the Contract Documents. Corrections or comments made during the review do not relieve the Contractor from compliance with the requirements of the Contract Documents.
- E. Re-submittals: Make re-submittals under procedures specified for submittals; identify changes made since previous submittal.

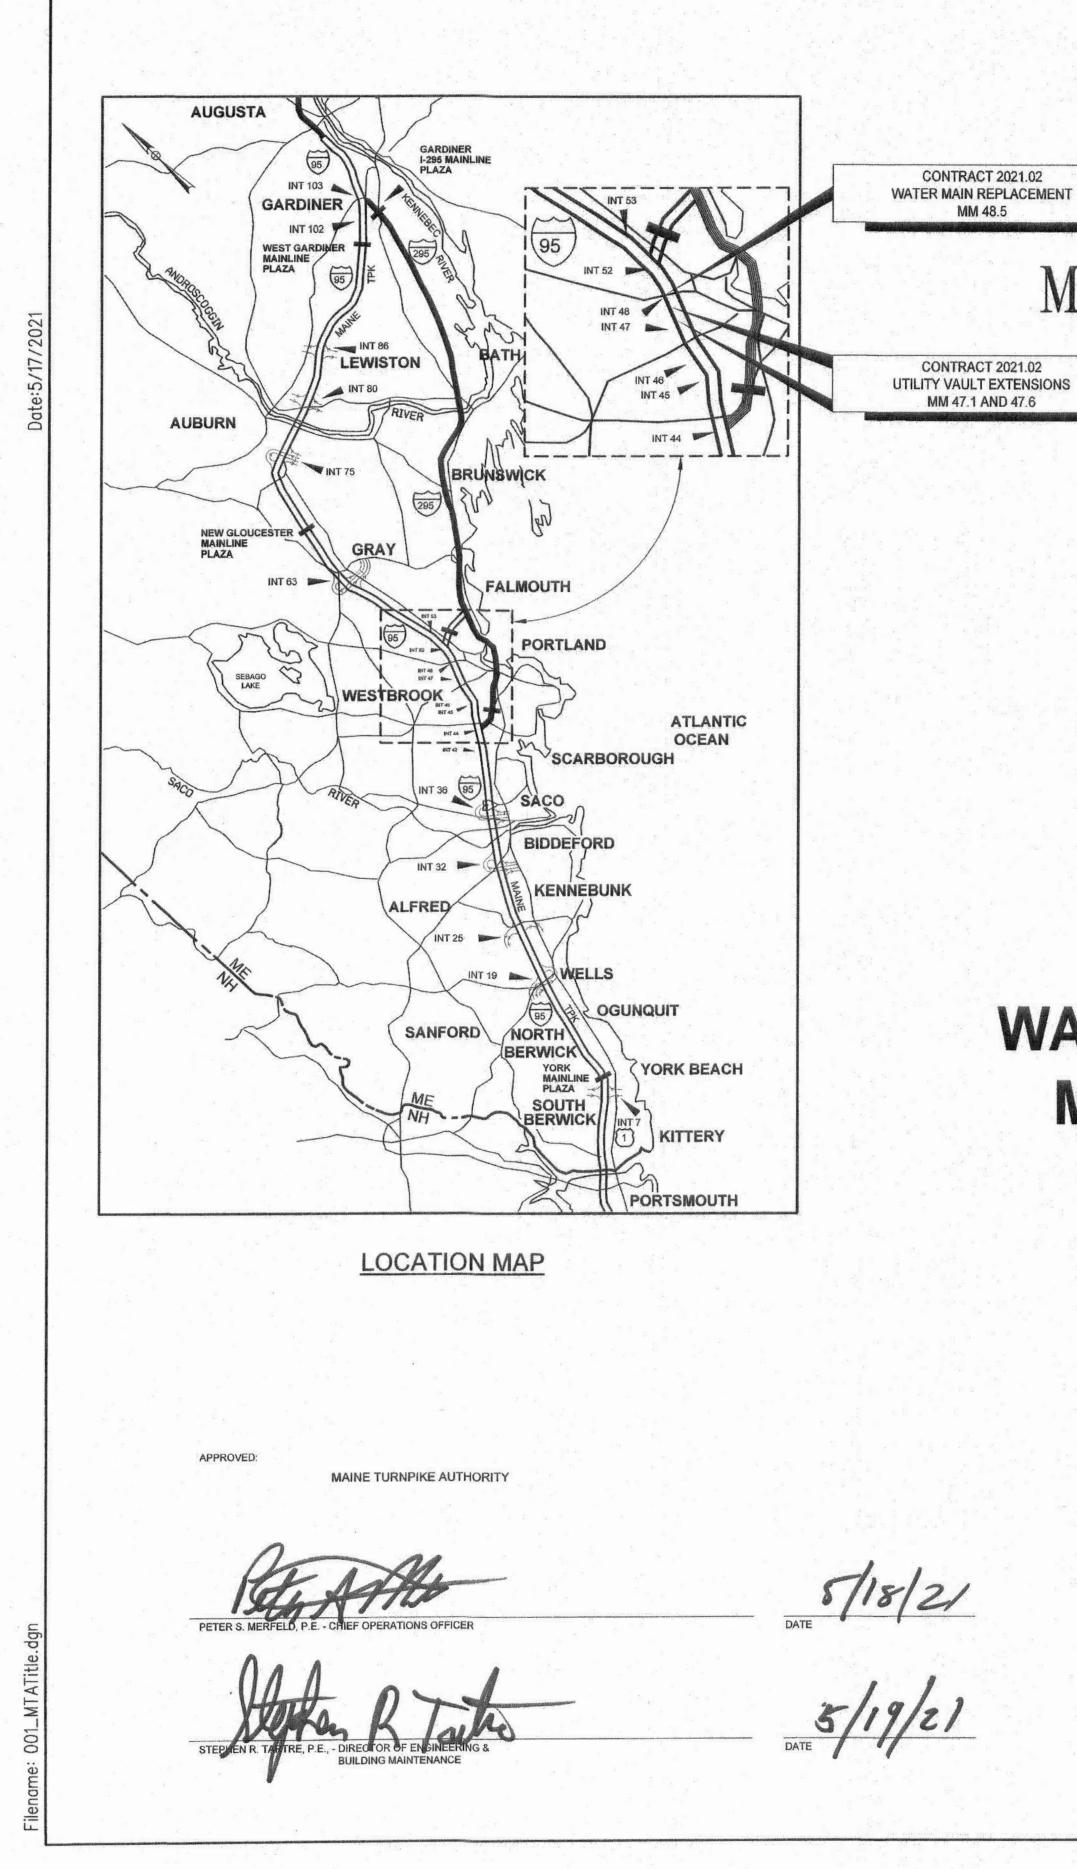



THE GOLD STAR **MEMORIAL HIGHWAY** 

# MAINE TURNPIKE AUTHORITY

DANIEL E. WATHEN, CHAIR ROBERT D. STONE, VICE CHAIR MICHAEL J. CIANCHETTE, MEMBER ANN R. ROBINSON, MEMBER THOMAS J. ZUKE, MEMBER JANE LINCOLN, MEMBER BRUCE VAN NOTE, MEMBER EX-OFFICIO


S. PETER MILLS, EXECUTIVE DIRECTOR

# **CONTRACT: 2021.02** WATER LINE AND UTILITY VAULTS MM 47.1, MM 47.6 AND MM 48.5

## **INDEX OF SHEETS**

SHEET NO.	DESCRIPTION
1	TITLE SHEET
2	ESTIMATE OF QUANTITIES AND GENERAL NOTES
3	TYPICAL SECTIONS
4-10	MAINTENANCE OF TRAFFIC
11-12	HIGHWAY PLANS
13	LIMIT OF DISTURBANCE
14-18	CROSS SECTIONS
19-31 )	UTILITY VAULT EXTENSION STRUCTURAL PLANS
∧ 32-34 )	WATER MAIN REPLACEMENT - PWD
/2\ 35 3	ABANDONED 8" CI PIPE PLANS - PWD
36-42 🥎	CONTRACT 2001.01 RAND ROAD RETAINING WALL
uu	ORIGINAL DESIGN PLANS



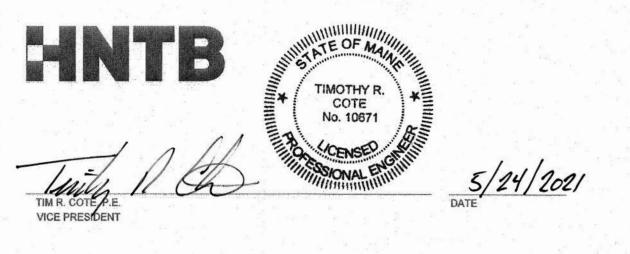

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## GUARDRAIL NOTES:

- AT THE END OF EACH WORK DAY, THE CONTRACTOR IS REQUIRED TO HAVE AN APPROVED CRASHWORTHY END TREATMENT ON ALL GUARDRAIL ITEMS, UNLESS NOTED OTHERWISE.
- 2. CONNECTIONS FOR PROPOSED GUARDRAIL TO EXISTING GUARDRAIL SHALL BE INCIDENTAL TO THE PROPOSED GUARDRAIL ITEMS, UNLESS OTHERWISE NOTED.
- 3. ALL GUARDRAIL SHALL BE INSTALLED IN A MANNER TO AVOID DRAINAGE STRUCTURES AND ELECTRICAL CONDUITS.
- 4. HOLES CREATED BY GUARDRAIL REMOVAL WILL BE FILLED AND COMPACTED WITH APPROVED MATERIALS AS DIRECTED BY THE RESIDENT. PAYMENT TO BE INCIDENTAL TO THE GUARDRAIL ITEMS.

## DRAINAGE NOTES:

- . INLETS AND OUTLETS OF ALL CULVERTS SHALL BE RIPRAPPED UNLESS OTHERWISE NOTED ON THE PLANS OR DIRECTED BY THE RESIDENT.
- 2. IF FOUNDATION MATERIAL IS REQUIRED UNDER CULVERTS, IT SHALL MEET THE REQUIREMENTS FOR GRANULAR BORROW - UNDERWATER BACKFILL.
- 3. ALL DITCH ELEVATIONS AND OFFSETS SHOWN ON THE CROSS SECTIONS ARE FOR THE FINISHED DITCH FLOW LINE.
- 4. THE CONTRACTOR SHALL MAINTAIN EXISTING DRAINAGE DURING CONSTRUCTION AS NEEDED FOR TEMPORARY USE, PRIOR TO PROPOSED DRAINAGE SYSTEMS BEING FUNCTIONAL AS IDENTIFIED ON PLANS.

## EROSION CONTROL NOTES:

- THE ANTICIPATED EROSION CONTROL DEVICES ARE SHOWN ON THE PLANS. THE CONTRACTOR SHALL PROPOSE ACTUAL TYPE AND LOCATION OF DEVICES FOR APPROVAL BY THE RESIDENT. ADDITIONAL MEASURES MAY BE PROPOSED BY THE CONTRACTOR DUE TO SITE OR WEATHER CONDITIONS. THE RESIDENT MAY DIRECT THE CONTRACTOR TO IMPLEMENT ADDITIONAL MEASURES. ANY ADDITIONAL MEASURES APPROVED BY THE RESIDENT WILL BE MEASURED FOR PAYMENT UNDER THE APPROPRIATE BID ITEMS.
- 2. EROSION CONTROL DEVICES USED AT EXIT 48 WATERLINE REPLACEMENT SHALL NOT BE MEASURED FOR PAYMENT AND SHALL BE CONSIDERED INCIDENTAL TO THE WATERLINE PAY ITEMS.
- 3. 4" LOAM HAS BEEN ESTIMATED FOR 100% OF THE DISTURBED SLOPE AREA UNLESS OTHERWISE SPECIFIED ON THE PLANS. ACTUAL PLACEMENT OF THE LOAM SHALL BE AS DESIGNATED BY THE RESIDENT.
- 4. ALL NON-ROCK SLOPES SHALL BE SEEDED WITH SEEDING METHOD NO. 2.
- 5. MULCH SHALL BE APPLIED IN SEEDED AREAS, EXCEPT WHERE EROSION CONTROL BLANKET IS SPECIFIED.
- 6. ALL TEMPORARY AND PERMANENT EROSION CONTROL DEVICES SHALL BE INSTALLED IN ACCORDANCE WITH THE MAINE DEPARTMENT OF TRANSPORTATION BEST MANAGEMENT PRACTICES.
- 7. TEMPORARY EROSION CONTROL BLANKET, ITEM 613.319 SHALL BE INSTALLED IN ALL DITCHES AND 2: SLOPES FROM TOP TO TOE OF SLOPE. LOAM AND SEED SHALL BE PLACED PRIOR TO THE INSTALLATION OF THE EROSION CONTROL BLANKET. LIMITS OF THE EROSION CONTROL BLANKET IN DITCHES SHALL BE 6'WIDE OR AS DESIGNATED BY THE RESIDENT.
- 8. TEMPORARY STABILIZATION WITH MULCH OR OTHER NON-ERODABLE COVER IS REQUIRED ON ALL EXPOSED SOILS THAT WILL NOT BE WORKED FOR MORE THAN 7 DAYS. AREAS WITHIN 75 FEET OF A WETLAND OR WATERBODY SHALL BE STABILIZED WITHIN 48 HOURS OF THE INITIAL DISTURBANCE OF THE SOIL OR PRIOR TO ANY STORM EVENT, WHICHEVER COMES FIRST. THE CONTRACTOR IS RESPONSIBLE FOR APPLYING TEMPORARY MULCH AS NECESSARY, IN ACCORDANCE WITH THE LATEST EDITION OF THE BMP'S, TO MINIMIZE SOIL EROSION PRIOR TO THE APPLICATION OF THE FINAL SLOPE TREATMENT.
- 9. TEMPORARY SEED SHALL BE APPLIED TO ALL DISTURBED AREAS THAT WILL NOT BE COMPLETED WITHIN 30 DAYS.
- IO. A DOUBLE ROW OF SILT FENCE PROTECTION SHALL BE INSTALLED AT ALL STREAM LOCATIONS AND OPEN WATER WETLANDS AS SHOWN ON THE PLANS, OR AS DIRECTED BY RESIDENT. AN ADDITIONAL QUANTITY IS INCLUDED FOR LOCATIONS NOT SPECIFICALLY SHOWN.
- II. STABILIZED CONSTRUCTION ENTRANCES MUST BE USED AND MAINTAINED.NO TRACKING OF SOIL ON THE MAINE TURNPIKE OR LOCAL ROADS WILL BE ALLOWED.

12. IF DIRECTED BY THE RESIDENT, EROSION CONTROL MIX SHALL BE USED IN PLACE OF LOAM AND SEED IN AREAS OF REGRADED TEMPORARY GRAVEL SHOULDER WIDENING. PAYMENT SHALL BE MADE PER THE CONTRACT UNIT PRICE OF THE LOAM PAY ITEM.

HNTB CORPORATION 82 Running Hill Road, Suite 201 South Portland, ME 04106 TEL (207) 774-5155 FAX (207) 228-0909



	ESTIMATED QUANTITIES			1	<del>.                                    </del>
TEM NO	DESCRIPTION		UTILITY VAULTS	TOTAL QUANTITY	UNIT
202.12	REMOVE EXISTING STRUCTURAL CONCRETE		(50)	50	СҮ
203.20	COMMON EXCAVATION	70	910	980	СҮ
203.25	GRANULAR BORROW	100	180	280	CY
304.14	AGGREGATE BASE COURSE - TYPE A	/50	700	850	CY
403.2/3	HOT MIX ASPHALT, 12.50 MM NOMINAL MAXIMUM SIZE		80	80	TON
	(BASE AND INTERMEDIATE BASE COURSE)		. –		
409.15	BITUMINOUS TACK COAT RSI OR RSIH - APPLIED		/5	15	GAL
419.30	SAWING BITUMINOUS PAVEMENT		450	450	LF
501.231	DYNAMIC LOAD TEST		2	2	EA
501 <b>.</b> 40	STEEL H-BEAM PILES, 53 LB/FT, DELIVERED		865	865	
501 <b>.</b> 401	STEEL H-BEAM PILES, 53 LB/FT, IN PLACE		865	865	LF
501.90 501.91	PILE TIPS		10 10	10 10	EA EA
501 <b>.</b> 91 501 <b>.</b> 92	PILE SPLICES PILE DRIVING EQUIPMENT MOBILIZATION		10	10	LA LS
501 <b>.</b> 92 511 <b>.</b> 091	TEMPORARY EARTH SUPPORT SYSTEMS			/	LS
5/4 <b>.</b> 06	CURING BOX FOR CONCRETE CYLINDERS			/	EA
526.306	TEMPORARY CONCRETE BARRIER, TYPE I		/	/	LA
220.000	- SUPPLIED BY AUTHORITY (1,760 LF)				
527.34	WORK ZONE GRASH GUSHIDHS TH3		-5-	~ 5 ~	UNIT
603.175	IĄ INCH REINFORCED CONCRETE PIPE - CLASS III		37	<u> </u>	LF
603.195	24 INCH REINFORCED CONCRETE FIPE - CLASS IN	<u>20</u>		$\sim_{20}$	P
603.28	CONCRETE COLLAR		1	/	EA
603.28/	CONCRETE COLLAR FOR WATERMAIN	/		/	ΕA
604.1581	UTILITY VAULT EXTENSION - STA 2360+02.55 NB			/	LS
604.1582	UTILITY VAULT EXTENSION - STA 2340+52.81 NB		1	/	LS
604.1583	UTILITY VAULT EXTENSION - STA 2340+52.81 SB		1	1	LS
606.366	GUARDRAIL, REMOVED AND RESET, TYPE 3C		540	540	LF
610.08	PLAIN RIPRAP				CY
610.18	STONE DITCH PROTECTION		5	5	CY
613.319	EROSION CONTROL BLANKET		200	200	SY
6/5.07	LOAM		170	170	CY
618.14	SEEDING METHOD NUMBER 2		/5	/5	UNIT
619 <b>.</b> 1201 619 <b>.</b> 1202	MULCH - PLAN QUANTITY TEMPORARY MULCH		/5	/5	UNIT LS
620 <b>.</b> 58	EROSION CONTROL GEOTEXTILE		54	54	SY
627 <b>.</b> 7/2	WHITE OR YELLOW PAVEMENT MARKING LINE		300	300	LF
627 <b>.</b> 73	TEMPORARY 6 INCH PAVEMENT MARKING TAPE		600	600	
629 <b>.</b> 05	HAND LABOR, STRAIGHT TIME	10	5	/5	HR
631.12	ALL PURPOSE EXCAVATOR (INCLUDING OPERATOR)	10	5	/5	HR
631.172	TRUCK-LARGE (INCLUDING OPERATOR)	10	5	15	HR
631.22	FRONT END LOADER (INCLUDING OPERATOR)	10	5	15	HR
631.36	FOREMAN	10	5	/5	HR
652 <b>.</b> 30	FLASHING ARROW		/	/	ΕA
652.312	TYPE III BARRICADES		2	2	EA
652 <b>.</b> 33	DRUM		110	110	EA
652.35	CONSTRUCTION SIGNS		660	660	SF
652.36/	MAINTENANCE OF TRAFFIC CONTROL DEVICES		/	/	LS
652.4/	PORTABLE-CHANGEABLE MESSAGE SIGN		2	2	EA
652.45	TRUCK MOUNTED ATTENUATOR		/5	/5	CD
656 <b>.</b> 50	BAILED HAY, IN PLACE		/5	/5	EA
656 <b>.</b> 632	30 INCH TEMPORARY SILT FENCE		900	900	LF
659 <b>.</b> 10	MOBILIZATION (UTILITY VAULTS)	1	/		LS
659 <b>.</b> // 822 <b>.</b> 3405	MOBILIZATION (WATERLINE) 8" CLASS 52 DI PIPE PUSH ON JOINT	/ 		10	LS LF
822.3405 822.3605		160		160	
823.311	12 CLASS 52 DI FIFE FUSH UN JUINT 12" GATE VALVE	2		160	EA
823 <b>.</b> 333	IZ GATE VALVE I" AIR RELEASE VALVE	2		2	EA EA
825.60	I AIR RELEASE VALVE	390		2 390	LF
827.303	LUSHITABLE MATERIAL BELOW TRENCH GRADE	$\sim$ $50$		$\sim 50$	-CX-
827.38	STA. 2360+02 VAULT PIPE MODIFICATION	$\gamma \gamma \gamma \gamma$	A		LS
845.211	STONE PIPE SUPPORT IN CASING - NB, SB, & SB ON RAME	<u>مرنم</u>			15
845 <b>.</b> 2/2	STONE PIPE SUPPORT IN CASING - NB, OFF RAMP	· · ·		,	LS

THE GOLD STAR

MEMORIAL HIGHWAY


WATER LINE AND UTILITY VAULTS


ESTIMATE OF QUANTITIES

AND GENERAL NOTES

CONTRACT: 2021.02

SHEET NUMBER: GN-01

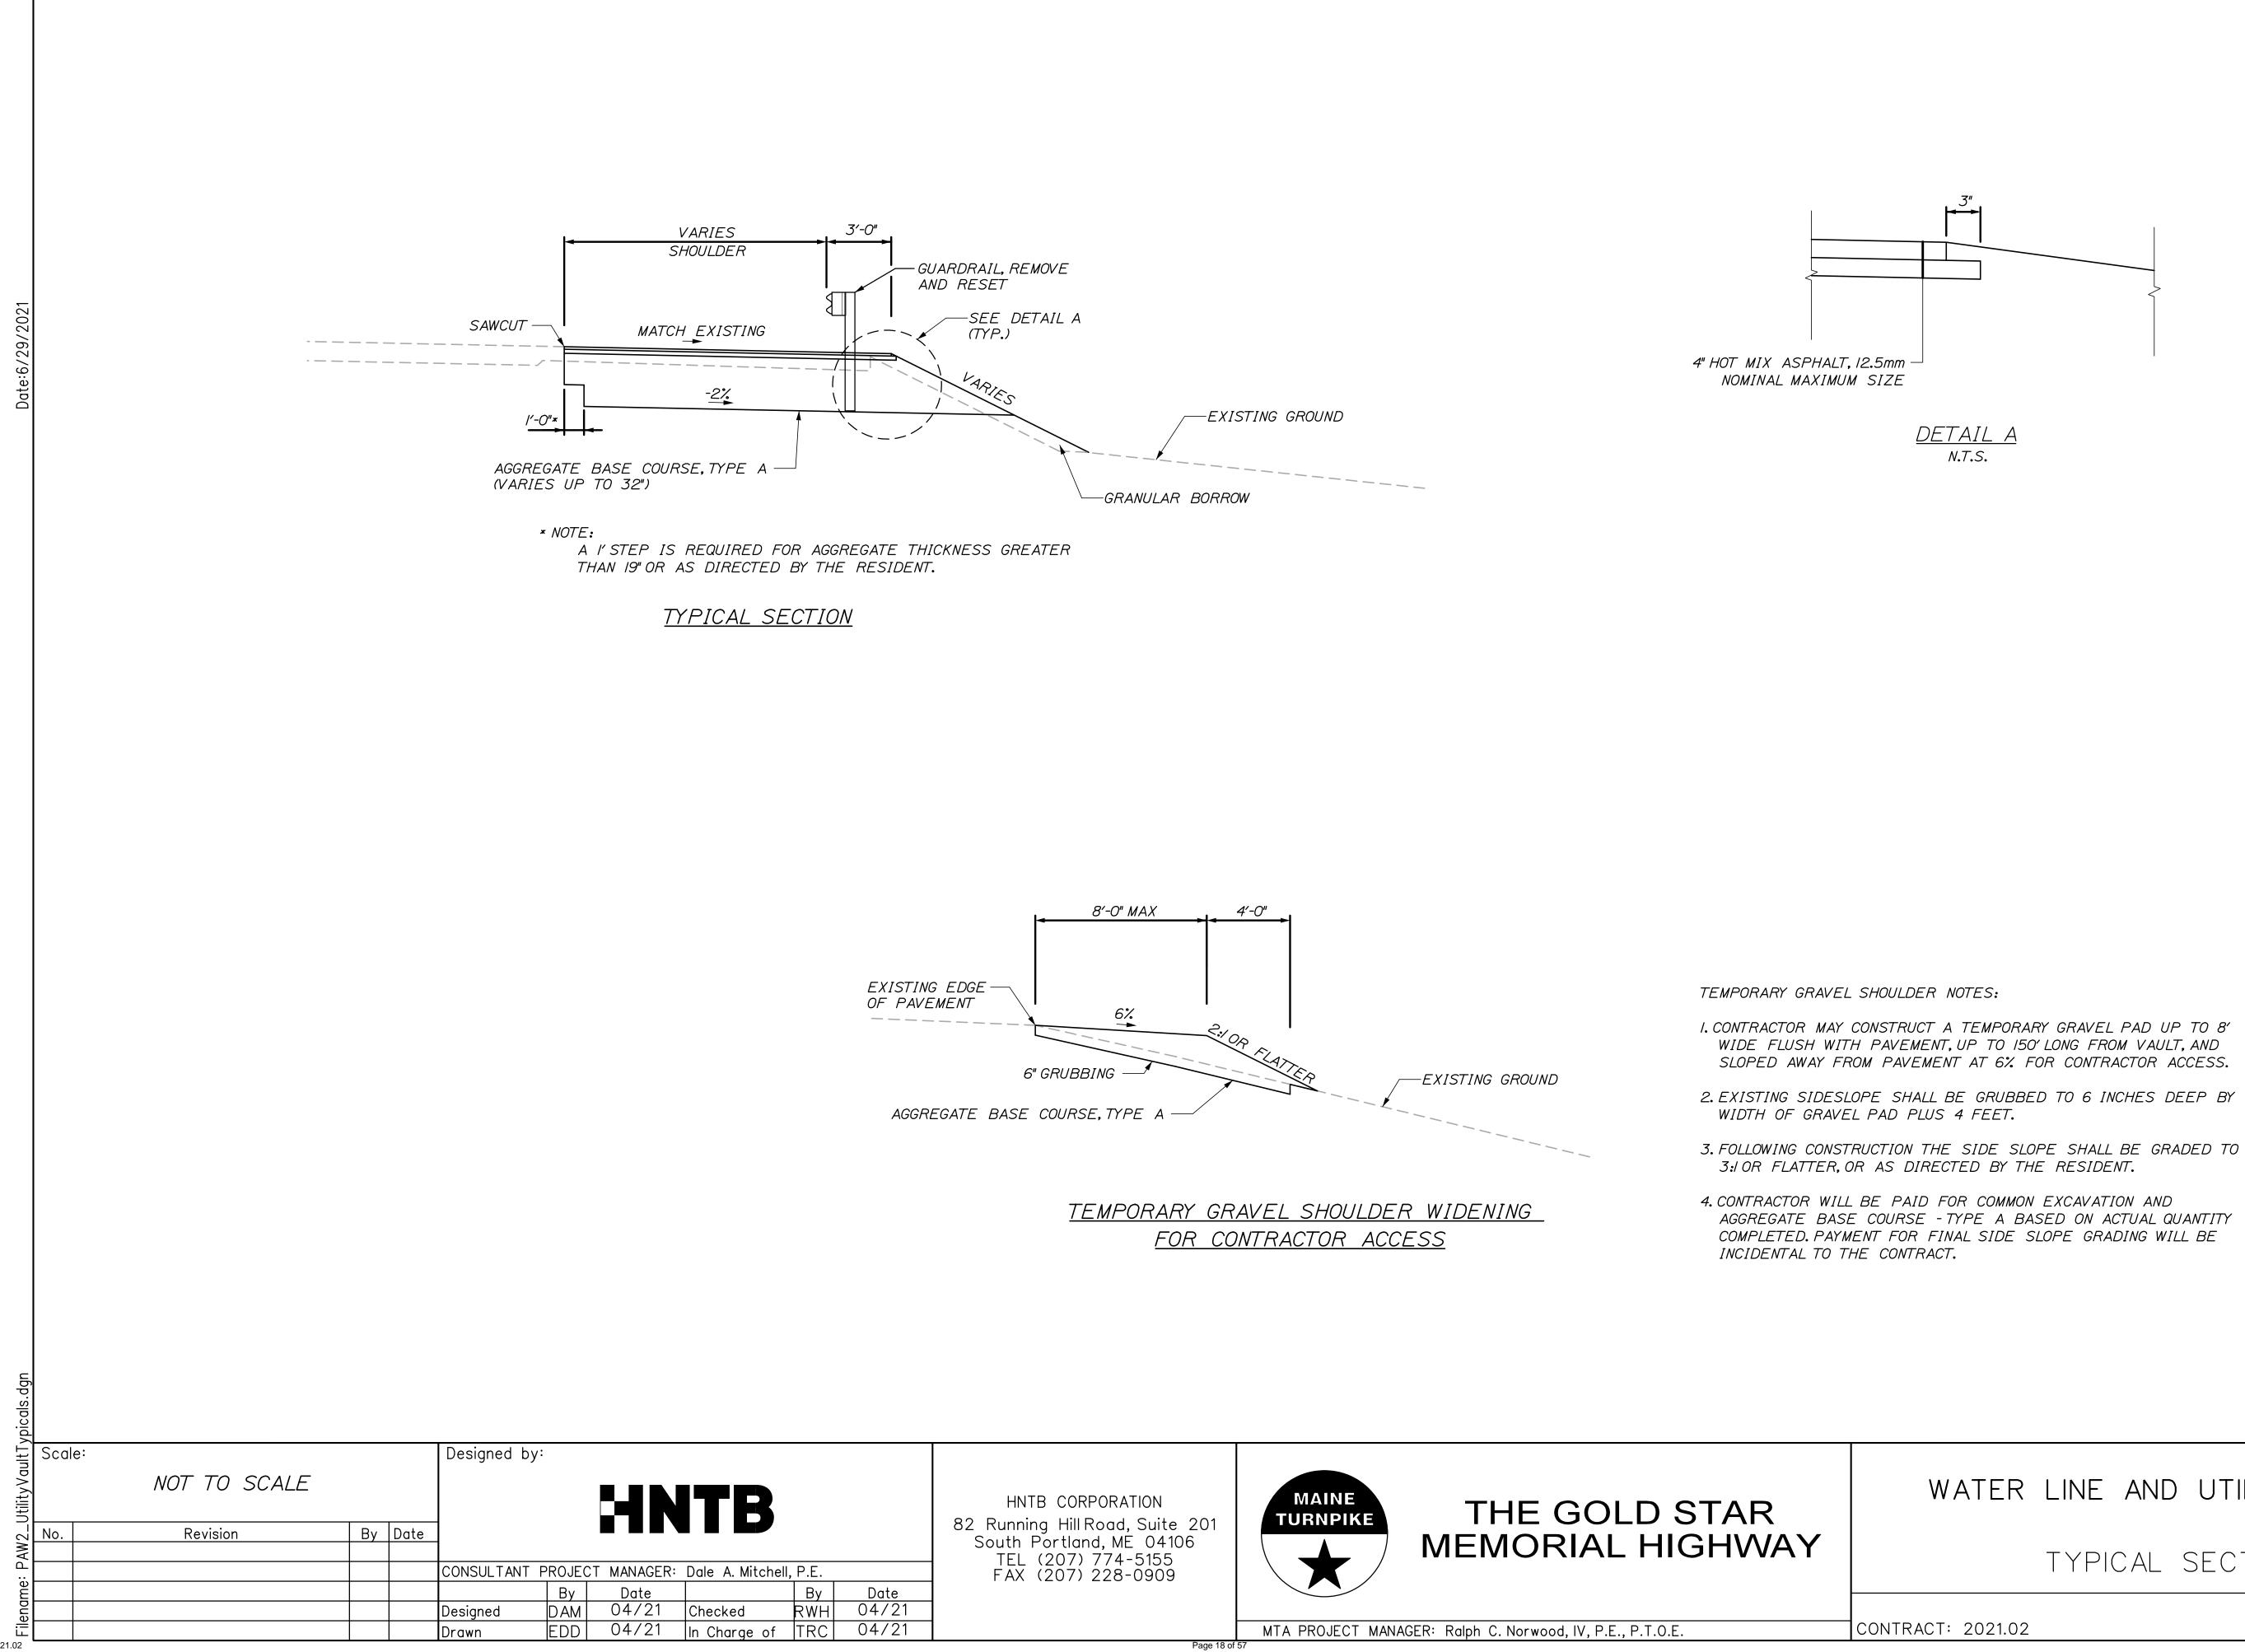

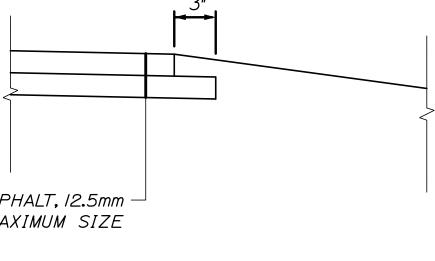


WATER LINE AND UTILITY VAULTS


TYPICAL SECTIONS

SHEET NUMBER: TYP-01


3 OF 42 Addendum 03

GENERAL MAINTENANCE OF TRAFFIC NOTES ALL WORK TO CONFORM TO MAINE DEPARTMENT OF TRANSPORTATION STANDARD SPECIFICATIONS, EXCEPT AS MODIFIED BY THE MAINE TURNPIKE AUTHORITY'S SUPPLEMENTAL AND SPECIAL PROVISIONS. ALL PAVEMENT STRIPING & SIGNING SHALL BE IN ACCORDANCE WITH THE "MANUAL ON UNIFORM TRAFFIC CONTROL 2. DEVICES", U.S.D.O.T., F.H.W.A., LATEST EDITION. 3. THESE PLANS SHOW THE GENERAL CONDITION FOR TURNPIKE MAINLINE AND RAMP TRAFFIC CONTROL. DURING CONSTRUCTION. SLIGHT MODIFICATIONS IN CONSTRUCTION PROCEDURE MAY OCCUR AND MAY REQUIRE SOME MINOR ADJUSTMENTS TO BE MADE IN THE FIELD. ALL PROCEDURES MUST BE APPROVED BY THE RESIDENT. 4. THE CONTRACTOR SHALL REMOVE ALL PAVEMENT MARKINGS THAT CONFLICT WITH PROPOSED PAVEMENT MARKINGS IN ACCORDANCE WITH THE SPECIFICATIONS AND MUTCD, PAYMENT SHALL BE INCIDENTAL TO THE CONTRACT. 5. TEMPORARY PAVEMENT MARKINGS SHALL BE TEMPORARY PAVEMENT MARKING TAPE, UNLESS OTHERWISE NOTED. PAYMENT FOR MARKINGS SHALL BE UNDER ITEM 627.73 - TEMPORARY 6 INCH PAVEMENT MARKING TAPE. EXPOSED BARRIER ENDS SHALL BE PROTECTED BY A WORK ZONE CRASH CUSHION. PAYMENT WILL BE UNDER ITEM 527.34I - WORK ZONE CRASH CUSHION - TL-3. 7. TAPER RATE FOR TEMPORARY CONCRETE BARRIER SHALL BE A MINIMUM OF 8: UNLESS MORE SPACE IS AVAILABLE. THEN THE BARRIER SHALL BE TAPERED AT 15:1 OR 100', WHICHEVER IS LONGEST. THE TAPERED BARRIER LENGTH IS DEPENDENT ON THE LOCATION OF THE BARRIER RELATIVE TO THE MAINE TURNPIKE SHOULDERS OR LANES. THE BARRIER SHALL TERMINATE AT A LOCATION WHERE A CRASH CUSHION CAN BE INSTALLED A MINIMUM OF 3 FEET FROM THE TRAVEL LANE. ALL TEMPORARY CONCRETE BARRIER SHALL HAVE DRAINAGE SLOTS TO ALLOW FLOW OF WATER. TEMPORARY CONCRETE BARRIER. 8. SET AT LOW POINTS, SHALL BE SET ON BLOCKING PER SPECIAL PROVISIONS. 9. ALL TEMPORARY WORK ZONE DEVICES SHALL BE MASH 2016 COMPLIANT UNLESS SUCH DEVICE(S) CAN BE SHOWN TO BE MASH 2009 OR NCHRP-350 COMPLIANT AND ARE STILL WITHIN THEIR NORMAL SERVICE LIFE AS DETERMINED BY THE RESIDENT. IO. CONTRACTOR SHALL SUBMIT PHASING SEQUENCE LAYOUTS AND WORK ELEMENTS FOR EACH CONSTRUCTION LOCATION, INCLUDING LANE AND SHOULDER WIDTH AND SAWCUT LOCATIONS FOR APPROVAL PRIOR TO CONSTRUCTION. SAWCUTS SHALL BE AT THE EDGE OR MIDDLE OF LANE UNLESS OTHERWISE APPROVED. \_//' MIN. \_//' MIN. \_ <u> МIN. |||</u> @ 40' ABBREVIATIONS FOR ALL MOT PLANS SHOULDER CLOSURE TSSW - 6" TEMPORARY SINGLE SOLID WHITE LINE (MAINLINE) TSBW - 6" TEMPORARY SINGLE BROKEN WHITE LINE TSDW - 6" TEMPORARY SINGLE DASHED WHITE LINE SHOULDER CLOSURE TSSY - 6" TEMPORARY SINGLE SOLID YELLOW LINE NOTES: Ι. WITHIN A PREVIOUSLY ESTABLISHED WORK ZONE. FOR REVIEW AND APPROVAL BY MTA. Designed by: Scale: NOT TO SCALE HNTB By Date Revision No. CONSULTANT PROJECT MANAGER: Dale A. Mitchell, P.E. By By Date DAM 04/21 RWH Checked Designed In Charge of TRC 04/21 04/21 EDD Drawn

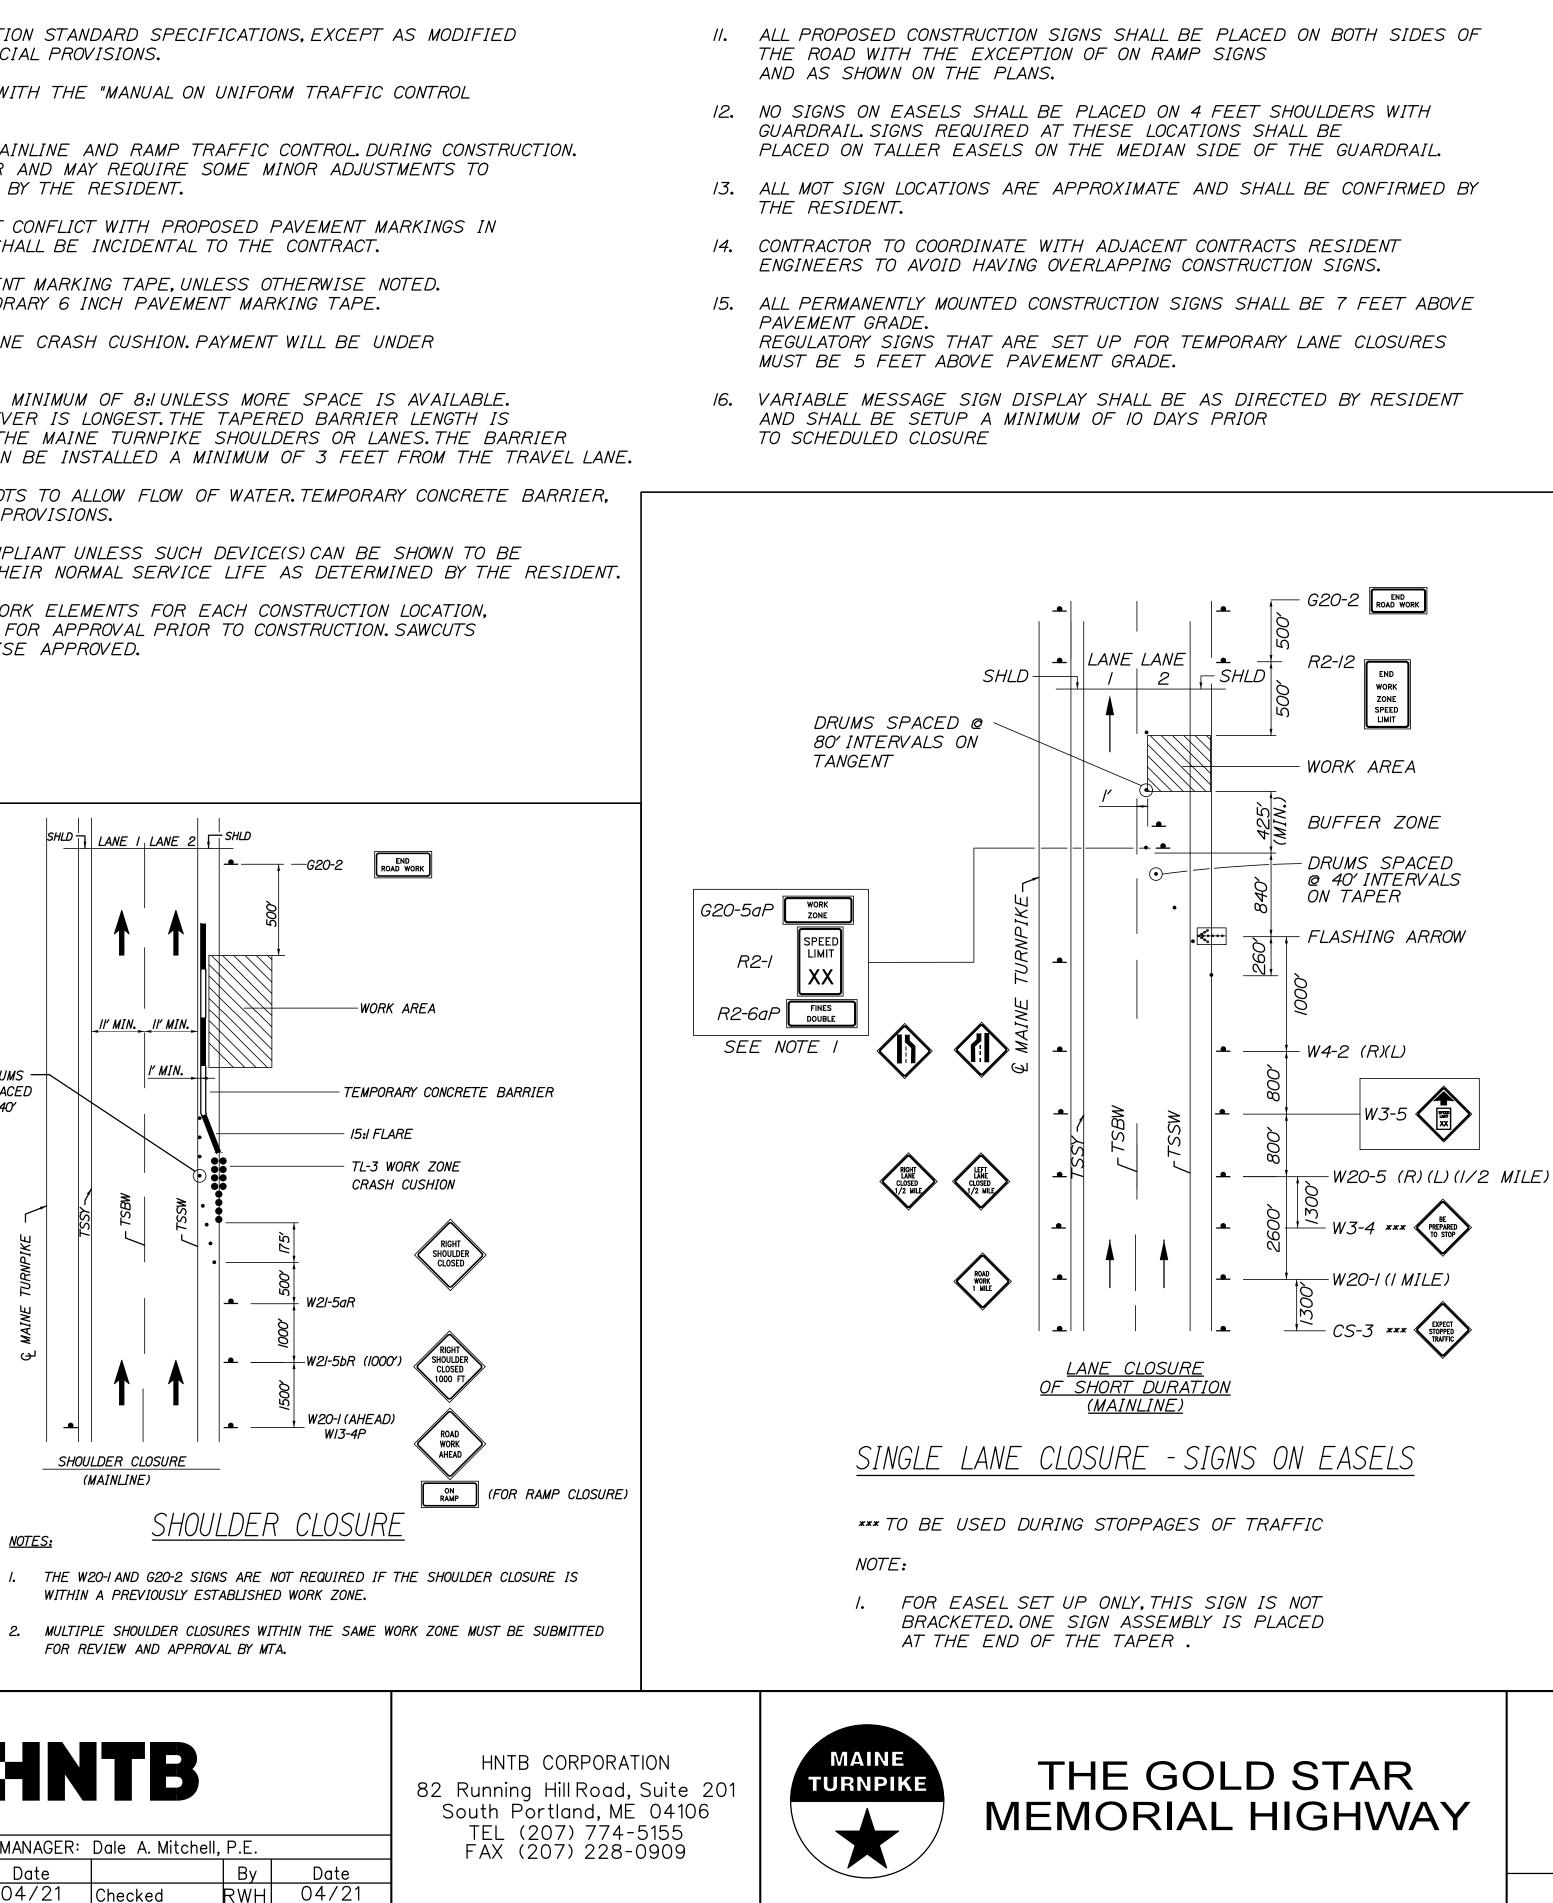


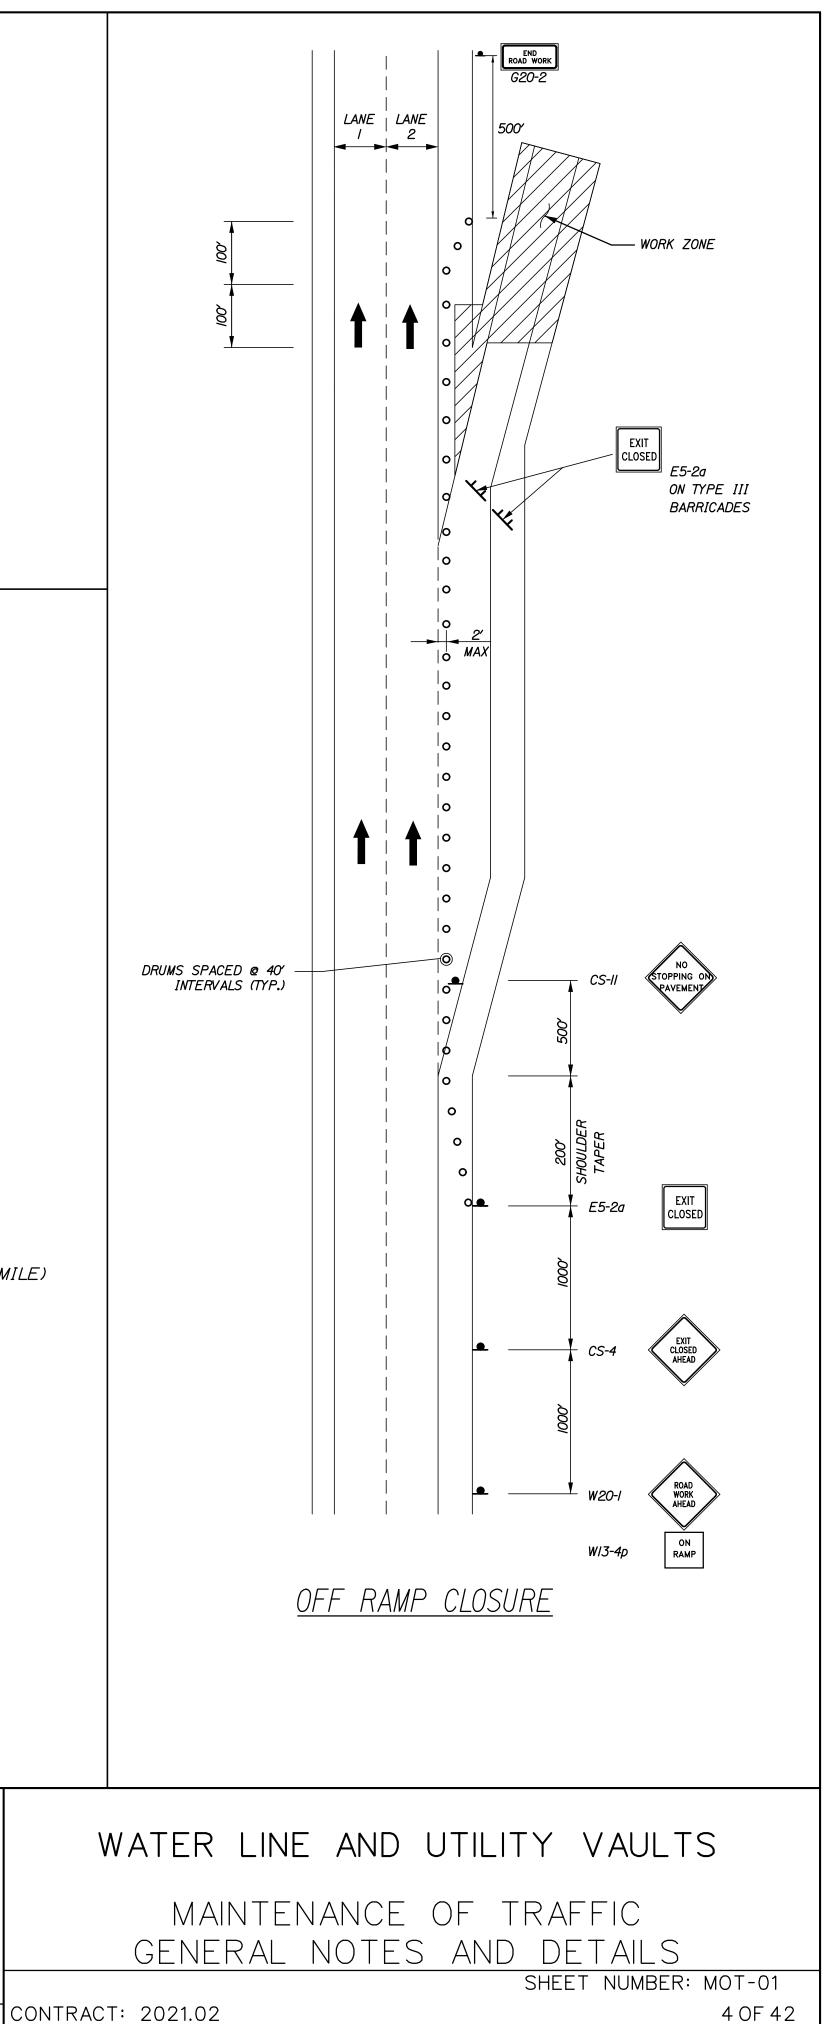



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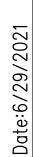

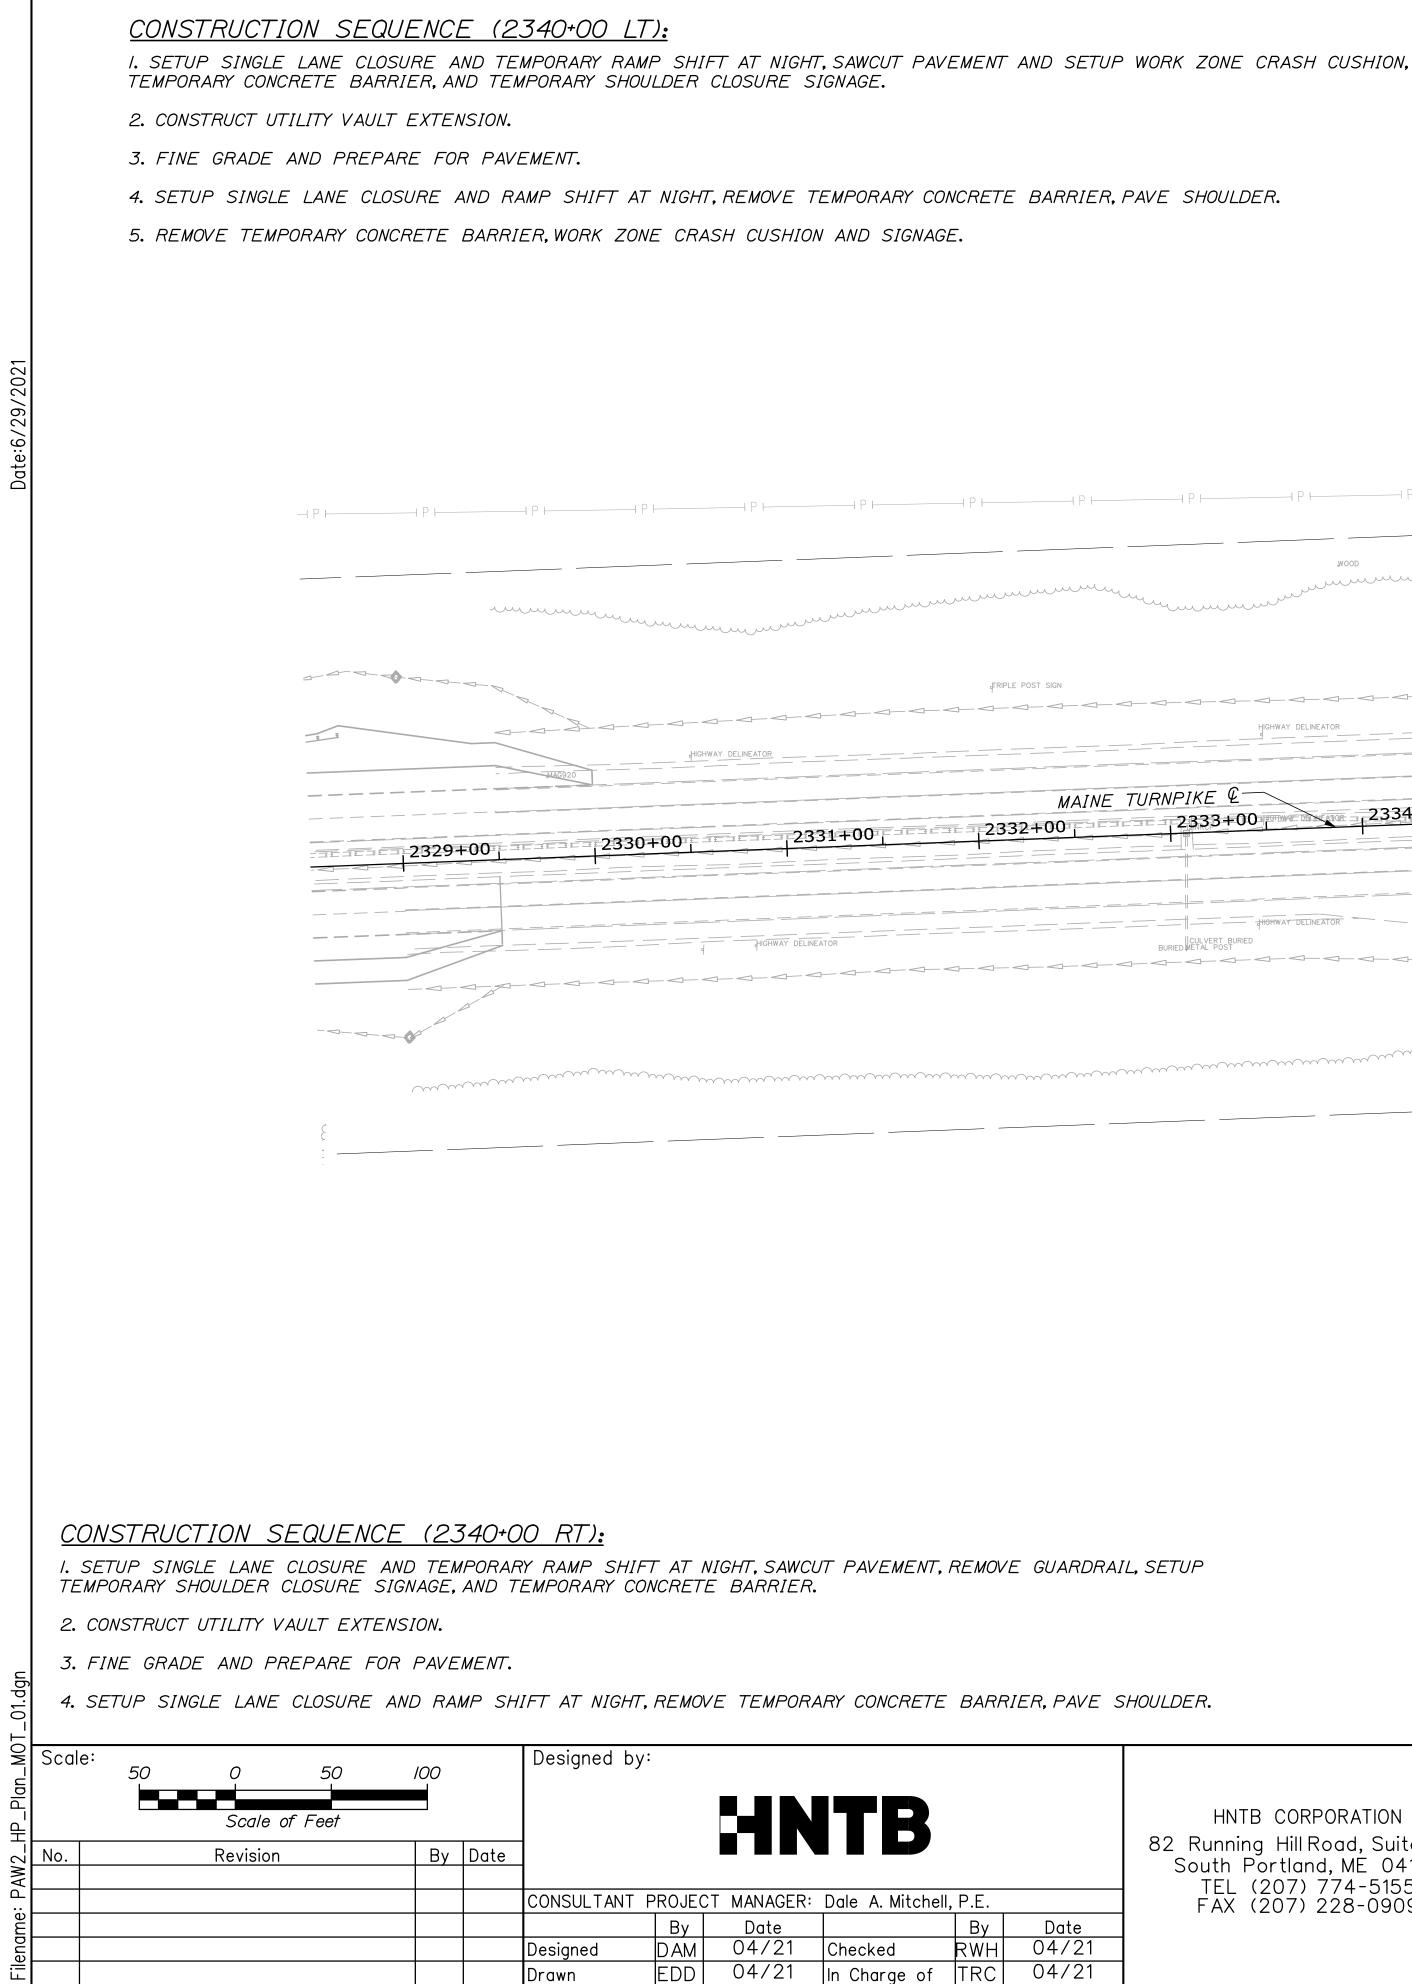
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	EL	EC PEDESTAL, INVERIER PANEL SOLAR PANEL ÉLEC PEDESTAL		
SIGN				
HIGHWAY DELINEATOR	AINE TURNPIKE			2340+0 TEMPO
MAINE TURNPIKE @	SOUTHBOUND			z z 2338 ± 00 / z / z z z z z z / ź / z / z / z / z / z / z
	IAINE TURNPIKE	$\rightarrow$		
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			GAS MARKER POST	t t t t
		B	GIN TEMPORARY DNCRETE BARRIER	× ~
			STA. 2339+50 TEMPORARY ( BARRIER	
				T SHOULDER
			/	
UARDRAIL, SETUP	/	/ /		
PAVE SHOULDER.	/		/ / /	
			,	
HNTB CORPORATION 82 Running HillRoad, Suite	201 MAINE	THE	GOLD ST	AR
82 Running Hill Road, Suite South Portland, ME 04106 TEL (207) 774-5155 FAX (207) 228-0909	$\mathbf{S}$		RIAL HIGH	HWAY
FAX (207) 228-0909 Date 4/21				-
4/21	MTA PROJECT M	ANAGER: Ralph C. Norwo	od, IV, P.E., P.T.O.E.	




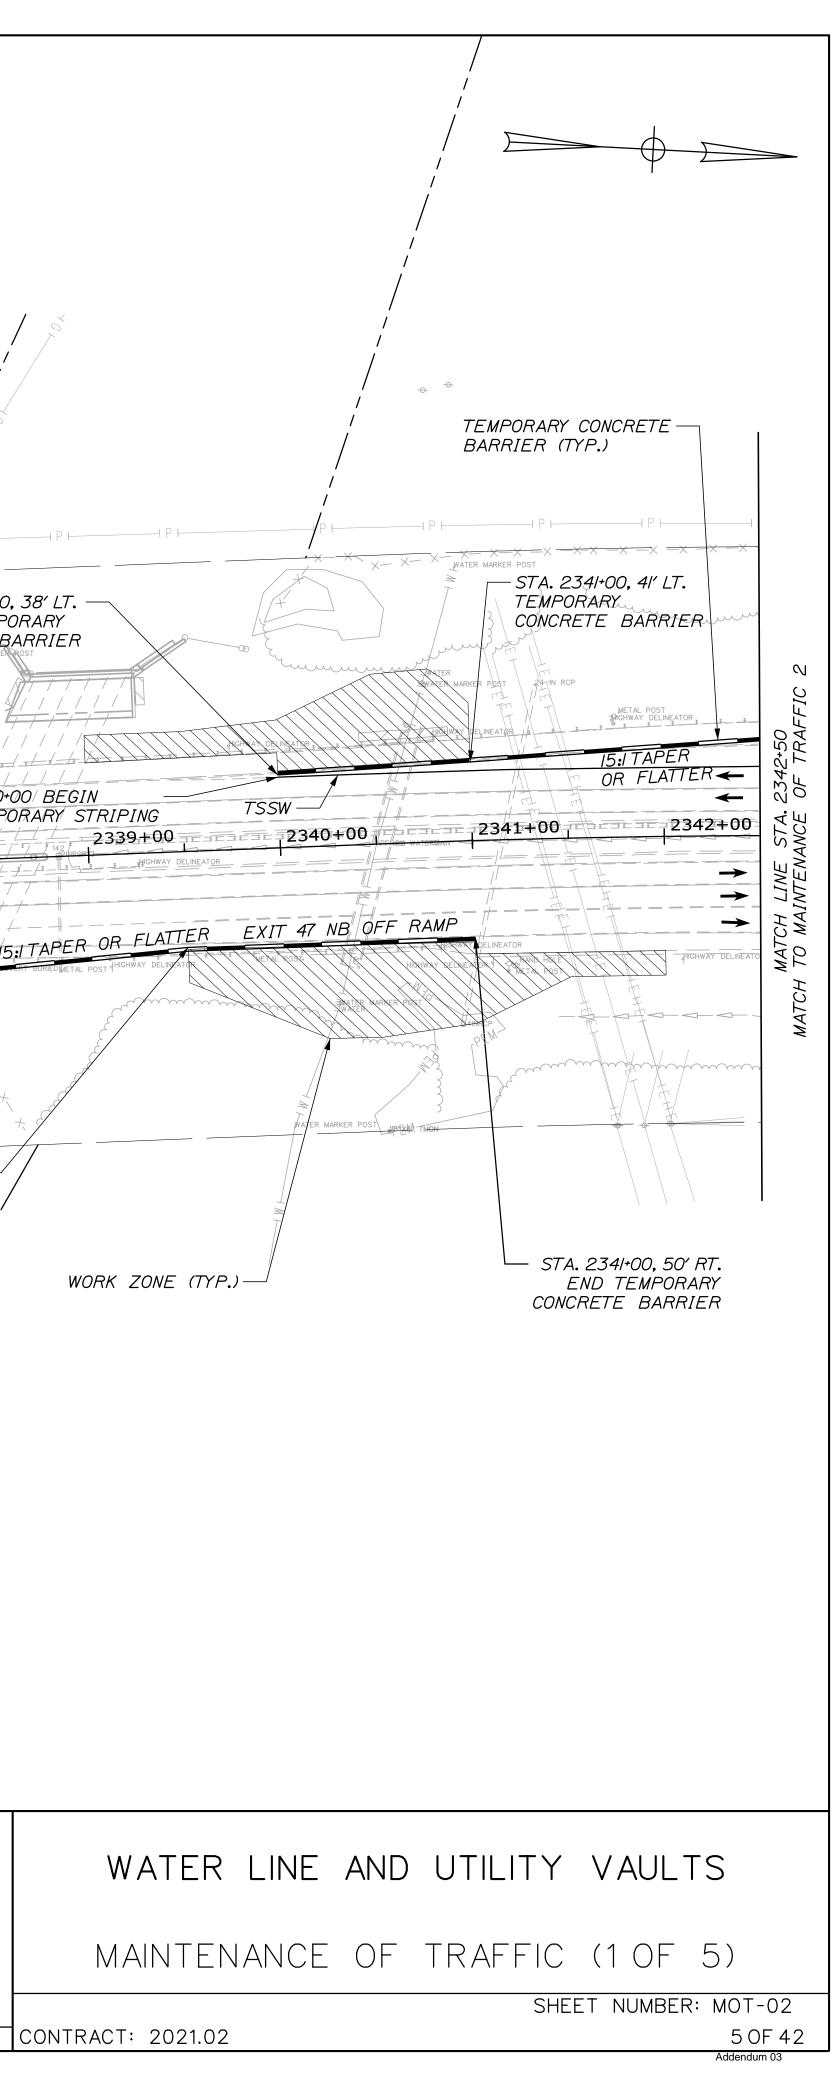

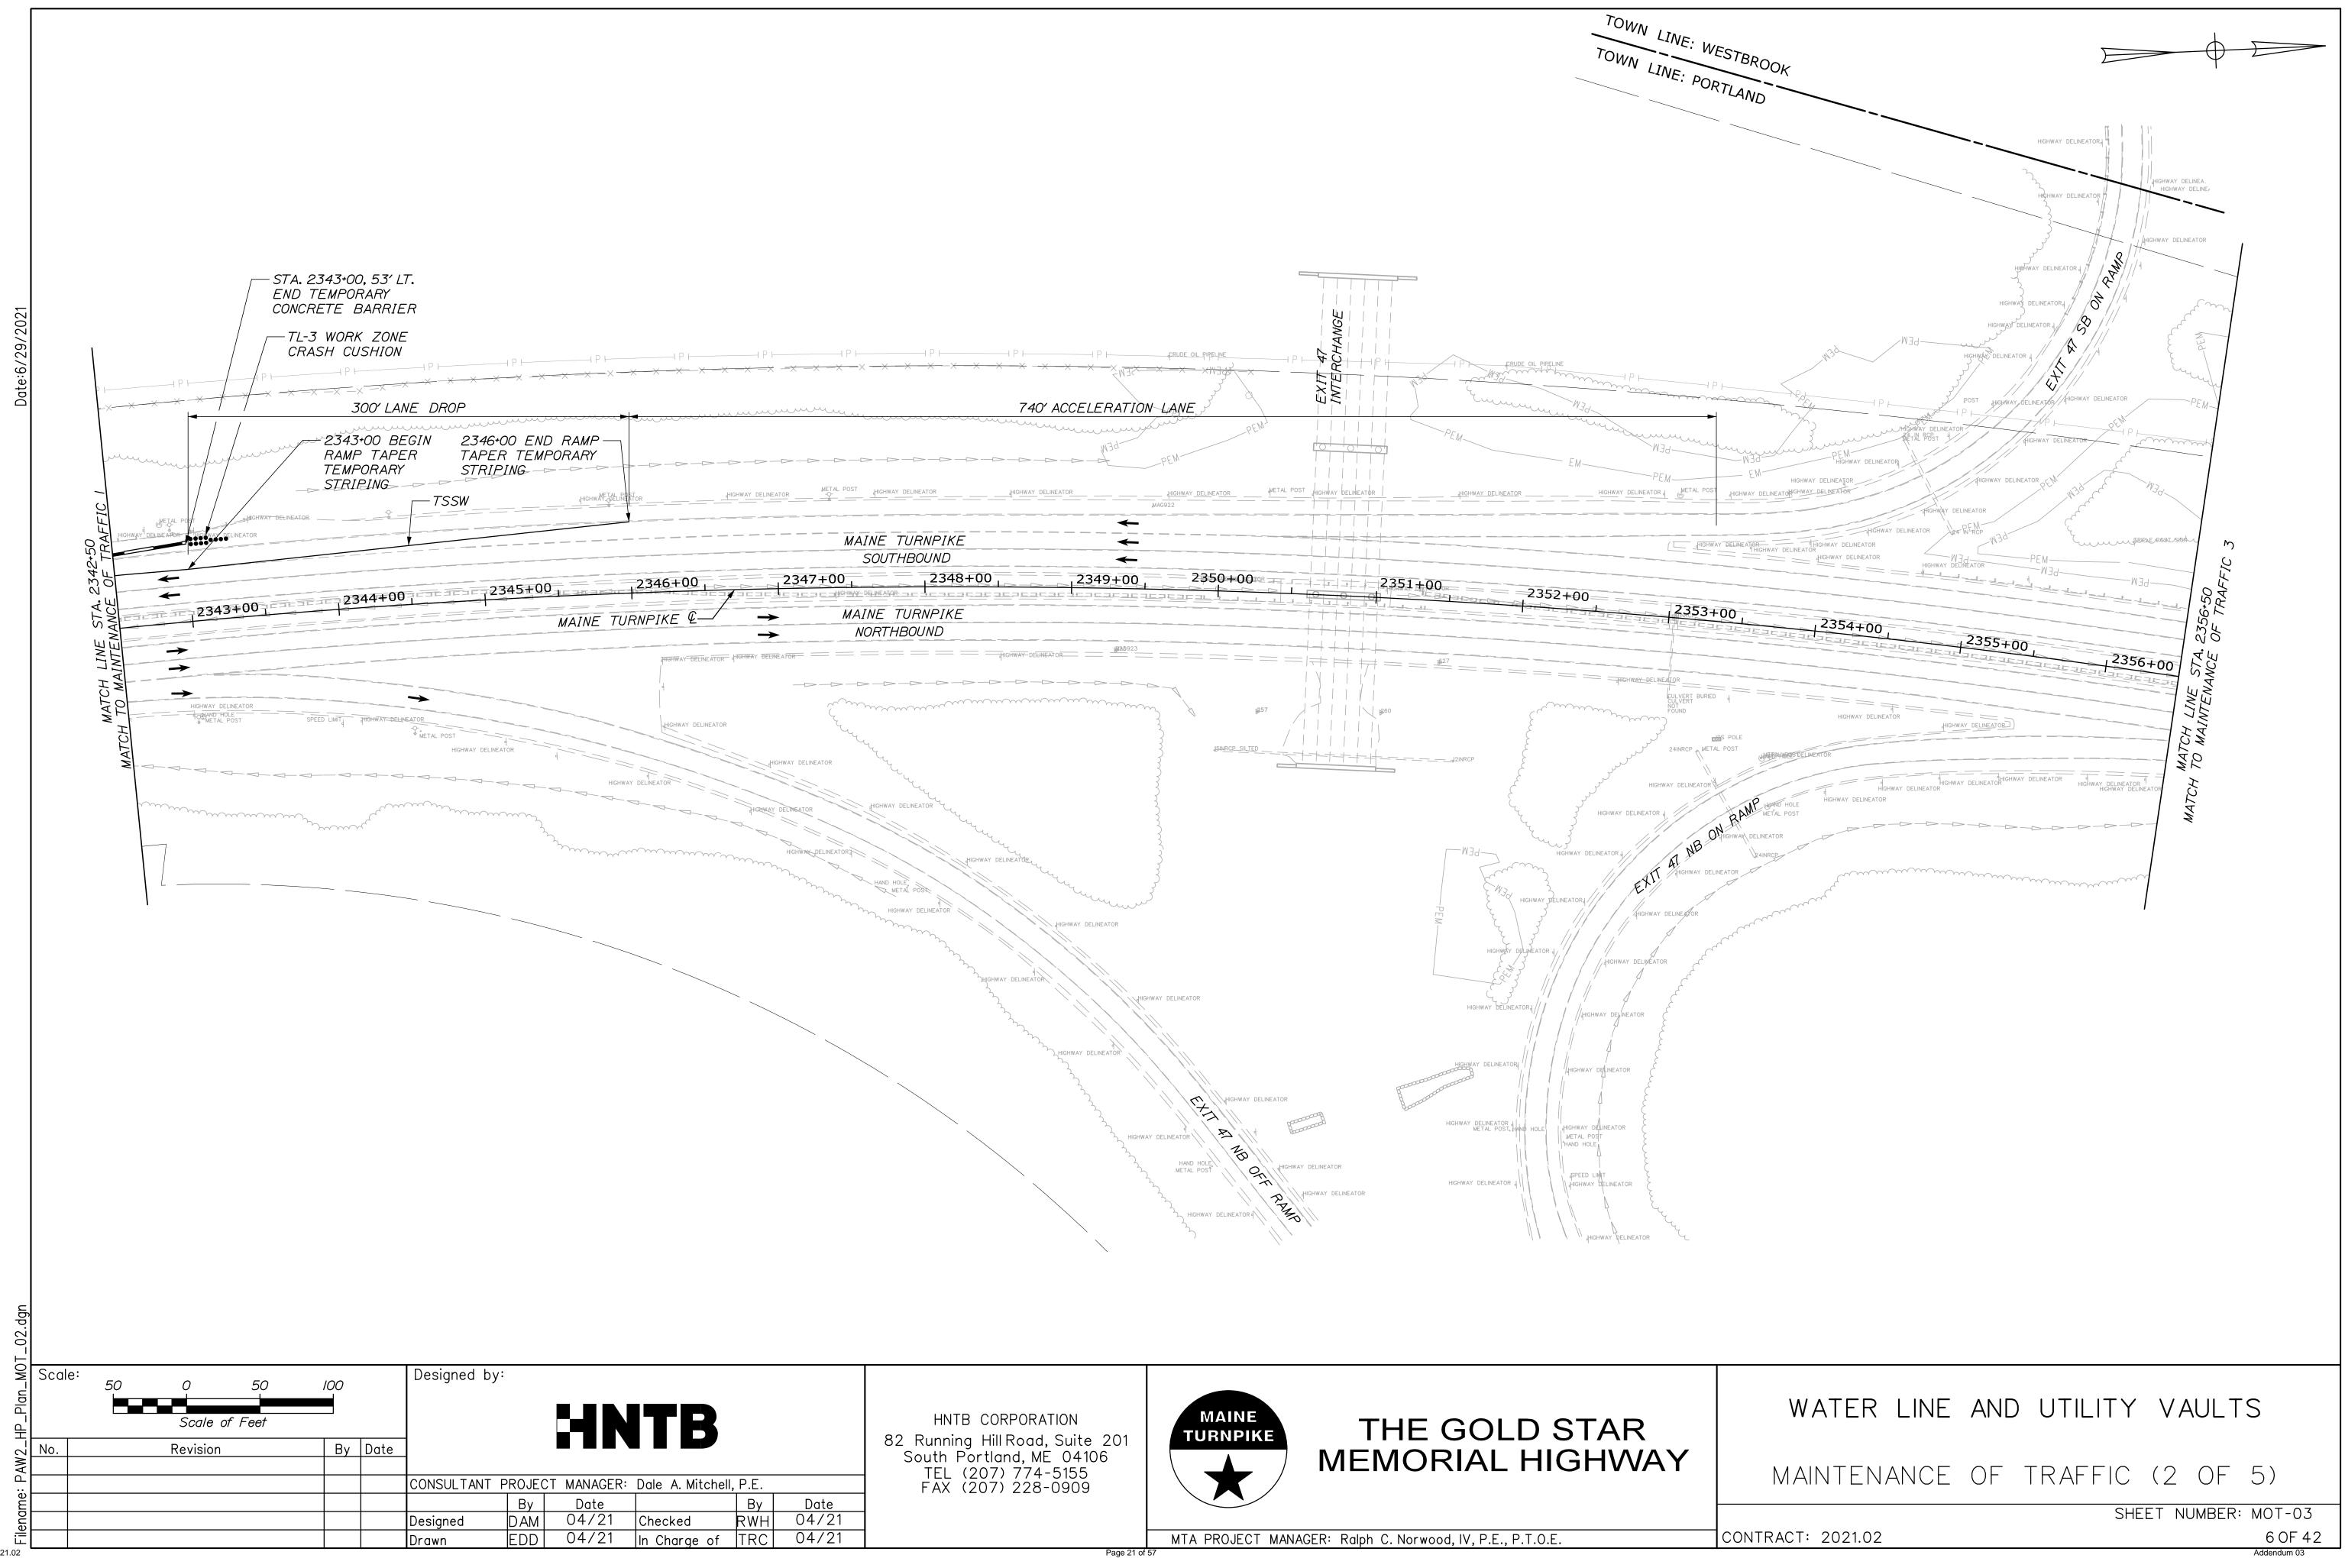


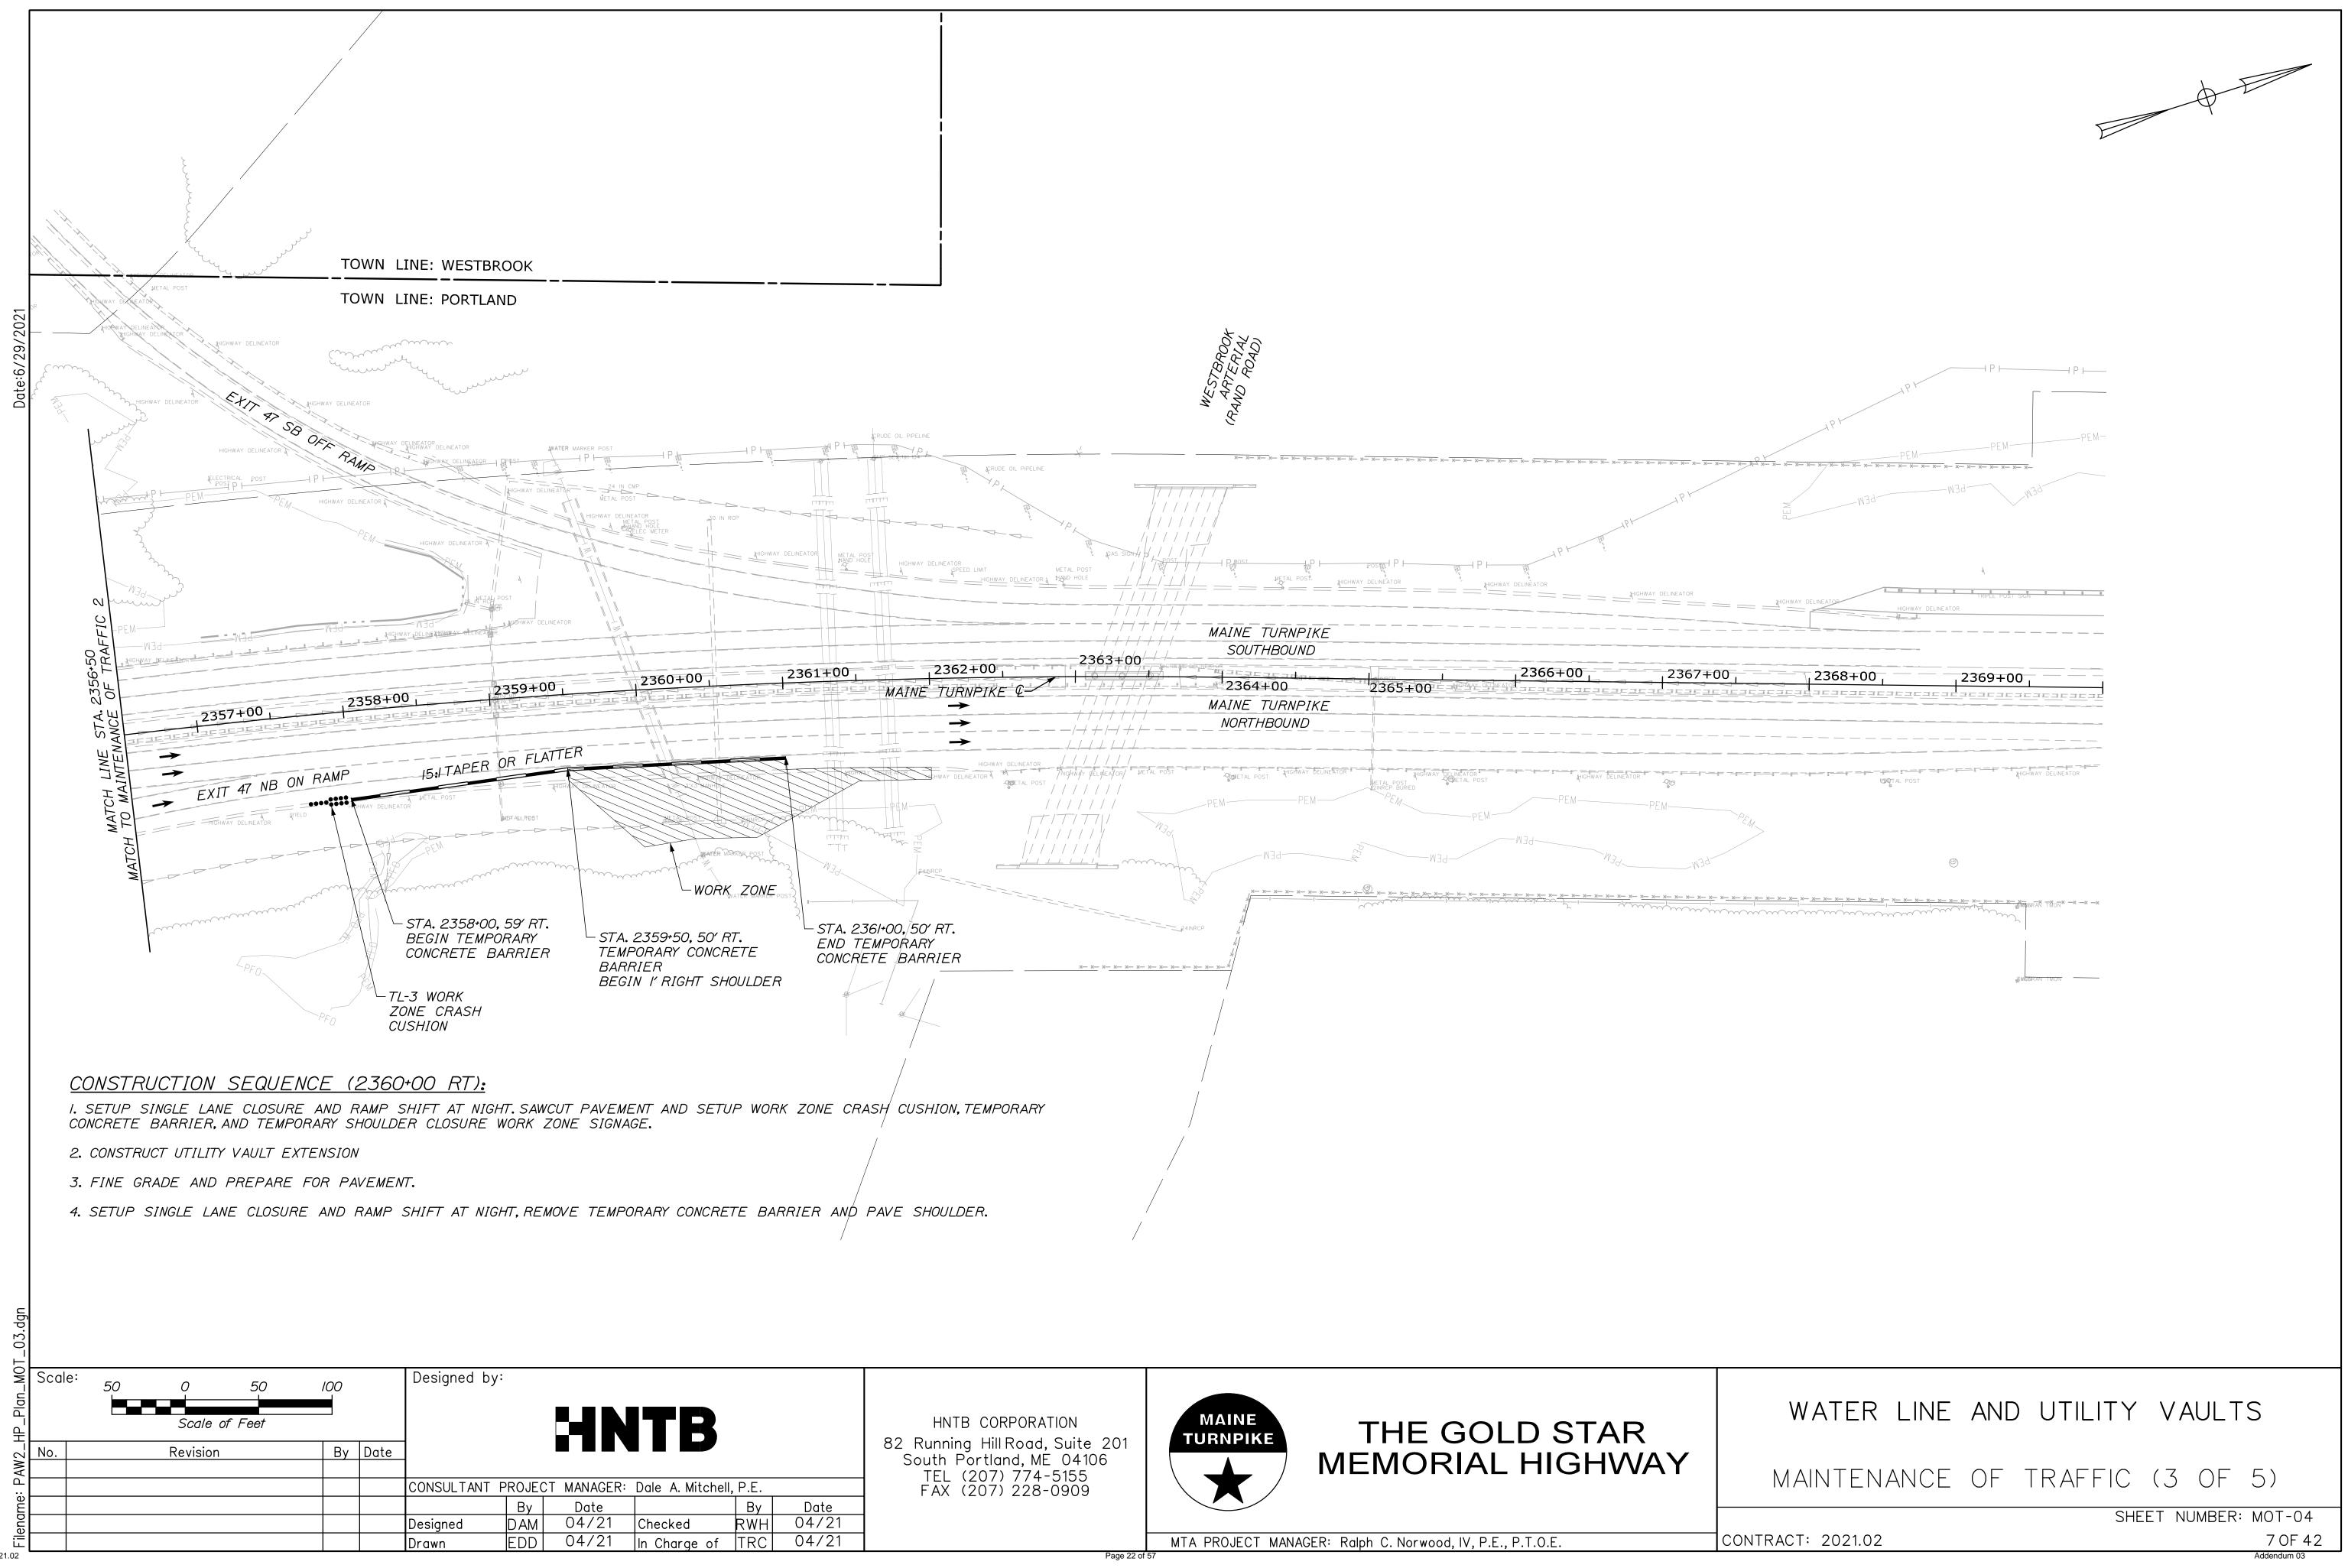

Contract 2021.02

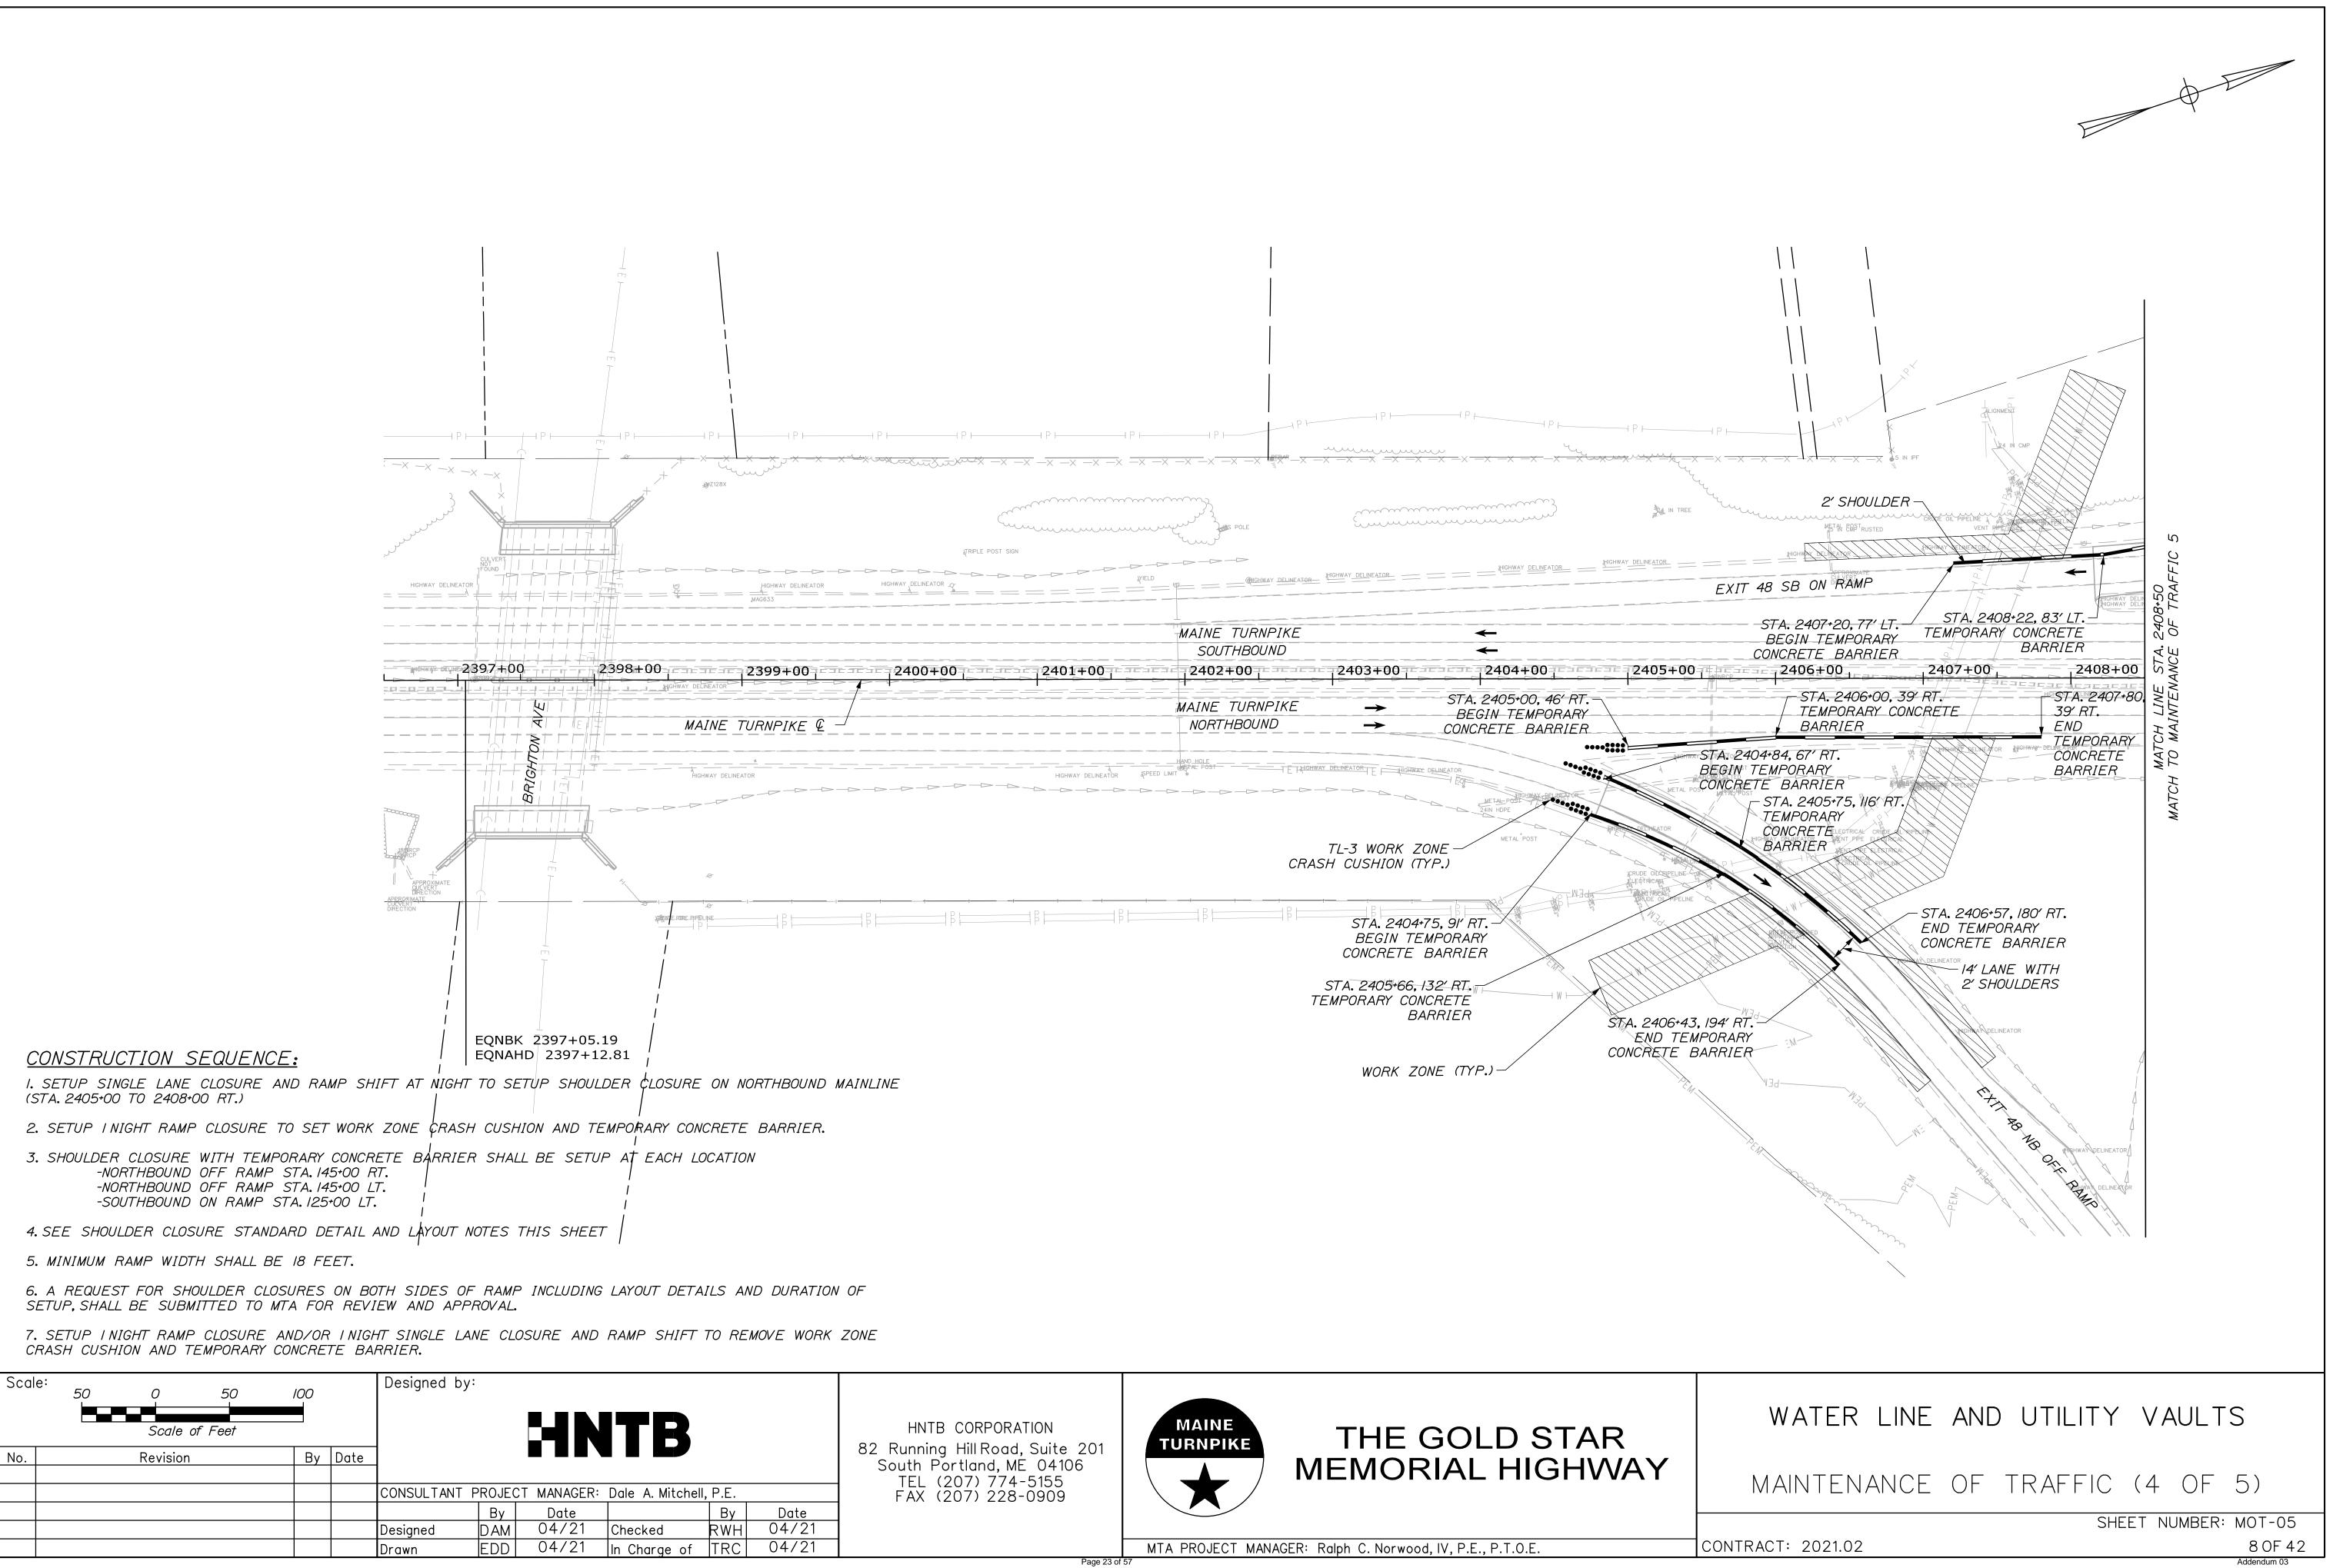

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ATRIPLE POST SIGN			HIGHWAY DELINEATOR
AY DELINEATOR HIGHWAY, DELINEATOR	YIELD WILLINE AT <del>OR</del>	HIGHWAY_DELINEATOR	
	MAINE TUDNDIKE		
	MAINE TURNPIKE SOUTHBOUND	← ←	
+00		2403+00	2405+00
		STA. 2405+00, 46' R	
	MAINE TURNPIKE	BEGIN TEMPORAF	γ∕
PIKE @		CONCRETE BARRIE	
		( DELINEATOR IT ATOT DELINEATOR	
			A METAL PO
		ME TAL-POST	
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		TL-3 WORK ZONE /	
	CRAS	TH CUSHION (TYP.)	CRUDE OLC RIPELINE
	-4		RETRICAL ARUDE OL PIPELINE
	ß [ ß [	STA. 2404+75, 9ľ RT.	The second
		BEGIN TEMPORARY	
		CONCRETE BARRIER	
		STA. 2405+66, 132' RT.	
	TE	EMPORARY CONCRETE BARRIER	
			STA. 2406+43 END TEM
			END TEM CONCRETE E
ROUND MAINIINE		WORK ZONE (TYP.)	CONCRETE E
BOUND MAINLINE		WORK ZONE (TYP.)	CONCRETE E

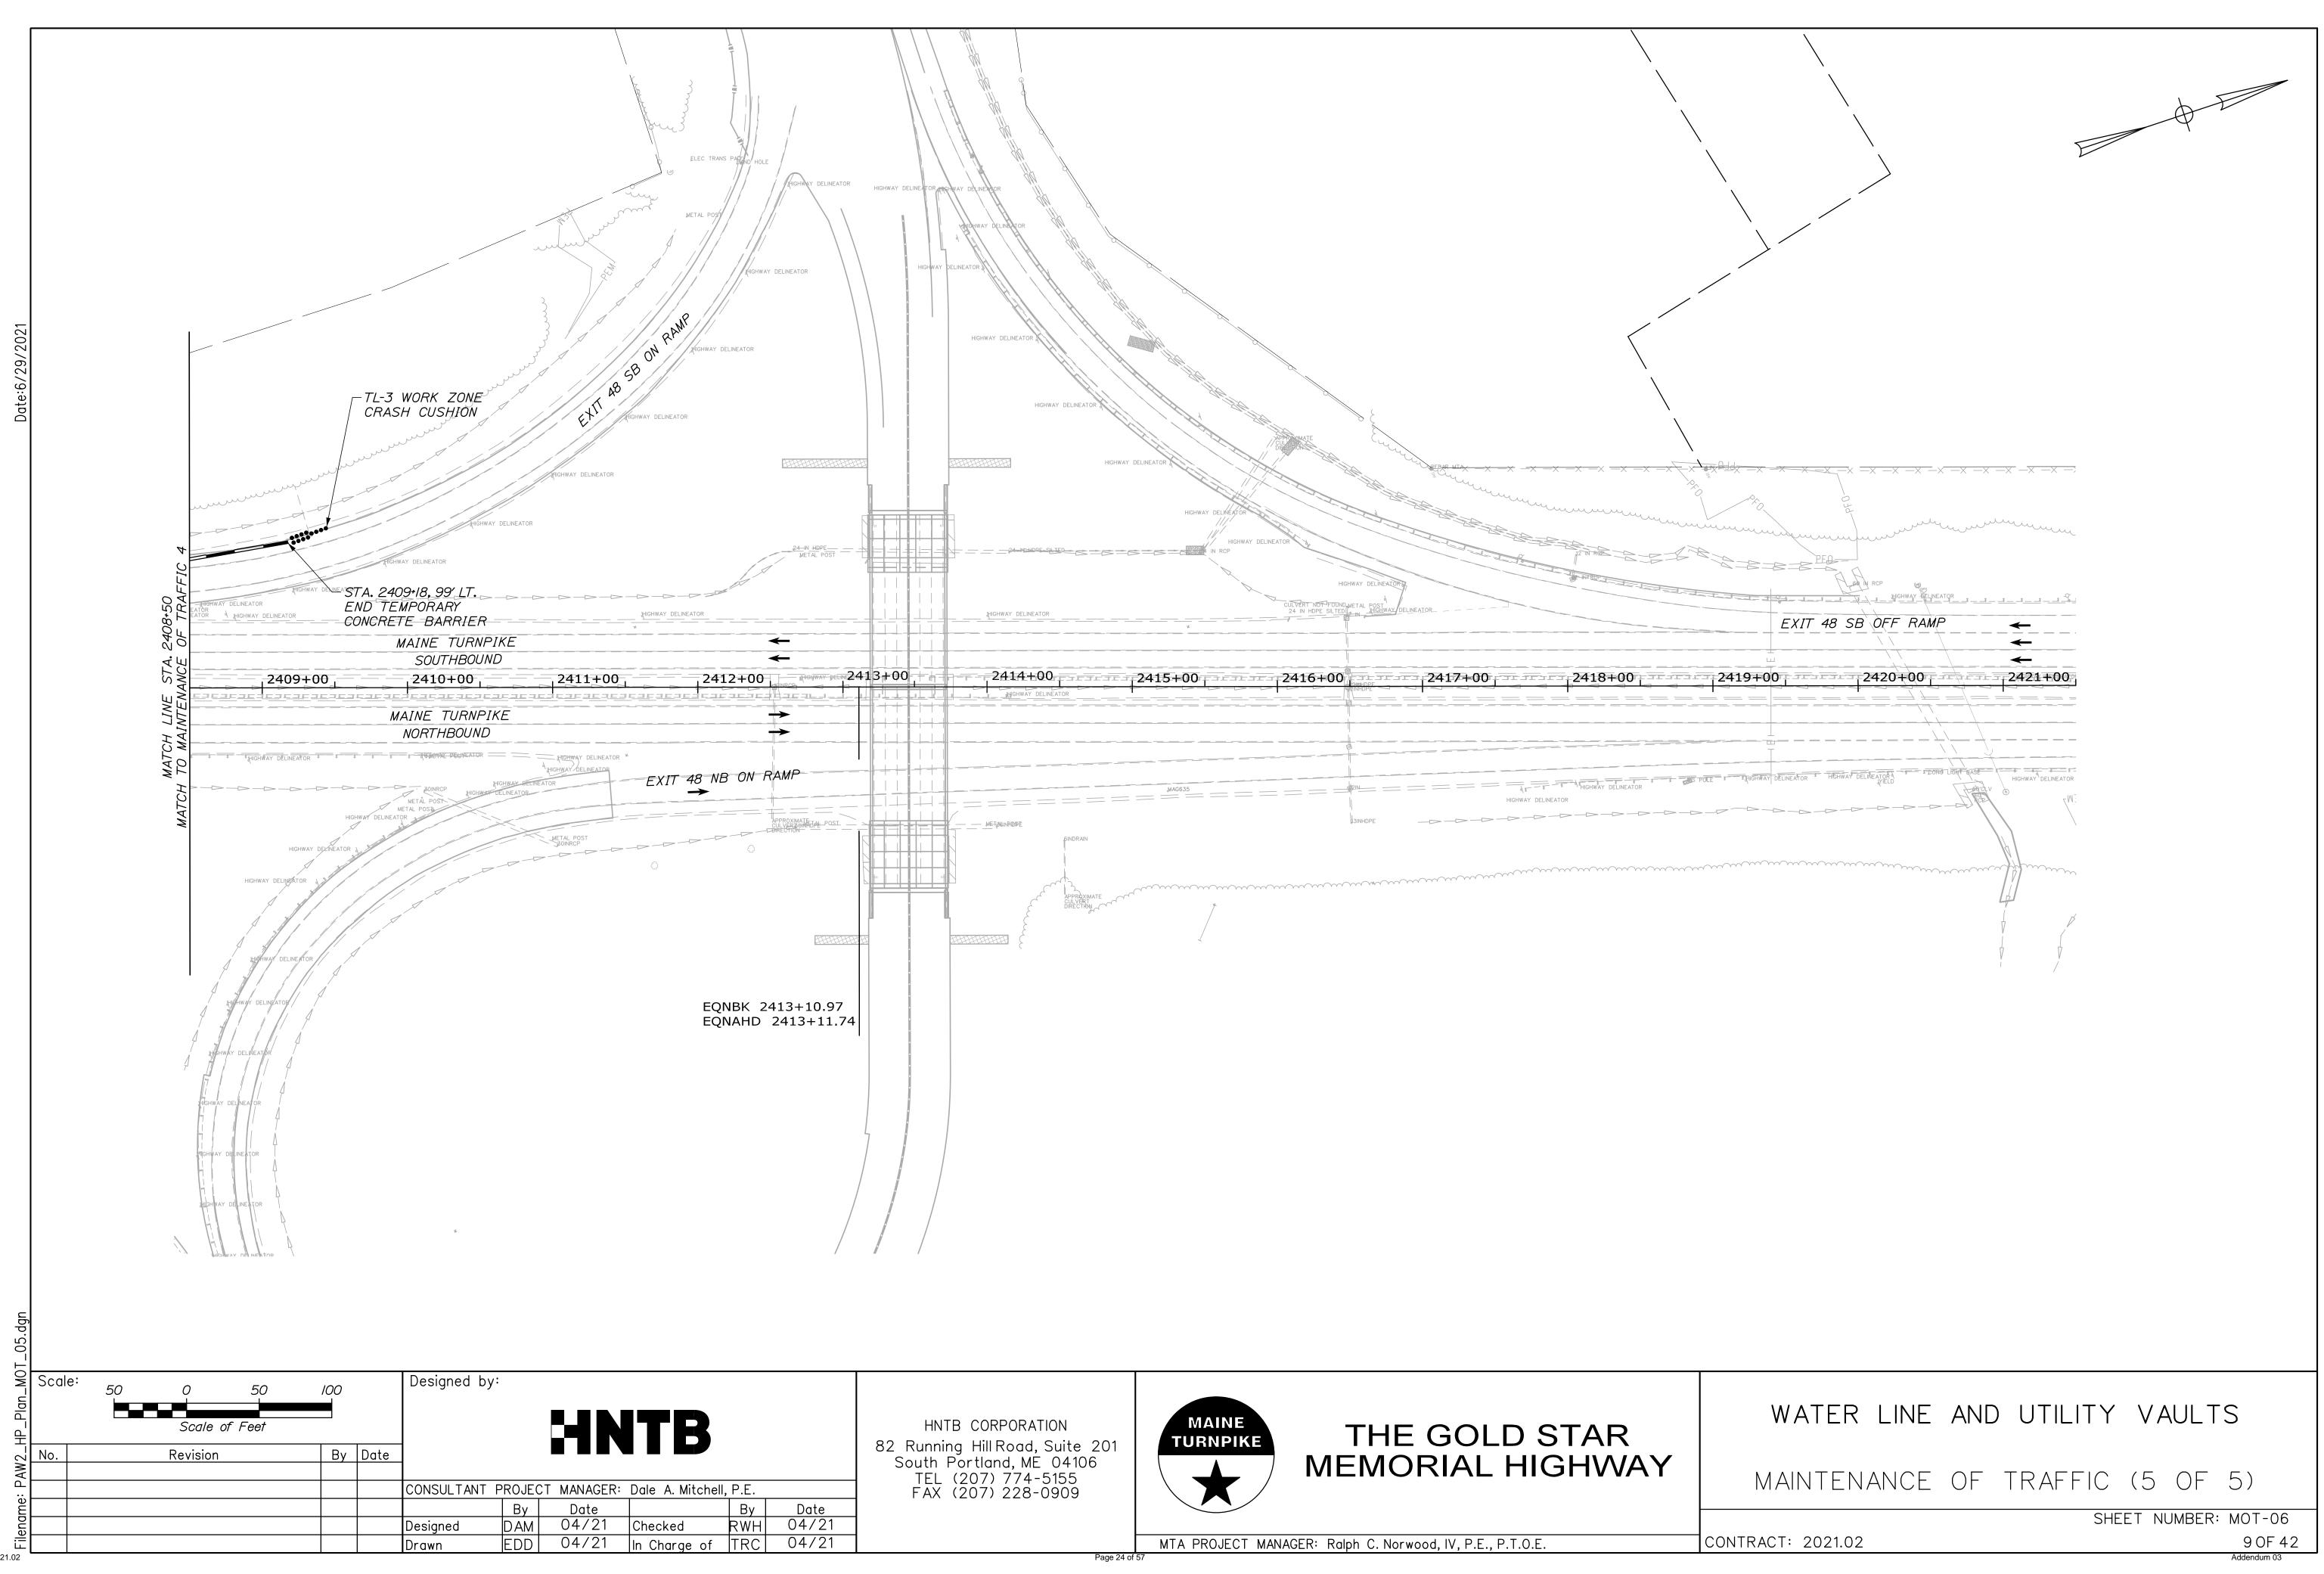

Contract 2021.02

IDENTIFI-		E OF GN		TEXT DI	MENSIONS (INCHES)	NUMBER OF	COL	OR	BORDER	AREA IN
CATION NUMBER	WIDTH	HEIGHT	TEXT	LETTER HEIGHT	VERTICAL ARROW SPACING RTE.MKR.	SIGNS	BACK- GROUND	LEGEND BORDER	RADIUS	SQUARE FEET (TOTAL)
E5-2a	48"	48"	EXIT CLOSED	TEXT CONFORM STANDA OR AS	DIMENSIONS SHALL 1 TO "2004 EDITION - ARD HIGHWAY SIGNS 5 SUPERSEDED BY 12 SUPPLEMENT"		ORANGE	RADIU CONF "2004 I STANDAR SIGNS SUPERS	ND BORDER S SHALL ORM TO EDITION - D HIGHWAY OR AS SEDED BY PPLEMENT"	16.00 (48)
G20-2	48"	24"	END ROAD WORK			4	ORANGE			8.00 (32)
G20-5aP	48"	24"	WORK ZONE			/	V			8.00 (8)
RI-2	48"	48"	Y I E L D			1	WHITE			6.93 (6.93)
R2-1 (50)	48"	60"	speed limit 50			/				20.00 (20)
R2-6aP	48"	24"	FINES DOUBLED			/				8.00 (8)
R2-12	48"	60"	END WORK ZONE SPEED LIMIT			2				20.00 (40)
W3-2	48"	<i>48</i> "				1	ORANGE			16.00 (16)
W3-5 (50)	48"	48"	SPEED LIMIT 50			2				16.00 (32)
W4-1	48"	48"				/				16.00 (16)
W4-2R	48"	48"				2				16.00 (32)
W4-5P	30"	24"	NO MERGE AREA			/				5.00 (5)

ate:6/29/2021

ary

-SignSum	Scale:				Designed by	•				
MOT_Sig		NOT TO SCALE					HN	ITR		
AW2_N	No.	Revision	By	Date						
с.					CONSULTANT	PROJEC	T MANAGER:	Dale A. Mitchel	I, P.E.	
me						By	Date		By	[
Filename:					Designed	DAM	04/21	Checked	RWH	04
File					Drawn	EDD	04/21	In Charge of	TRC	04
2021.02										

Contract 2021.0

IDENTIFI-		E OF GN		TEXT DIMENSIO		(INCHES)	NUMBER OF	COL	OR	BORDER	AREA IN
CATION NUMBER	WIDTH	HEIGHT	TEXT	LETTER HEIGHT	VERTICAL SPACING	ARROW RTE.MKF	SIGNS REQUIRED	BACK- GROUND	LEGEND BORDER	RADIUS	SQUARE FEET (TOTAL)
WI3-4P	36"	36"	ON RAMP	CONFORM STANDA OR AS	DIMENSIONS TO "2004 NRD HIGHW, S SUPERSE 2 SUPPLEN	EDITION AY SIGNS DED BY	- 8	ORANGE	RADIU CONFO "2004 E STANDAR SIGNS SUPERS	ND BORDER S SHALL ORM TO EDITION - D HIGHWAY S OR AS SEDED BY PPLEMENT"	9.00 (72)
W20-I (AHEAD) (I MILE)	48"	48"	ROAD WORK XXX				8 2				16.00 (128) 16.00 (32)
W2O-5R (I/2 MILE) (AHEAD)	48"	48"	RIGHT LANE CLOSED 1/2 MILE				 2				16.00 (16) 16.00 (32)
W2I-5aR	48"	48"	RIGHT SHOULDER CLOSED				4				16.00 (64)
W2I-5bR	48"	48"	RIGHT SHOULDER CLOSED 1000 FT				4				16.00 (64)
CS-4	48"	48"	EXIT CLOSED AHEAD	6" C 6" C 6" C	4" 4"		/				16.00 (16)
CS-11	48"	48"	NO STOPPING ON PAVEMENT	6" C 6" C 6" C	4" 4"		/				16.00 (16)



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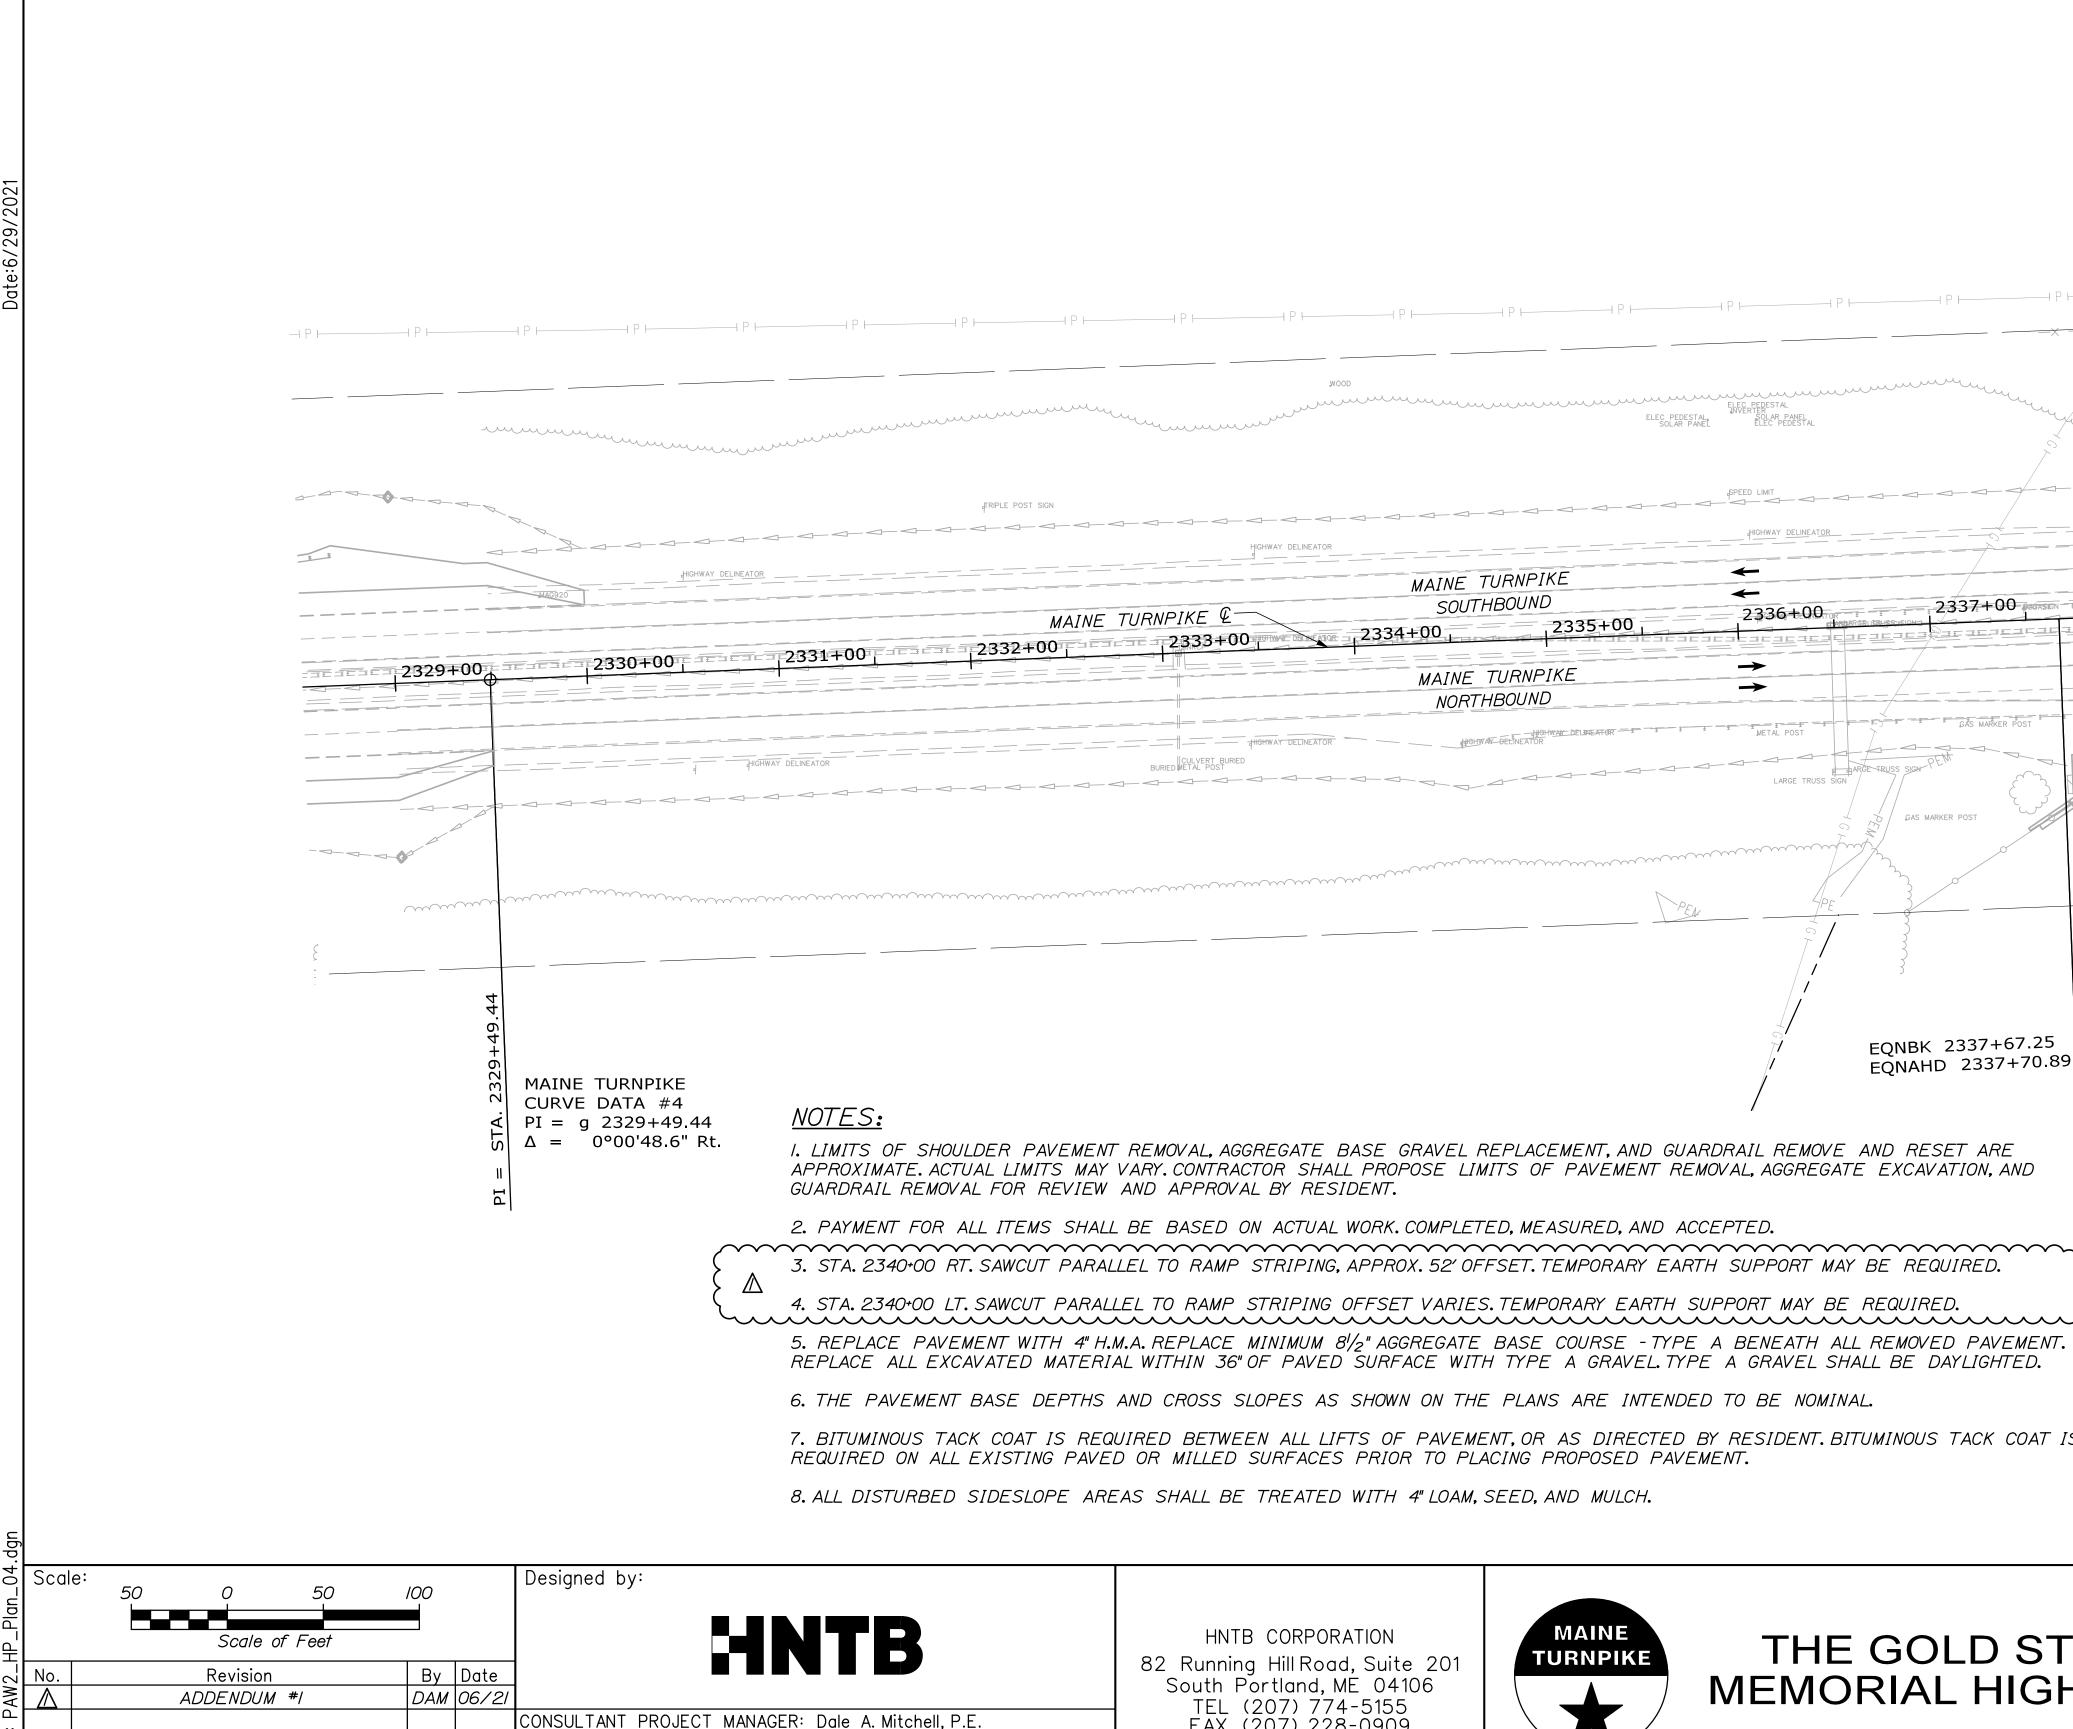
THE GOLD STAR MEMORIAL HIGHWAY

## WATER LINE AND UTILITY VAULTS

MAINTENANCE OF TRAFFIC SIGN SUMMARY

CONTRACT: 2021.02

SHEET NUMBER: MOT-07



WOOD WOOD	ELEC PEDESTAL NVERTER ELEC PEDESTAL NVERTER ELEC PEDESTAL NVERTER ELEC PEDESTAL NVERTER ELEC PEDESTAL NVERTER AR PANEL
	ELEC PEDESTAL NVERTER SOLAR PANEL ELEC PEDESTAL SOLAR PANEL ELEC PEDESTAL ELEC PEDESTAL ELEC PEDESTAL
	speed limit
HIGHWAY DELINEATOR	
MAINE TURNPI SOUTHBOUND	IKE D 2336+00rgr = 1 2337+00 pogaston = 2338
AINE TURNPIKE 2 2333+00 2334+00	
MAINE TURNP	
MAINE TURNP NORTHBOUND	SIKE
	$\frac{D}{D} \longrightarrow \frac{D}{D} \longrightarrow \frac{D}$
NORTHBOUNL	D
NORTHBOUNL	D HOHWAAT DELEMEATOR = = = = = = = = = = = = = = = = = = =
NORTHBOUND	D HOHWAAT DELEMEATOR = = = = = = = = = = = = = = = = = = =
NORTHBOUNL	D HOHWAAT DELEMEATOR = = = = = = = = = = = = = = = = = = =
NORTHBOUNL	D INFWARE DELARGE TRUSS SIGN LARGE TRUSS SIGN DAS MARKER POST LARGE TRUSS SIGN DAS MARKER POST DAS MARKER POST LARGE TRUSS SIGN DAS MARKER POST DAS MARKER POST
NORTHBOUNL	D INCHANGE DELENEATION INCHANGE TRUSS SIGN LARGE TRUSS SIGN PEN D D D D D D D D D D D D D
EMENT REMOVAL, AGGREGATE BASE GRAVEL REPLAC	DIRE D ARRE TRUSS SIGN LARGE TRUSS SIGN LARGE TRUSS SIGN PE EQNBK 2337+67.25 EQNAHD 2337+70.89

ITEM 606.366 GUARDRAIL, REMOVE AND RESET

STA. 2339+50.00, 53.45' RT. TO STA. 2340+83.37, 54.10' RT. (ADJUST LIMITS IN THE FIELD)

STA. 2338+07.80, 48.38' LT. TO STA. 234I+00.00, 53.19' LT. (ADJUST LIMITS IN THE FIELD)


4. STA. 2340+00 LT. SAWCUT PARALLEL TO RAMP STRIPING OFFSET VARIES. TEMPORARY EARTH SUPPORT MAY BE REQUIRED.

5. REPLACE PAVEMENT WITH 4" H.M.A. REPLACE MINIMUM 81/2" AGGREGATE BASE COURSE - TYPE A BENEATH ALL REMOVED PAVEMENT. REPLACE ALL EXCAVATED MATERIAL WITHIN 36" OF PAVED SURFACE WITH TYPE A GRAVEL. TYPE A GRAVEL SHALL BE DAYLIGHTED.

6. THE PAVEMENT BASE DEPTHS AND CROSS SLOPES AS SHOWN ON THE PLANS ARE INTENDED TO BE NOMINAL.

7. BITUMINOUS TACK COAT IS REQUIRED BETWEEN ALL LIFTS OF PAVEMENT, OR AS DIRECTED BY RESIDENT. BITUMINOUS TACK COAT IS REQUIRED ON ALL EXISTING PAVED OR MILLED SURFACES PRIOR TO PLACING PROPOSED PAVEMENT.

8. ALL DISTURBED SIDESLOPE AREAS SHALL BE TREATED WITH 4" LOAM, SEED, AND MULCH.

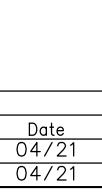

By

RWH

Date

04/21

Checked

In Charge of TRC

DAM 04/21

By |

EDD

Designed

Drawn

HNTB CORPORATION 82 Running HillRoad, Suite 201 South Portland, ME 04106 TEL (207) 774-5155 FAX (207) 228-0909








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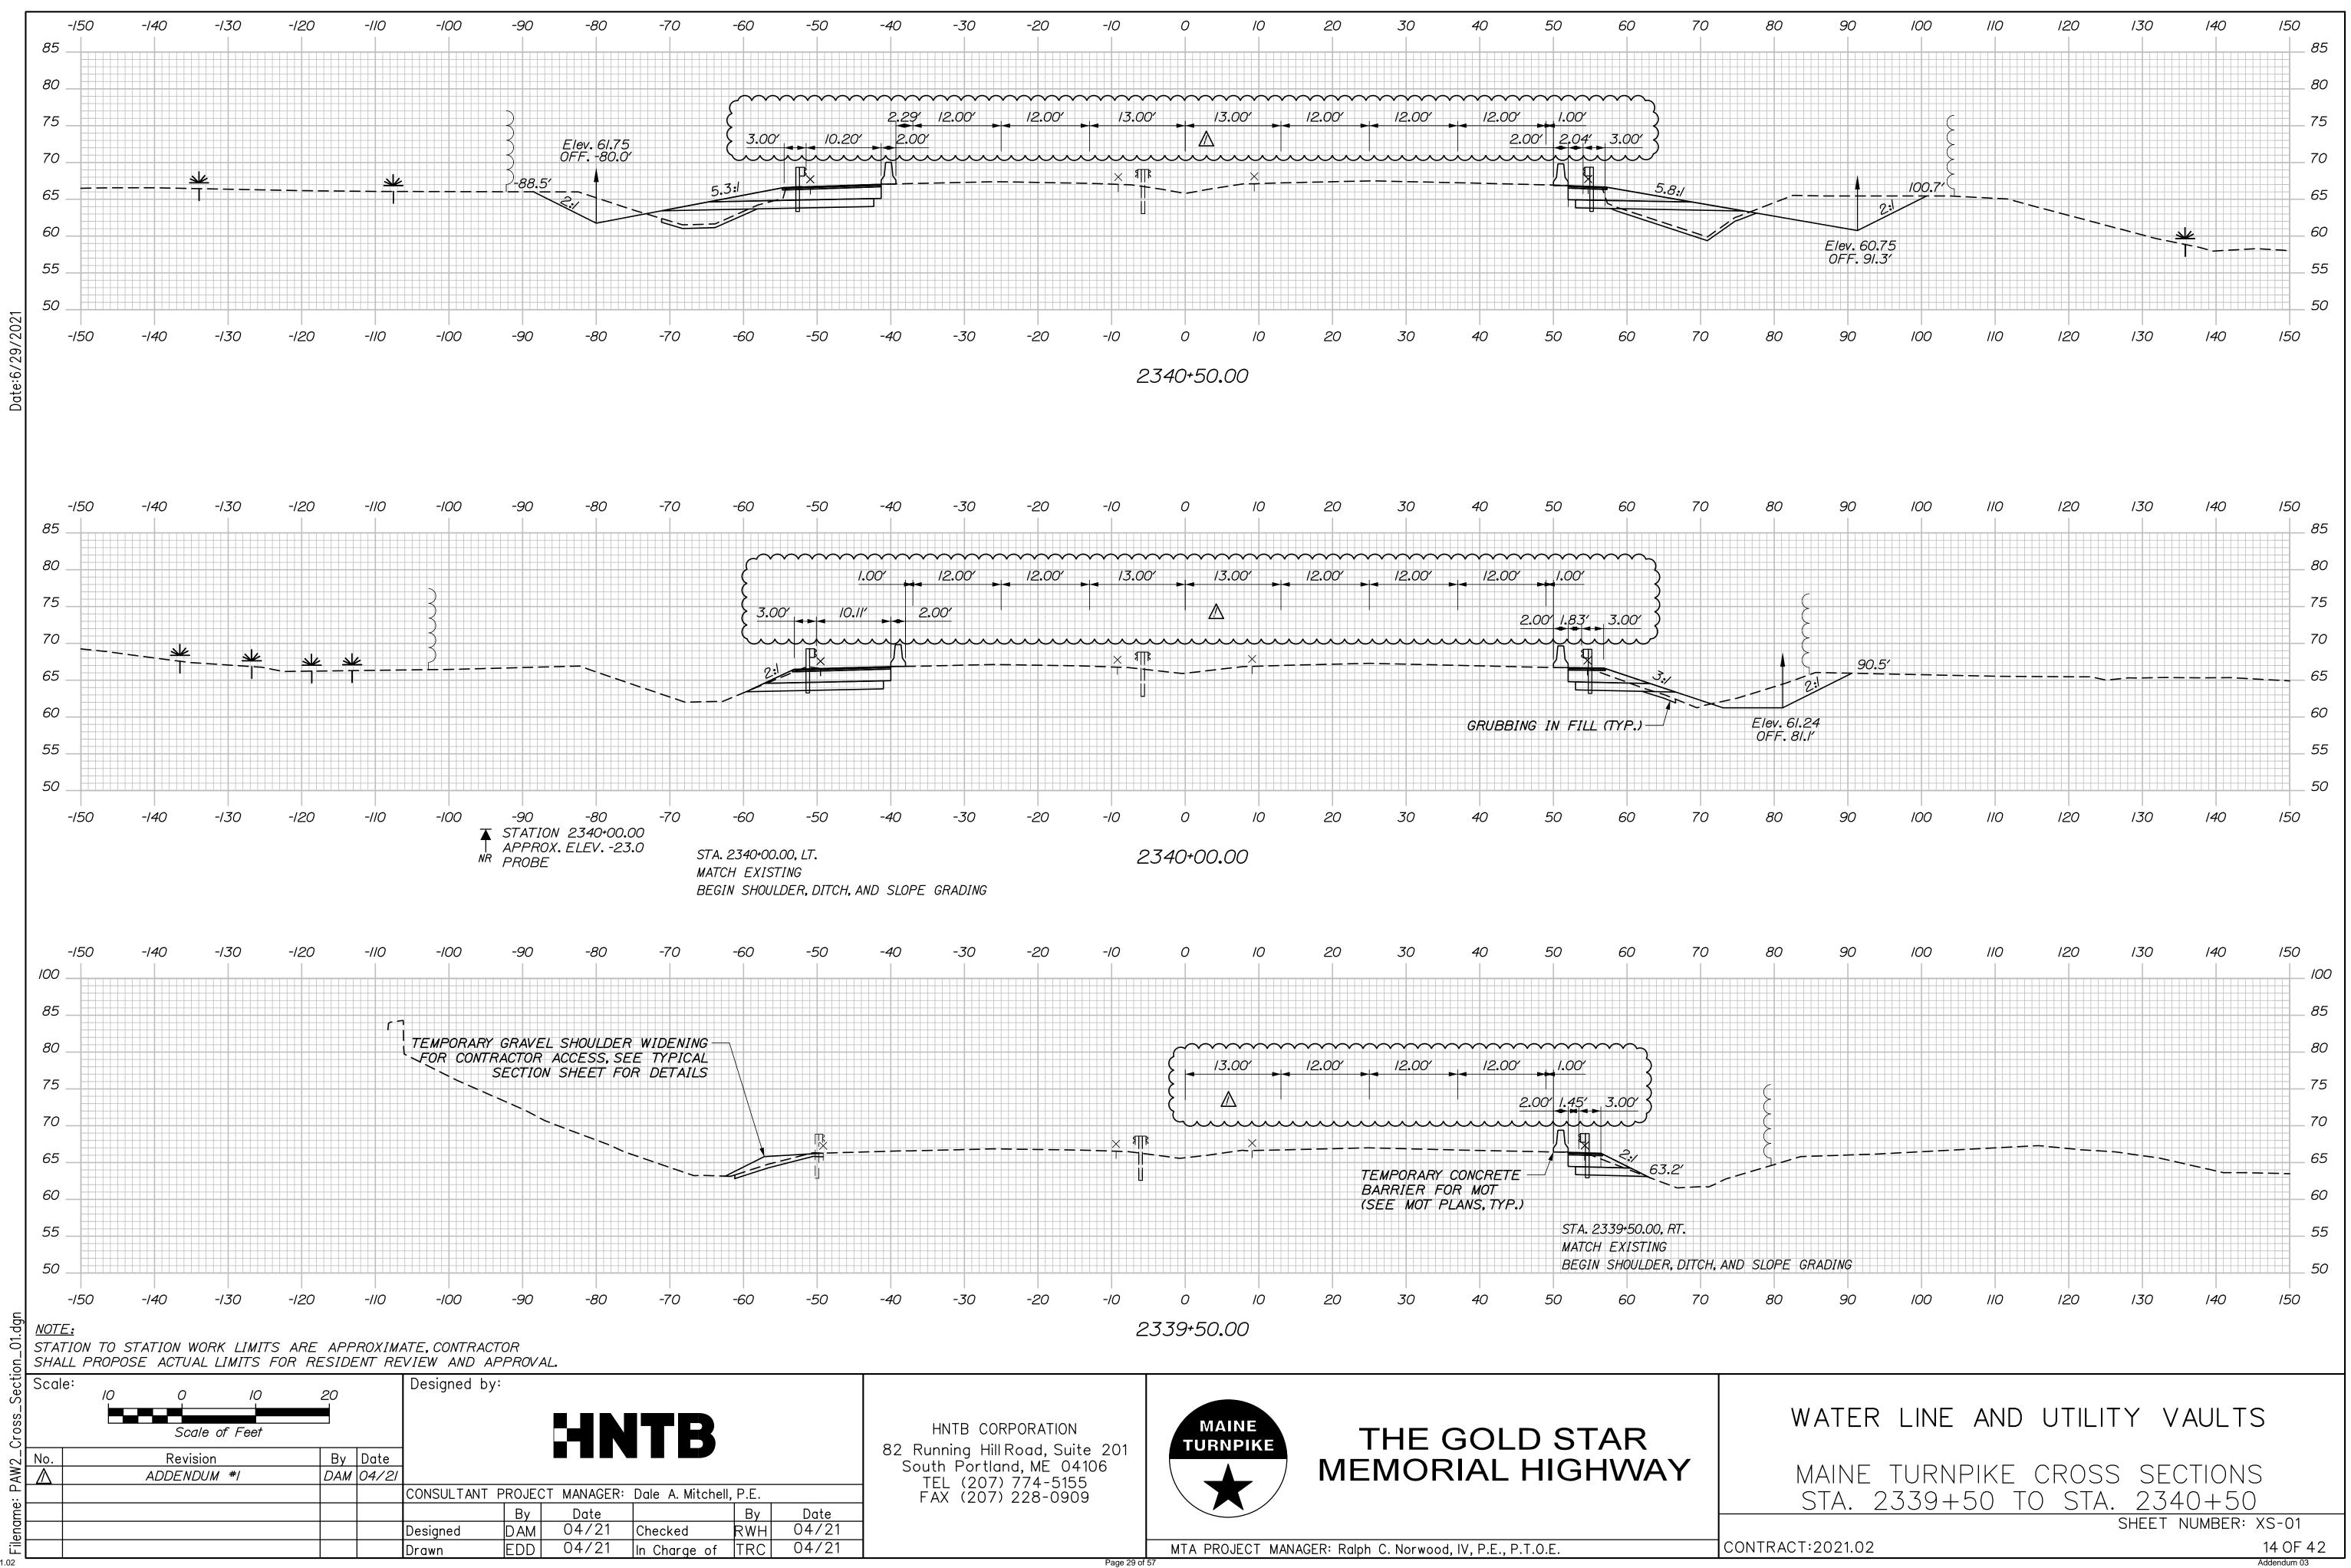
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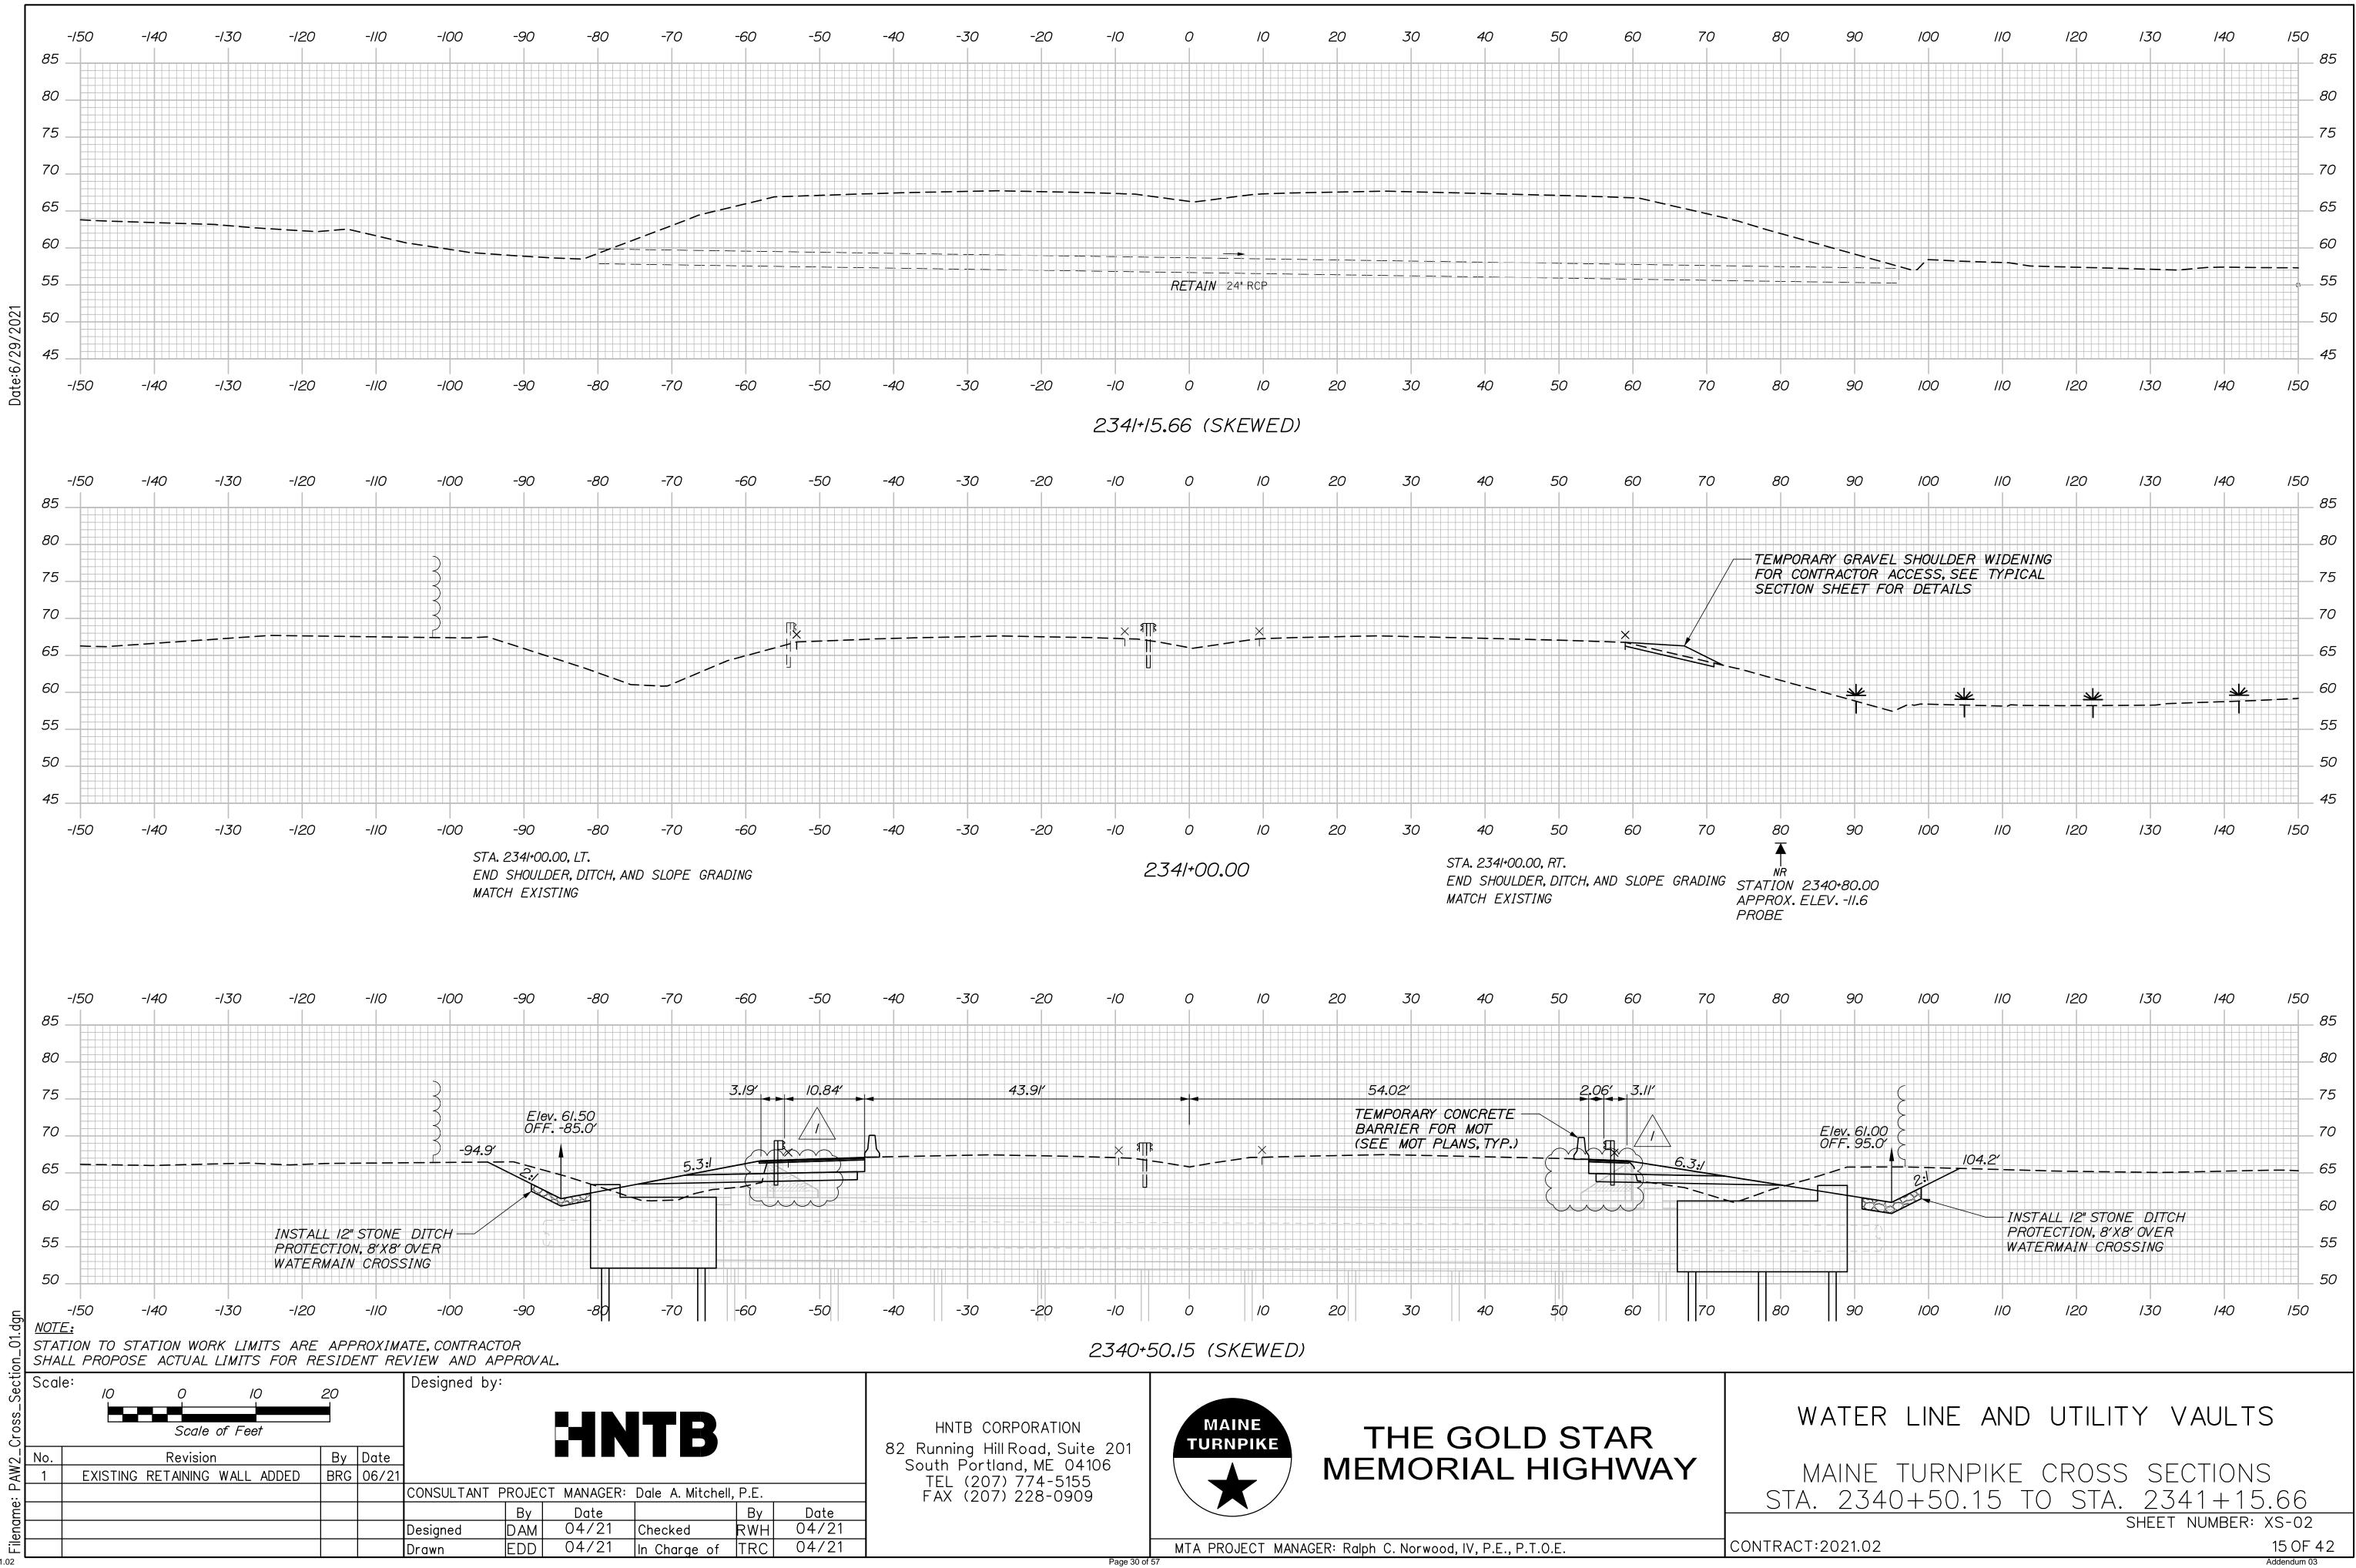
MTA PROJECT MANAGER: Ralph C. Norwood, IV, P.E., P.T.O.E. Page 26 of 57






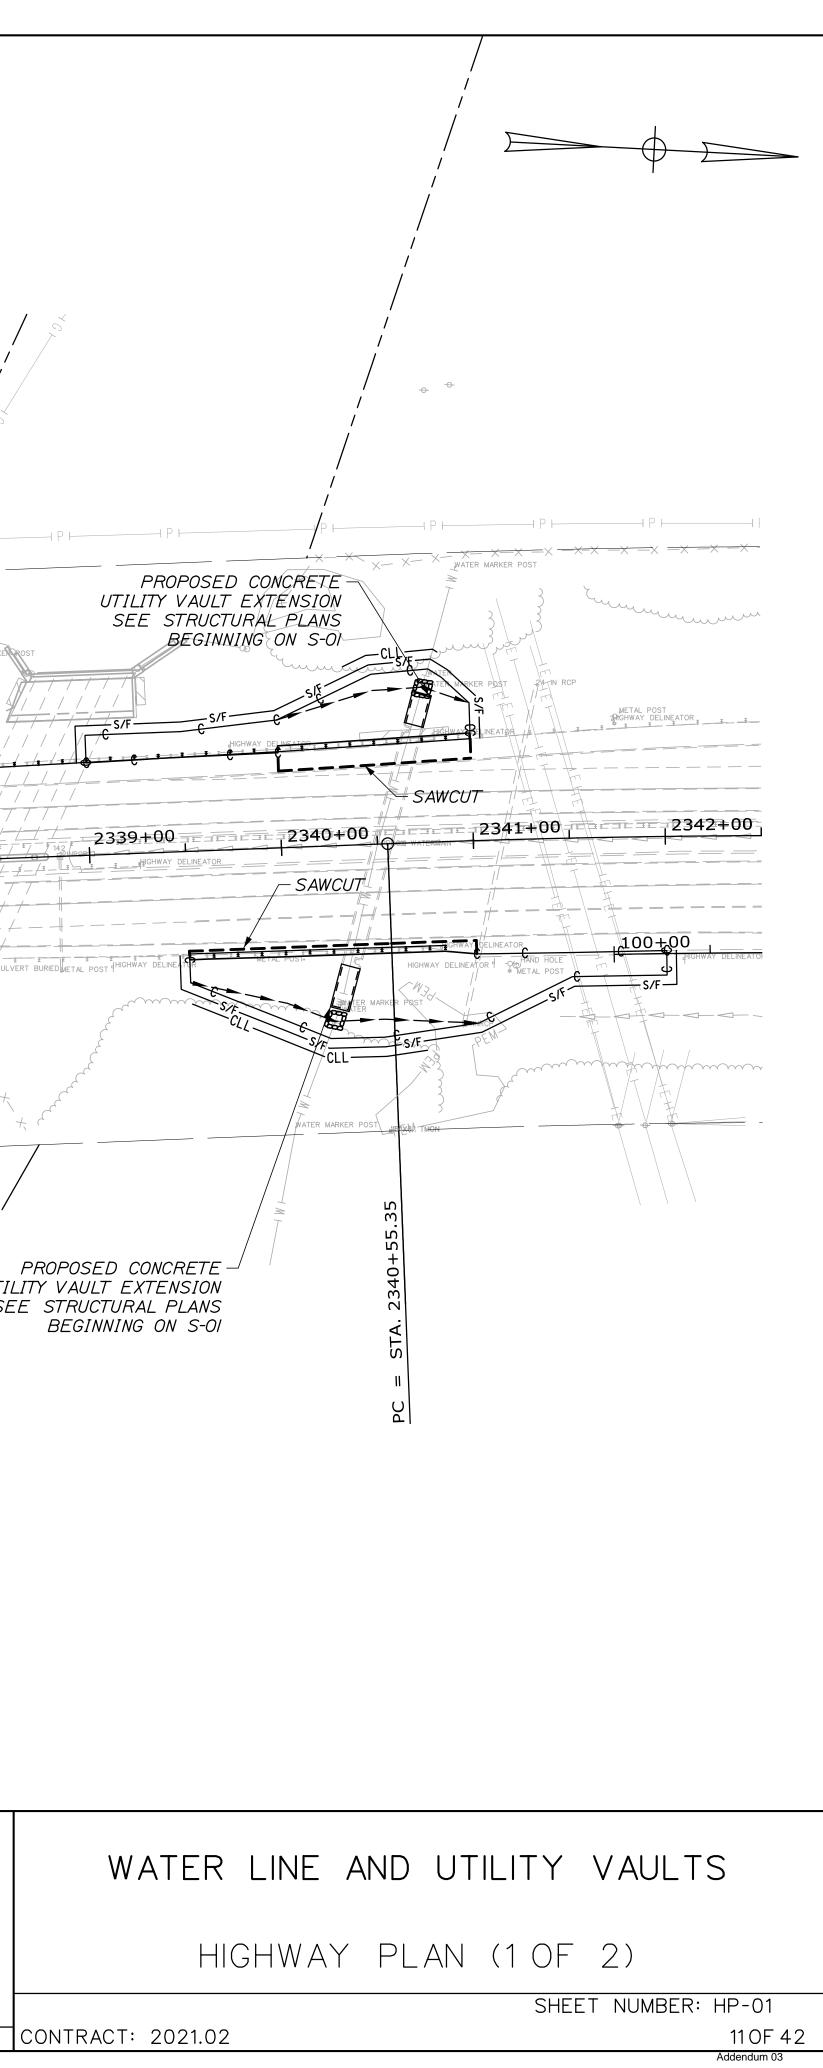


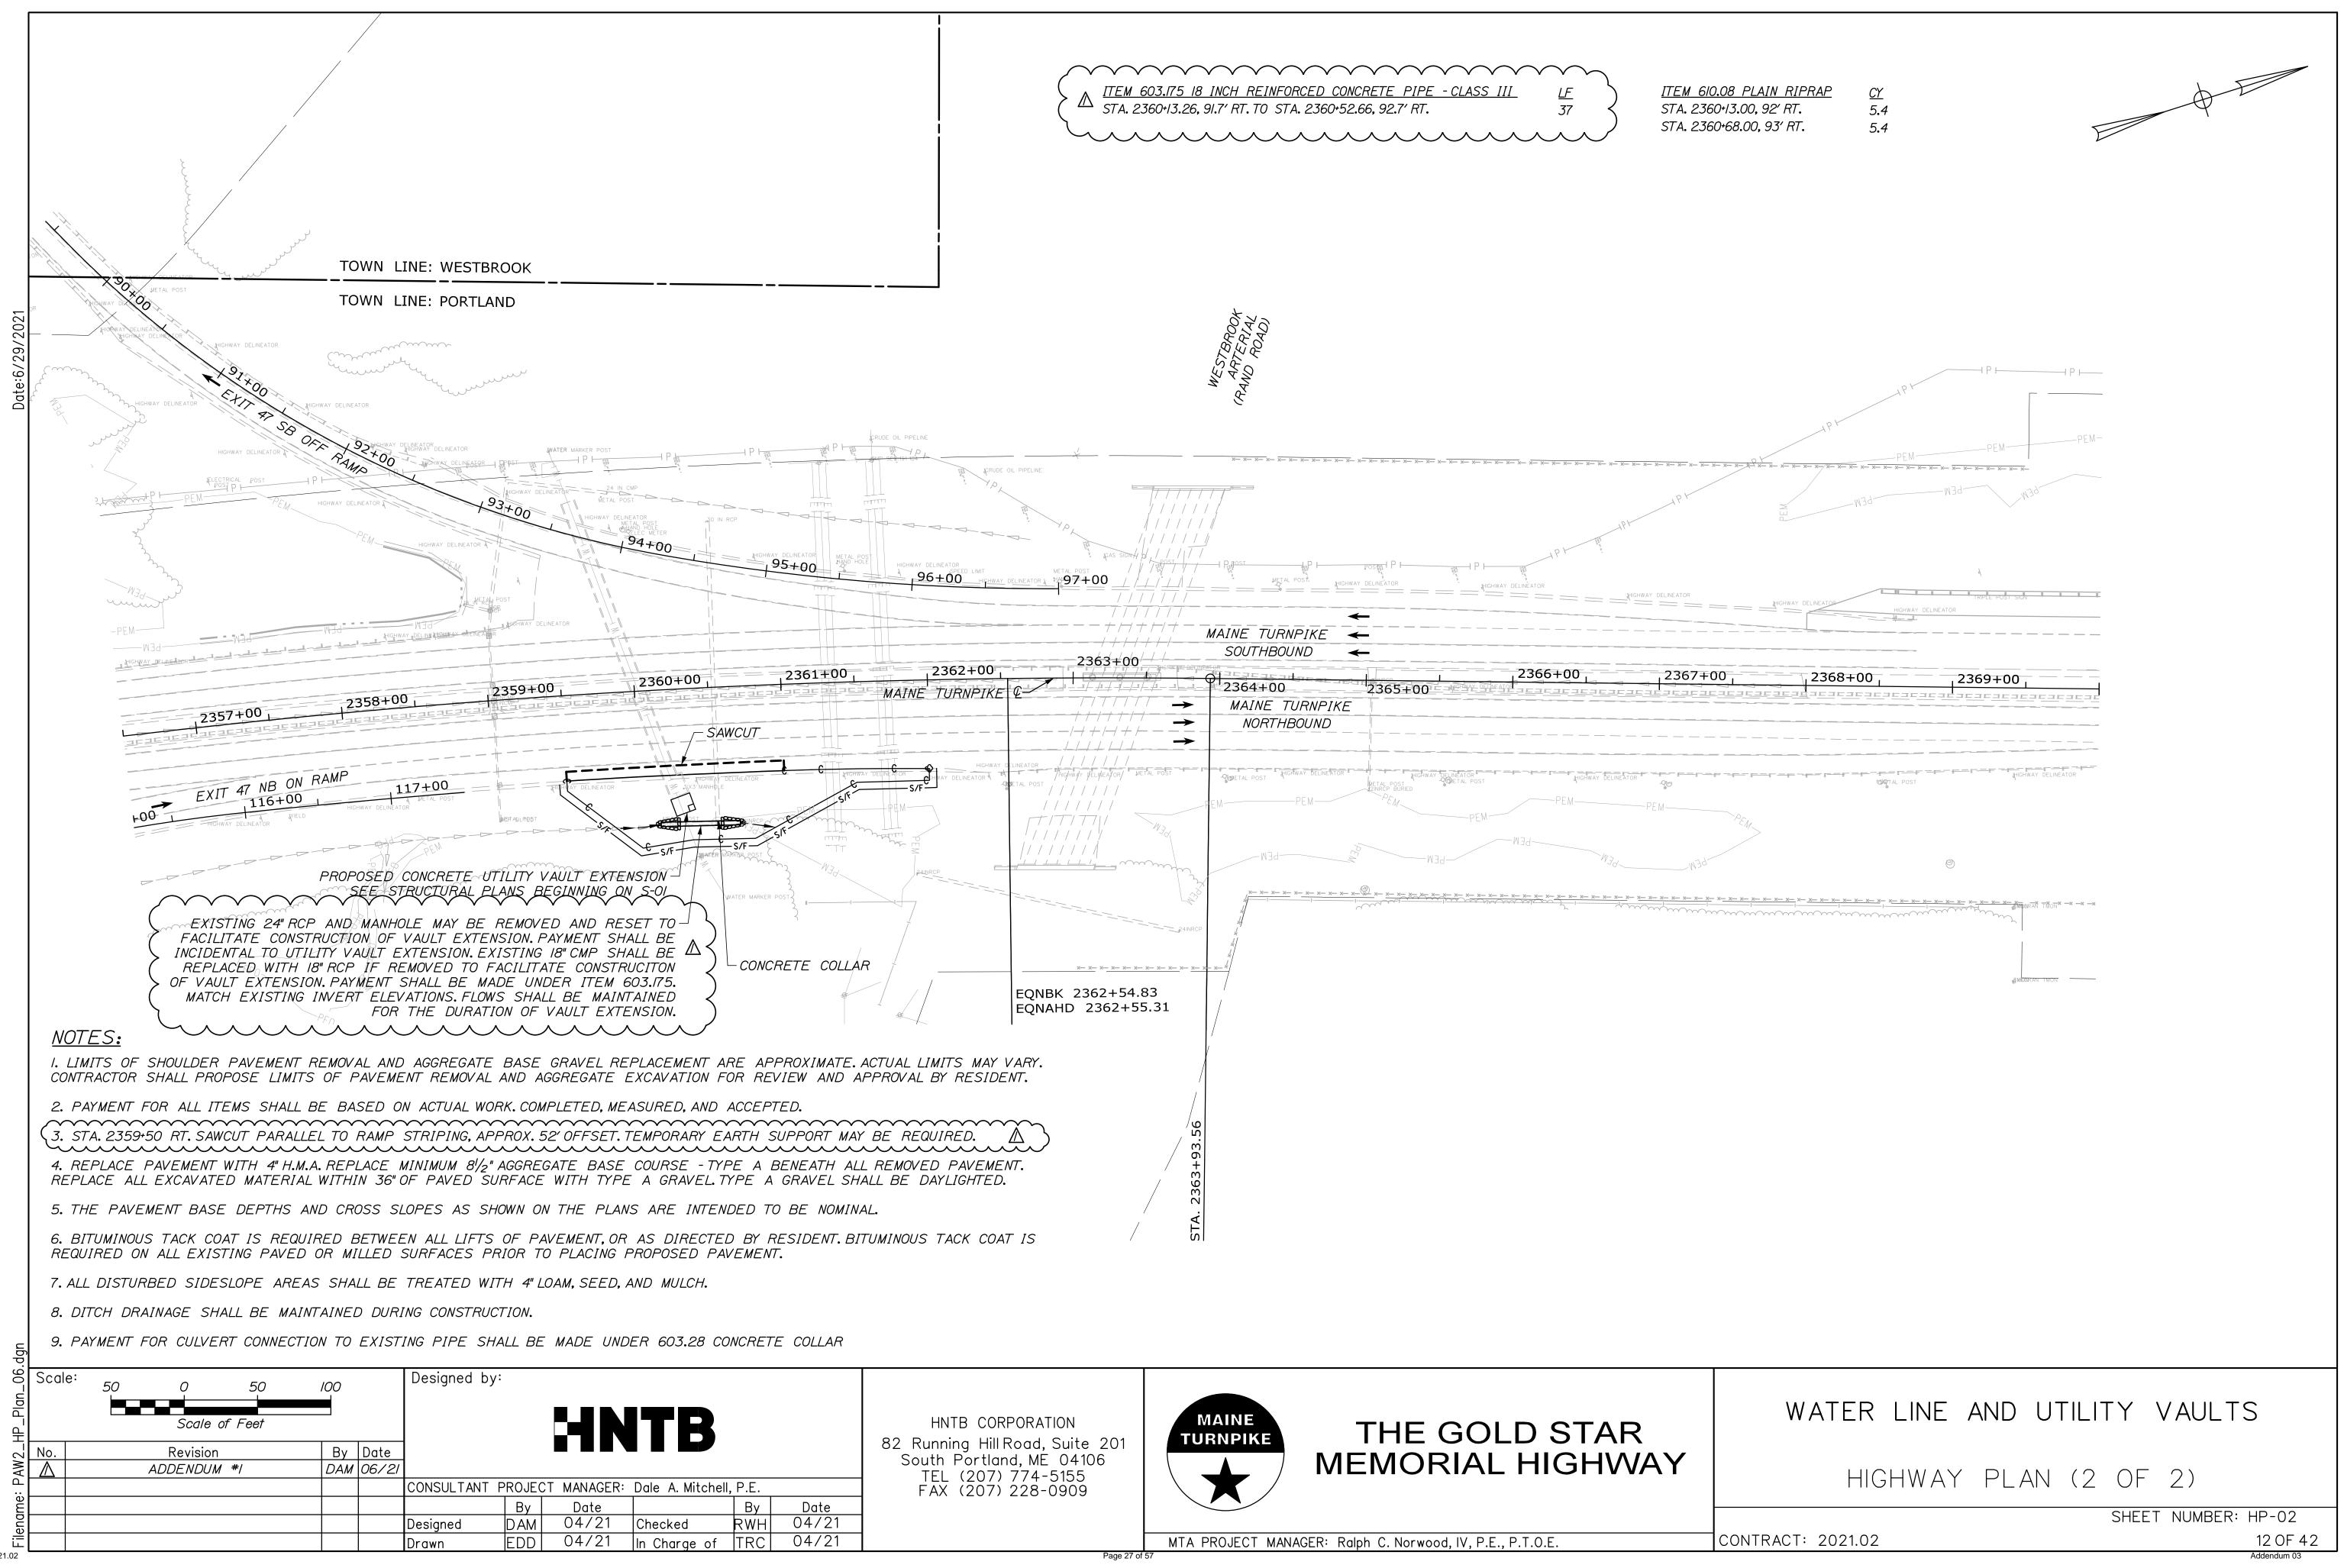


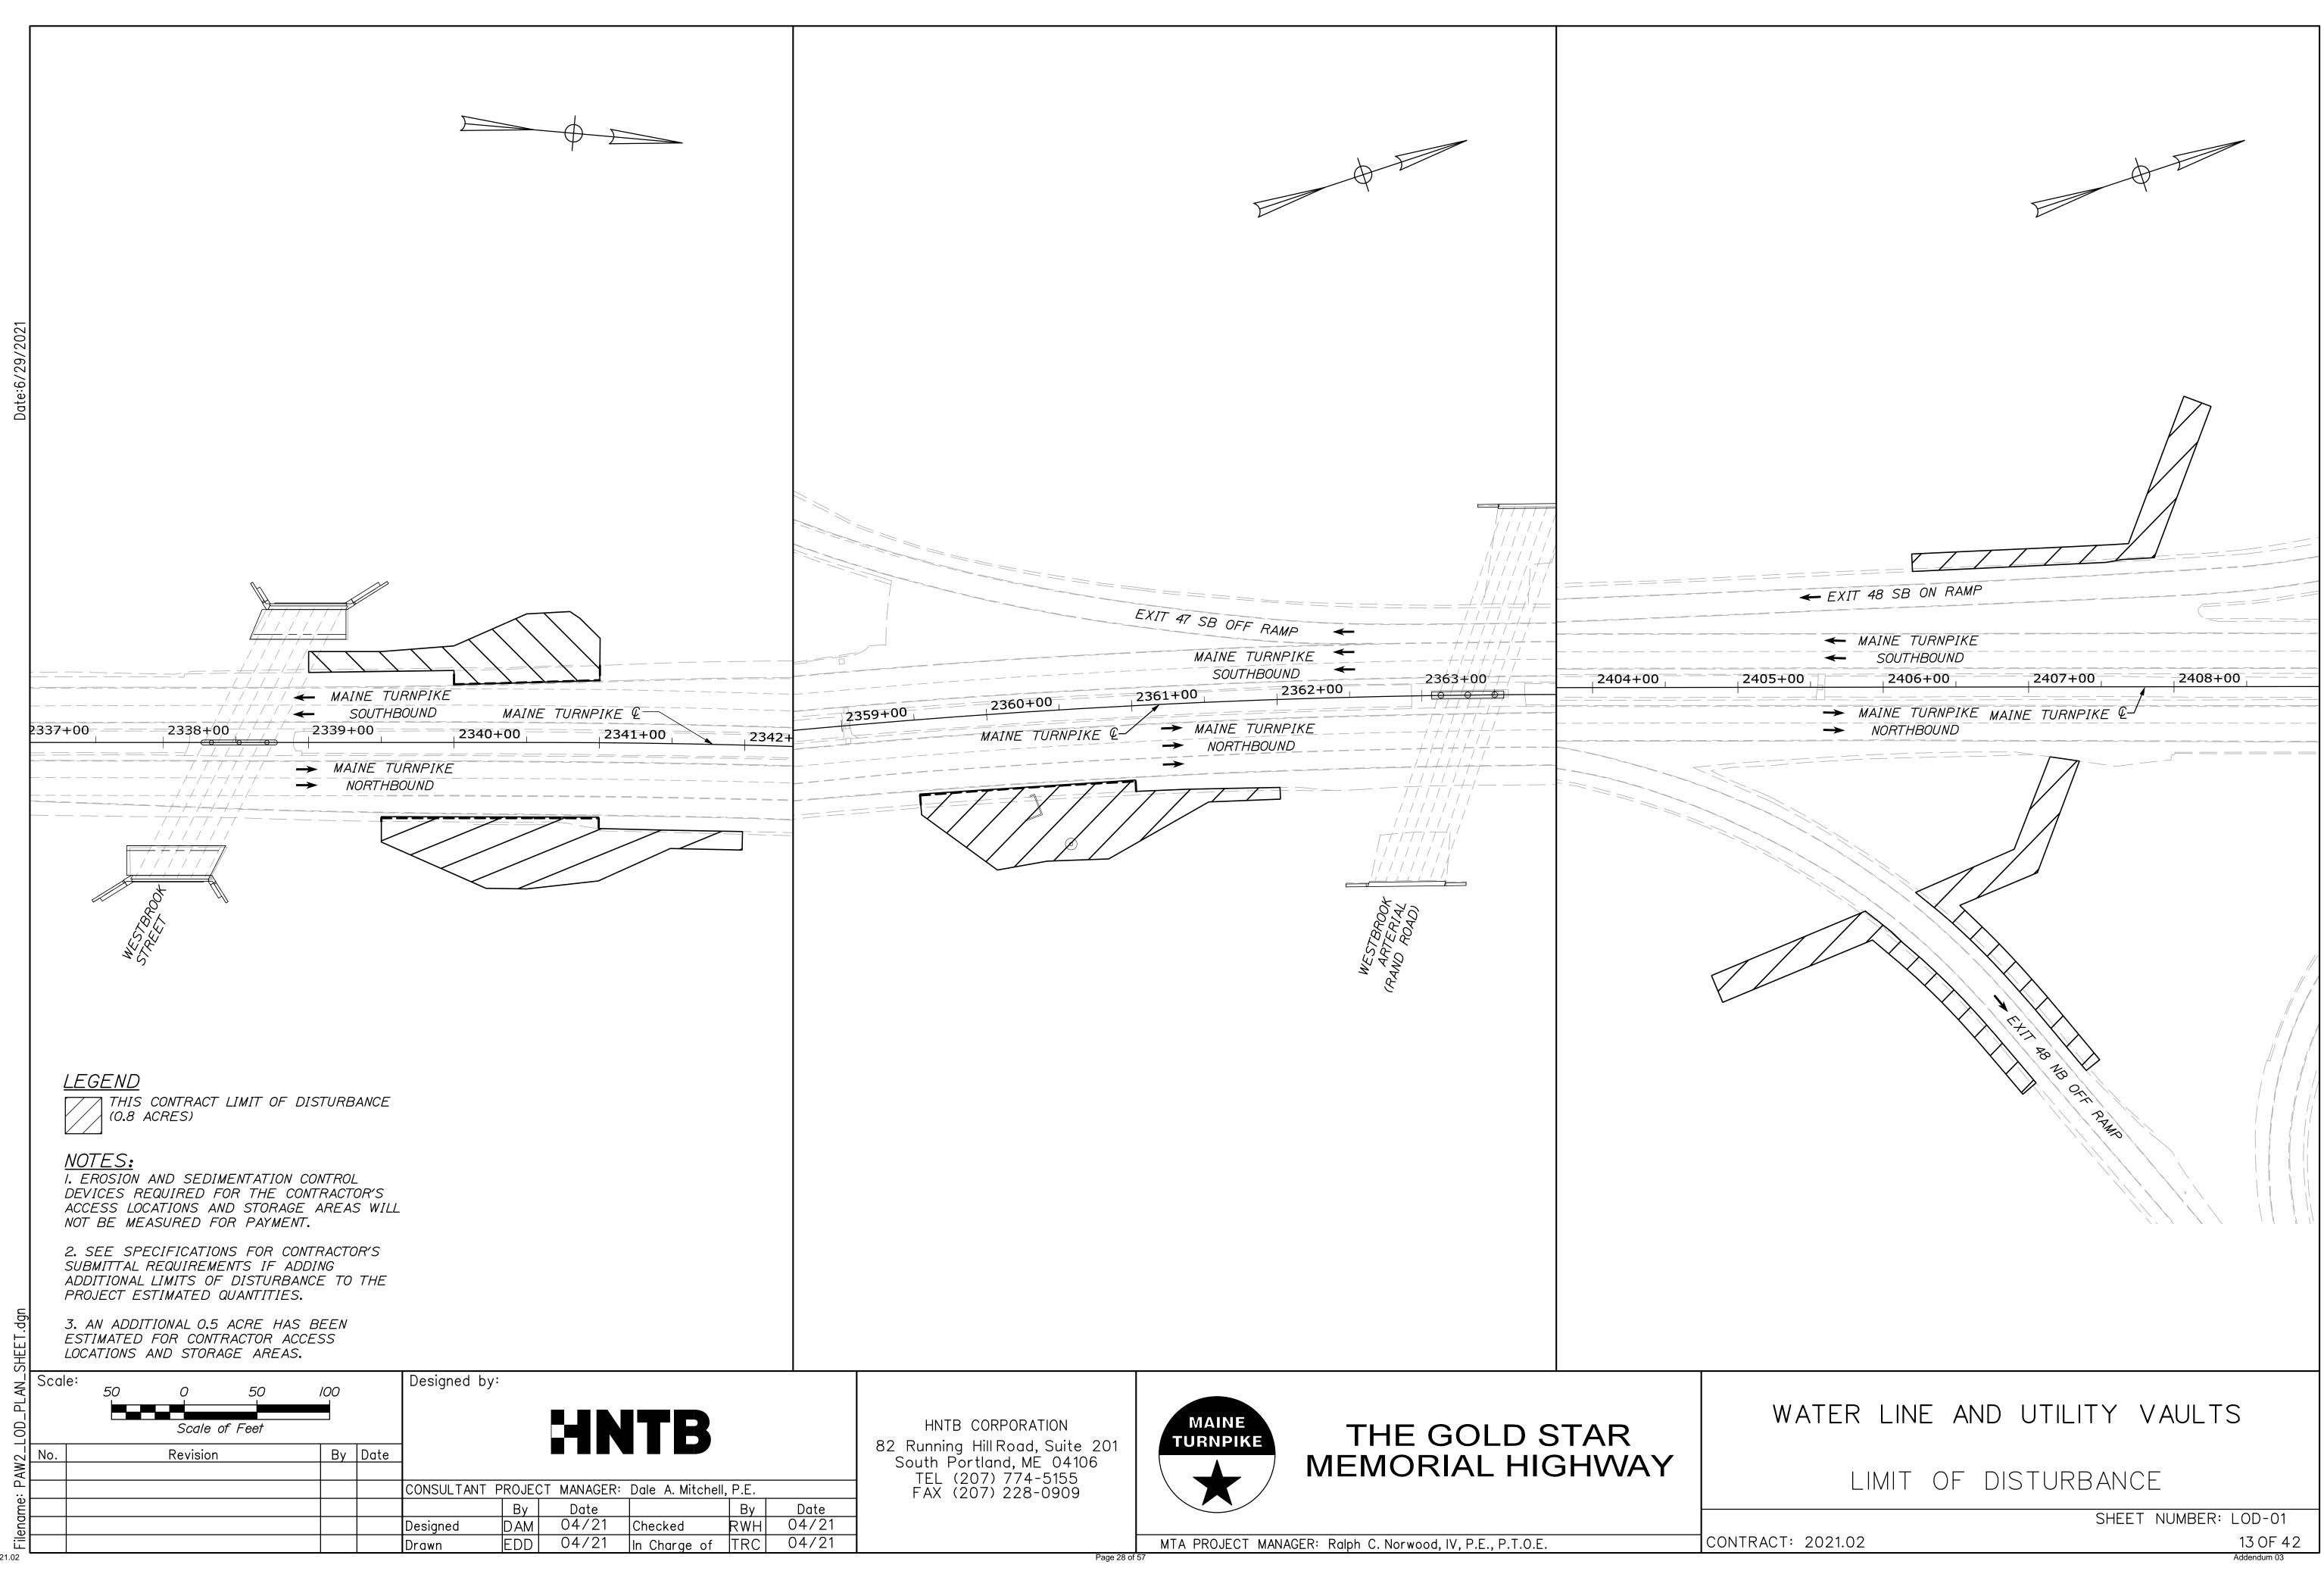

Addendum 03

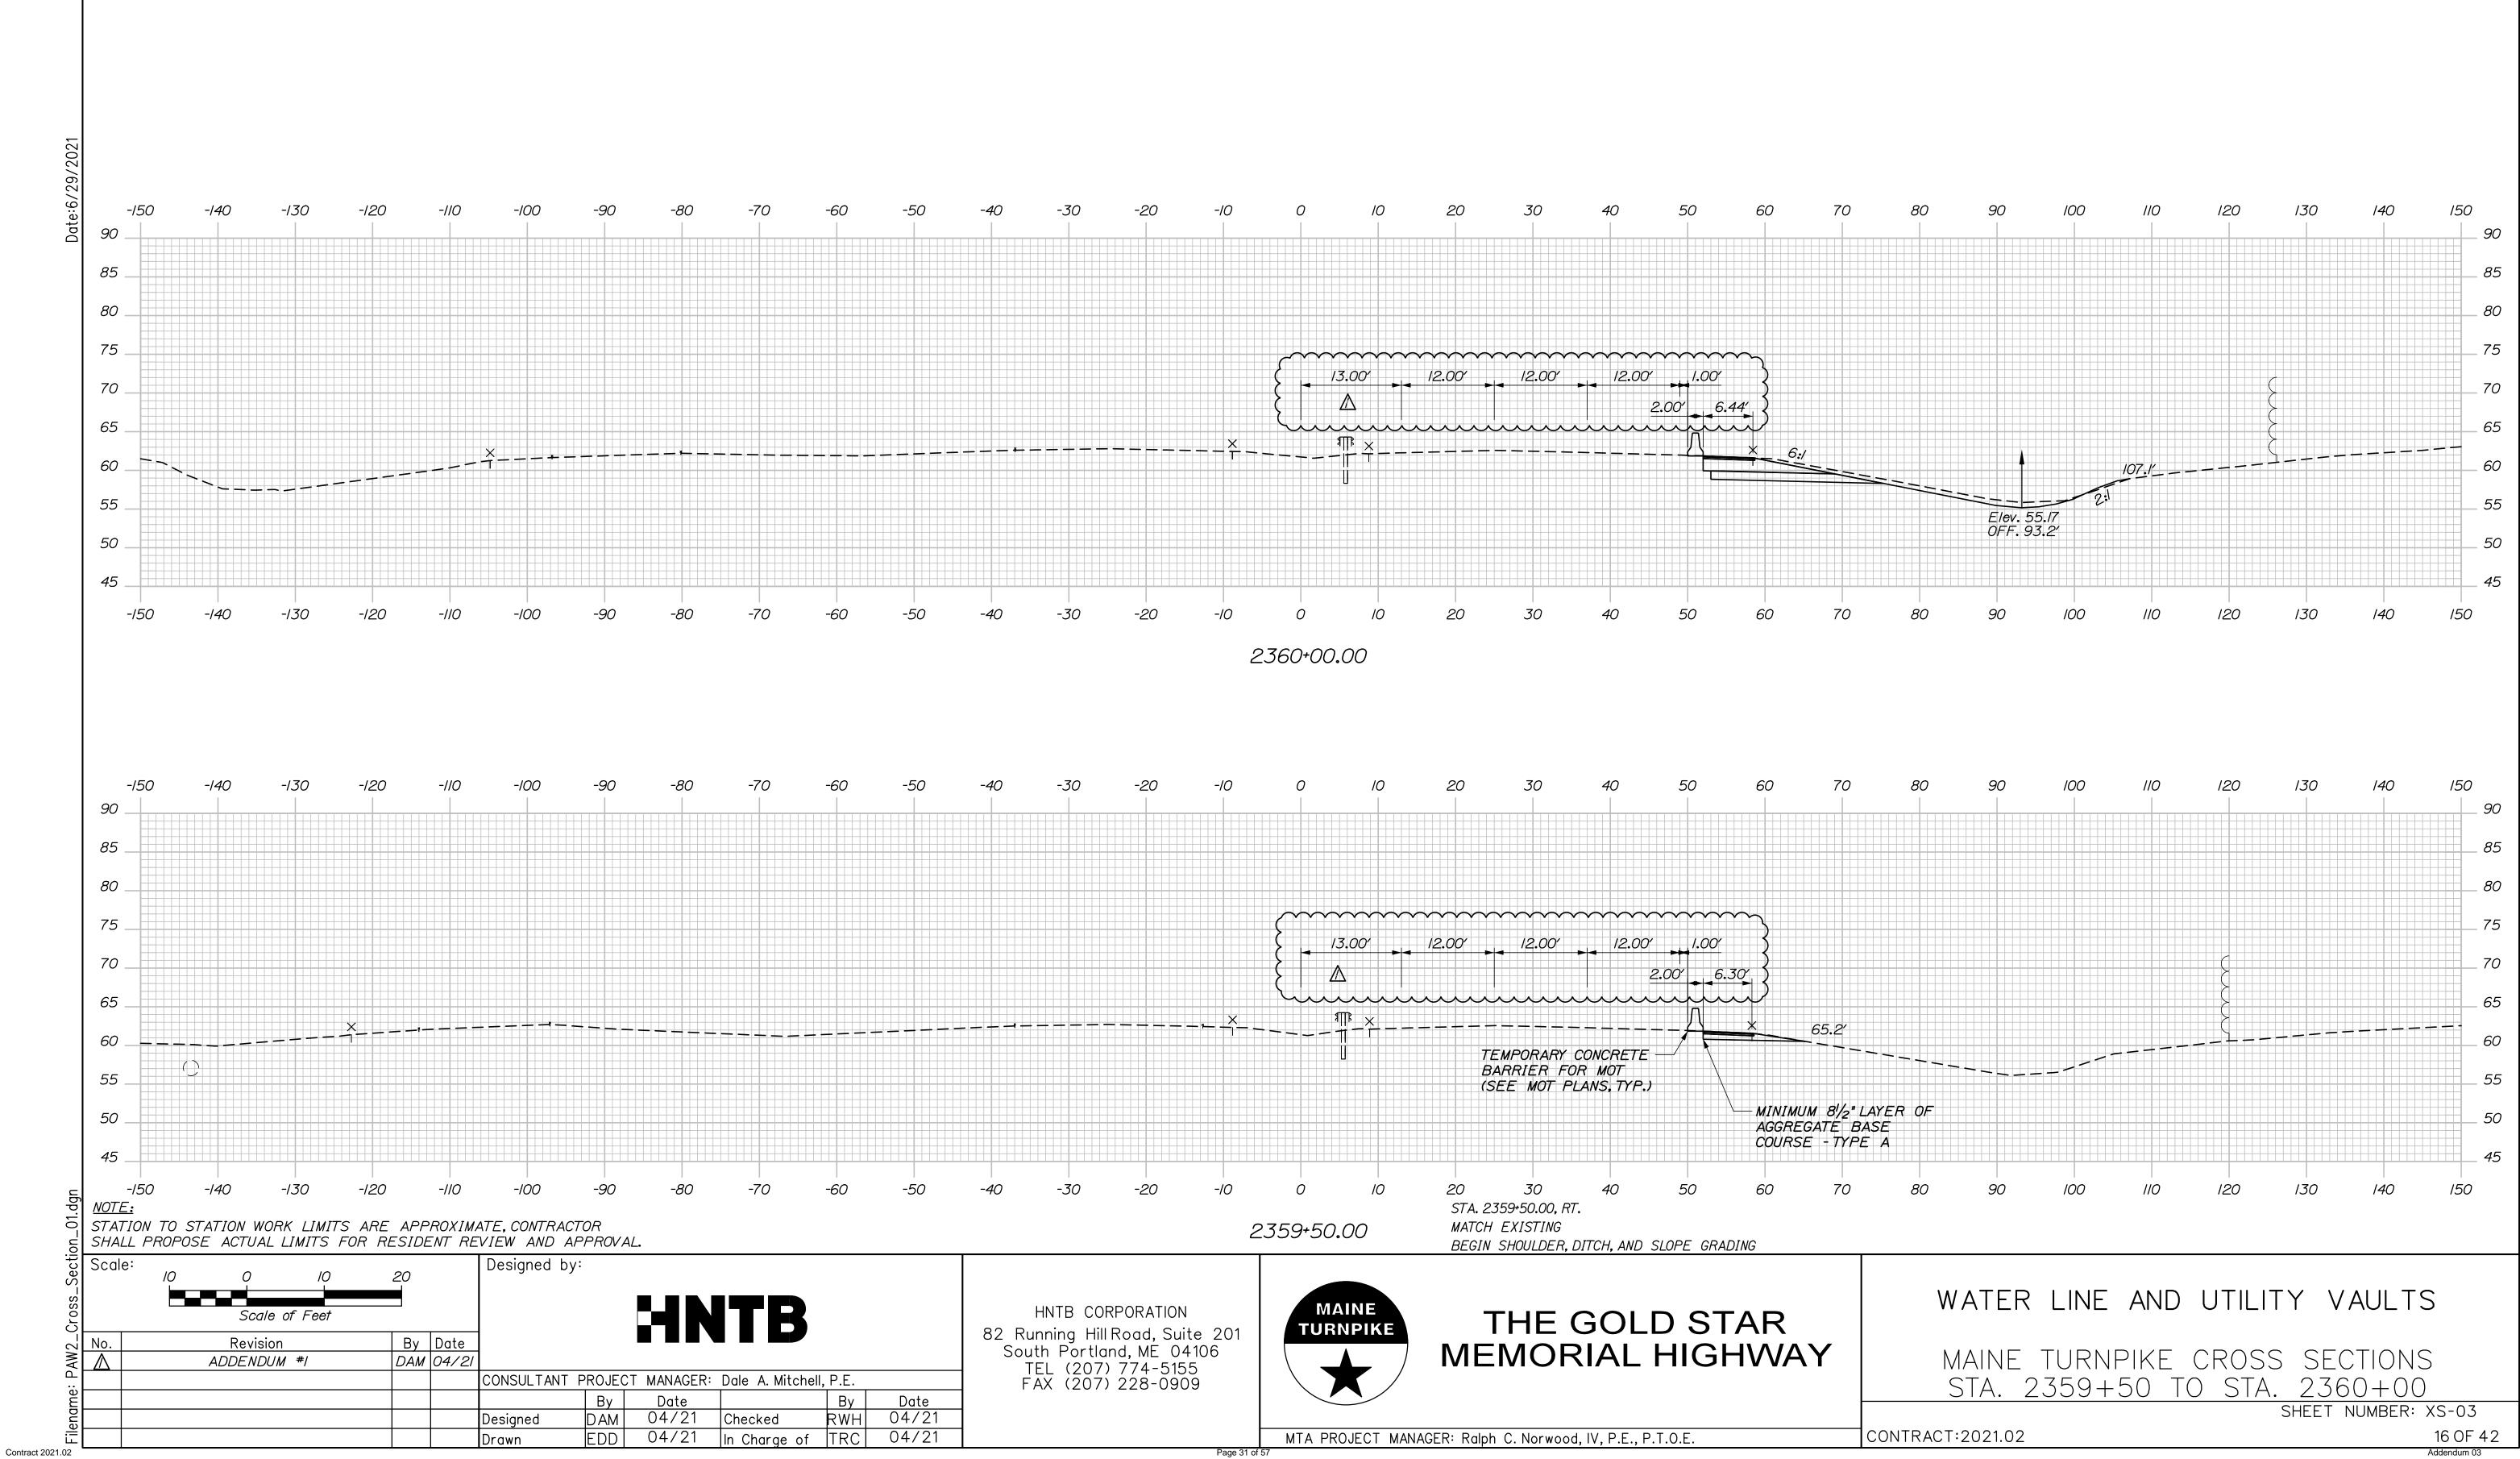

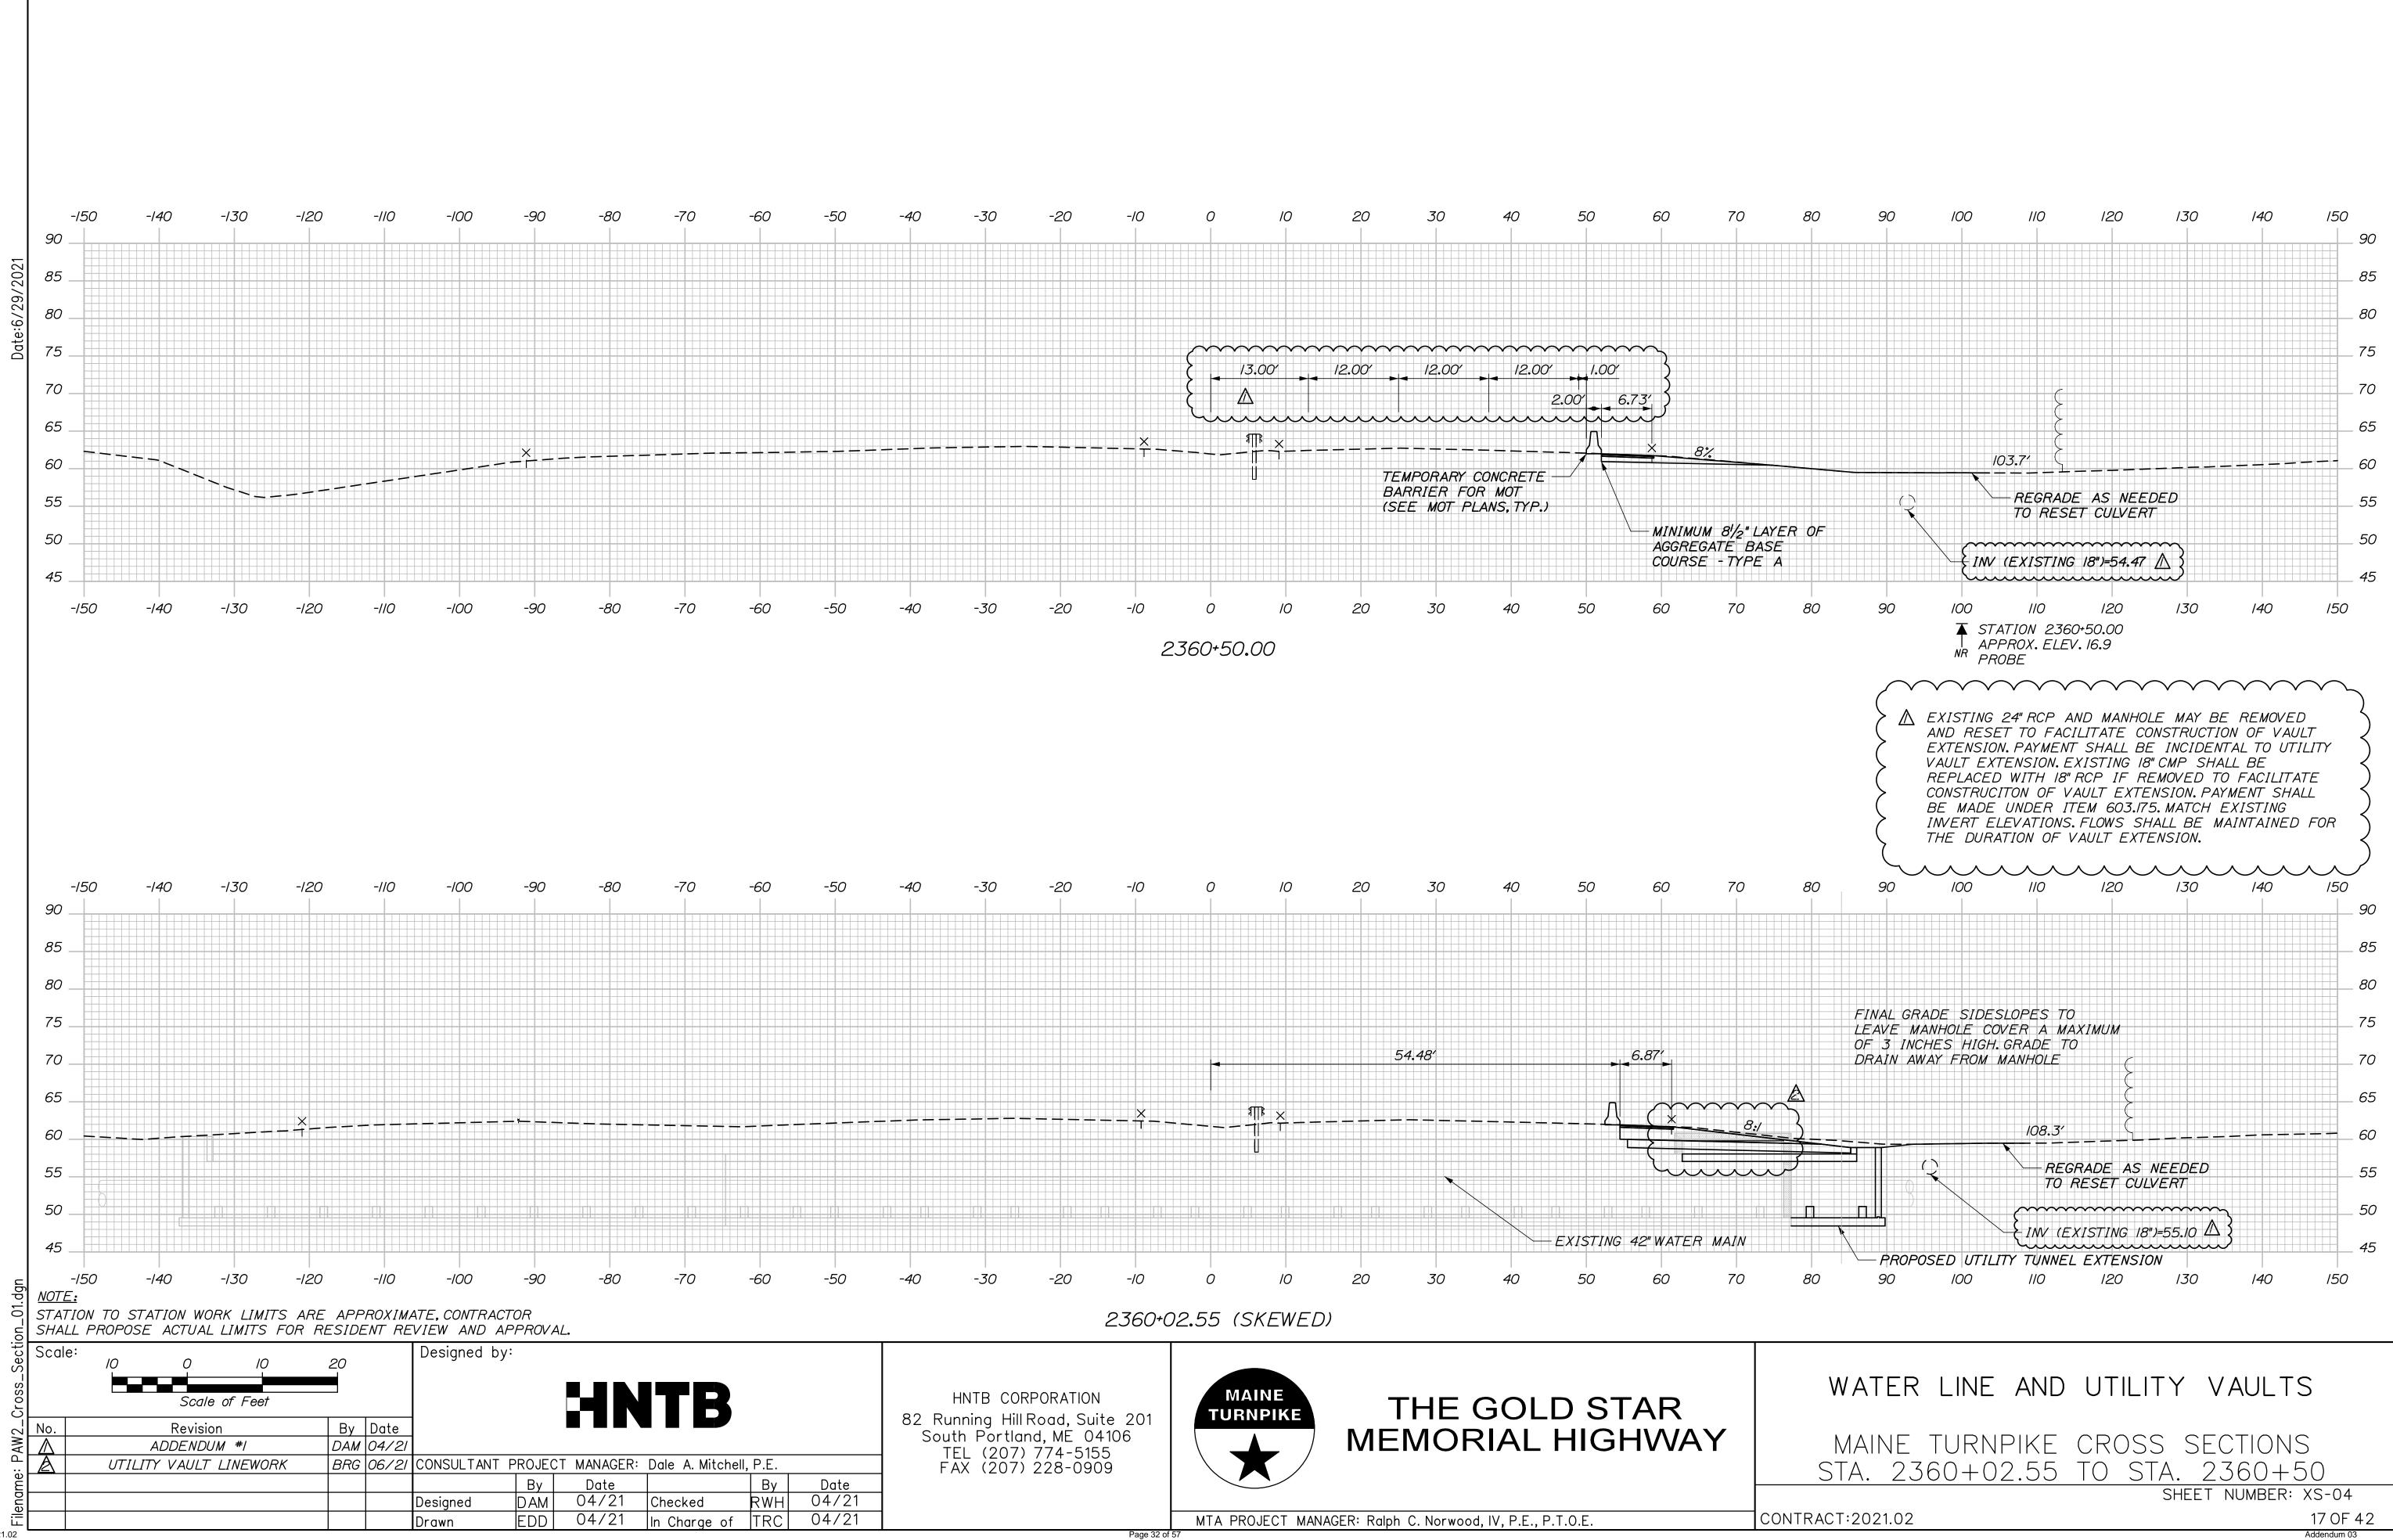

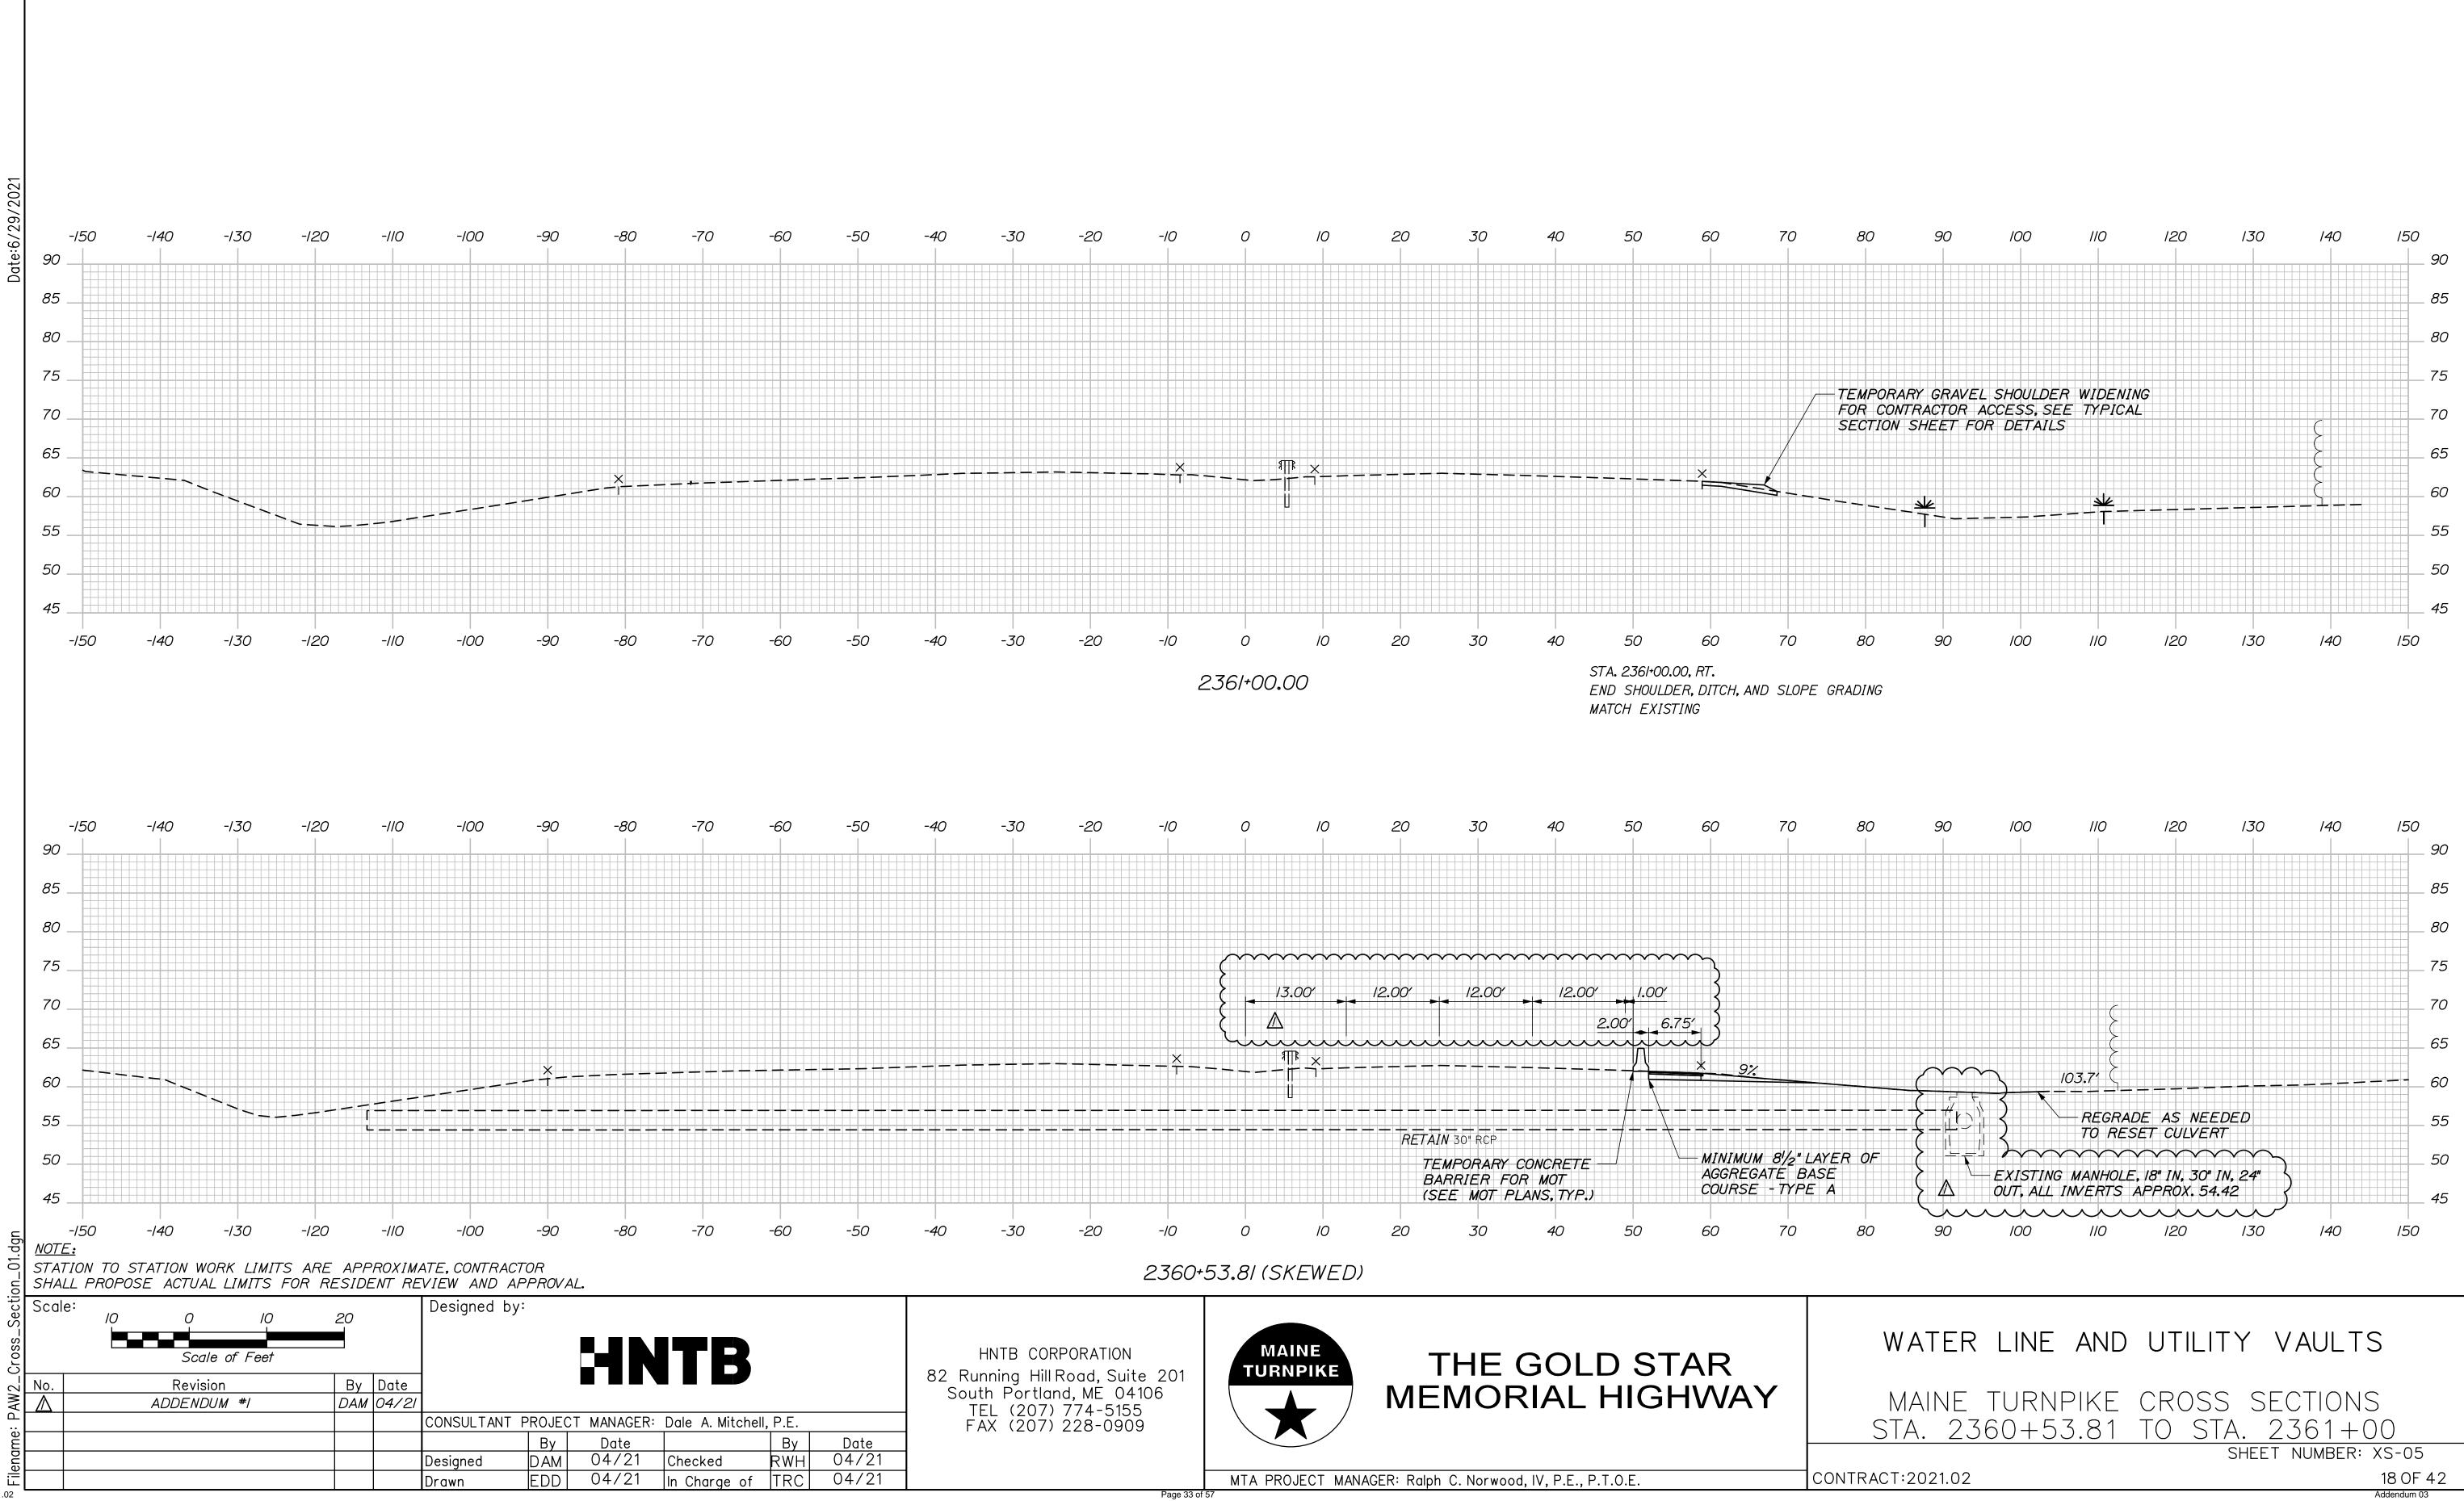

Filename: 019_Gener	No. 1	Revision CONCRETE REMOVAL QUANTITY	By BRG	Date 06/21	CONSULTANT Designed Drawn	PROJEC <sup>-</sup> By BRG ERB		Dale A. Mit Checked In Charge	chell, P.E. By JDW	Date 03/21 03/21
General Notes	Scale	e: NO SCALE			Designed by					
Rev. 1	6. D. PRO	LL BE NO LESS THAN THE MINIMU IMENSIONS WITH RESPECT TO EXIS VIDED FOR REFERENCE.IF FIELD ENSIONS SHOWN ON THE PLANS, TH	STING CONE	STRUC DITIONS	TURES ARE . VARY BY MOR	APPROX RE THA	'IMATE ANL N I" FROM			1 1 1 1 1 1 1 1 1 1 1 1 1 1 1 1 1 1 1
	I. TH PLA 2. C THE 3. F 4. C 5. W CON EPO SHA	NERAL NOTES: HE PROPOSED ELEVATIONS ARE B NS ARE BASED ON NGVD 29 DATU COPIES OF THE AS-BUILT PLANS A ACCURACY OF THESE PLANS IS I REINFORCING STEEL SHALL HAVE A CHAMFER ALL EXPOSED CONCRETE HERE DRILLING AND ANCHORING OF TRACTOR SHALL USE A MATERIAL DXY AND RESIN BASED ADHESIVE ALL BE SUFFICIENT TO DEVELOP 12	M. RE O VOT G CLE, EDGE F RE, LISTE BOND, 25% O	N FILE UARANT AR COV SS 3/4" U INFORC D ON T ING SY. F THE	AT THE MAI TEED. YER OF 2", UN JNLESS OTHEN ING STEEL IS THE MAINEDOT STEMS. THE D YIELD STREN	NE TUF LESS O RWISE SPECI T PREQ PEPTH O NGTH OI	RNPIKE AUT THERWISE NOTED. FIED THE UALIFIED I DF EMBEDN THE BAF	THORITY. NOTED. LIST OF MENT R, BUT		т Т М С S 5 Т 6 С Т Е 7 S С
		<u>EINFORCING STEEL</u> -GRADE 60 TRUCTURAL STEEL-ASTM 572,G -ASTM 709,G	RADE	- 50; fy						7 3 F 4
		STEEL H-PILES, ASTM A572, GRADE ALL OTHER STRUCTURAL STEEL SI <u>SIC DESIGN STRESSES</u> <u>ONCRETE</u> - CLASS AAA - f'c = 4,500	HALL		RM TO ASTM A	4709, GF	PADE 50			S D M 2 C F S
Date:6/29/2021	<u>C</u> <u>R</u> <u>A</u>	<u>ONCRETE</u> CLASS AAA <u>EINFORCING STEEL</u> AASHTO M3I, GRADE 60 EPOXY CO <u>NCHOR BOLTS</u> ASTM FI554, GRADE 55 <u>TRUCTURAL STEEL</u>							604.1583	
	<u>/_</u>	<u>SIGN LOADING</u> IVE LOAD-HL-93 TERIALS							501.92 511.091 514.06 604.1581 604.1582	PILE TEM CUR
		HIGHWAYS AND BRIDGES, NOVEMBL AASHTO LRFD BRIDGE CONSTRUCT							501.401 501.90 501.91	STE PILE PILE
		STATE OF MAINE, DEPARTMENT OF HIGHWAYS AND BRIDGES, REVISIO STATE OF MAINE DEPARTMENT O	N OF	NOVEM	BER 2014.				NO. 202.12 501.231 501.40	REM DYN STE
	<u>D</u>	<u>ECIFICATIONS</u> <u>ESIGN</u> AASHTO LRFD BRIDGE DESIGN SF <u>ONSTRUCTION</u>	PECIF	ICATIO	NS, 8TH EDITI	ON.			ITEM	

			7		INDEX OF DRAWINGS	
QUANTITY TABLE			PAGE NO.	TITLE	SHEET NO.	
DESCRIPTION	UNIT	STRUCTURAL		19	STRUCTURAL PLANS GENERAL NOTES	S-0/
		QUANTITY		20	UTILITY VAULT DETAILS STA. 2340+52.81	S-02
REMOVE EXISTING STRUCTURAL CONCRETE	CY	( 50 )	/ /	21	UTILITY VAULT DETAILS STA. 2340+52.81 - DETAILS I	S-03
DYNAMIC LOAD TEST	EA	2		22	UTILITY VAULT DETAILS STA. 2340+52.81 - DETAILS II	S-04
STEEL H-BEAM PILES, 53 LB/FT, DELIVERED	LF	865		23	UTILITY VAULT DETAILS STA. 2340+52.81 - DETAILS III	S-05
STEEL H-BEAM PILES, 53 LB/FT, IN PLACE	LF	865		24	UTILITY VAULT DETAILS STA. 2340+52.81 - DETAILS IV	S-06
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PILE DRIVING EQUIPMENT MOBILIZATION	LS	1		27	UTILITY VAULT DETAILS STA. 2360+02.55 - DETAILS I	S-09
TEMPORARY EARTH SUPPORT SYSTEMS	LS	1		28	UTILITY VAULT DETAILS STA. 2360+02.55 - DETAILS II	S-10
CURING BOX FOR CONCRETE CYLINDERS	EA	/		29	UTILITY VAULT DETAILS STA. 2360+02.55 - DETAILS III	S-11
UTILITY VAULT EXTENSION - STA 2360+02.55 NB	LS	1	-	30	UTILITY VAULT DETAILS STA. 2360+02.55 - DETAILS IV	S-12
UTILITY VAULT EXTENSION - STA 2340+52.8/ NB	LS	1		3/	UTILITY VAULT DETAILS STA. 2360+02.55 - REINFORCING SCHEDULE	S-/3
UTILITY VAULT EXTENSION - STA 2340+52.8/SB	LS	1	-			

## UTILITY VAULT NOTES:

I. ALL EXISTING DIMENSIONS AND DETAILS ARE TAKEN FROM ORIGINAL DESIGN DRAWINGS AND ARE NOT GUARANTEED. THE CONTRACTOR SHALL DETERMINE AND ESTABLISH ALL DIMENSIONS AND EXISTING DETAILS NECESSARY FOR COMPLETION OF ALL WORK BY FIELD MEASUREMENT AND SURVEY.

2. PAYMENT FOR REMOVAL OF EXISTING CONCRETE AND SAW CUTTING CONCRETE IS INCIDENTAL TO THE RELATED UTILITY VAULT EXTENSION PAY ITEMS. BEFORE REMOVAL OF CONCRETE, THE DEMOLITION LIMIT SHALL BE SAW CUT TO A DEPTH OF I" MINIMUM. CARE SHALL BE TAKEN NOT TO DAMAGE ANY REINFORCING STEEL THAT IS TO REMAIN.

3. BARS BROKEN DURING REMOVAL OF EXISTING CONCRETE SHALL BE REPLACED AT THE CONTRACTOR'S EXPENSE BY DRILLING AND ANCHORING AN EQUIVALENT SIZED BAR.

4. THE CONTRACTOR SHALL DEVELOP A CONSTRUCITON PROCEDURE, TEMPORARY WATER MAIN SUPPORT, AND TEMPORARY SUPPORT SYSTEMS THAT WILL PROTECT, AT ALL TIMES, THE WATER MAINS. EACH WATER MAIN WILL BE REMOVED FROM SERVICE DURING THE WORK BY CLOSING THE VALVES ON EACH SIDE OF THE WORK AREA. SEE SPECIAL PROVISION 604 FOR ADDITIONAL INFORMATION.

5. THE UTILITY VAULTS SHALL FOLLOW THE HORIZONTAL ALIGNMENT OF THE EXISTING WATER MAIN.

6. MANHOLES SHALL BE NEENAH FOUNDRY COMPANY, R-6660-NH SERIES CATALOG NUMBER R-6660-NH, OR APPROVED EQUIVALENT. PAYMENT FOR THE MANHOLES ARE INCIDENTAL TO THE RELATED 604 UTILITY VAULT EXTENSION PAY ITEMS.

7. PREPARATION OF THE EXISTING CONCRETE SHALL PRODUCE A SOUND, CLEAN SURFACE FREE OF BOND INHIBITING MATERIALS. ANY CONCRETE AREAS FOUND TO BE UNSOUND SHALL BE RE-CHIPPED BY THE CONTRACTOR. PAYMENT SHALL BE INCIDENTAL TO THE RELATED UTILITY VAULT EXTENSION PAY ITEMS.

8. APPLY A BONDING AGENT TO THE EXISTING CONCRETE SURFACES PRIOR TO PLACING NEW CONCRETE. THE MANUFACTURER'S INSTRUCTIONS FOR THE SELECTED BONDING AGENT MUST BE FOLLOWED AND APPROVED BY THE ENGINEER. PAYMENT SHALL BE INCIDENTAL TO THE RELATED UTILITY VAULT EXTENSION PAY ITEMS.

9. FOR MANHOLE STEP DETAILS SEE MAINE DEPARTMENT OF TRANSPORTATION STANDARD DETAILS, PAGE 604(03). PAYMENT SHALL BE INCIDENTAL TO THE RELATED UTILITY VAULT EXTENSION PAY ITEMS.

IO. FOR DETAILS OF EXISTING CONCRETE RETAINING WALL TO BE DEMOLISHED, SEE AS-BUILT PLANS FOR CONTRACT 2001.01.

HNTB CORPORATION

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II. STRUCTURAL EXCAVATION AND BACKFILL SHALL BE IN ACCORDANCE WITH MAINEDOT STANDARD SPECIFICATION 206 AND INCIDENTAL TO RELATED 604 PAY ITEMS.

LIST OF ABBREVIATIONS ABUT. - ABUTMENT ADDL. - ADDITIONAL ALT. - ALTERNATE APPROX. - APPROXIMATELY BOT. - BOTTOM BRG. - BEARING CB - CATCH BASIN CIP - CAST IN PLACE CL. - CLEAR/CLASS *Q* - CENTERLINE CONC. - CONCRETE CONSTR. - CONSTRUCTION CY - CUBIC YARD DEMO. - DEMOLITION DIA. - DIAMETER EA. - EACH EB - EASTBOUND E.F. - EACH FACE EL - ELEVATION EQ. - EQUAL



THE GOLD STAR MEMORIAL HIGHWAY

EXIST. - EXISTING EXP. - EXPANSION F.F. - FAR FACE JT. - JOINT LF - LINEAR FOOT LT. - LEFT MAX. - MAXIMUM MEDOT - MAINE DEPARTMENT OF TRANSPORTATION MIN. - MINIMUM MTA - MAINE TURNPIKE AUTHORITY NB - NORTHBOUND N.F. - NEAR FACE N.T.S. - NOT TO SCALE OC - ON CENTER OHSS - OVERHEAD SIGN STRUCTURE OPT - OPTION PED. - PEDESTAL PGL - PROFILE GRADE LINE P - PLATE


PROP. - PROPOSED P.S.I. - POUNDS per SQUARE INCH RCP - REINFORCED CONCRETE PIPE RDWY. - ROADWAY RT. - RIGHT SHLDR. - SHOULDER SB - SOUTHBOUND SF - SQUARE FEET SP. - SPACES STA. - STATION TEMP. - TEMPORARY T.&B. - TOP & BOTTOM TPKE. - TURNPIKE TYP. - TYPICAL U.O.N. - UNLESS OTHERWISE NOTED VERT. - VERTICAL V.I.F. - VERIFY IN FIELD WB - WESTBOUND W.P. - WORKING POINT WW - WINGWALL




## STRUCTURAL PLANS GENERAL NOTES


CONTRACT:2021.02

SHEET NUMBER: S-01

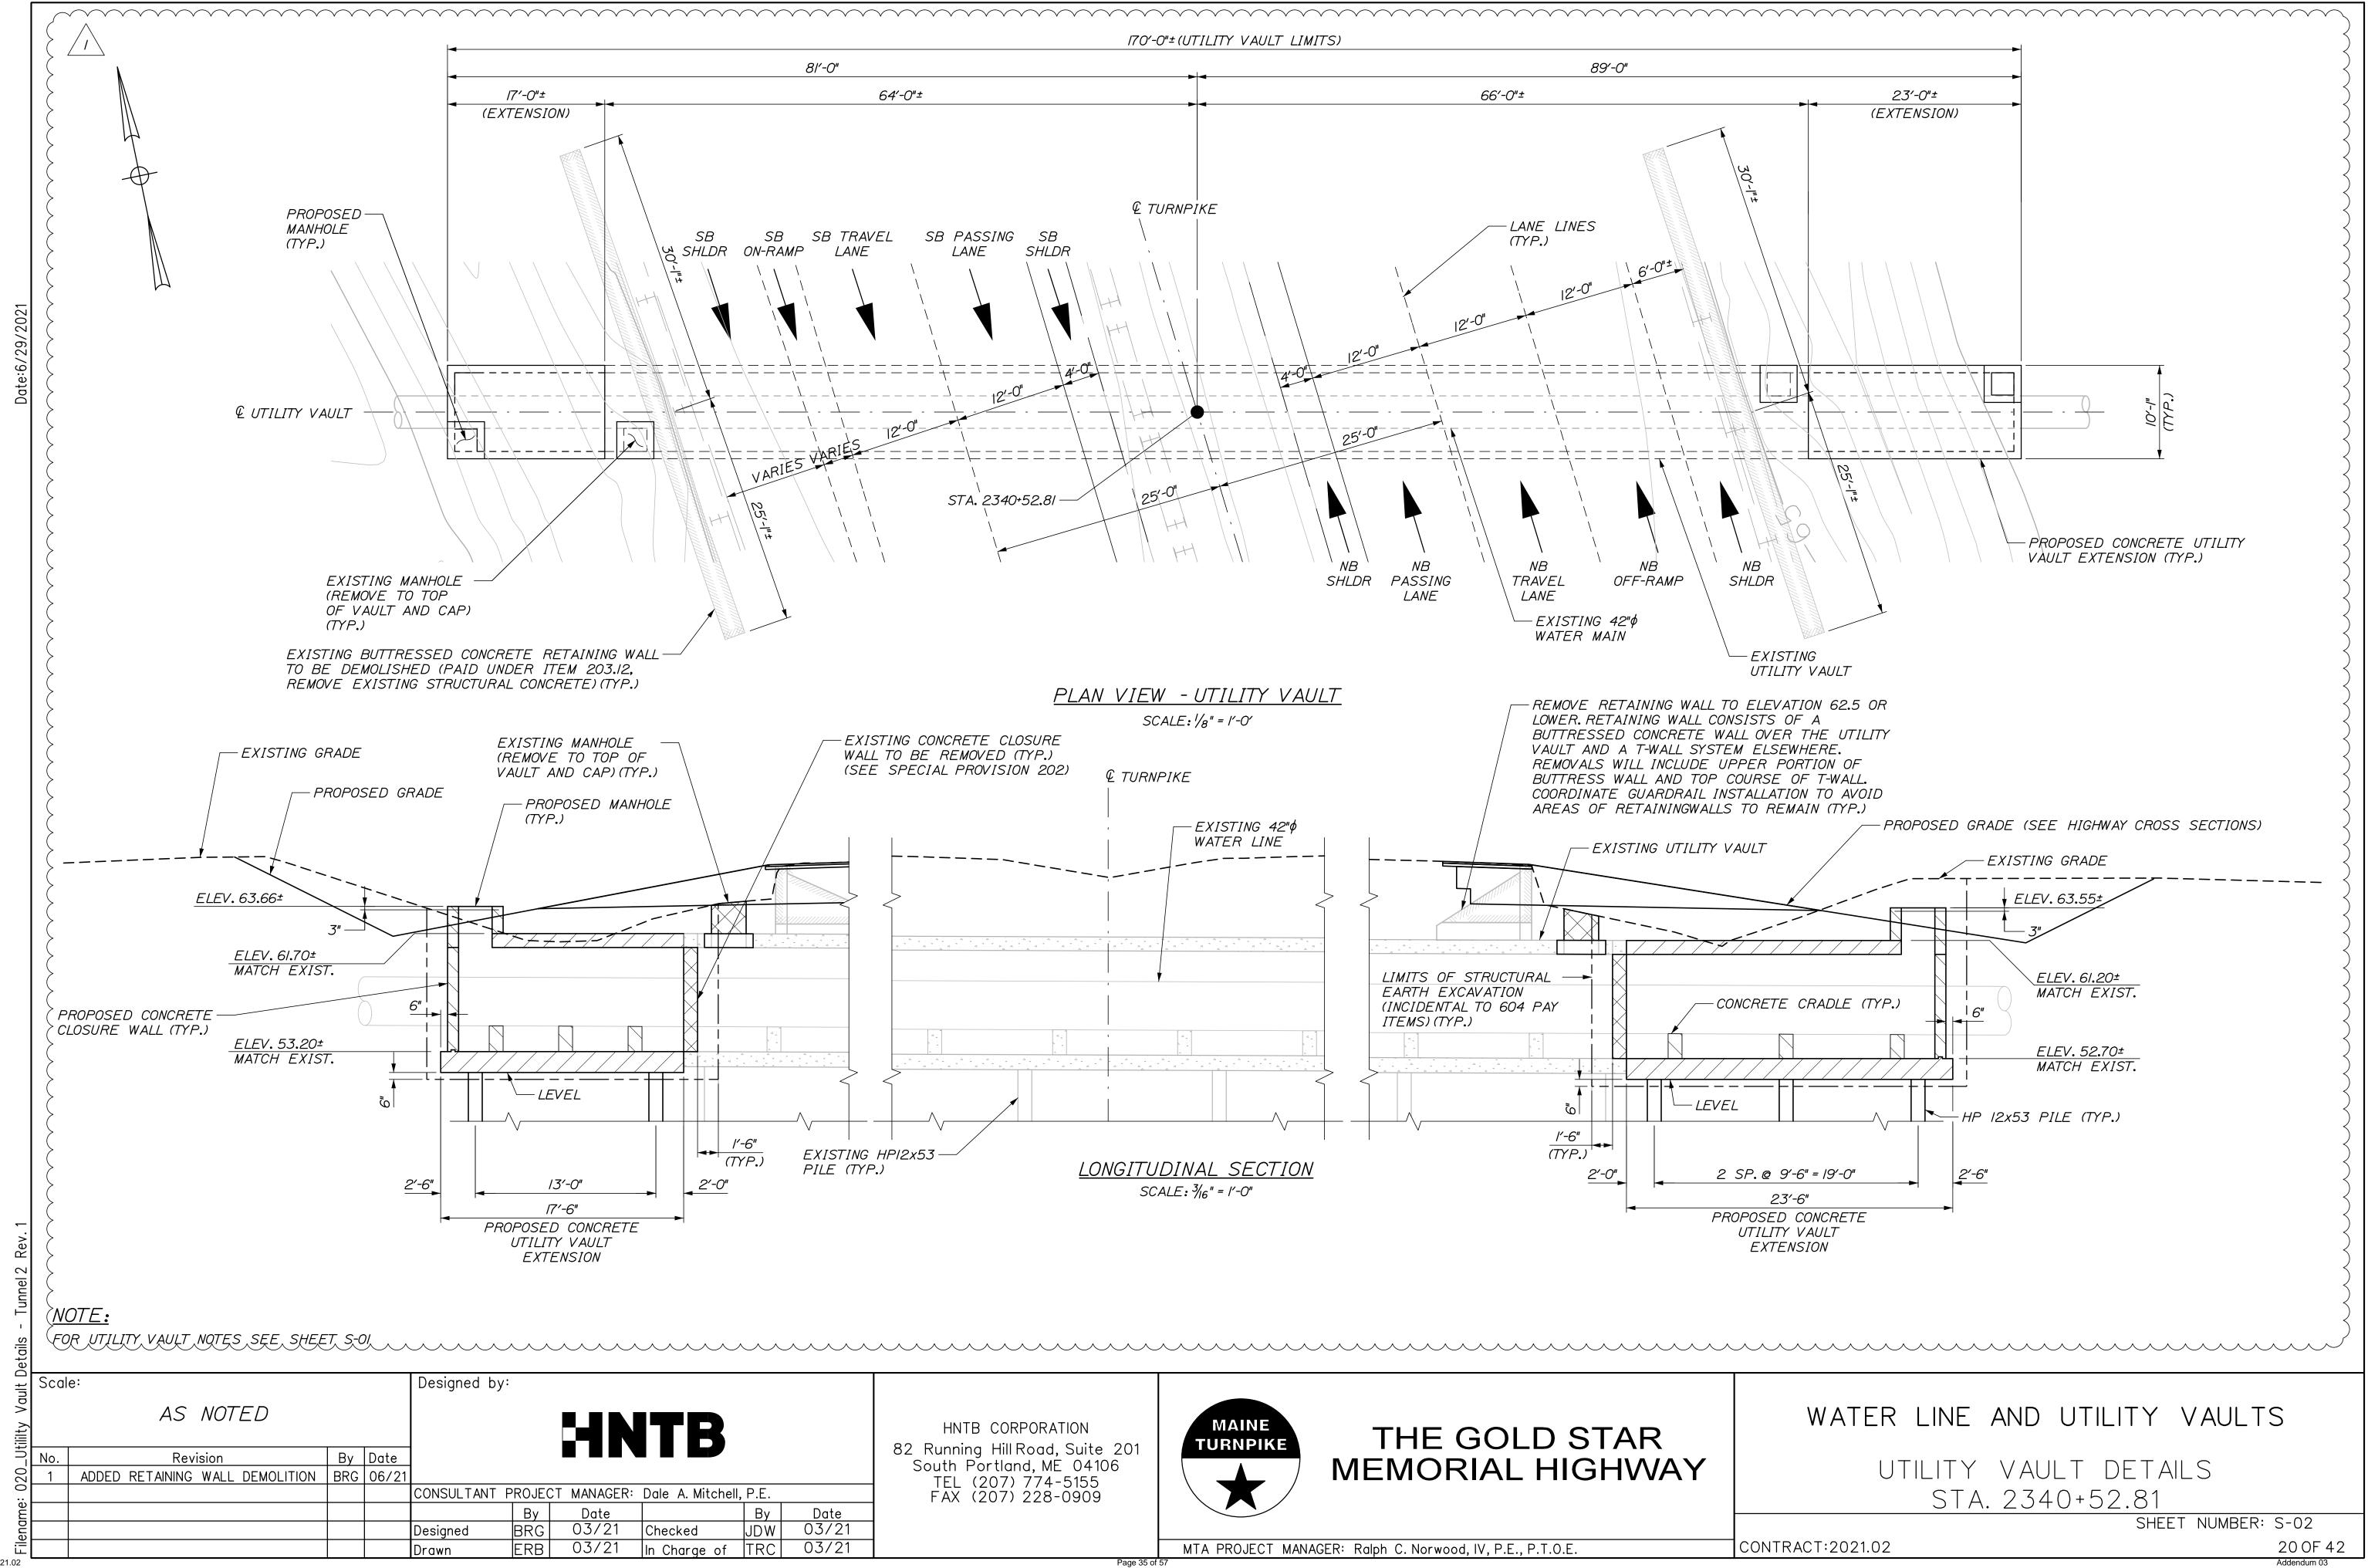

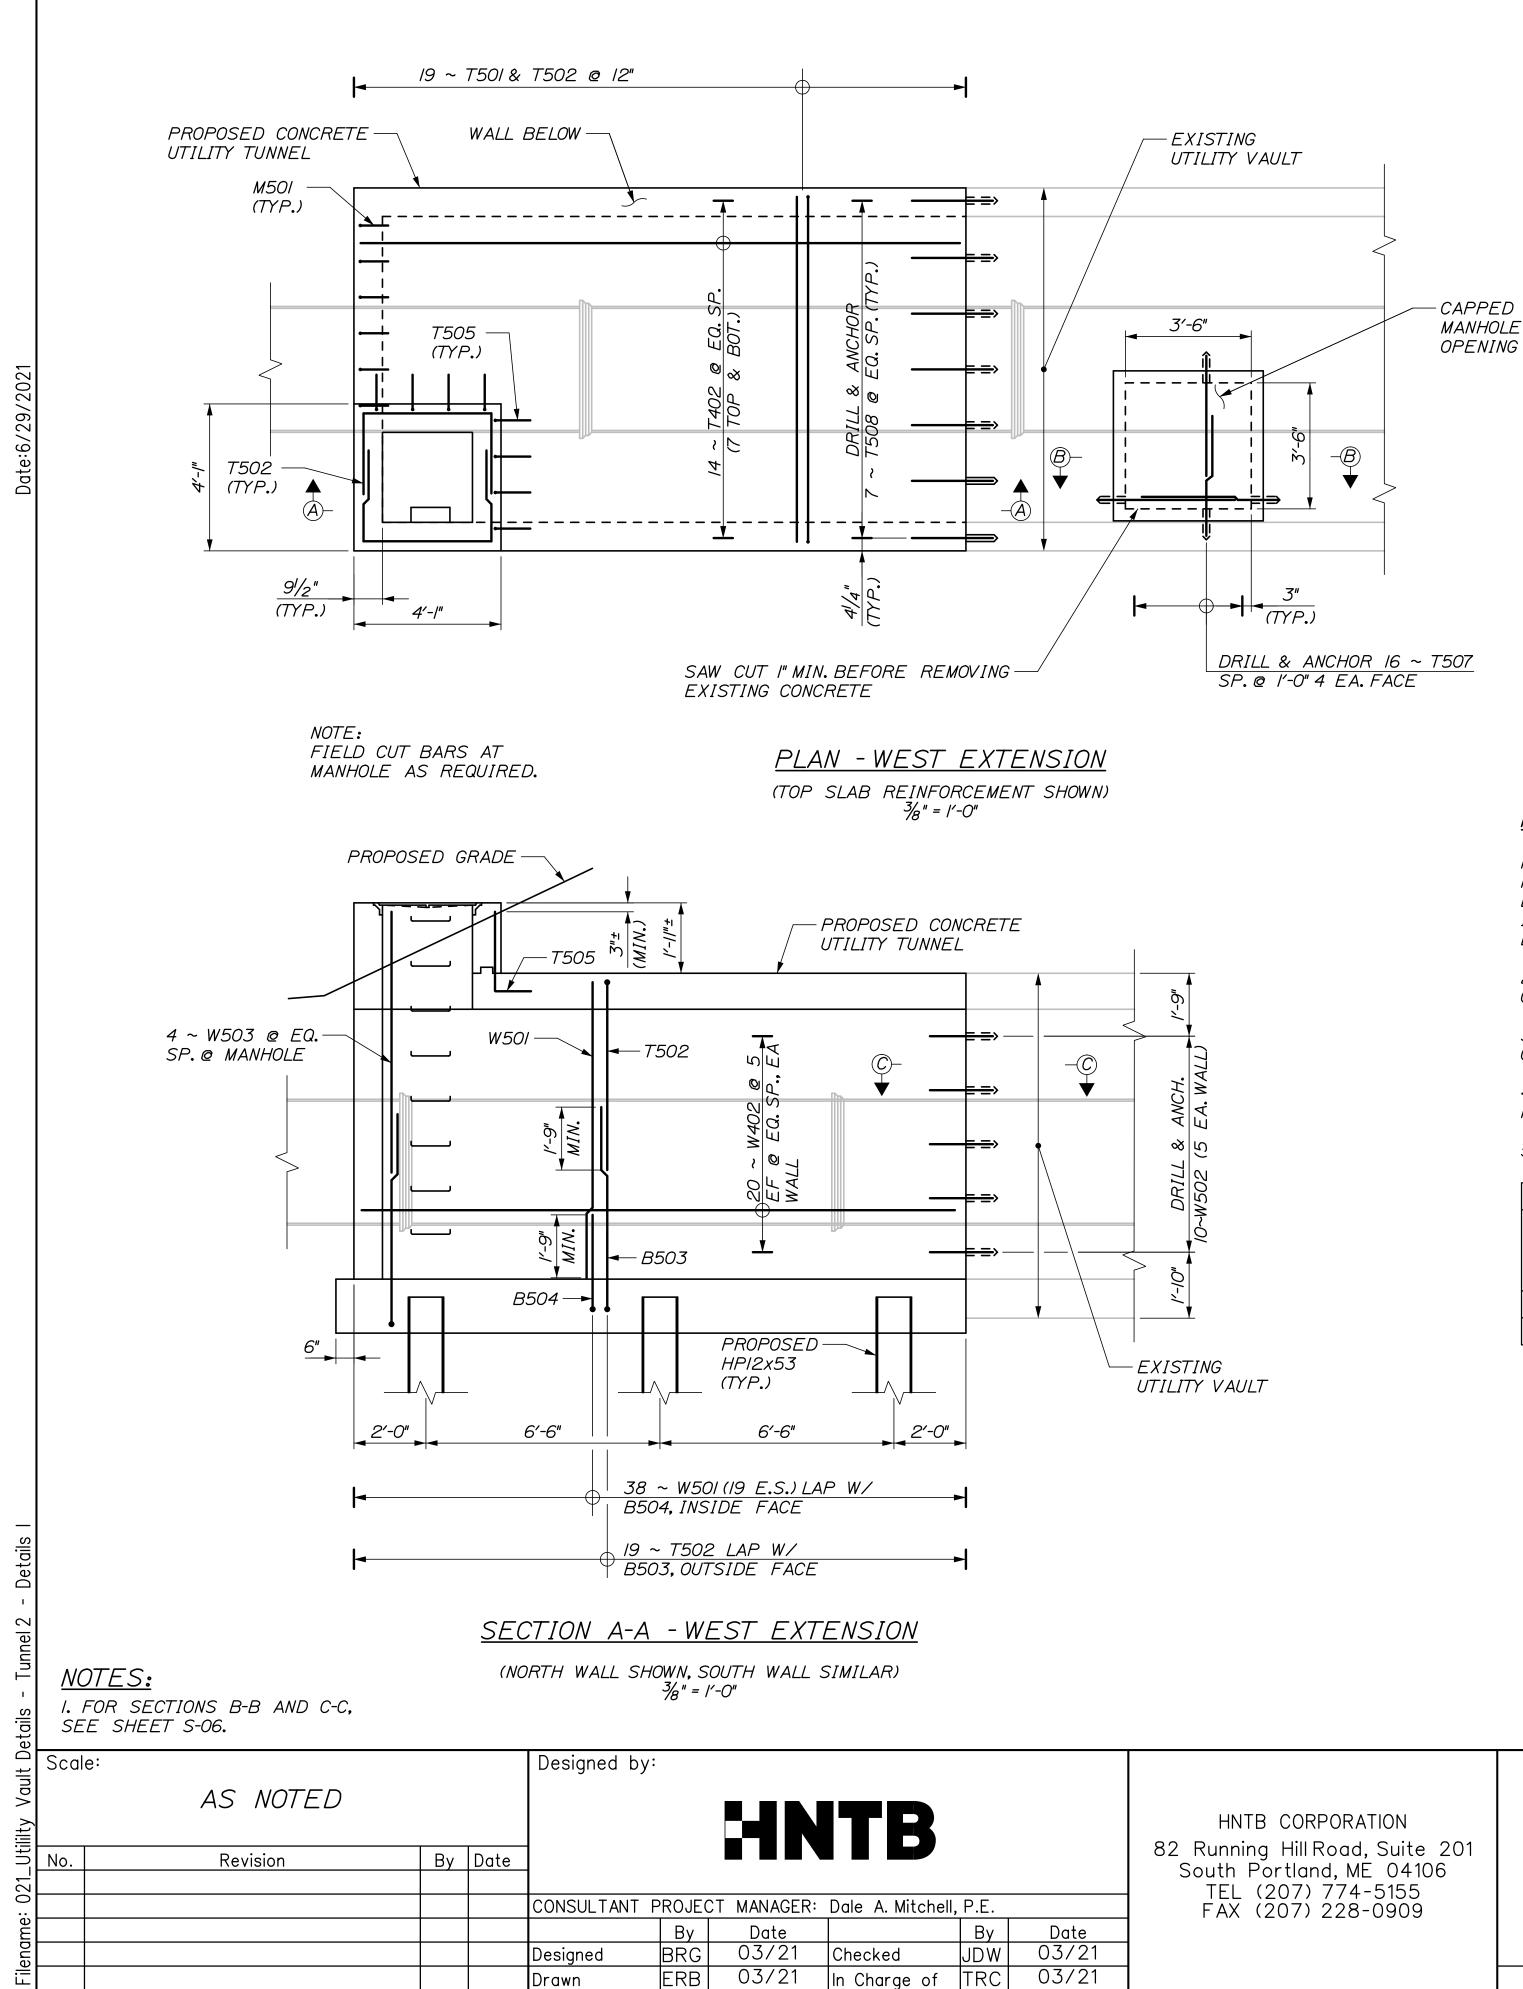

Contract 2021.02

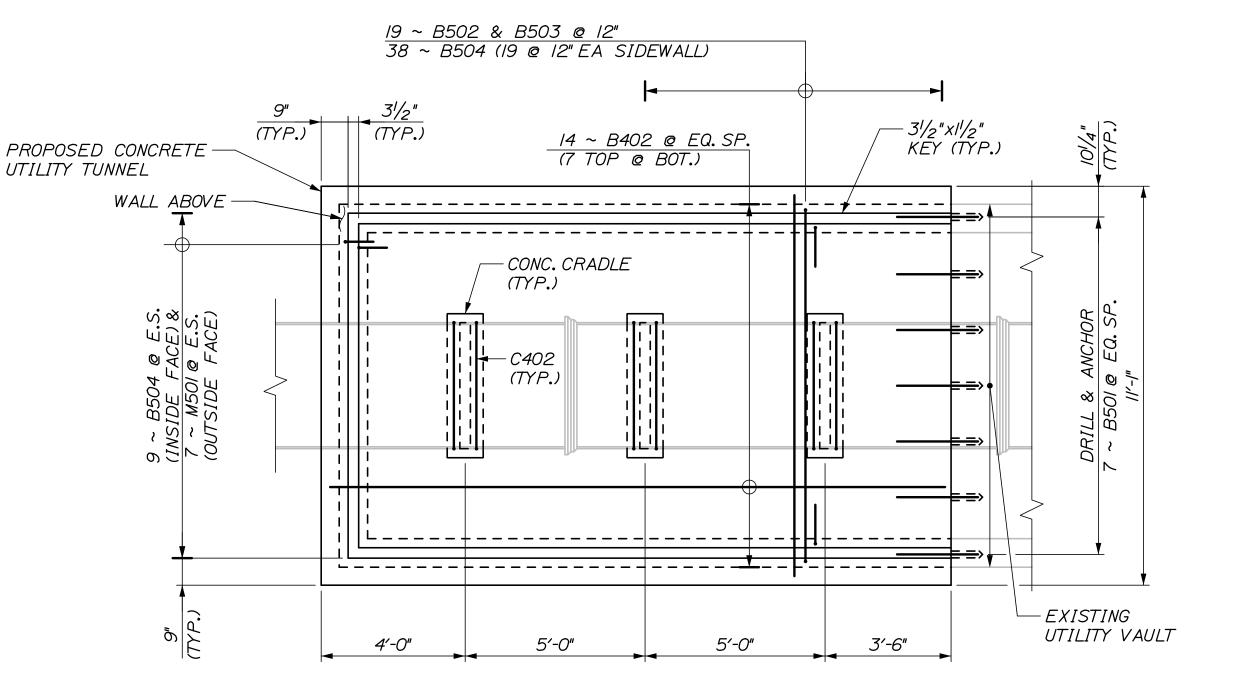

## PILE NOTES

I. THE CONTRACTOR SHALL PERFORM AND SUBMIT A WAVE EQUATION ANALYSIS FOR REVIEW AND ACCEPTANCE BY THE RESIDENT. THE MAXIMUM ALLOWABLE DRIVING STRESS IS 0.90 TIMES FY. THE SUBMITTAL ANALYSIS SHALL INCLUDE THE PROPOSED STOPPING CRITERIA BASED ON THE WAVE EQUATION ANALYSIS AND THE PROPOSED DRIVING SYSTEM. THE STOPPING CRITERIA SHALL INCLUDE THE BLOWS PER INCH AND THE NUMBER OF I-IN. INTERVALS AT WHICH PILE INSTALLATION MAY BE TERMINATED. THE COST OF PERFORMING THE WAVE EQUATION ANALYSIS WILL BE CONSIDERED INCIDENTAL TO PAY ITEM 501.92.

2. THE CONTRACTOR SHALL PERFORM 2 DYNAMIC LOAD TEST(S), ONE AT EACH FOUNDATION, TO CONFIRM THE NOMINAL DRIVING RESISTANCE OF THE PILES. THE DYNAMIC TEST SHALL BE PERFORMED ON THE FIRST PRODUCTION PILE DRIVEN AT EACH FOUNDATION. 3. PILES SHALL BE IN ACCORDANCE WITH STANDARD SPECIFICATION 501. ESTIMATED PILE LENGTHS INCLUDE 10 FEET PER PILE AS

CONTINGENCY TO THE LENGTH OF THE PILES REQUIRED.


4. ALL PILES SHALL BE EQUIPPED WITH A PILE TIP IN ACCORDANCE WITH STANDARD SPECIFICATION SECTION 501.048, PREFABRICATED PILE TIPS.


5. ELEVATIONS ARE APPROXIMATE AND ARE PROVIDED FOR REFERENCE ONLY.


	PILE DATA											
LOCATION	PILE SIZE	NUMBER OF PILES	AXIAL COMPH RESISTANCE		MINIMUM PILE TIP ELEVATION	ESTIMATED PILE	NOMINAL DRIVING RESISTANCE (KIPS)					
			NOMINAL	FACTORED								
NORTHBOUND	HP 12x53	6	486	3/6	-12	-20	600					
SOUTHBOUND	HP 12x53	4	535	348	-23	-28	671					





THE GOLD STAR MEMORIAL HIGHWAY

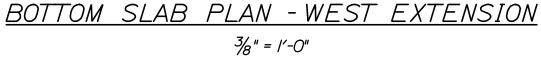


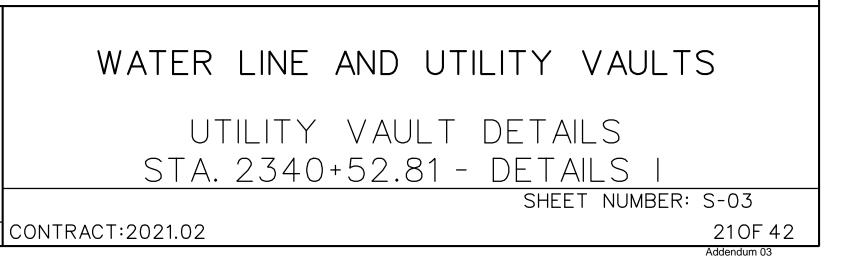

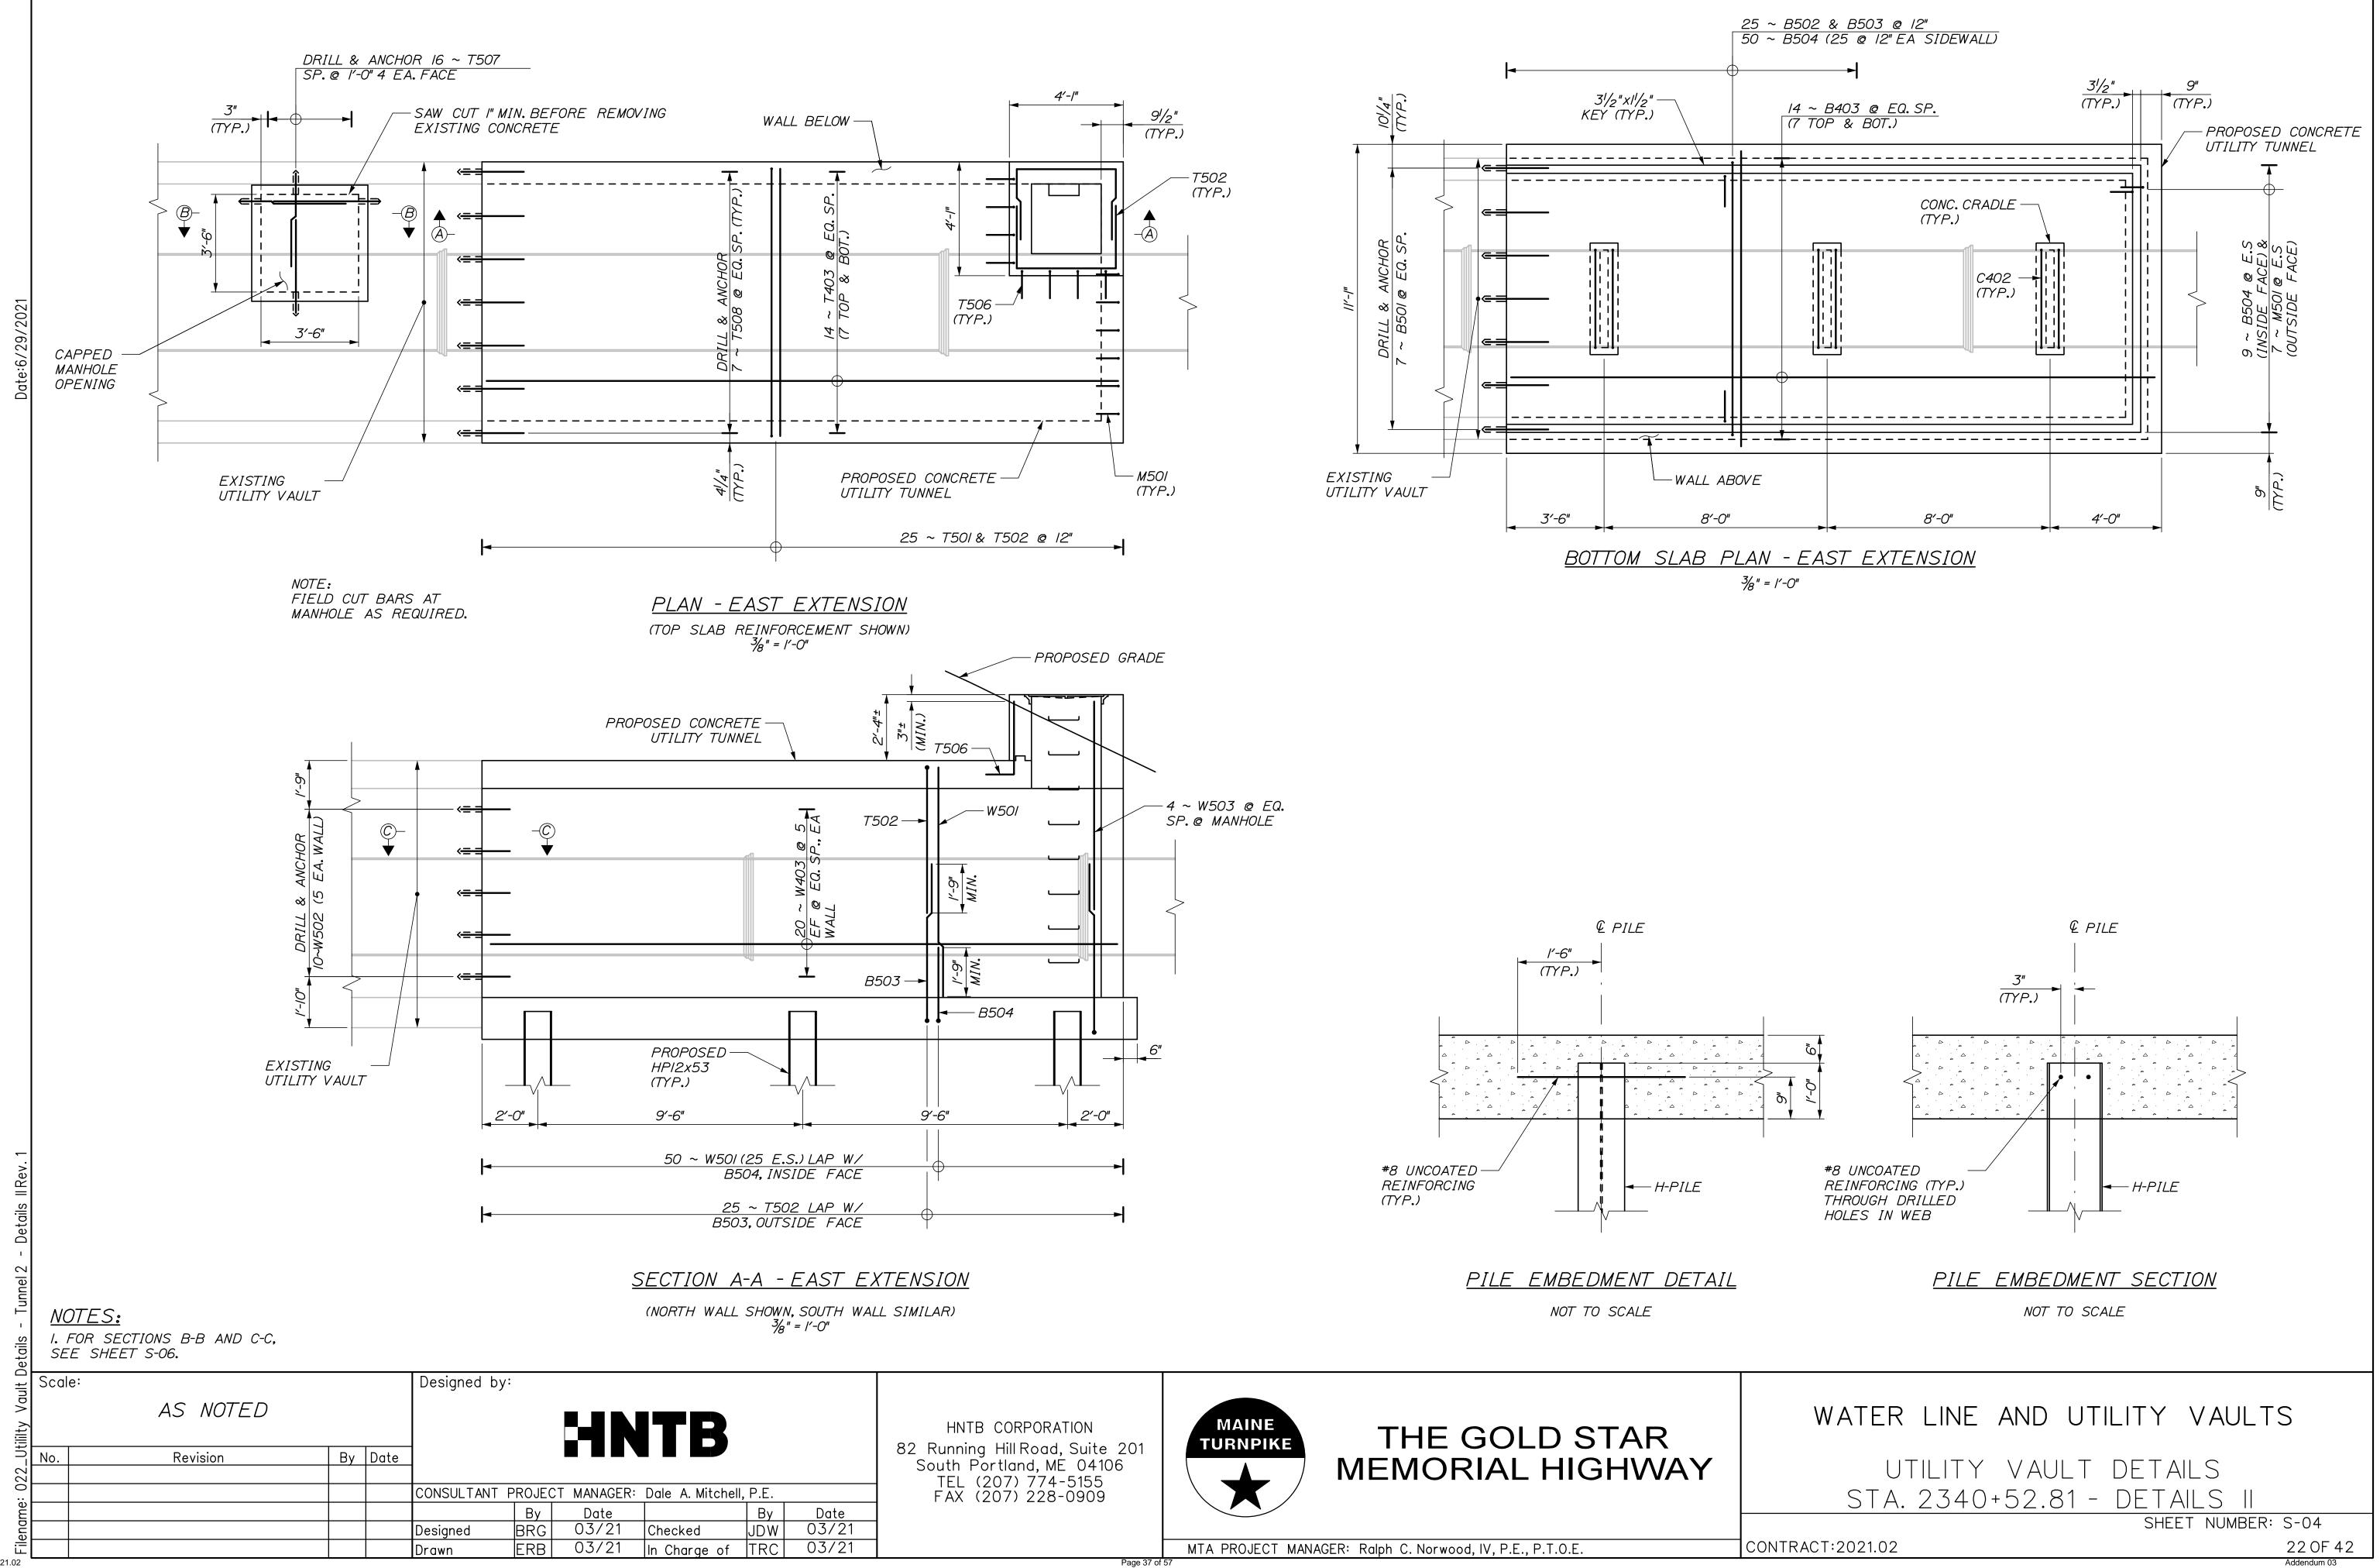

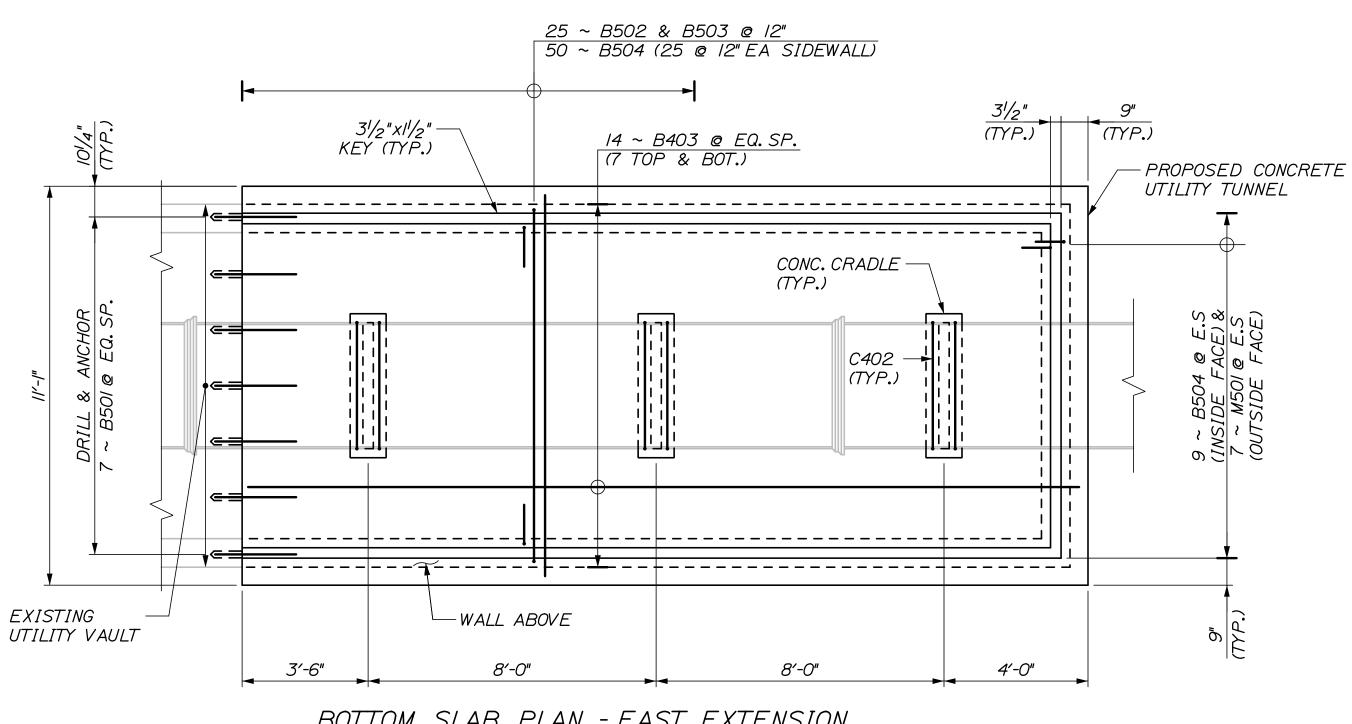


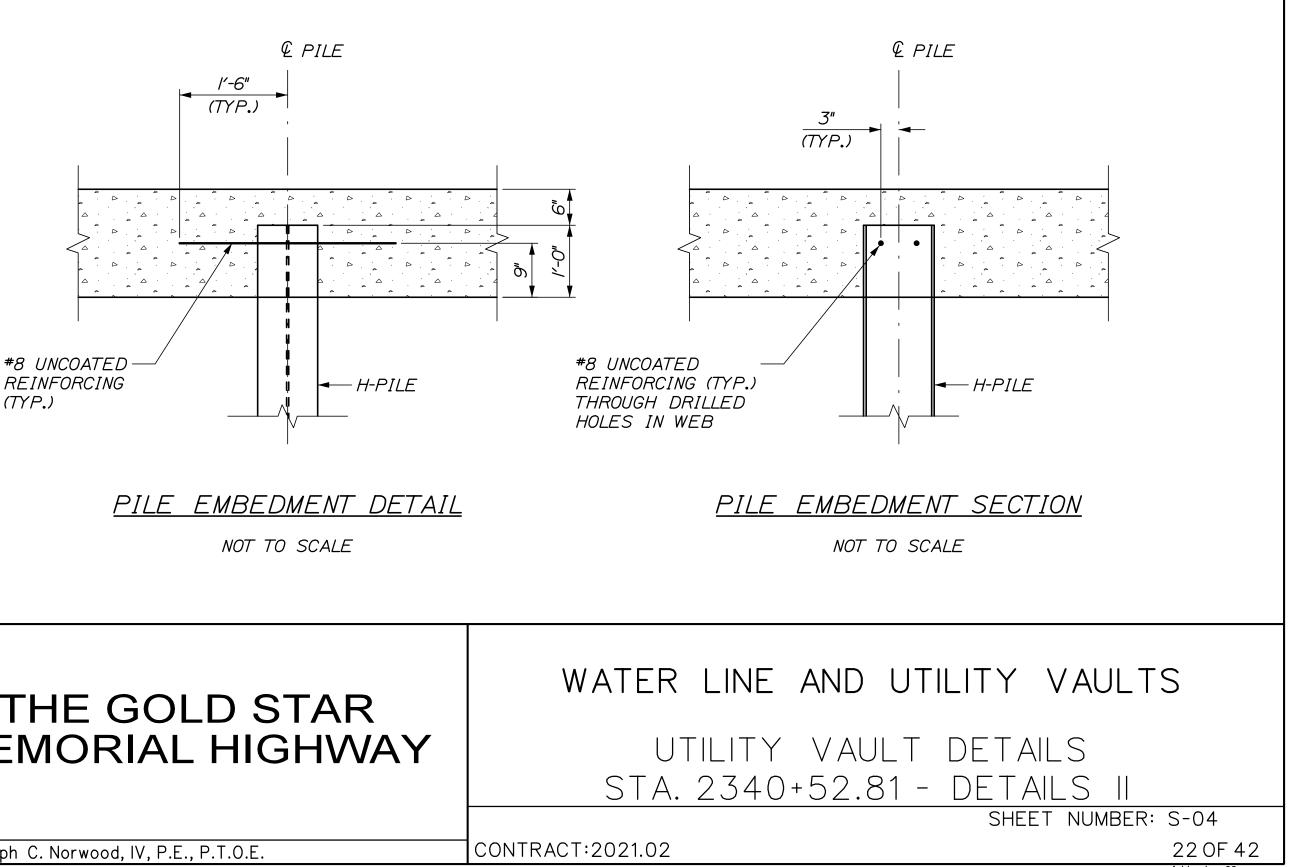

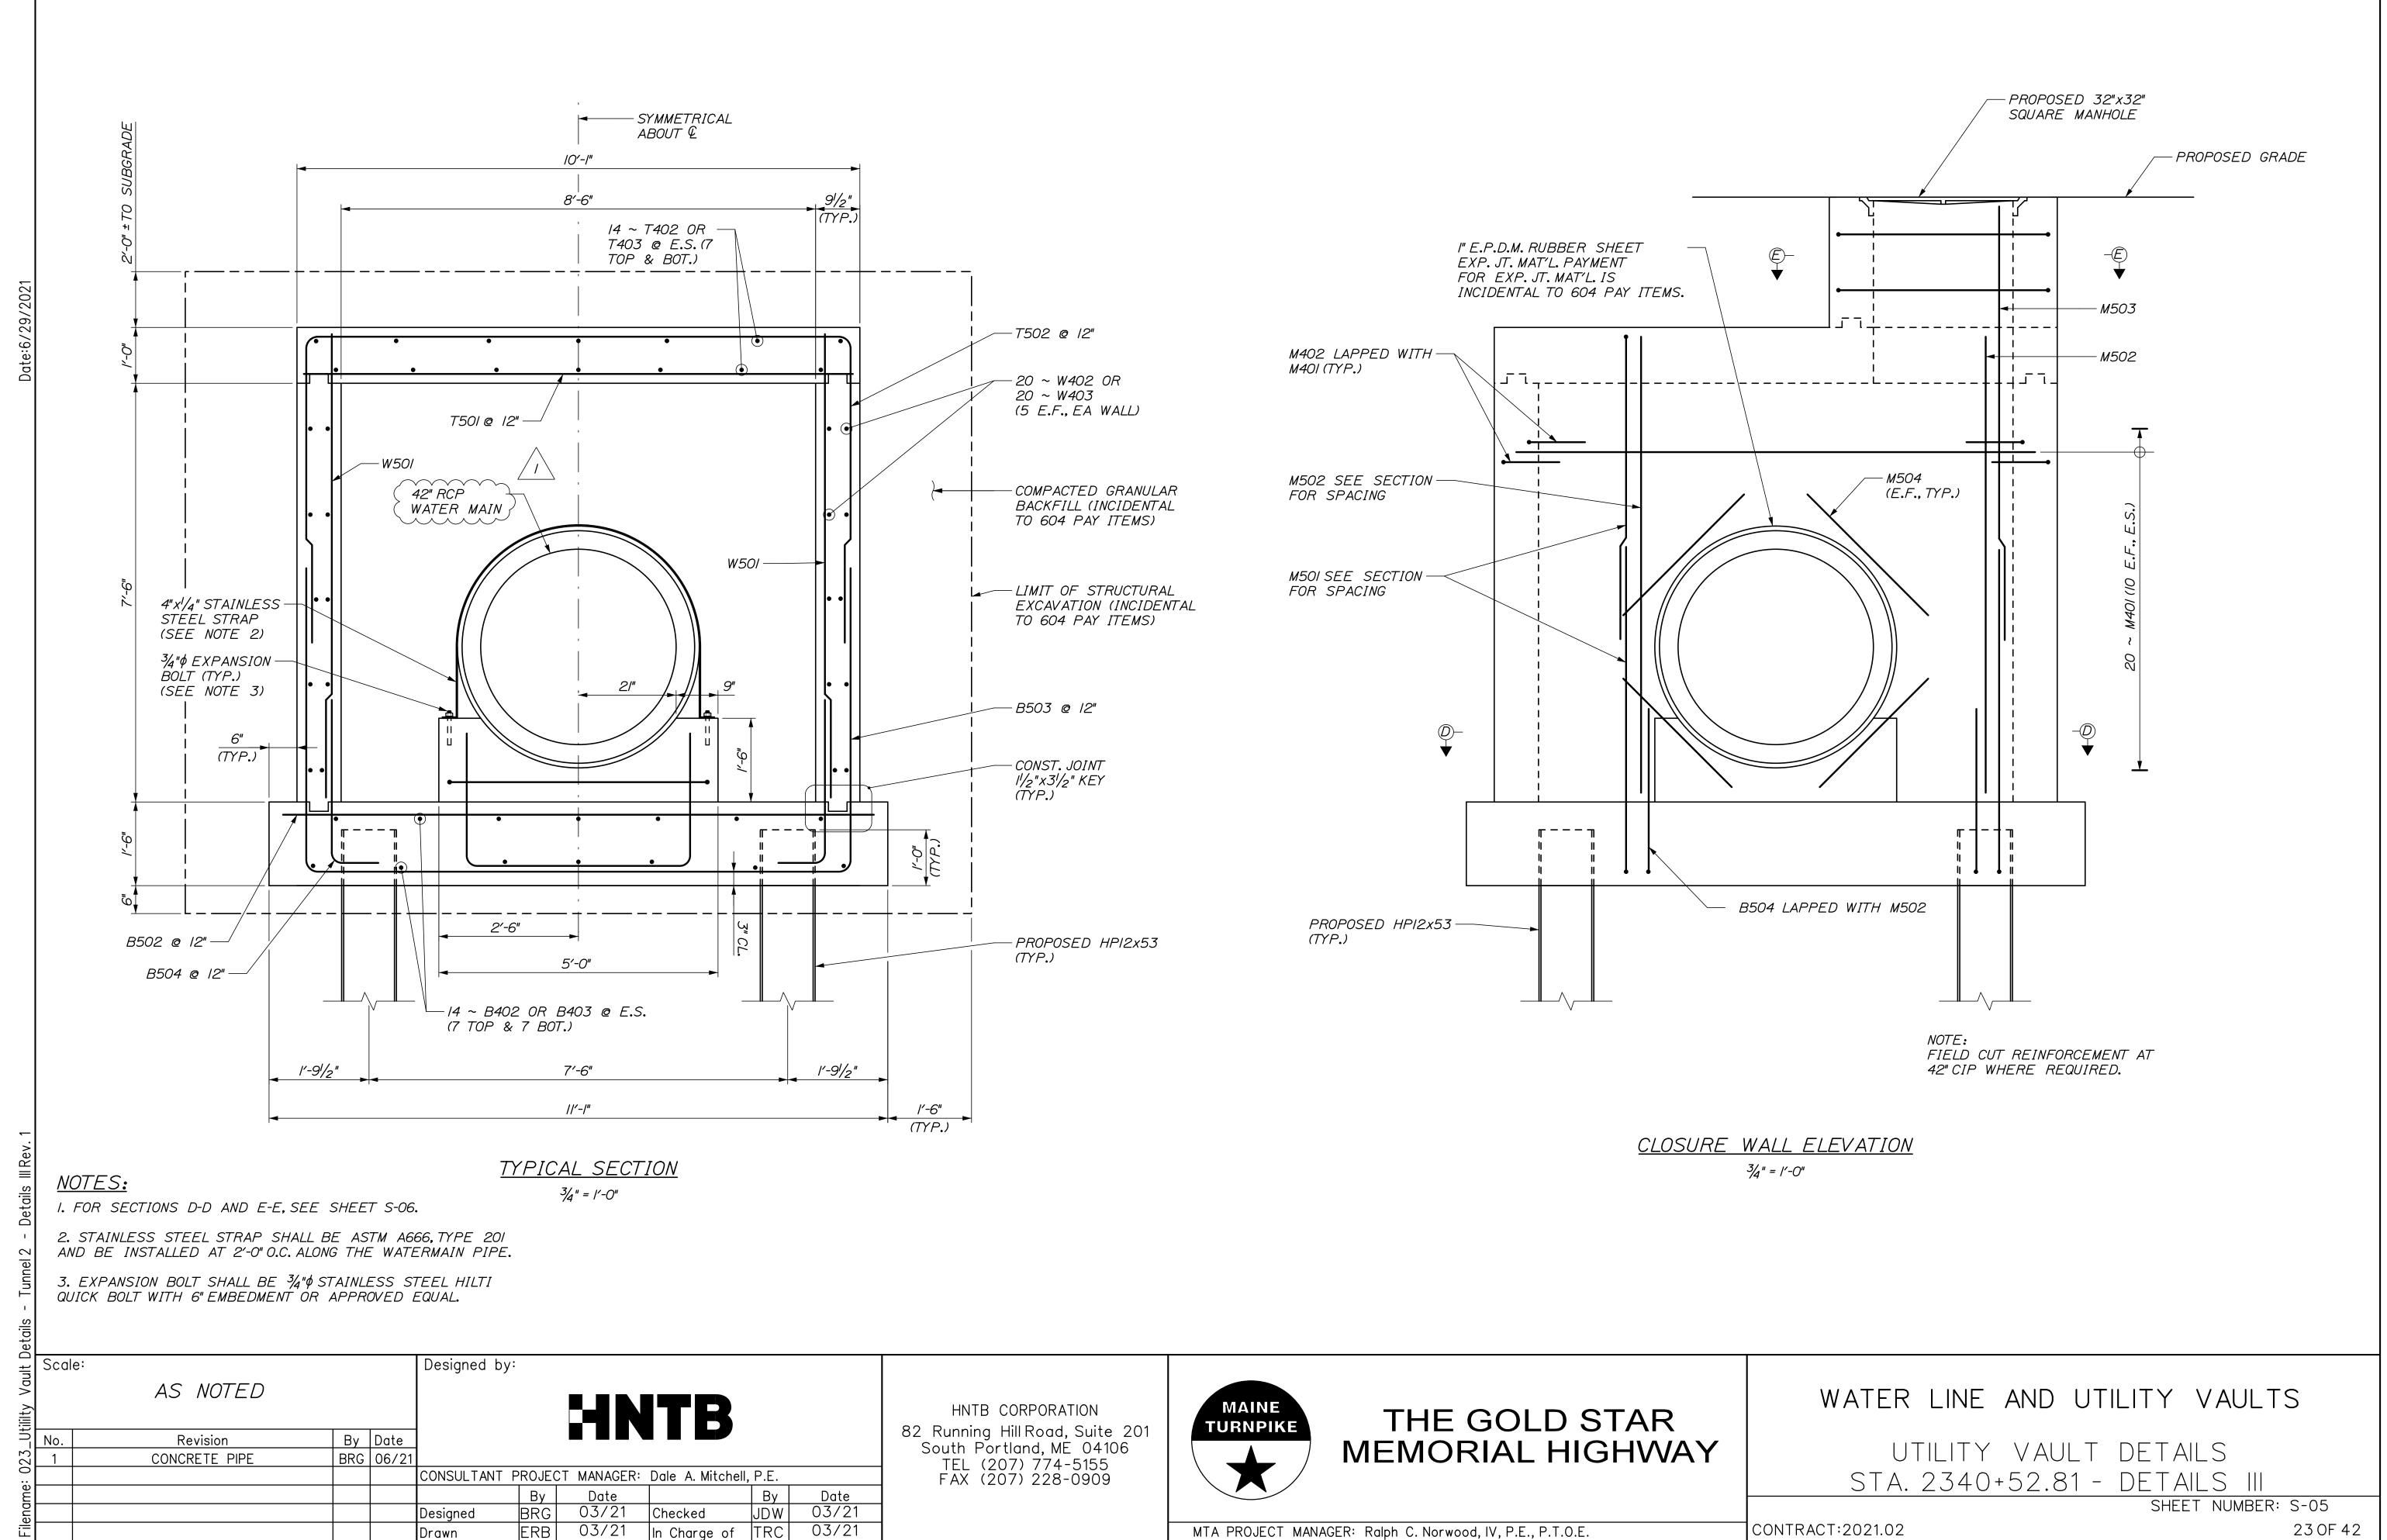


MTA PROJECT MANAGER: Ralph C. Norwood, IV, P.E., P.T.O.E. Page 38 of 5

Addendum 03

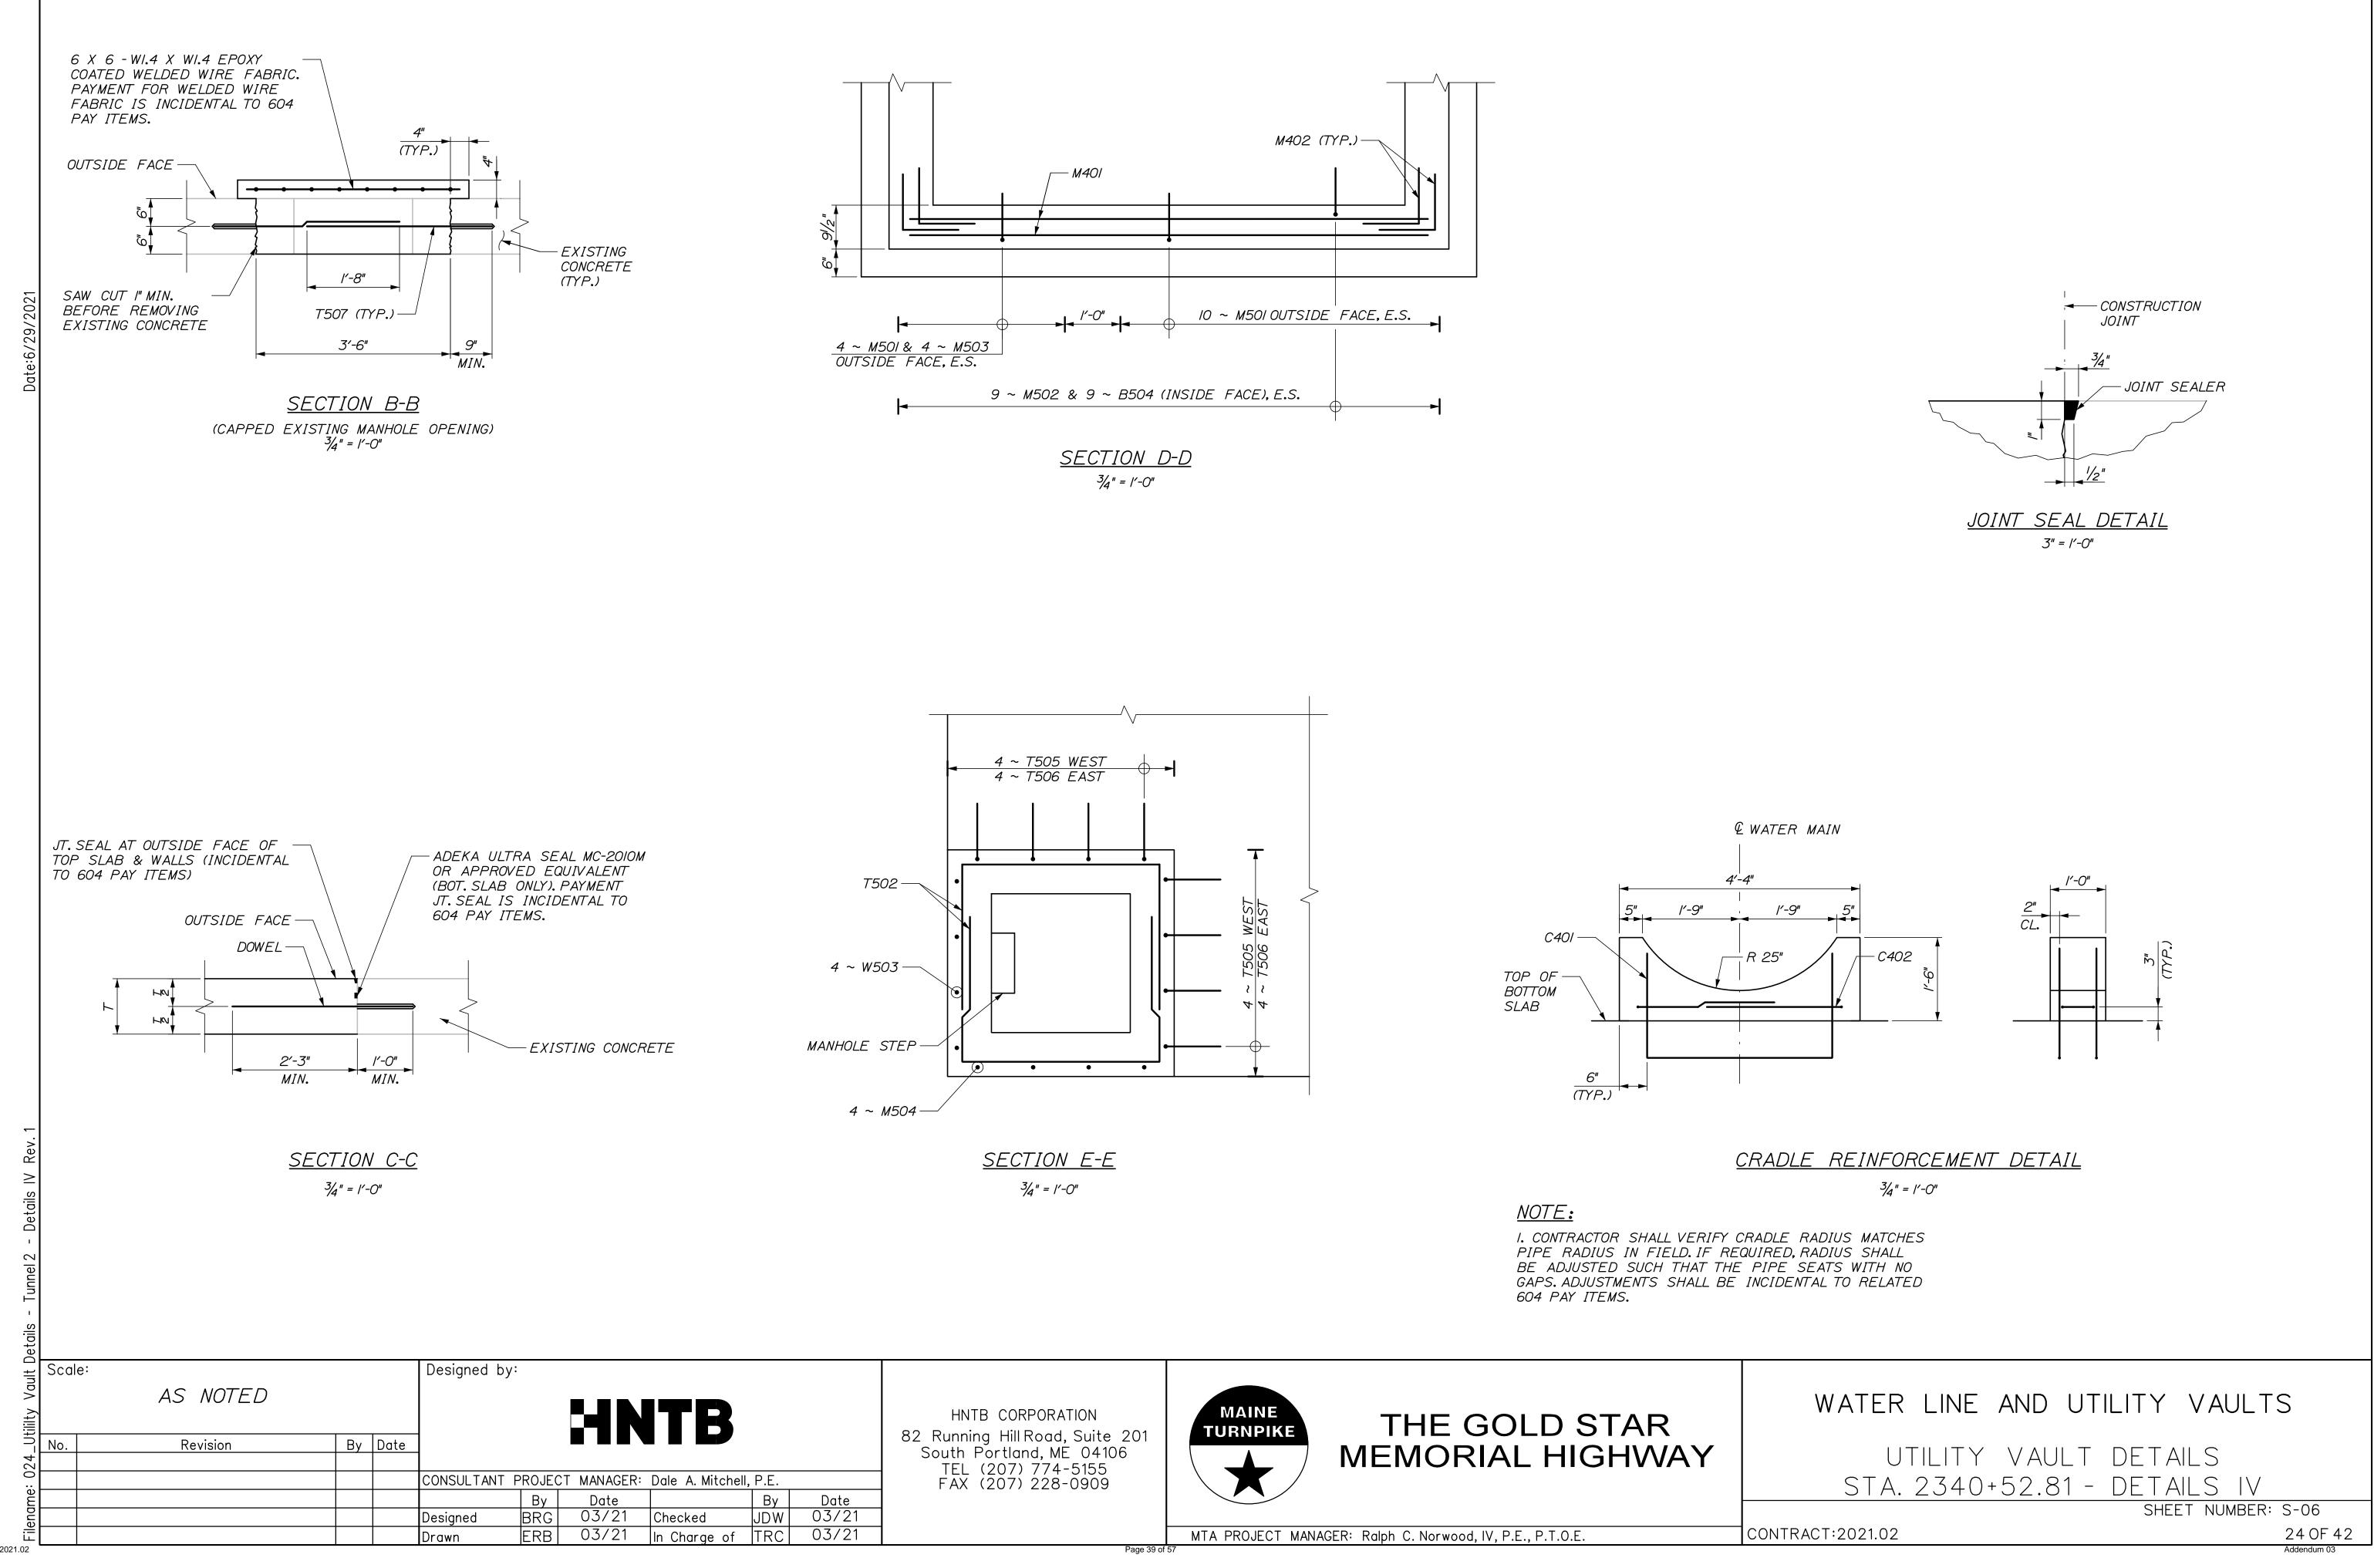

$$\frac{CTION}{3/4} = 1'-0''$$

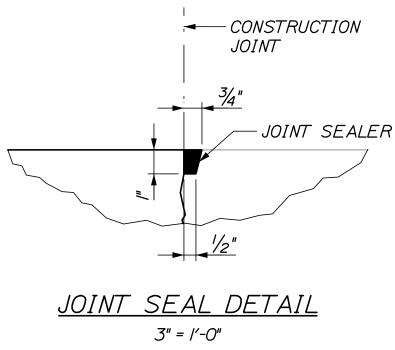

			WE						
MARK	SIZE	NO.	LE	NG	гн	TYPE	Α	В	REMARKS
STA. 2340+	52.81	Autor and Starte							
T402	4	14	16'	- 1	8"	STR			Top Slab: Longitudinal
T501	5	19	9'	-	9"	STR			Top Slab: Transverse Botto
T502	5	19	21'	-	11"	129	9'-9"	6'-1"	Top Slab: Transverse Top
T503	5	4	9'	-	8"	129	3'-4"	3'-2"	Top Slab: Horizontal Manho
T505	5	8	5'	-	4"	118	3'-4"	2'-0"	Top Slab: Vertical Manhole
T507	5	16	3'	-	4"	STR			Top Slab: Existing Manhole I
T508	5	7	3'	-	6"	STR			Top Slab: Dowel
W402	4	20	16'	-	8"	STR			Sidewalls: Longitudinal
W501	5	38	8'	-	2"	STR			Sidewalls: Vertical Int. Fac
W502	5	10	3'	-	6"	STR			Sidewalls: Dowels
W503	5	4	9'	-	0"	STR			Sidewalls: Vertical @ Manho
B402	4	14	17'	-	2"	STR			Bottom Slab: Longitudinal
B501	5	7	3'	-	6"	STR			Bottom Slab: Dowels
B502	5	19	10'	-	9"	STR			Bottom Slab: Transverse T
B503	5	19	22'	-	9"	129	9'-9"	6'-6"	Bottom Slab: Transverse Bot
B504	5	47	6'	-	10''	118	6'-0"	10"	Bottom Slab: Vertical Hool
M401	4	20	9'	-	9"	STR			Closure Wall: Horizontal
M402	4	40	4'	-	0"	118	2'-0"	2'-0"	Closure Wall: Horizontal Hoo
M501	5	14	6'	-	11"	118	6'-1"	10"	Closure Wall: Vertical Ext. Fa
M502	5	9	8'	-	2"	STR			Closure Wall: Vertical Int. Fa
M503	5	4	9'	-	0"	STR			Closure Wall: Vertical Manhole Out
M504	5	8	5'	-	0"	STR			Closure Wall: Utility Diagon
C401	4	6	8'	-	8"	129	3'-6"	2'-7"	Cradle: Vertical
C402	4	6	6'		8"	129	8"	3'-0"	Cradle: Horizontal

MARK	SIZE	NO.	LE	NG	тн	ТҮРЕ	Α	В	REMARKS
STA 2340+	52.81								
T403	4	14	22'	-	8"	STR			Top Slab: Longitu
T501	5	25	9'	-	9"	STR			Top Slab: Transvers
T502	5	25	21'	-	11"	129	9'-9"	6'-1"	Top Slab: Transver
T503	5	6	9'	-	8"	129	3'-4"	3'-2"	Top Slab: Horizontal
T506	5	8	5'	-	9"	118	3'-4"	2'-5"	Top Slab: Vertical N
T507	5	16	3'	-	4"	STR			Top Slab: Existing Ma
T508	5	7	3'	-	6"	STR			Top Slab: Dov
W403	4	20	22'	-	8"	STR			Sidewalls: Longit
W501	5	50	8'	-	2"	STR			Sidewalls: Vertical I
W502	5	10	3'	-	6"	STR			Sidewalls: Dow
W503	5	4	9'	-	0"	STR			Sidewalls: Vertical @
B403	4	14	23'	-	2"	STR			Bottom Slab: Long
B501	5	7	3'	-	6"	STR			Bottom Slab: Do
B502	5	25	10'	-	9"	STR			Bottom Slab: Transv
B503	5	25	22'	-	9"	129	9'-9"	6'-6"	Bottom Slab: Transver
B504	5	59	6'	-	10"	118	6'-0"	10"	Bottom Slab: Vertic
M401	4	20	9'	-	9"	STR			Closure Wall: Hor
M402	4	40	4'	-	0"	118	2'-0"	2'-0"	Closure Wall: Horizor
M501	5	14	6'	-	11"	118	6'-1"	10"	Closure Wall: Vertical
M502	5	9	8'	-	2"	STR			Closure Wall: Vertica
M503	5	4	9'	-	0''	STR			Closure Wall: Vertical Manho
M504	5	8	5'	-	0''	STR			Closure Wall: Utility
C401	4	6	8'	-	8''	129	3'-6"	2'-7"	Cradle: Vertic
C402	4	6	6'	-	8"	129	8"	3'-0"	Cradle: Horizor

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Т	
Tunnel 2	
I	
)etails	

ult D		e:			Designed by:					
Utililty Vault		NO SCALE					HN	TR		
1	110.	Revision	By	Date						
: 025					CONSULTANT F	PROJEC	T MANAGER:	Dale A. Mitchell,	P.E.	
me						By	Date		By	D
Filename:					Designed	BRG	03/21	Checked	JDW	03
File					Drawn	ERB	03/21	In Charge of	TRC	03
21.02										

ottom Fop hole ole e Infill

\_\_\_\_\_ ace hole

al Top Bottom Dok

looks Face Face outside Face onal

itudinal rse Bottom erse Top al Manhole Manhole Manhole Infill wel

gitudinal l Int. Face wels Manhole


ngitudinal owels sverse Top erse Bottom ical Hook

orizontal ontal Hooks al Ext. Face cal Int. Face hole Outside Face y Diagonal

tical contal

A	
<u> </u>	B

<u>type 118</u>

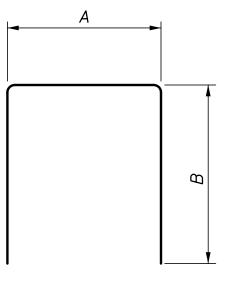

<u>TYPE 129</u>



HNTB CORPORATION 82 Running Hill Road, Suite 201 South Portland, ME 04106 TEL (207) 774-5155 FAX (207) 228-0909



THE GOLD STAR MEMORIAL HIGHWAY

CONTRACT:2021.02


WATER LINE AND UTILITY VAULTS

UTILITY VAULT DETAILS

STA. 2340+52.81 - REINFORCING SCHEDULE

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SHEET NUMBER: S-07

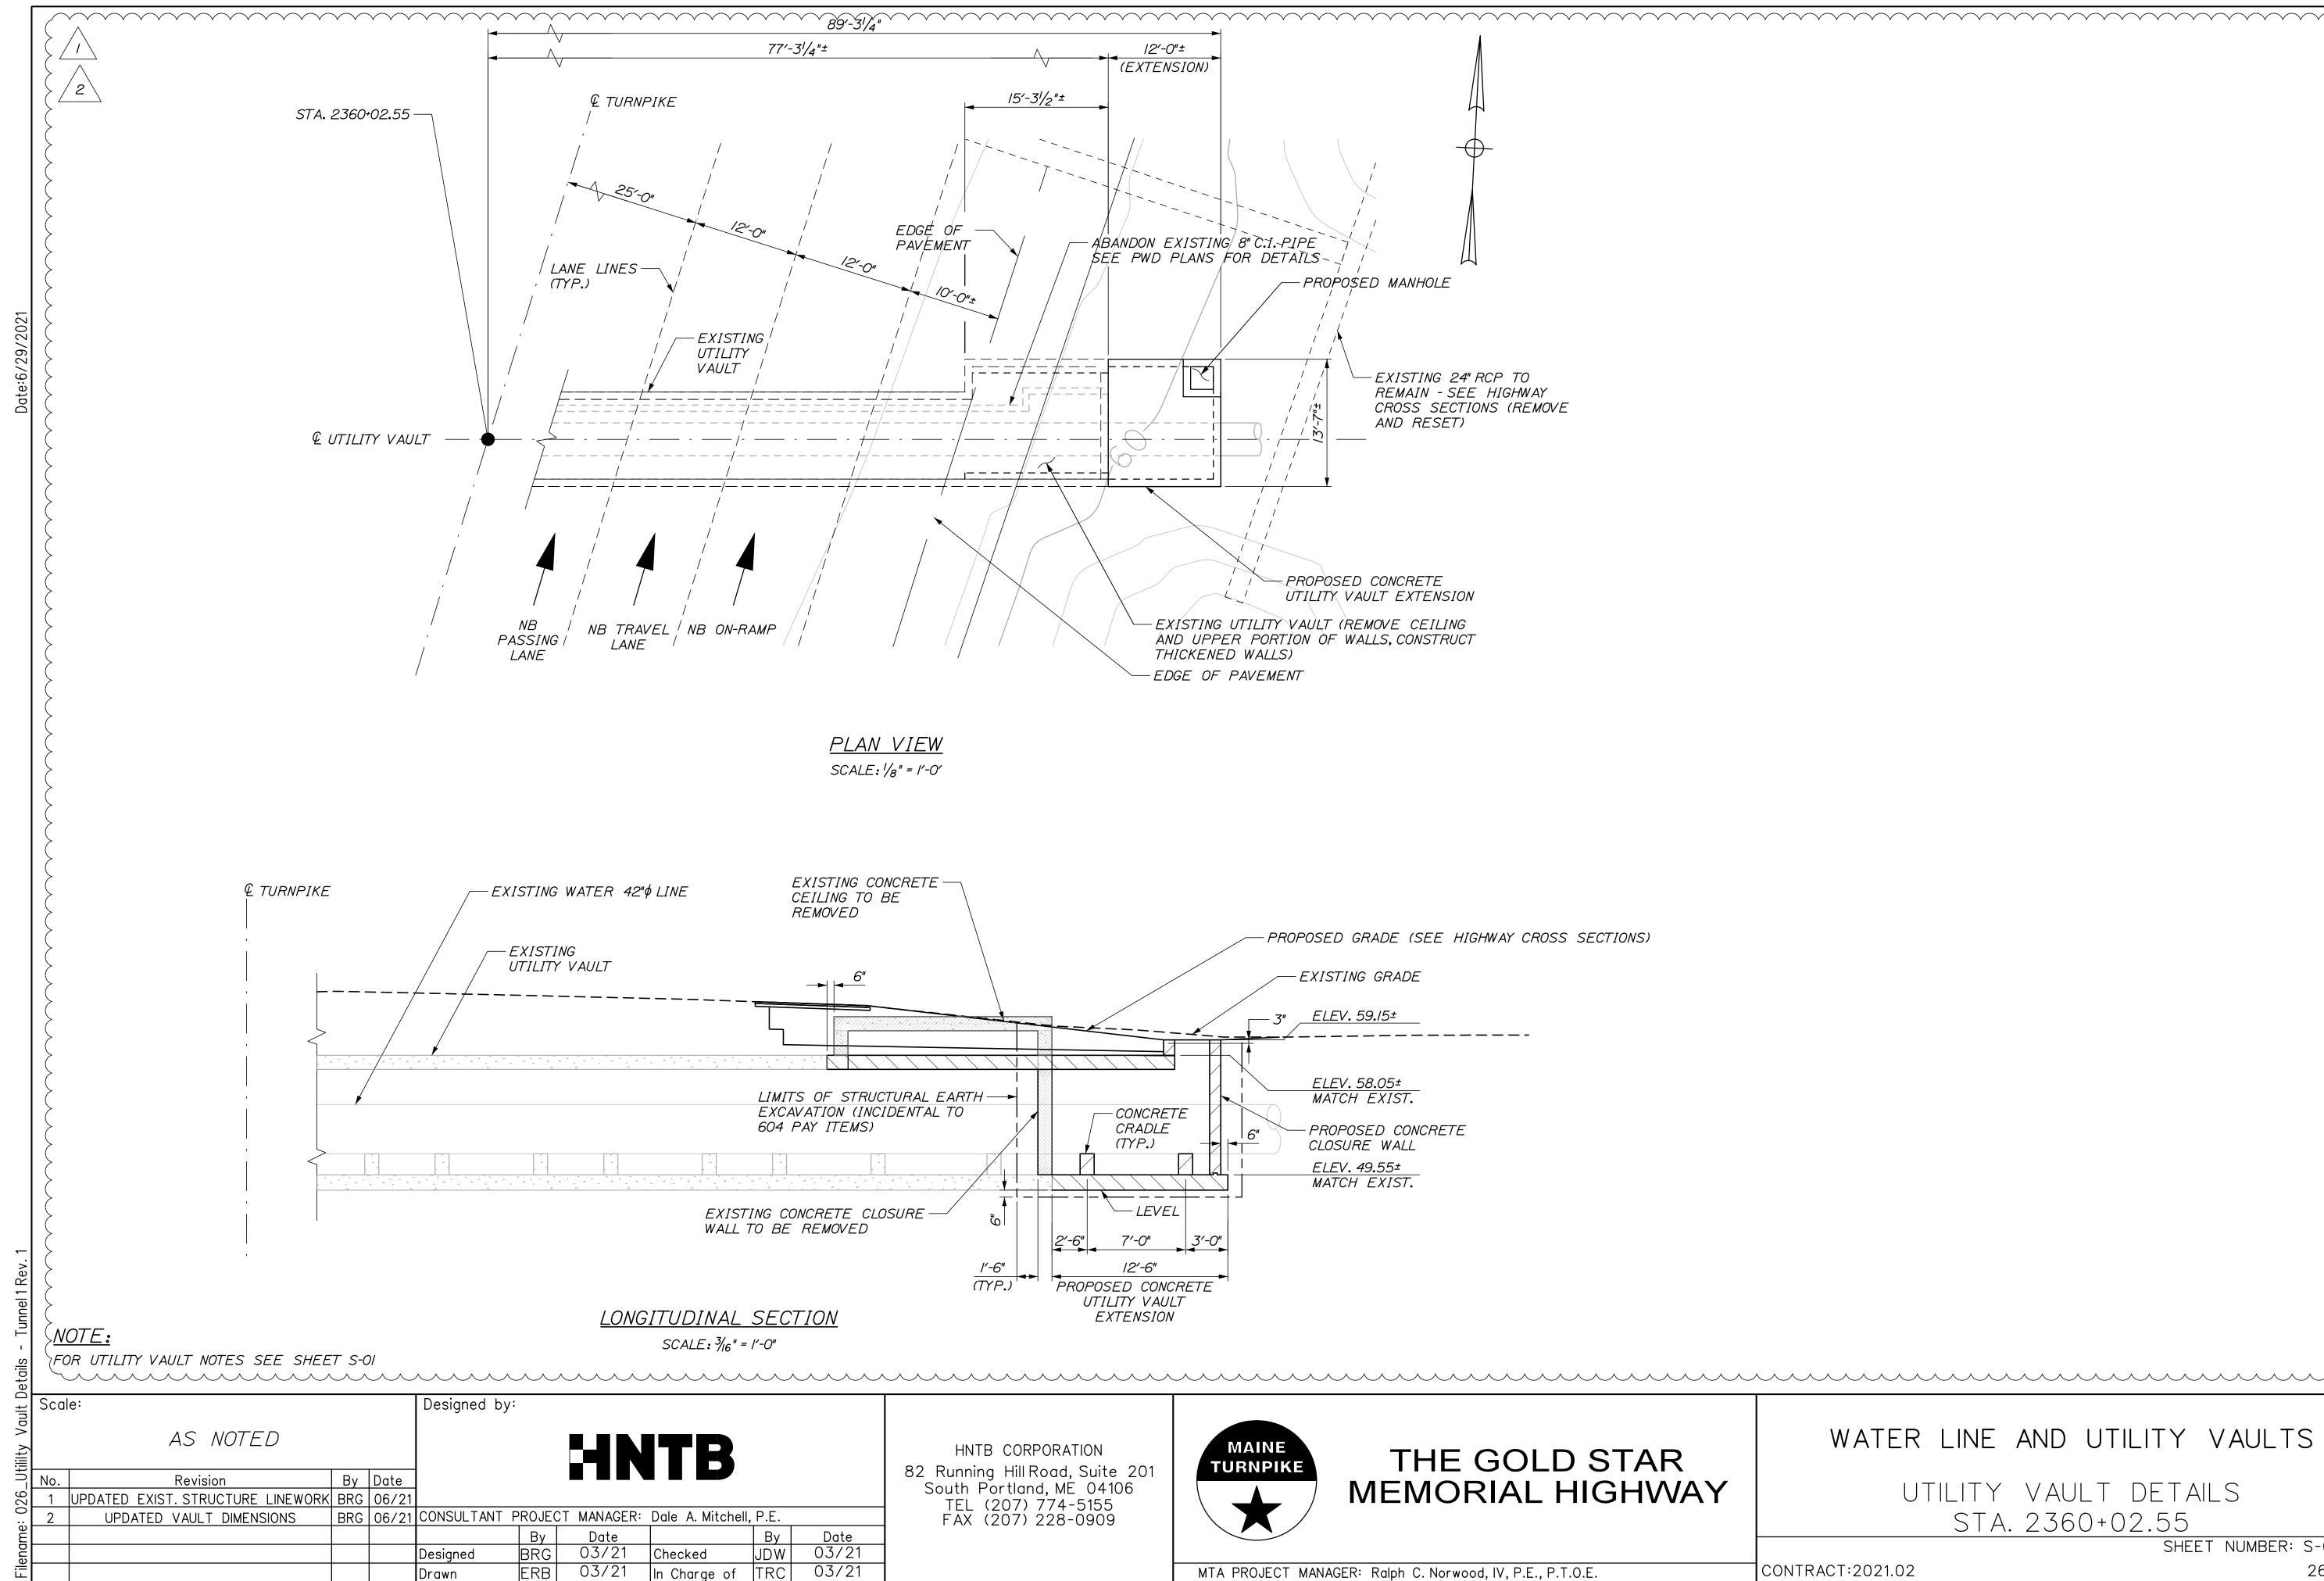

MTA PROJECT MANAGER: Ralph C. Norwood, IV, P.E., P.T.O.E.

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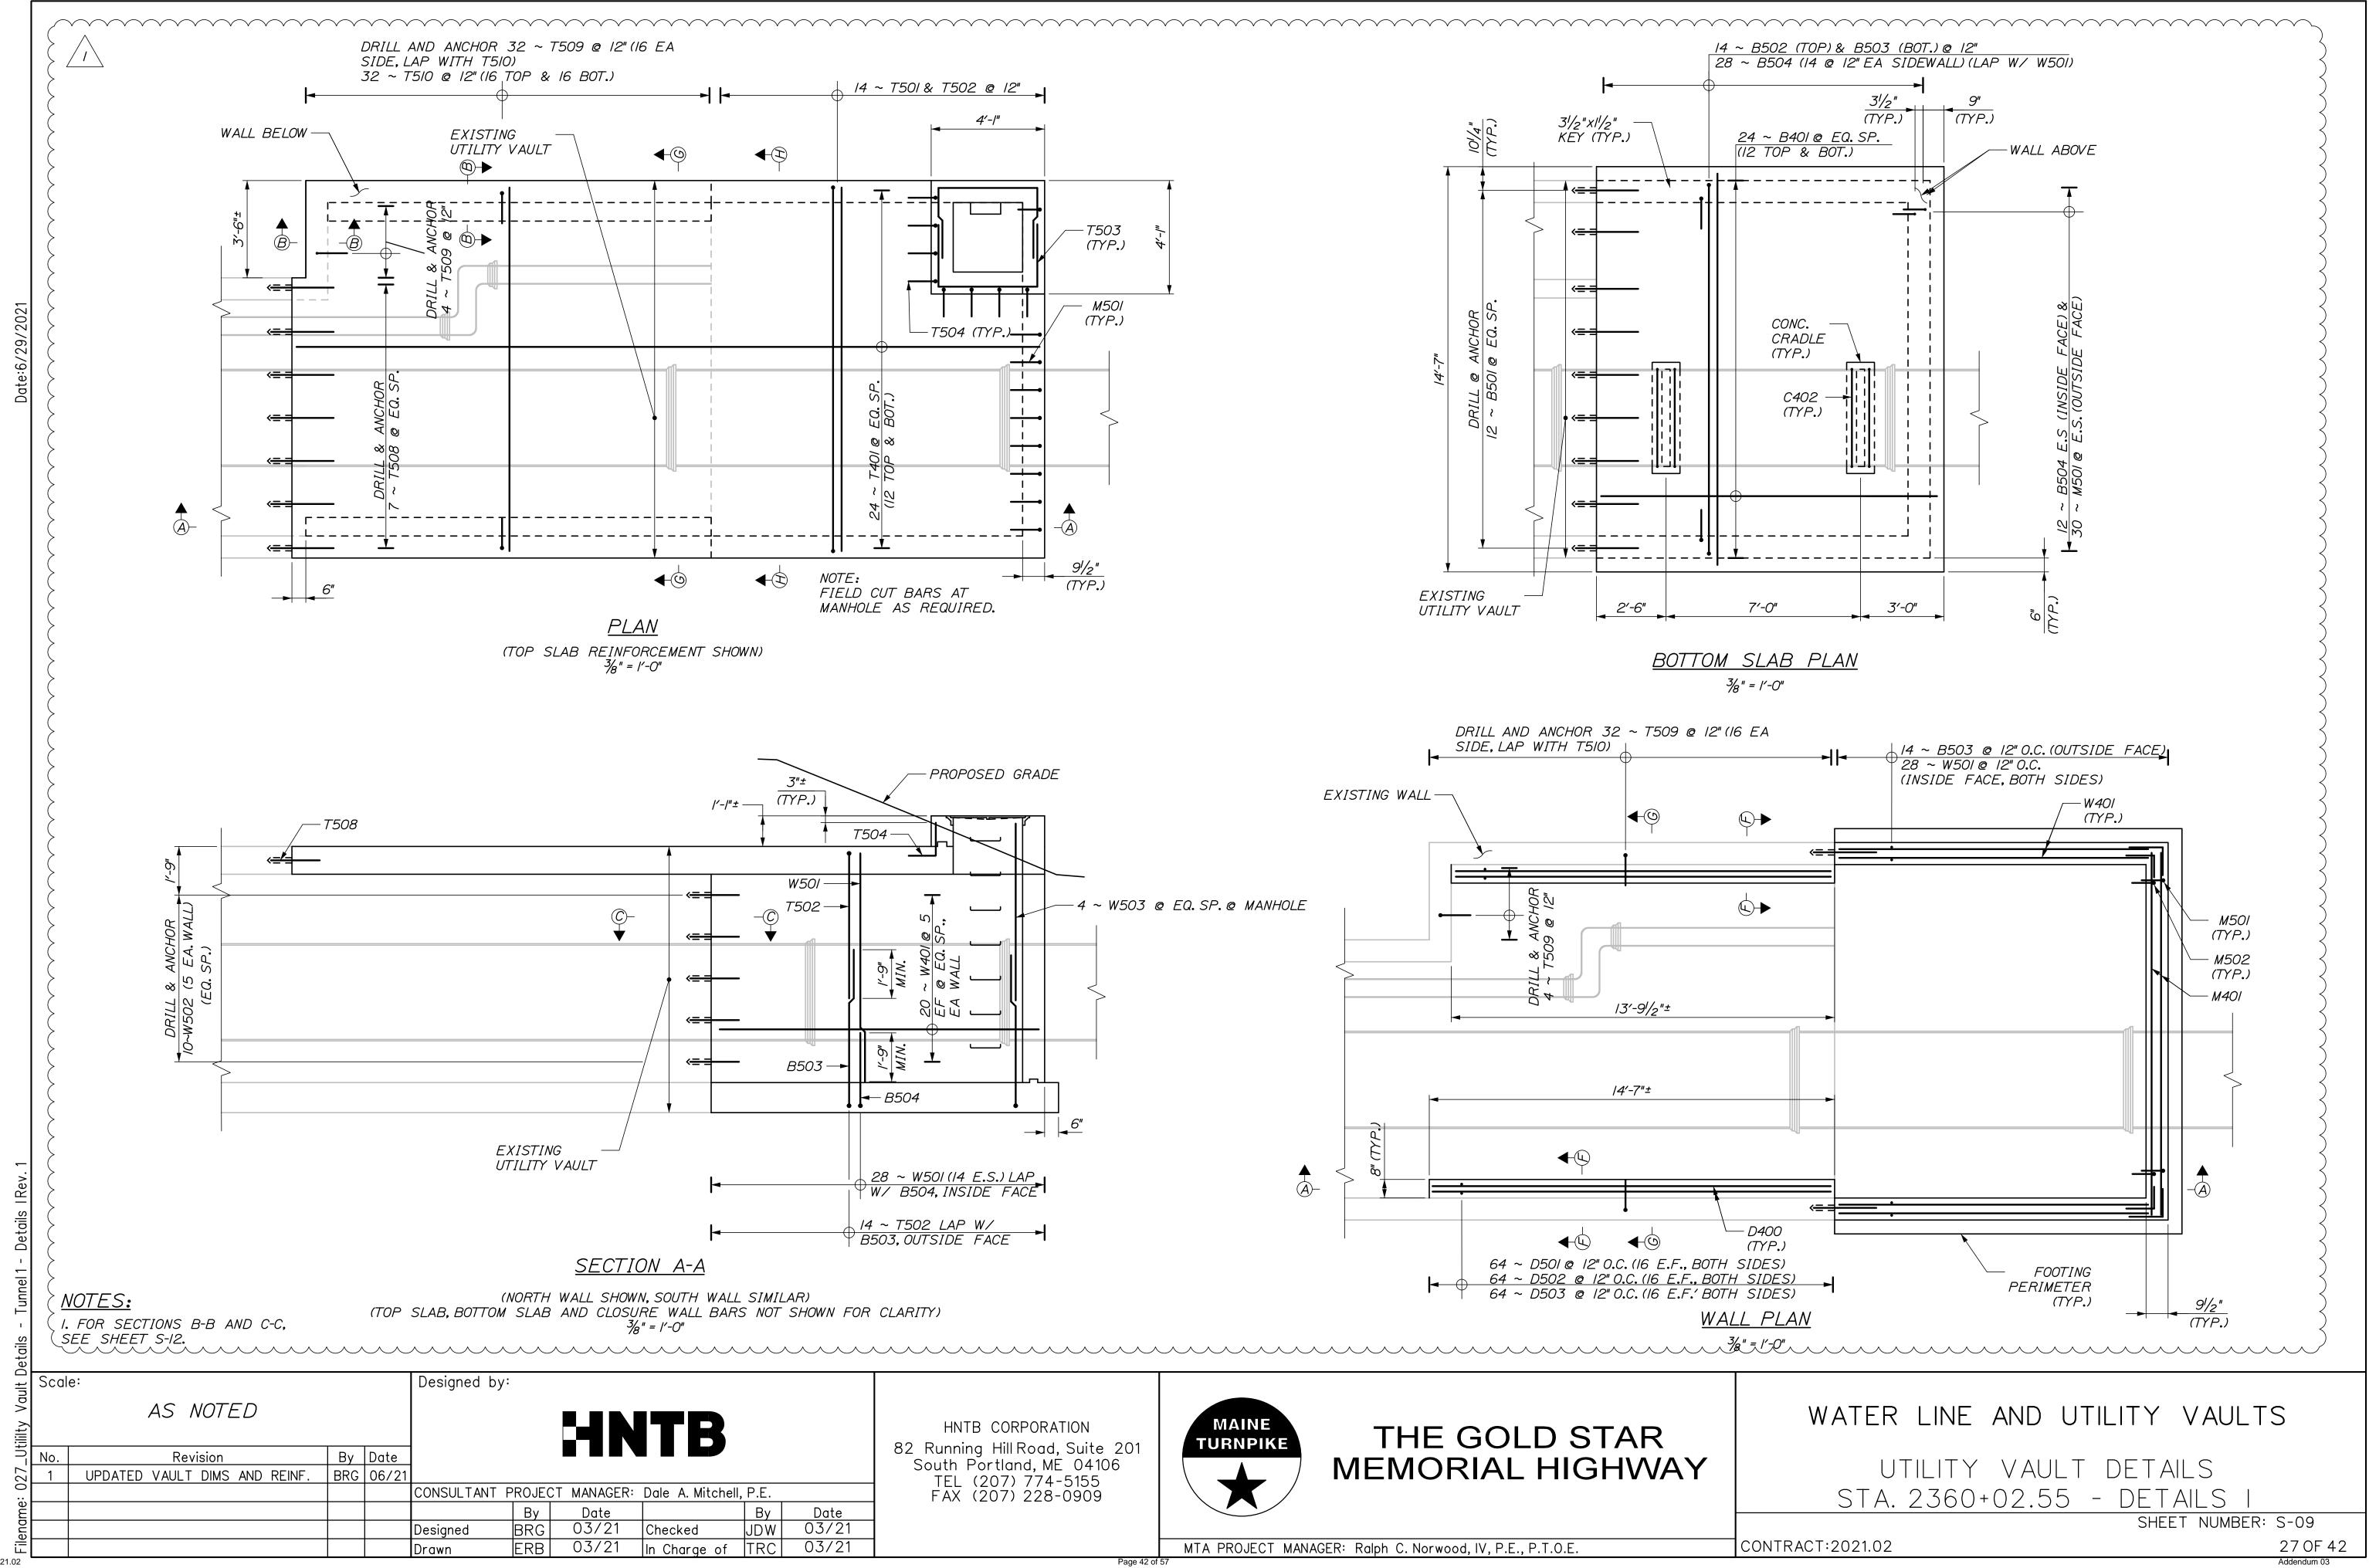
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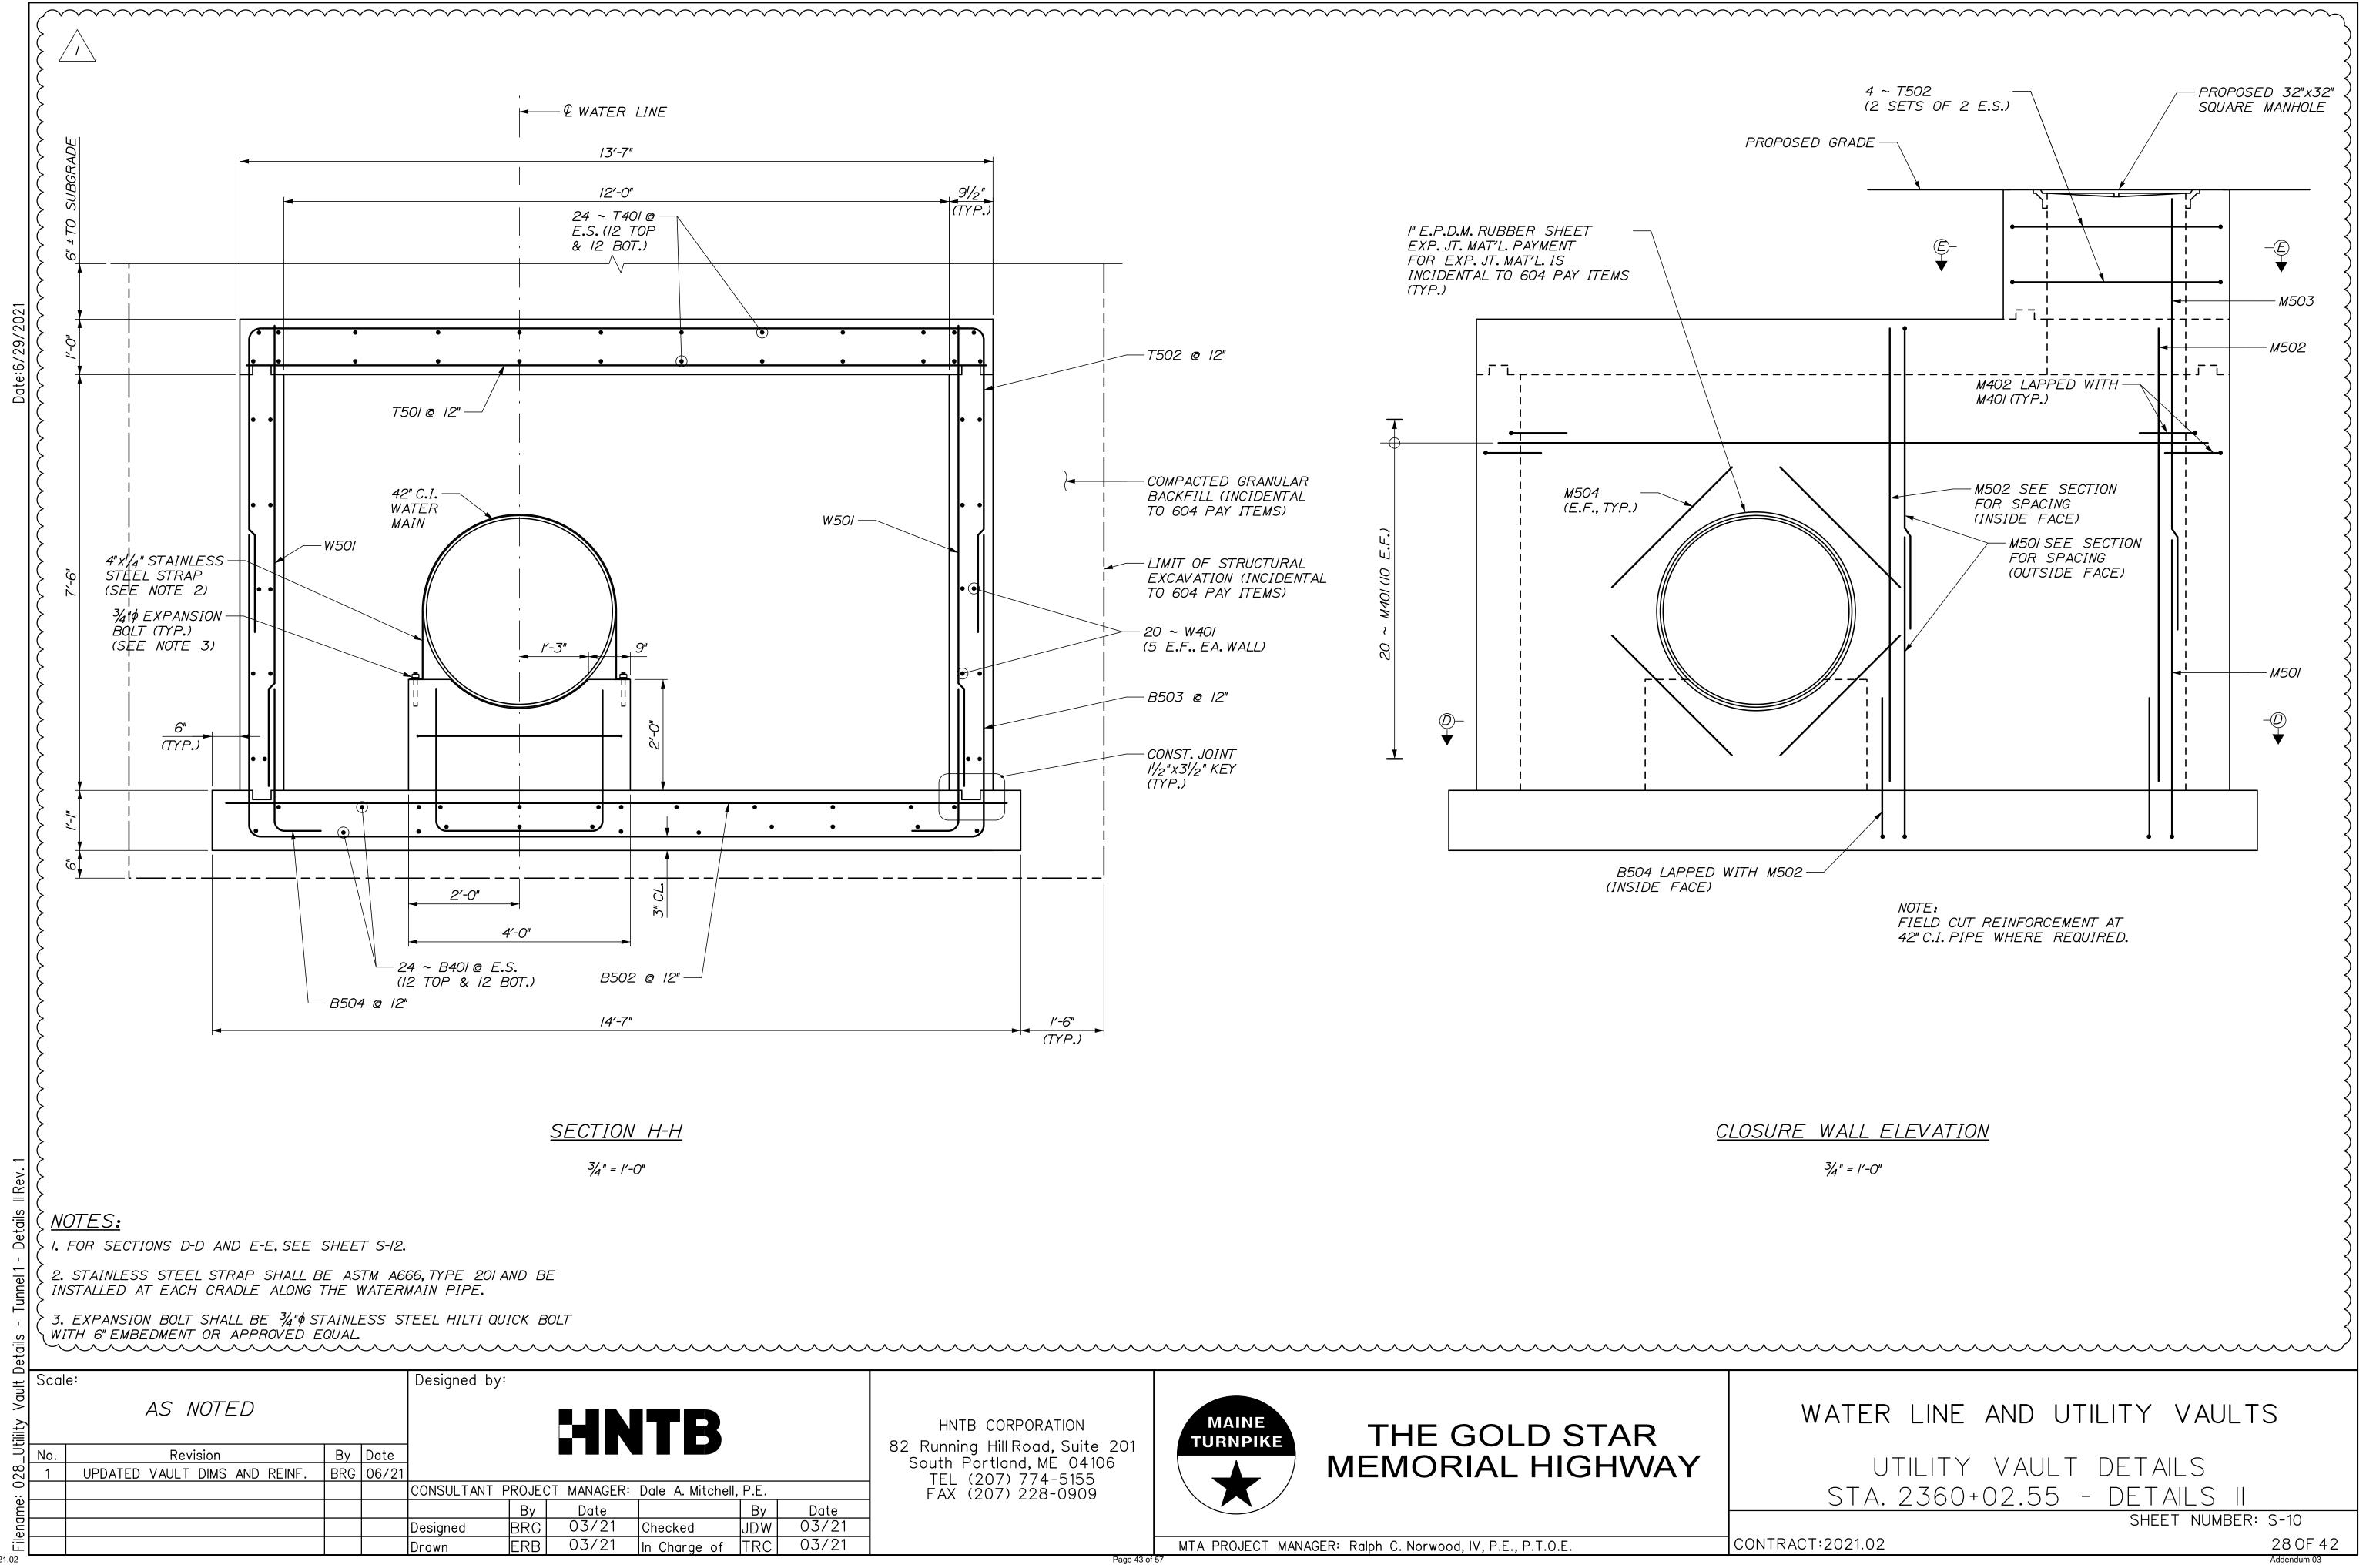
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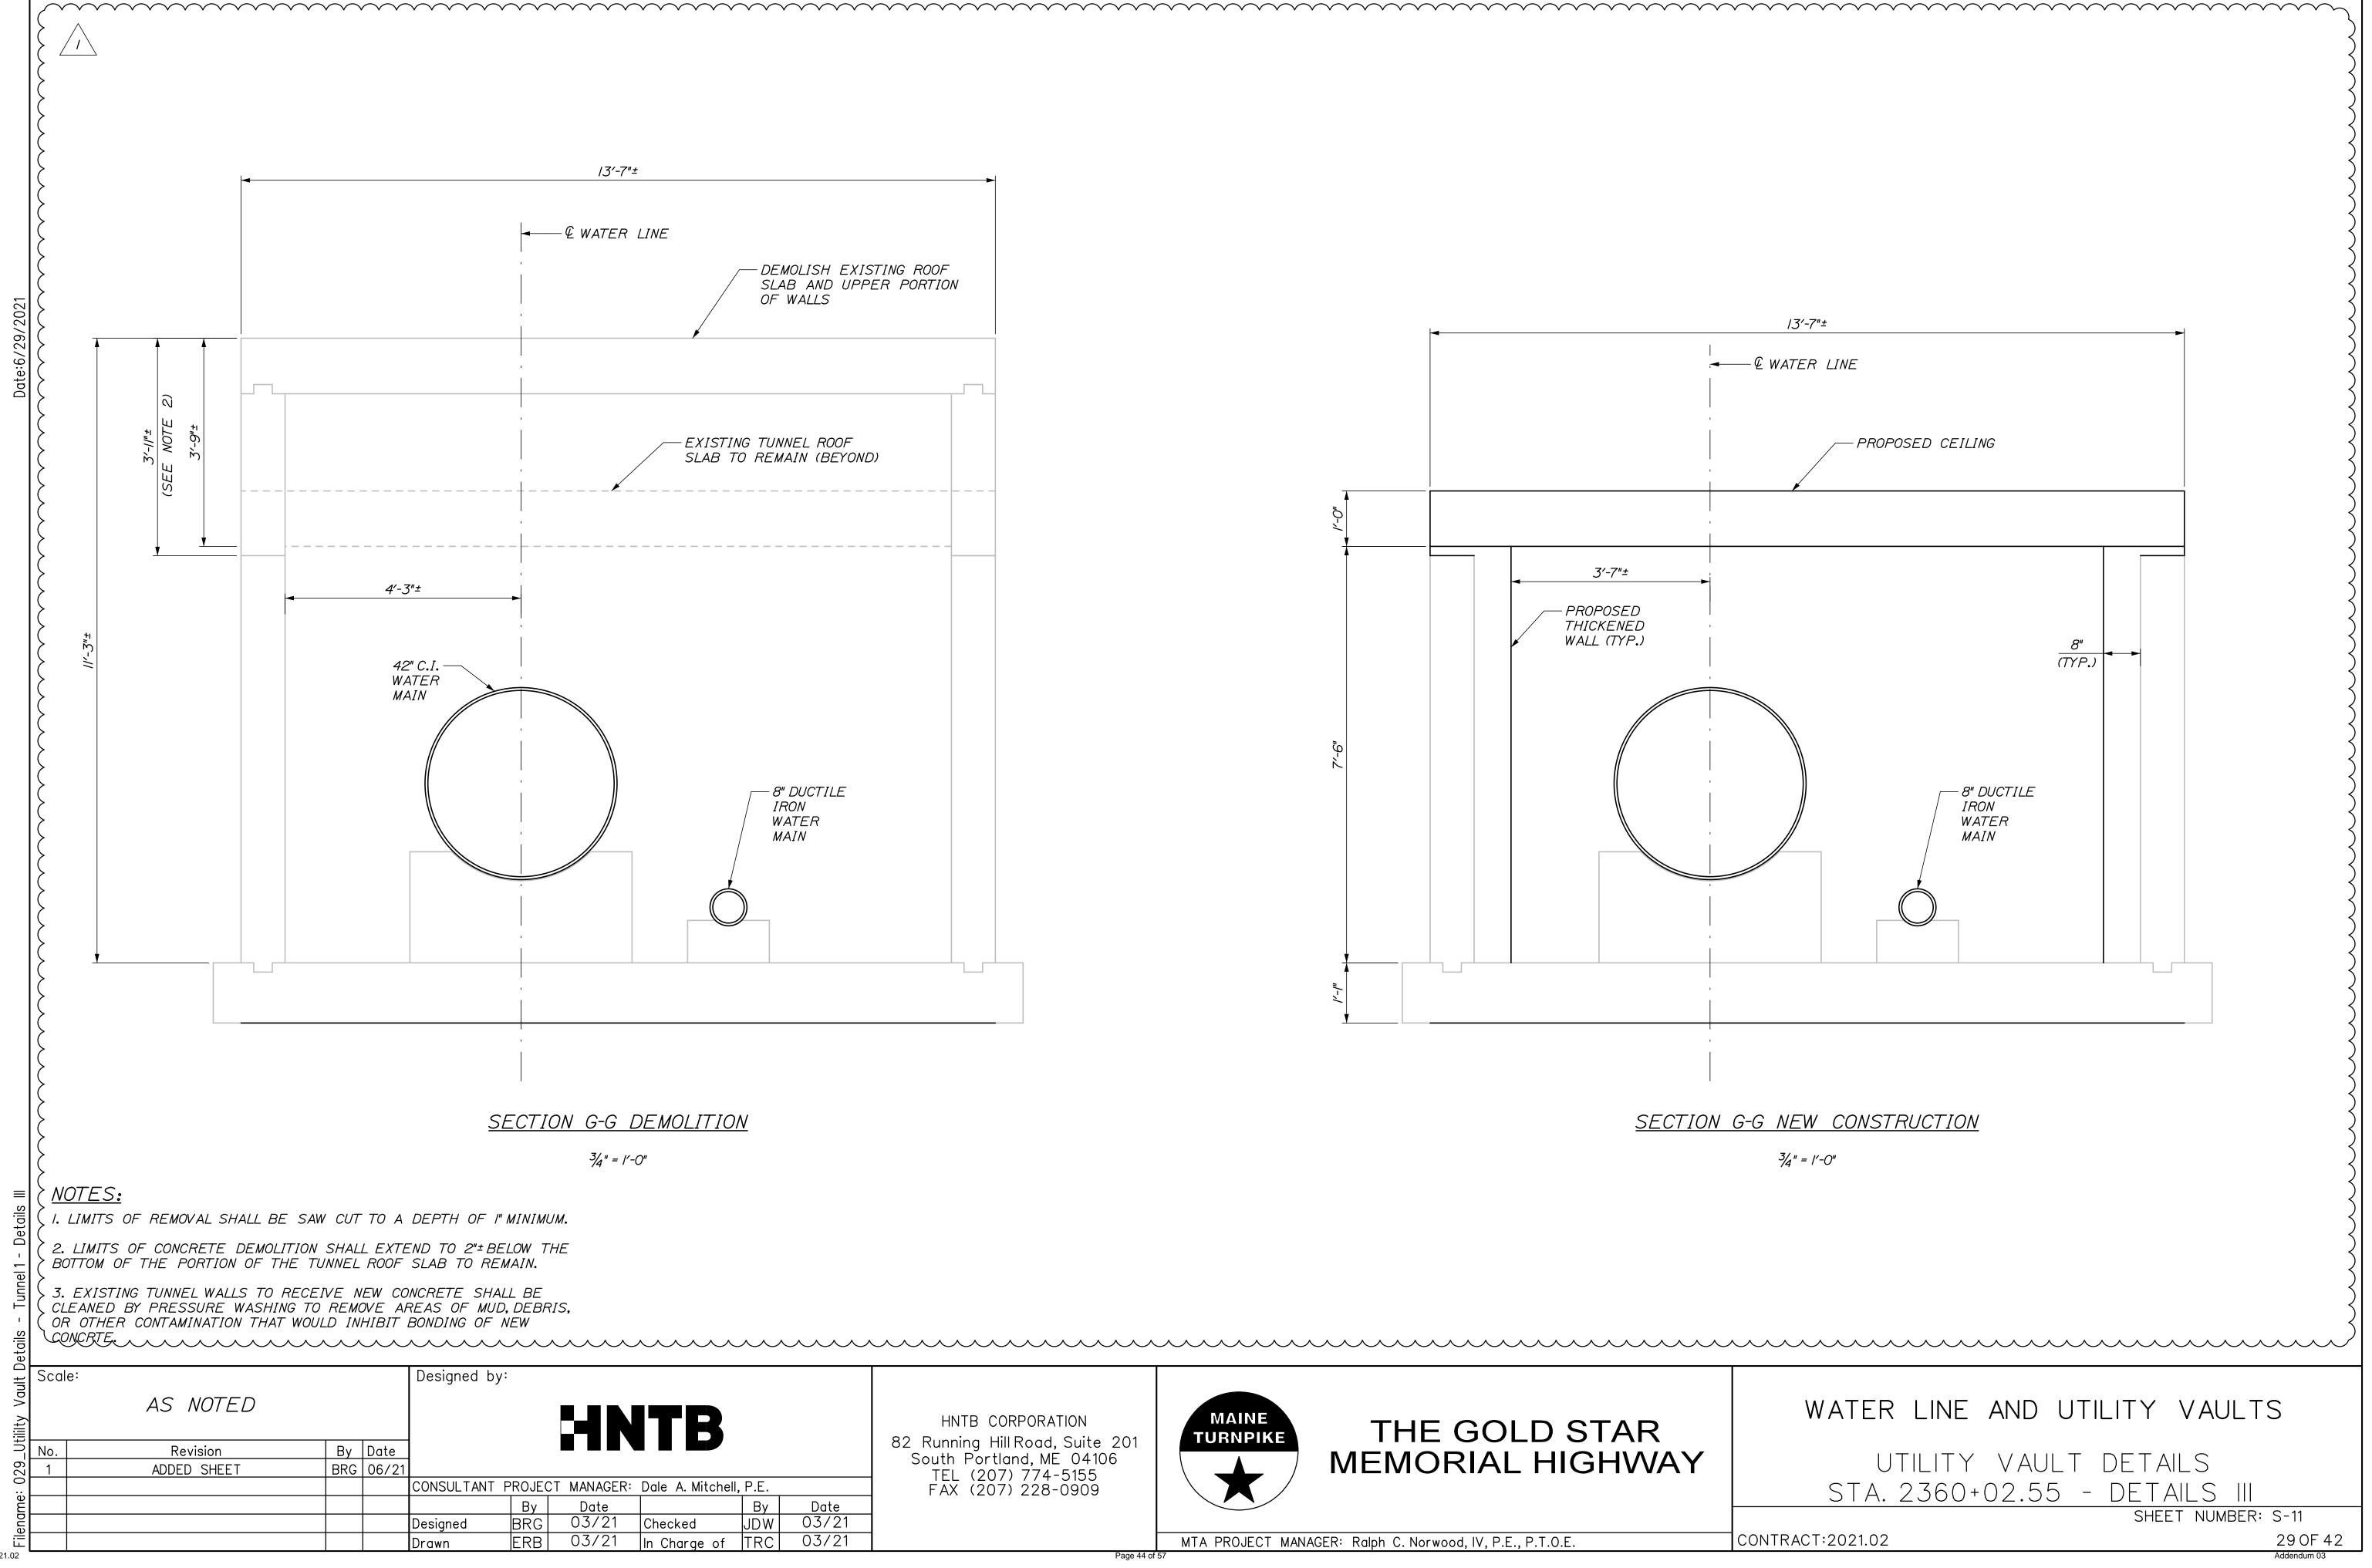
STA. 2360+02.55


UTILITY VAULT DETAILS


WATER LINE AND UTILITY VAULTS







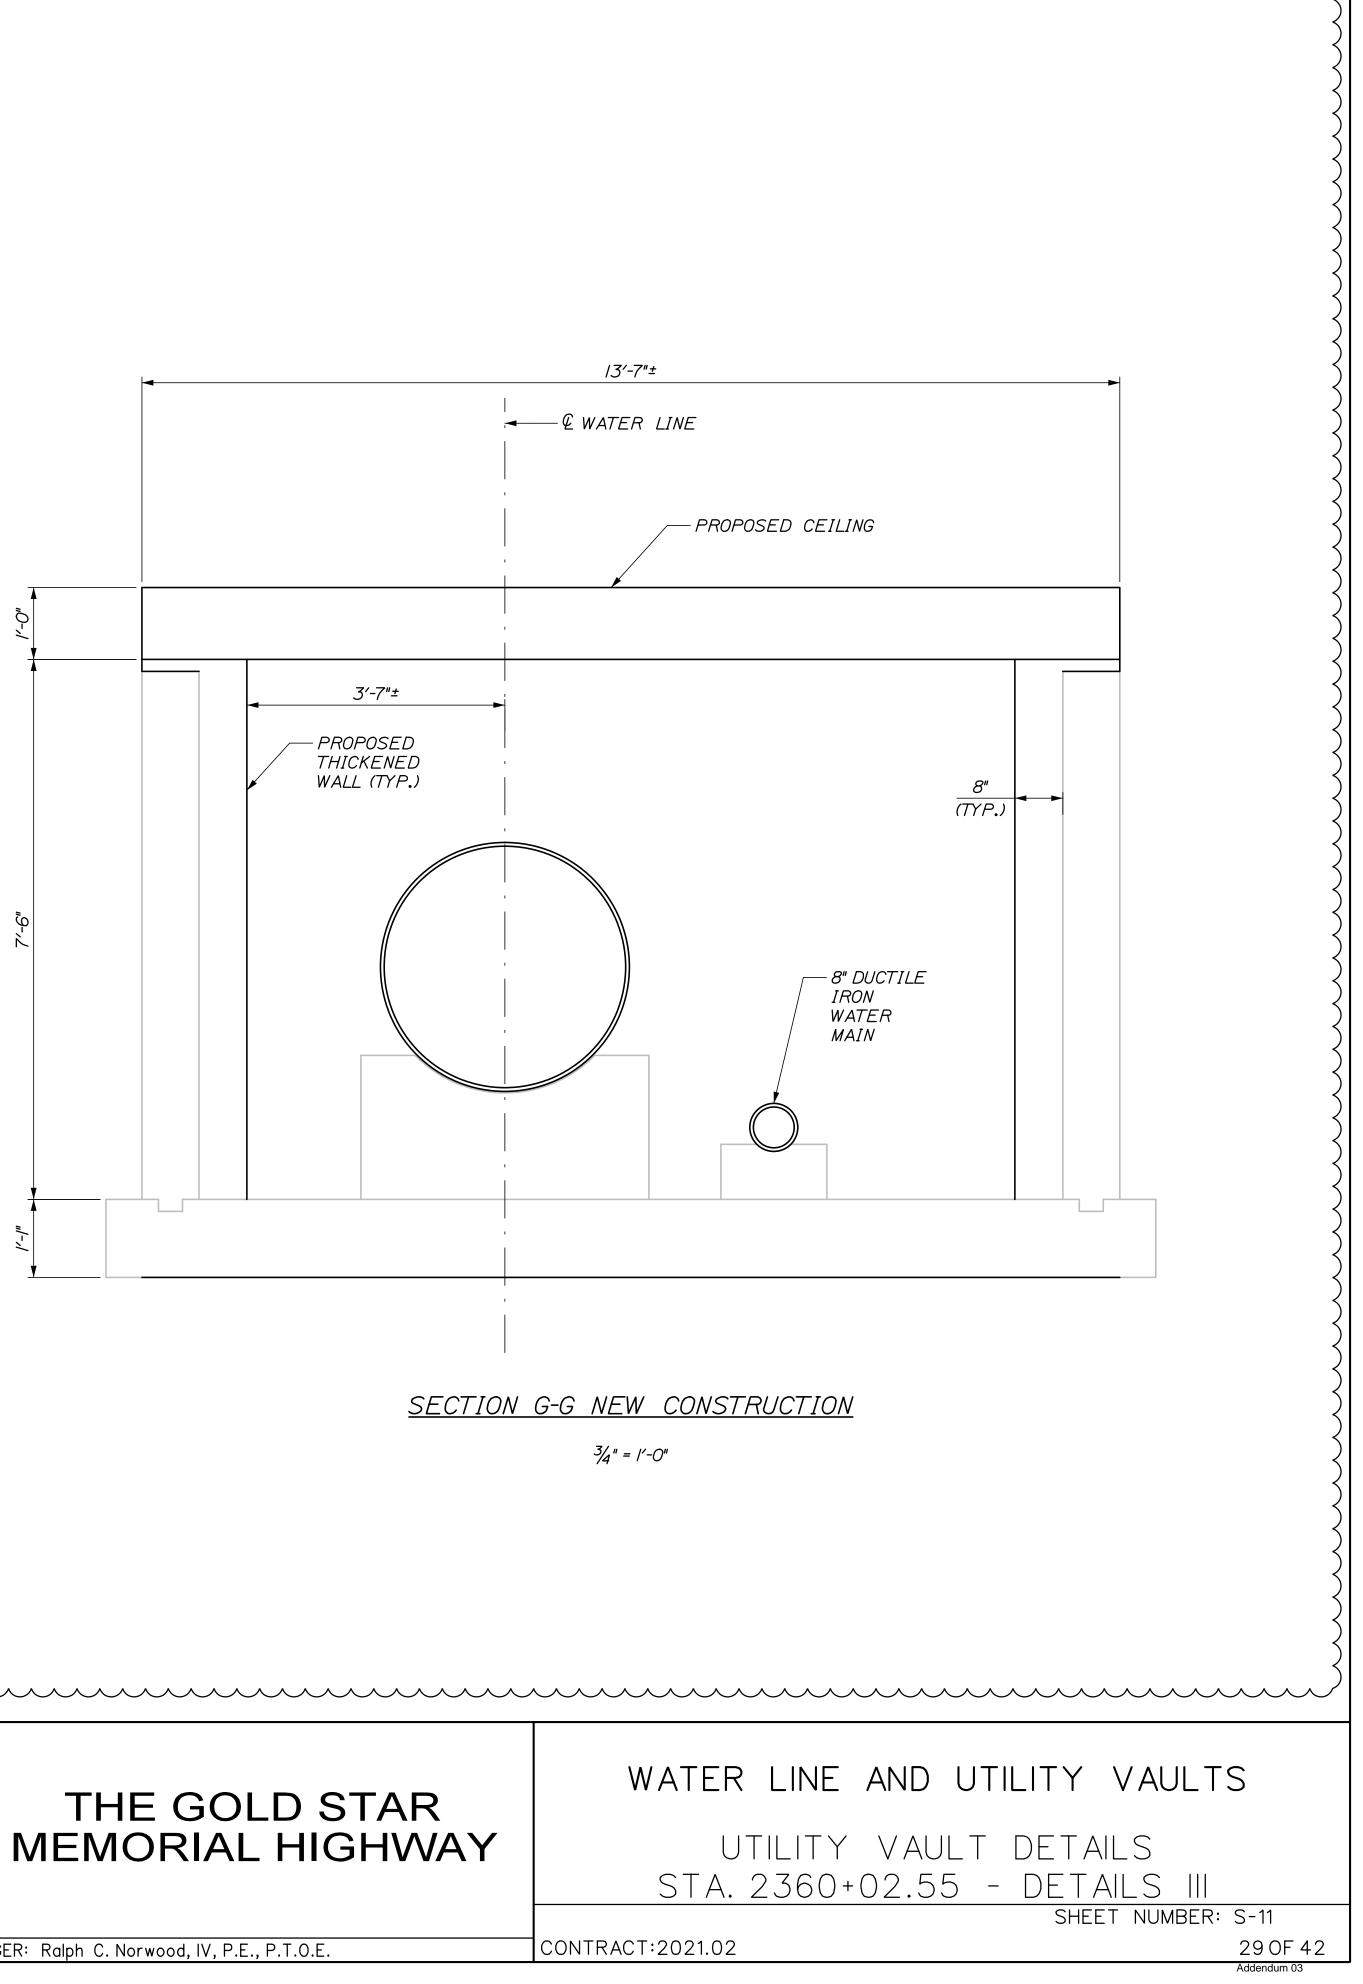

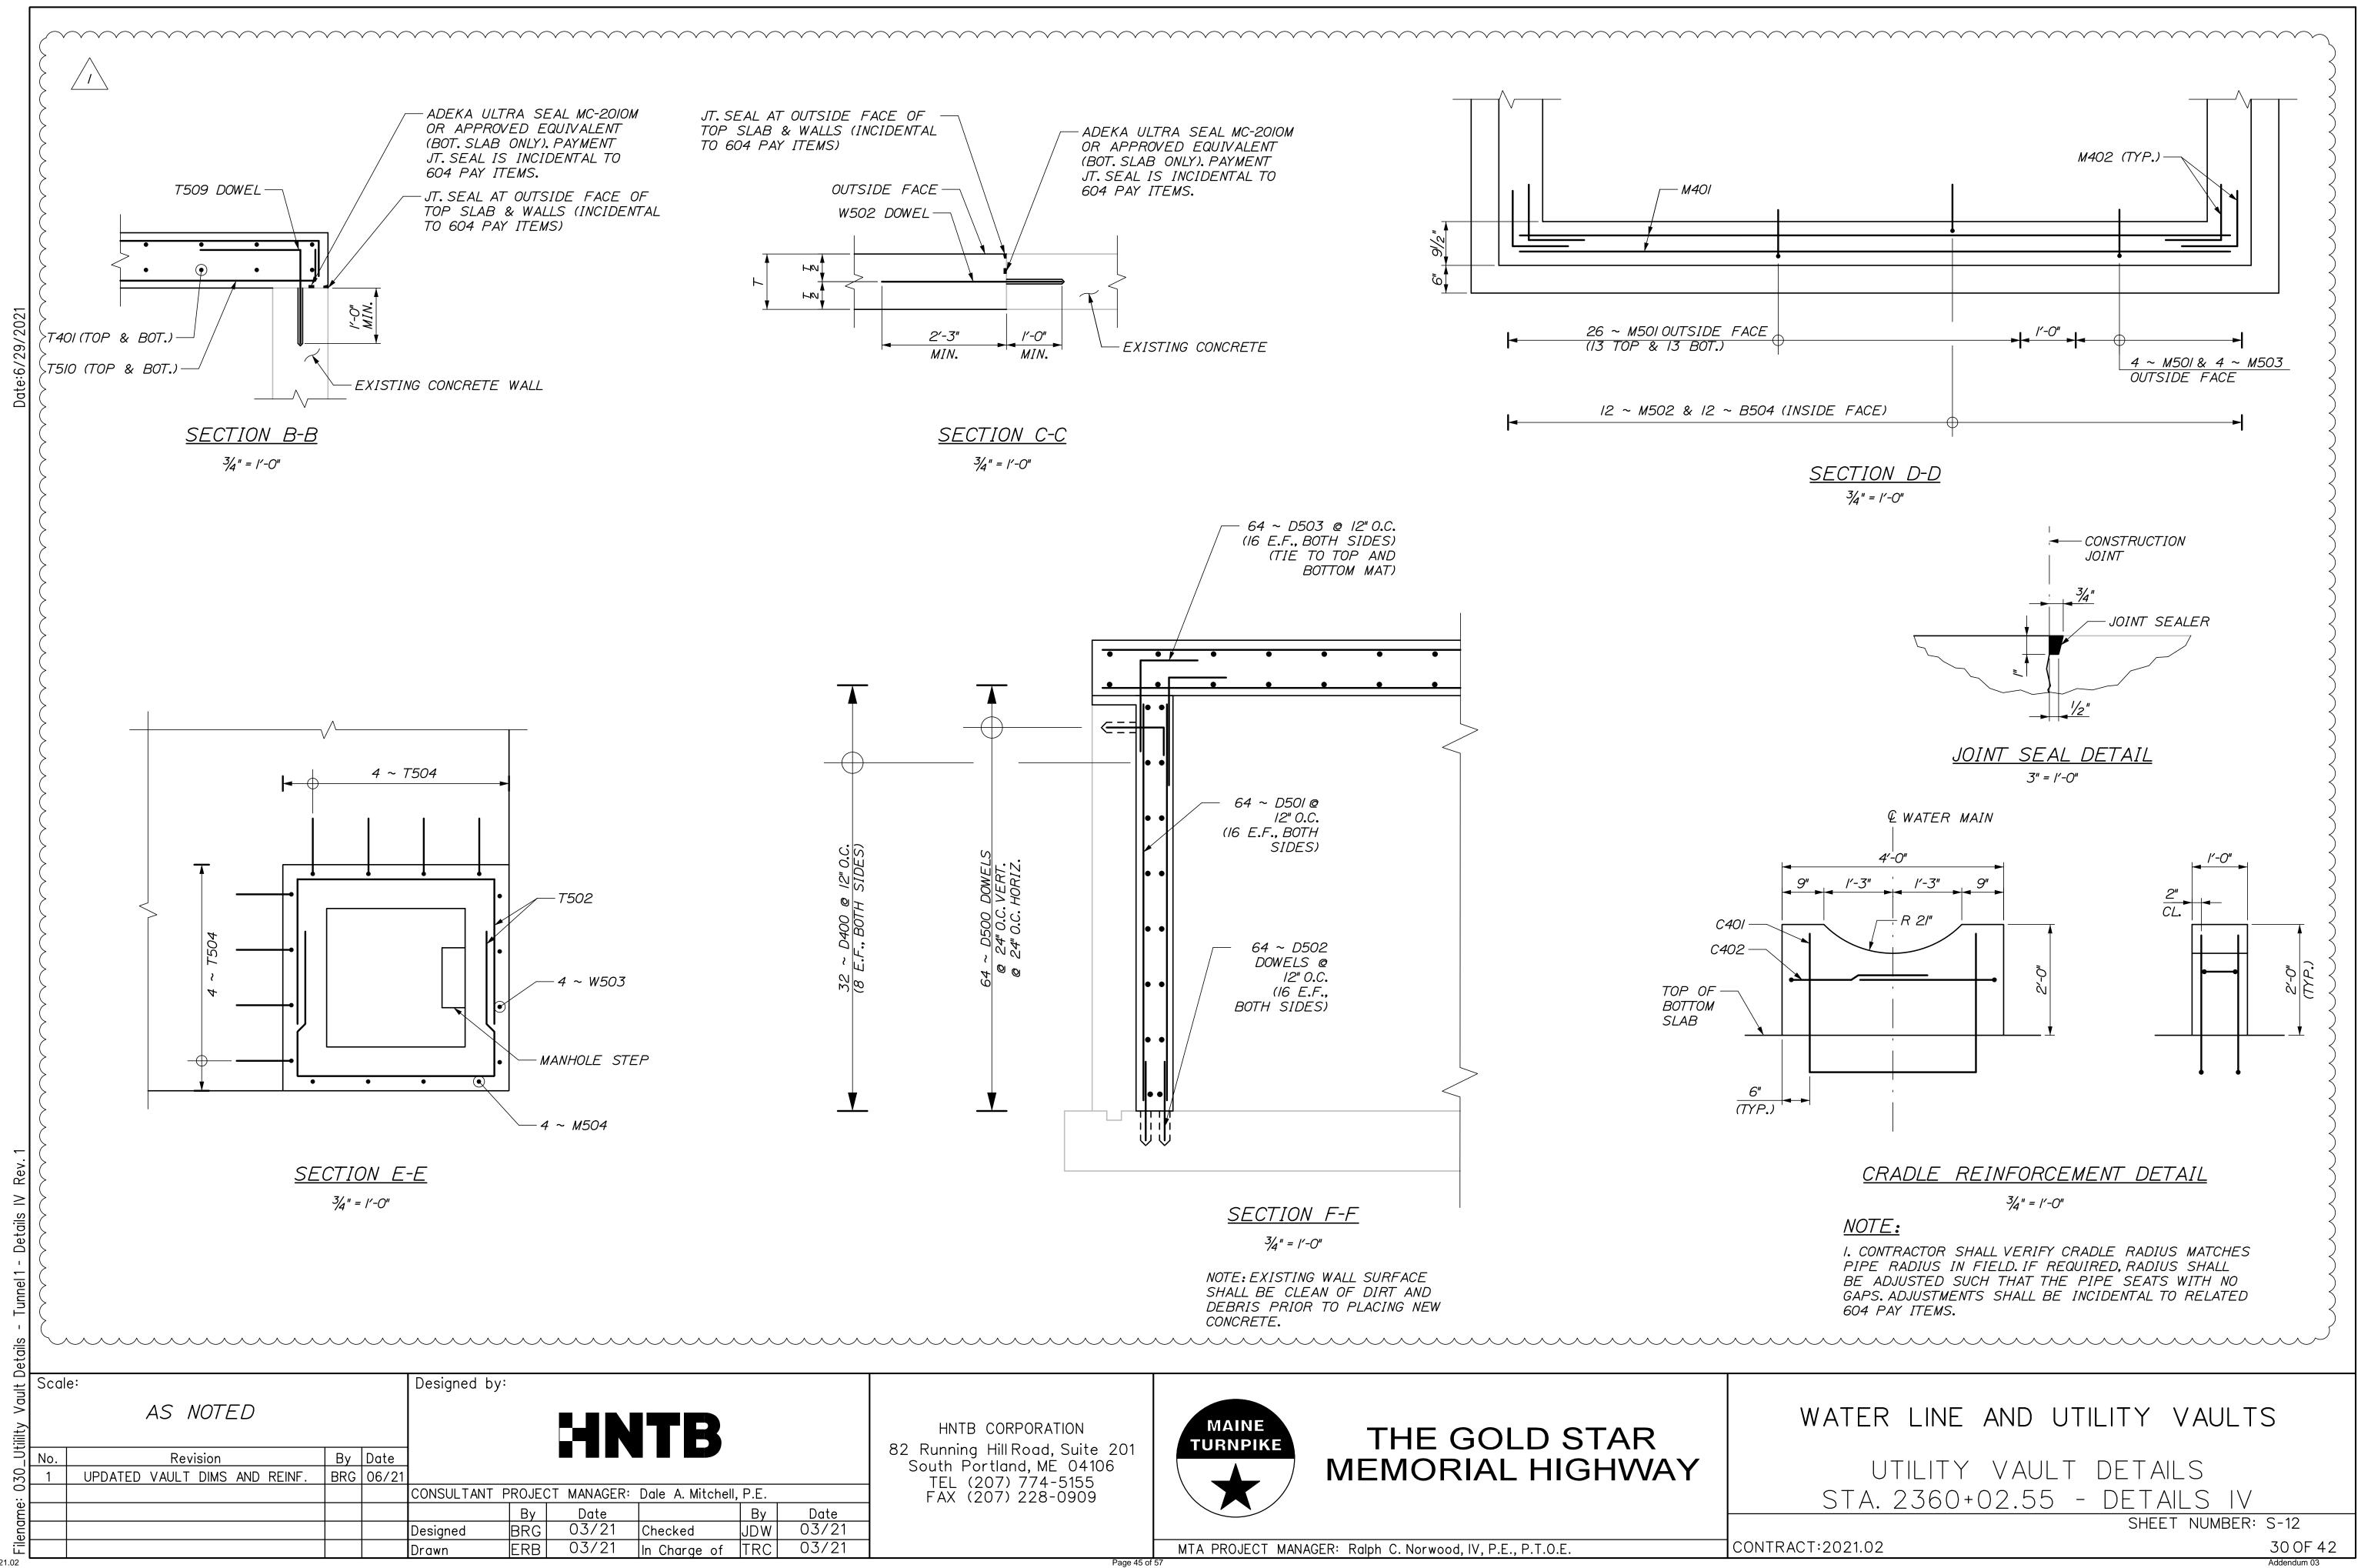

UTILITY VAULT REINFORCING SCHEDULE									
		LENGTH	ТҮРЕ	Α	В	REMARKS			
STA 2360+02.55	4 24	26 - 7	STR			Top Slab: Longitudinal			
	5 14	13 - 3	STR			Top Slab: Transverse Bottom			
	5 14	25 - 5	129	13'-3"	6'-1"	Top Slab: Transverse Top			
2012-000	5 4 5 8	9 - 8	129 118	<u>3'-4"</u> 3'-4"	<u>3'-2"</u> 1'-2"	Top Slab: Horizontal Manhole Top Slab: Vertical Manhole			
	5 7	3 - 6	STR	<del>0 +</del>		Top Slab: Dowel			
	5 36	4 - 0	118	2'-3"	1'-9"	Wall to Top Slab Dowel			
<b>T510</b> 5	5 32	14 - 4	129	13'-2"	7"	Top Slab: Transverse			
¢ W401 4	4 20	11 - 8	STR			Sidewalls: Longitudinal			
	5 28	8 - 2	STR			Sidewalls: Vertical Int. Face			
W502 5		3 - 6	STR			Sidewalls: Dowels			
VV503 5	5 4	9 - 0	STR			Sidewalls: Vertical @ Manhole			
B401 4	4 24	12 - 2	STR			Bottom Slab: Longitudinal			
	5 12	3 - 6	STR			Bottom Slab: Dowels			
B502 5	5 14	14 - 3	STR			Bottom Slab: Transverse Top			
	5 14	26 - 3	129	13'-3"	6'-6"	Bottom Slab: Transverse Bottom			
B504 5	5 40	6 - 10	118	6'-0"	10"	Bottom Slab: Vertical Hook			
M401 4	4 20	13 - 3	STR			Closure Wall: Horizontal			
	4 80	4 - 0	118	2'-0"	2'-0"	Closure Wall: Horizontal Hooks			
M501 5	111	6 - 11	118	6'-1"	10"	Closure Wall: Vertical Ext. Face			
	5 <u>12</u> 5 4	8 - 2 9 - 0	STR STR			Closure Wall: Vertical Int. Face Closure Wall: Vertical Manhole Outside Fac			
	5 8	5 - 0	STR			Closure Wall: Utility Diagonal			
	5 8	1 - 6	STR			Closure Wall: Utility Diagonal			
	1 1		100						
	4 4 4 4	8 - 8	129 129	<u>3'-6"</u> 8"	<u>2'-7"</u> 3'-0"	Cradle: Vertical Cradle: Horizontal			
	4 4	2 4	129	1'-2"	1'-2"	Cradle: Vertical			
C404 4	4 4	1 - 8	129	8"	1'-0"	Cradle: Horizontal			
	1 00								
	4 <u>32</u> 5 64	14 - 1	STR 118	1'-1"	7"	Thickened Wall: Horizontal Thickened Wall: Dowel			
	5 64	7 - 0	STR			Thickened Wall: Vertical			
	5 64	3 - 0	STR			Thickened Wall: Slab Dowels			
D503 5	5 64	4 - 0	118	2'-9"	2'-0"	Thickened Wall: Top Corner Bars			
	B								
<u>7</u> <u>Y</u>	<u>'PE 118</u>	2 Designed by:		' <u>PE 129</u>					




THE GOLD STAR MEMORIAL HIGHWAY


CONTRACT:2021.02

310F 42 Addendum 03

# WATER LINE AND UTILITY VAULTS

UTILITY VAULT DETAILS STA. 2360+02.55 - REINFORCING SCHEDULE SHEET NUMBER: S-13

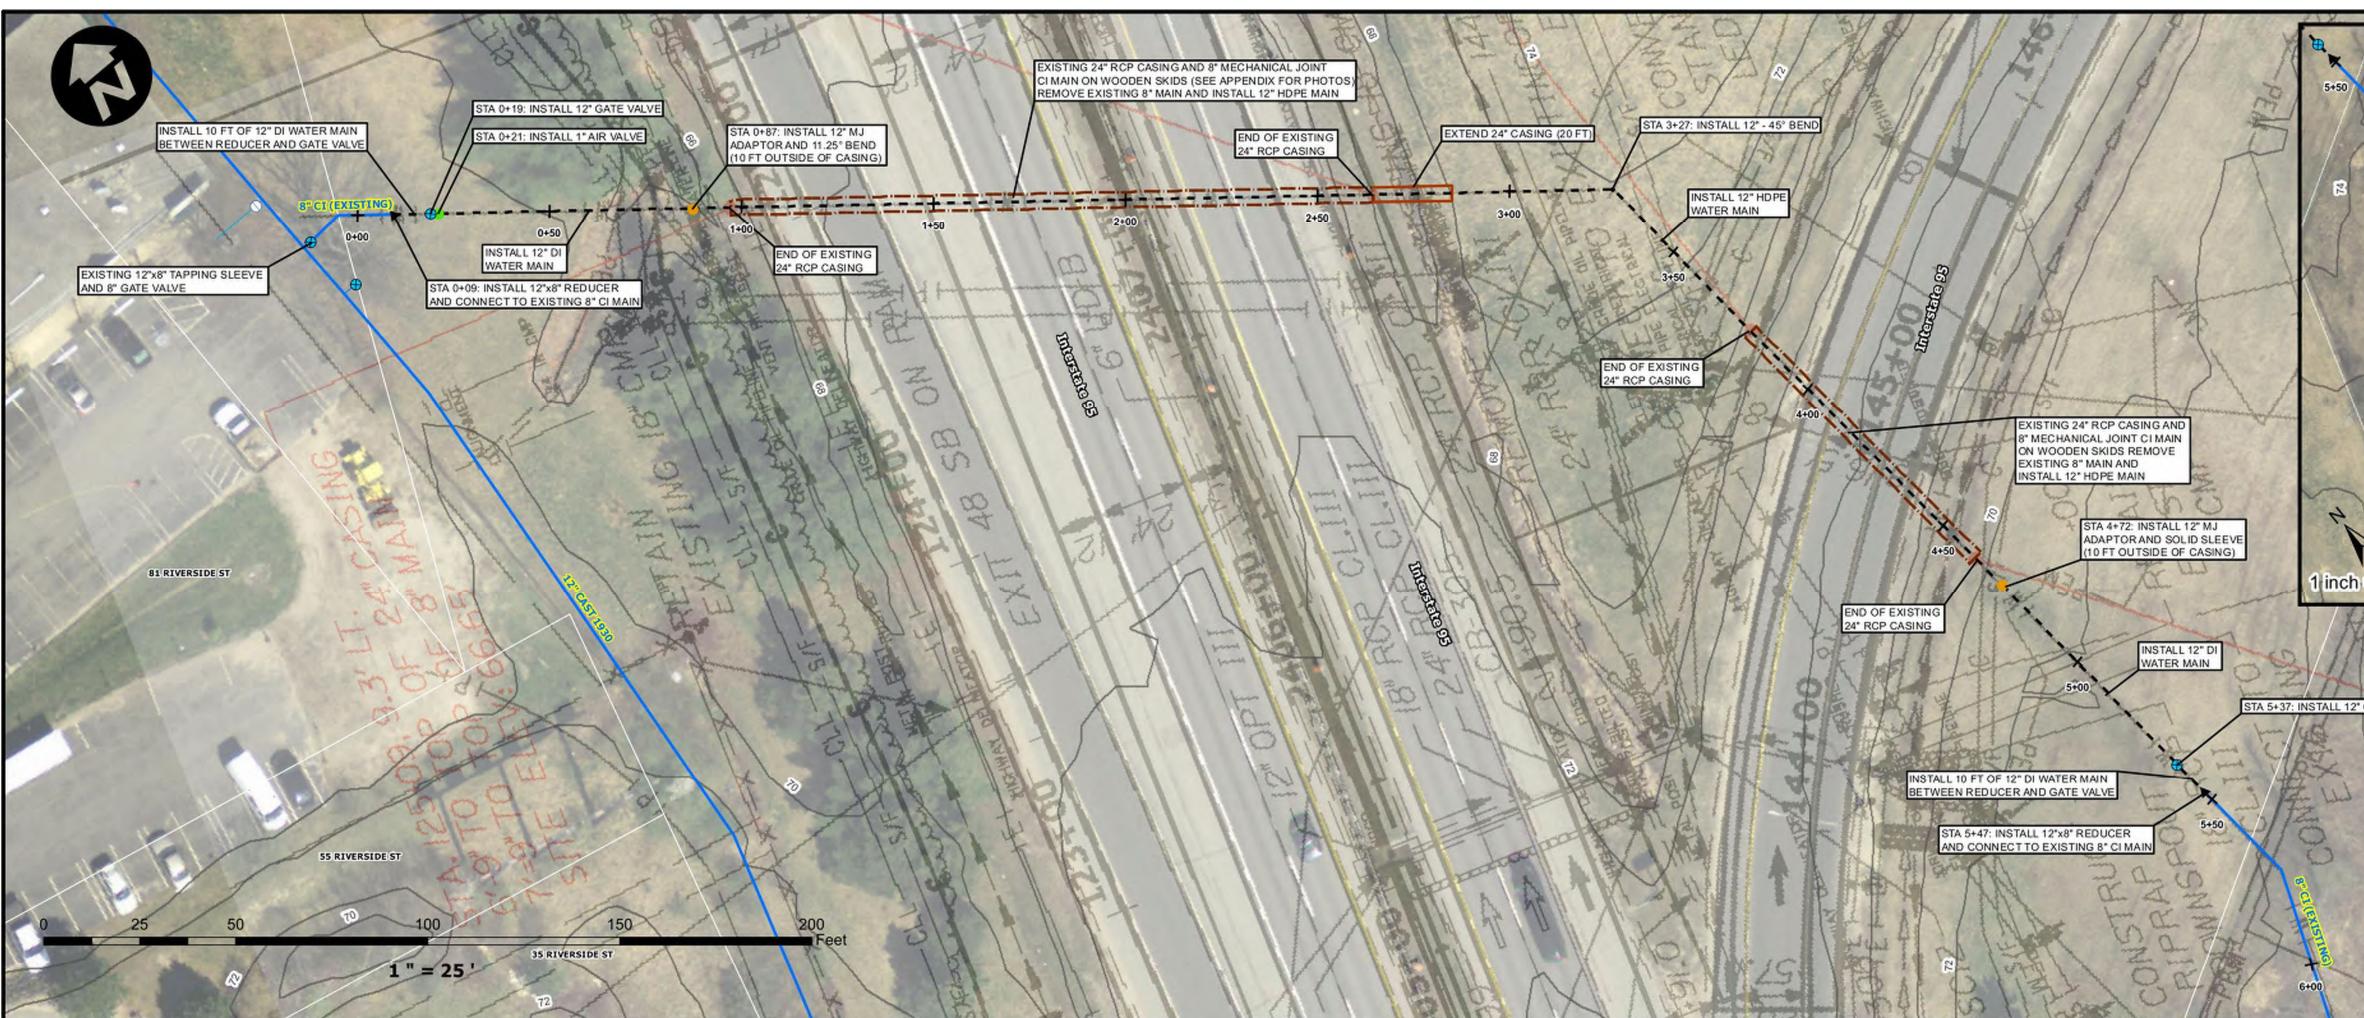

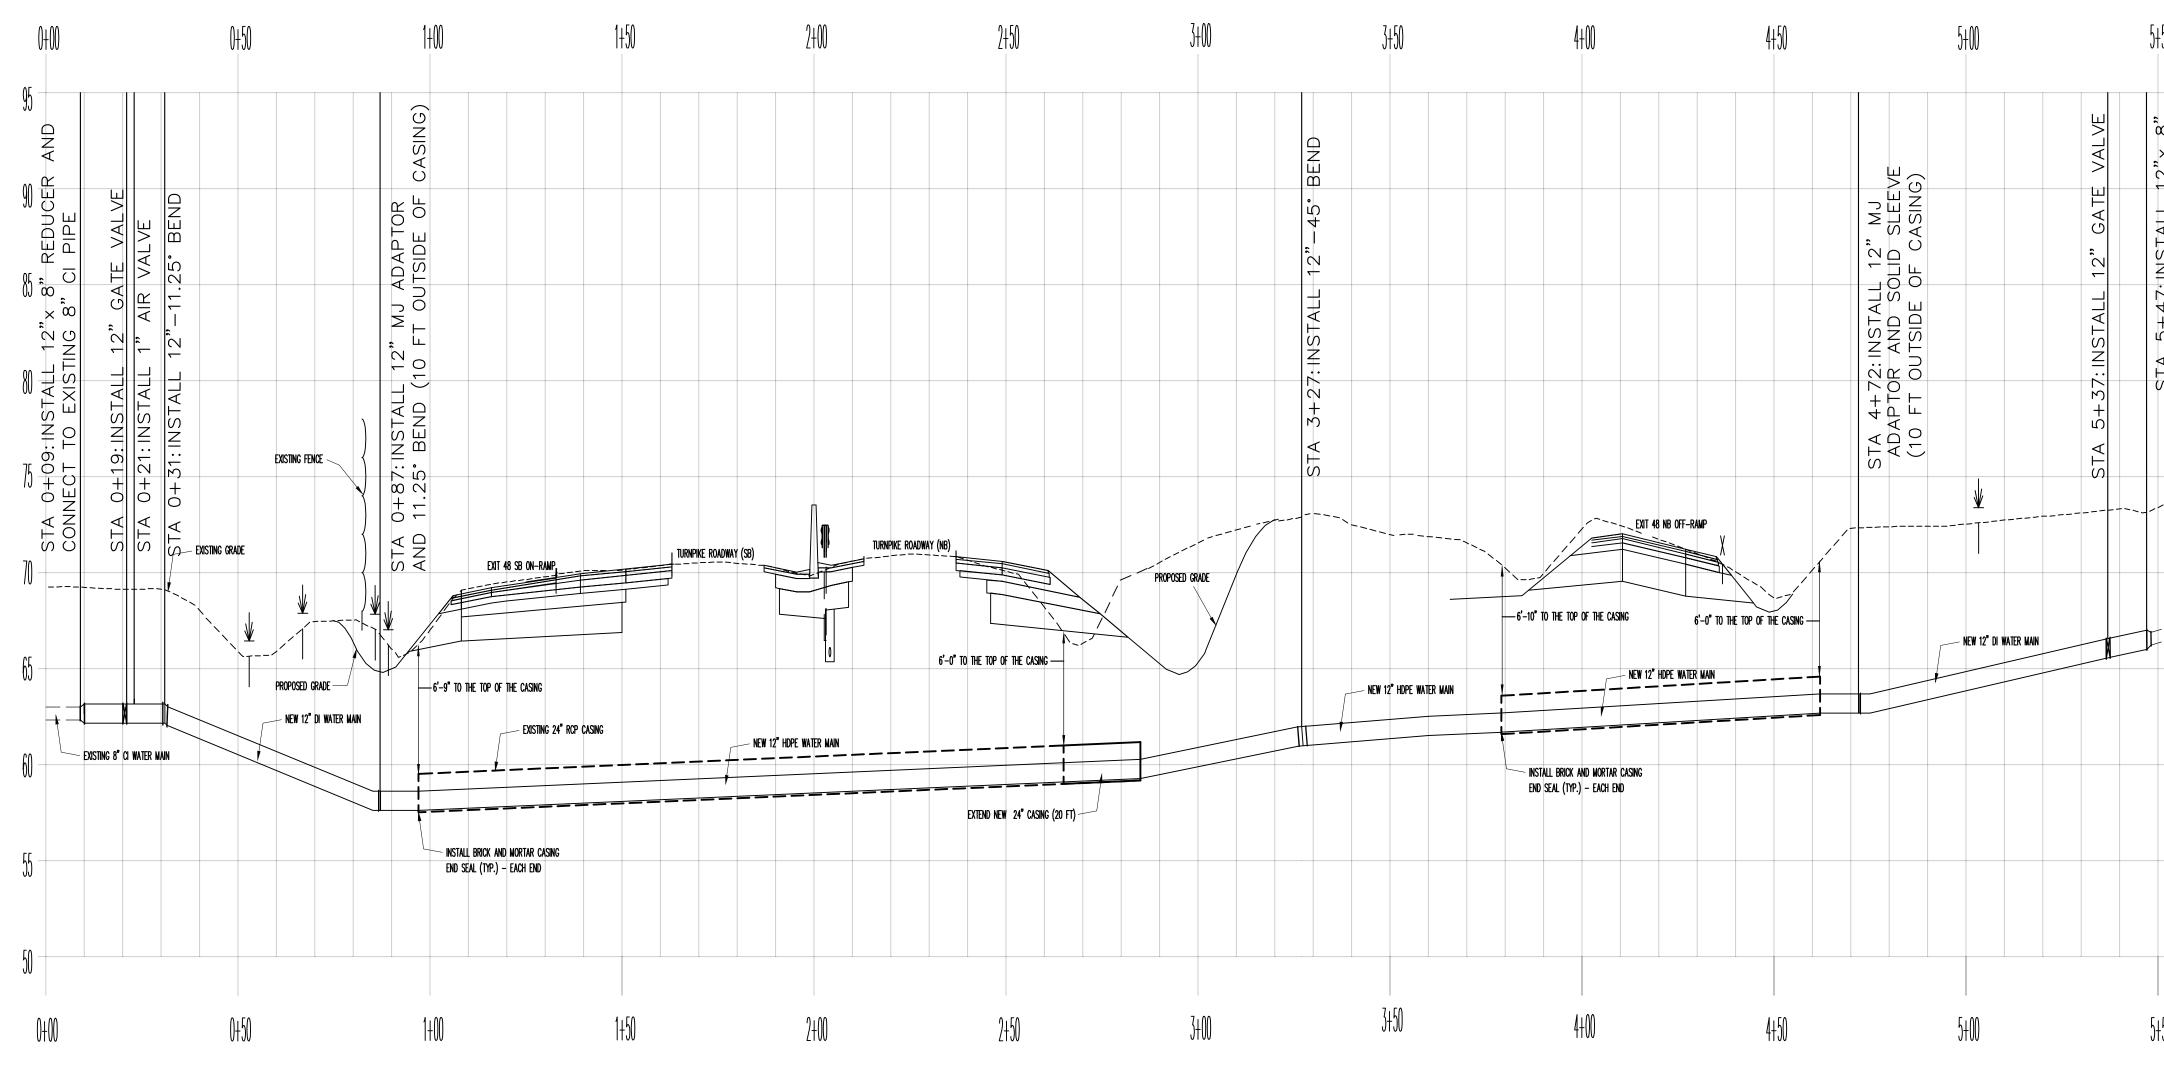


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CONTRACT:

		94	
16		NOTES 1. CONTRACTOR SHALL DISPOSE OF ALL EXCAVATED PIPING AND APPURTENANCES.	PROJECT: <b>437698</b>
e to feet	INTELL I' AIR VALVE ON INTELL I' AIR VALVE ON INTELLI' AIR VALVE INTELLI'	<ol> <li>THE PORTLAND WATER DISTRICT WILL NOTIFY CUSTOMERS FOR ALL WORK INVOLVING TEMPORARY SHUTDOWN OF SERVICE. CUSTOMERS MUST RECEIVE AT LEAST 48 HOURS NOTIFICATION PRIOR TO ANY SHUTDOWN. THE DISTRICT MUST RECEIVE NOTICE FROM THE CONTRACTOR OF THE SHUTDOWN AT LEAST 48 HOURS PRIOR TO CUSTOMER NOTIFICATION.</li> <li>ALL DUCTILE IRON PIPE AND FITTINGS SHALL BE POLY- WRAPPED PER SPECIICATIONS.</li> <li>LOCATIONS OF UTILITIES OTHER THAN WATER ARE APPROXIMATE, AND NOT ALL UTILITES ARE SHOWN. THE CONTRACTOR IS RESPONSIBLE FOR LOCATING, SUPPORTING AND PROTECTING ALL UTILITIES DURING INSTALLATION OF THE WATER MAIN.</li> <li>THE ANNULAR SPACE OF EACH CASING SHALL BE FILLED WITH 3/8" STONE.</li> <li>THE RCP CASING SHALL BE TONGUE AND GROOVE CLASS 4 IN ACCORDANCE WITH AASHTO M170. JOINTS SHALL BE SEALED WITH BUTYL IN ACCORDANCE WITH AASHTO M198.</li> <li>INSTALL RESTRAINED JOINT GASKETS IN ALL DUCTILE IRON PUSH ON JOINTS.</li> </ol>	MTA CROSSING - EXIT 48 PORTLAND, MAINE WATER MAIN REPLACEMENT
	HU SUY	LEGEND	Σξ
(AE)		EXISTING WATER MAIN	5
THE H		PROPOSED/RENEWED SERVICE	
	THE H	O RECONNECT SERVICE	
	6+00 95		MOTHY CONSULTS OF AN ALTER OF
STA 5+47:INSTALL 12"x REDUCER AND CONNECT TO EXISTING 8" CI PIPE	90		DRAWN BY: BSJ DESIGN BY: TM DATE: 12/31/2020
5+47: JCER / XISTIN	UJ		<u>ا</u> ج
	 Verti Horizon	ROFILE CAL: 1"=5' NTAL: 1"=25"	<b>J Water District</b> Ment and Planning department Street, Portland me 04104 www.pwd.org
	65 60 55		Portland Water Asset Management and Plan 225 Douglass Street, Portl (207) 774-5961 • WWW.PWD.ORG
5+50	50 6+00		SHEET
2021.02		32 OF 42	SHEET: <b>1 OF 3</b> Addendum 03



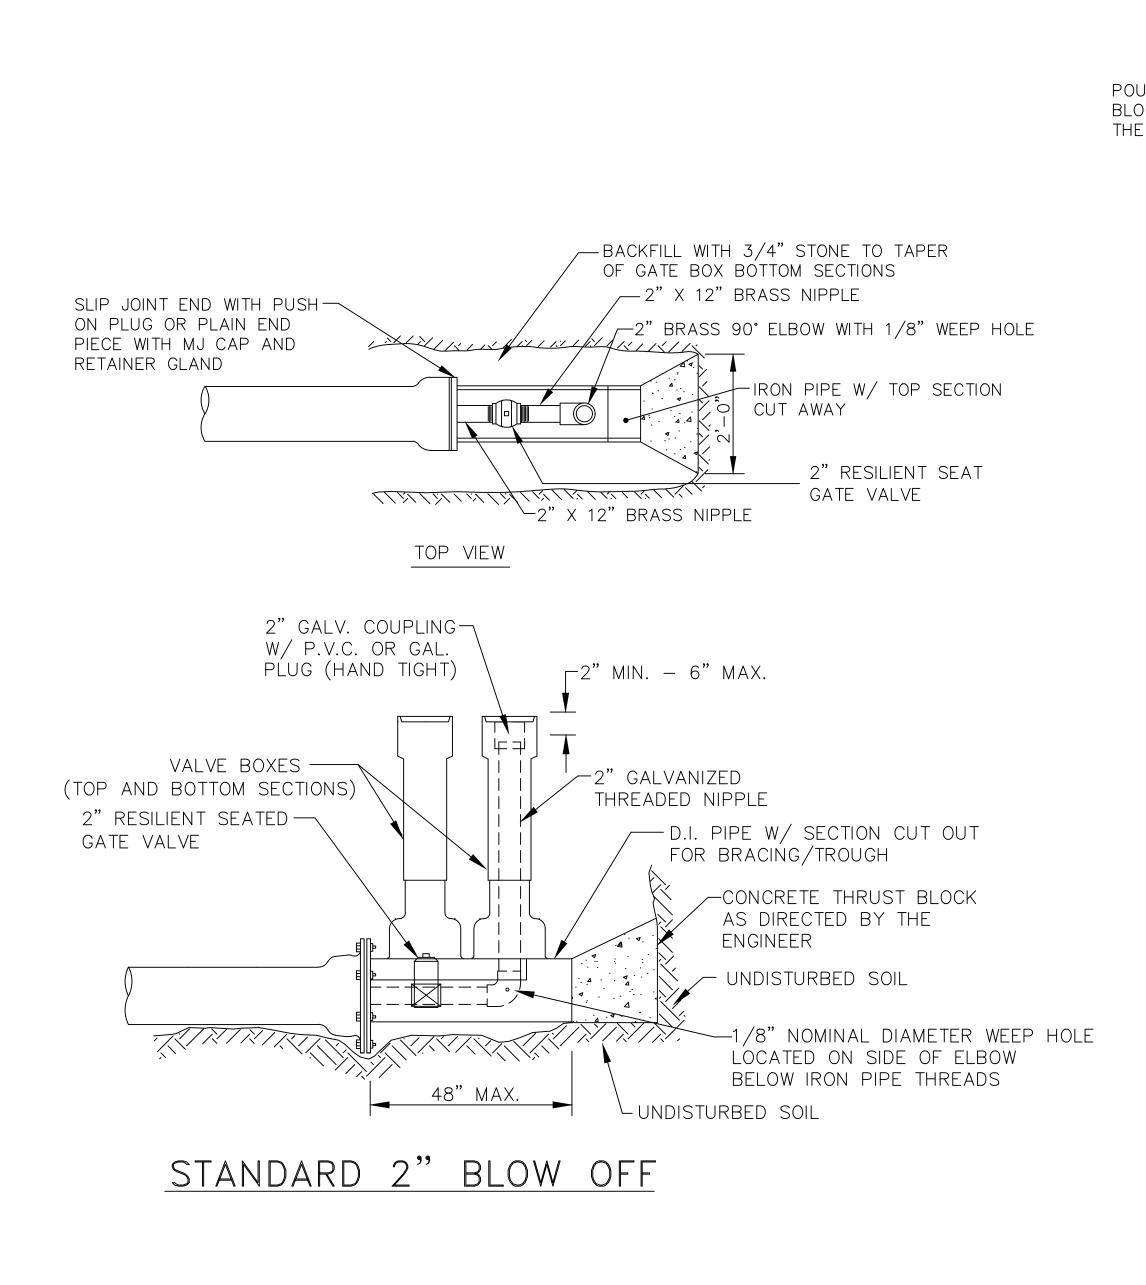

## TYPICAL AIR VALVE (1")

\_¶1<u>"</u>CLEARANCE USE 3/4" BRONZE CORP., C.C. INLET THREAD AND 1" IRON PIPE OUTLET THREAD - SAND/GRAVEL

OF BOX


- AIR VALVE BOX IS TO BE BACKFILLED WITH 3/4" CRUSHED STONE FROM SPRING LINE TO SHOULDER


-USE 3/4" ANGLE BALL VALVE W/ 1" I.P.T. INLET


-STANDARD SERVICE ROD

TYPICAL VALVE BOX BASE (No. 160) OR No. 645 W/ TOP SECTION No. 56

STANDARD SERVICE BOX TO WITHIN 4" OF COVER

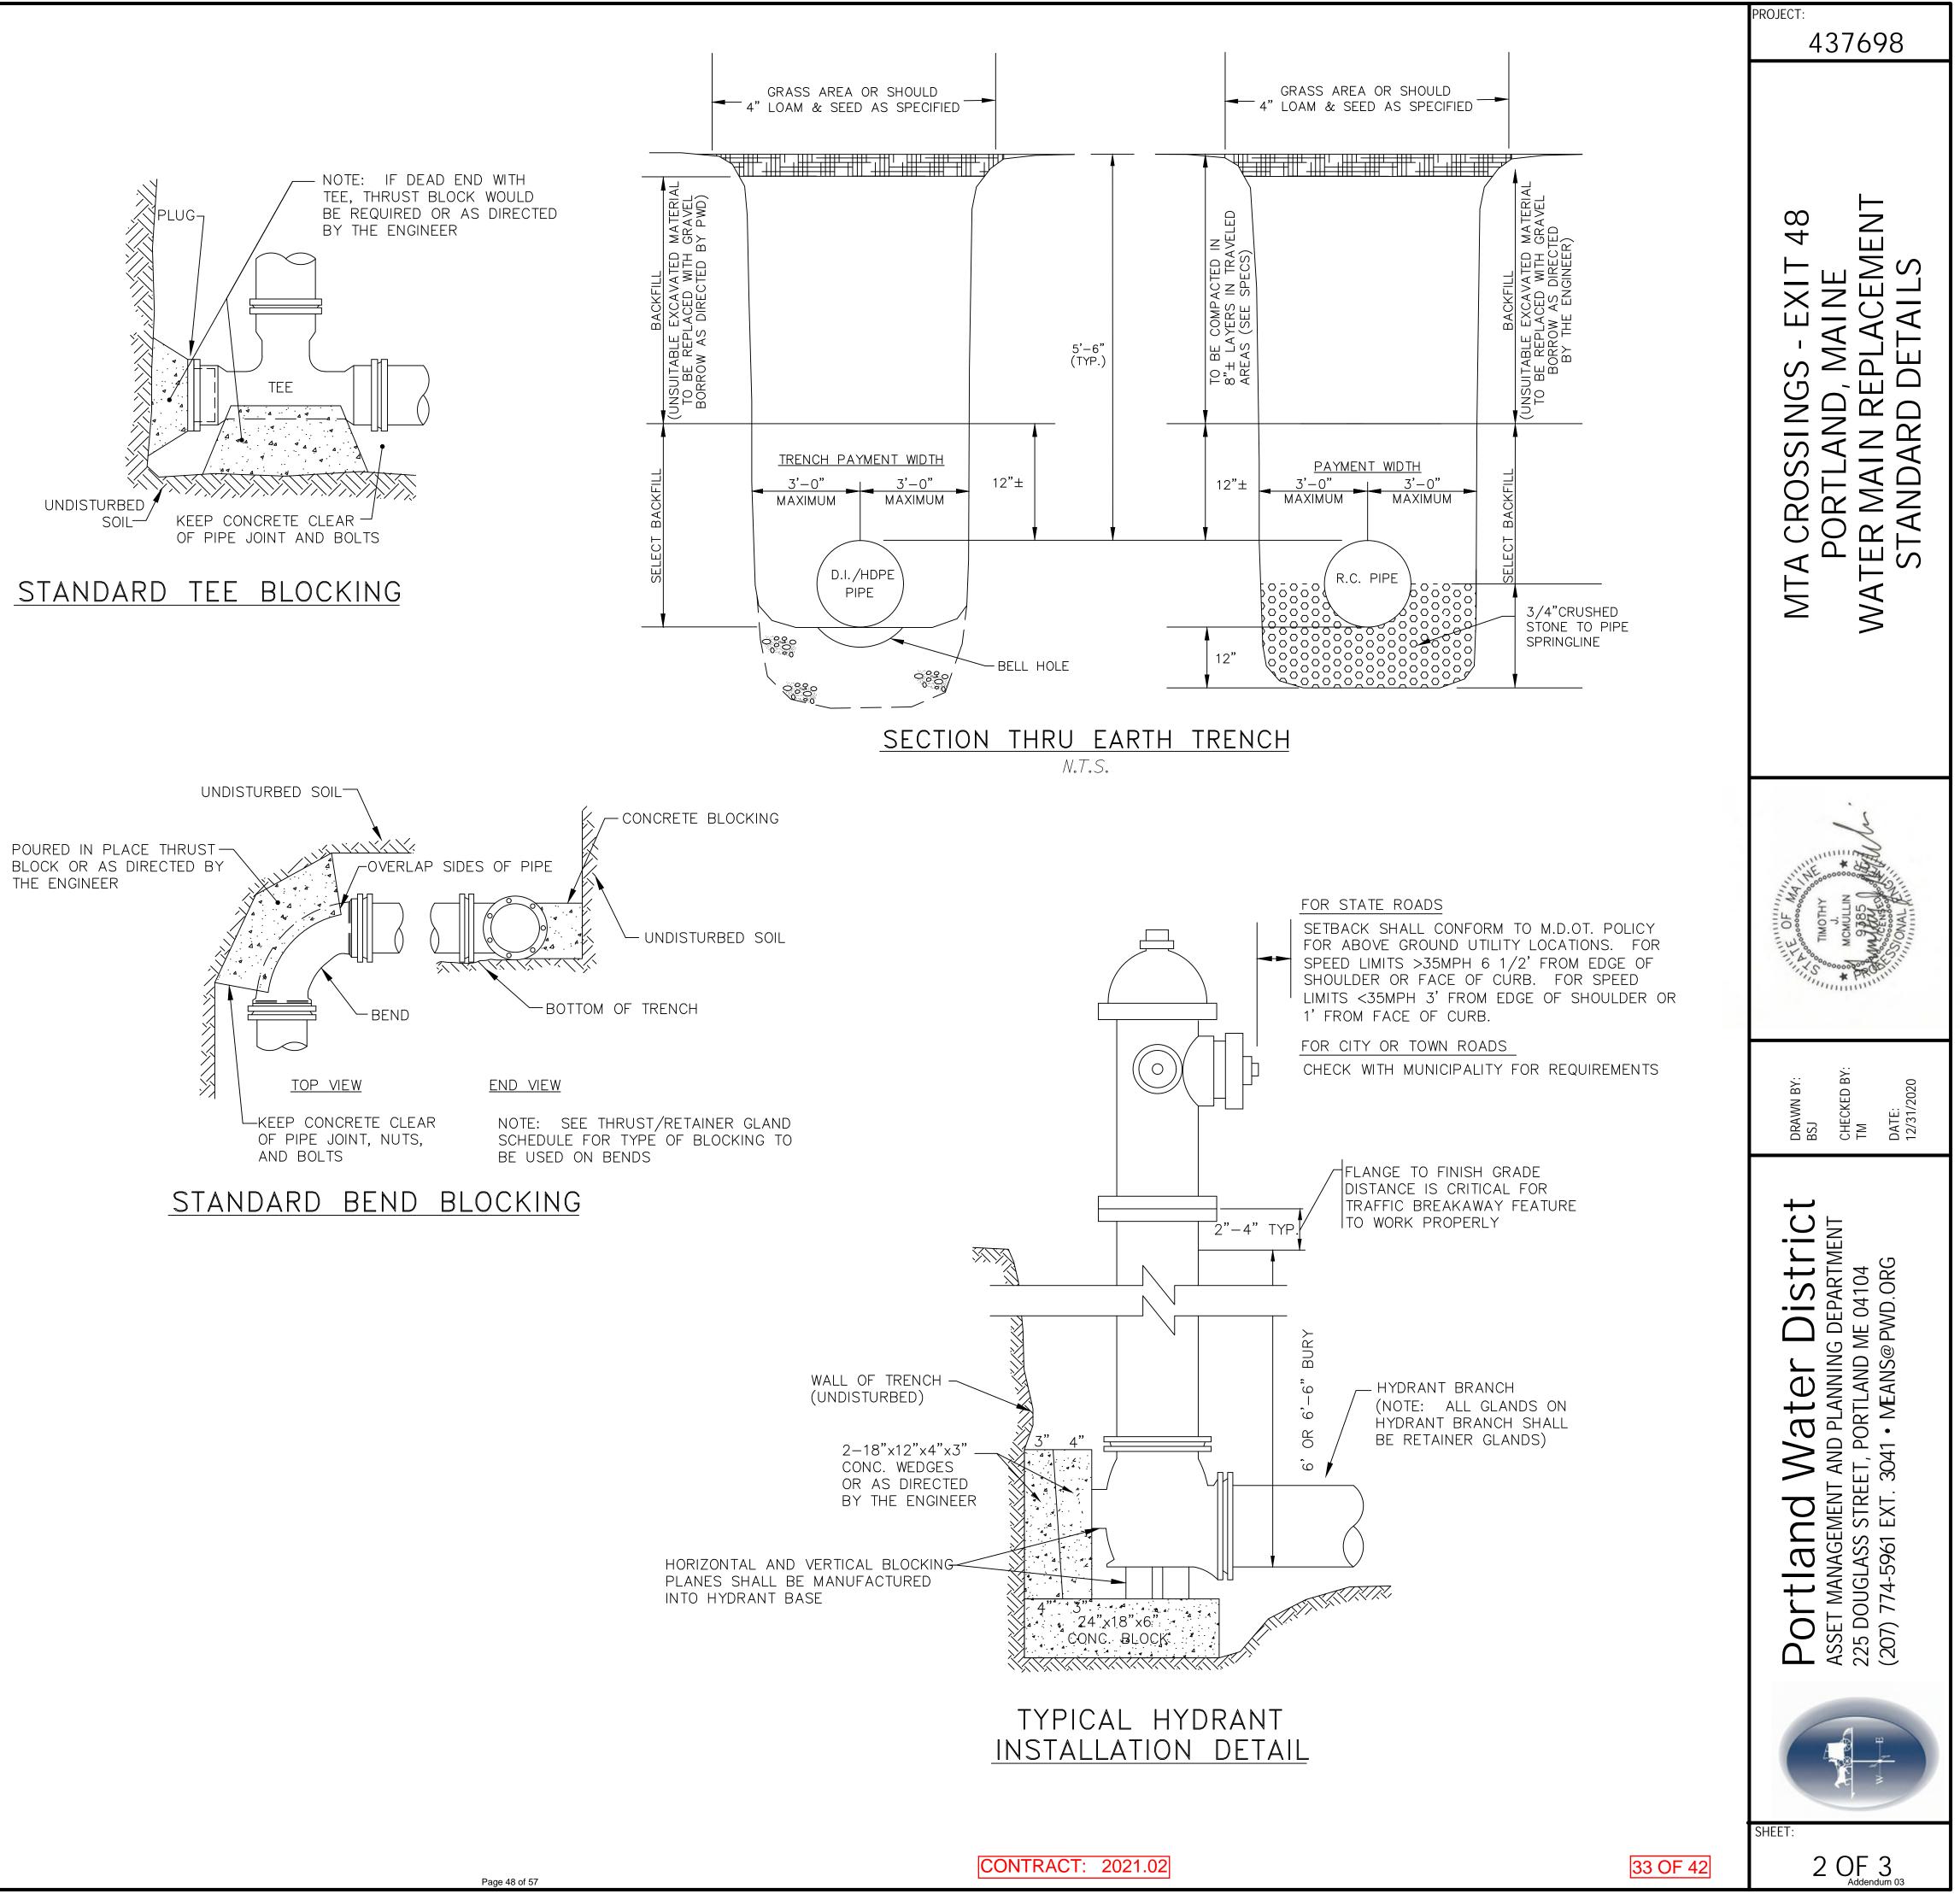


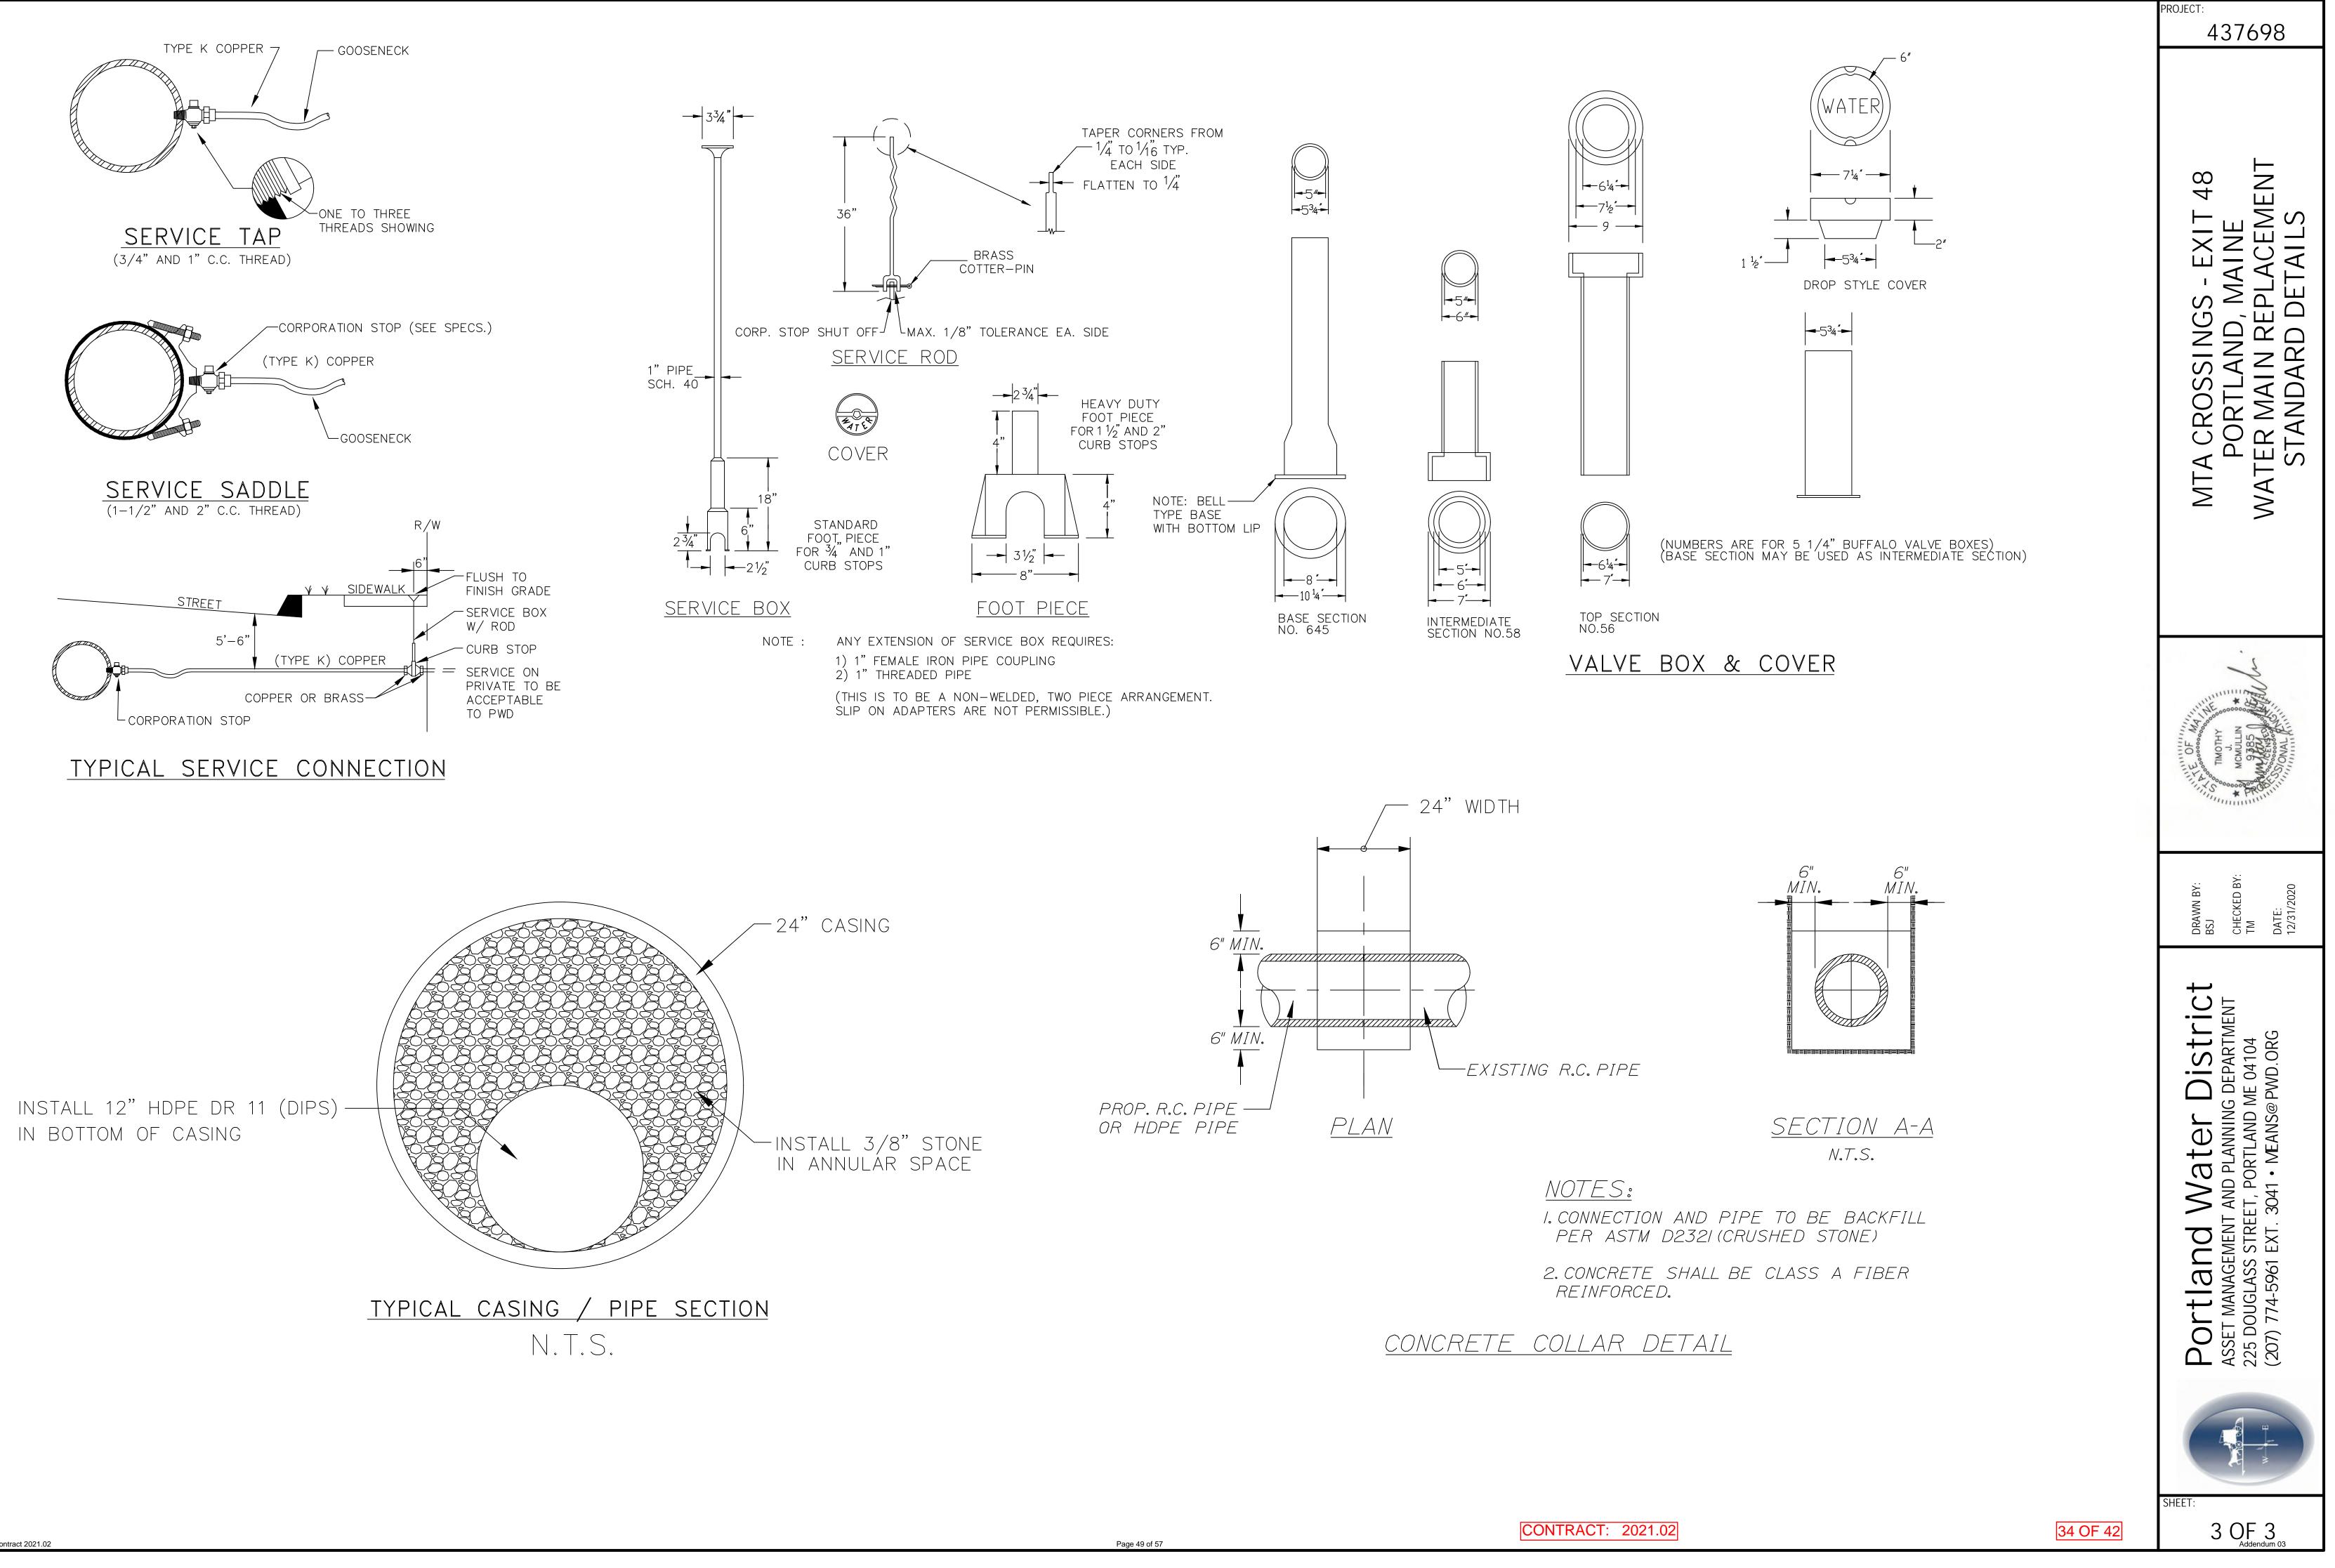

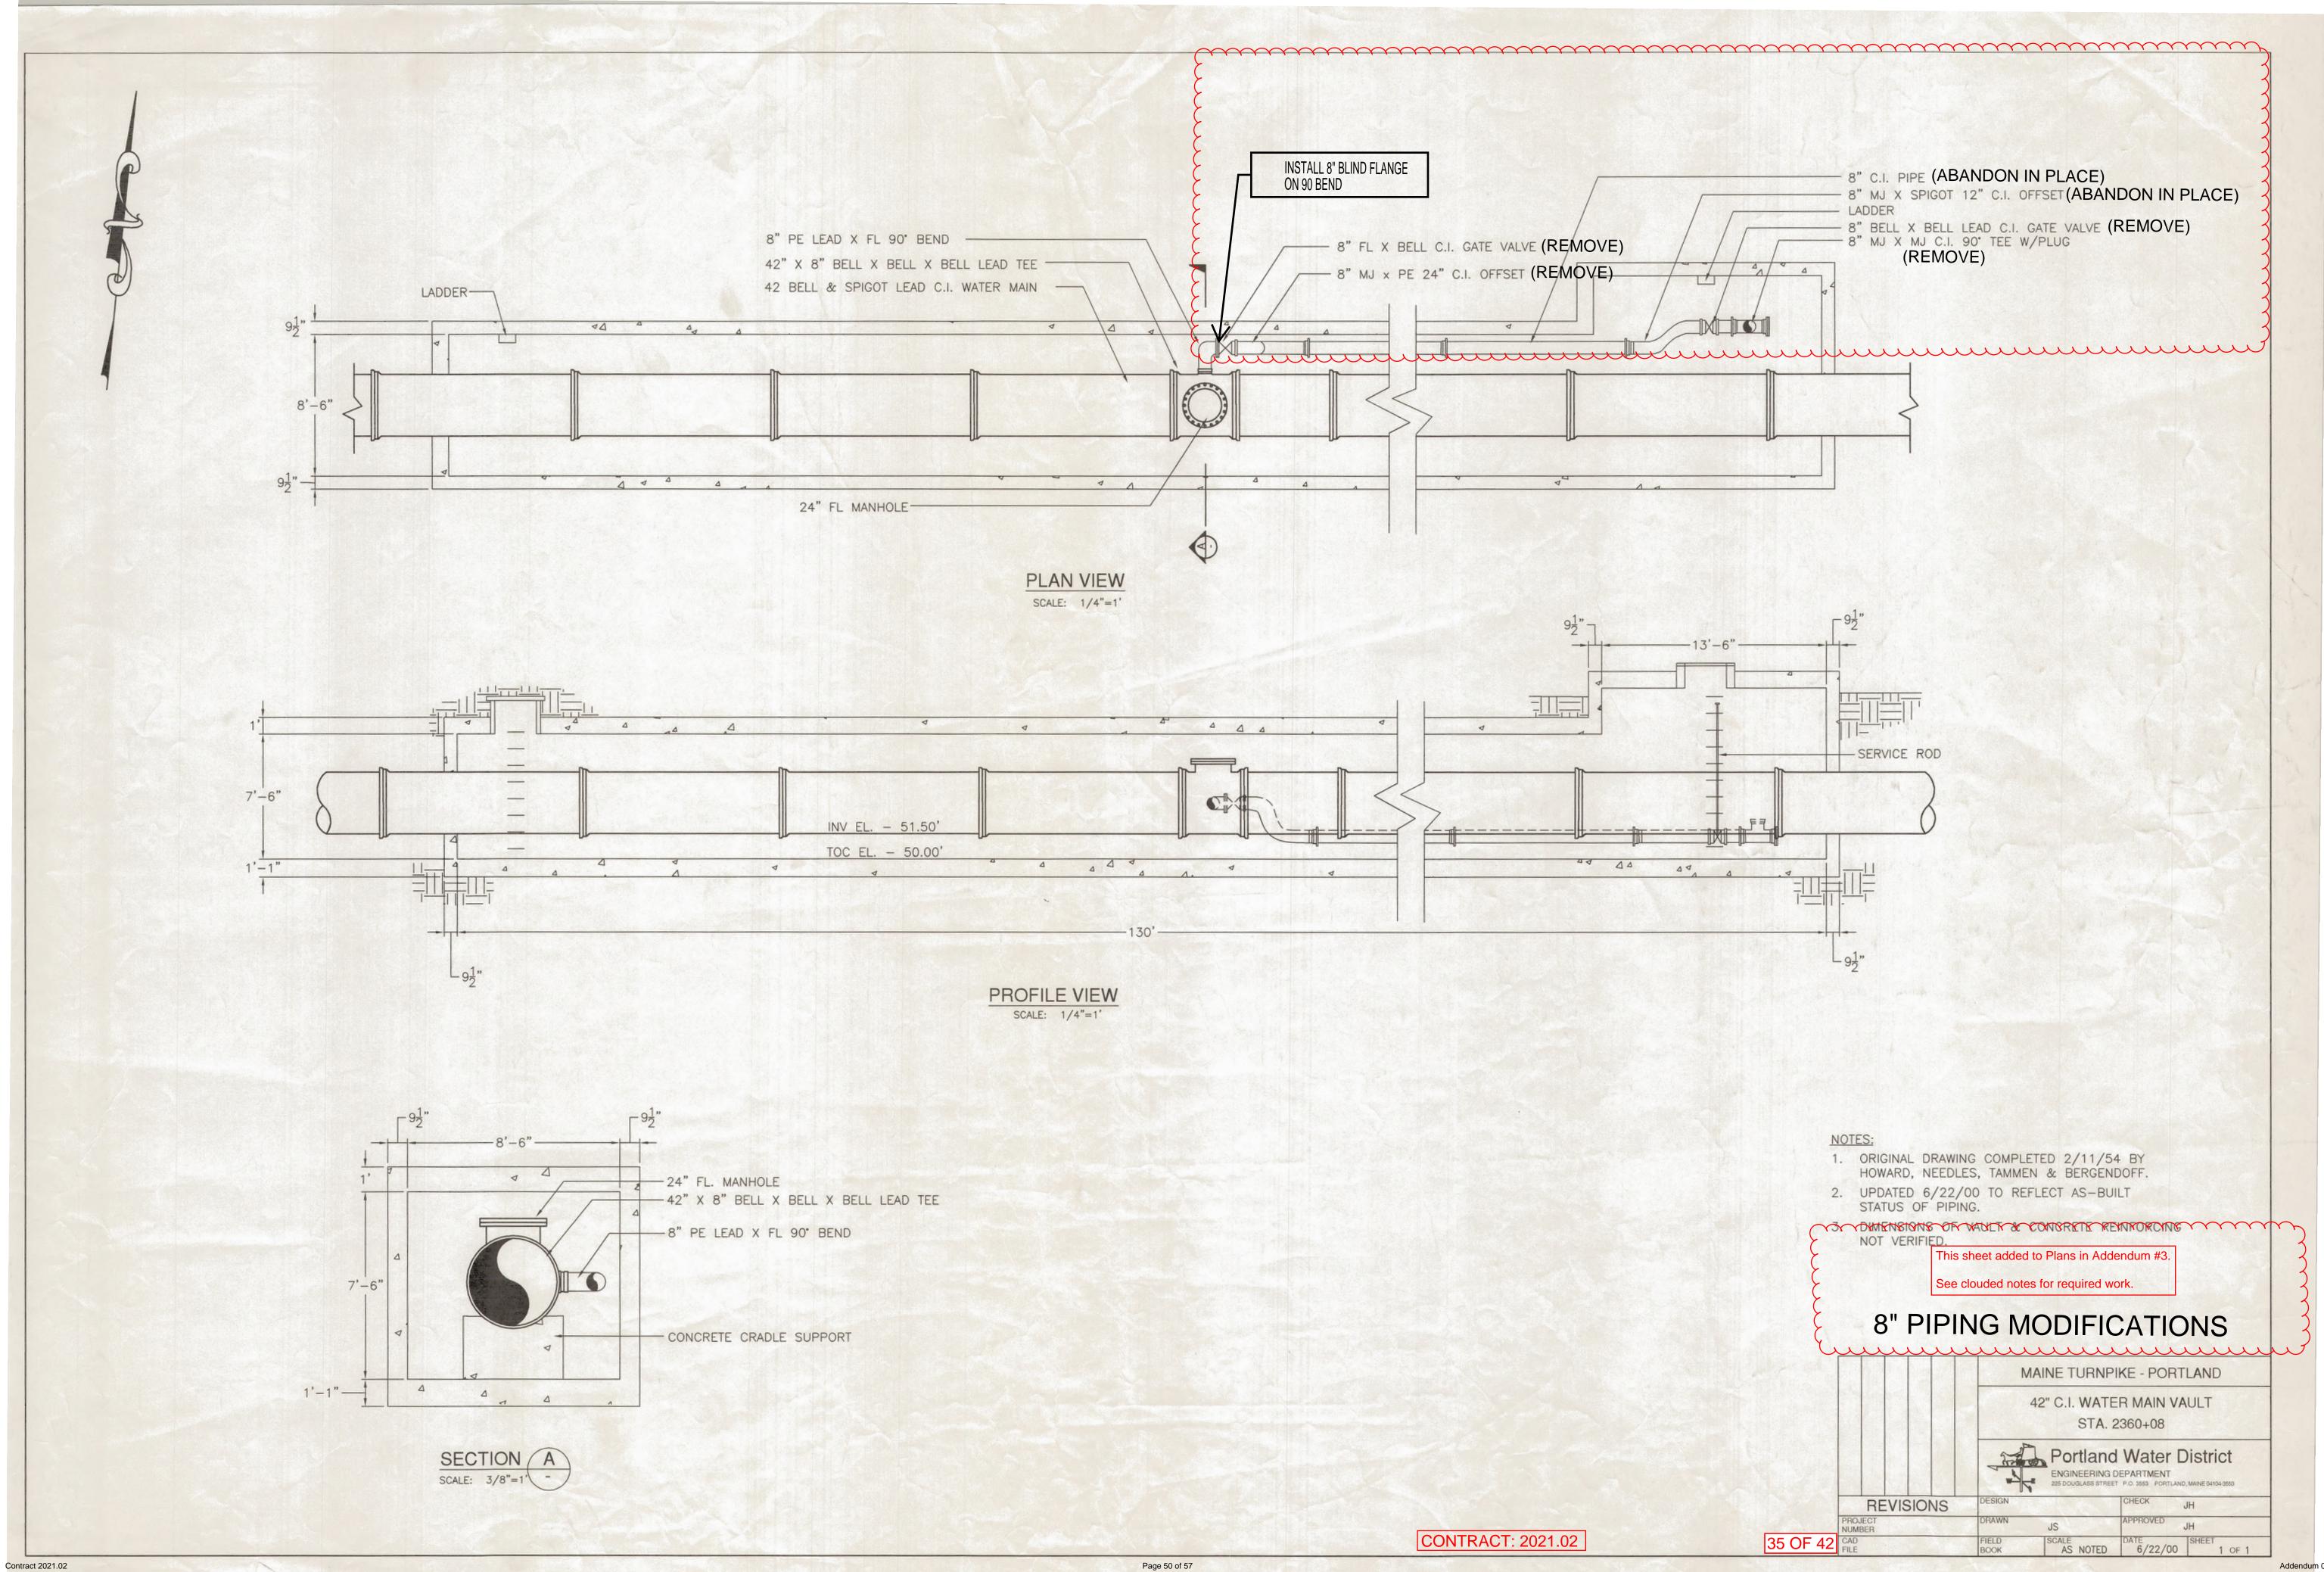

Addendum 03

PROPOSED MANHOLE C MA	BE MAINE TURNPIKE	INDEX OF DRAWINGSSHEET NO.TITLEPWD-S1GENERAL PLANPWD-S2PLAN & ELEVATIONPWD-S3DETAILSPWD-S4REINFORCING SCHEDULE
EXISITNG 42" CIP WATER MAIN PROPOSED TOE OF SLOPE	SIT NG REINFORCED CONCRETE WATER MAIN VAULT	AS-BUILT PLANSSHEET NO.TITLEN/APROPOSED BOX CULVERT FOR 42" C.I. WATERMAIN STA. 2360+08.
SHOULDER 12' 12' 4 EXISTING ROADWAY N ONIO	Proposed	QUANTITIESITEM NO.DESCRIPTIONQUANTITY206.061STRUCTURAL EARTH EXCAVATION – DRAINAGE390MINOR STRUCTURES, BELOW GRADE304.10AGGREGATE BASE COURSE – GRAVEL170304.10AGGREGATE BASE COURSE – GRAVEL170502.30STRUCTURAL CONCRETE BOX CULVERT (100 CY)1503.12REINFORCING STEEL, FABRICATED AND DELIVERED9640503.13REINFORCING STEEL, PLACING9640514.06CURING BOX FOR CONCRETE CYLINDERS1
PROPOSED TOE/ OF SLOPE	MAINE TURNER SHOOTDER	DESIGN AASHTO STANDARD SPECIFICATIONS FOR HIGHWAY BRIDGES SIXTEENTH EDIT 1996 WITH LATEST INTERIM REVISIONS. CONSTRUCTION STATE OF MAINE, DEPARTMENT OF TRANSPORTATION, STANDARD SPECIFICAT HIGHWAYS AND BRIDGES, REVISION OF APRIL 1995.
1" = 20'		<u>DESIGN LIVE LOAD</u> AASHTO HS 25-44
<u>GENERAL NOTES</u>		<u>DESIGN METHOD</u> LOAD FACTOR DESIGN
<ol> <li>A COPY OF AS-BUILT PLAN IS INCLUDED IN THIS CONTRACT FOR THE CONTRACTOR'S CONVENIENCE. THE COMPLETENESS AND ACCURACY OF THIS PLAN IS NOT GUARANTEED.</li> </ol>	ABBREVIATIONS N.F. NEAR FACE F.F. FAR FACE	<u>MATERIALS</u> <u>CONCRETE</u> f'c = 4,000 P.S.I. (CLASS A) <u>REINFORCING STEEL</u>
<ol> <li>BORING LOGS ARE INCLUDED IN APPENDIX G OF THE SPECIFICATIONS.</li> <li>ALL PROPOSED ELEVATIONS REFERENCE THE NORTH AMERICAN</li> <li>VERTICAL DATUM (NAVD) 1988. THE ELEVATIONS REFERENCED ON THE AS-BUILT PLAN MAY DIFFER.</li> </ol>	E.F.EACH FACEE.S.EQUALLY SPACEDCL.CLEARTTOPBBOTTOM	AASHTO M31 GRADE 60 (UNCOATED BARS) fy = 60,000 P.S.I.
<ul> <li>FOR ADDITIONAL DETAILS REFERENCED OR NOT SHOWN IN THESE</li> <li>4. DRAWINGS, SEE THE STATE OF MAINE, DEPARTMENT OF TRANSPORTATION, STANDARD DETAILS, HIGHWAYS AND BRIDGES, APRIL 1997.</li> </ul>	&ANDTYP.TYPICALEXIST.EXISTINGPROP.PROPOSED	ORIGINAL DESIGN PLANS
		WE WITLADITO WILLING TRADAK INTERALANCE
e: A& NQTED		<b>D WIDENING PROJECT</b> WESTBROOK, MAINE

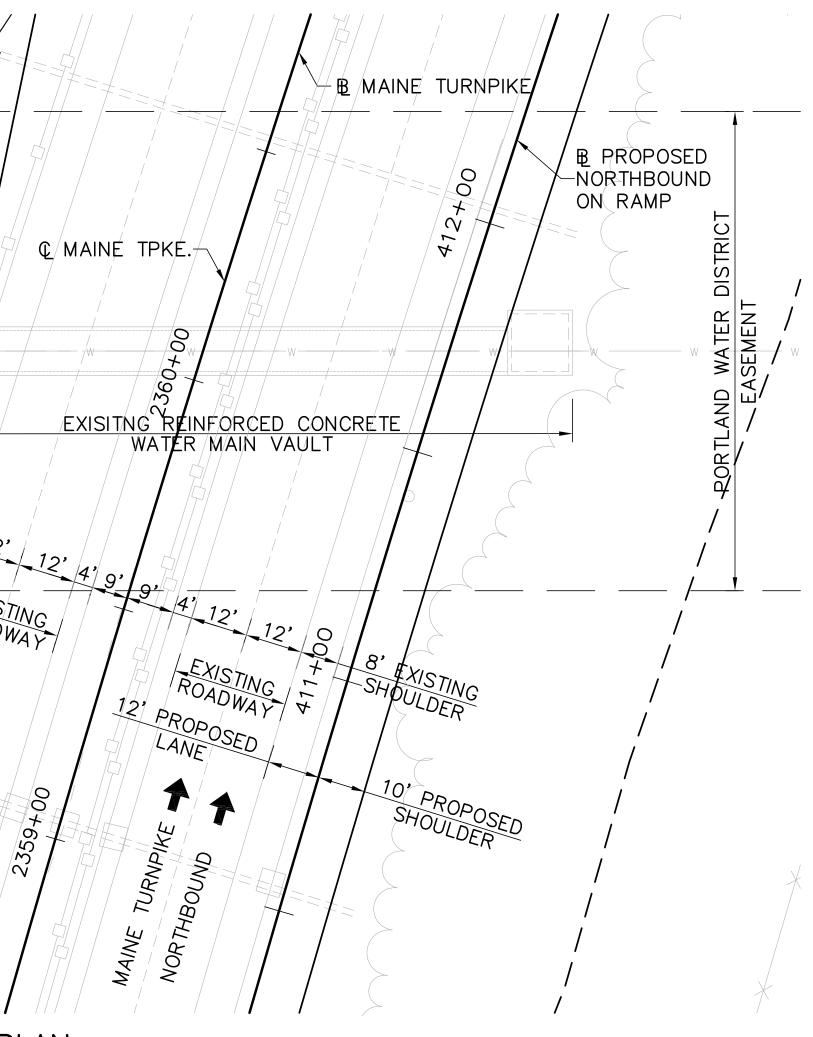



ABBREVIATIONS				
N.F.	NEAR FACE			
F.F.	FAR FACE			
E.F.	EACH FACE			
E.S.	EQUALLY SPACED			
CL.	CLEAR			
Т	TOP			
В	BOTTOM			
38	AND			
TYP.	TYPICAL			
EXIST.	EXISTING			
PROP.	PROPOSED			

	NDEX OF DRAWINGS
SHEET NO.	TITLE
PWD-S1	GENERAL PLAN
PWD-S2	PLAN & ELEVATION
PWD-S3	DETAILS
PWD-S4	REINFORCING SCHEDULE

	AS-BUILT PLANS						
SHEET NO.	TITLE						
N/A	PROPOSED BOX CULVERT FOR WATERMAIN STA. 2360+08.	42" C.I.					
	W/(TERM/(IN ST/): 2000100:						

### QUANTITIES

DESCRIPTION	QUANTITY	UNIT
STRUCTURAL EARTH EXCAVATION - DRAINAGE	390	C.Y.
MINOR STRUCTURES, BELOW GRADE		
AGGREGATE BASE COURSE – GRAVEL	170	C.Y.
STRUCTURAL CONCRETE BOX CULVERT (100 CY)	1	L.S.
REINFORCING STEEL, FABRICATED AND DELIVERED	9640	LBS.
REINFORCING STEEL, PLACING	9640	LBS.
CURING BOX FOR CONCRETE CYLINDERS	1	EACH

### **SPECIFICATIONS**

