MAINE TURNPIKE AUTHORITY

DANIEL E. WATHEN, CHAIR ROBERT D. STONE, VICE CHAIR MICHAEL J. CIANCHETTE, MEMBER ANN R. ROBINSON, MEMBER JANE L. LINCOLN, MEMBER THOMAS J. ZUKE, MEMBER BRUCE A. VAN NOTE, EX-OFFICIO MEMBER

S. PETER MILLS, EXECUTIVE DIRECTOR

CONTRACT 2022.04

BRIDGE REPAIRS ROUTE 236 UNDERPASS (MM 1.25) ROUTE 1 OFF-RAMP (RAMP J) UNDERPASS (MM 1.50) ROUTE 1 ON-RAMP (RAMP H) UNDERPASS (MM 1.60) WILSON ROAD UNDERPASS (MM 2.00) **SPRUCE CREEK OVERPASS (MM 2.20)** LITTLEFIELD ROAD UNDERPASS (MM 17.30)

> **EMERGENCY VEHICLE RAMPS** LITTLEFIELD ROAD (MM 17.30)




Route 1 Off-Ramp (Ramp J)

Underpass (MM 1.50)

> Gordon M. Edington, P.E. Consultant Project Manager

1/14/2022 DATE

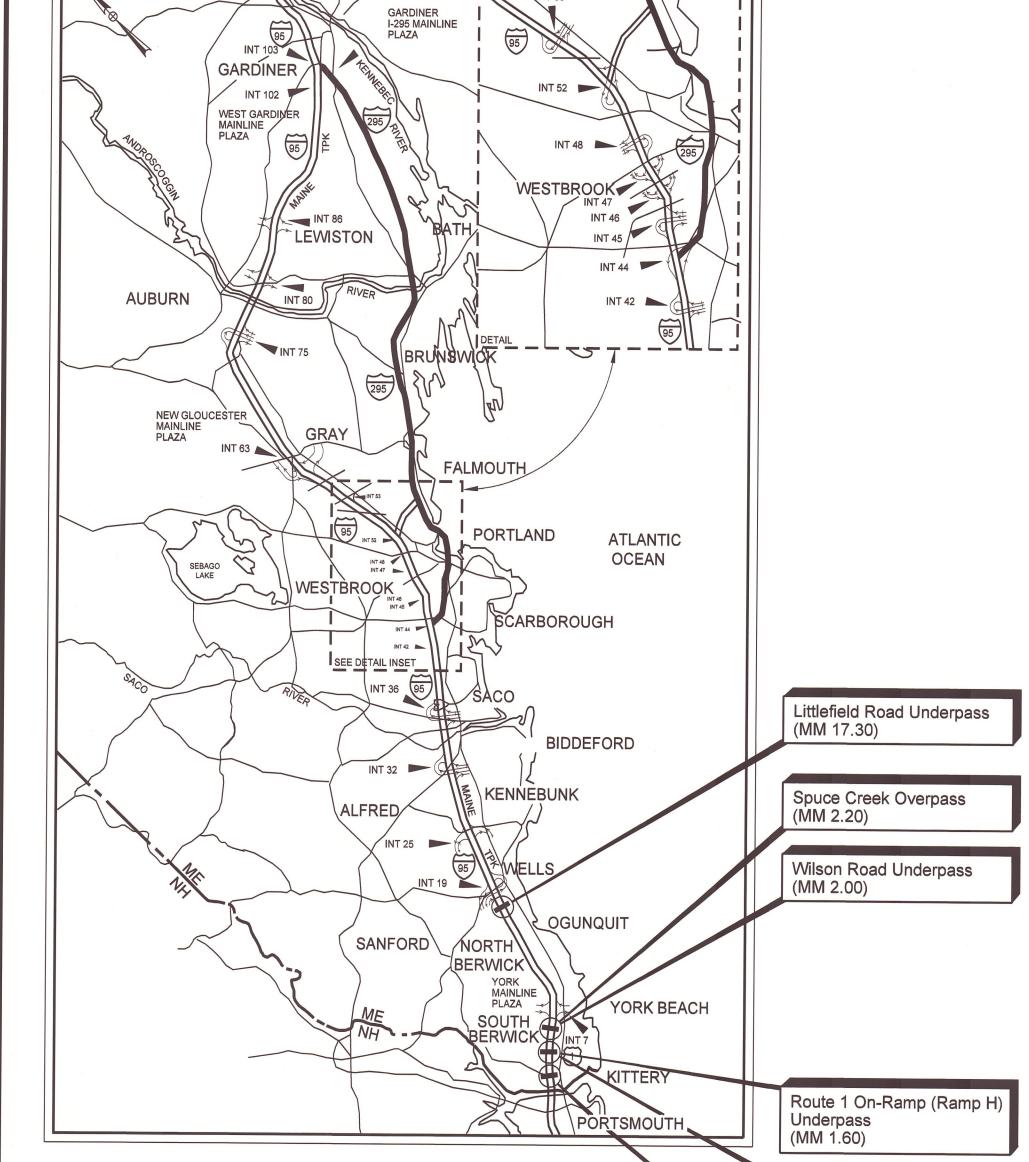

Route 236 Underpass (MM 1.25) APPROVED: MAINE TURNPIKE AUTHORITY 01-11-15

LOCATION MAP



ontract

INDEX OF SHEETS

Maintenance of Traffic Details (3 Sheets)

Structure 1 Route 236 Underpass Bridge

Structure 2 Ramp J Underpass Bridge

Structure 3 Ramp H Underpass Bridge

Structure 4 Wilson Road Underpass Bridge

Ramp J Detour Plan (1 Sheet) Ramp H Detour Plan (1 Sheet)

Concrete Repair Typical Details

Miscellaneous Details

General Plan and Elevation Bridge Typical Section

Abutment No. 1 Repairs Abutment No. 2 Repairs

Deck Underside Repairs **Bridge Joint Modifications**

General Plan and Elevation

Bridge Typical Section

Abutment No. 1 Repairs

Abutment No. 2 Repairs

General Plan and Elevation

Abutment No. 1 Repairs Abutment No. 2 Repairs

Bridge Joint Modifications

Bridge Typical Section

Pier No. 2 Repairs

Abutment No. 1 Repairs Abutment No. 2 Repairs Pier No. 1 Repairs

Bridge Joint Modifications (1 of 2)

Bridge Joint Modifications (2 of 2)

Structure 5 Spruce Creek Overpass Bridge

Slope Protection Repairs

Bridge Typical Section

Wingwall Repairs

Bridge Drain Details

NB Abutment No. 1 Repairs

SB Abutment No. 1 Repairs

NB Abutment No. 2 Repairs

Deck Underside Repairs

Bridge Joint Modifications

Bearing Pedestal Details (1 of 2)

Bearing Pedestal Details (2 of 2)

Structure 6 Littlefield Road Underpass Bridge

Bridge Rail Transition Details

General Plan and Elevation **Bridge Typical Section**

Abutment No. 1 Repairs

Abutment No. 2 Repairs

Slope Protection Repairs

Typical Roadway Sections Details and Sign Summary

General Plans (2 Sheets)

Cross Sections (15 Sheets)

General Notes and Construction Notes

Disturbance Impact Plans (2 Sheets)

Littlefield Road EVR Earthwork Summary

Fencing Details

Profiles (2 Sheets)

Typical Sections

Pier Repairs

Pier No. 2 Repairs

Wilson Road Detour Plan (1 Sheet)

Route 236 Maintenance of Traffic Details (8 Sheets)

Spruce Creek Maintenance of Traffic Details (20 Sheets) Littlefield Road Maintenance of Traffic Details (5 Sheets)

Title Sheet

Estimated Quantities


ESTIMATED QUANTITIES

|--|

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				CONSULTANT	PROJE(CT MANAGER:	G. Edington		
					Ву	Date		Ву	Date
				Designed	MÉB	10/29/21	Checked	GME	10/29/2
				Drawn	DPD	10/29/21	In Charge of	TSB	10/29/2

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ITEM NO.

615.07

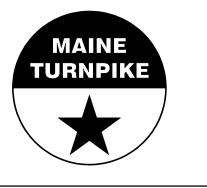619.1202

620.58

627.712

631.11

631.171

634.1612

639.19

*656.*75

659.10

631.36 Foreman

DESCRIPTION

Seeding Method Number 2

Erosion Control Geotextile

631.10 Air Compressor (including operator)

Field Office, Type B

645.109 Remove and Reset Sign

Mobilization

656.50 Baled Hay, in place

652.39 Work Zone Traffic Control

Air Tool (including operator)

631.12 All Purpose Excavator (including operator)

30 inch Temporary Silt Fence

830.17 Utility Conduit Hanger System Hardware

Truck - small (including operator)

White or Yellow Pavement Marking Line

Removal of Bridge & Highway Lighting Including Wire

Temporary Soil Erosion and Water Pollution Control

Regulatory, Warning, Confirmation and Route Assembly Sign, Type I

619,1201 Mulch - Plan Quantity

626.15 Electrical Serivce Box

629.05 Hand Labor, Straight Time

Temporary Mulch

THE GOLD STAR MEMORIAL HIGHWAY

MTA PROJECT NO. 2022.04 2022 SOUTHERN BRIDGE REPAIRS ESTIMATED QUANTITIES

SHEET NUMBER: VHB: 55345.00 CONTRACT: 2022.04

ESTIMATED QUANTITIES

UNIT

UNIT

LS

SY

LF

HR

HR

HR

HR

HR

HR

LS

EΑ

EΑ

SF

LS

EΑ

LF

LS

LS

LS

Route 1 | Route 1 | Wilson

2,250 870 850 1,320 470

Road

230

200

200

230

230

230

Spruce Littlefield Creek Road

Littlefield

430

36

36

57

33

30

1,620

Road EVR

Quantity

430

36

36

57

6,600

230

200

200

230

230

230

33

30

1,620

2 OF **117**

Route Off-Ramp On-Ramp

(Ramp J) (Ramp H

MTA PROJECT MANAGER: Ralph Norwood, IV

SPECIFICATIONS

Design: AASHTO LRFD Bridge Design Specifications, 2018.

Construction: State of Maine Department of Transportation Standard Specifications, 2014 Edition.

> State of Maine Department of Transportation Standard Details for Highways and Bridges, 2020 Edition, with all revisions thereto.

> AASHTO LRFD Bridge Construction Specifications, Fourth Edition

Structural Steel:

<u>NEW MATERIALS</u>
Concrete (Unless noted otherwise)Class AAA - Modified Reinforcing SteelASTM A6I5/A6I5M, Grade 60
Structural Steel: All Material (except as noted) ASTM A709/A709M, Grade 36 High Strength Bolts (except as noted) ASTM A325, Type I
BASIC DESIGN STRESSES (NEW MATERIALS)
Concrete f'c = 4,500 psi
Reinforcing Steel fy = 60,000 psi

ASTM A 709/A 709M, Grade 36..... Fy = 36,000 psi

ASTM A 325..... Fu = 120,000 psi

TRAFFIC AND DESIGN LOADING DATA

ROUTE 236 UNDERPASS BRIDGE

GENERAL CONSTRUCTION NOTES

- I. All details shall be in conformance with Maine Department of Transportation (MaineDOT) 2014 Standard Details for Highways and Bridges with all updates and MaineDOT Best Management Practices for Erosion and Sediment Control, latest revision unless otherwise noted in these plans.
- 2. All work must be completed within the Right of Way shown in these Plans.
- 3. The Contractor shall submit proposed staging area(s) and field trailer location to the Resident for approval prior to starting work.
- 4. Any portions of the existing bridges removed by the Contractor shall become the property of the Contractor. The steel portions of the existing bridges may be coated with a lead-based paint system. The Contractor is responsible for the containment, proper management and disposal of all lead-contaminated hazardous waste generated by the work of this project.
- 5. Copies of the As-Built plans are posted on the Maine Turnpike Authority website at www.maineturnpike.com/projects/construction-contracts. The completeness and accuracy of these plans is not guaranteed.
- 6. Chamfer all exposed new concrete edges $\frac{3}{4}$ " unless otherwise noted.
- 7. For all structures pigmented protective coating for concrete surfaces shall be applied to the following areas:
 - All exposed concrete surfaces of the piers, unless otherwise noted. - Exposed concrete surfaces of the abutments as shown in these plans.
- 8. For all structures clear protective coating for concrete surfaces shall be applied to the following areas:
 - All exposed bridge curbs, parapet and transition barriers,
 - All exposed median concrete.
 - All overhang and fascia concrete as shown in these plans.
- 9. For all structures the bridge seat shall be cleaned before applying pigmented protective coating.
- 10. The Contractor shall place approach pavement at all locations to achieve a smooth transition between existing and proposed pavement.

EROSION CONTROL NOTES

I. All temporary and permanent erosion control devices shall be installed in accordance with the Maine Department of Transportation Best Management Practices.

UTILITIES NOTES

- I. Existing utilities on these plans were compiled from existing plans and various other sources. Locations are not guaranteed to be accurate nor is it guaranteed that all utilities are shown. No separate or additional compensation will be allowed to the Contractor due to any variance between the data shown on the plans and the actual field conditions encountered. No work shall be started until the owners of the various utilities are notified by the Contractor of the proposed construction. The Contractor is also required to call Dig Safe at I-888-344-7233 at least 72 hours prior to the start of the work.
- 2. The Maine Turnpike Authority is a non-member utility operator and is not registered with the Dig Safe system. The contractor shall contact all non-members through www.OKtoDIG.com or as otherwise required by the Maine Public Utilities Commission. All proposed excavation locations shall be marked at the time of notification. No excavation shall be permitted until the authority has located and marked it's underground utilities. The Resident Engineer shall be provided an electronic copy of all Dig Safe tickets within 24 hours of their release for project notifications and 3rd party utility locater coordination.
- 3. The anticipated utilities involved in this contract are: Central Maine Power Company Charter Communications, Inc. Consolidated Communications Kennebunk, Kennebunkport & Wells Water District

CONTRACT: 2022.04

4. Contractor shall protect all new and existing utilities from damage during the construction as approved by the utility owners.

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١	No.	Revision	Ву	Date				VII	U	
					CONSULTANT	PROJEC	CT MANAGER:	G. Edington		
						Ву	Date		Ву	Date
					Designed	MÉB	10/29/21	Checked	GME	10/29/2
					Drawn	DPD	10/29/21	In Charge of	TSB	10/29/2

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THE GOLD STAR MEMORIAL HIGHWAY

MTA PROJECT NO. 2022.04 2022 SOUTHERN BRIDGE REPAIRS GENERAL NOTES

SHEET NUMBER: VHB: 55345.00

MTA PROJECT MANAGER: Ralph Norwood, IV

3 OF **117**

- 2. Spruce Creek Overpass Temporary Traffic Control: Each traffic control phase includes the anticipated work during that phase. After the completion of all phased construction, it is anticipated the Contractor will conduct the mill and overlay work with lane closures in accordance with the layouts described in Note I.
- 3. Littlefield Road Emergency Vehicle Ramps (EVR) Temporary Traffic Control: The maintenance of traffic plan for the construction of the Littlefield EVRs will include Turnpike and Littlefield Road shoulder closures and lane closures as needed in accordance with the layouts described in Note I.
- 4. All orange construction signs shall be fluorescent orange with Type VIII, IX or XI sheeting. Placement of signs shall be adjusted to avoid obstructing existing signs and to ensure proper sight lines to the construction signs as determined by the Resident and shall be new or in like new condition.
- 5. Temporary lane closures will be required, with advanced approval, whenever work will occur within four feet of the I-95 traveled way. Temporary lane closures shall be removed if no work is occurring. See Special Provisions for more information.
- 6. All lane closures shall require approval from the Maine Turnpike Authority through the Resident. The Resident is required to submit a request for lane closures by noon on Thursday for any lane closures needed for the following week. The Contractor shall plan the work and requests for lane closures accordingly.
- 7. In the event that lane closure(s) begin to cause back-ups in through traffic of more than five minutes, the Contractor shall deploy the additional signs as indicated in the single lane closure set-up details.
- 8. Approach ends of temporary concrete barrier shall be placed outside of the highway clear zone (minimum 34 feet from the traveled way along I-95) or protected by temporary impact attenuators or with guardrail overlaps as approved by the Resident.
- 9. Maximum spacing for channelizing devices (drums) shall be: 80' on center along tangents 40' on center along tapers
- 10. Work Zone Speed Limits shall only be permitted when temporary lane closures are in place.
- II. The indicated signs and sign quantities in these plans are approximate for the Contractor's information only.

 The Contractor is responsible for providing all traffic control devices, including all signing in the quantities required to accommodate their approved traffic control plans.

LOCAL ROAD SINGLE LANE CLOSURE/SHOULDER CLOSURE

	CON	STRUCT	ION SIC	GN SUMN	IARY
		Text Dimensions (Inches)		Size	
	Sign		Letter Vertical Height Spacing		Quantity and Color
G20-2	END ROAD WORK	Text Dimensions Shall Conform to "Standard Highway		36"x18"	2 - Black on Orange
W20-I	ROAD WORK AHEAD	Signs"	- 2012 	36"x36"	2 - Black on Orange
W20-4	ONE LANE ROAD AHEAD			36"x36"	2 - Black on Orange
W20-7		,		36" x 36"	2 - Black on Orange

STABILIZED CONSTRUCTION ENTRANCE

CON	STRUCT	ION SIC	GN SUMN	IARY					
Cina	Text Dimensions (Inches) Letter Vertical Height Spacing		Size	Ouratity and Onlan					
Sign				Quantity and Color					
G20-2 END ROAD WORK	Text Dimensions Shall Conform to "Standard Highway		48"x24"	I - Black on Orange					
W7-3aP NEXT NEXT X MILES	Signs" - 2012		36"x30"	I - Black on Orange					
W20-I (AHE AD)			48" x 48"	2 - Black on Orange					
W21-5 SHOULDER WORK			48" x 48"	I - Black on Orange					
CS-10 TRUCKS ENTERING	•		48"×48"	I - Black on Orange					

ABBREVIATIONS FOR ALL WORK ZONE PLANS

BWLL = BROKEN WHITE LANE LINE SWEL = SOLID WHITE EDGE LINE SYEL = SOLID YELLOW EDGE LINE

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500 Southborough Dr.
Suite 105B

South Portland, ME 04106
TEL (207) 889-3150
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THE GOLD STAR MEMORIAL HIGHWAY MTA PROJECT NO. 2022.04 2022 SOUTHERN BRIDGE REPAIRS

MAINTENANCE OF TRAFFIC DETAILS (1 OF 3)

VHB: 55345.00 SHEET NUMBER: 4
CONTRACT: 2022.04 4 OF 117

MTA PROJECT MANAGER: Ralph Norwood, IV

TURNPIKE SHOULDER CLOSURES (INCLUDING SPRUCE CREEK PHASES 1 & 2)

CONSTRUCTION SIGN SUMMARY							
COIV	SIRUCI	1010 510	71V <i>SU IVI I</i> I	//AM			
Sign	Text Dim (Inc.		Size	Quantity and Color			
Sign	Letter Height			addining and color			
G20-2 END ROAD WORK	Text Dimensions Shall Conform to "Standard Highway		48"x24"	4 - Black on Orange			
W20-I (AHEAD)	Signs"	- 2012	48" x 48"	6 - Black on Orange			
W21-5aL LEFT SHOULDER CLOSED 1000 FT			48" x 48"	4 - Black on Orange			
W21-5aR RIGHT SHOULDER CLOSED 1000 FT			48" x 48"	4 - Black on Orange			
W21-5bL LEFT SHOULDER CLOSED			48" x 48"	4 - Black on Orange			
W21-5bR RIGHT SHOULDER CLOSED			48" x 48"	4 - Black on Orange			
W2I-5bL (500) LEFT SHOULDER CLOSED 500 FT			48" x 48"	4 - Black on Orange			
W2I-5bR RIGHT SHOULDER CLOSED 500 FT			48" x 48"	4 - Black on Orange			

TEMPORARY SINGLE AND DOUBLE LANE CLOSURES (INCLUDING SPRUCE CREEK PHASES IA, 2A & 2B)

	CON	STRUCT	ION SIG	GN SUMN	IARY
	Sign	(Inc	nensions hes)	Size	Quantity and Color
		Letter Vertical Height Spacing			
CS-3	EXPECT STOPPED TRAFFIC	7" 7" 7"	4" 4"	48" x 48"	4 - Black on Orange
G20-2	END ROAD WORK	Shall C to "Sto High		48"x24"	4 - Black on Orange
G20-5aP	WORK ZONE	Signs*	- 2012 	36"x24"	5 - Black on Orange
R2-I(35)	SPEED LIMIT 35			48" x60"	I - Black on White
R2-I(60)	SPEED LIMIT 60			48"x60"	4 - Black on White
R2-6aP	FINES DOUBLE			36"x24"	5 - Black on White
R2-12	END WORK ZONE SPEED LIMIT			36"x54"	4 - Black on White
W3-2				48" x 48"	2 - Black on Orange
W3-4	BE PREPARED TO STOP			48" x 48"	4 - Black on Orange
W3-5(35)	SPEED			48" x 48"	I - Black on Orange
W3-5(60)	SPEED LIMIT 60			48" x 48"	4 - Black on Orange
W4-2L				48" x 48"	8 - Black on Orange
W4-2R				48" x 48"	4 - Black on Orange
W13-4P	ON RAMP	,		36" x 36"	I - Black on Orange

TEMPORARY SINGLE AND DOUBLE LANE CLOSURES CONTINUED (INCLUDING SPRUCE CREEK PHASES IA, 2A & 2B)

	CON	STRUCT	ION SIC	GN SUMM	'ARY
Sign		(Inc	vertical	Size	Quantity and Color
W8-I	BUMP	Shall C to "Sta	Spacing mensions Conform andard hway	48" x 48"	8 - Black on Orange
W8-24a	RUMBLE STRIP AHEAD		- 2012 	48" x 48"	4 - Black on Orange
W20-I	ROAD WORK 1 MILE			48" x 48"	4 - Black on Orange
W2O-I (AHEAD)	ROAD WORK AHEAD			48"x48"	2 - Black on Orange
W20-5a	LEFT LANES CLOSED 1/2 MILE			48" x 48"	4 - Black on Orange
W20-5a (AHE AD)	LEFT LANES CLOSED AHEAD			48" x 48"	2 - Black on Orange
W20-5L	LEFT LANE CLOSED 1/2 MILE			48" x 48"	4 - Black on Orange
W20-5R	RIGHT LANE CLOSED 1/2 MILE			48" x 48"	4 - Black on Orange
W20-5L (AHEAD)	LEFT LANE CLOSED AHEAD			48" x 48"	I - Black on Orange
W2O-5R (AHEAD)	RIGHT LANE CLOSED AHEAD			48" x 48"	2 - Black on Orange
CS-4	SINGLE LANE RAMP AHEAD	,		48" x 48"	I - Black on Orange

Scale: NOT TO SCALE

No. Revision

By Date

CONSULTANT PROJECT MANAGER: G. Edington

By Date

Designed MLG 10/29/21 Checked MDS 10/29/21

Drawn JAR 10/29/21 In Charge of TSB 10/29/21

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South Portland, ME 04106

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THE GOLD STAR MEMORIAL HIGHWAY


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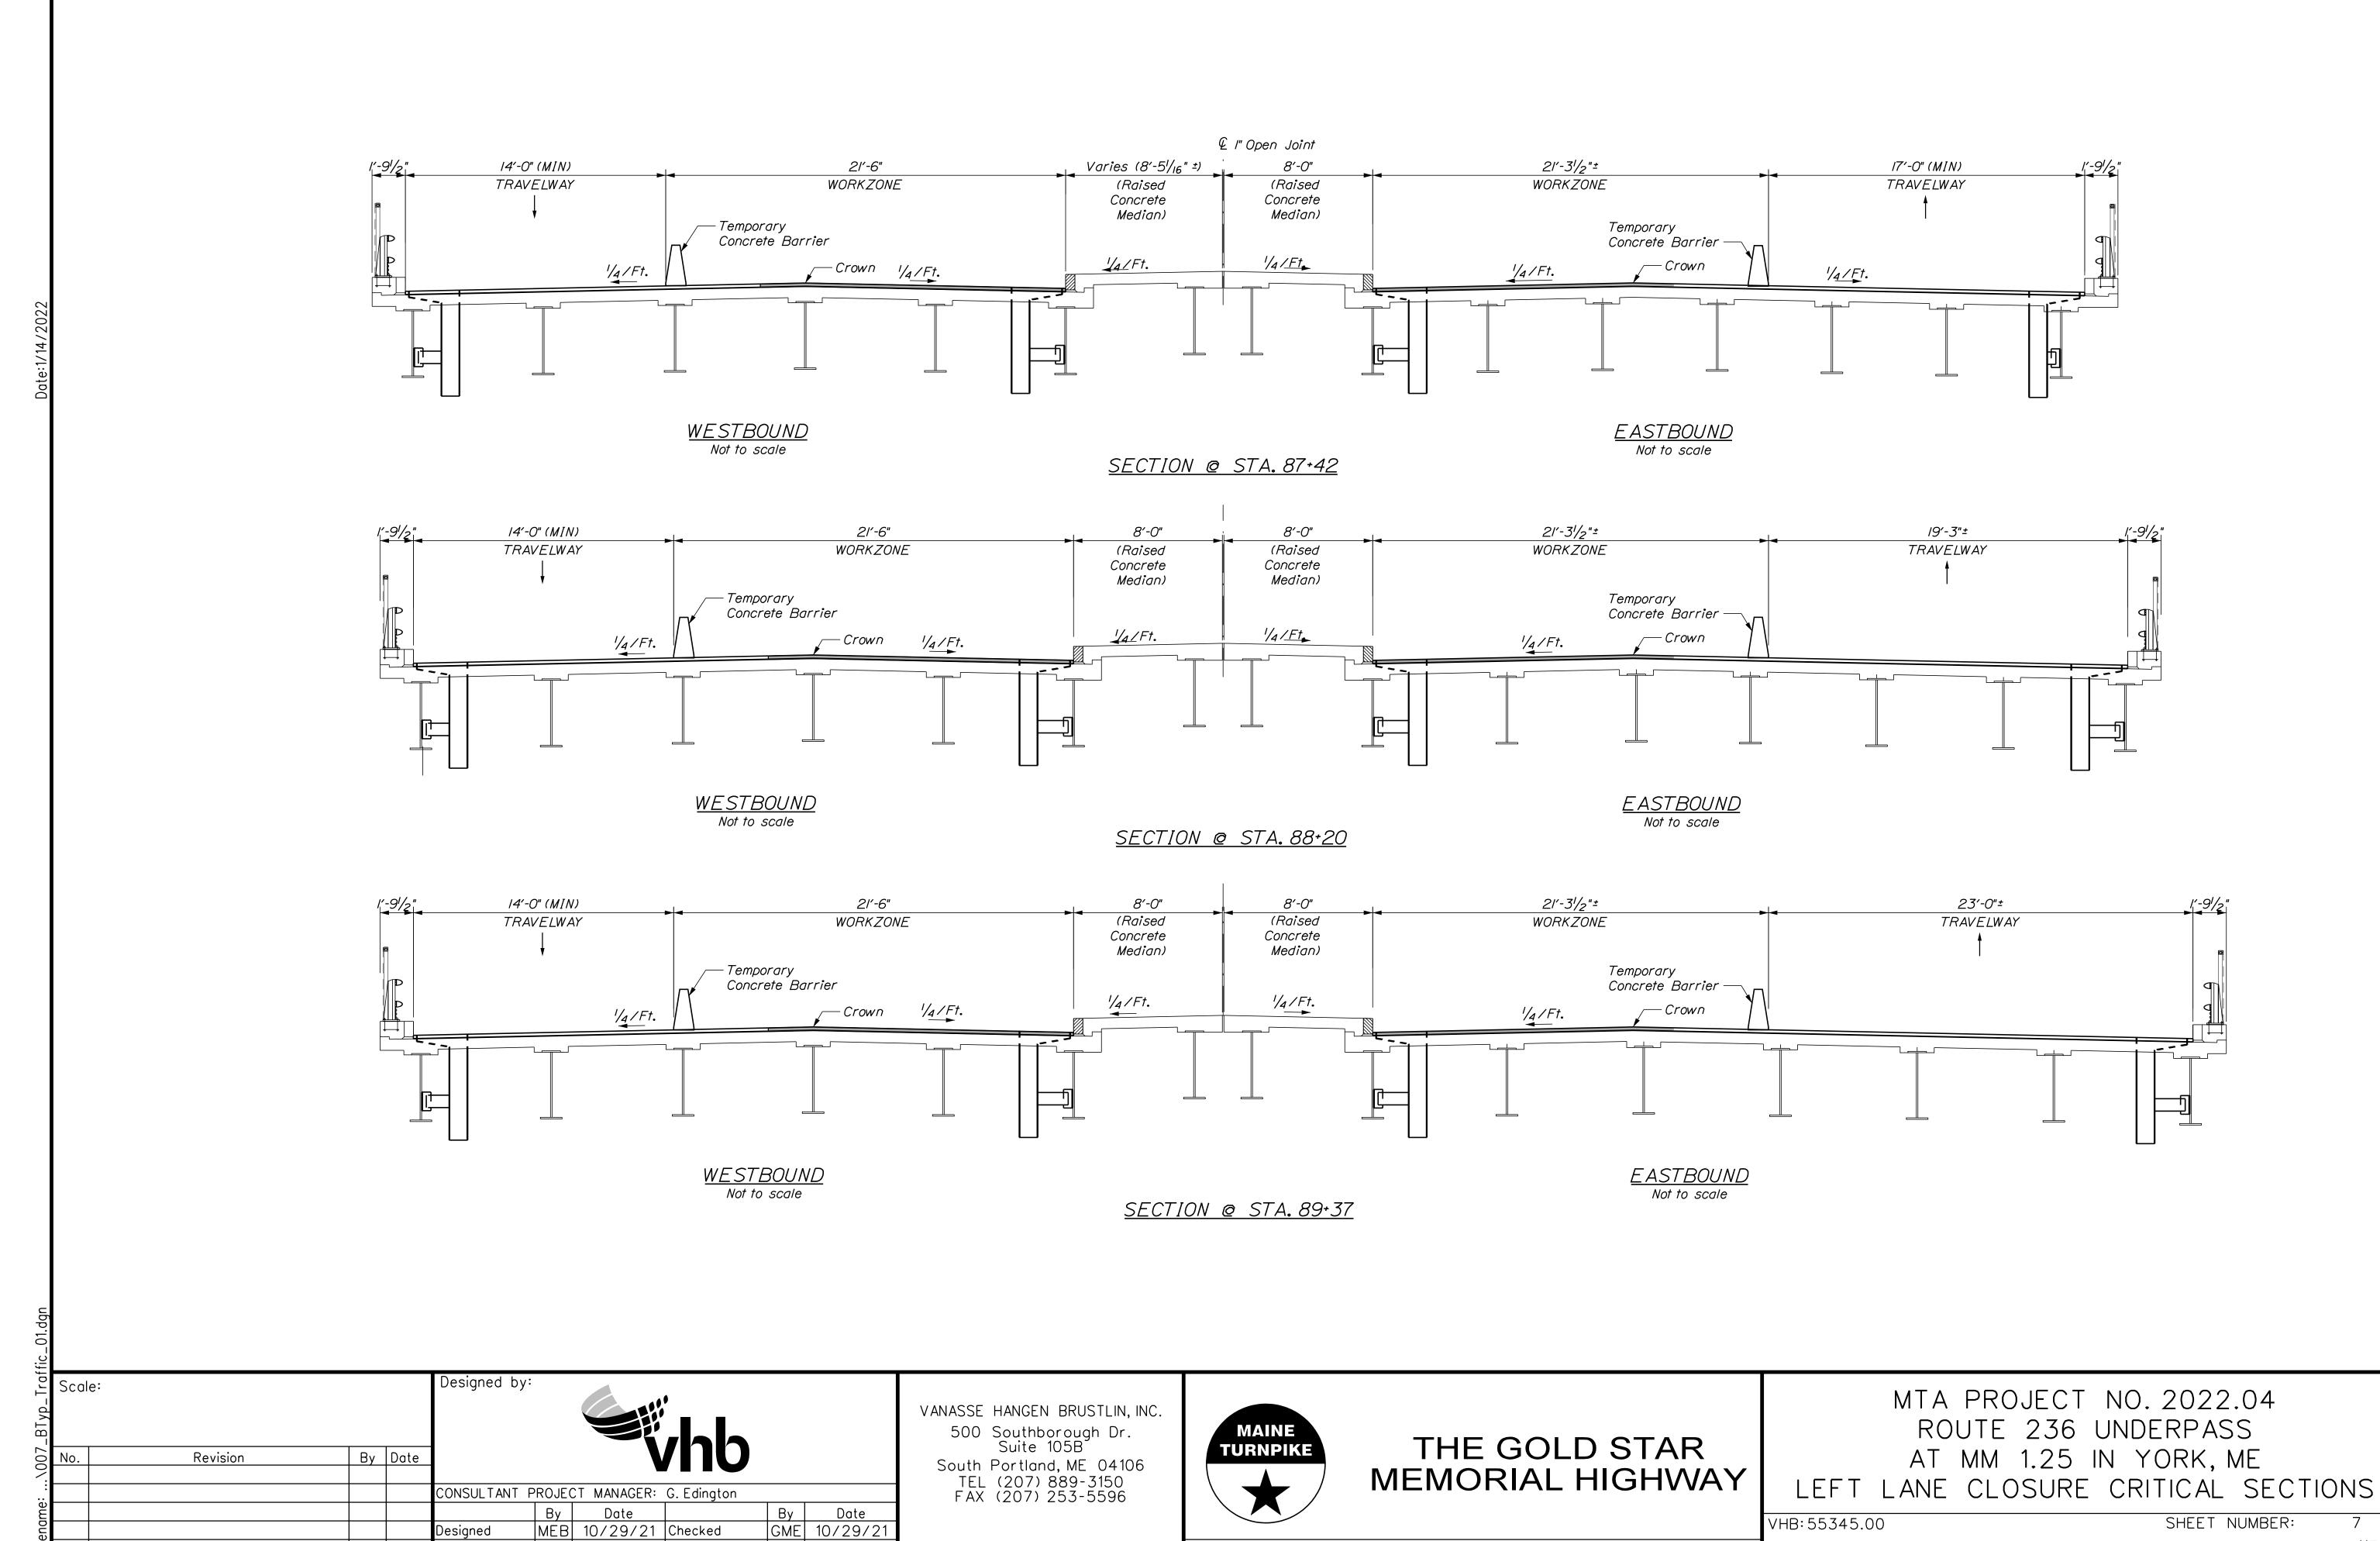
MAINTENANCE OF TRAFFIC DETAILS (2 OF 3)

VHB: 55345.00 SHEET NUMB
CONTRACT: 2022.04

MTA PROJECT MANAGER: Ralph Norwood, IV

SHEET NUMBER: 5
5 OF 117



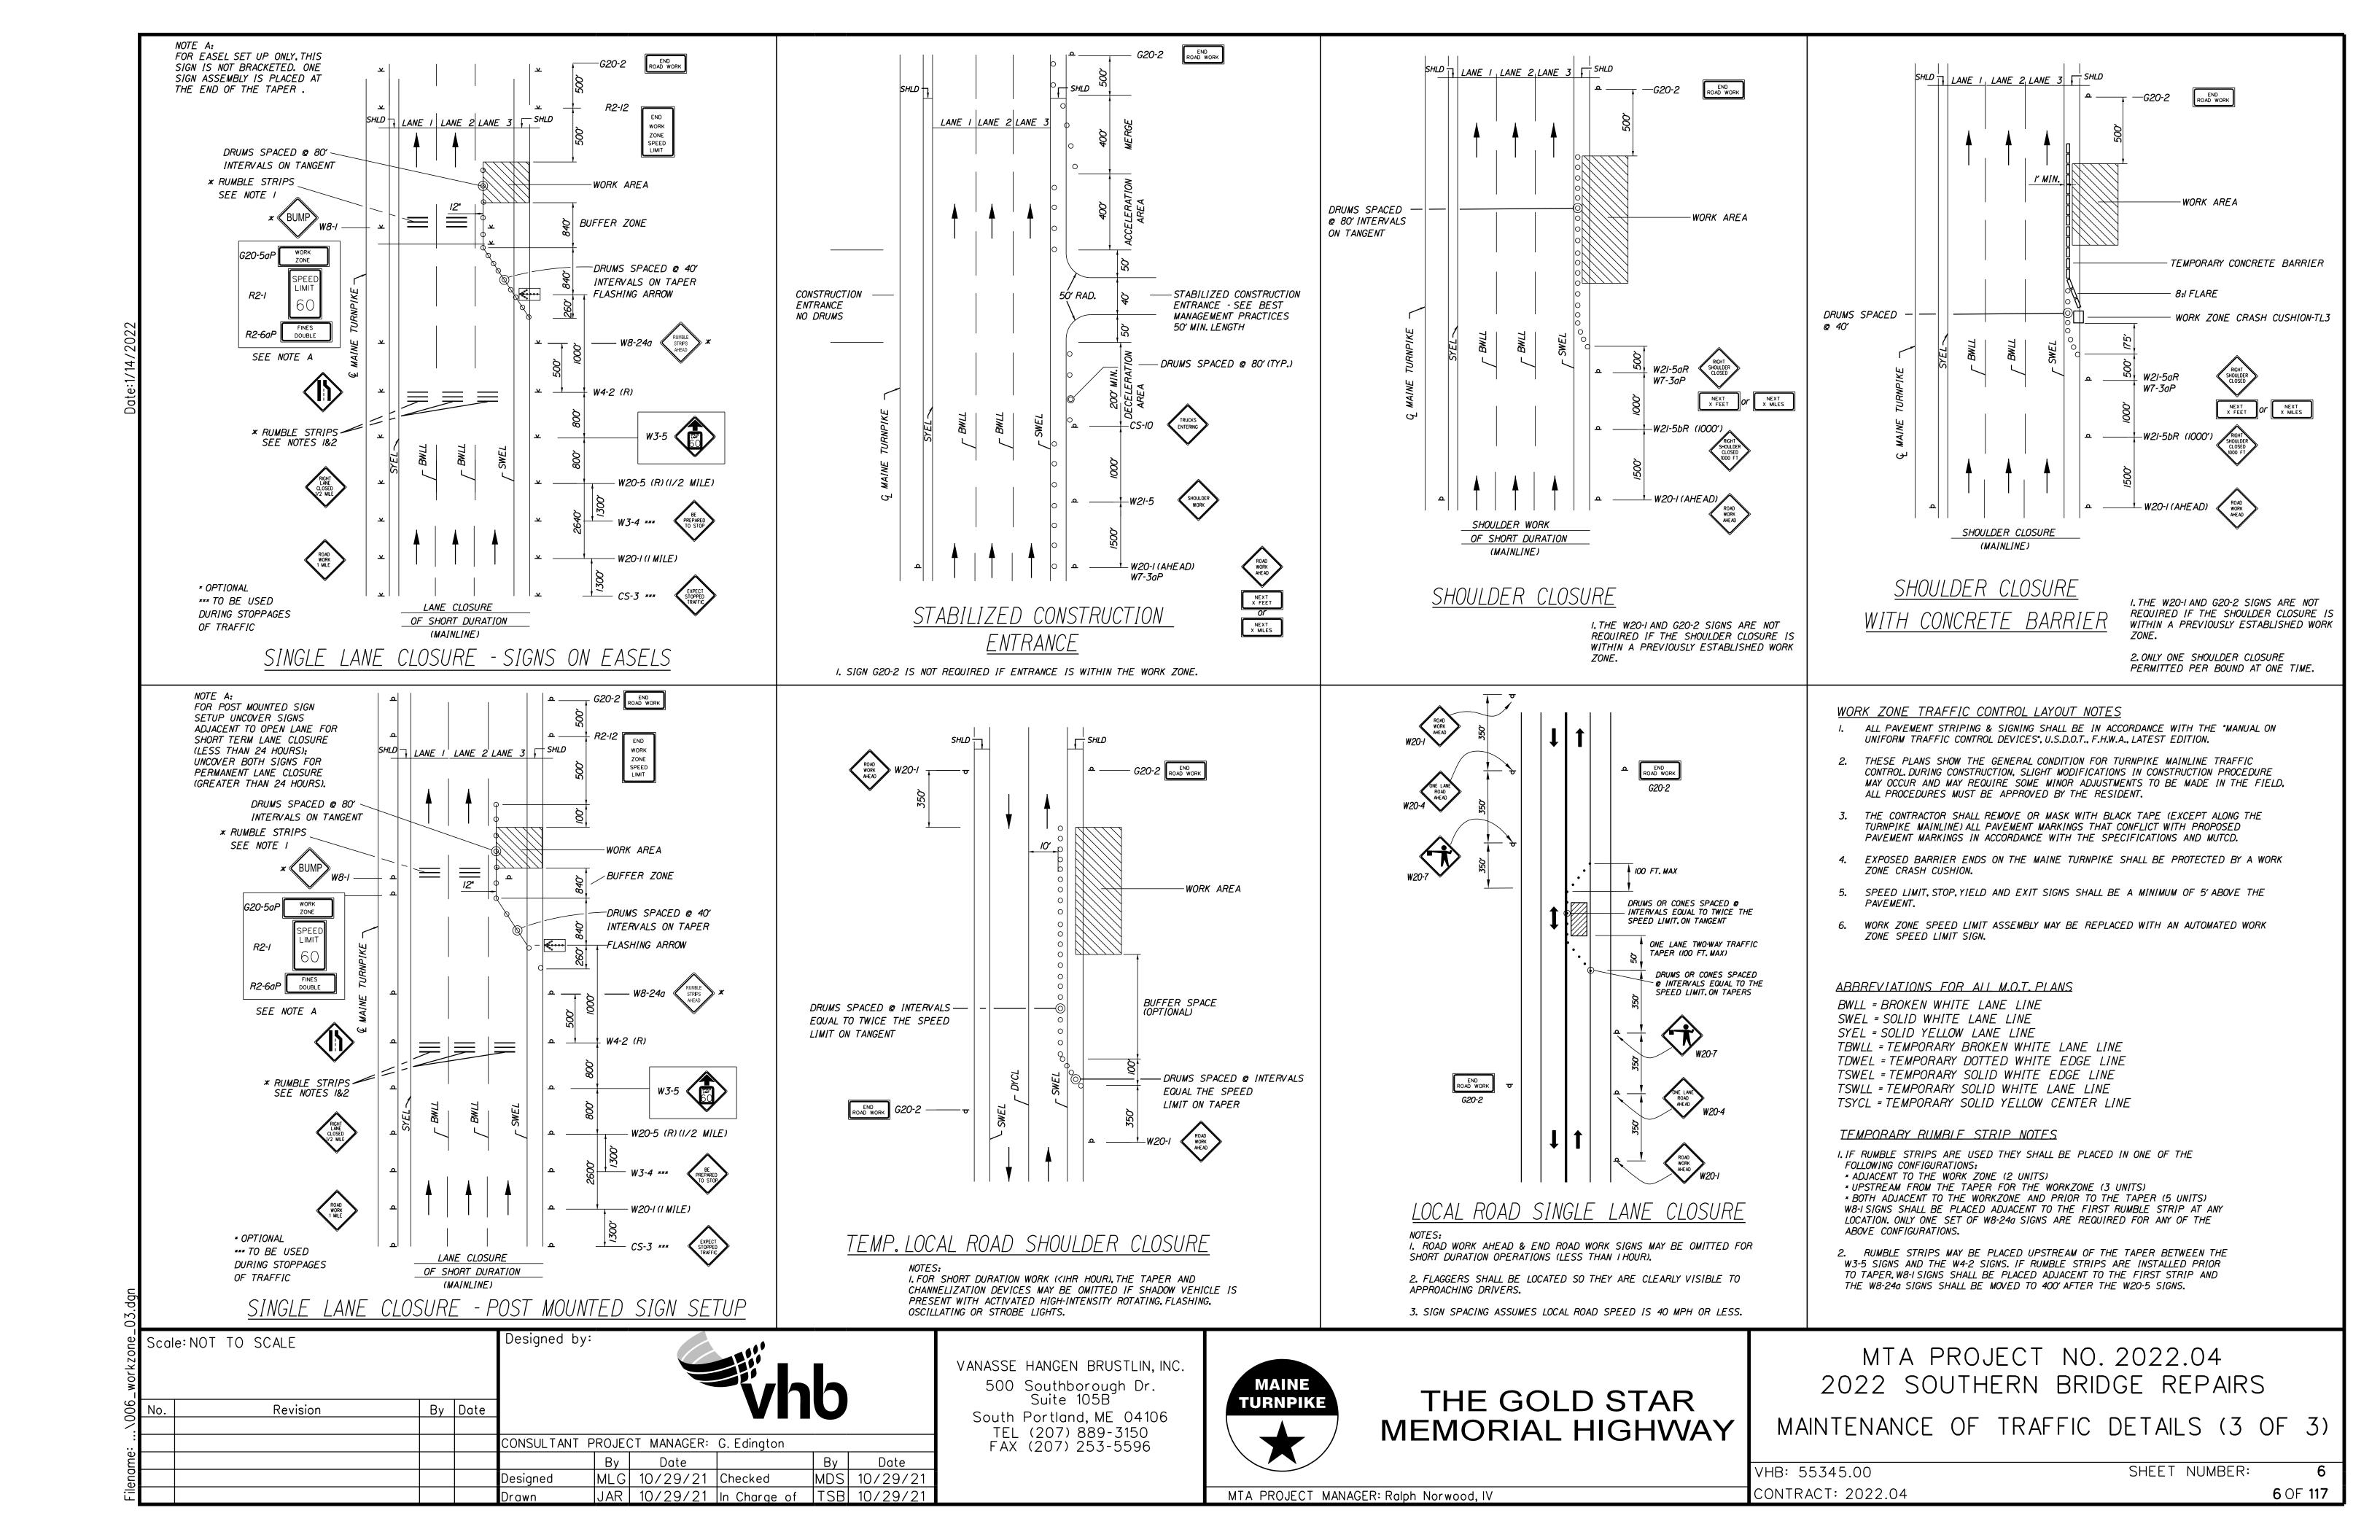


MEB 10/29/21 Checked

DPD 10/29/21 In Charge of TSB 10/29/21

Designed

SHEET NUMBER: VHB: 55345.00 CONTRACT:2022.04 7 OF **117** MTA PROJECT MANAGER: RALPH C. NORWOOD, IV

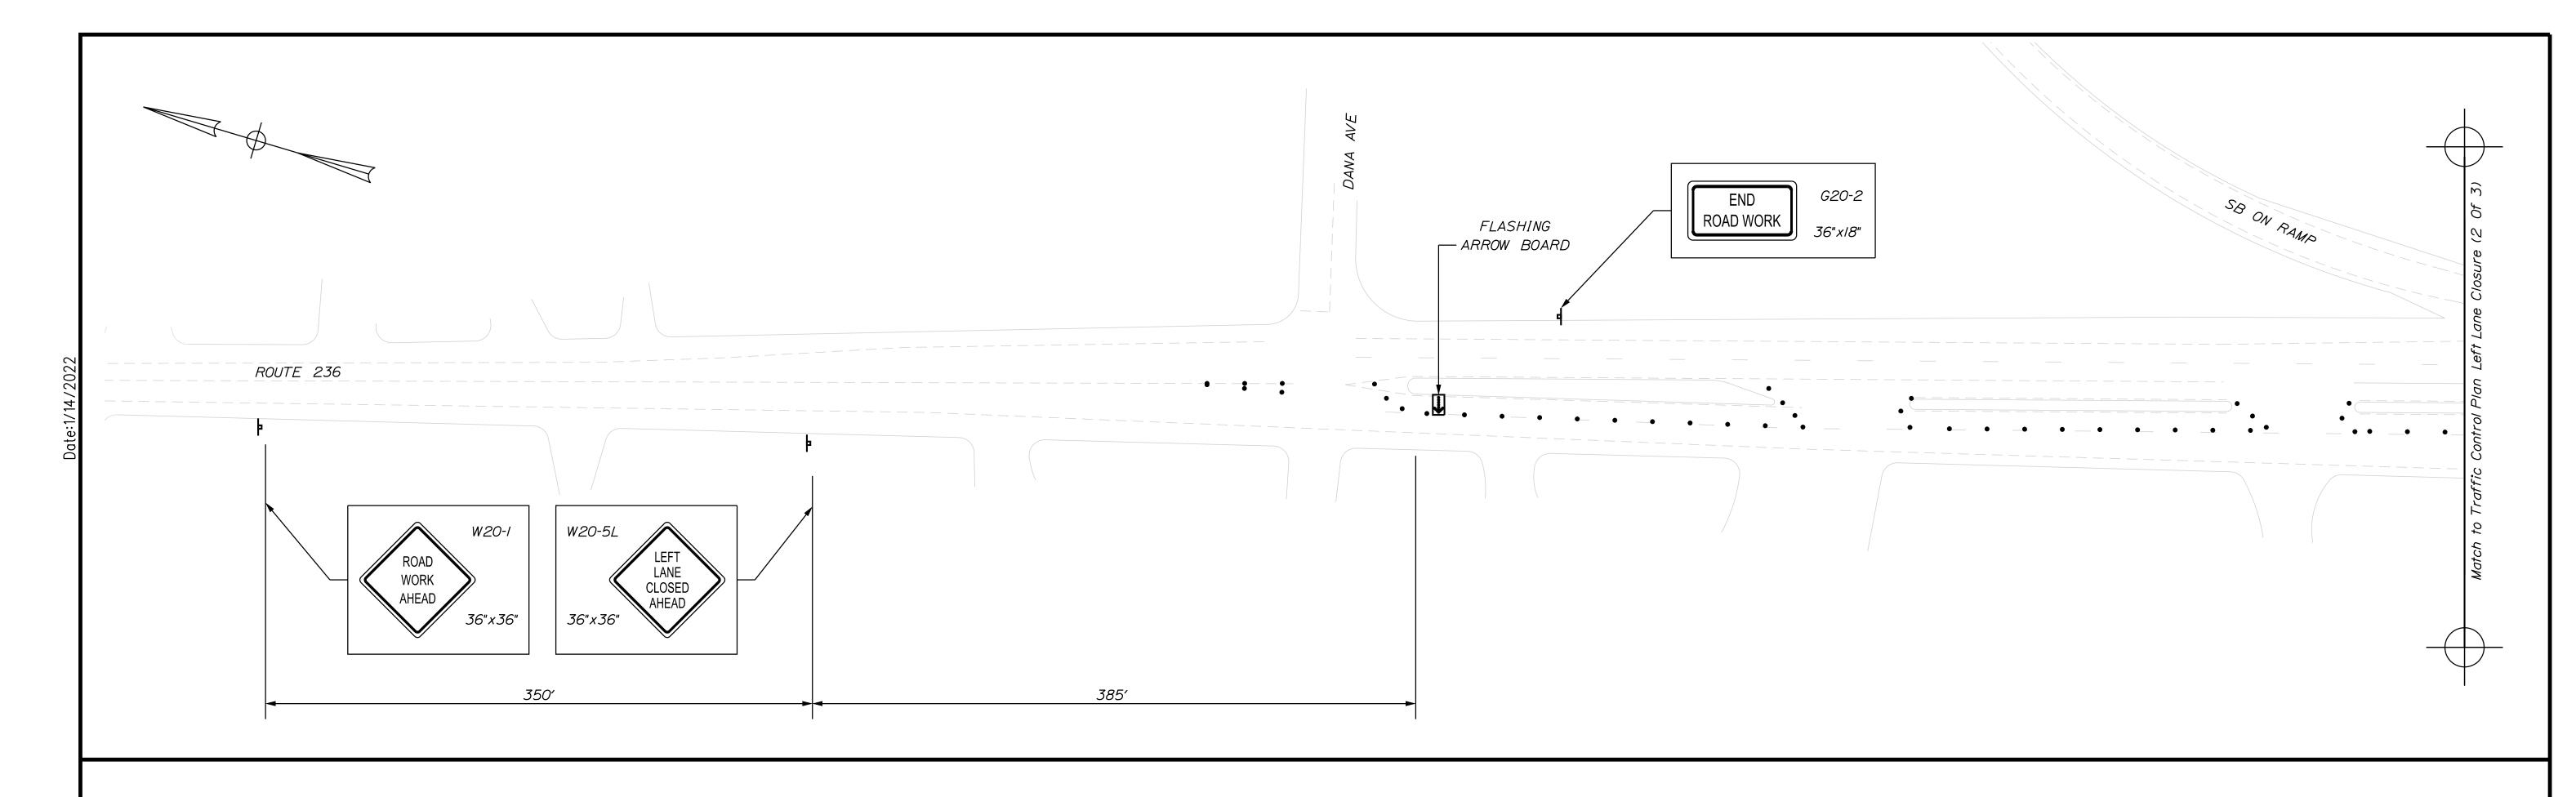

ROUTE 236 LEFT LANE AND MEDIAN CLOSURE

		CTDUCT	ION CI		IAA DY
	CON	SIRULI	1011 510	GN SUMM	MARY
Sign		Text Dimensions (Inches)			Overetity and Color
		Letter Height	Vertical Spacing	Size	Quantity and Color
CS-3	EXPECT STOPPED TRAFFIC	7" 7" 7" 4"		48" x 48"	I - Black on Orange ∗
G20-2	END ROAD WORK	Text Dimensions Shall Conform to "Standard Highway		36"x18"	2 - Black on Orange
RI-I	STOP	Signs"	Signs" - 2012		2 - Red on White
RI-2	YIELD			36"x36"x 36"	I - Red on White
WI-4R				36"x36"	4 - Black on Orange
W3-1				48" x 48"	2 - Black/Red on Orange

STRUCT	ION SIG	ON SUMN	IARY
Text Dimensions (Inches) Letter Vertical Height Spacing			
		SiZe	Quantity and Color
Text Dimensions Shall Conform to "Standard Highway		48" x 48"	I - Black on Orange ∗
Signs"	- 2012	36"×36"	I - Black on Orange
		36"x36"	2 - Black on Orange
		48"x48"	6 - Black on Orange
		36"x36"	I - Black on Orange
	Text Din (Inc Letter Height Text Din Shall C to "Sta	Text Dimensions (Inches) Letter Vertical Height Spacing Text Dimensions Shall Conform	Letter Vertical Spacing Text Dimensions Shall Conform to "Standard Highway Signs" - 2012 36"x36" 48"x48"

* See Special Provision Section 652 for Requirements for the Use of CS-3 and W3-4

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No.	Revision	Ву	Date	1					
				CONSULTANT F	PROJEC	CT MANAGER:	G. Edington		
					Ву	Date		Ву	Date
				Designed	MÉB	10/29/21	Checked	GME	10/29/2
				Drawn	DPD	10/29/21	In Charge of	TSB	10/29/2

<u>LEGEND</u>

Type 3 Barricade with Detour Sign

Detour Sign on Post Support

Type 3 Barricade

Flashing Arrow Board

• • • • Channelizing Device

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THE GOLD STAR


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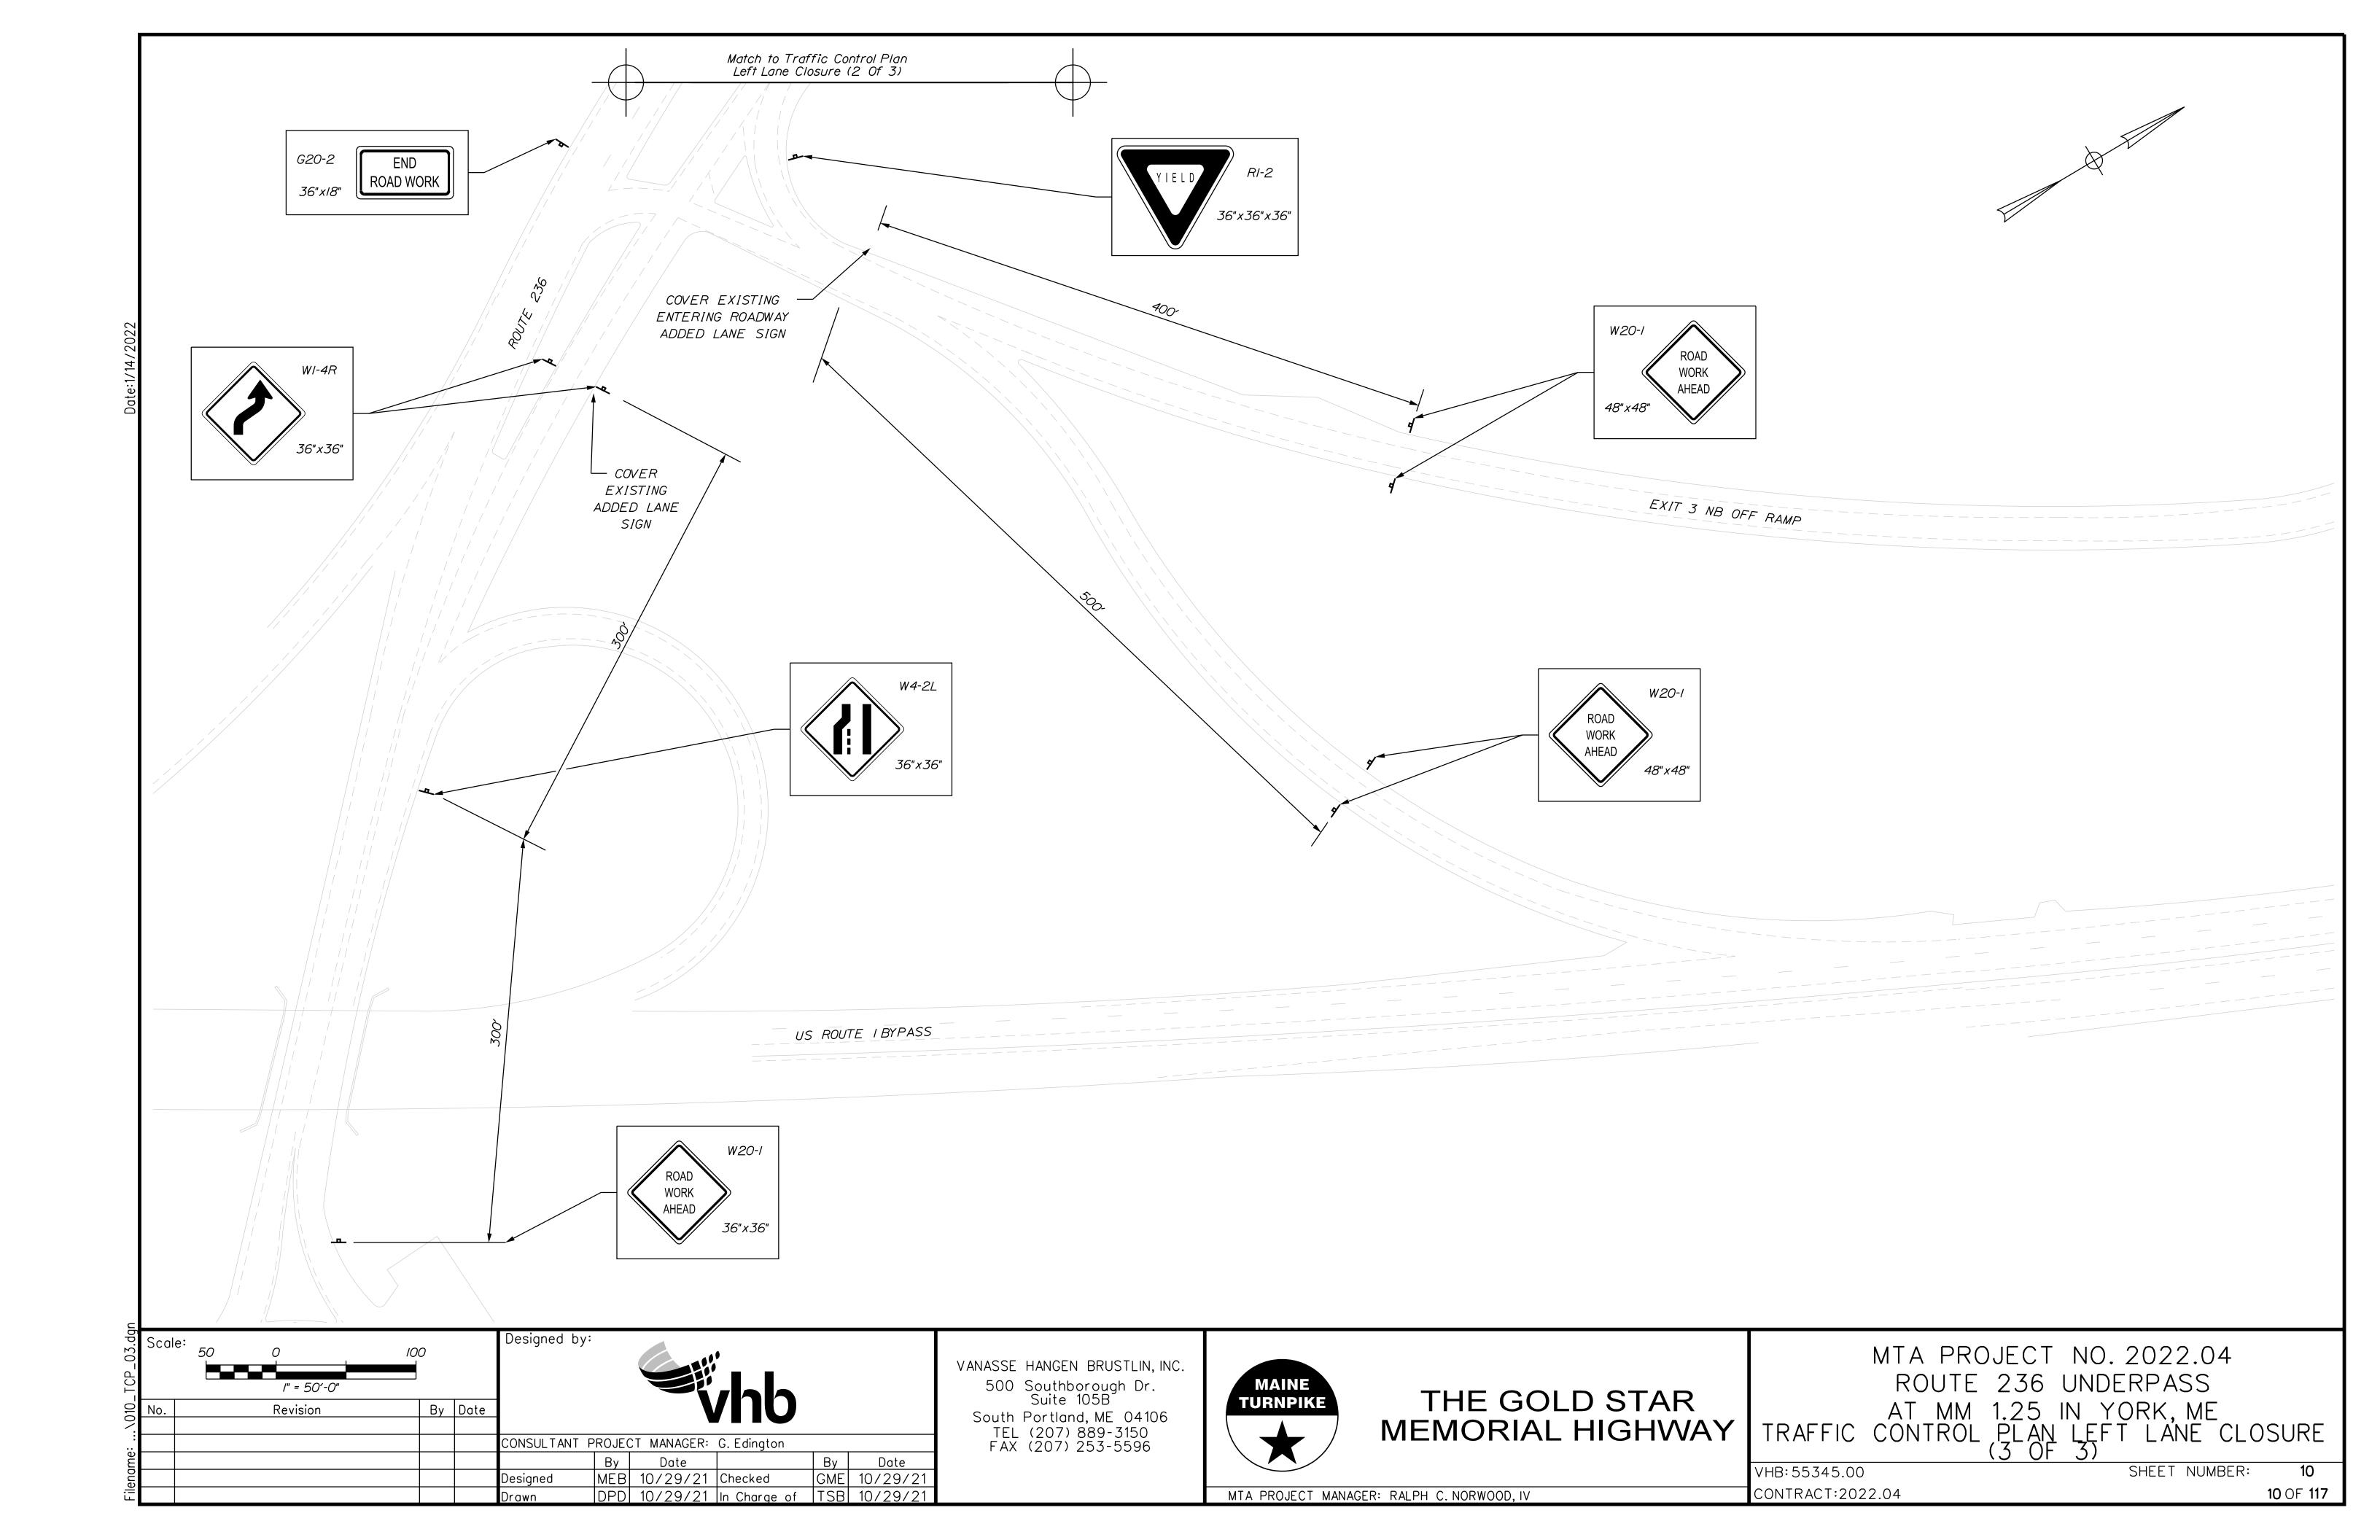
MEMORIAL HIGHWAY


TRAFFIC CONTROL PLAN LEFT LANE CLOSURE (1 OF 3) VHB: 55345.00 SHEET NUMBER:

MTA PROJECT MANAGER: RALPH C. NORWOOD, IV

CONTRACT:2022.04 **8** OF **117**



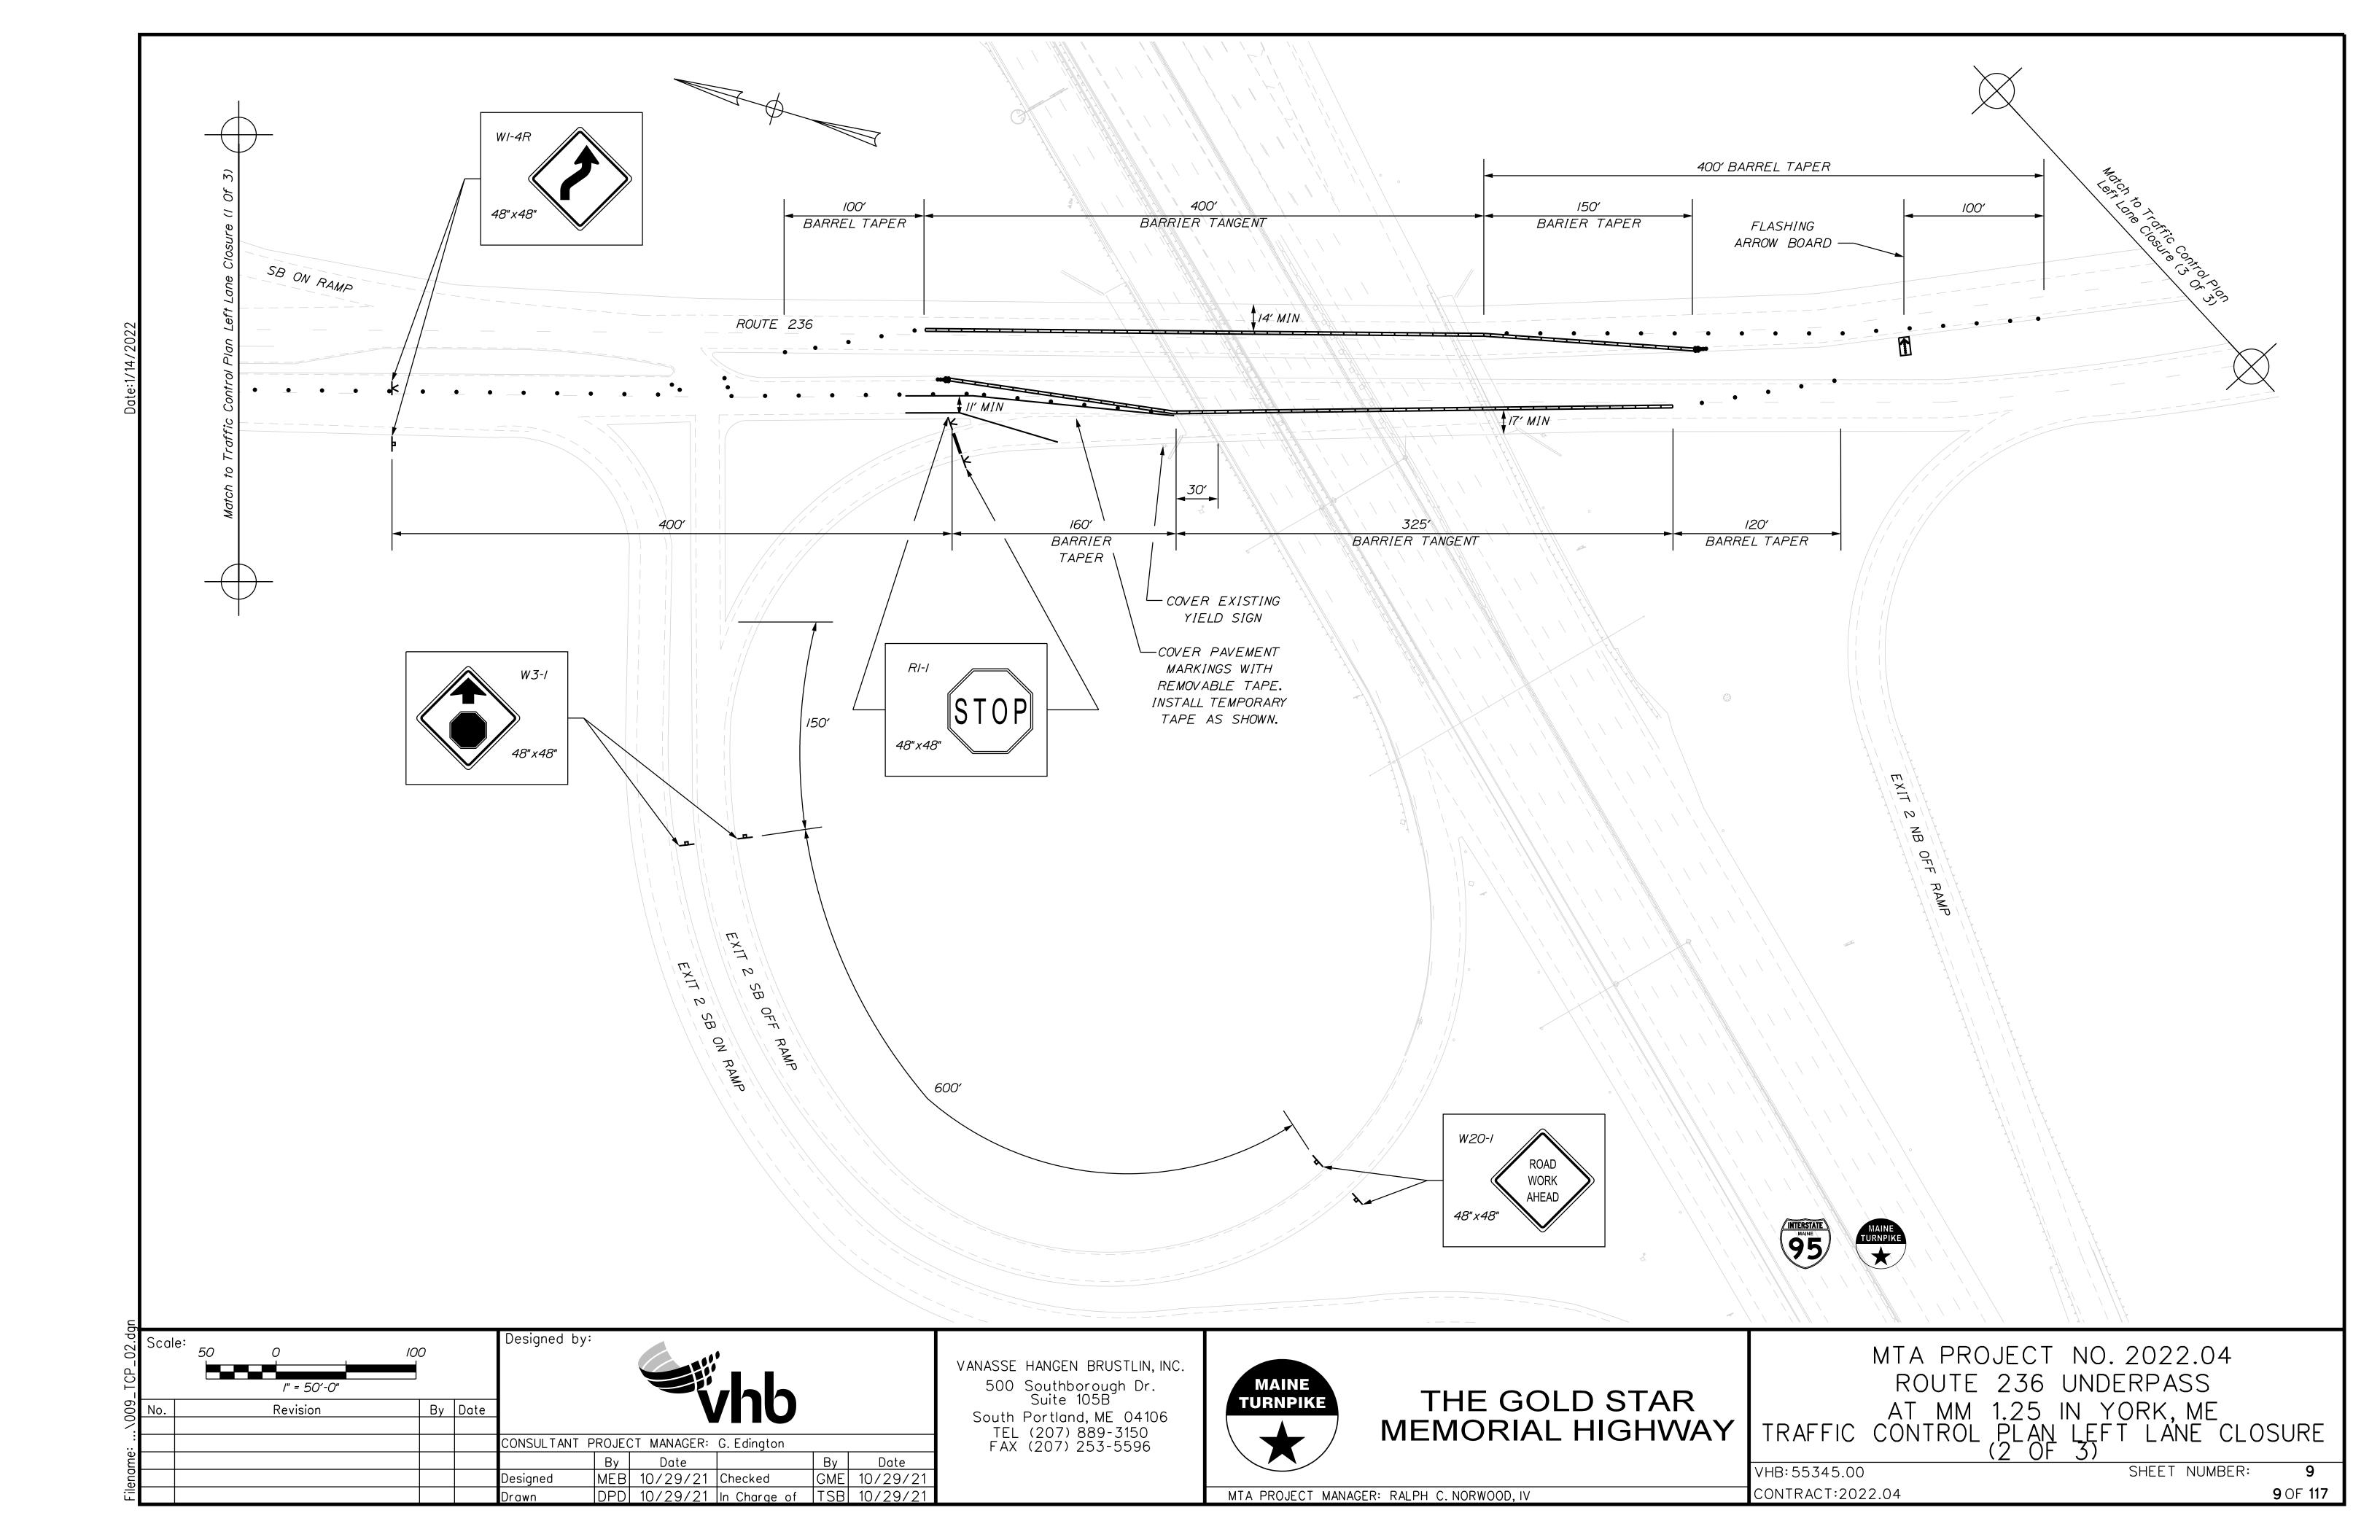

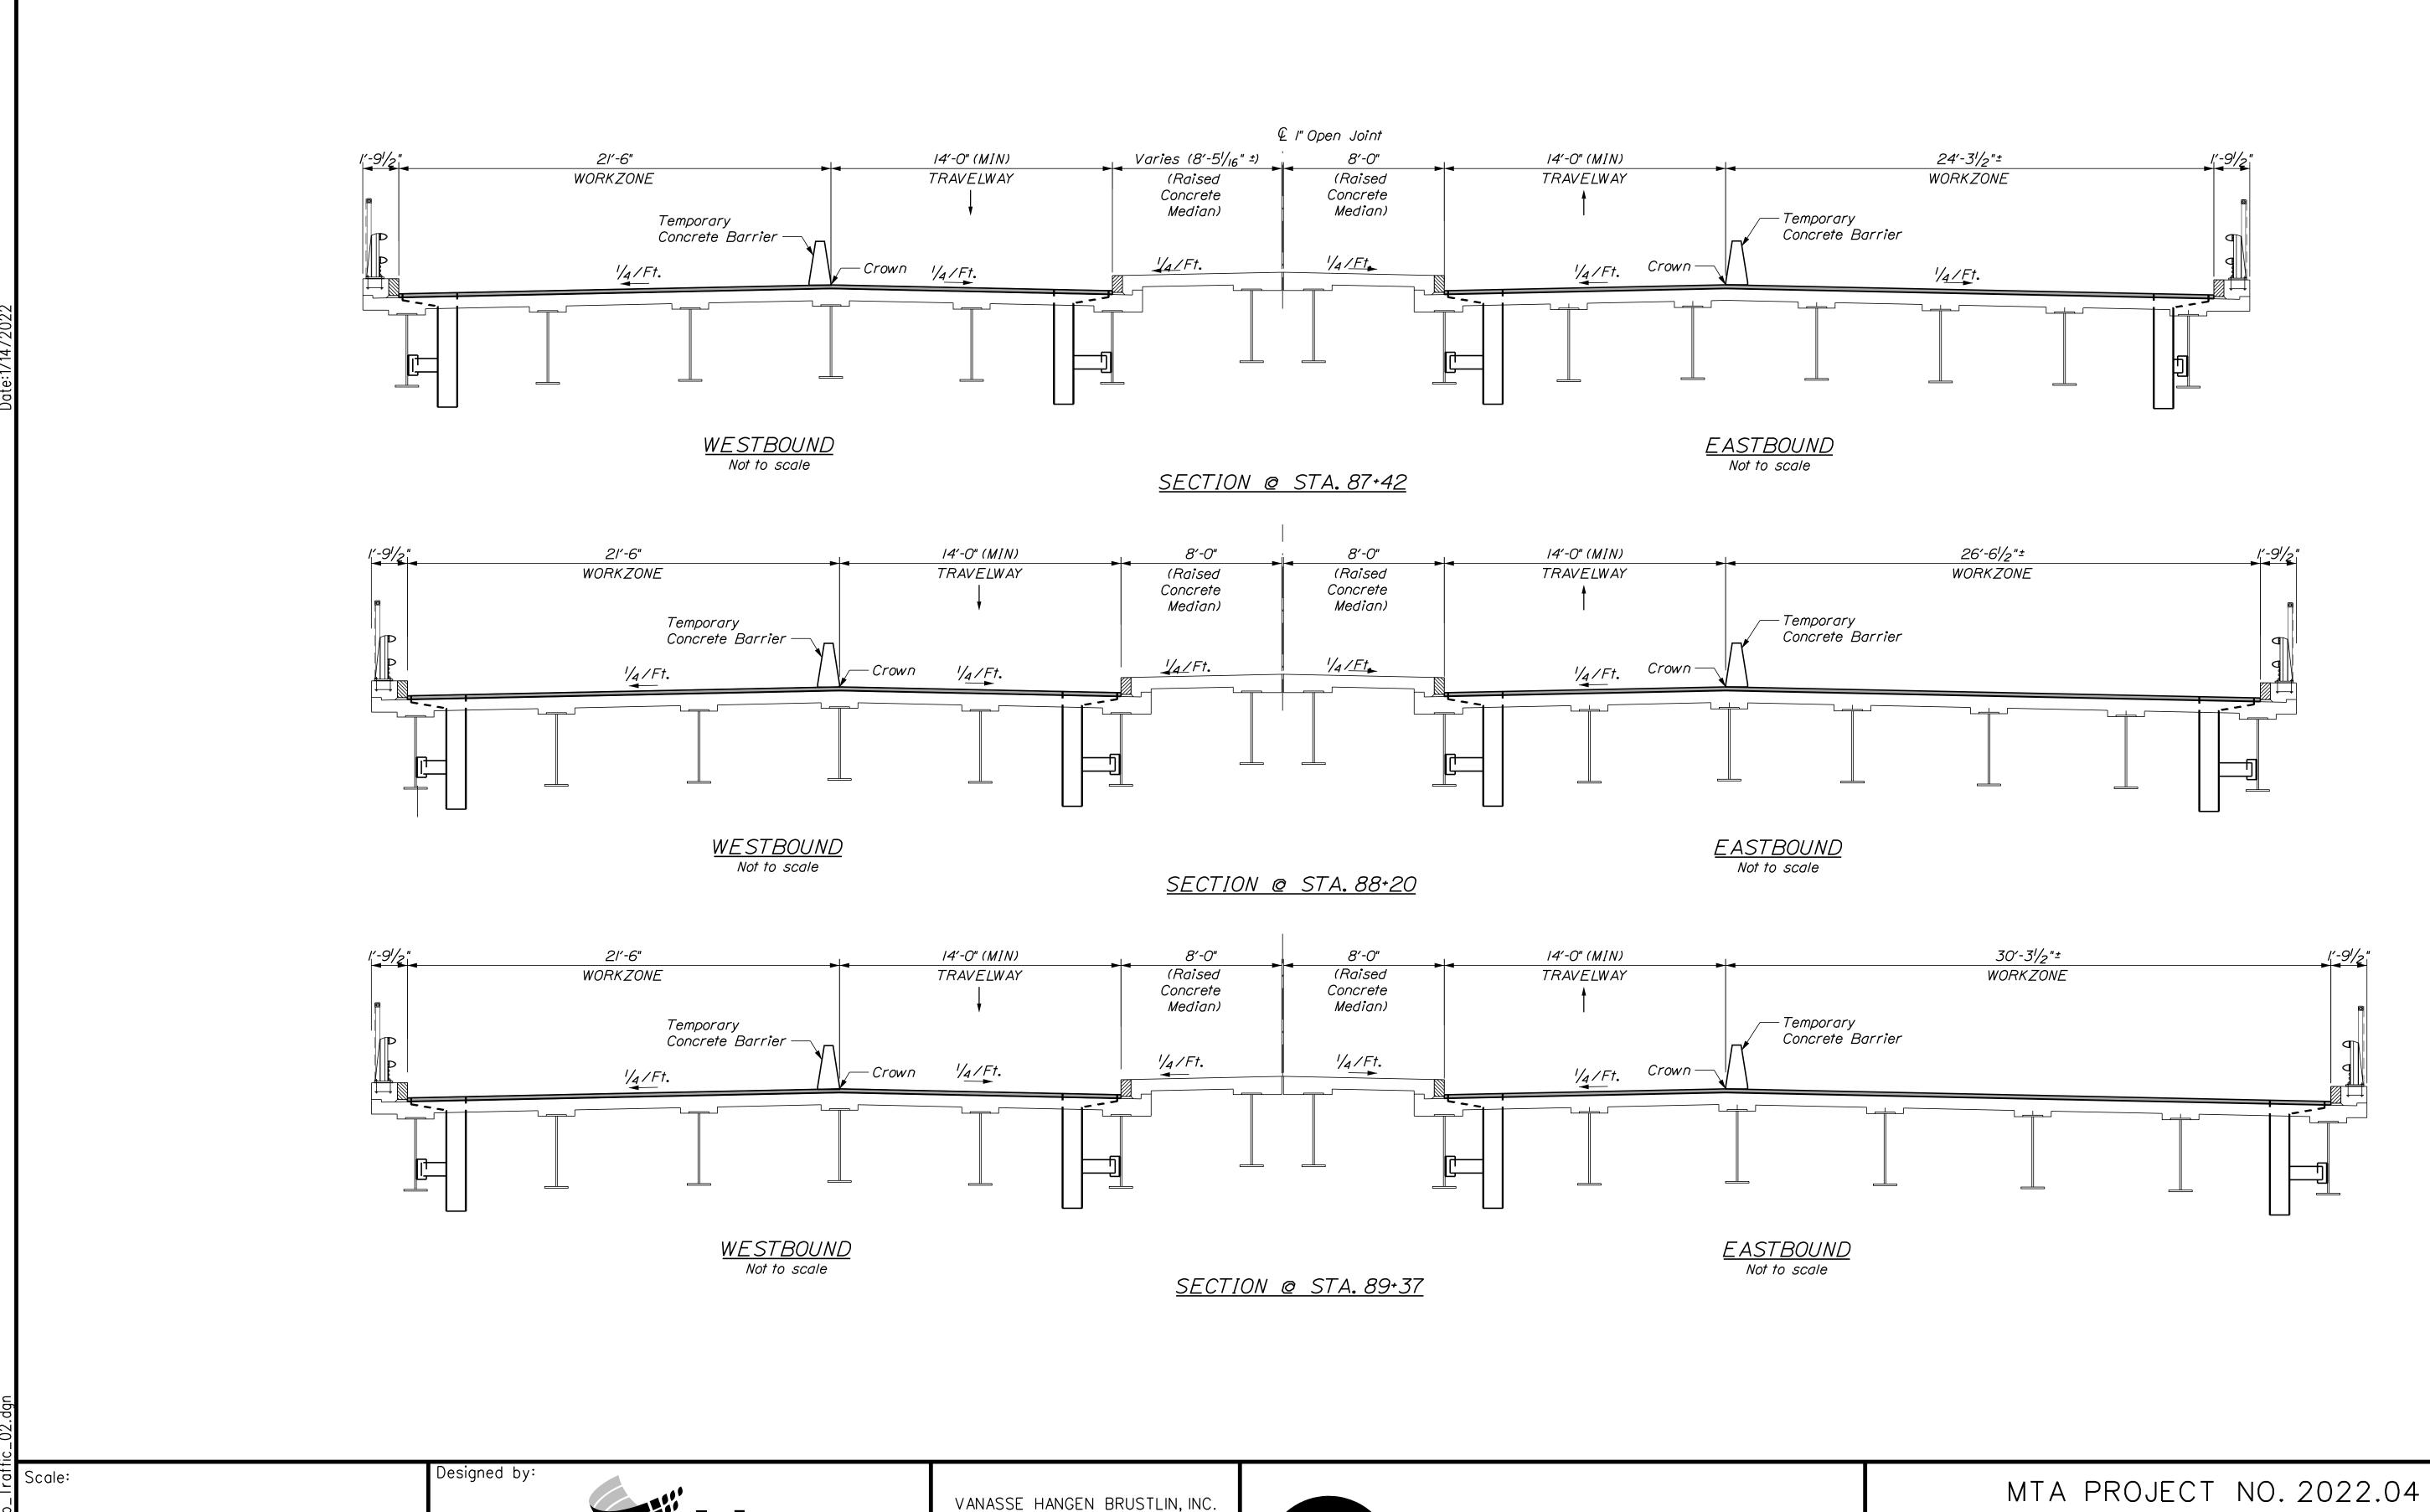

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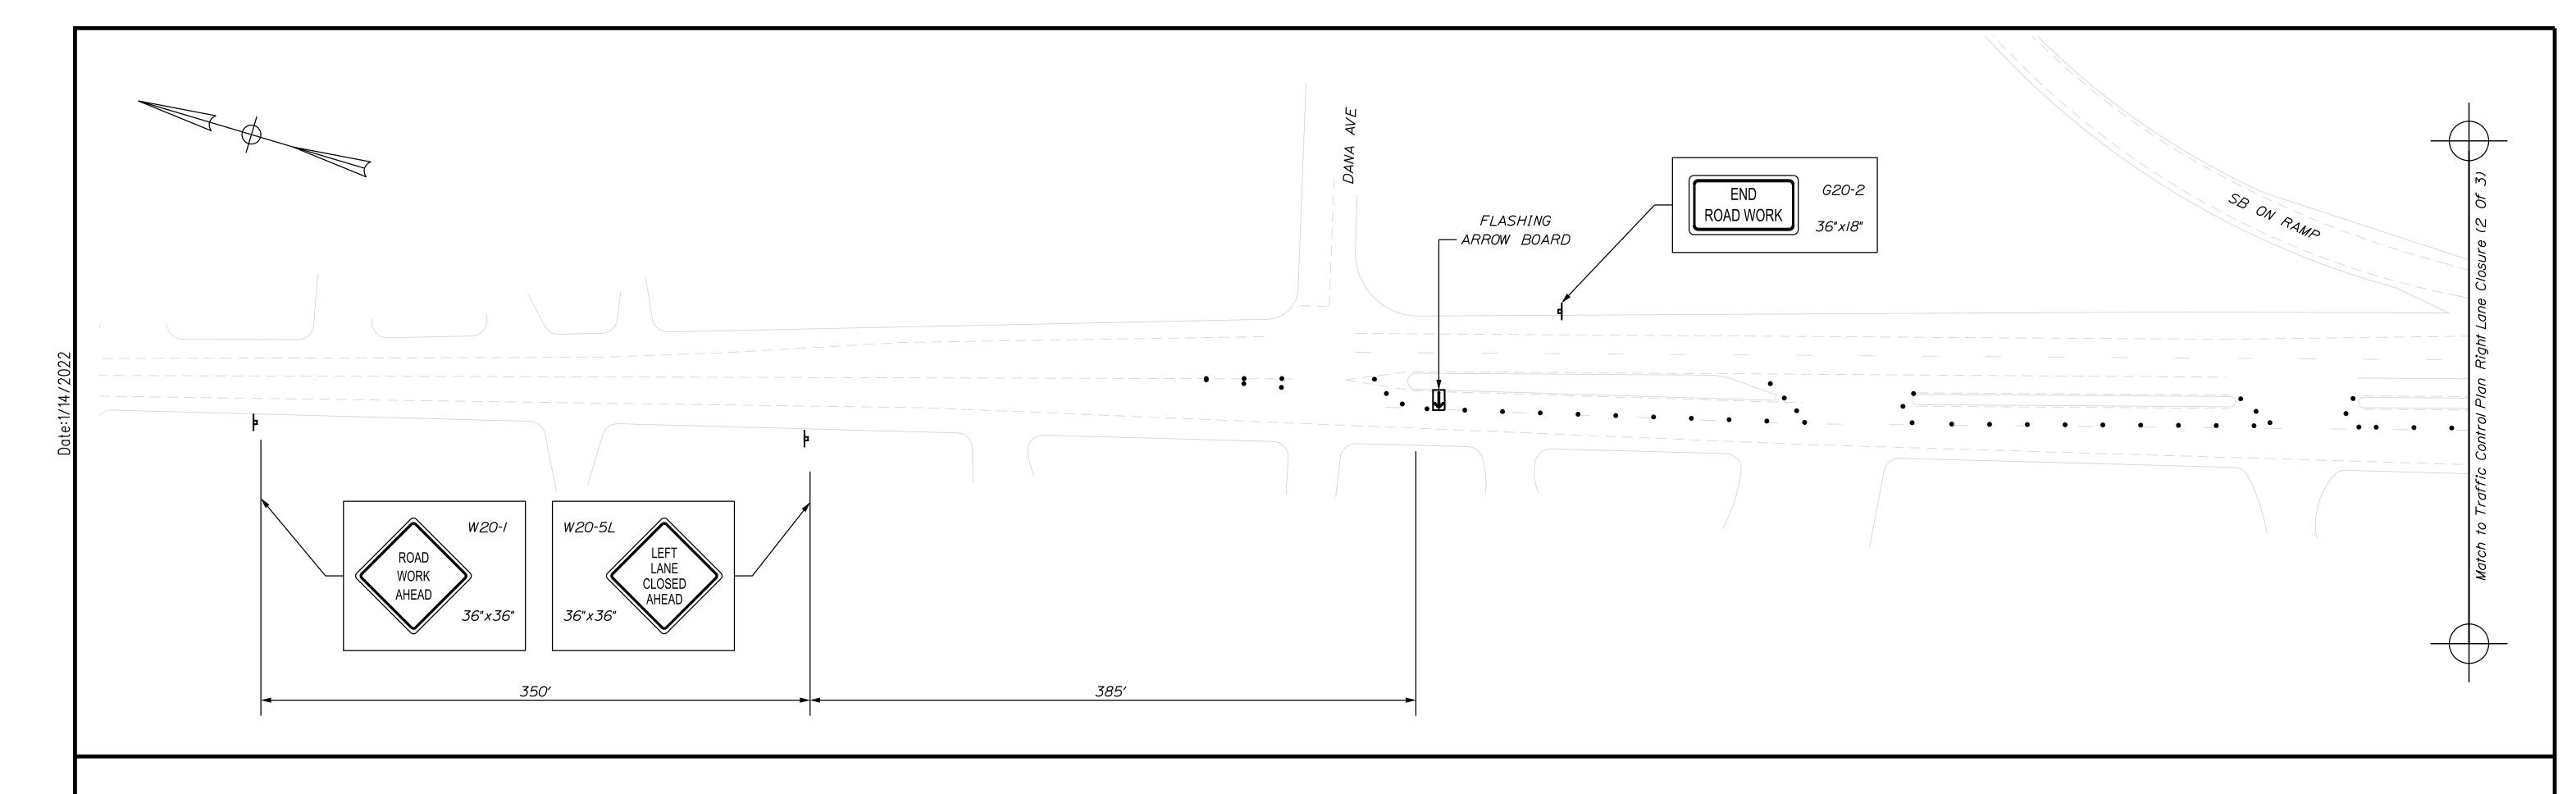
THE GOLD STAR MEMORIAL HIGHWAY

ROUTE 236 UNDERPASS

AT MM 1.25 IN YORK, ME

RIGHT LANE CLOSURE CRITICAL SECTIONS

VHB: 55345.00 SHEET NUMBER: 11
CONTRACT: 2022.04 11 OF **117**



ROUTE 236 RIGHT LANE CLOSURE

	CON	STRUCT	ION SIG	GN SUMN	MARY
Sign			mensions hes)	Size	
		Letter Height			Quantity and Color
CS-3	CS-3 EXPECT STOPPED TRAFFIC		4" 4"	48" x 48"	I - Black on Orange ≭
G20-2	END ROAD WORK	Shall C	mensions Conform andard way	36"x18"	2 - Black on Orange
RI-I	STOP	Signs"	- 2012	48" x 48"	2 - Red on White
RI-2	YIELD			36"x36"x 36"	I - Red on White
WI-4L	(\$)			36"x36"	2 - Black on Orange
W3-/		,		48" x 48"	2 - Black/Red on Orange

CON	STRUCT	ION SIG	ON SUMN	IARY		
	Text Dimensions (Inches)		C*=-			
Sign	Letter Vertical Height Spacing		Size	Quantity and Color		
W 3-4 BE PREPARED TO STOP	Text Dimensions Shall Conform to "Standard Highway		48" x 48"	I - Black on Orange ∗		
W20-1 ROAD WORK		- 2012 	36" x 36"	2 - Black on Orange		
(AHEAD)			48" x 48"	6 - Black on Orange		
W20-5L LEFT LANE CLOSED AHEAD			36" x 36"	I - Black on Orange		

* See Special Provision Section 652 for Requirements for the Use of CS-3 and W3-4

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No.	Revision	Ву	Date	-			/no		
				CONSULTANT	PROJEC	CT MANAGER:	G. Edington		
					Ву	Date		Ву	Date
				Designed	MÉB	10/29/21	Checked	GME	10/29/
				Drawn	DPD	10/29/21	In Charge of	TSB	10/29/

<u>LEGEND</u>

Type 3 Barricade with Detour Sign

Detour Sign on Post Support

Type 3 Barricade

Flashing Arrow Board

• • • • Channelizing Device

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MTA PROJECT MANAGER: RALPH C. NORWOOD, IV

THE GOLD STAR

MTA PROJECT NO. 2022.04 ROUTE 236 UNDERPASS THE GOLD STAR

AT MM 1.25 IN YORK, ME


MEMORIAL HIGHWAY


TRAFFIC CONTROL PLAN RIGHT LANE CLOSURE

(1 OF 3)

VHB: 55345.00

SHEET NUMBER: 12 CONTRACT:2022.04 12 OF 117

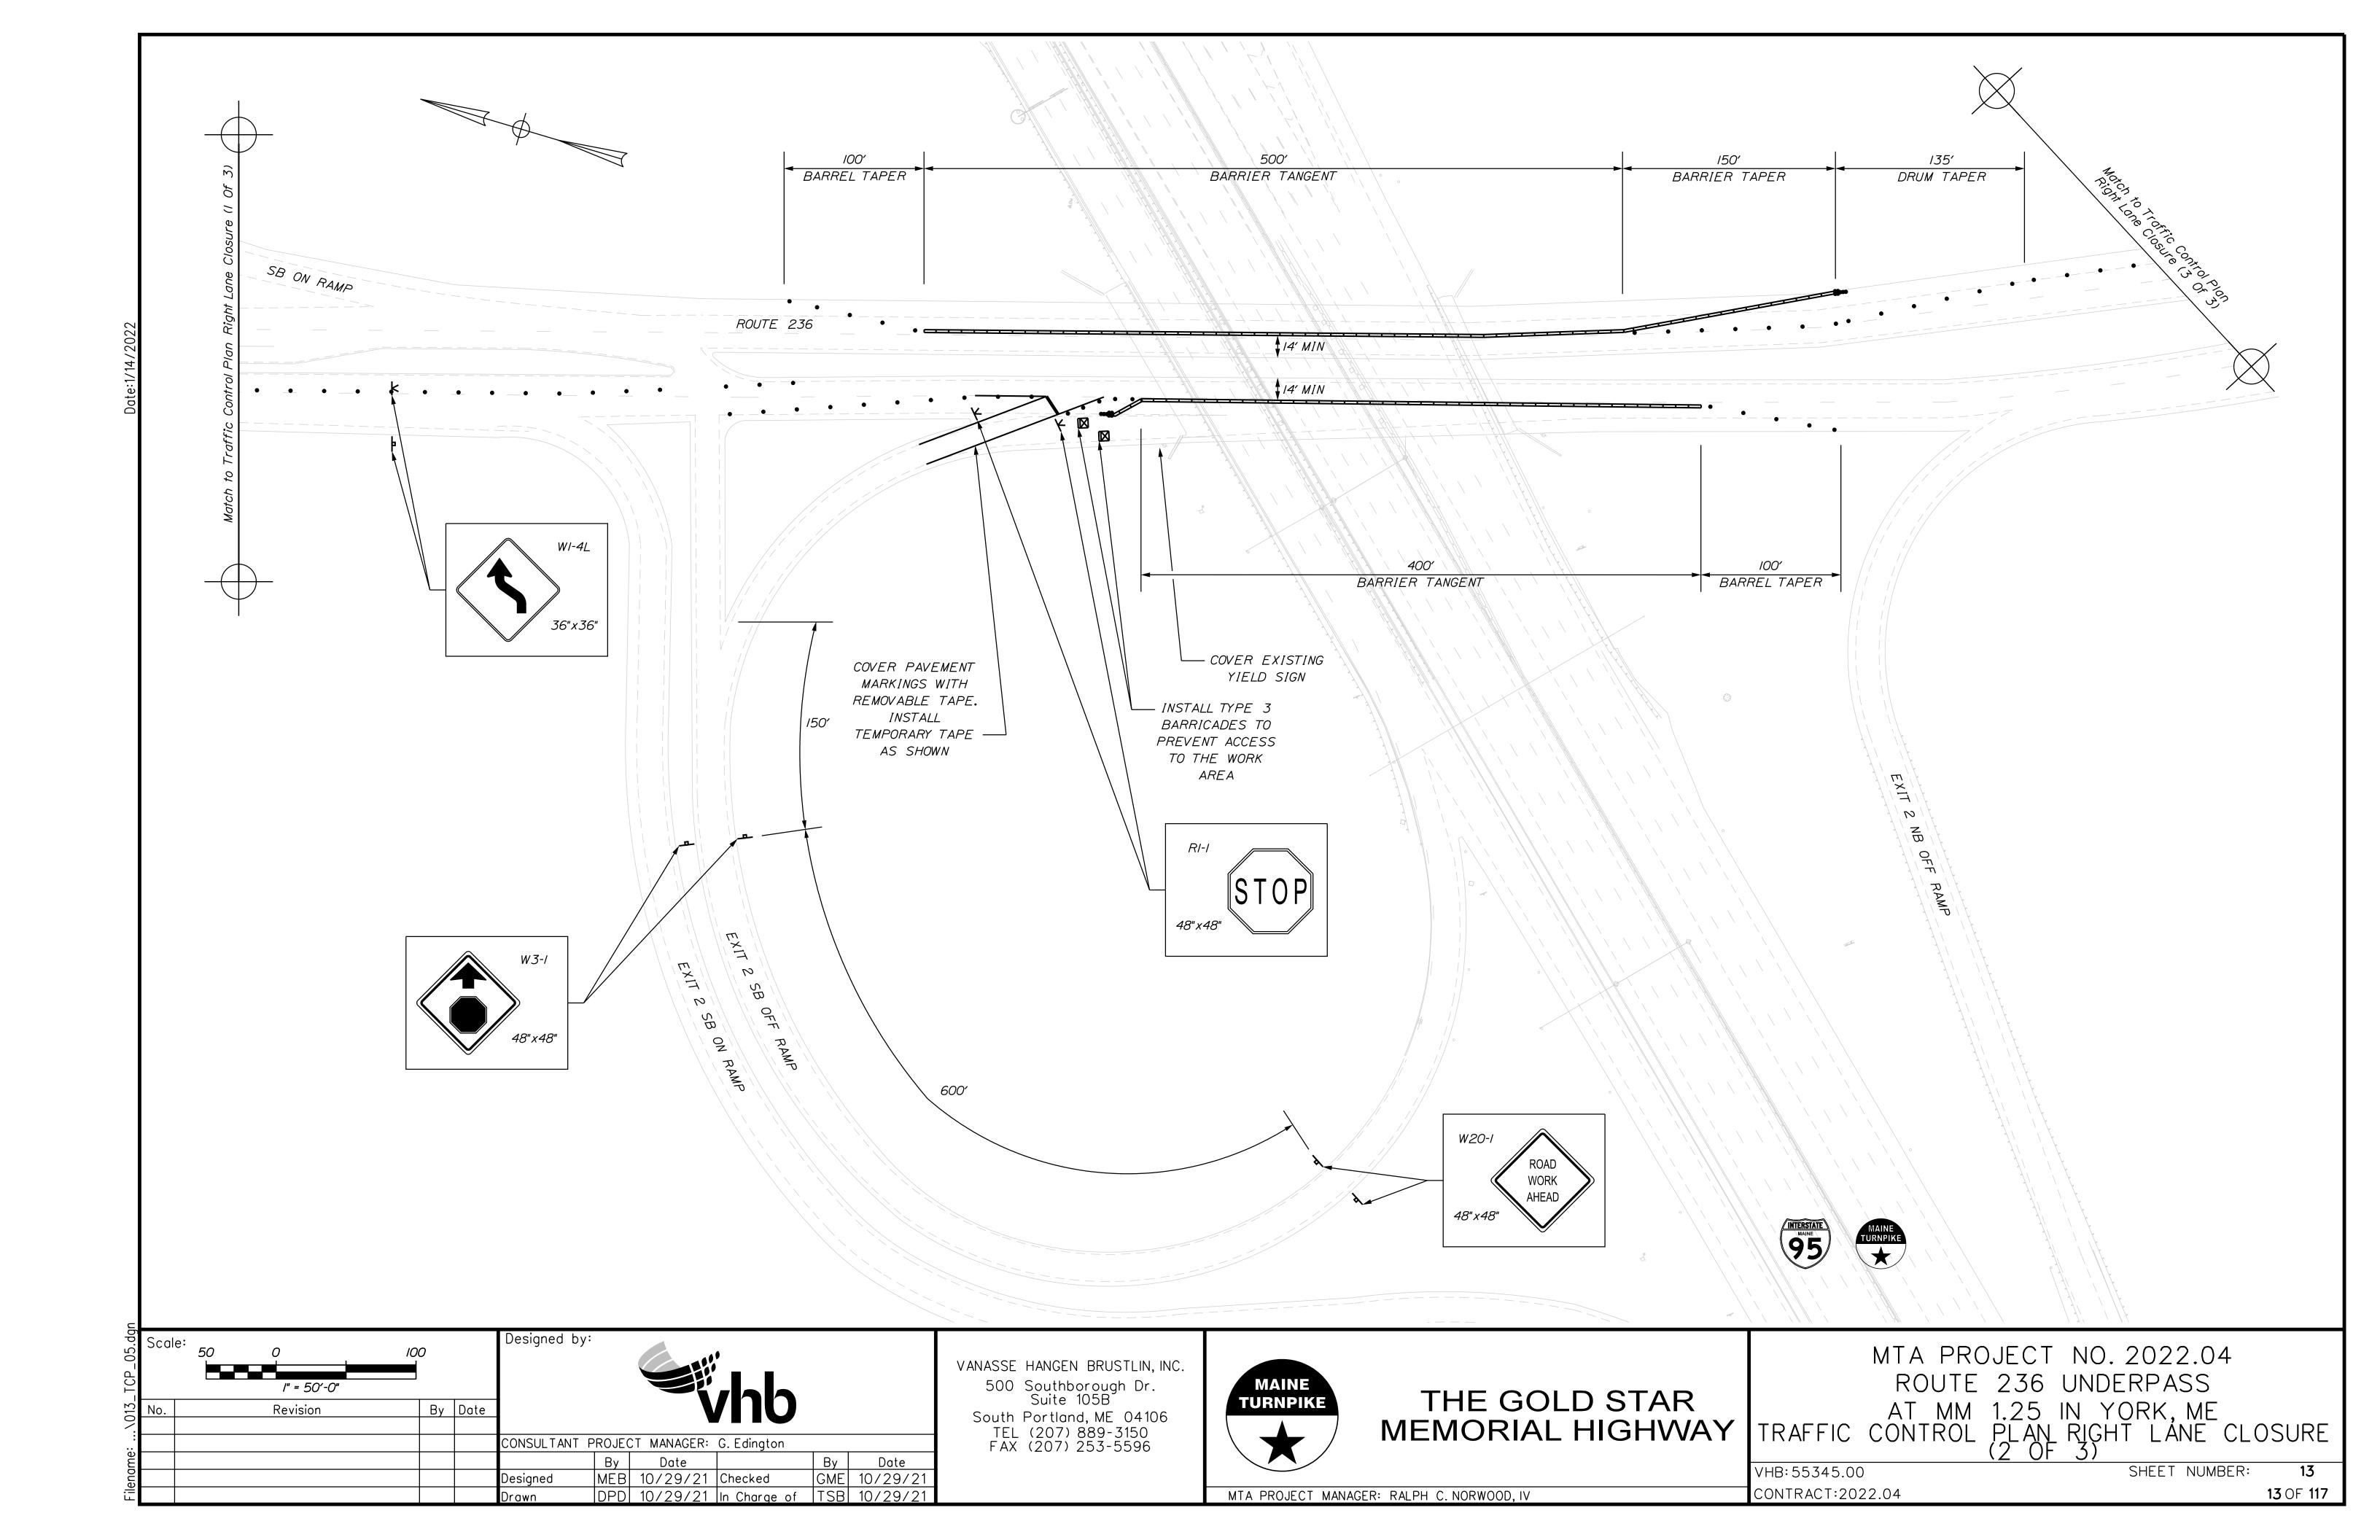


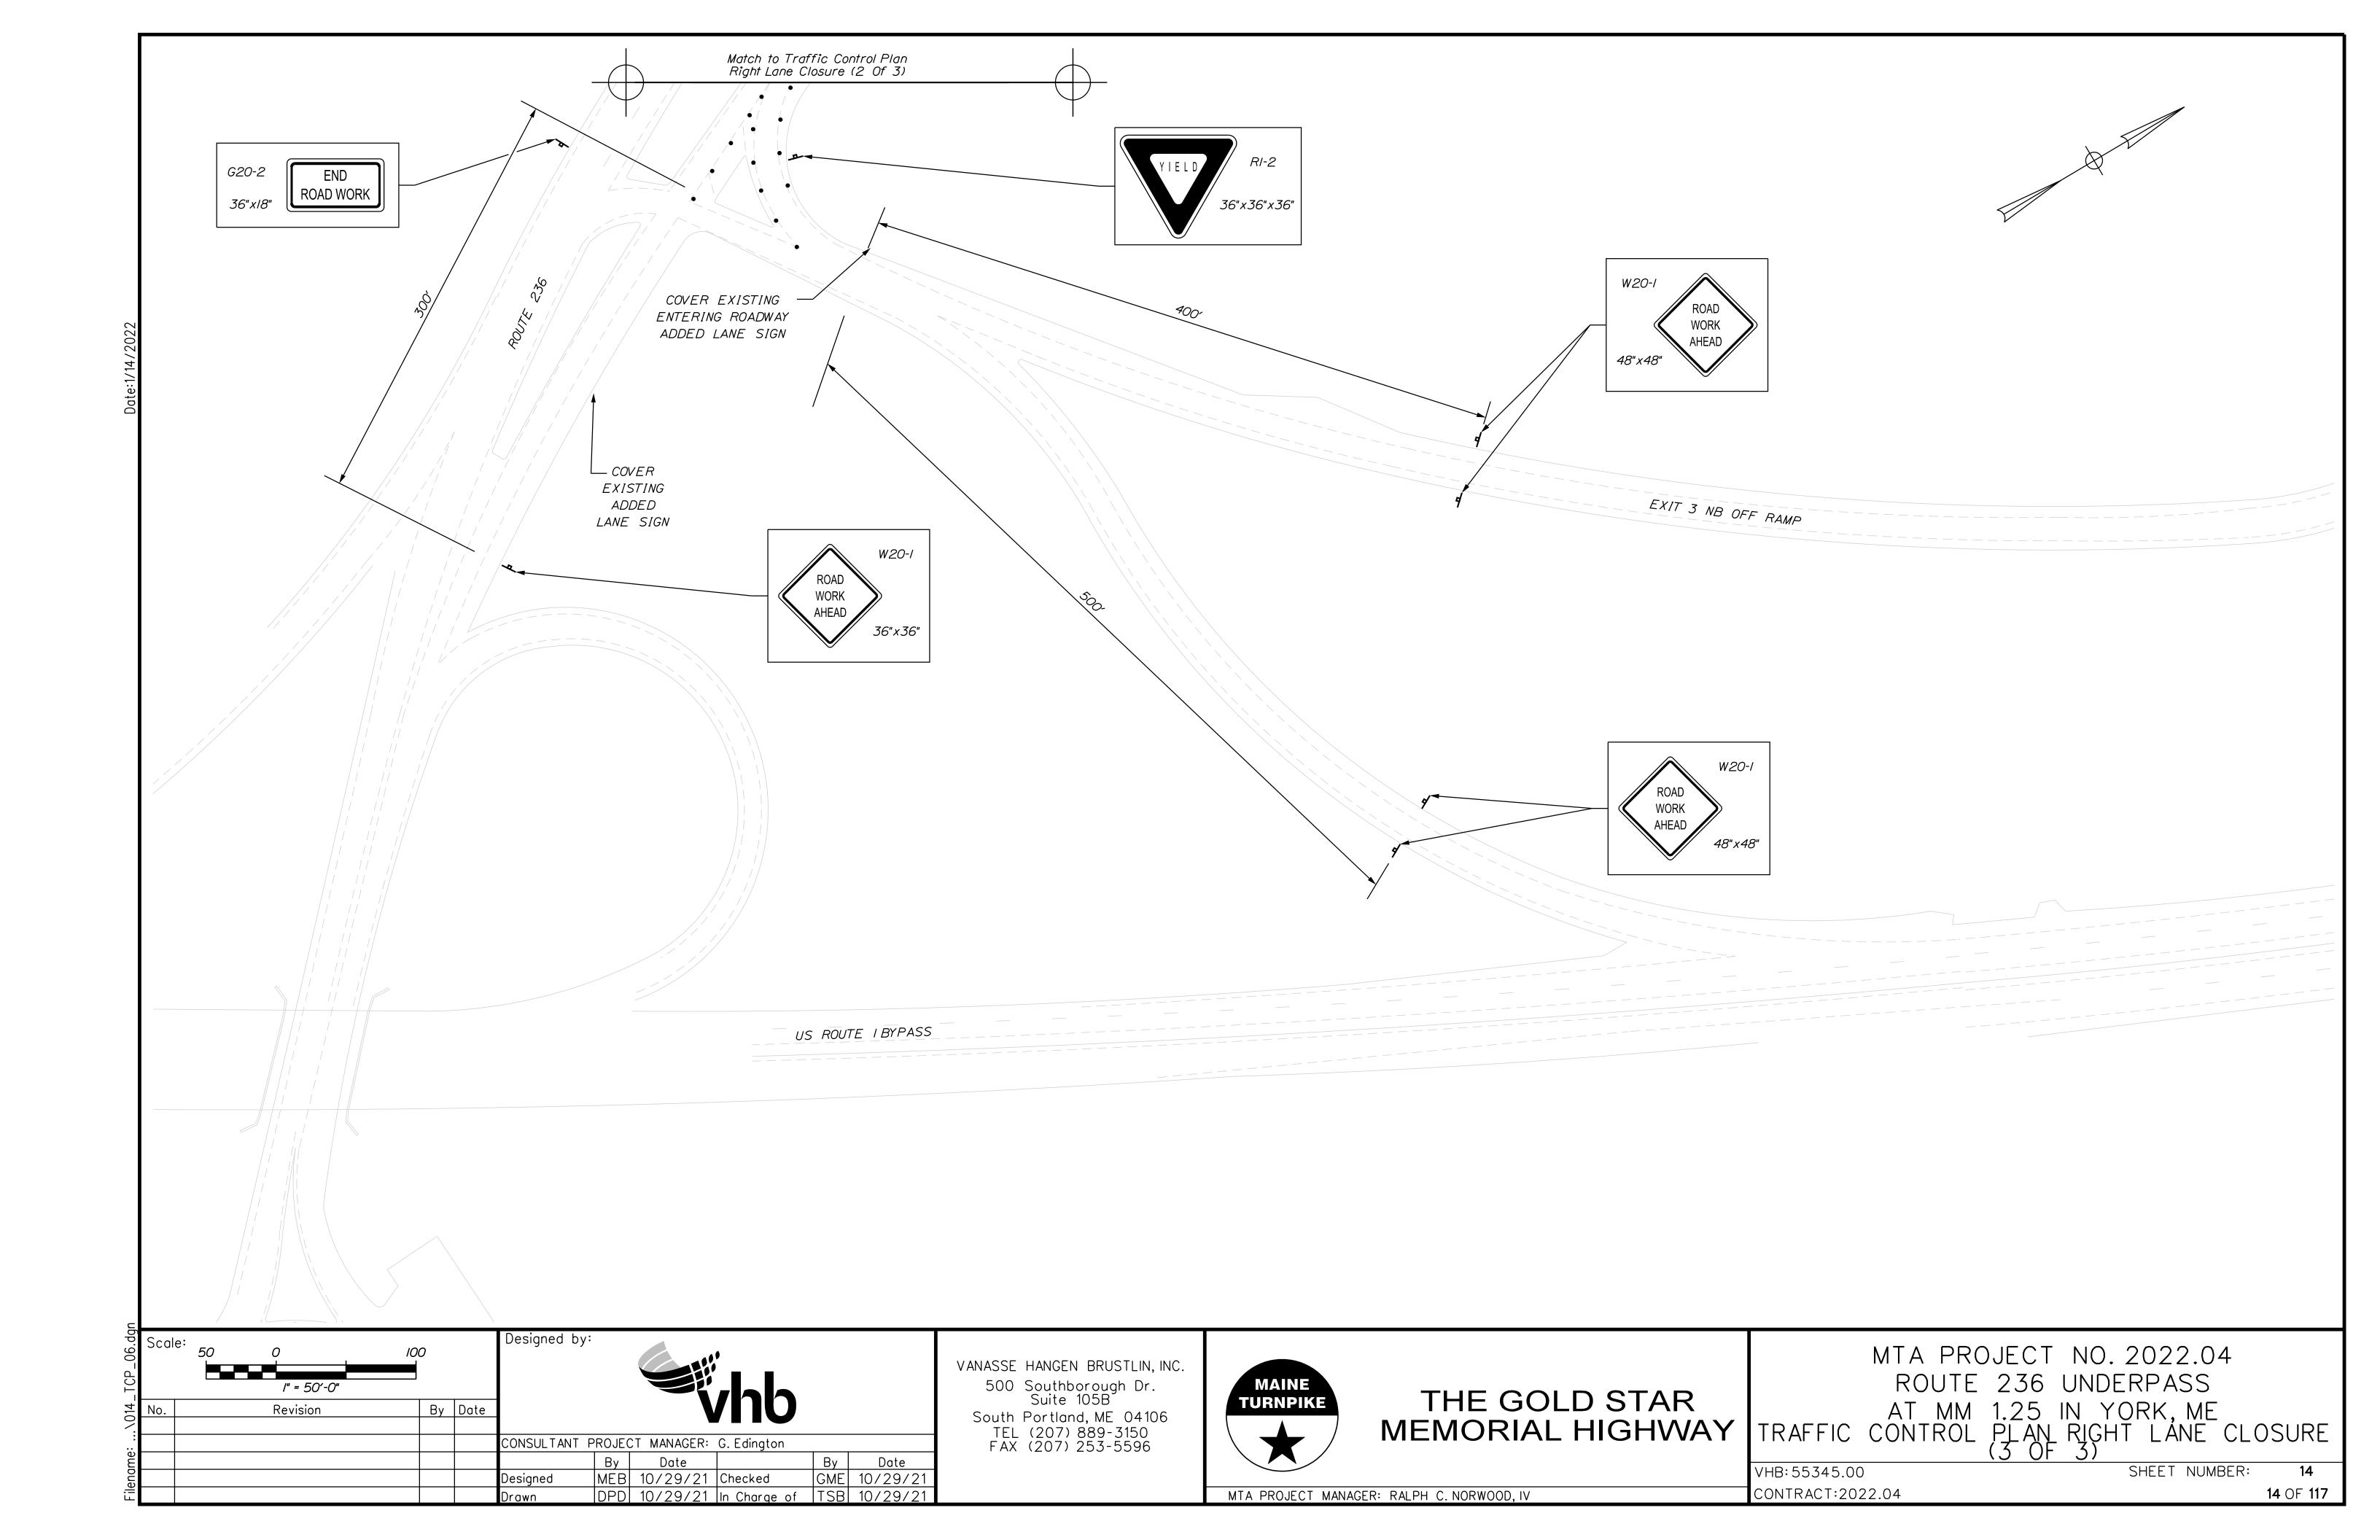


SHSB - Text Dimensions Shall Conform to "Standard Highway Signs Book" - 2012 Edition.

CONSTRUCTION NOTE:

Detour signs shall not be installed more than two weeks prior to the start of the detour and all detour and other traffic control materials shall be removed within two weeks of the end of the detour.

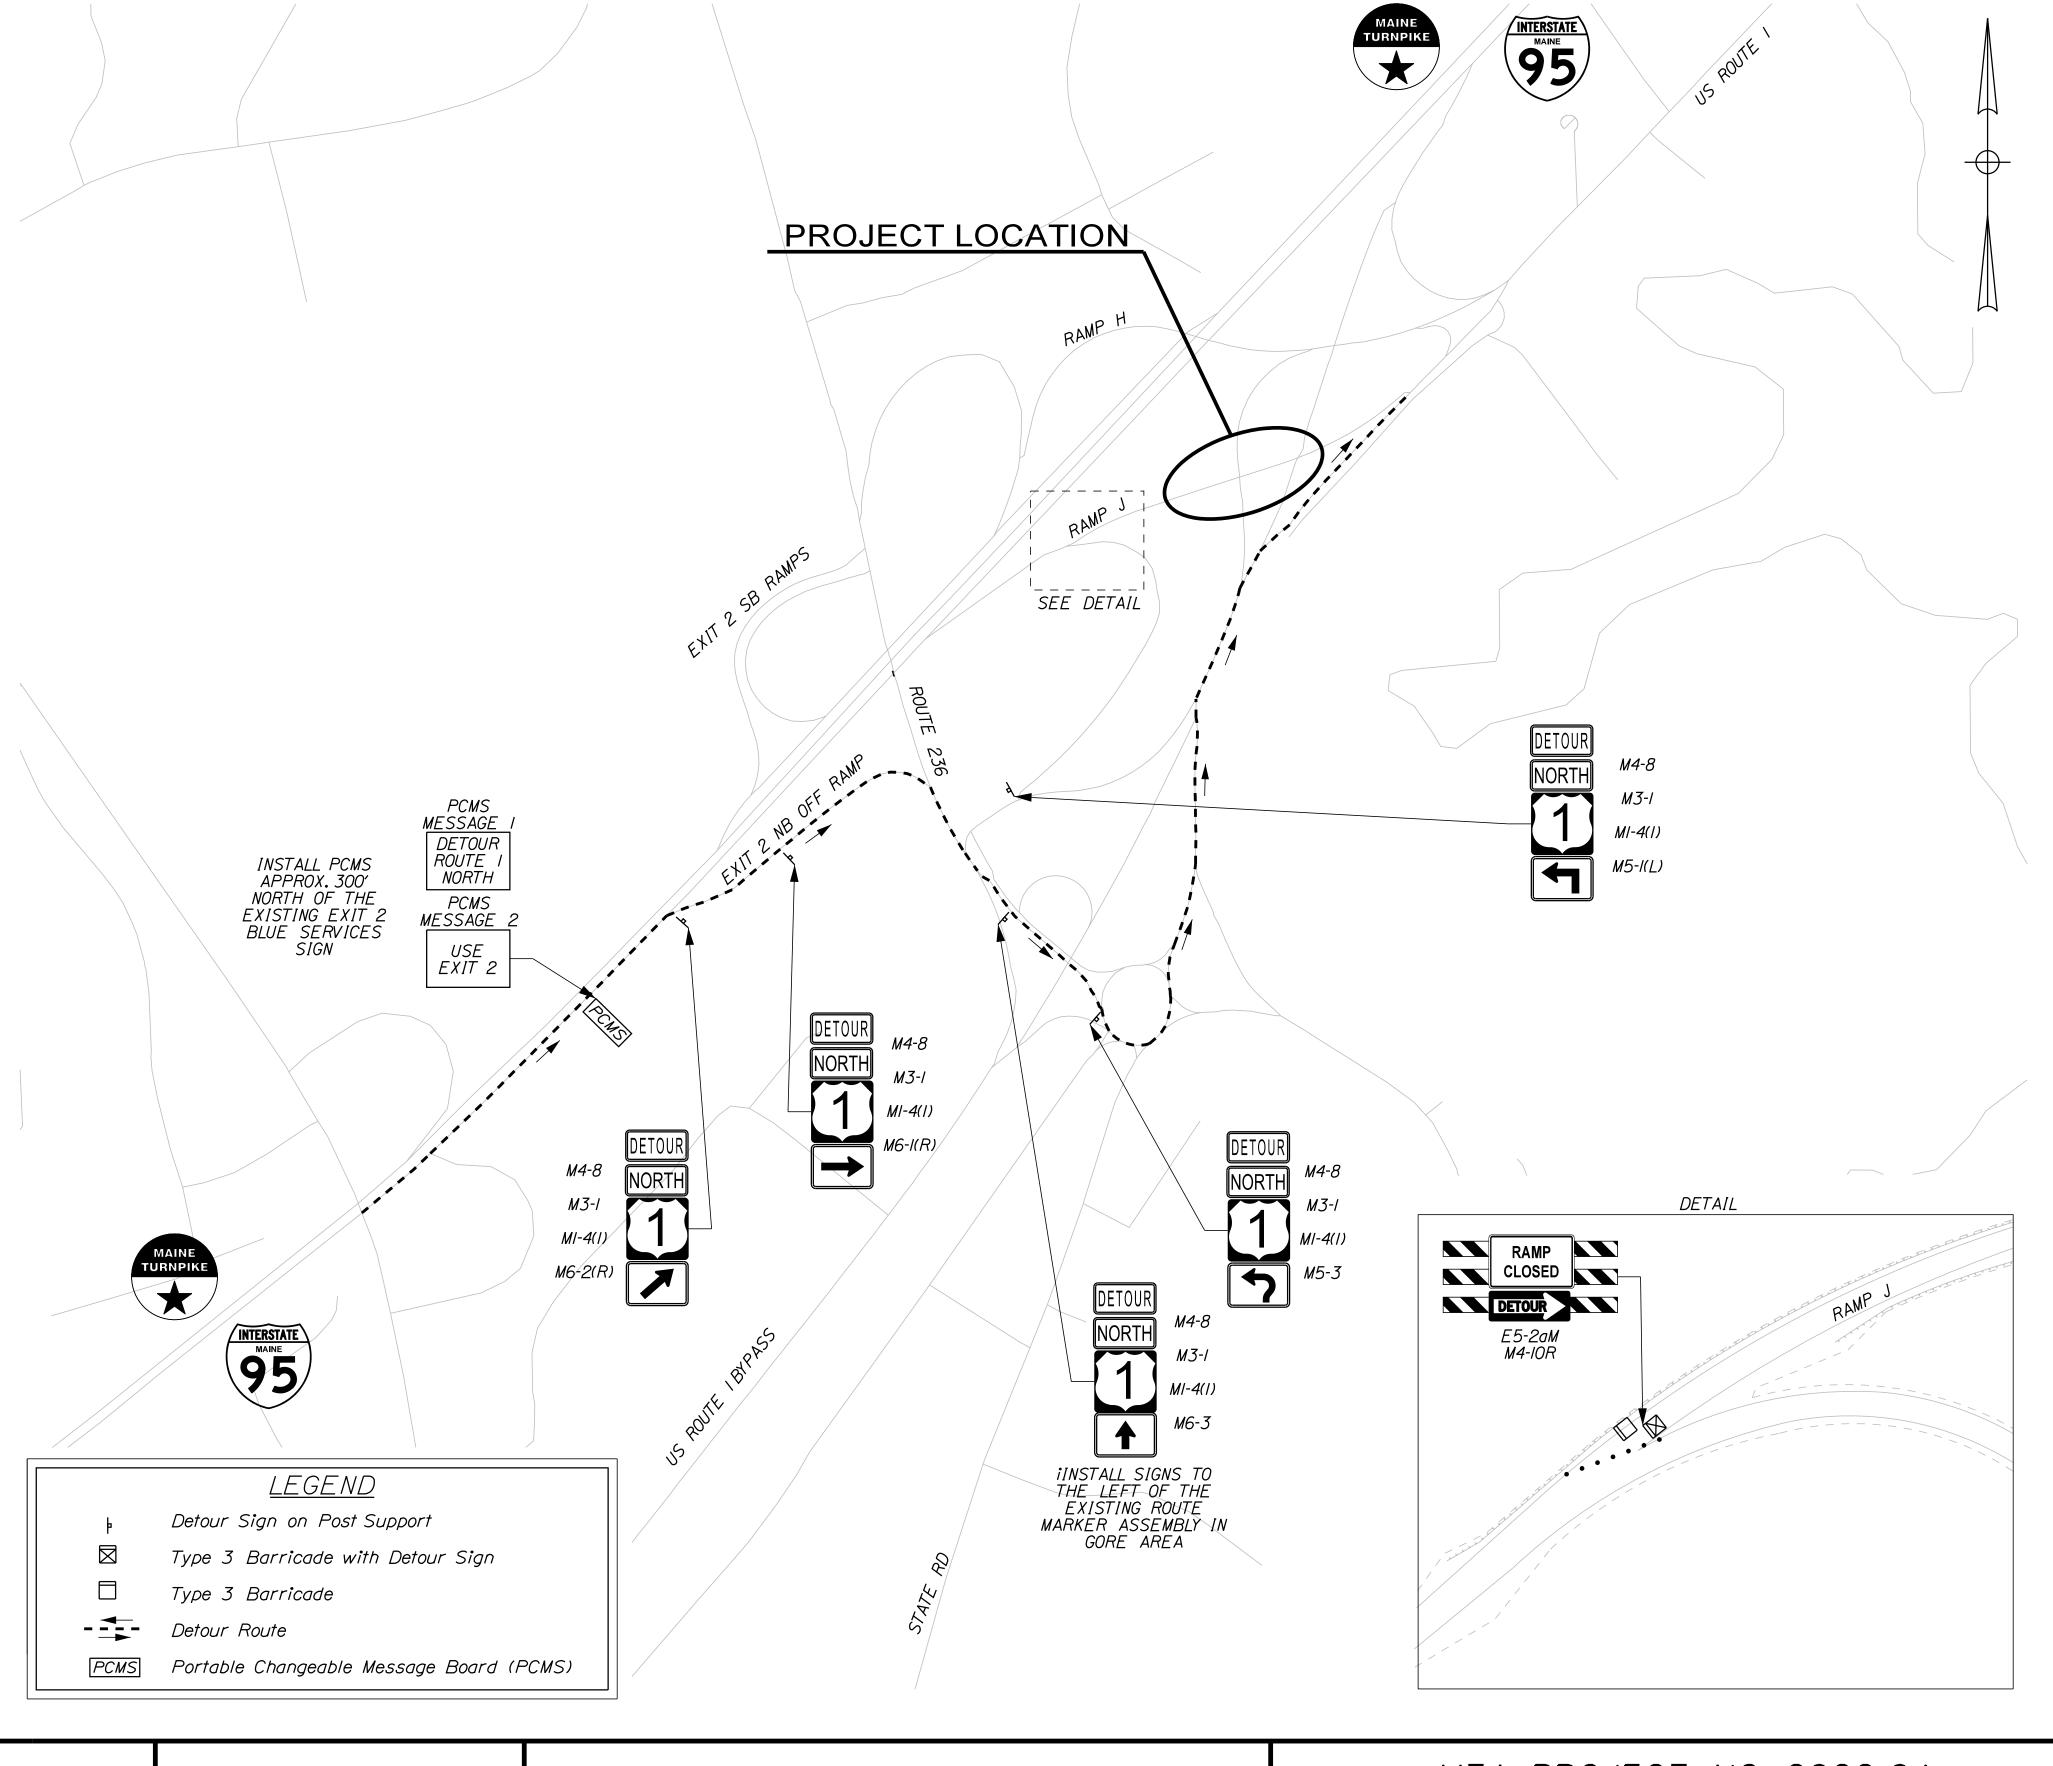

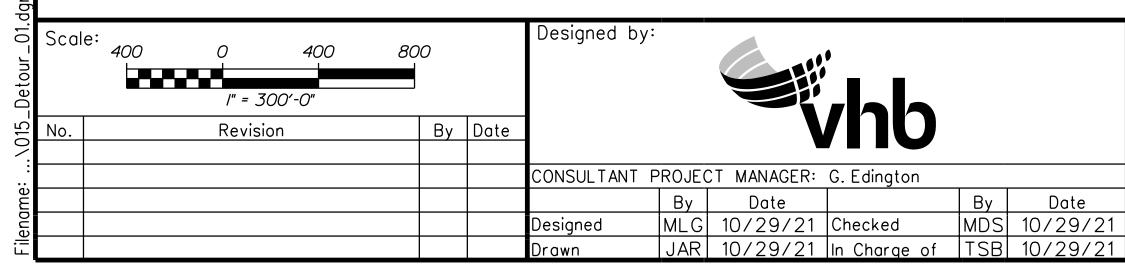

VANASSE HANGEN BRUSTLIN, INC. 500 Southborough Dr. Suite 105B South Portland, ME 04106

TEL (207) 889-3150 FAX (207) 253-5596



THE GOLD STAR MEMORIAL HIGHWAY MTA PROJECT NO. 2022.04 RAMP "J" UNDERPASS AT MM 1.50 IN YORK, ME DETOUR PLAN

SHEET NUMBER: VHB:55345.00


MTA PROJECT MANAGER: RALPH C. NORWOOD, IV


15 CONTRACT:2022.04 15 OF 117

SHSB - Text Dimensions Shall Conform to "Standard Highway Signs Book" - 2012 Edition.

CONSTRUCTION NOTE:

Detour signs shall not be installed more than two weeks prior to the start of the detour and all detour and other traffic control materials shall be removed within two weeks of the end of the detour.

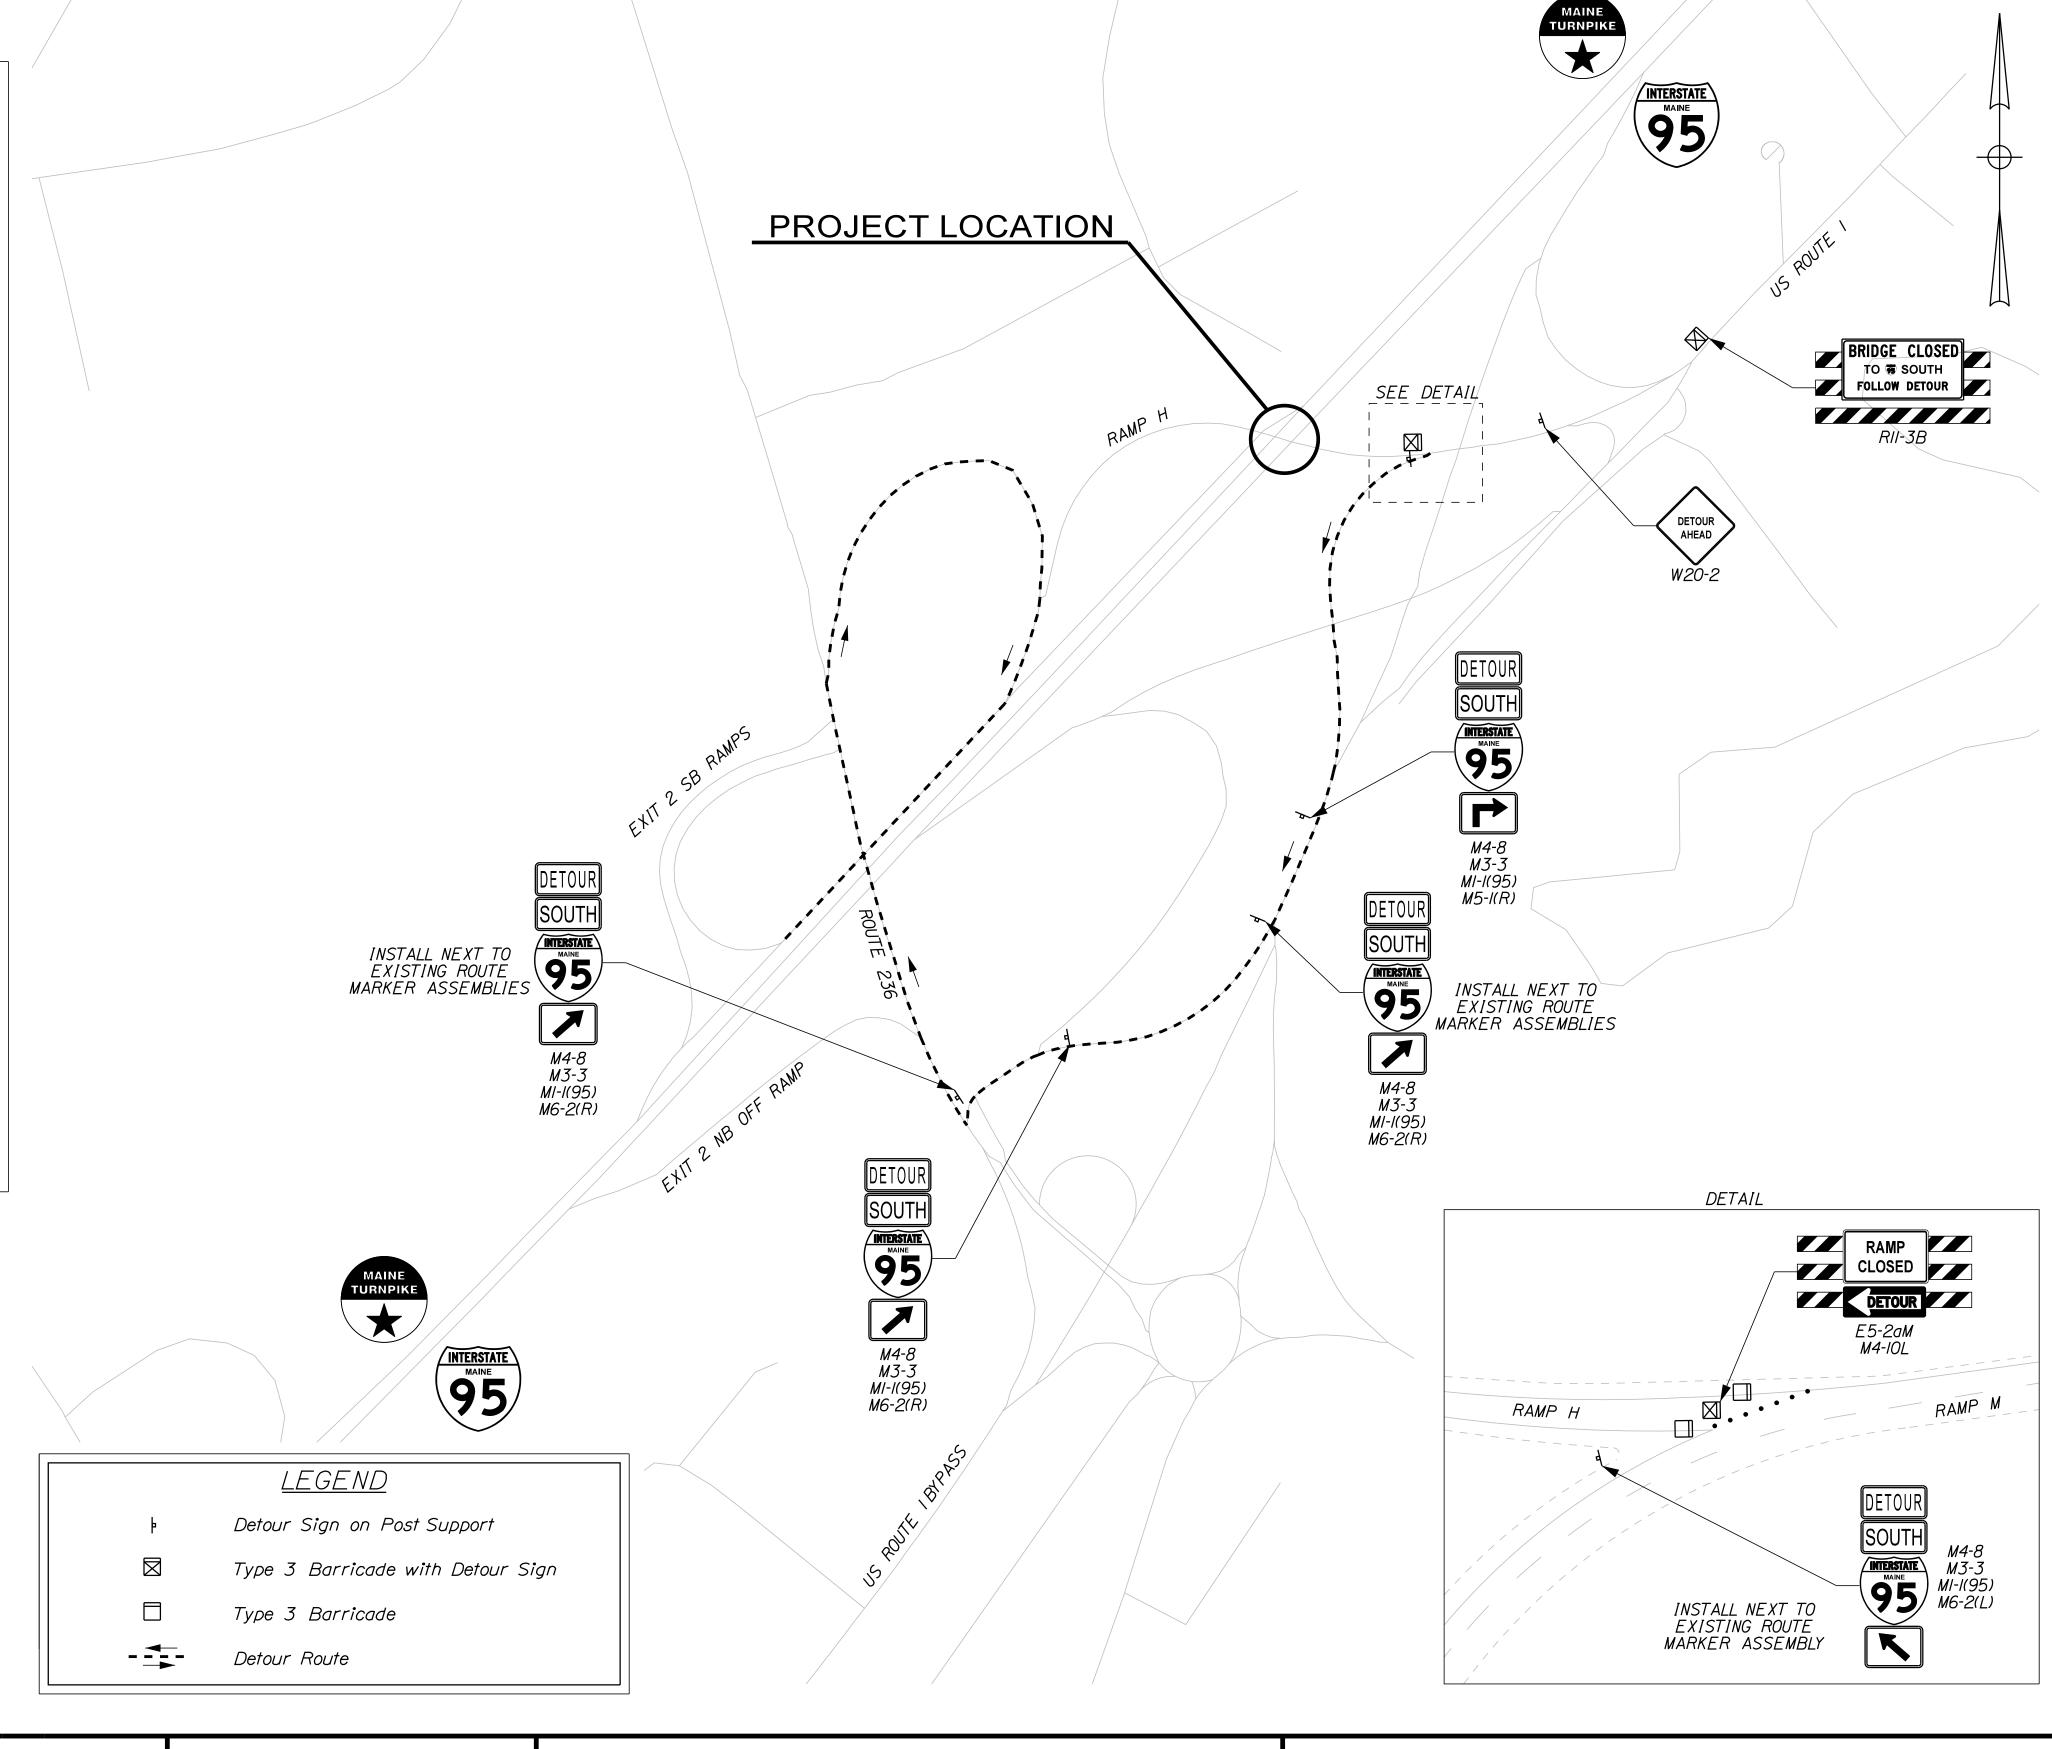

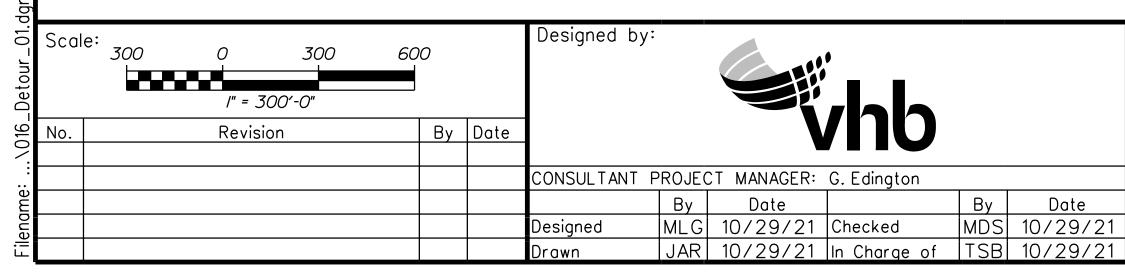

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MAINE
TURNPIKE


THE GOLD STAR MEMORIAL HIGHWAY

MTA PROJECT NO. 2022.04
ROUTE 1 (RAMP H) UNDERPASS
AT MM 1.60 IN YORK, ME
DETOUR PLAN

VHB:55345.00 CONTRACT:2022.04

SHEET NUMBER: 16 16 OF 117

MTA PROJECT MANAGER: RALPH C. NORWOOD, IV

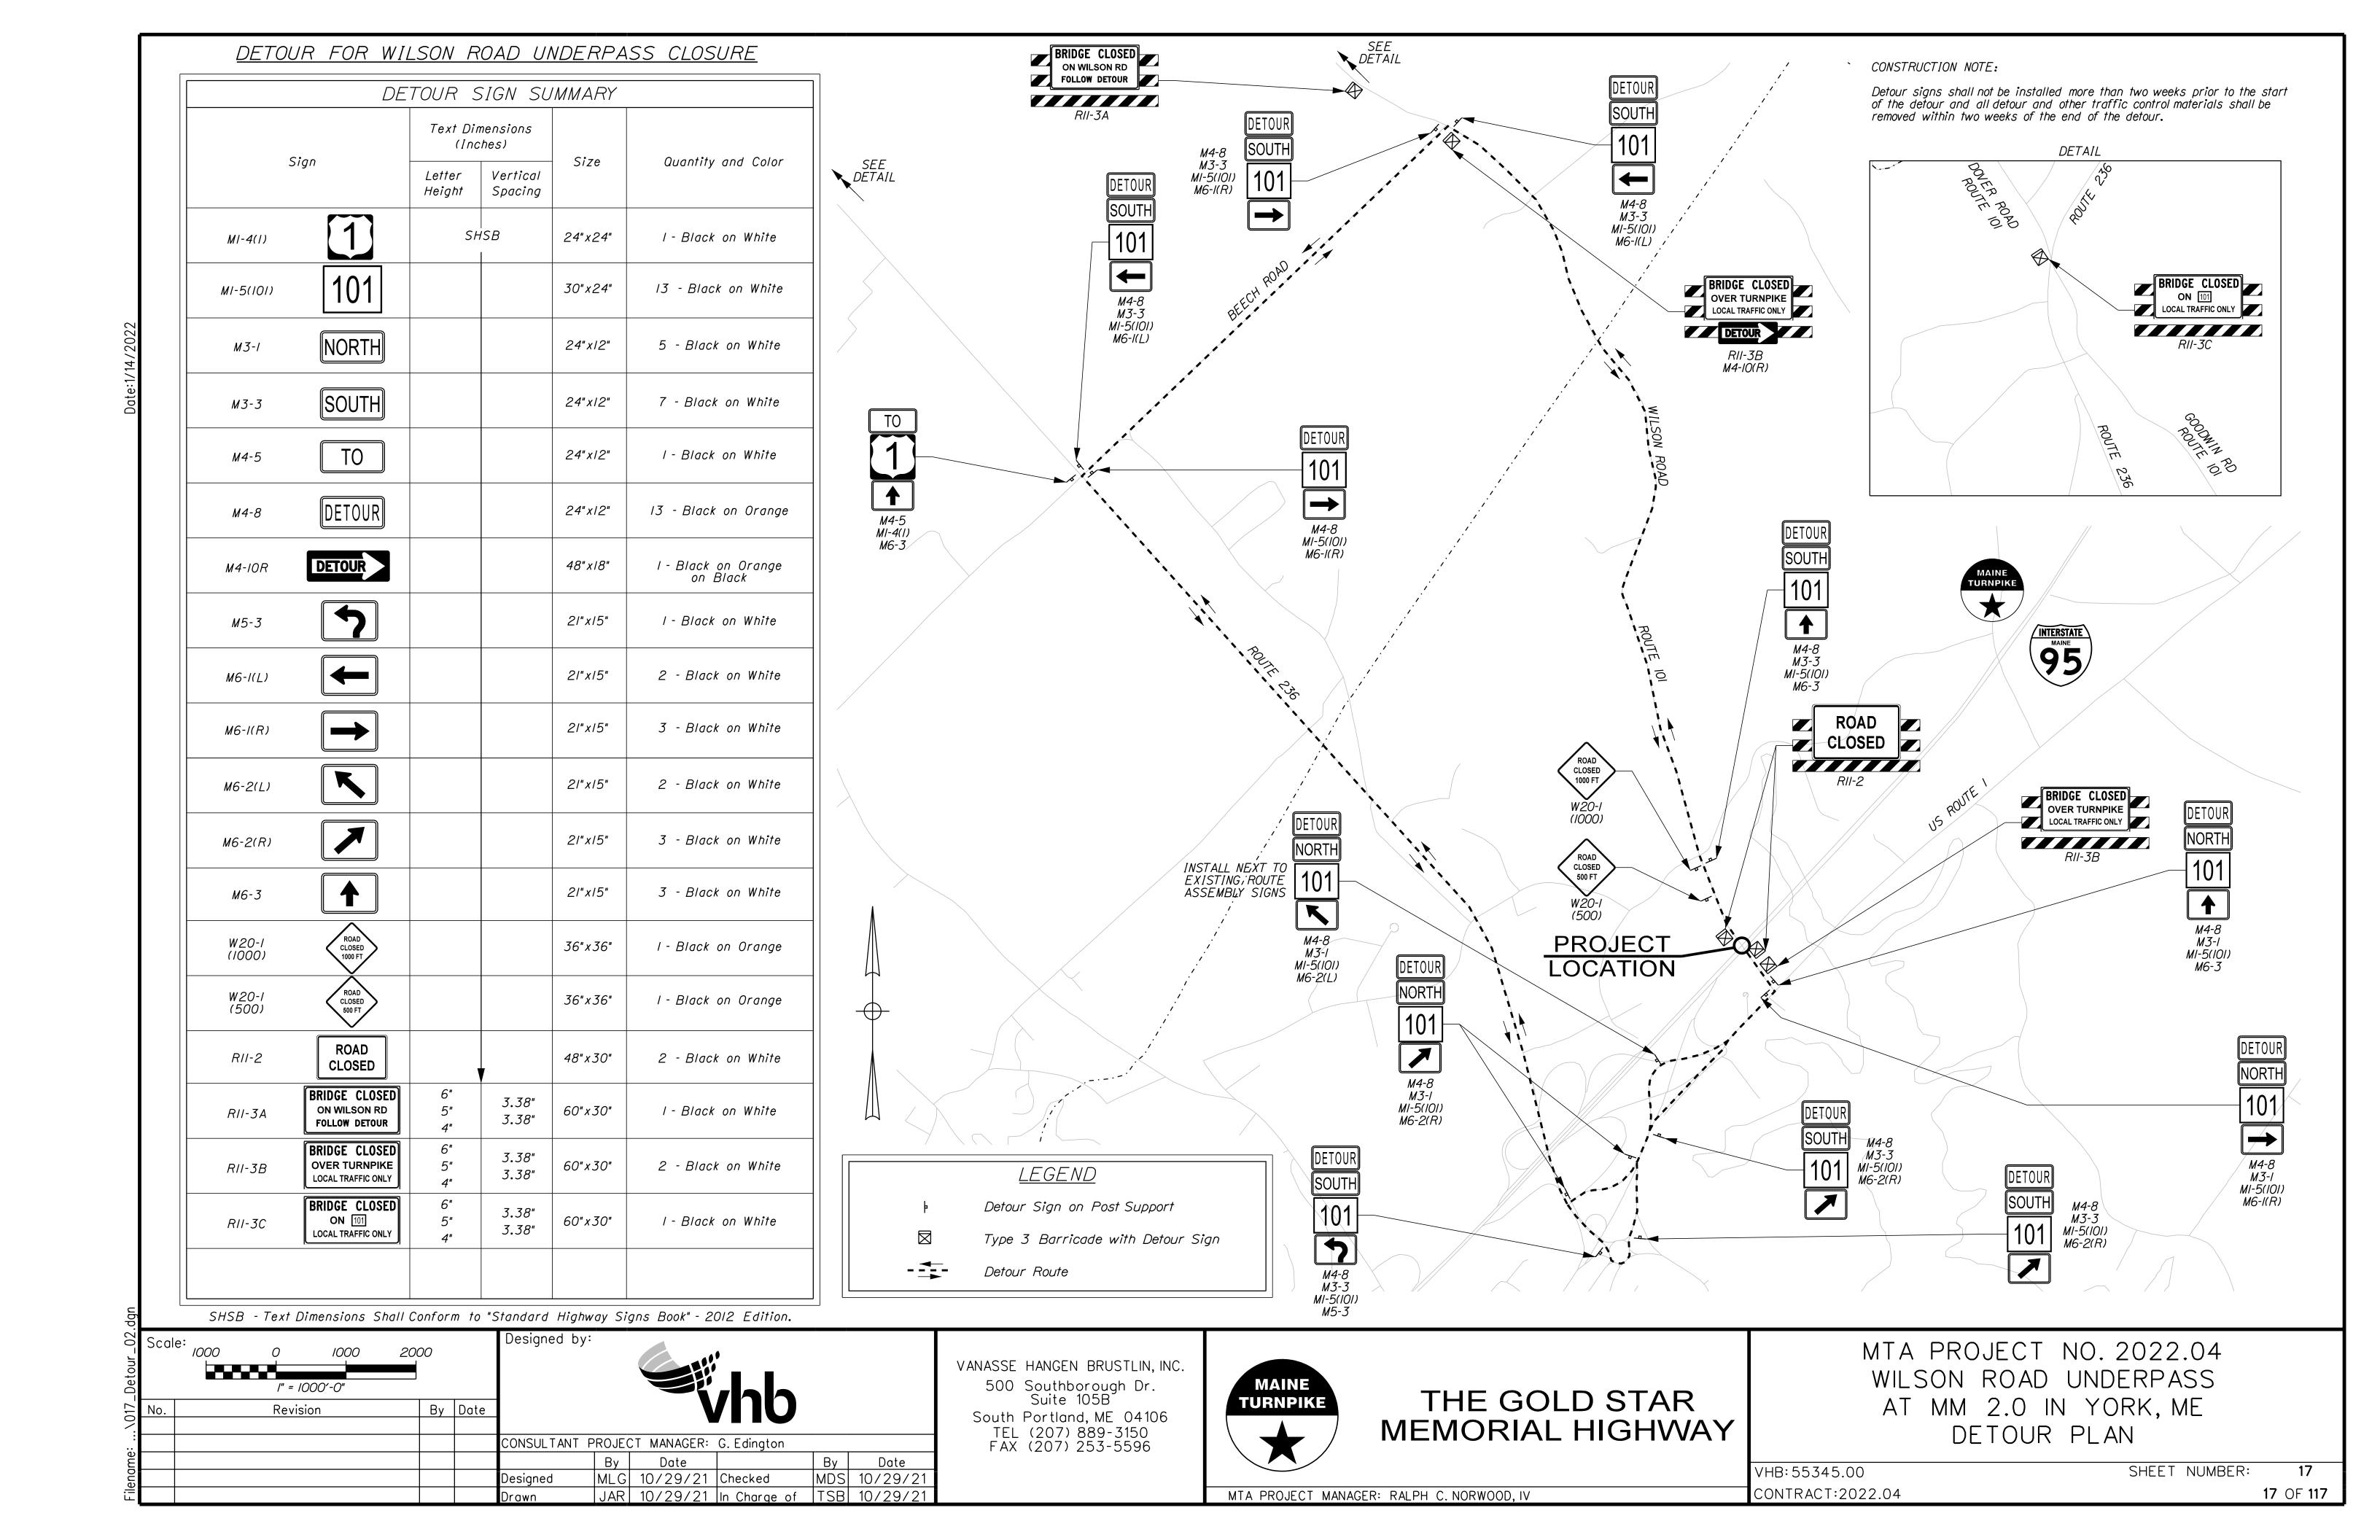

TURNPIKE SOUTHBOUND

Not to Scale

60′-10"


TURNPIKE NORTHBOUND

Not to Scale

60′-10"

<u>PHASE I</u> <u>TRAFFIC CONTROL SECTION</u>

€ I-95 & € I" Closed Joint

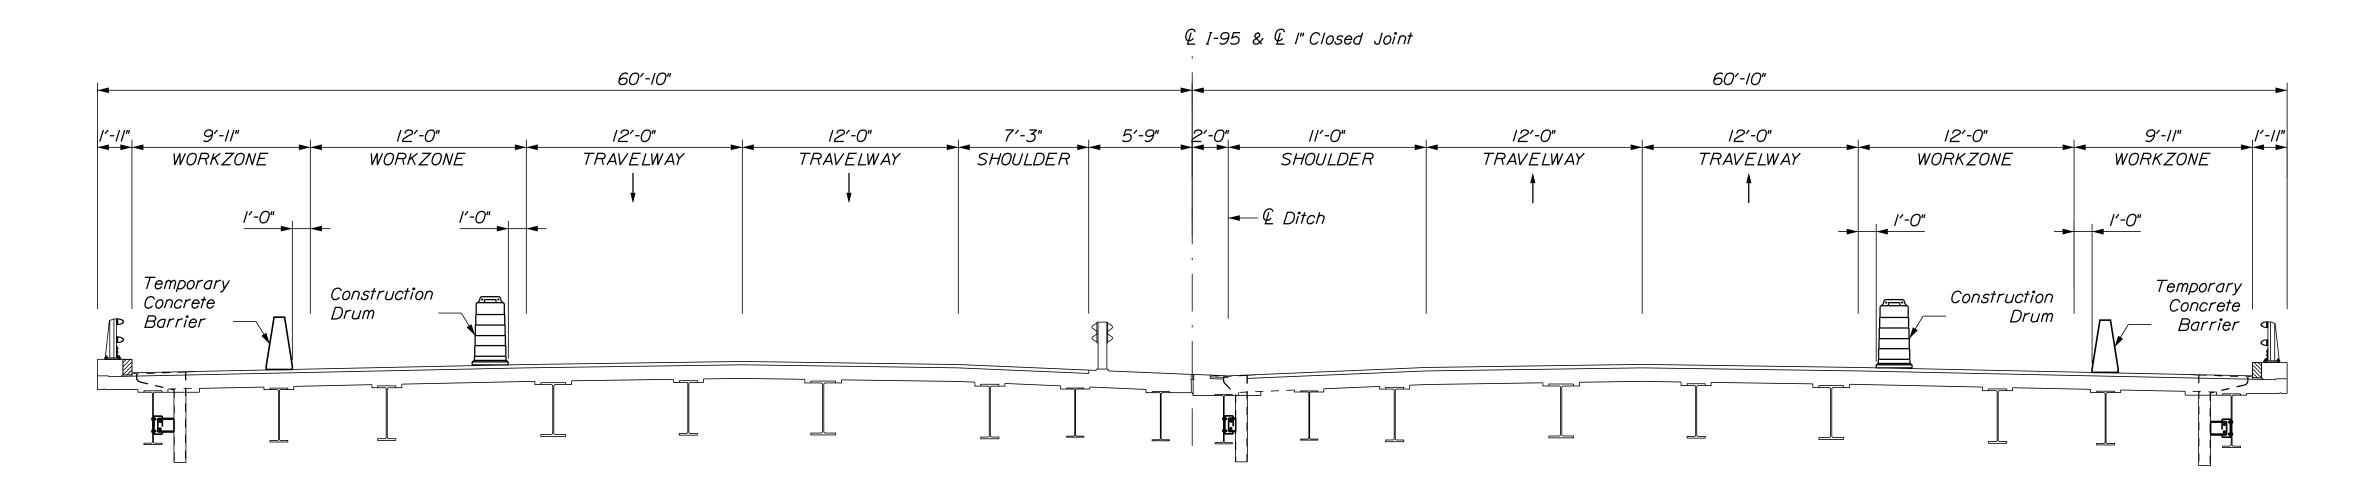

TURNPIKE SOUTHBOUND

Not to Scale

TURNPIKE NORTHBOUND

Not to Scale

PHASE IA TRAFFIC CONTROL SECTION

CONTRACTOR SHALL ESTABLISH A DOUBLE RIGHT LANE CLOSURE IN ACCORDANCE WITH THE MAINTENANCE OF TRAFFIC DETAILS TO COMPLETE THE JOINT WORK IN THE RIGHT LANE TO PROVIDE A MINIMUM OF 4' OFFSET FROM THE ACTIVE TRAVEL LANE.

VANASSE HANGEN BRUSTLIN, INC.
500 Southborough Dr.
Suite 105B
South Portland, ME 04106
TEL (207) 889-3150
FAX (207) 253-5596

MAINE
TURNPIKE

THE GOLD STAR MEMORIAL HIGHWAY

MTA PROJECT NO. 2022.04
INTERSTATE 95 OVER SPRUCE CREEK
AT MM 2.20 IN YORK, ME

WORKZONE

Temporary

Concrete


Barrier


/'-0"


LANE CLOSURE CRITICAL SECTIONS (1 OF 2)


VHB: 55345.00 SHEET NUMBER: 18
CONTRACT: 2022.04 18 OF **117**


MTA PROJECT MANAGER: RALPH C. NORWOOD, IV

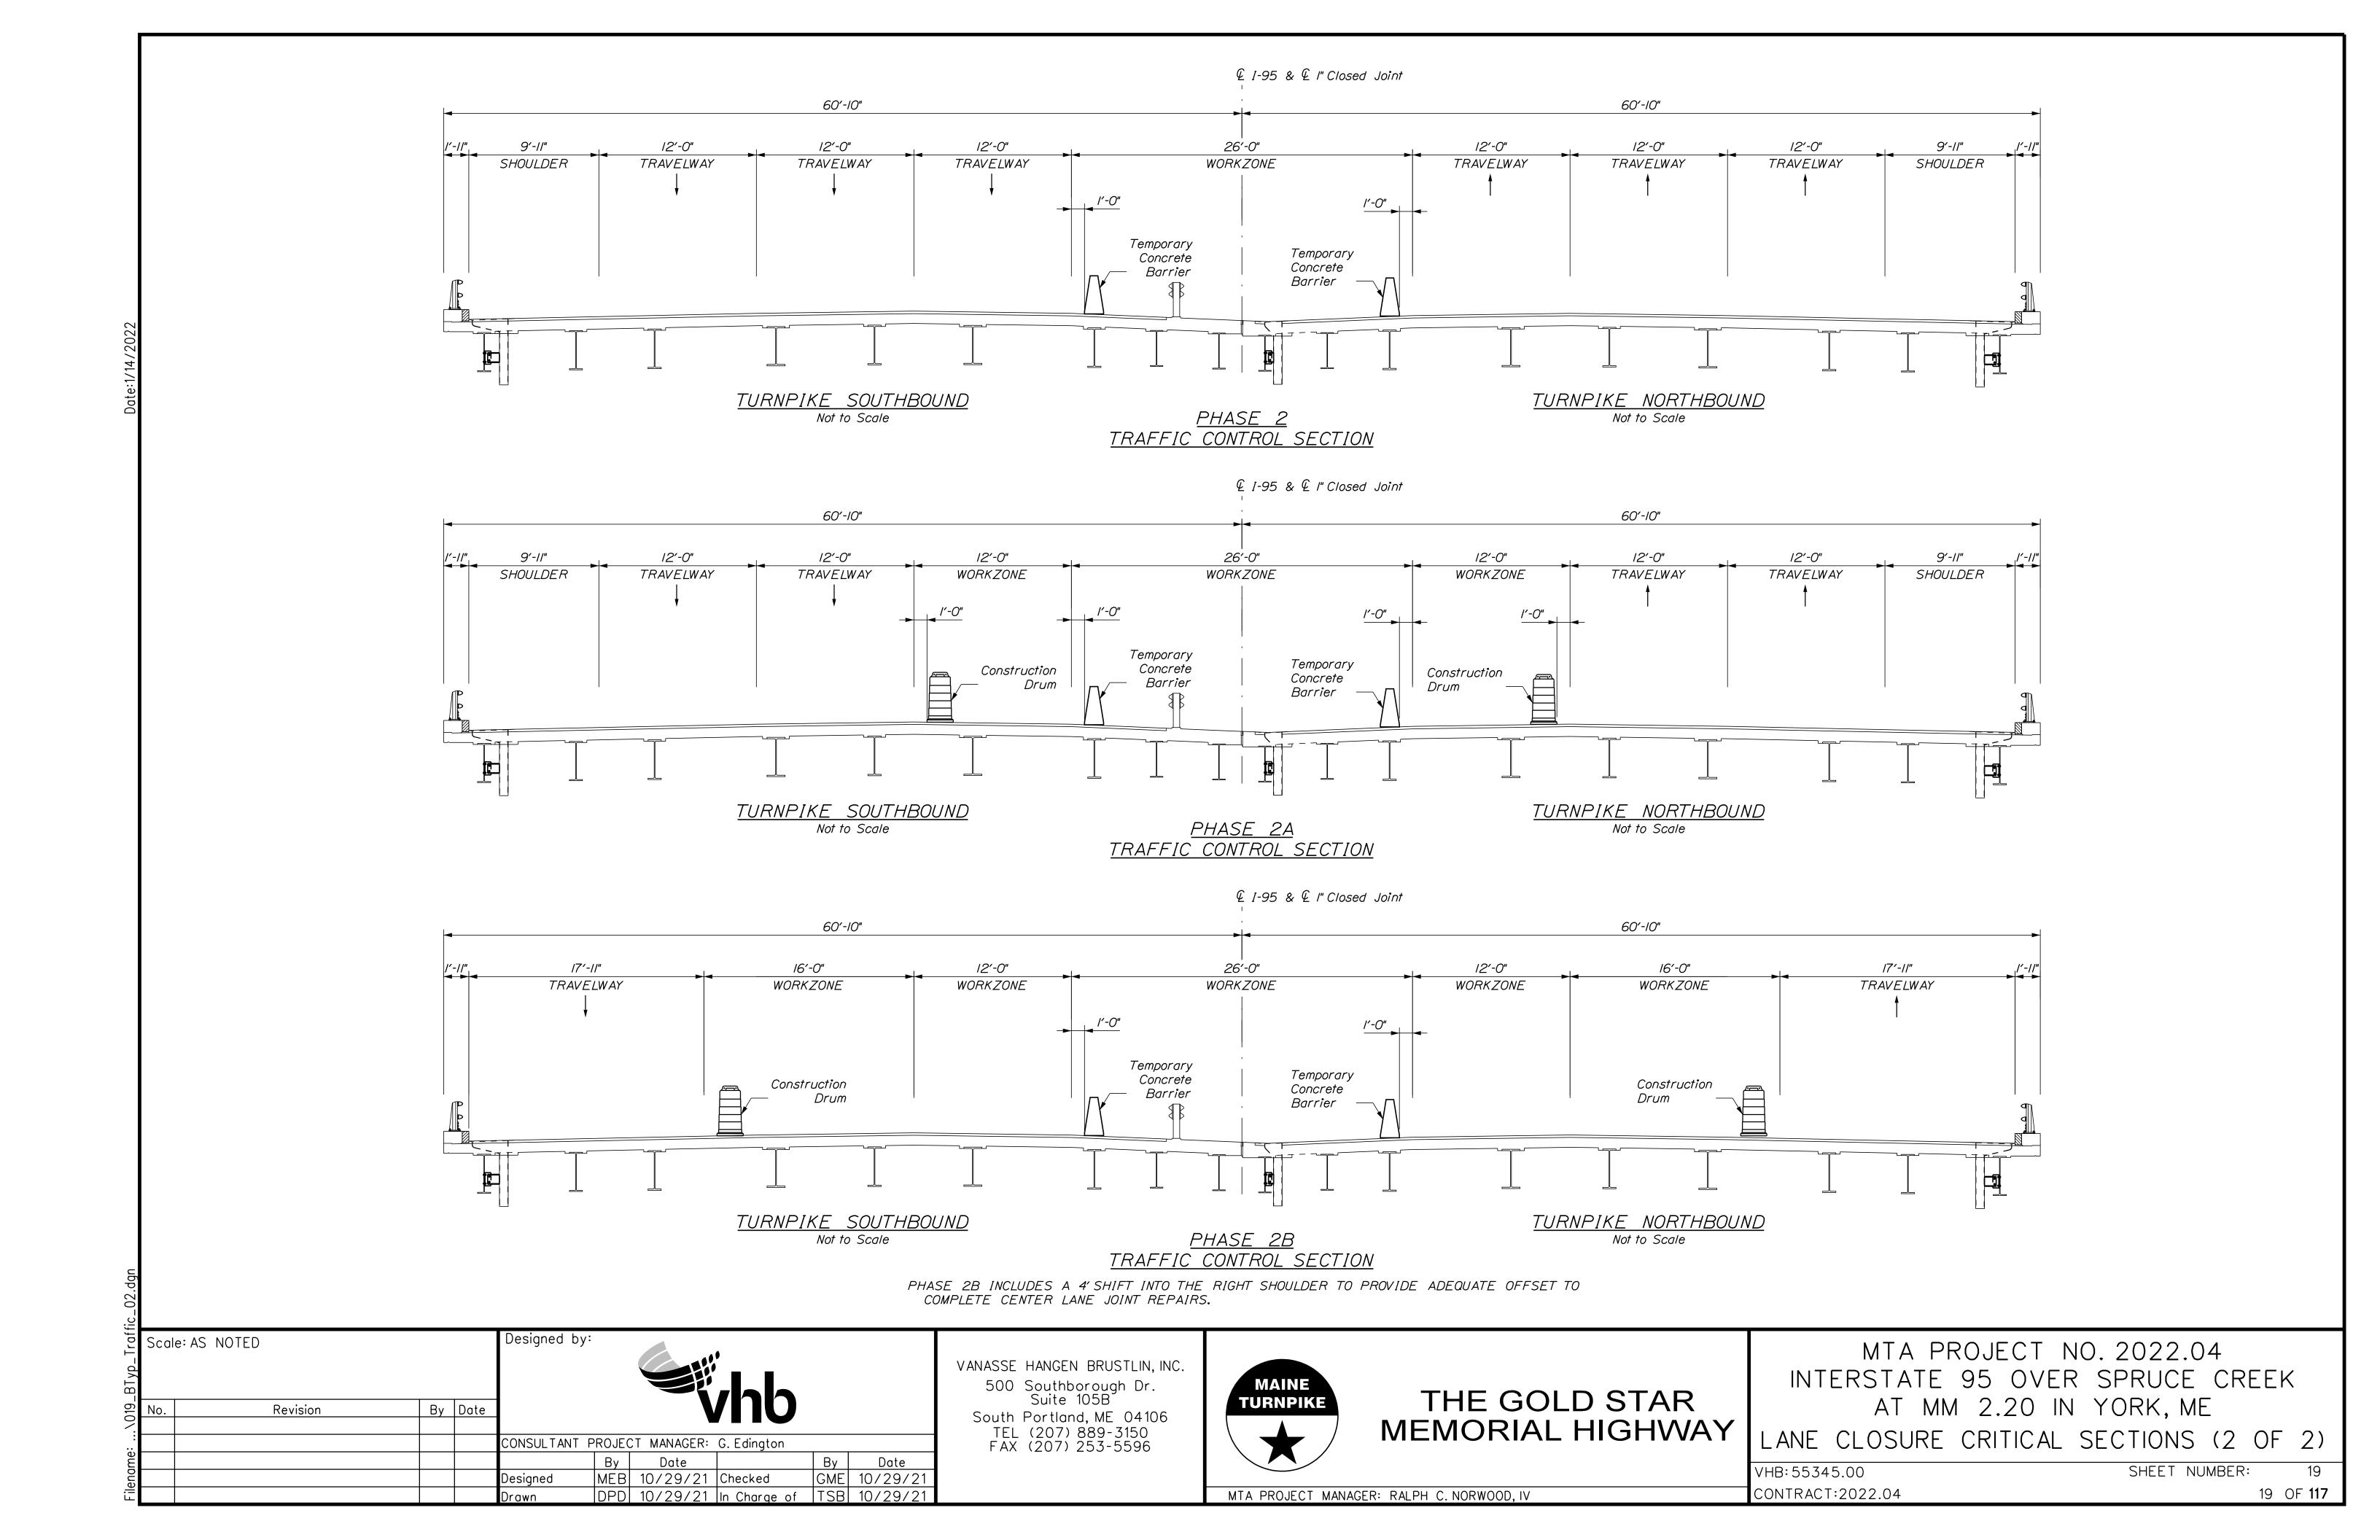


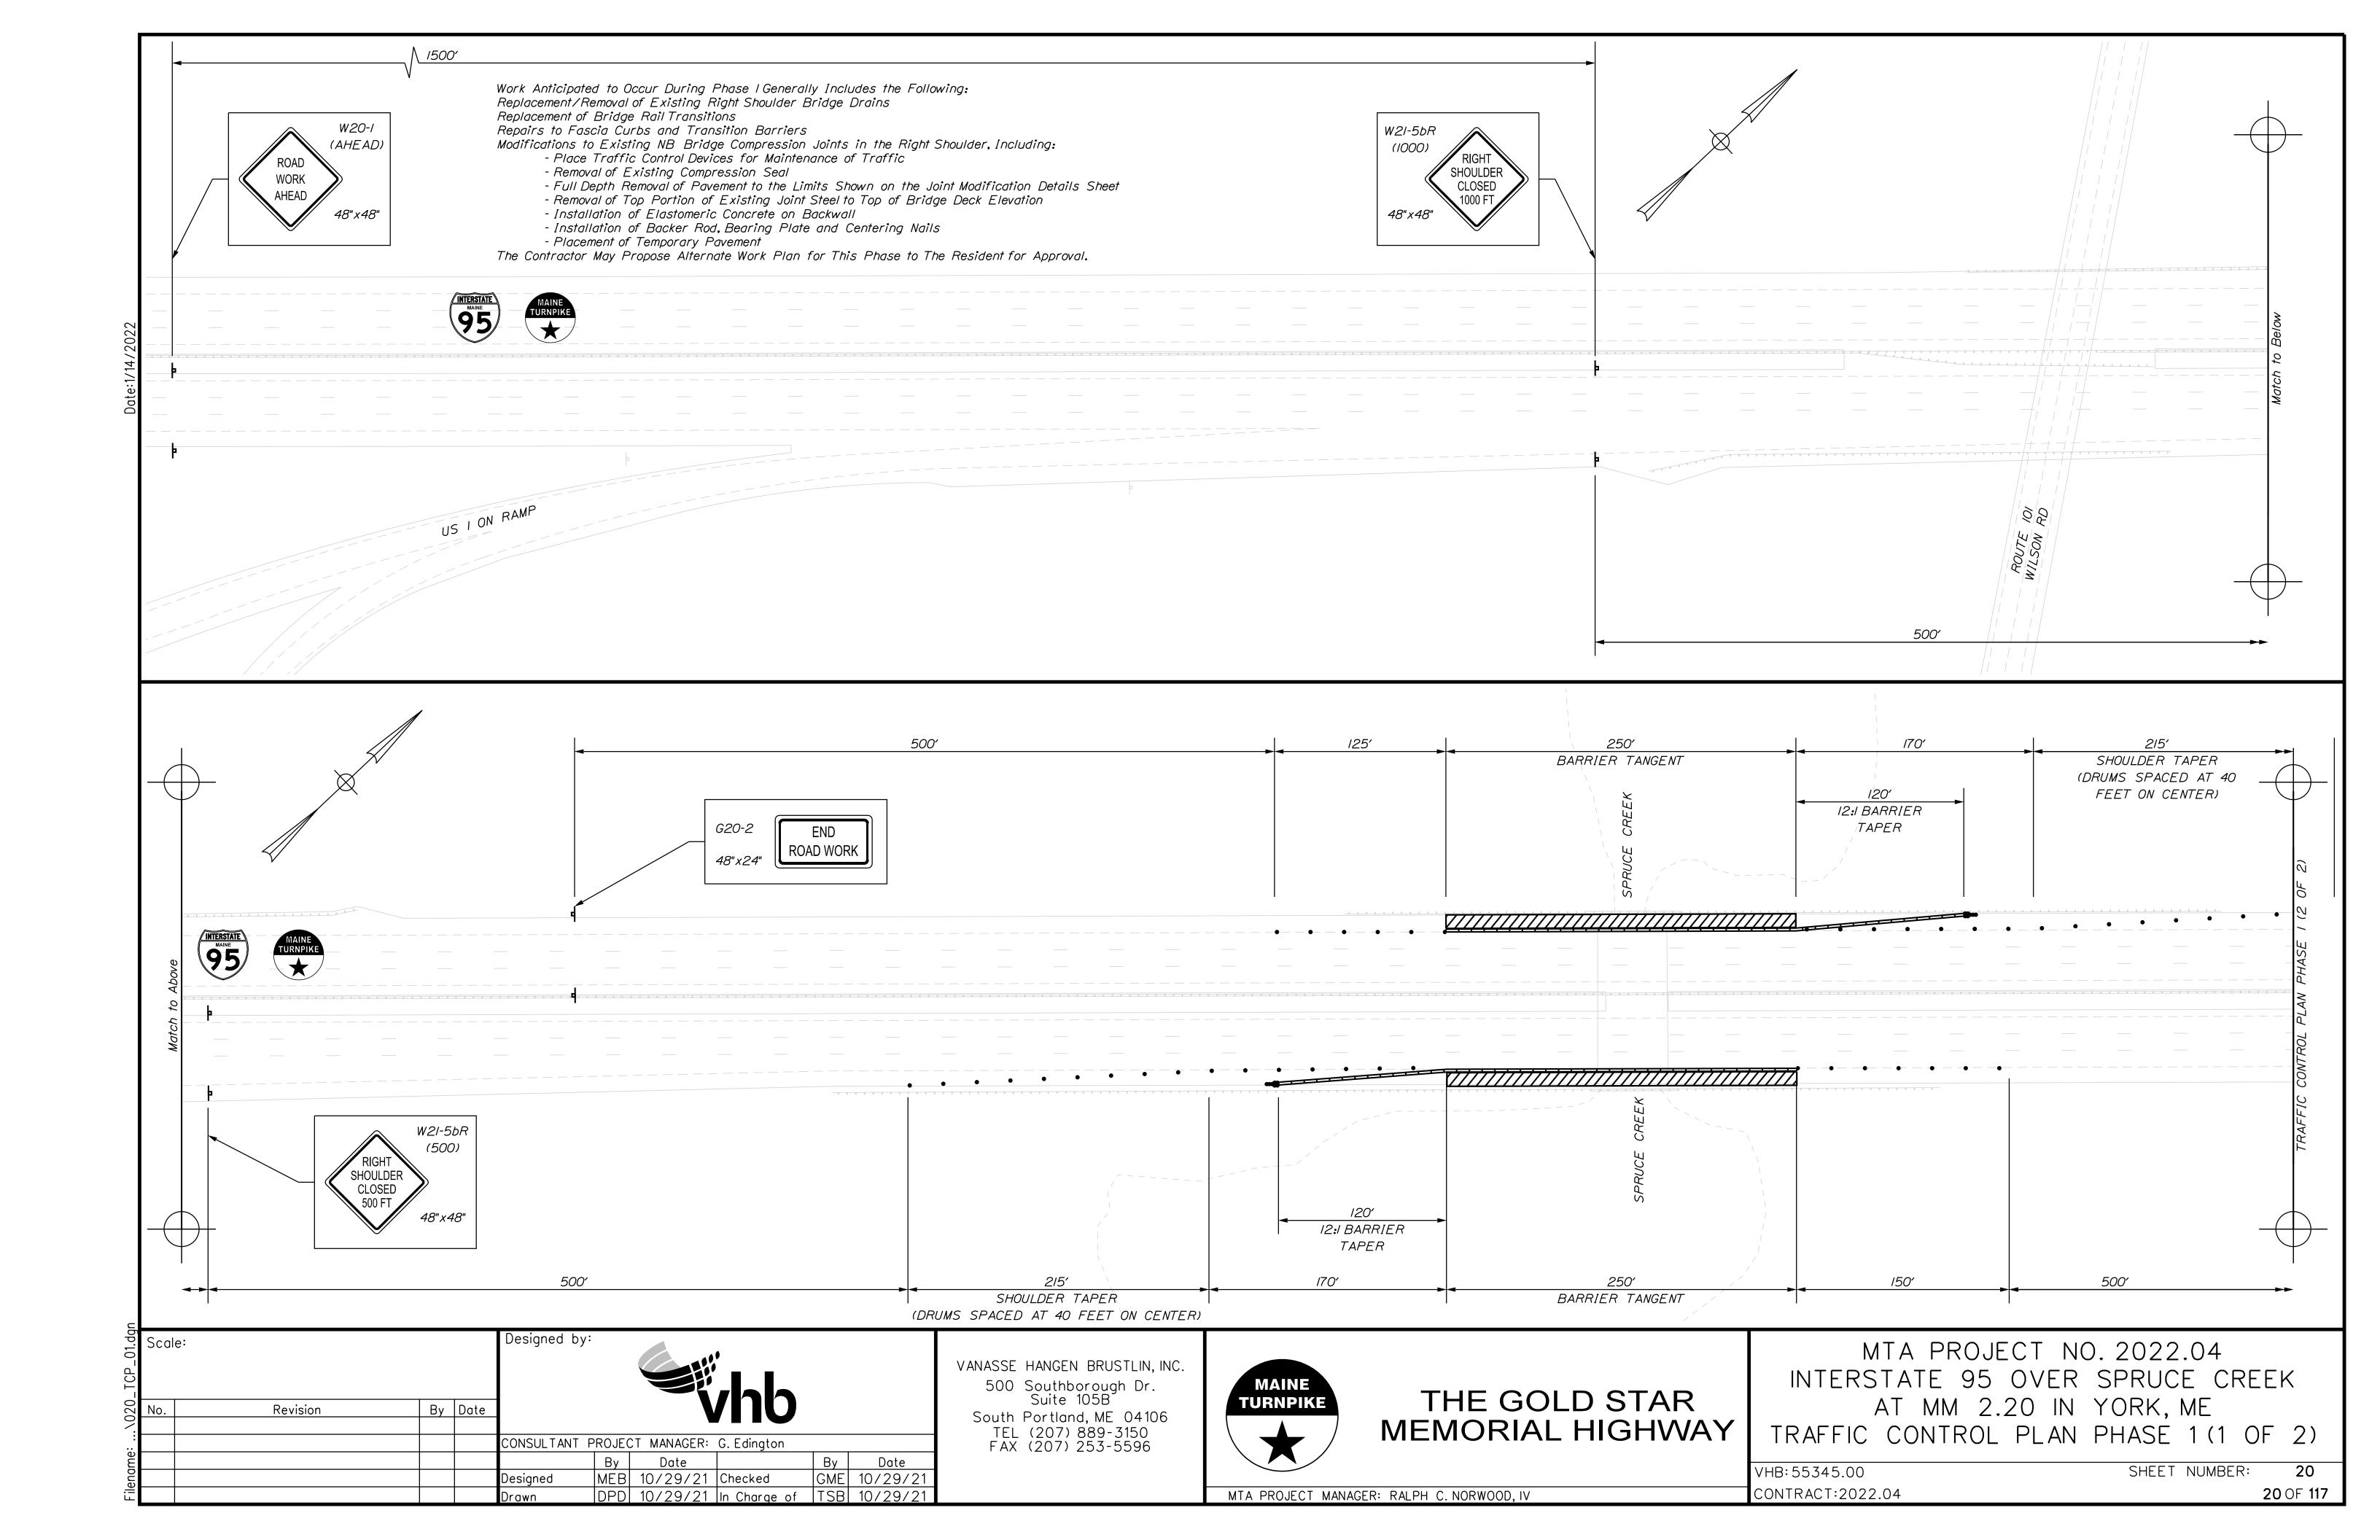


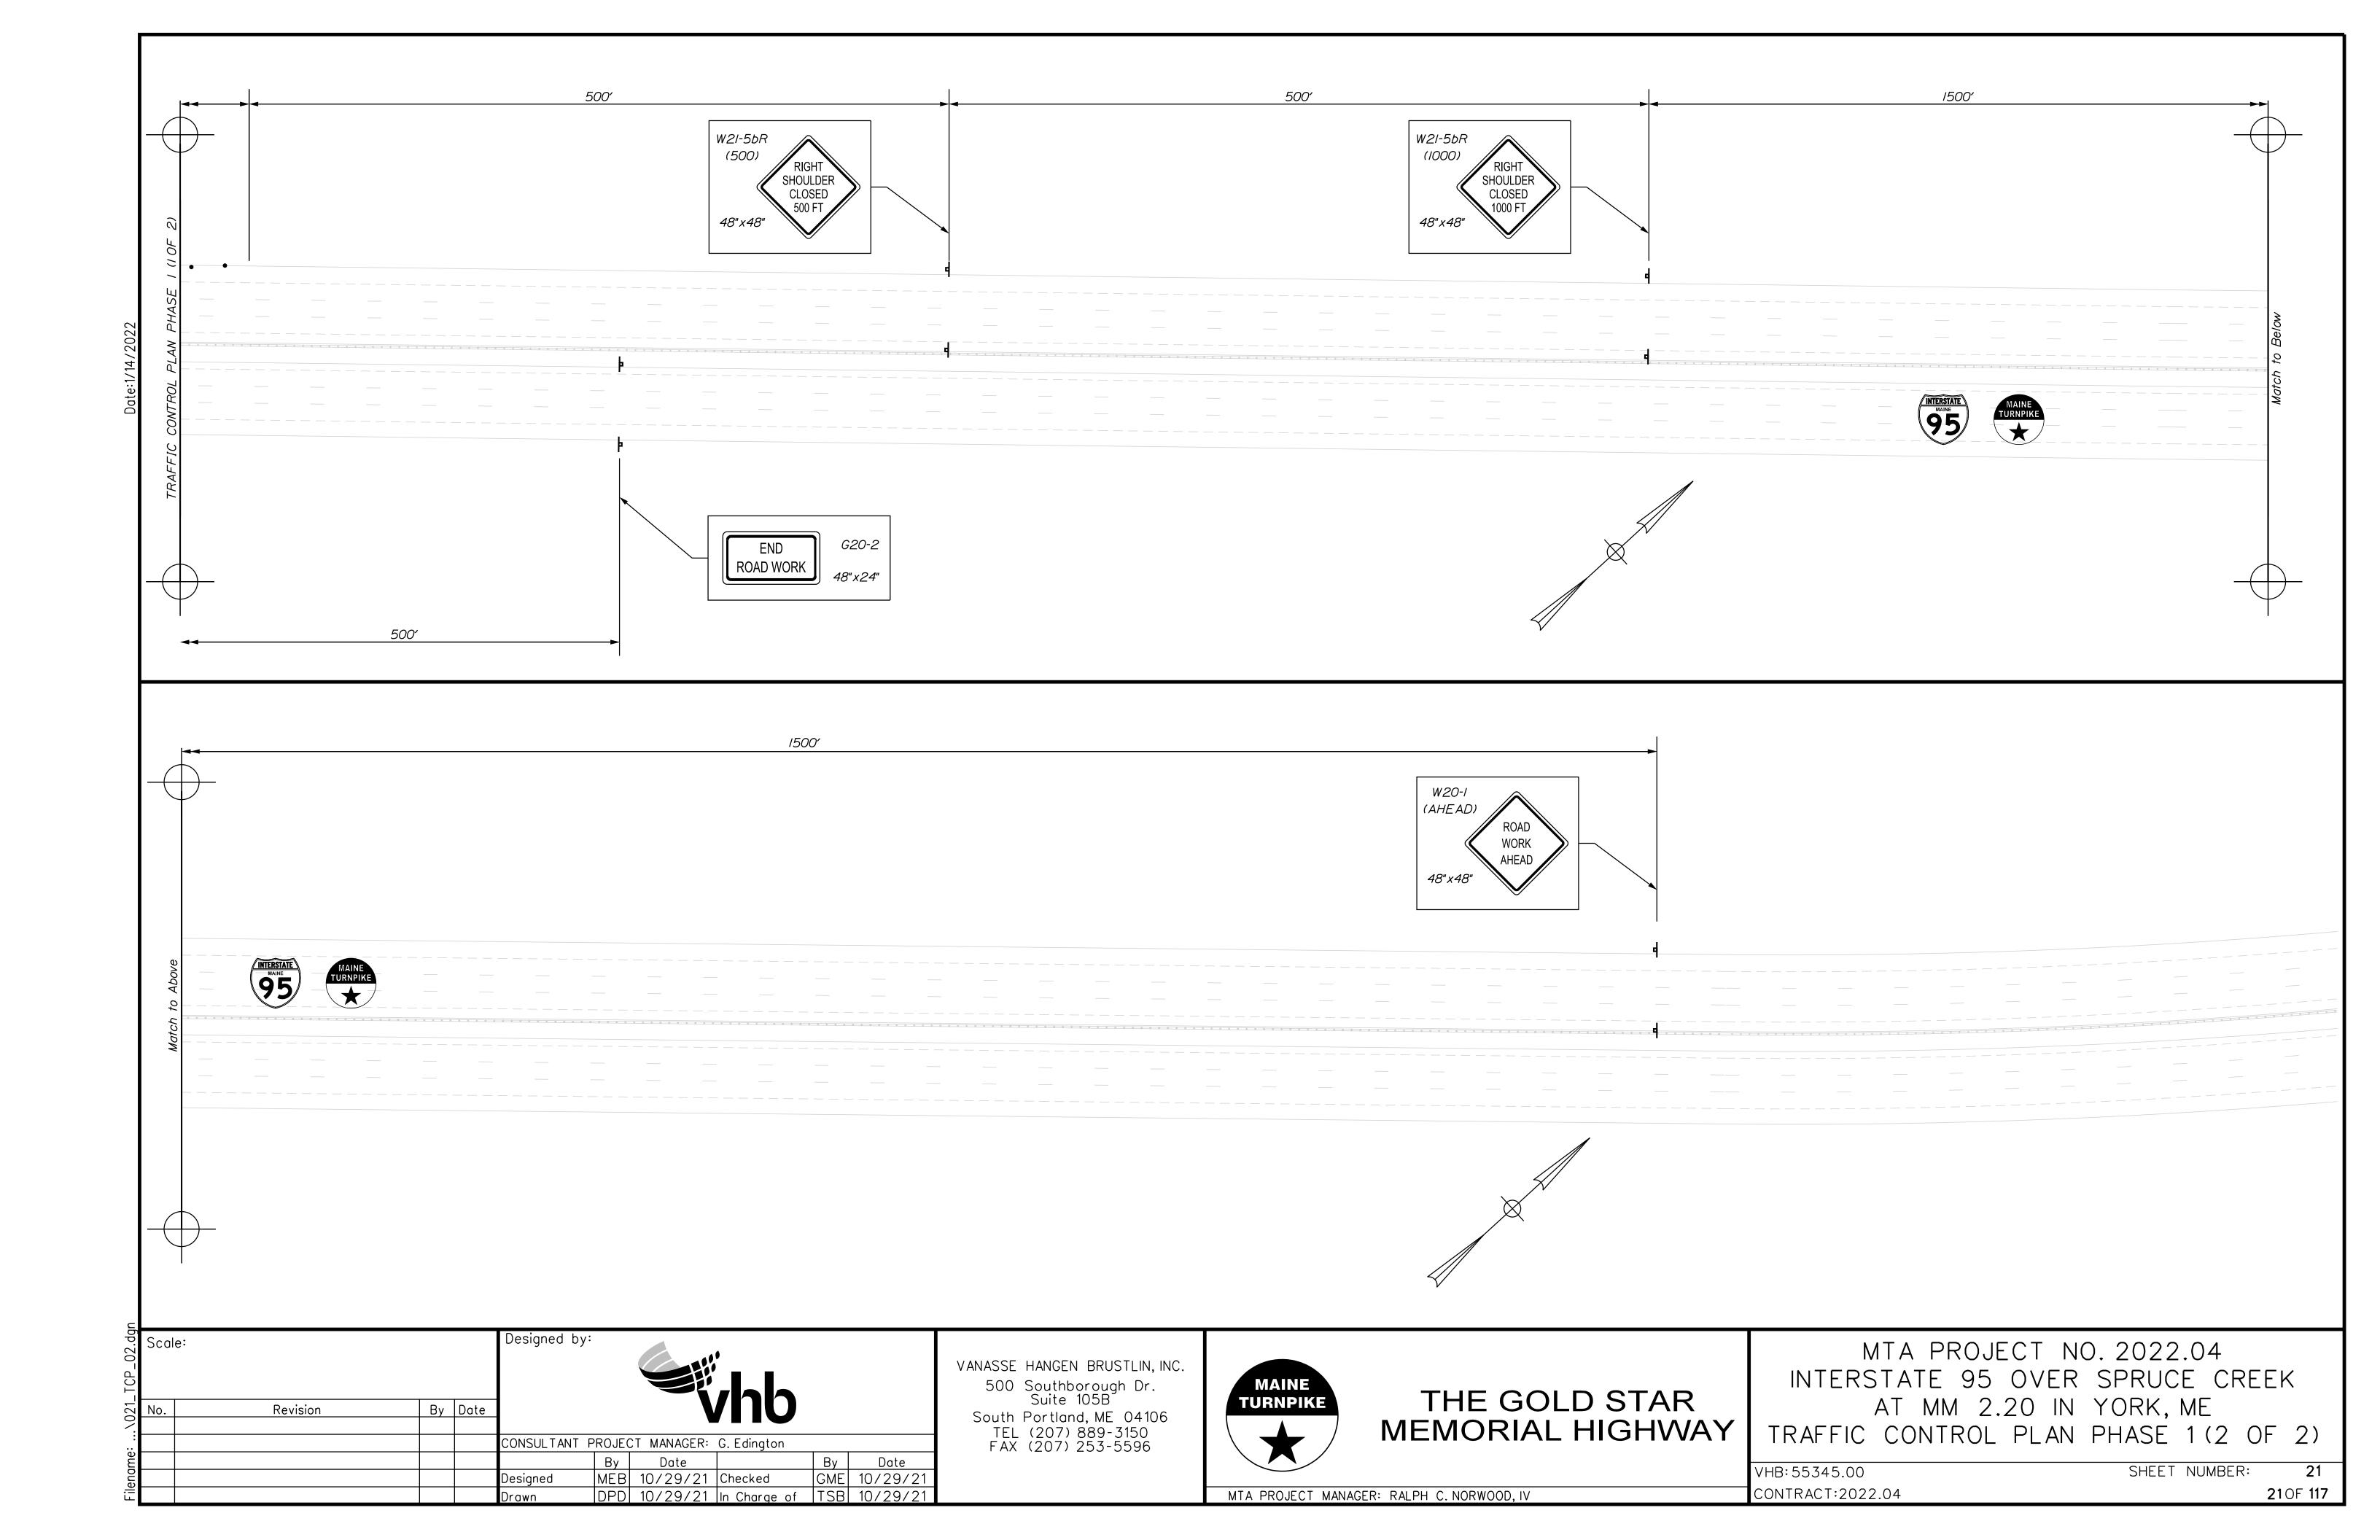


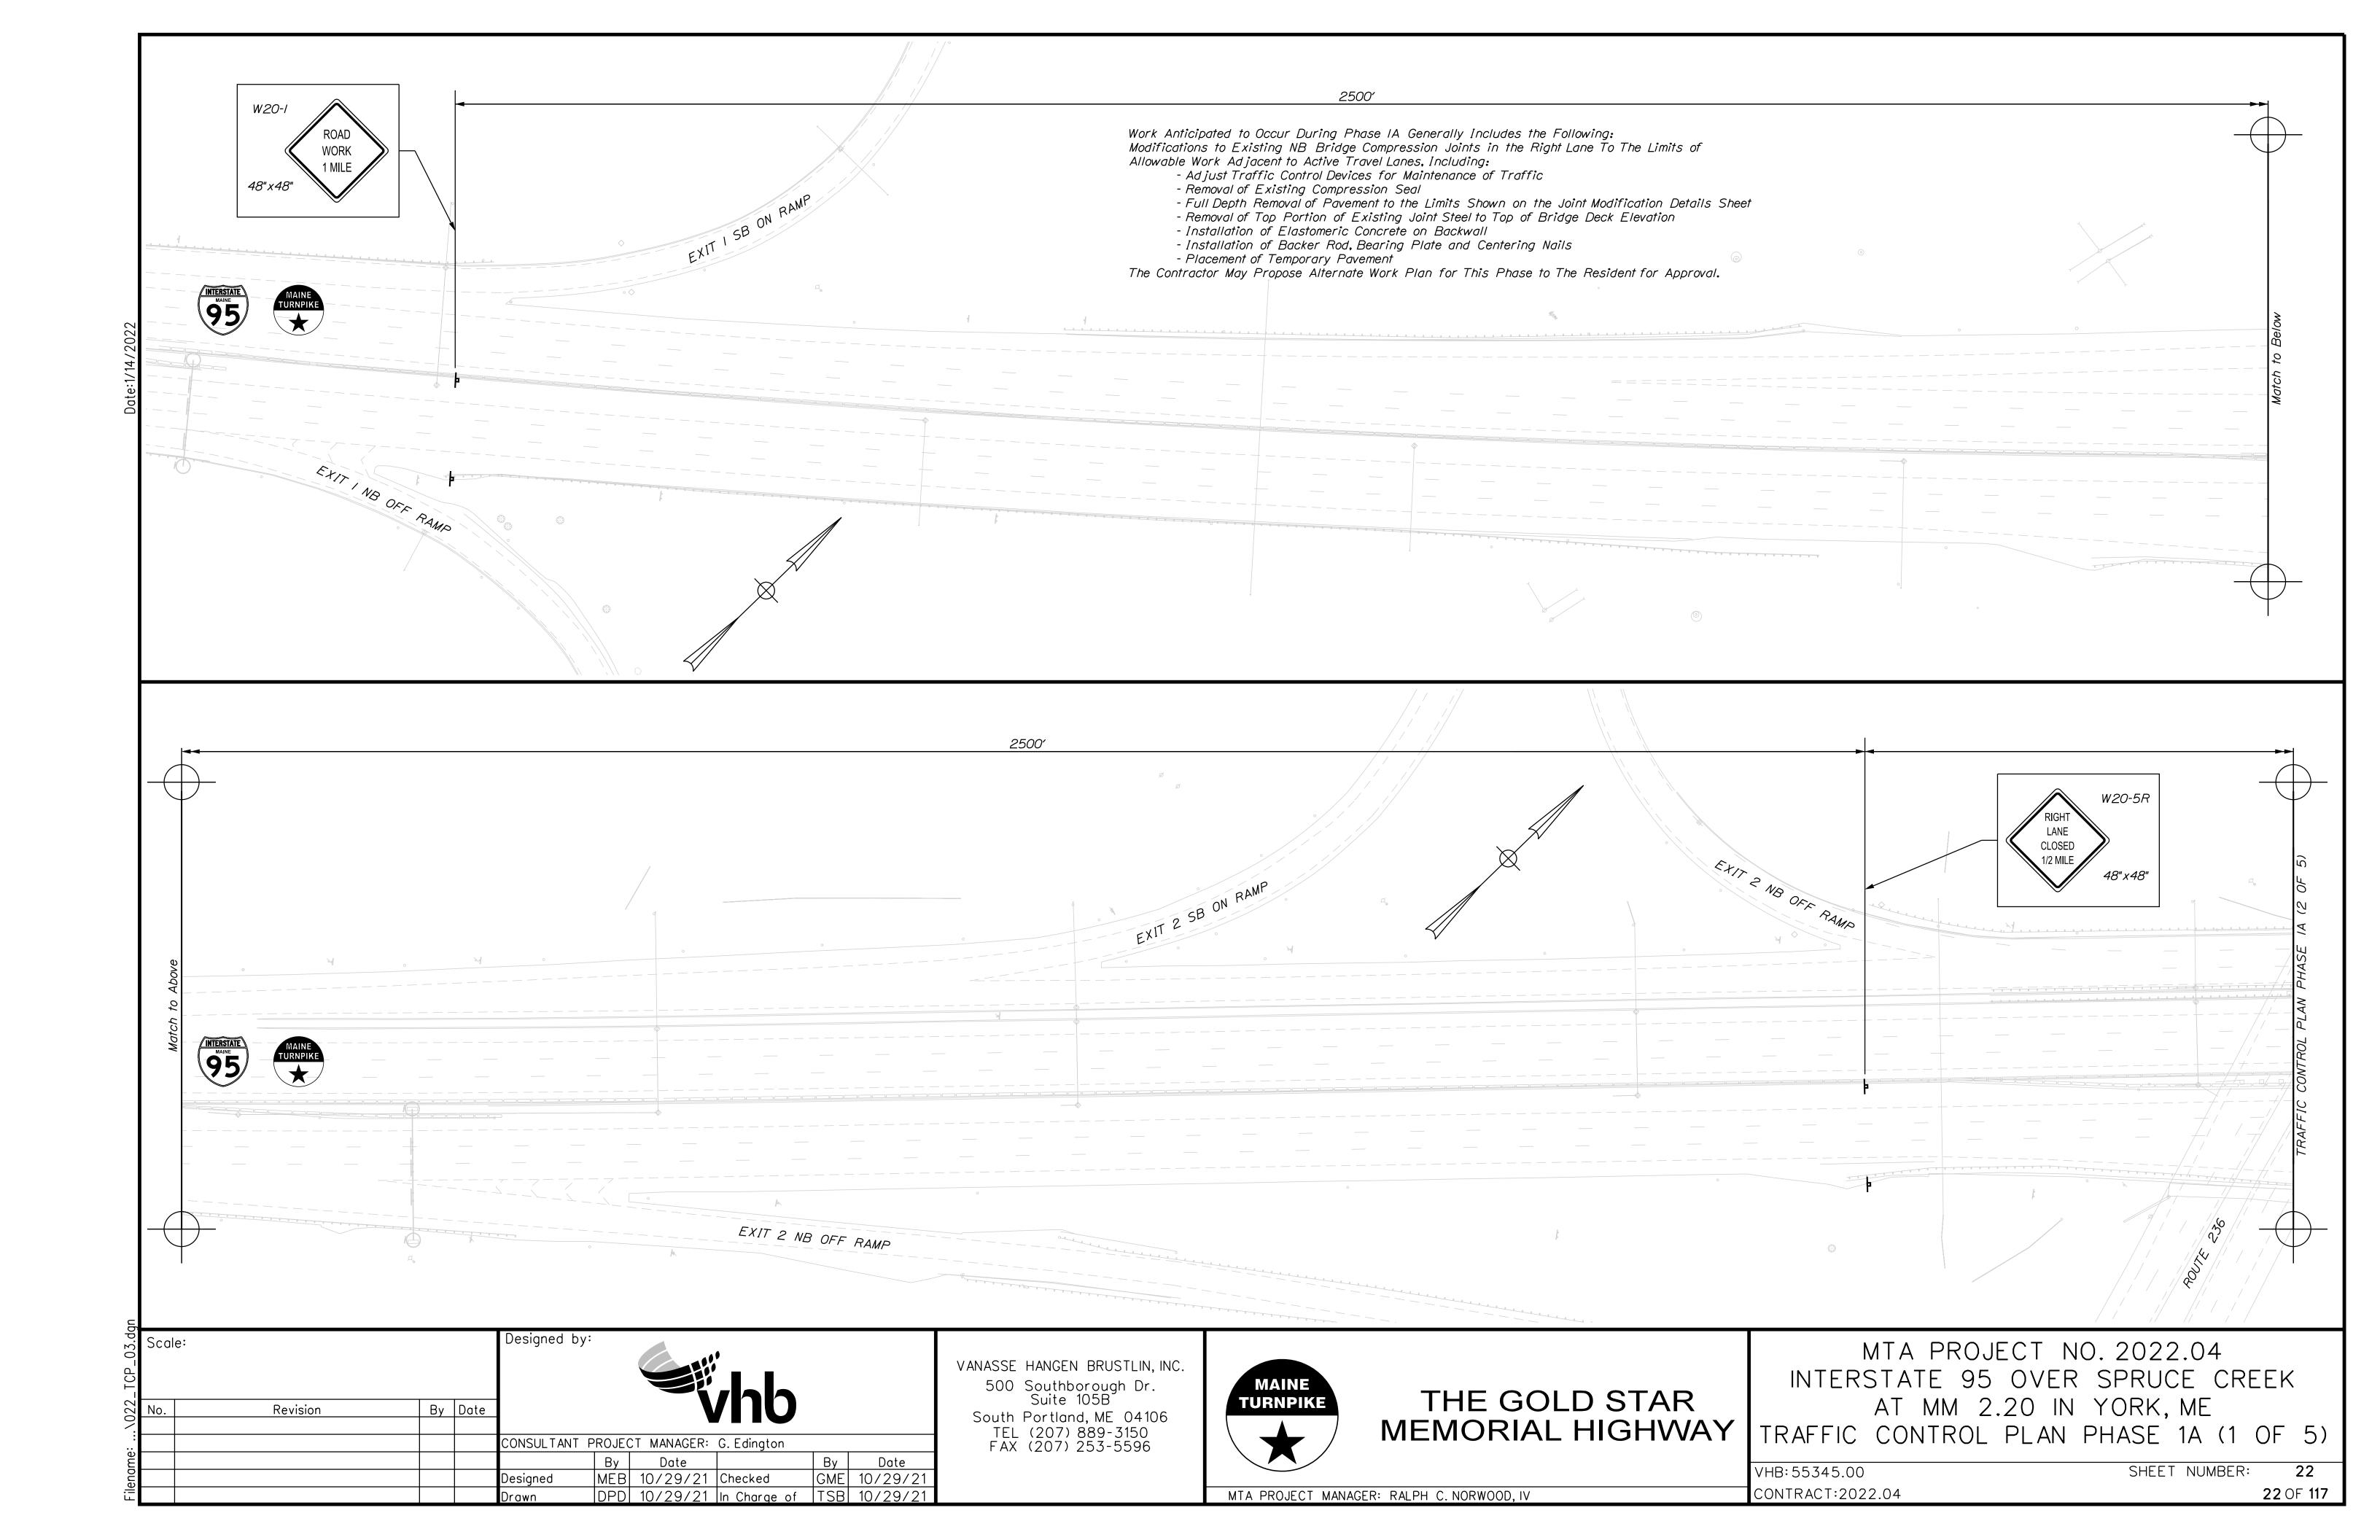


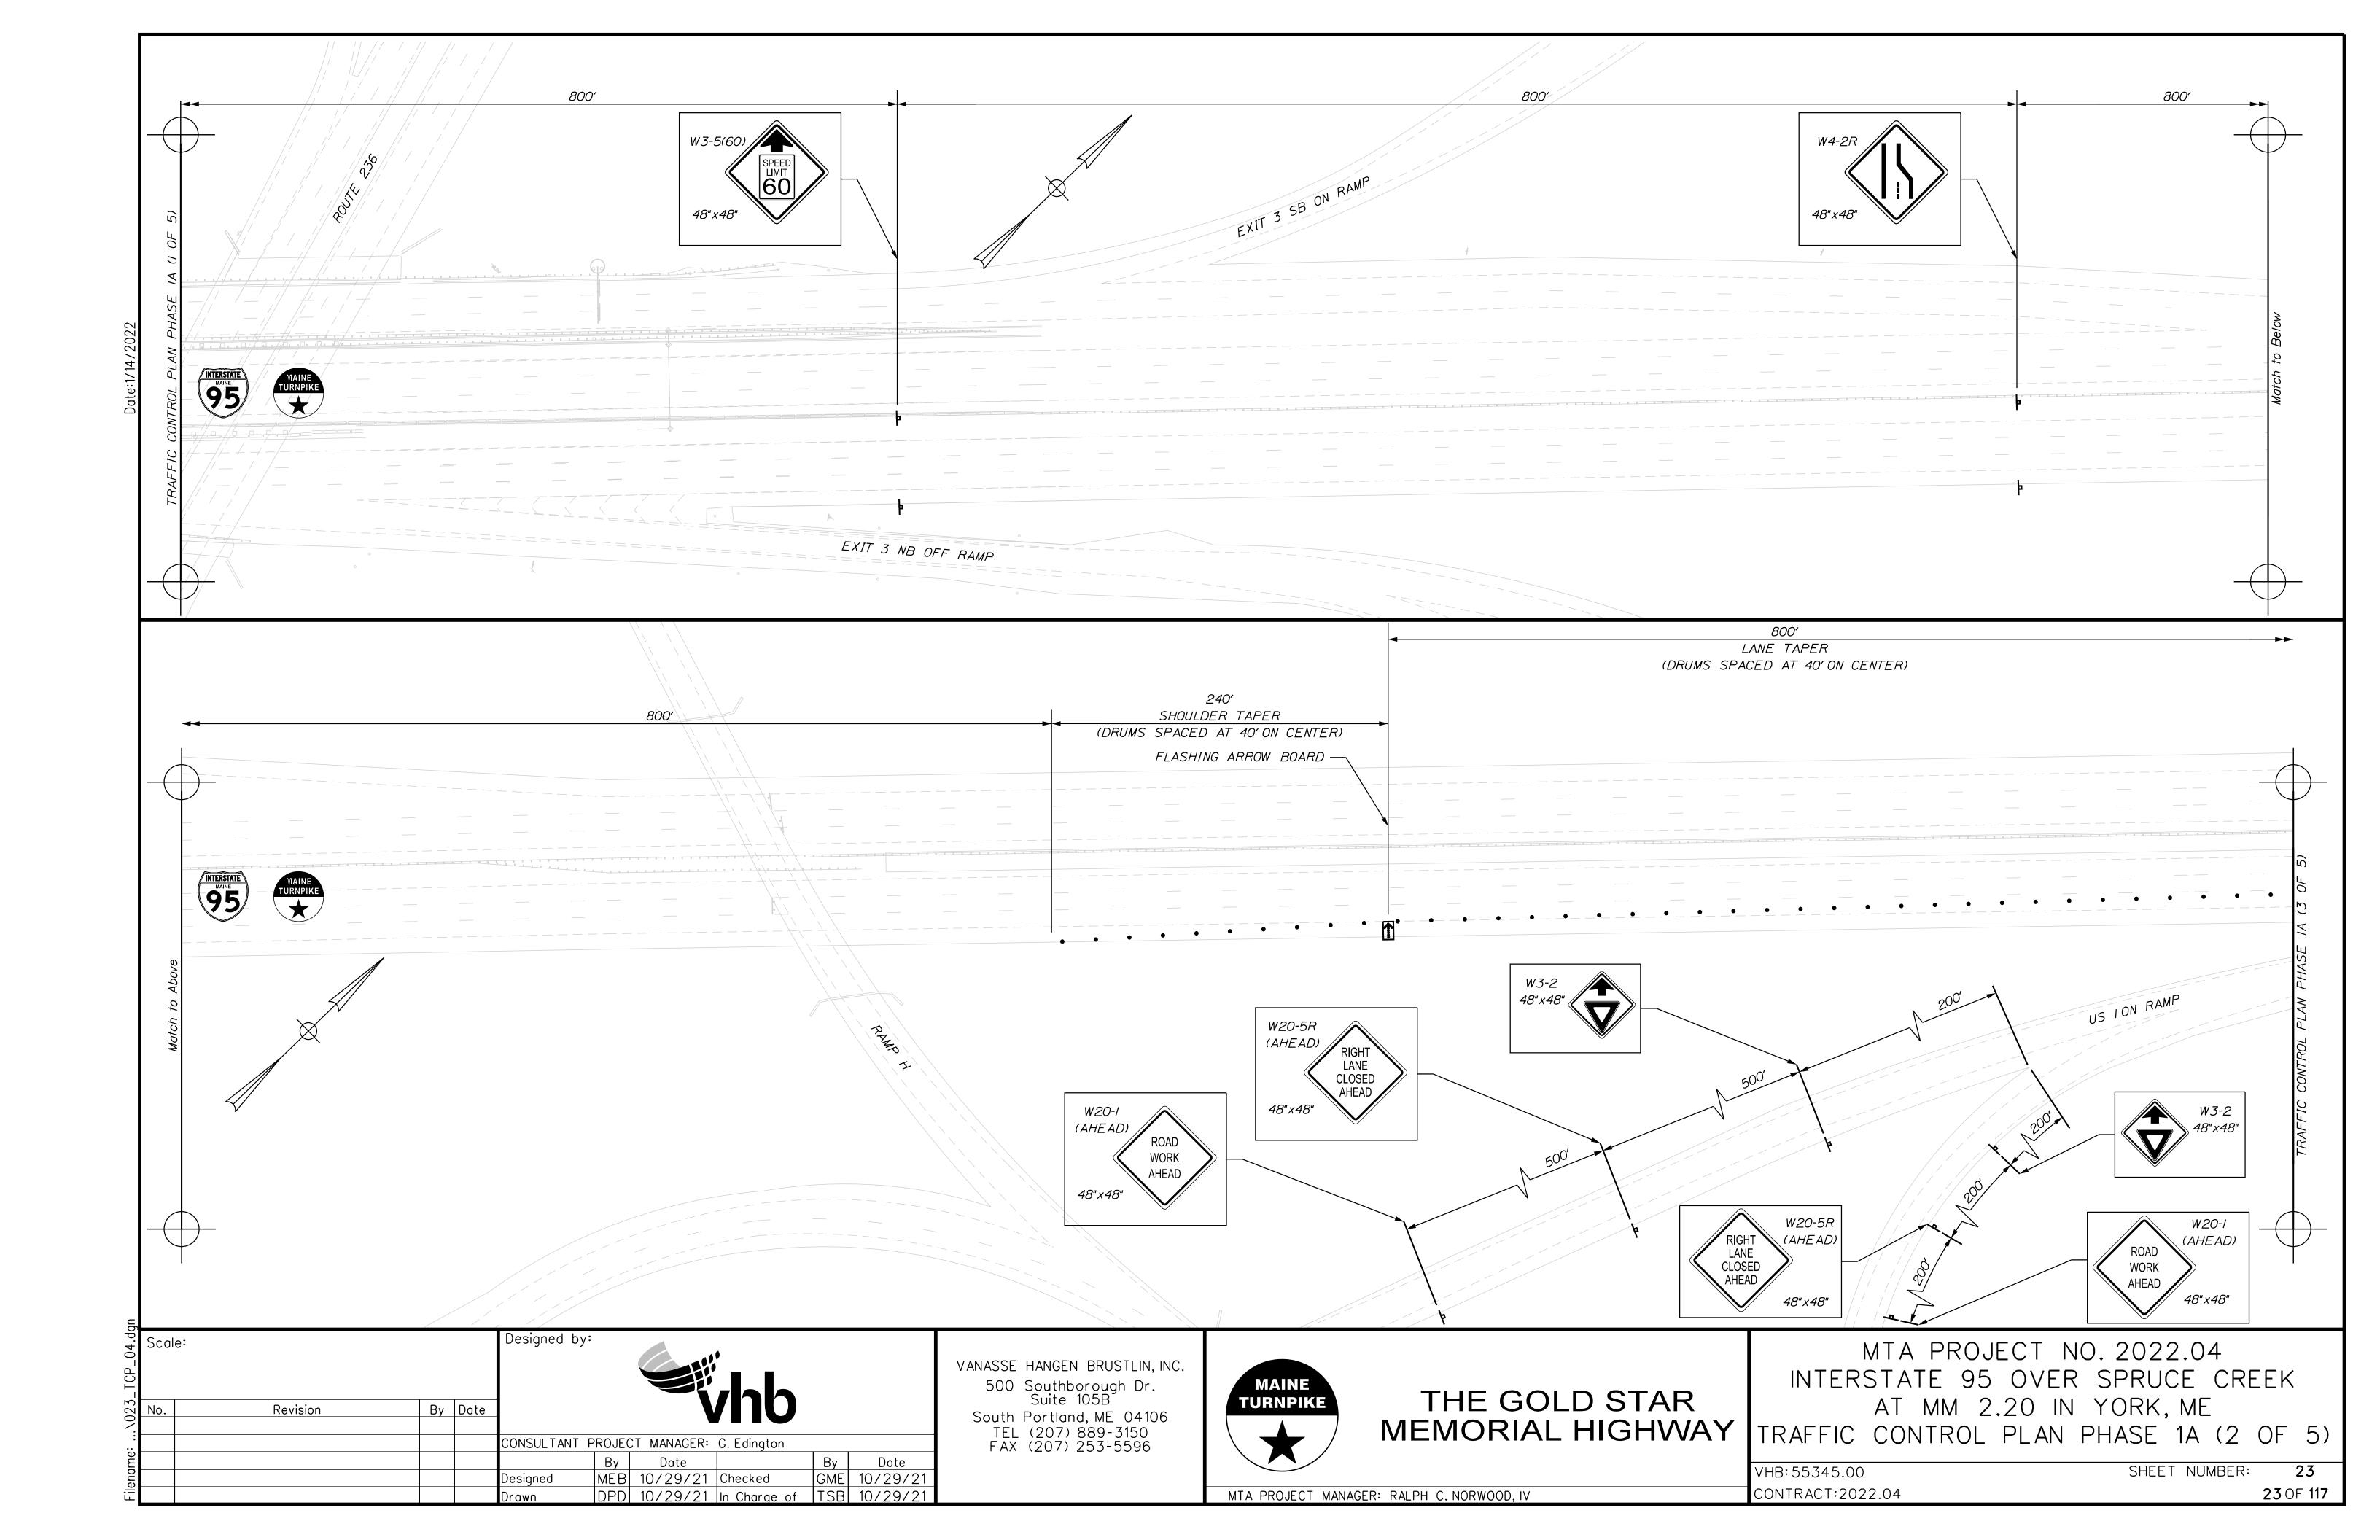


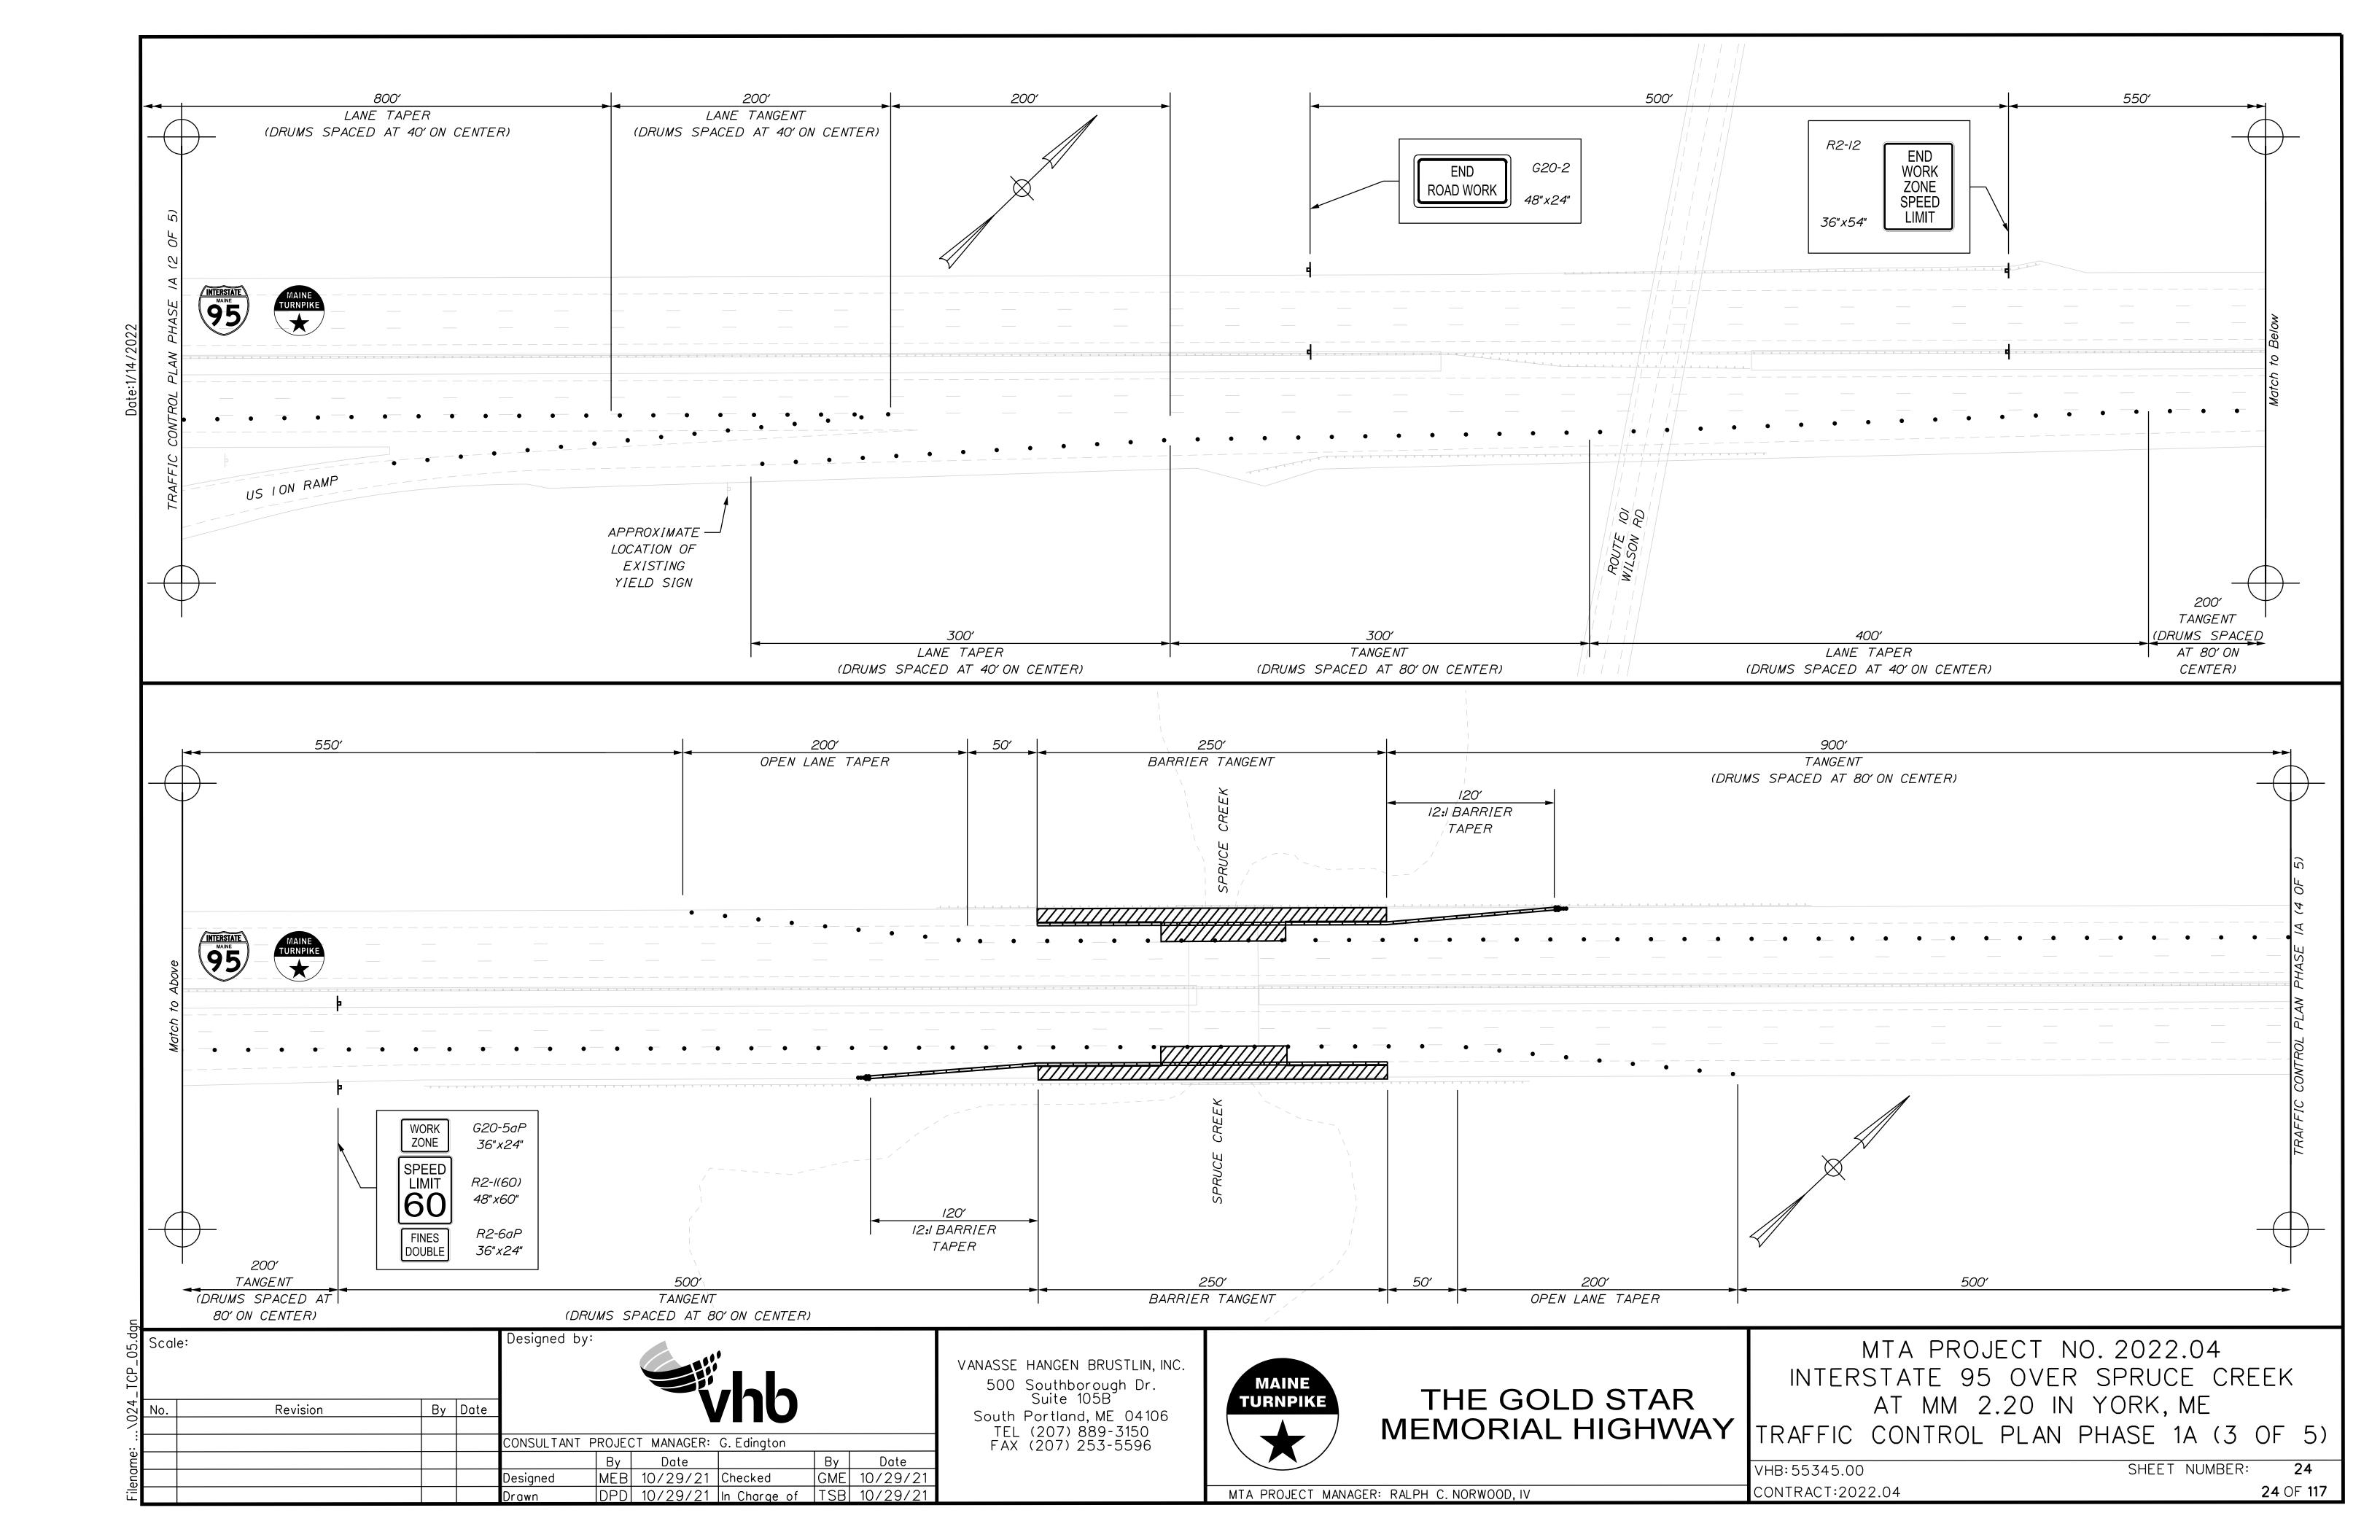


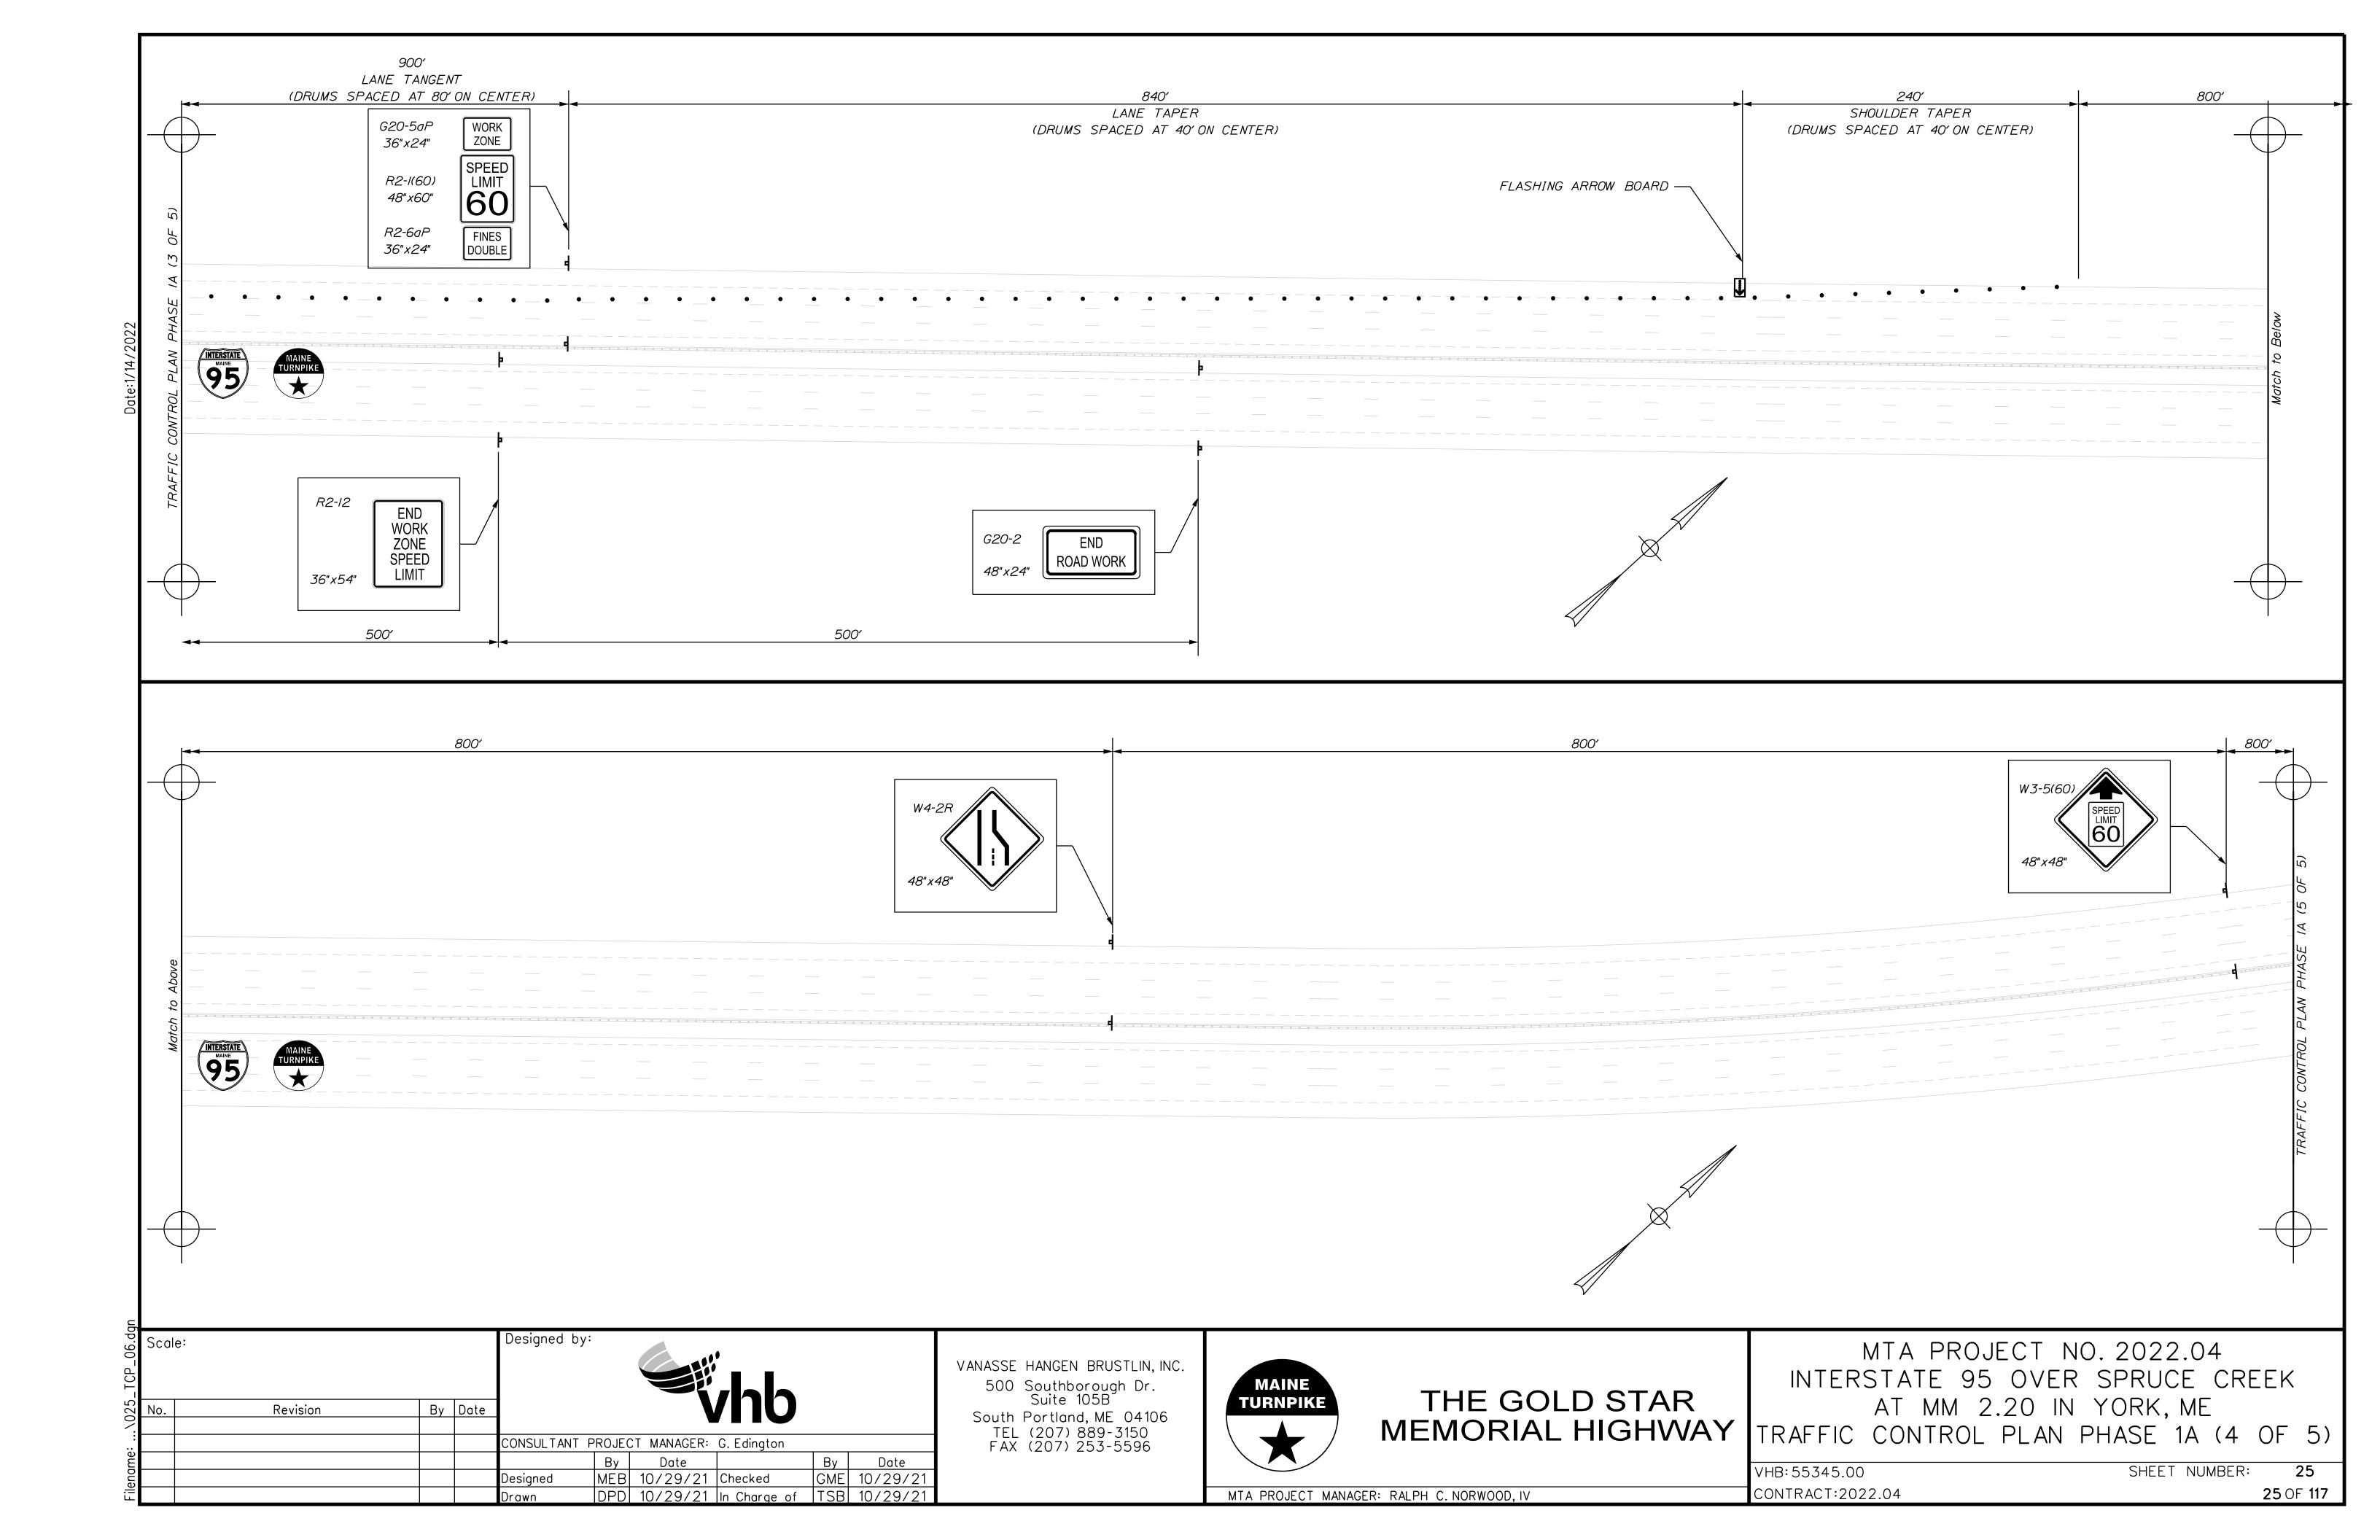


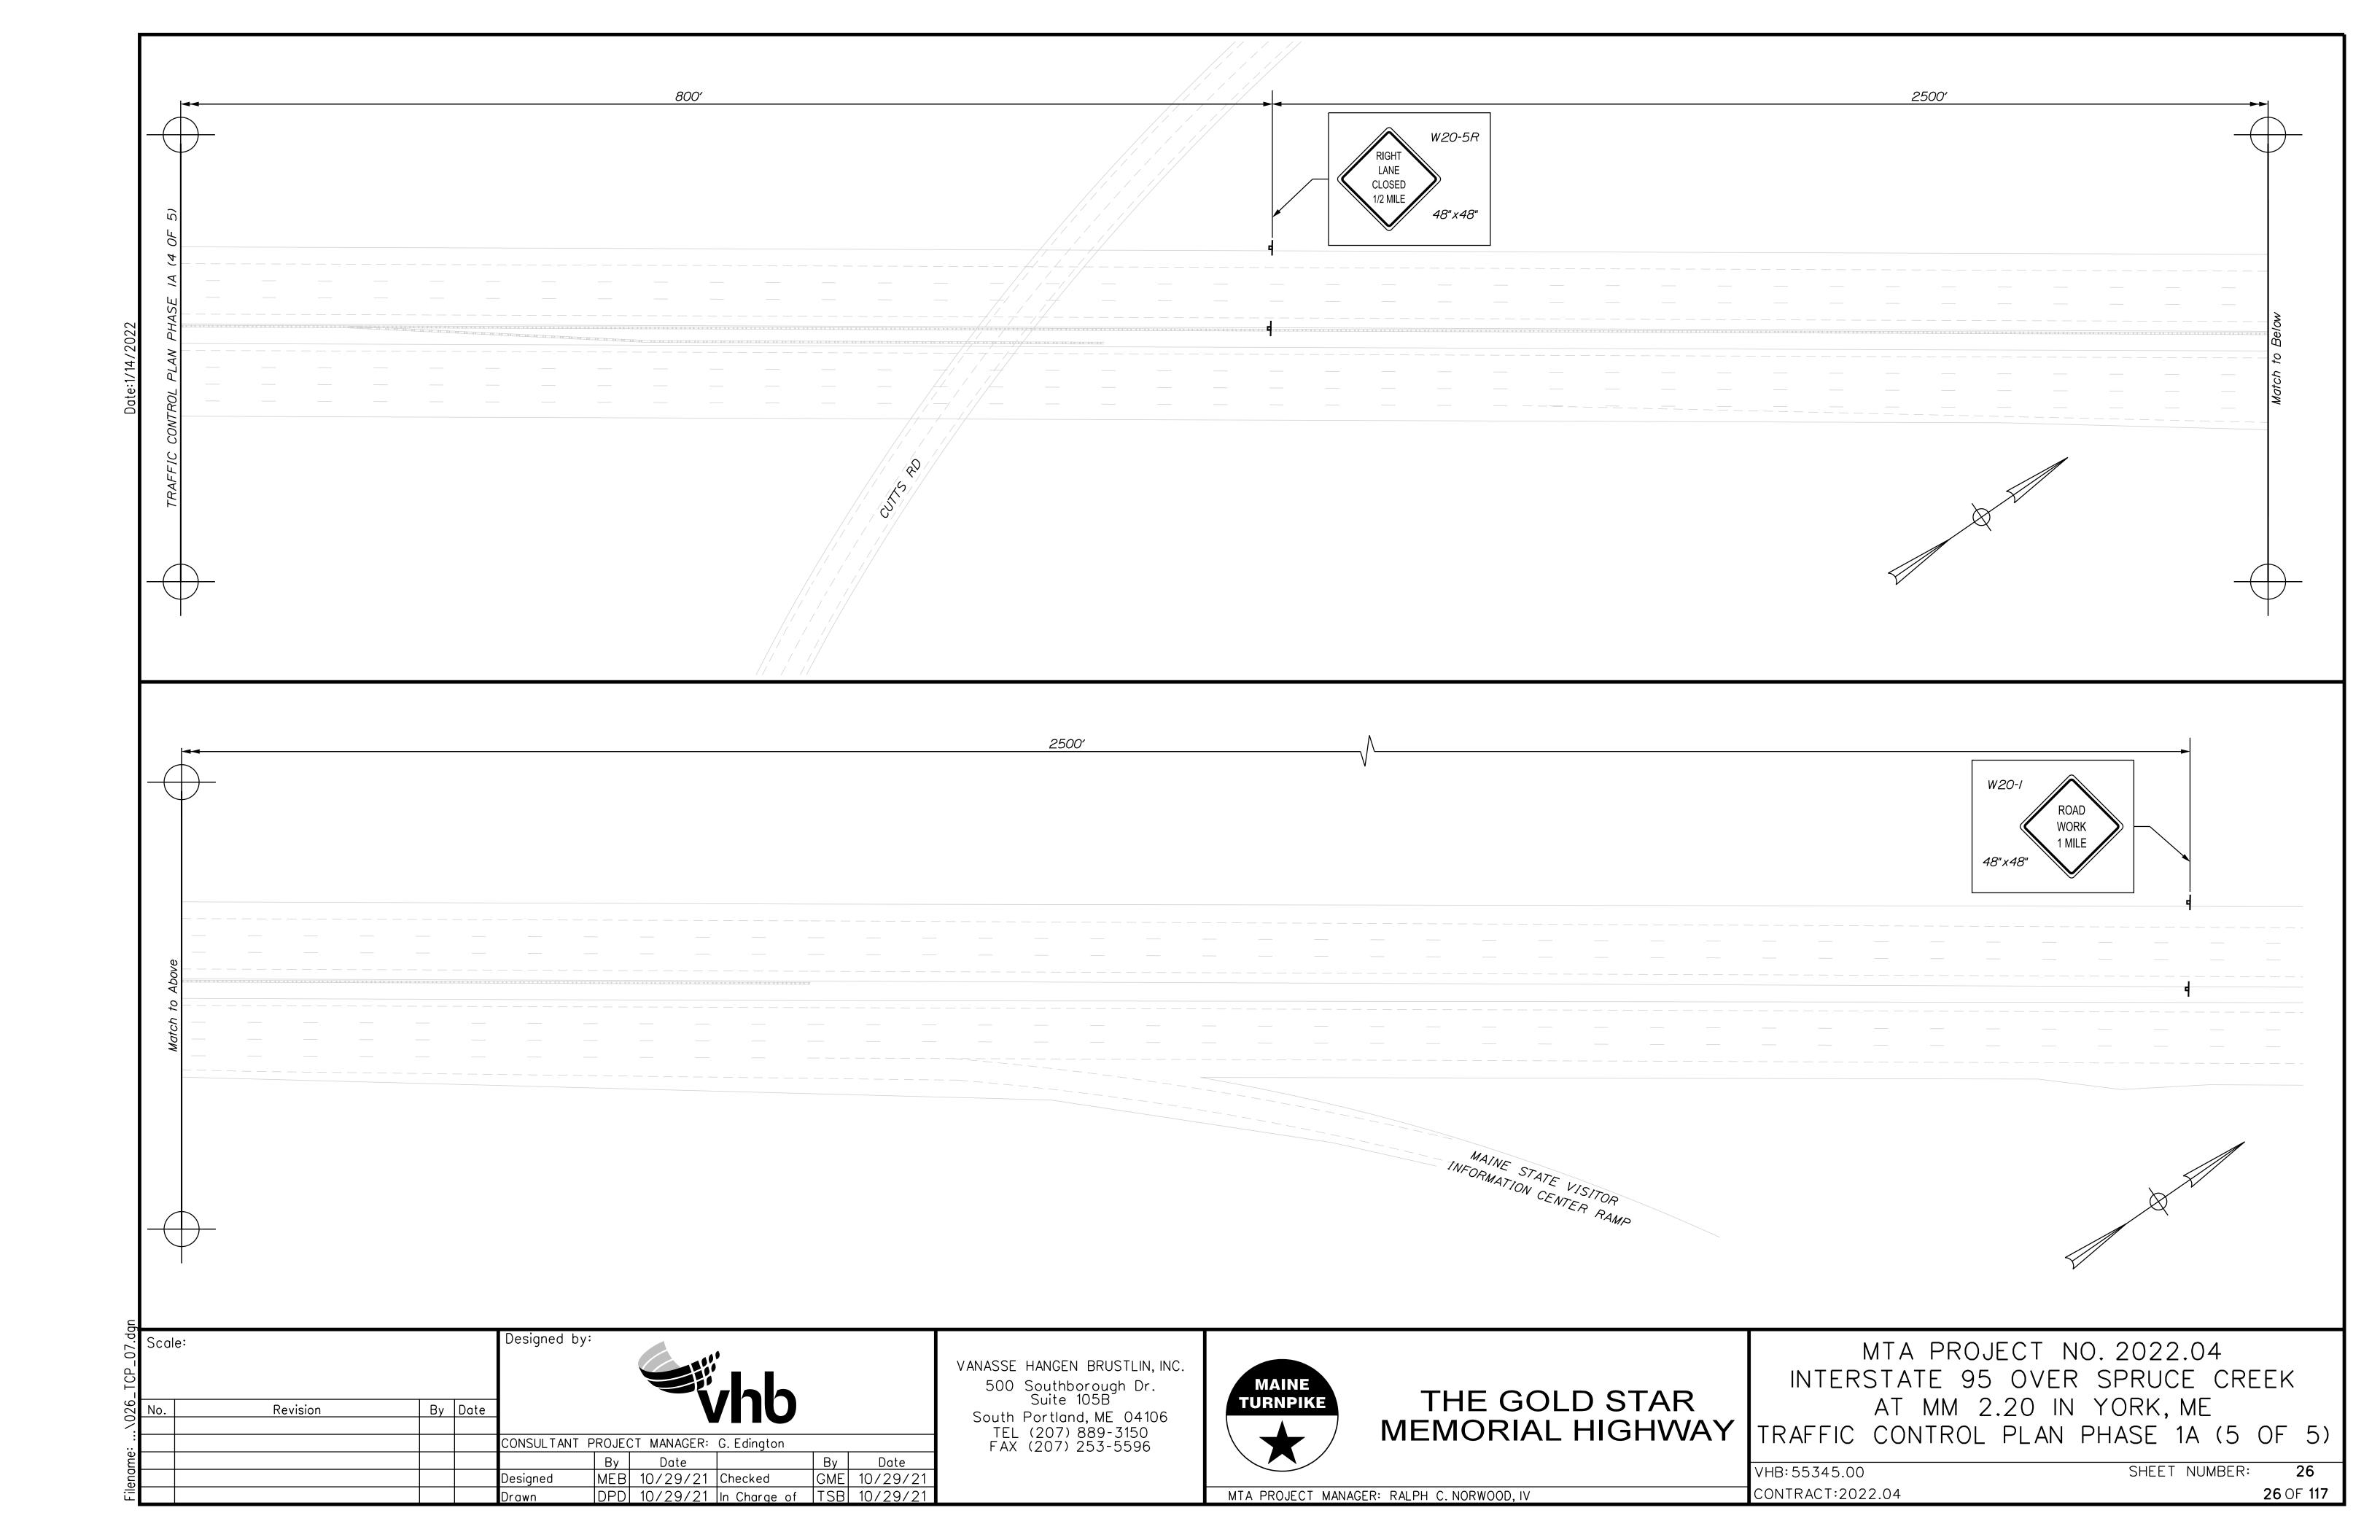


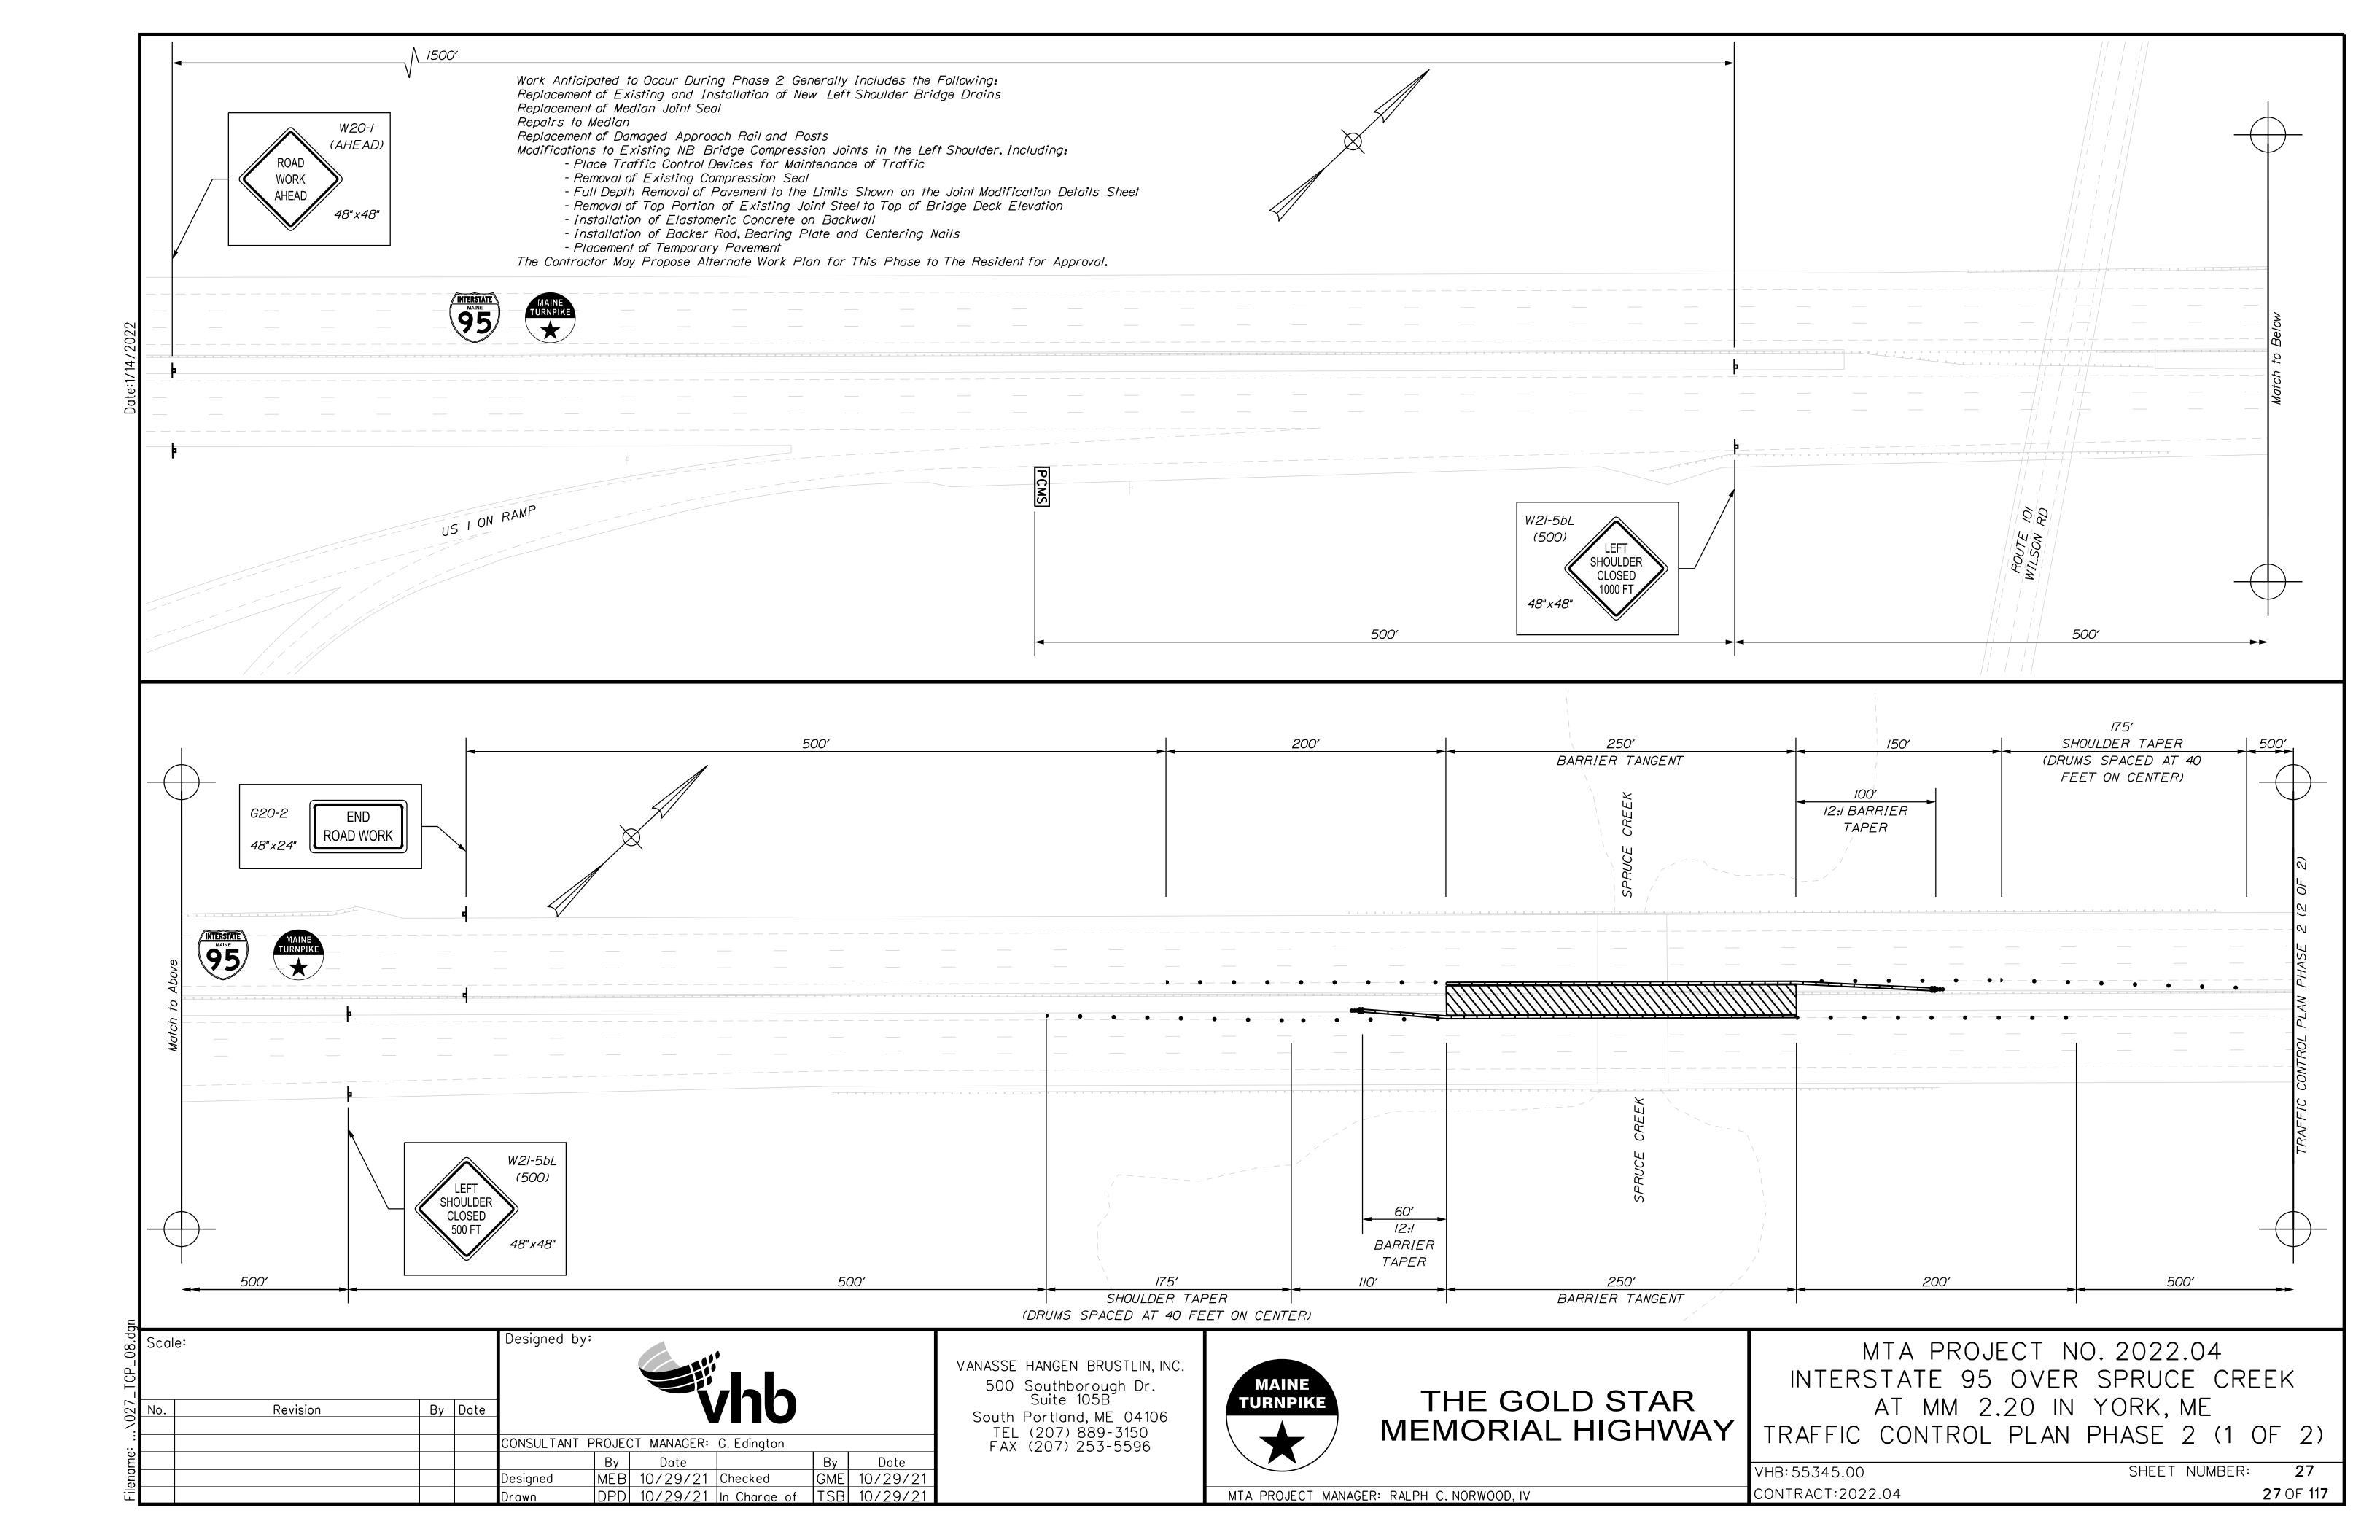


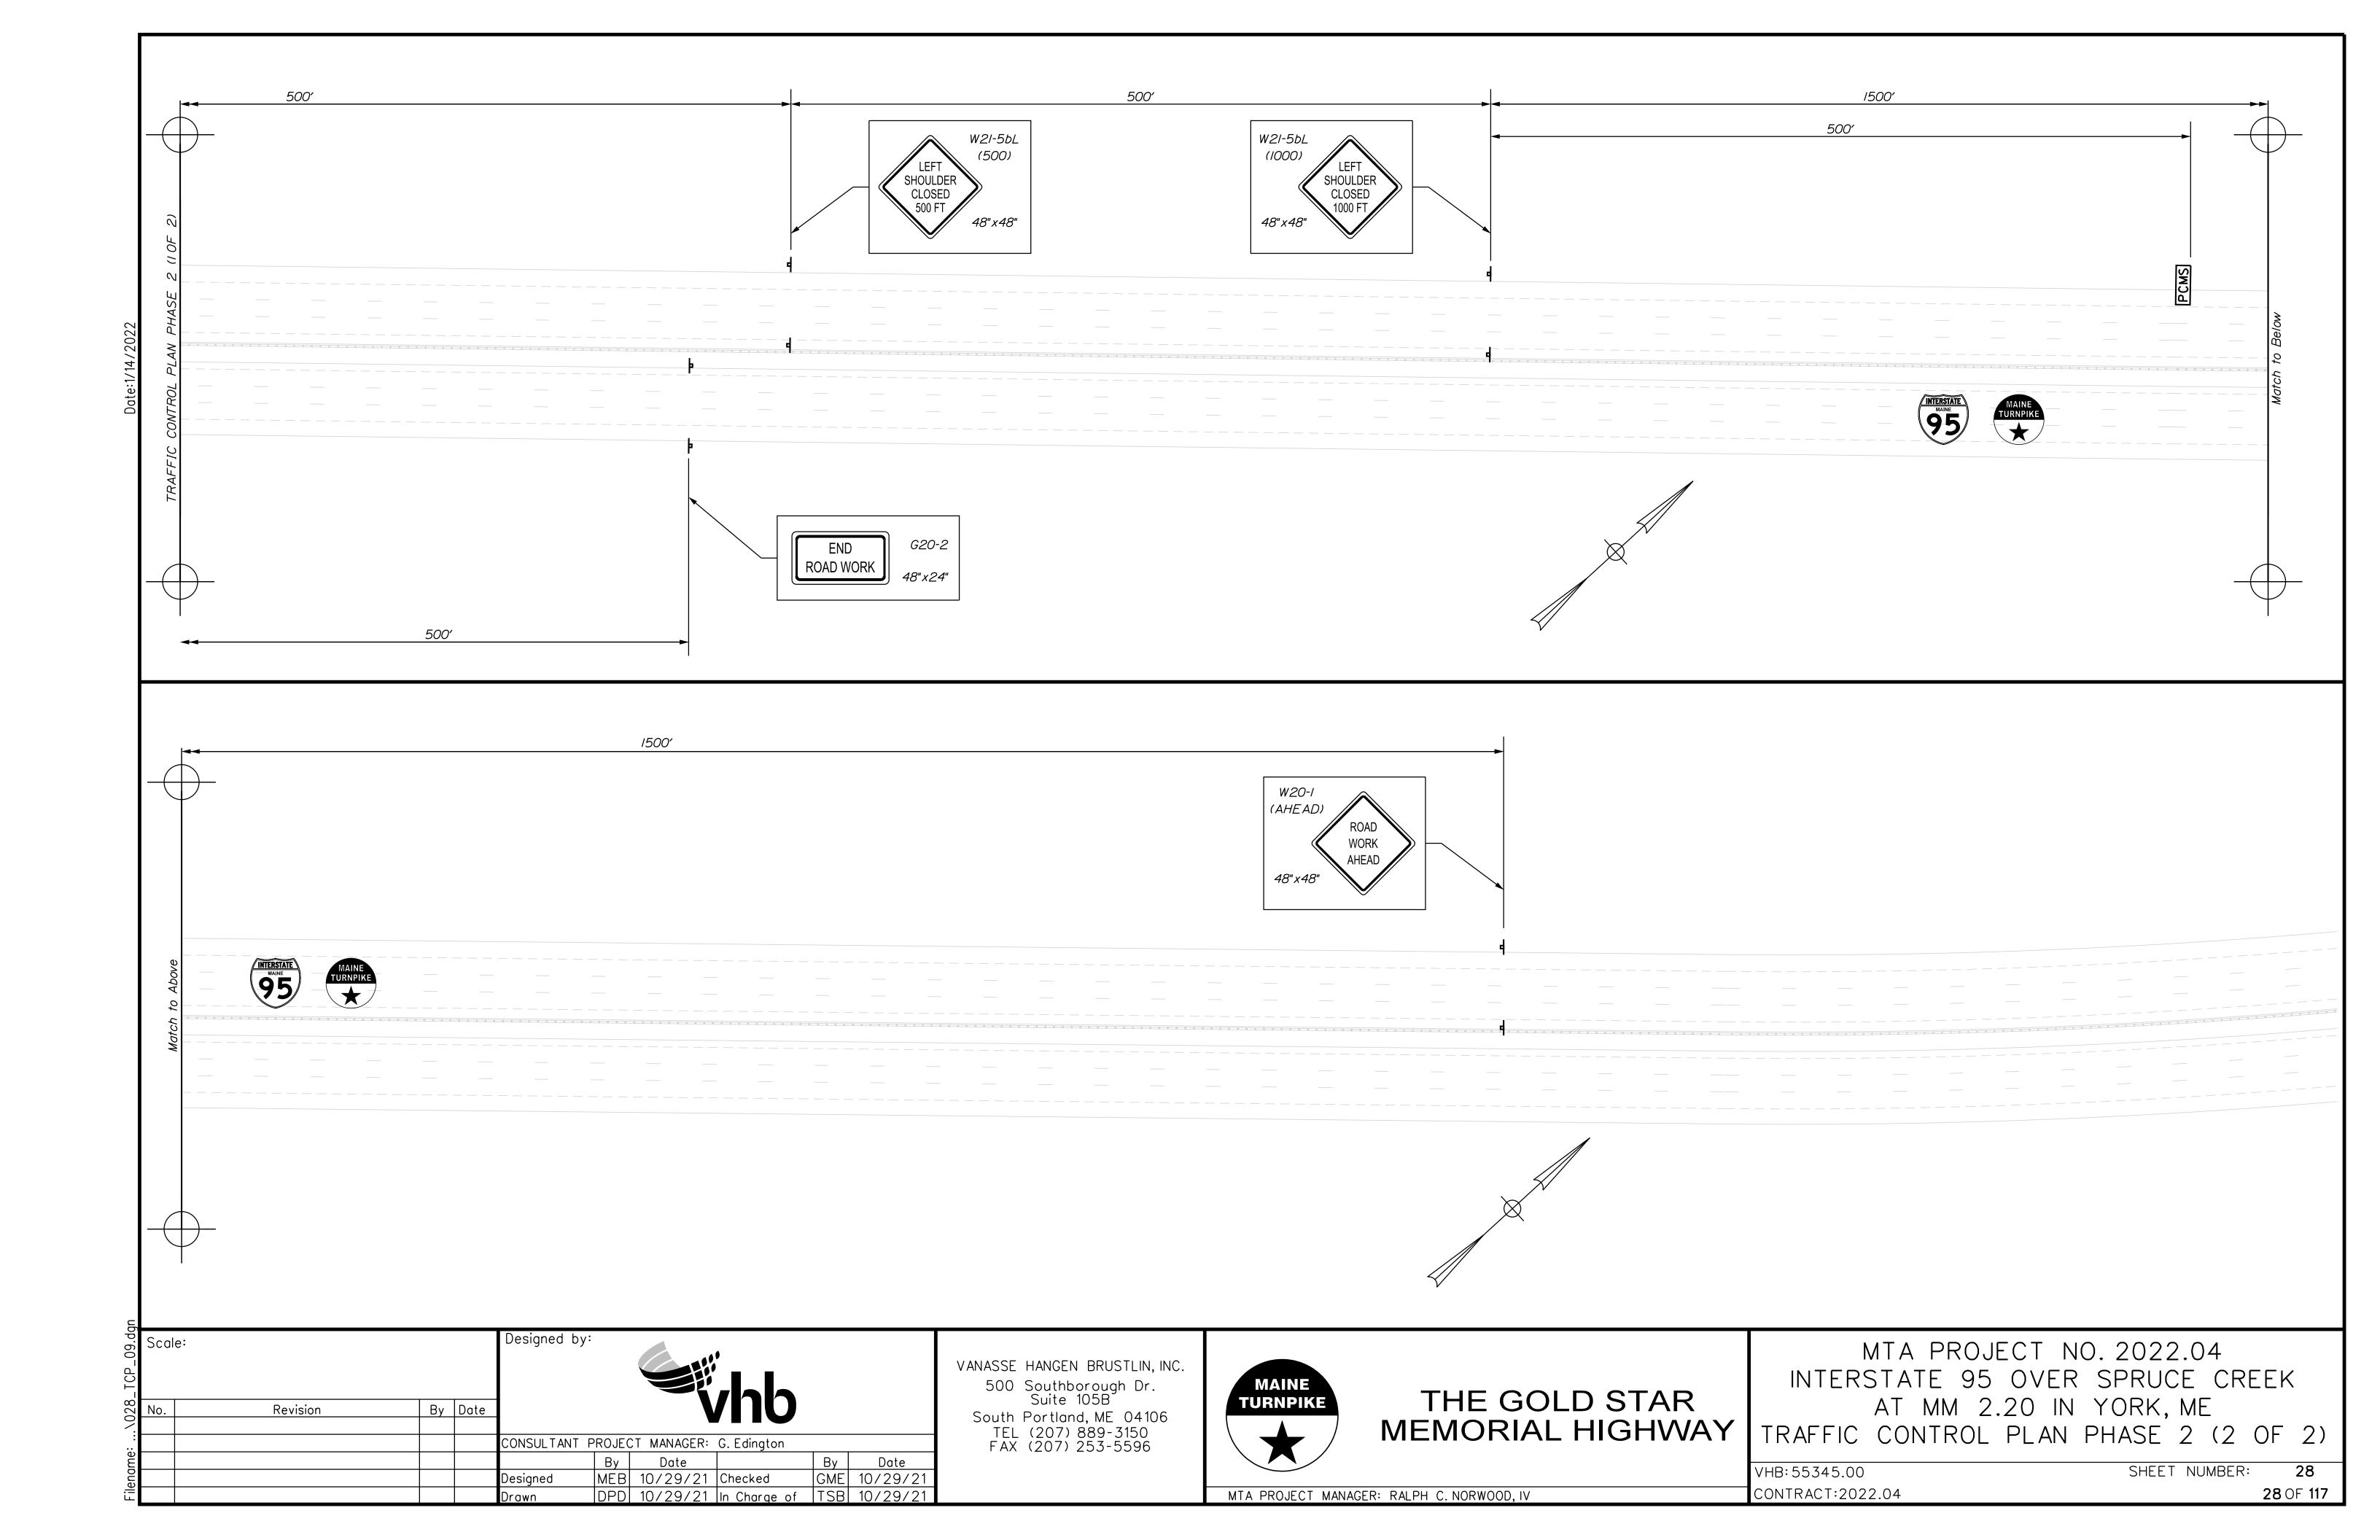


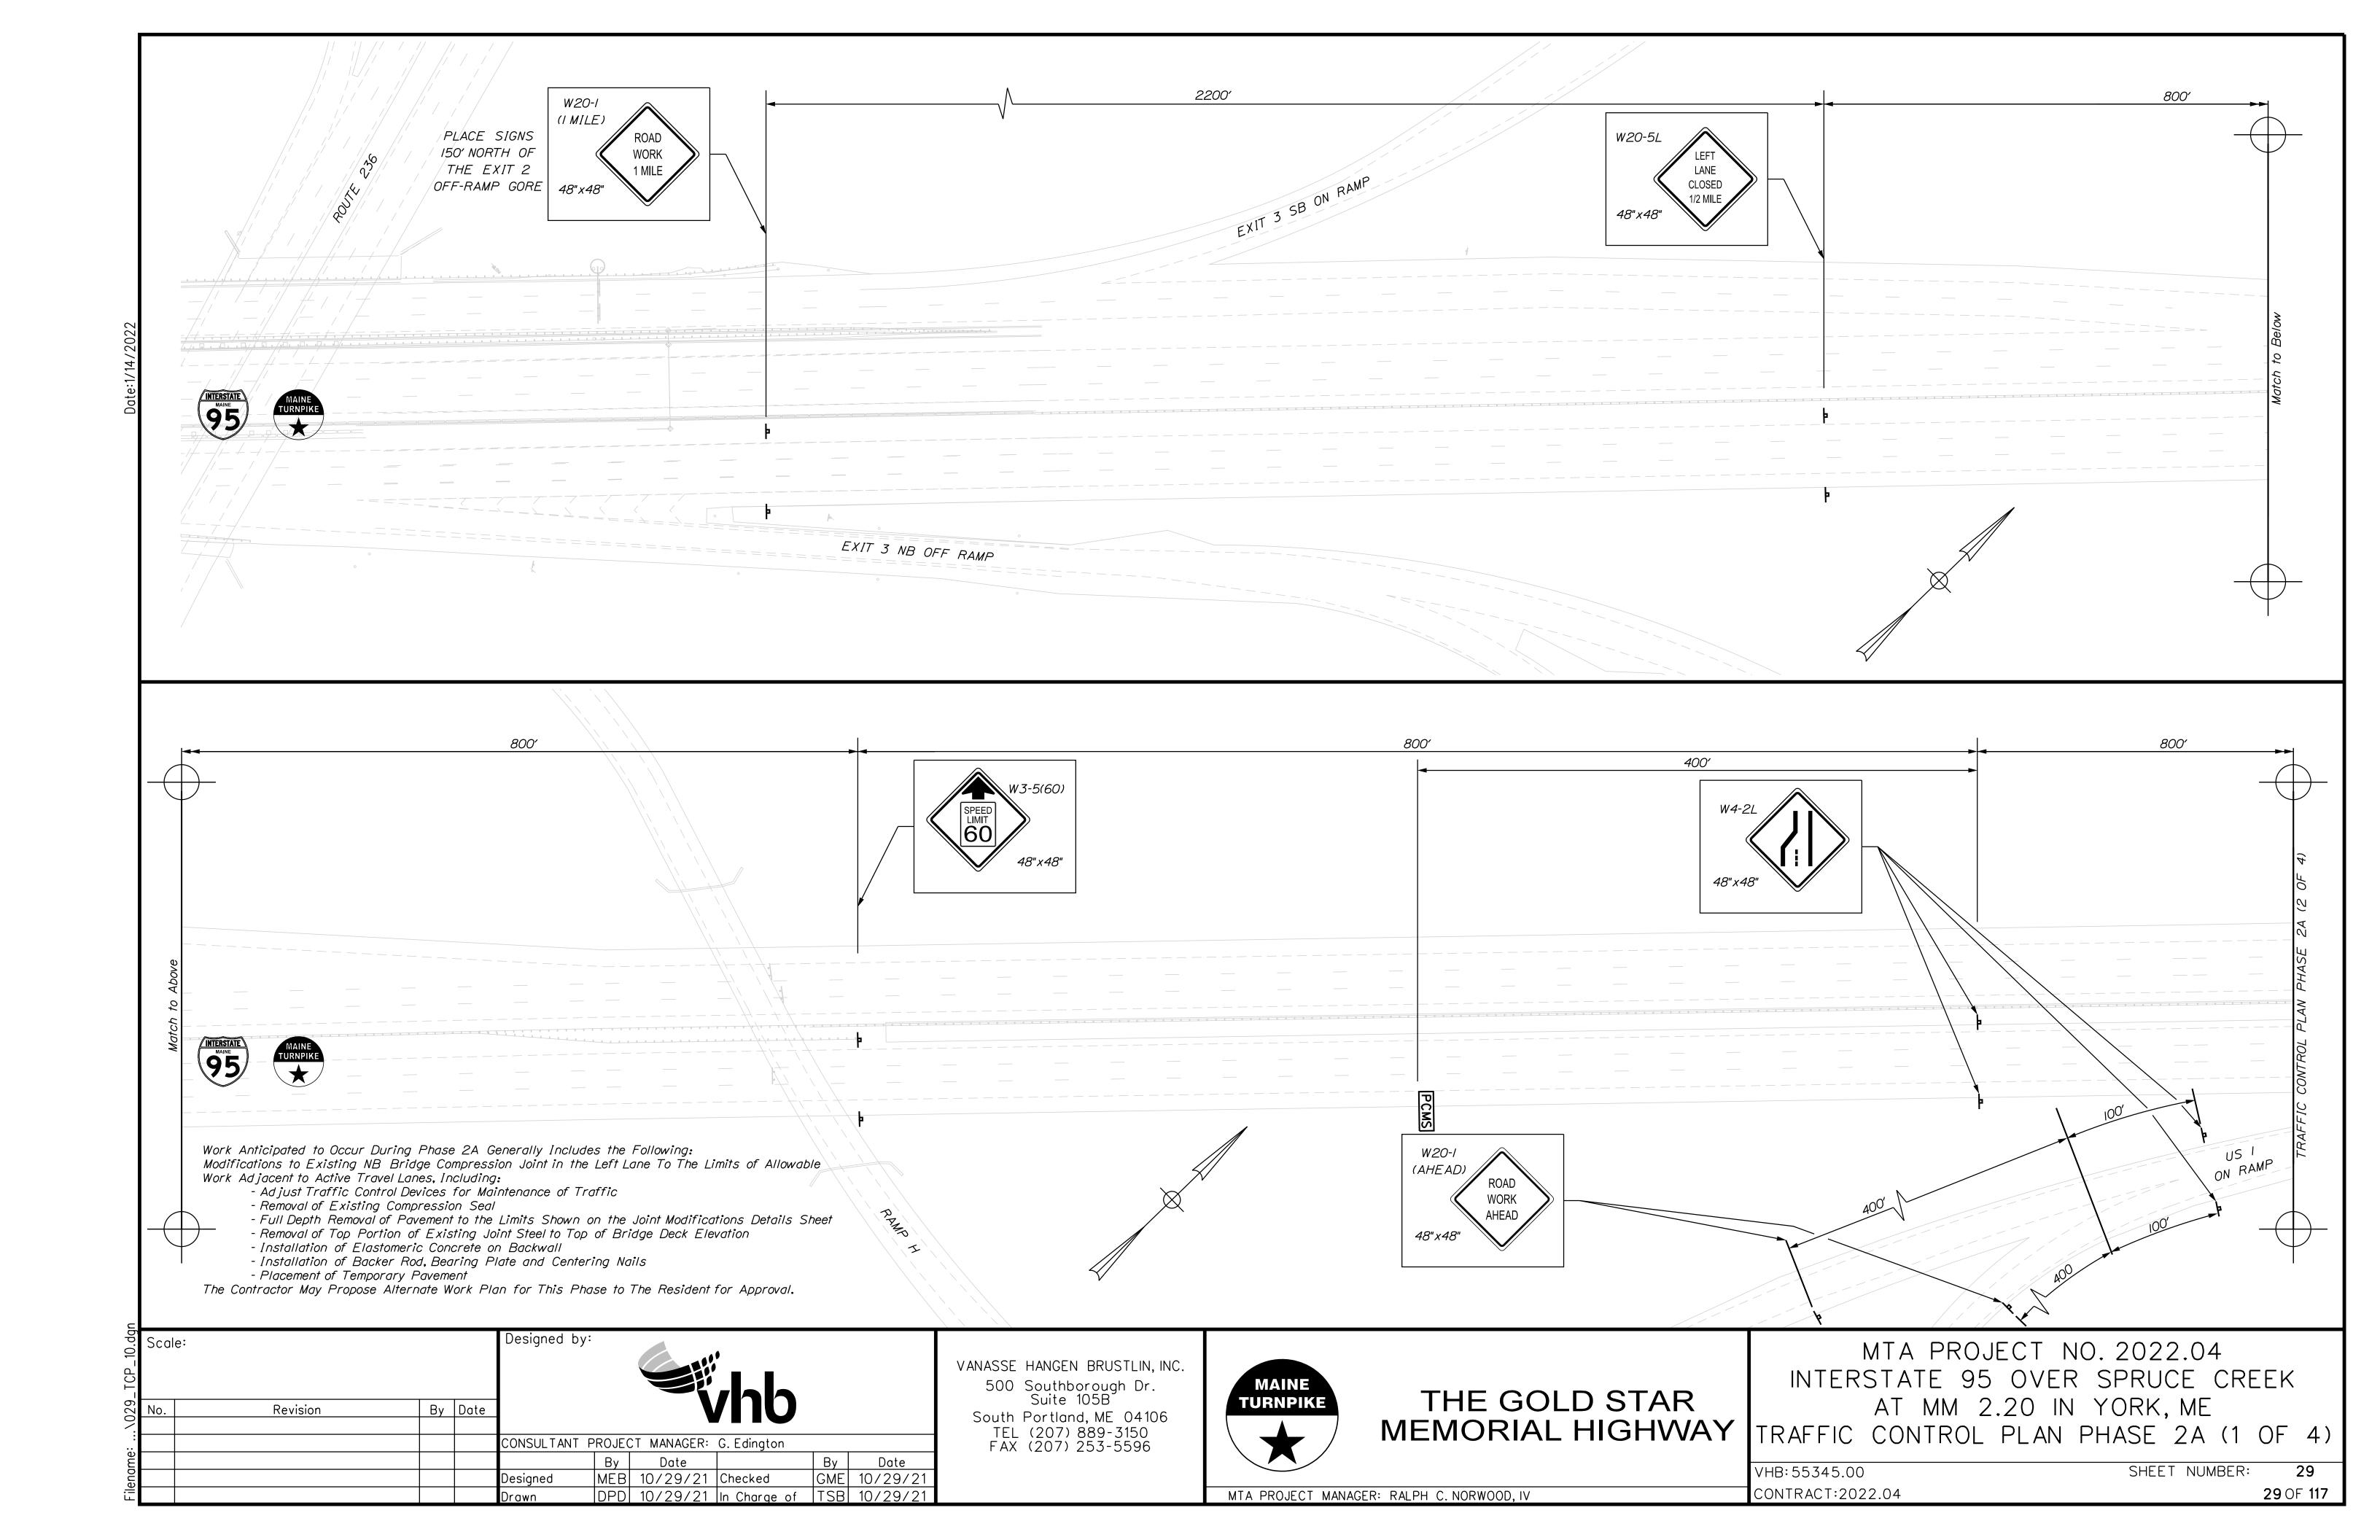


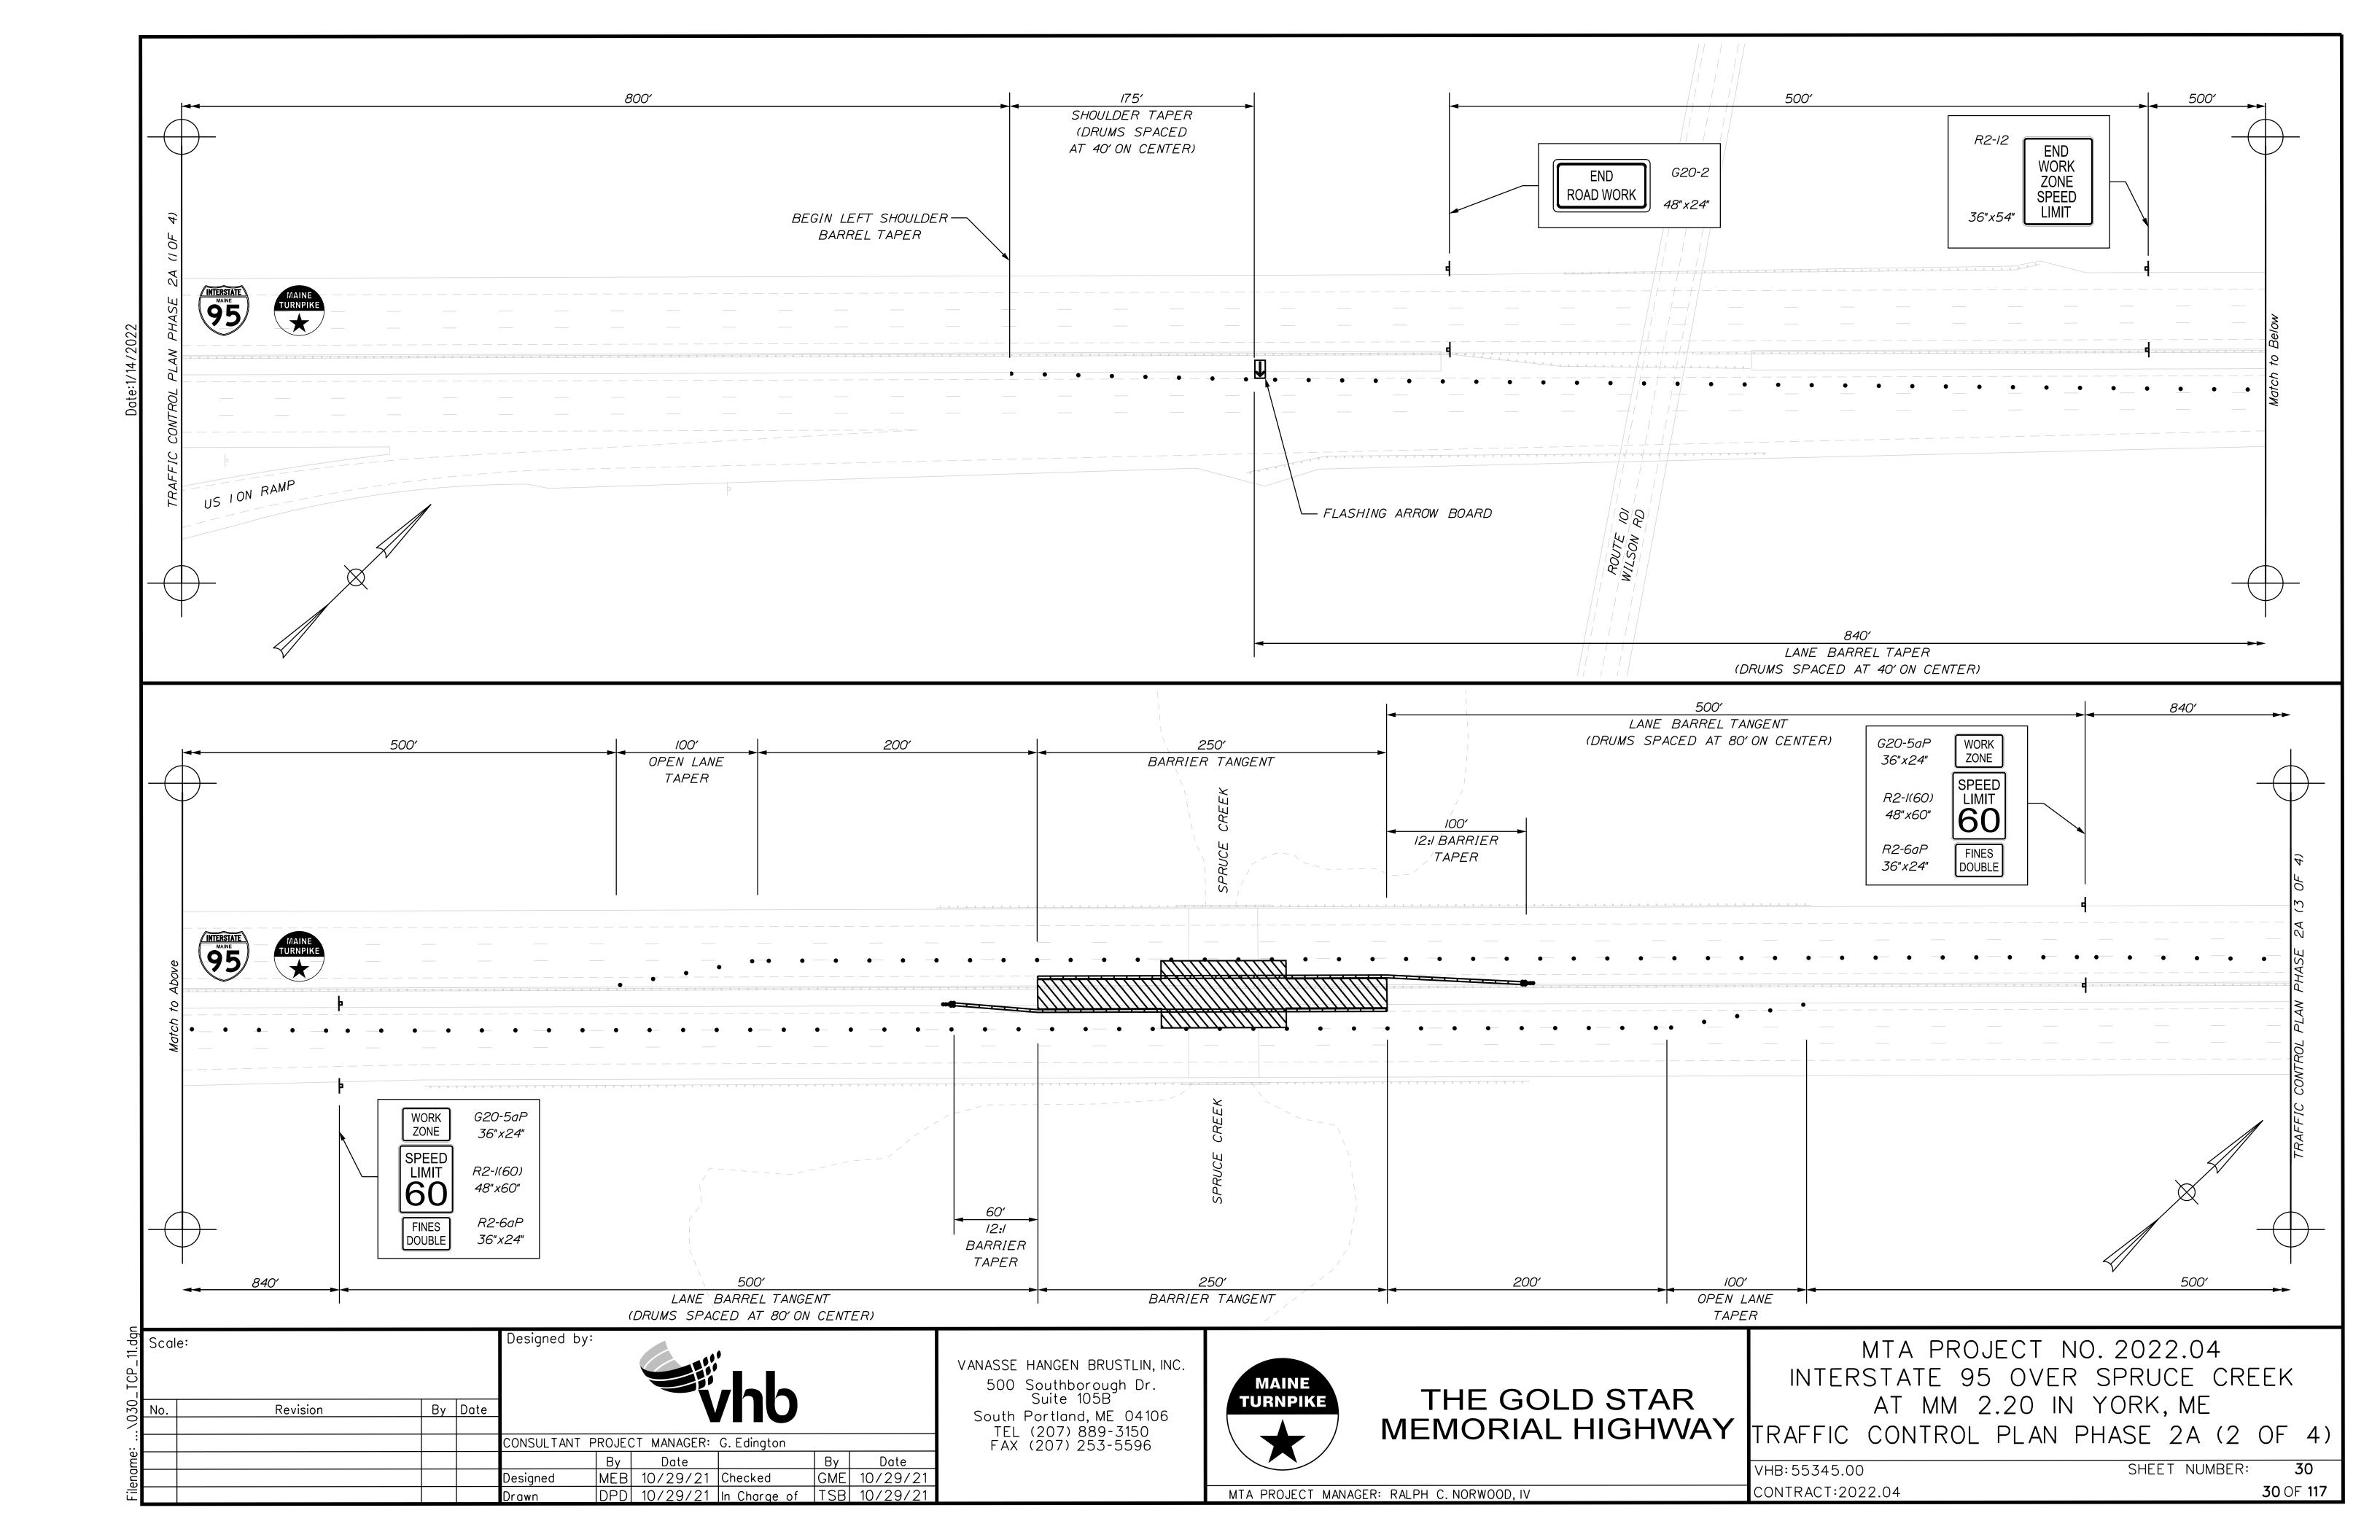


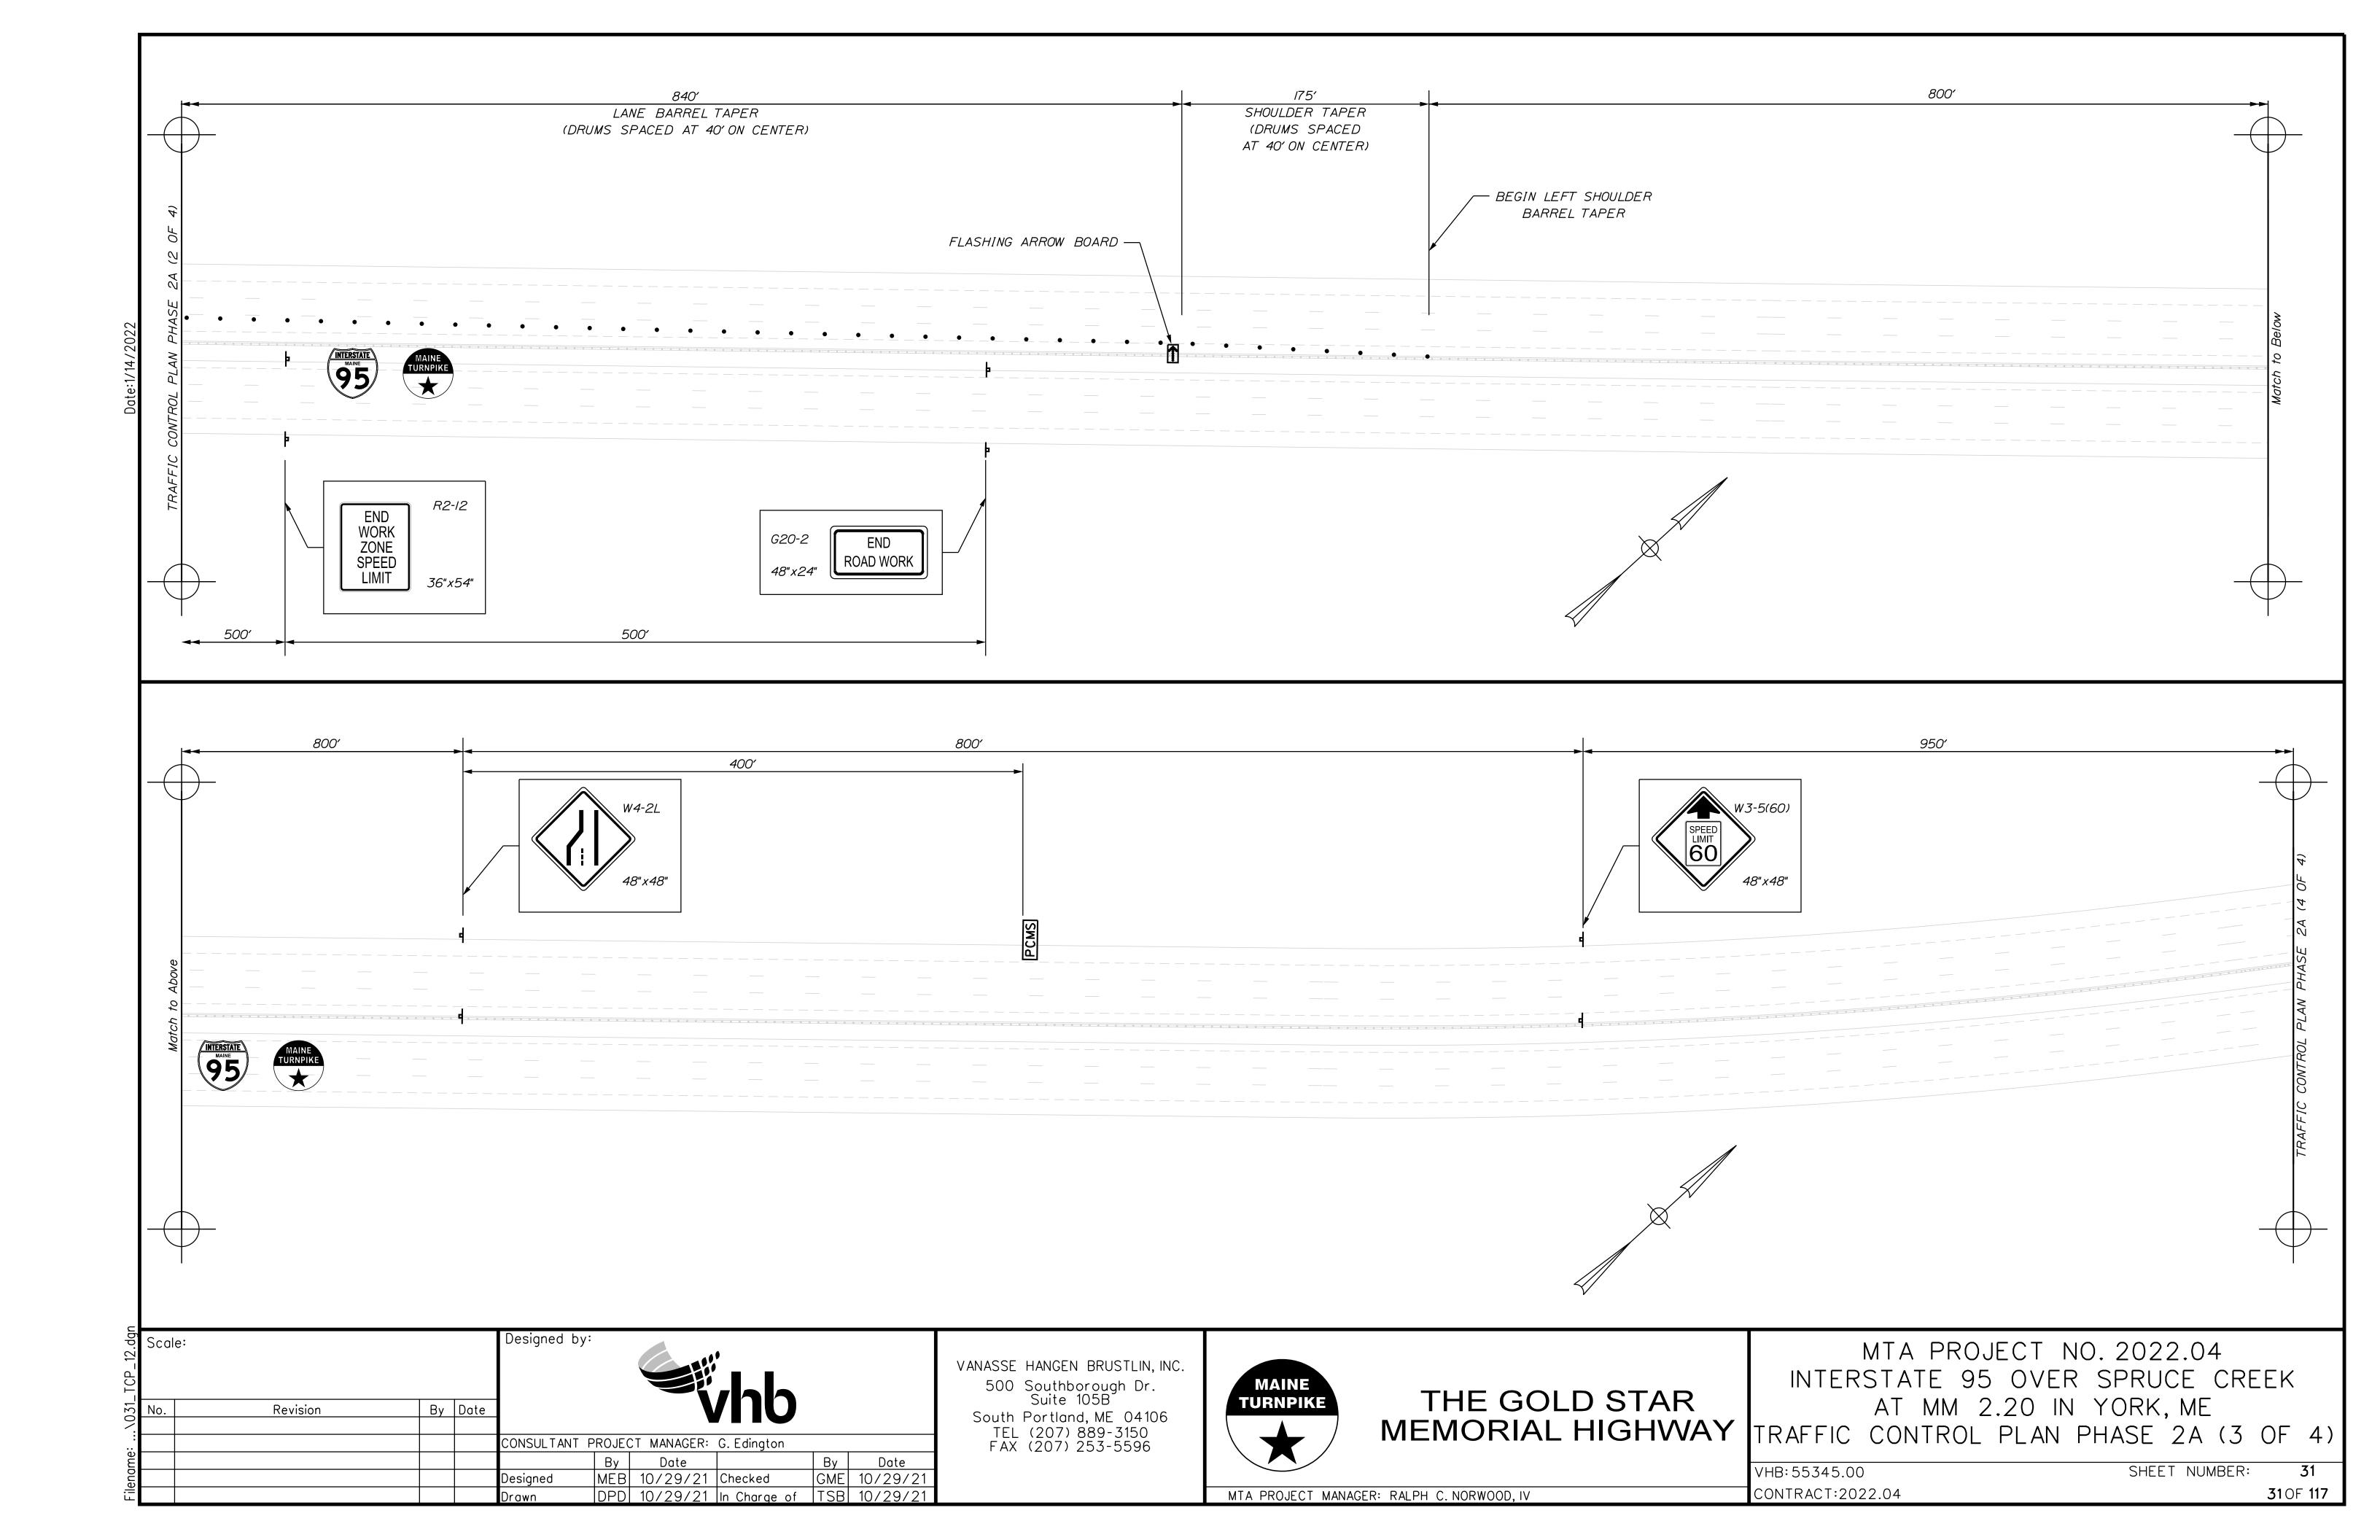


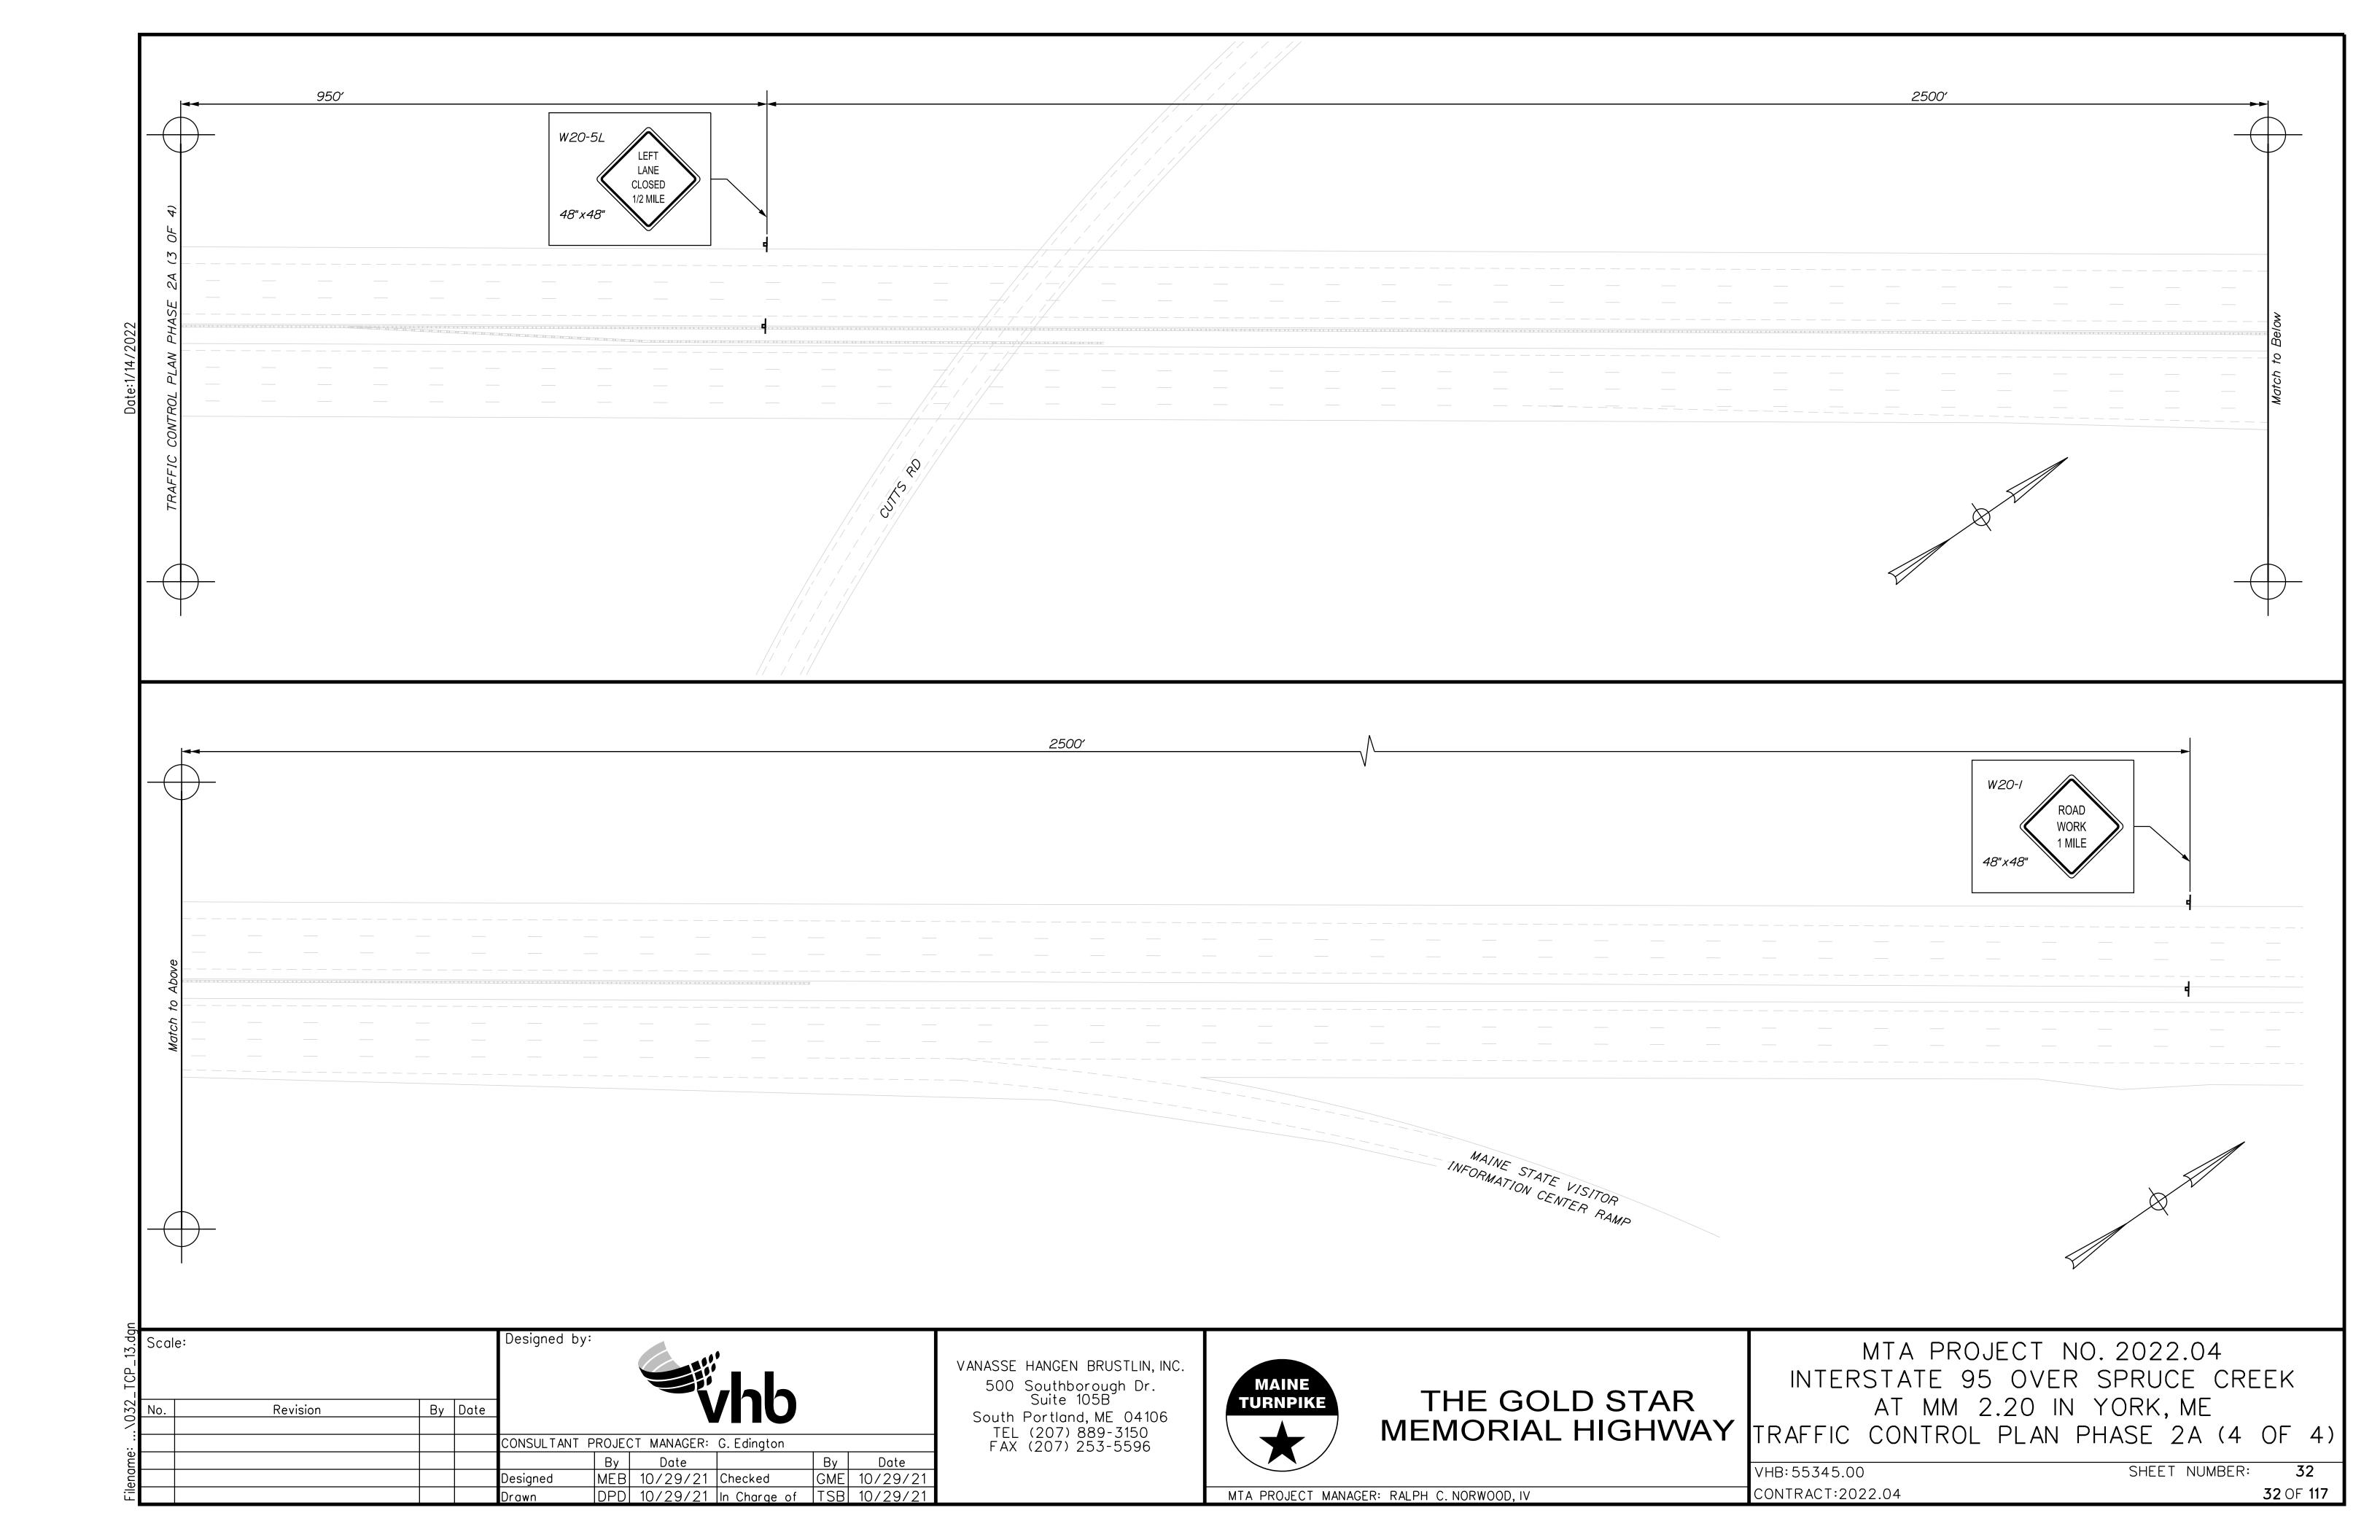


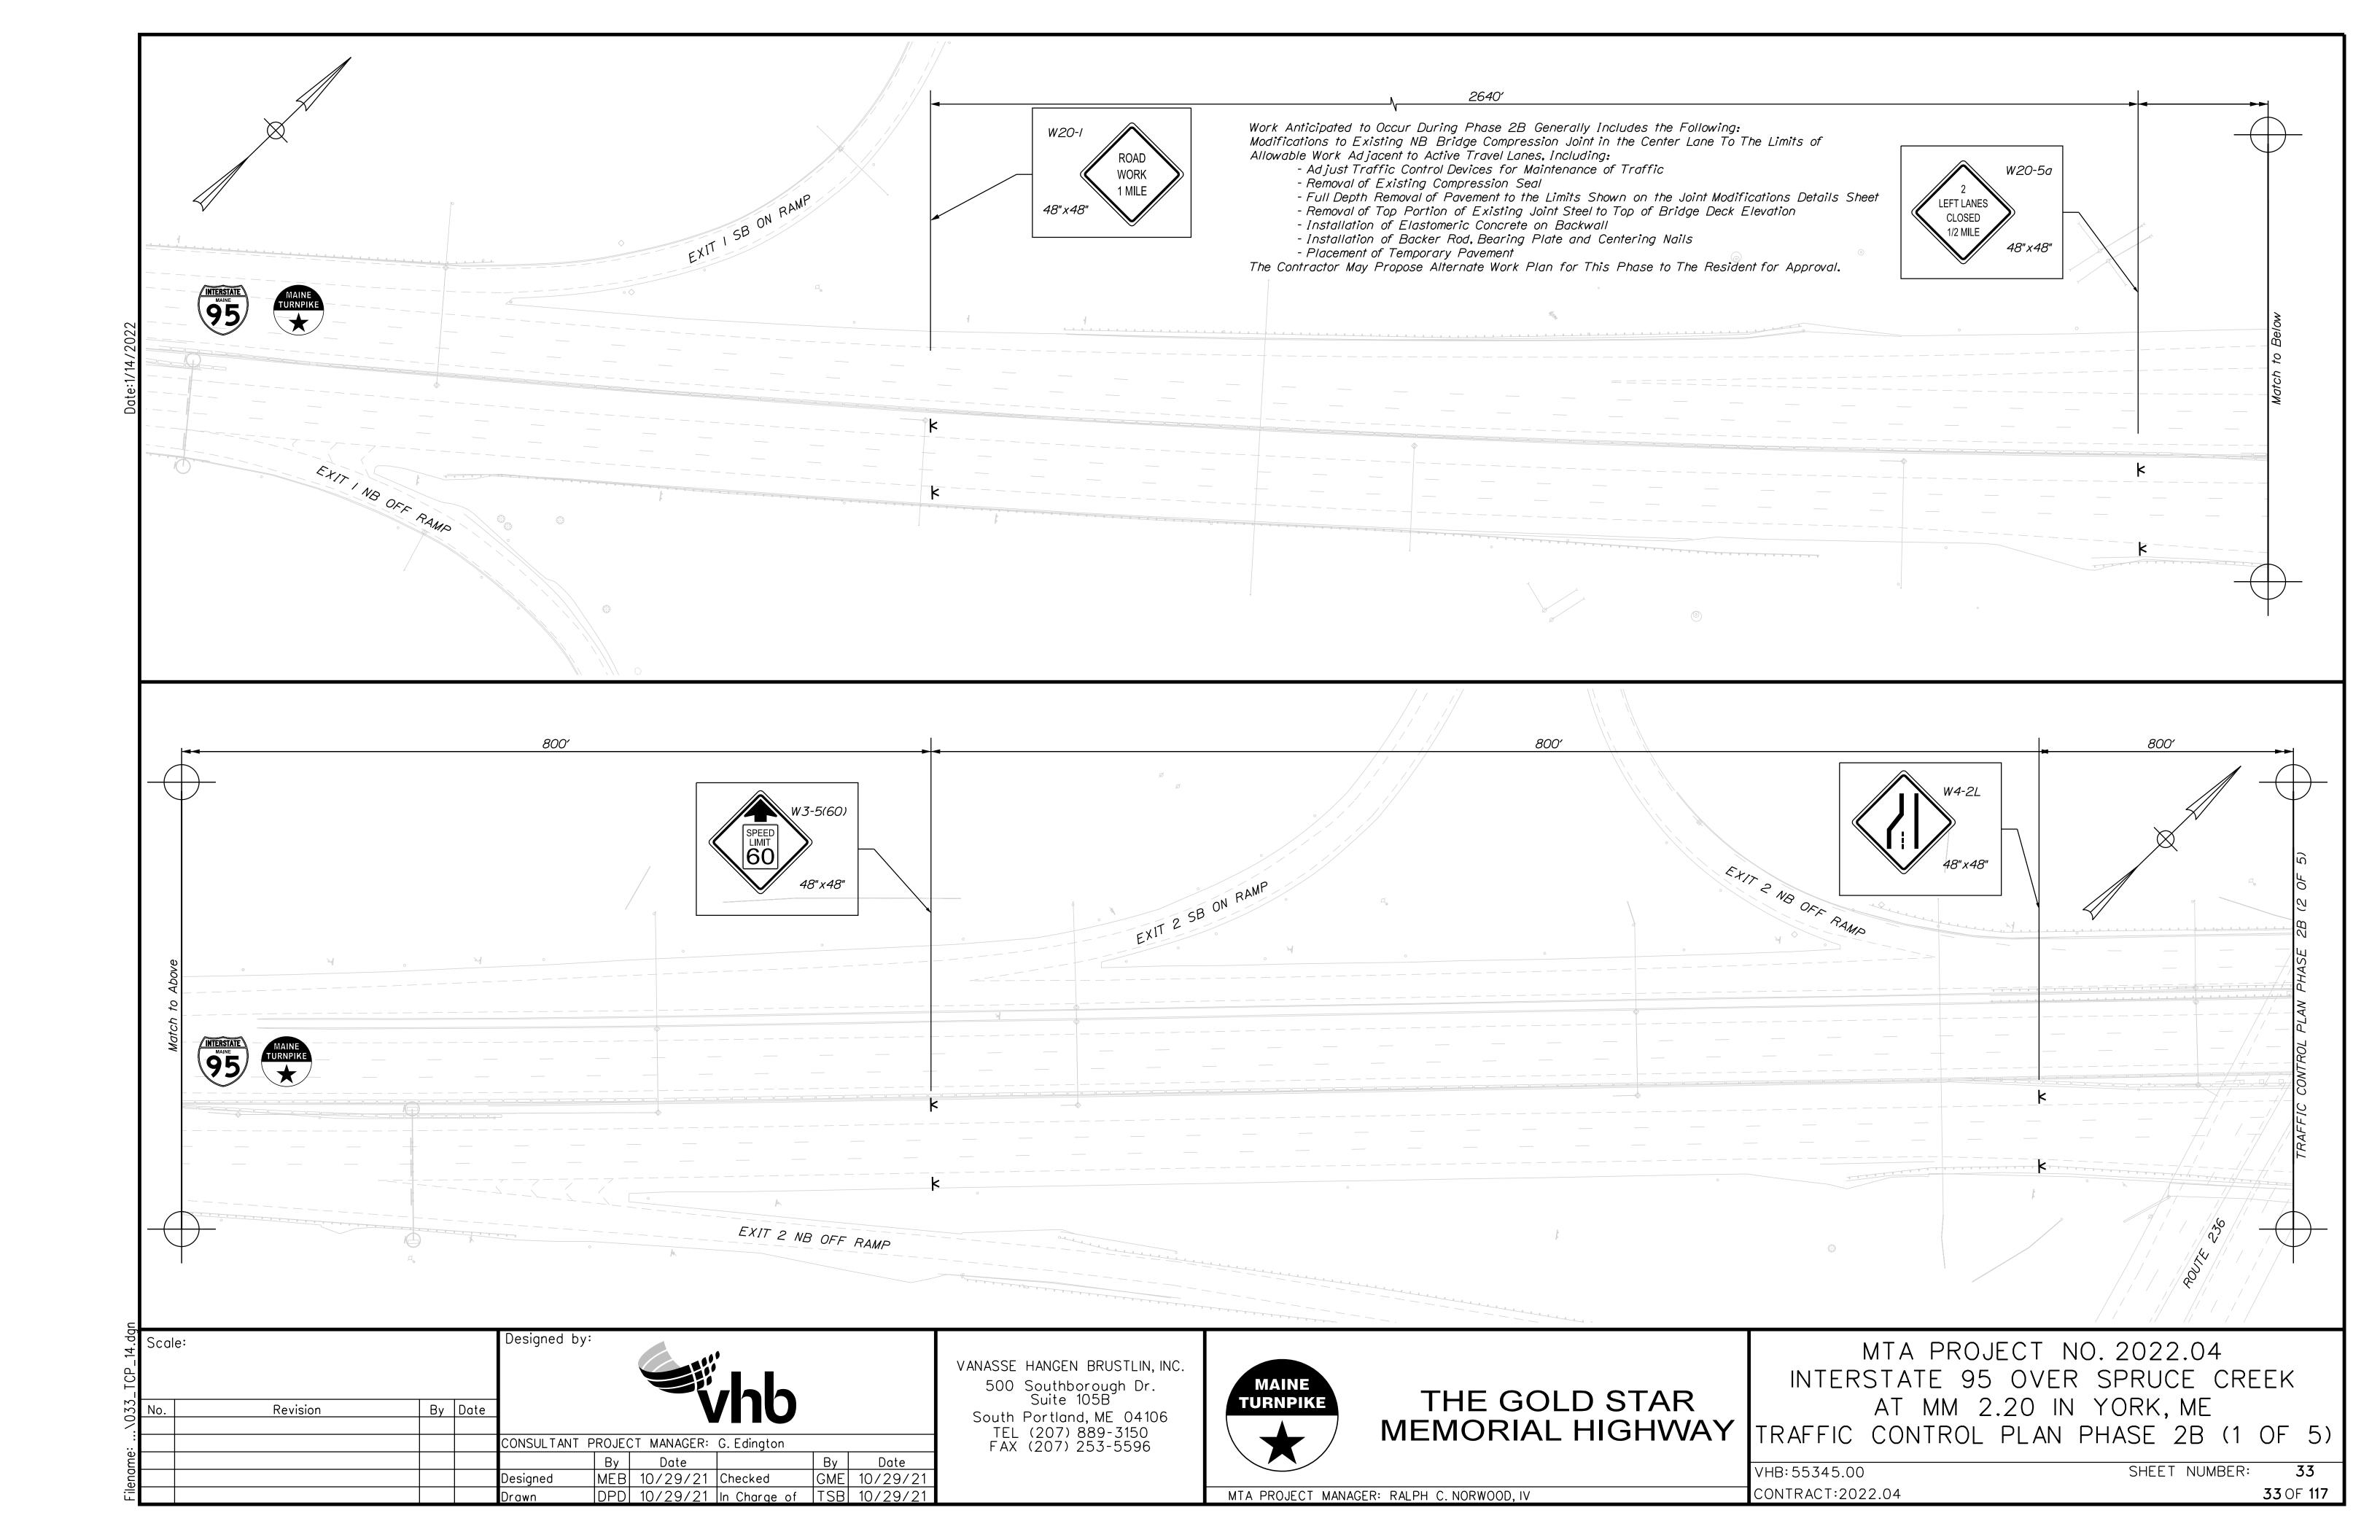


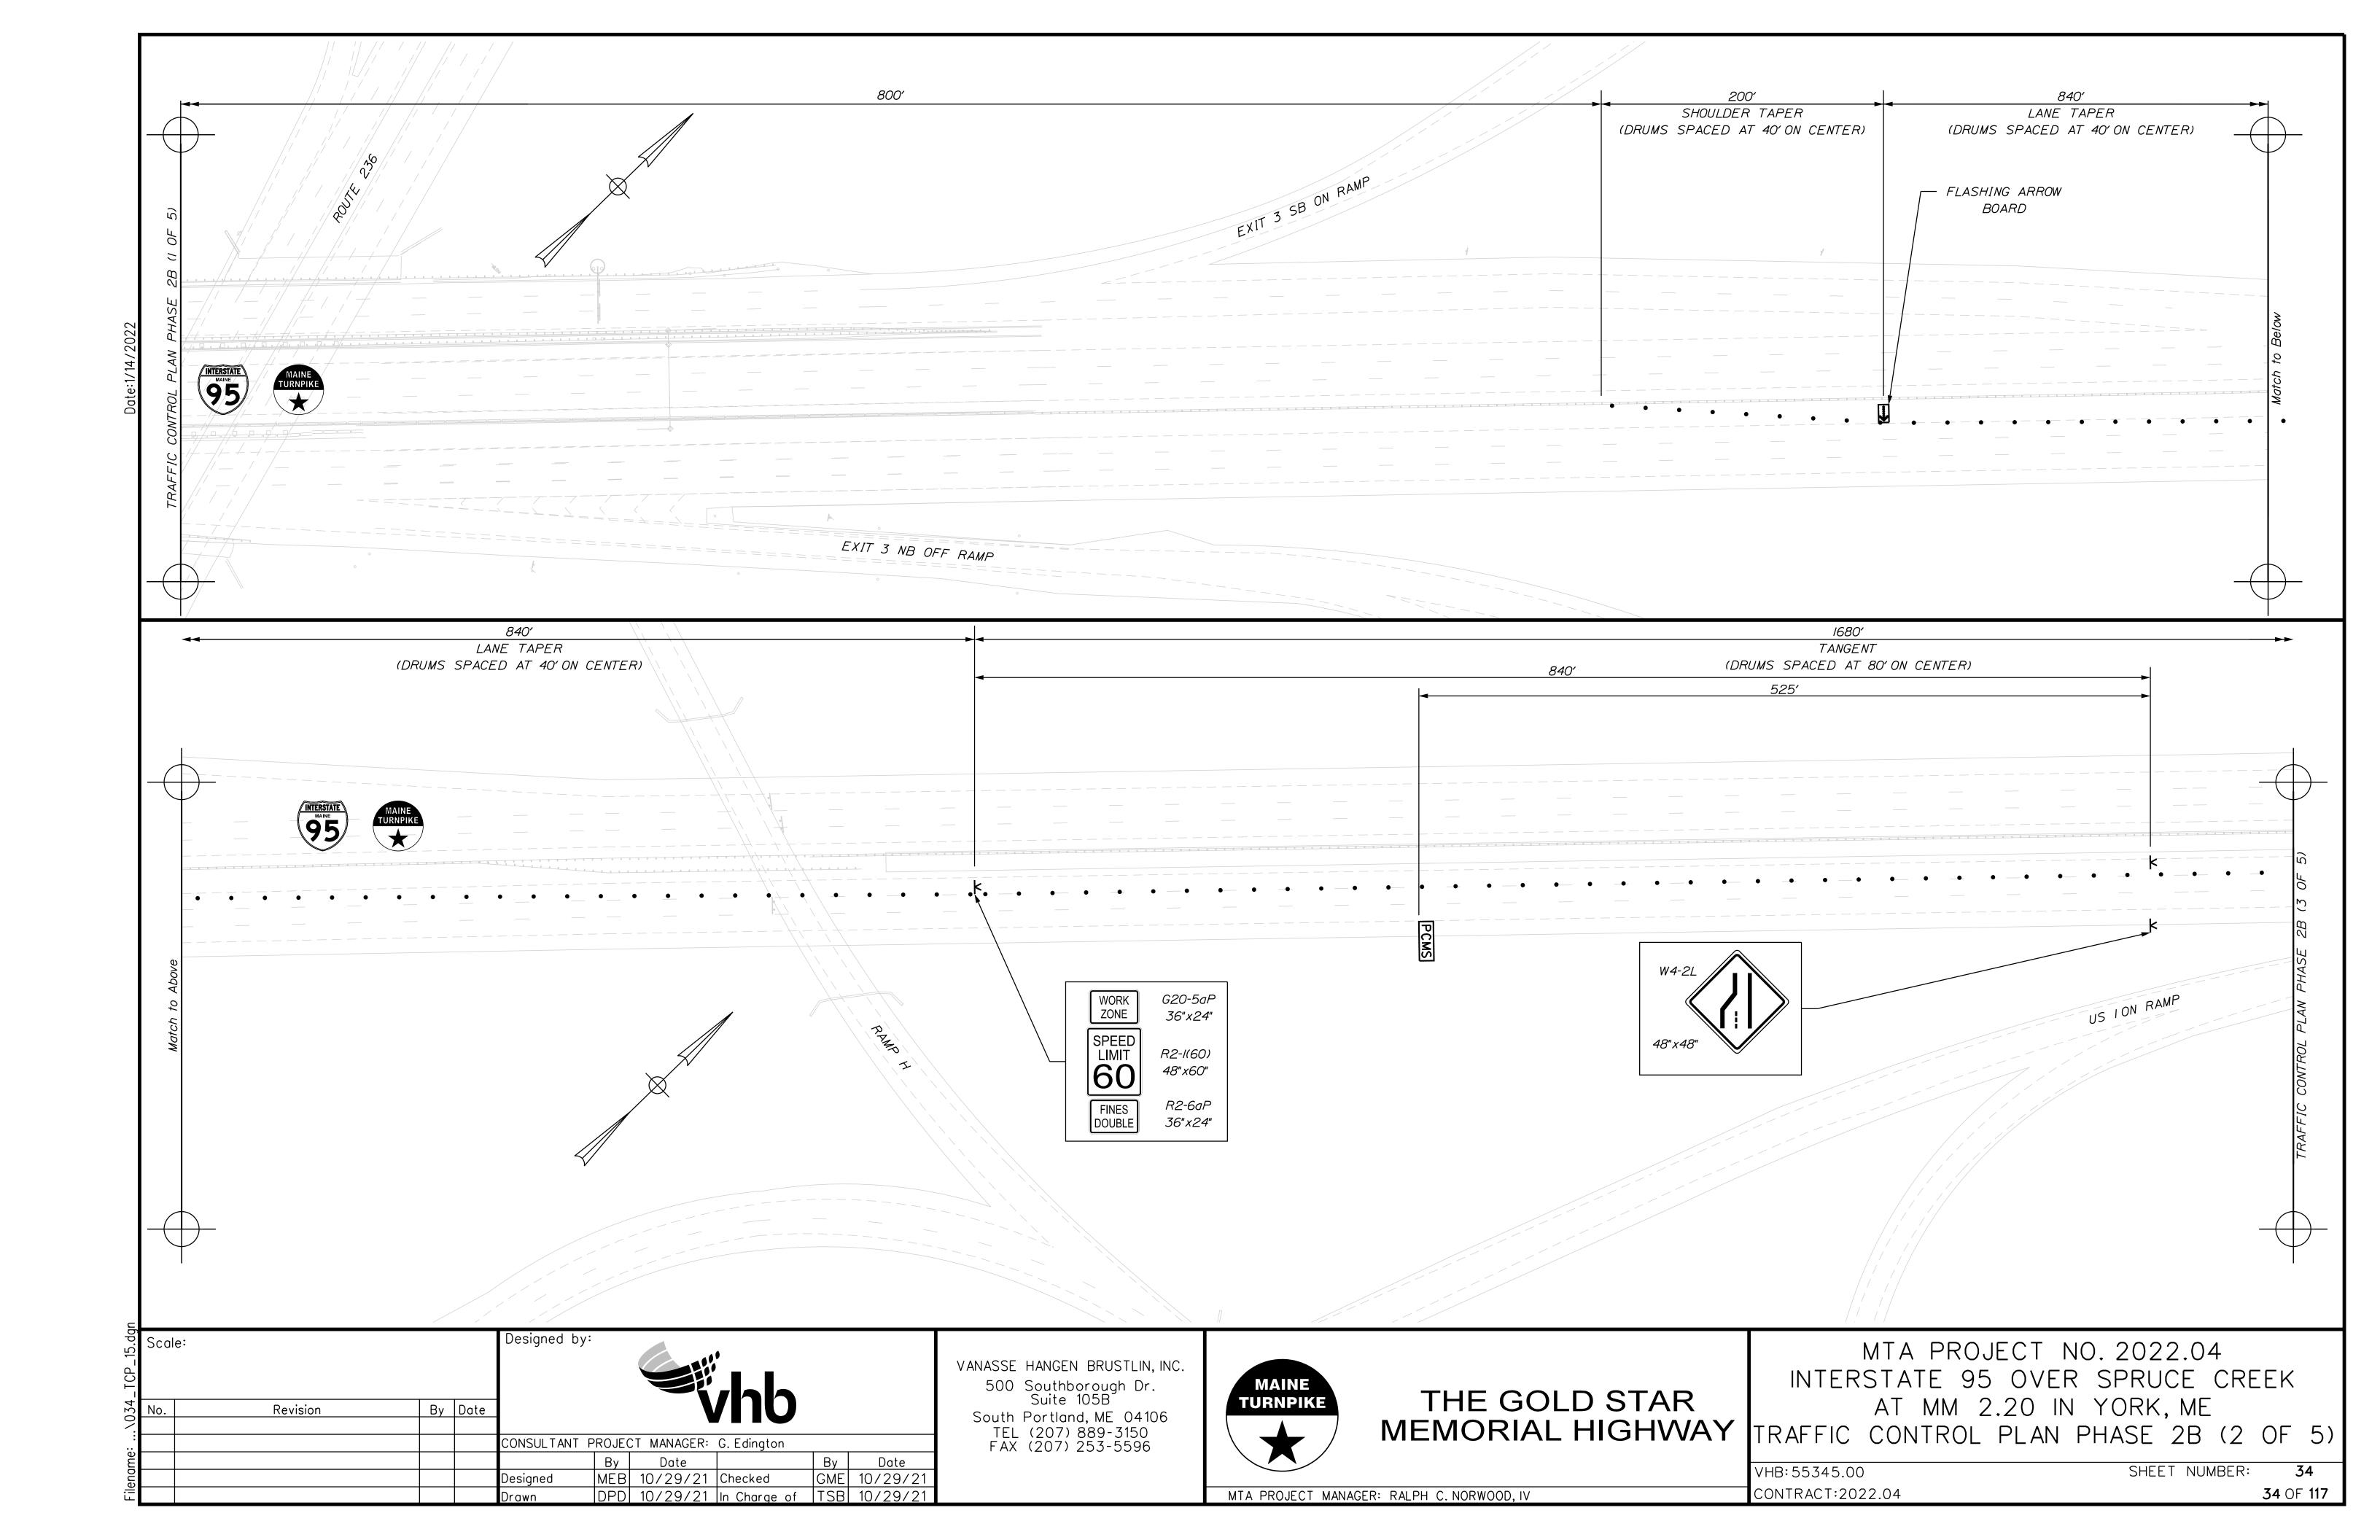

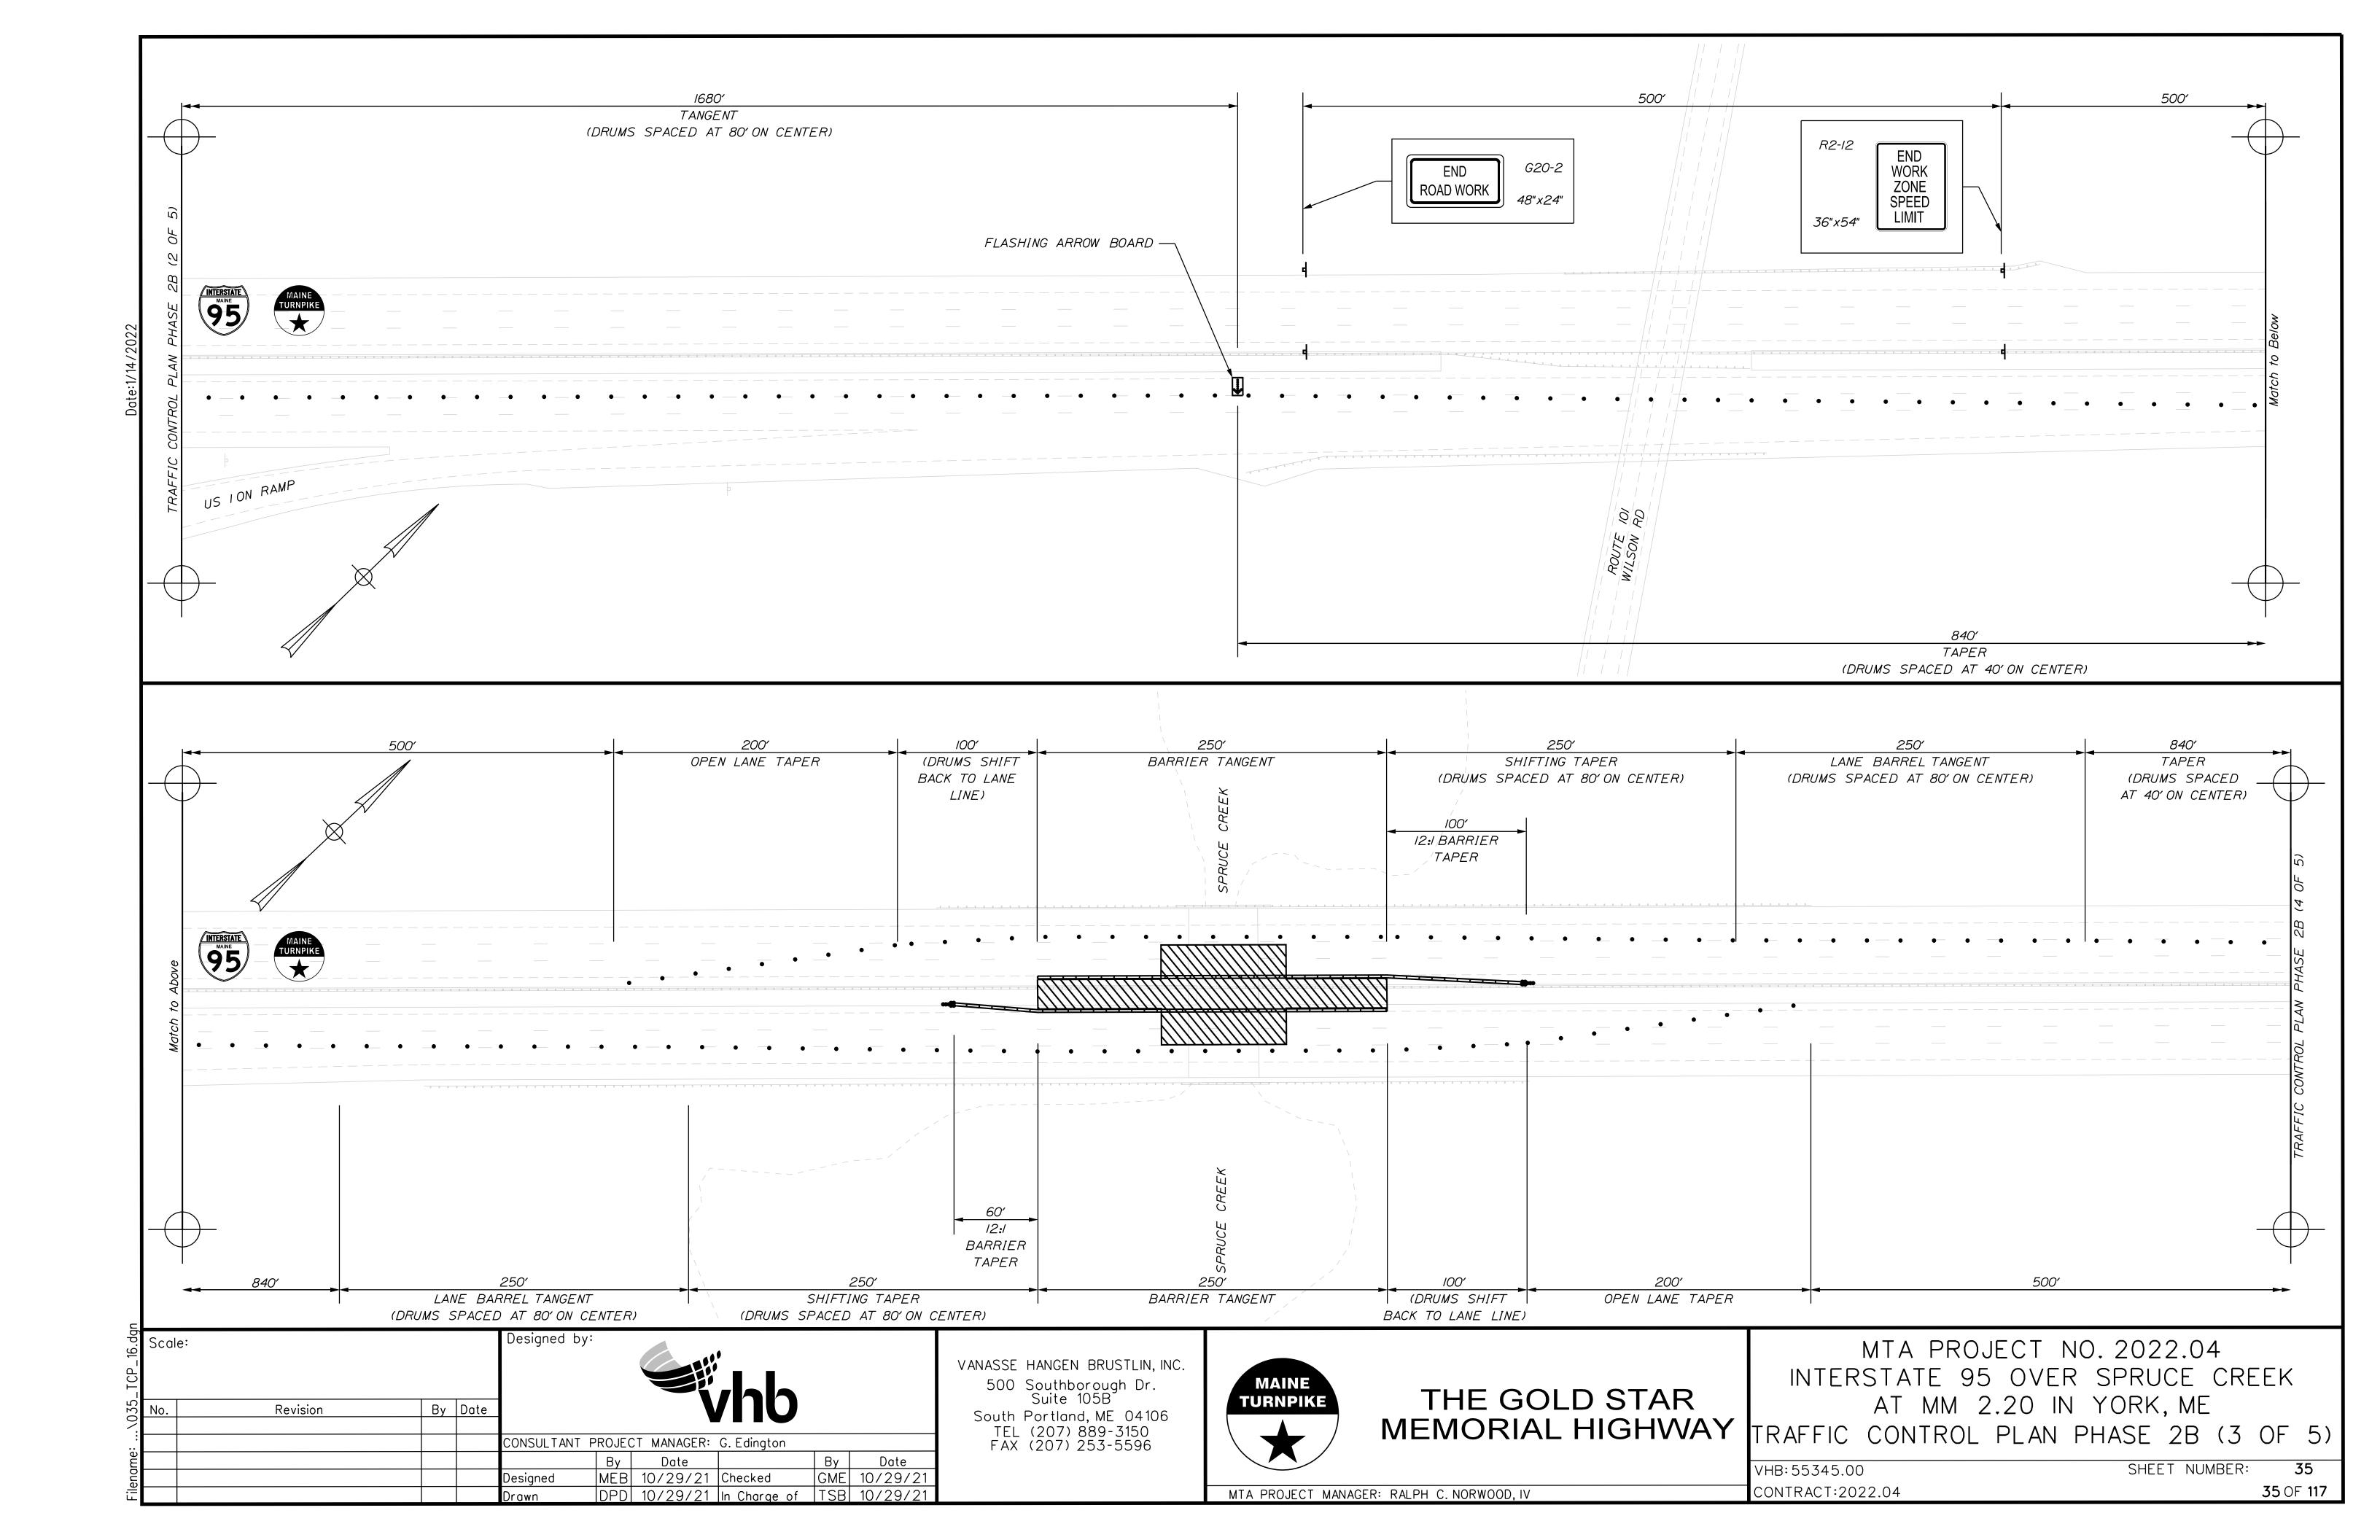

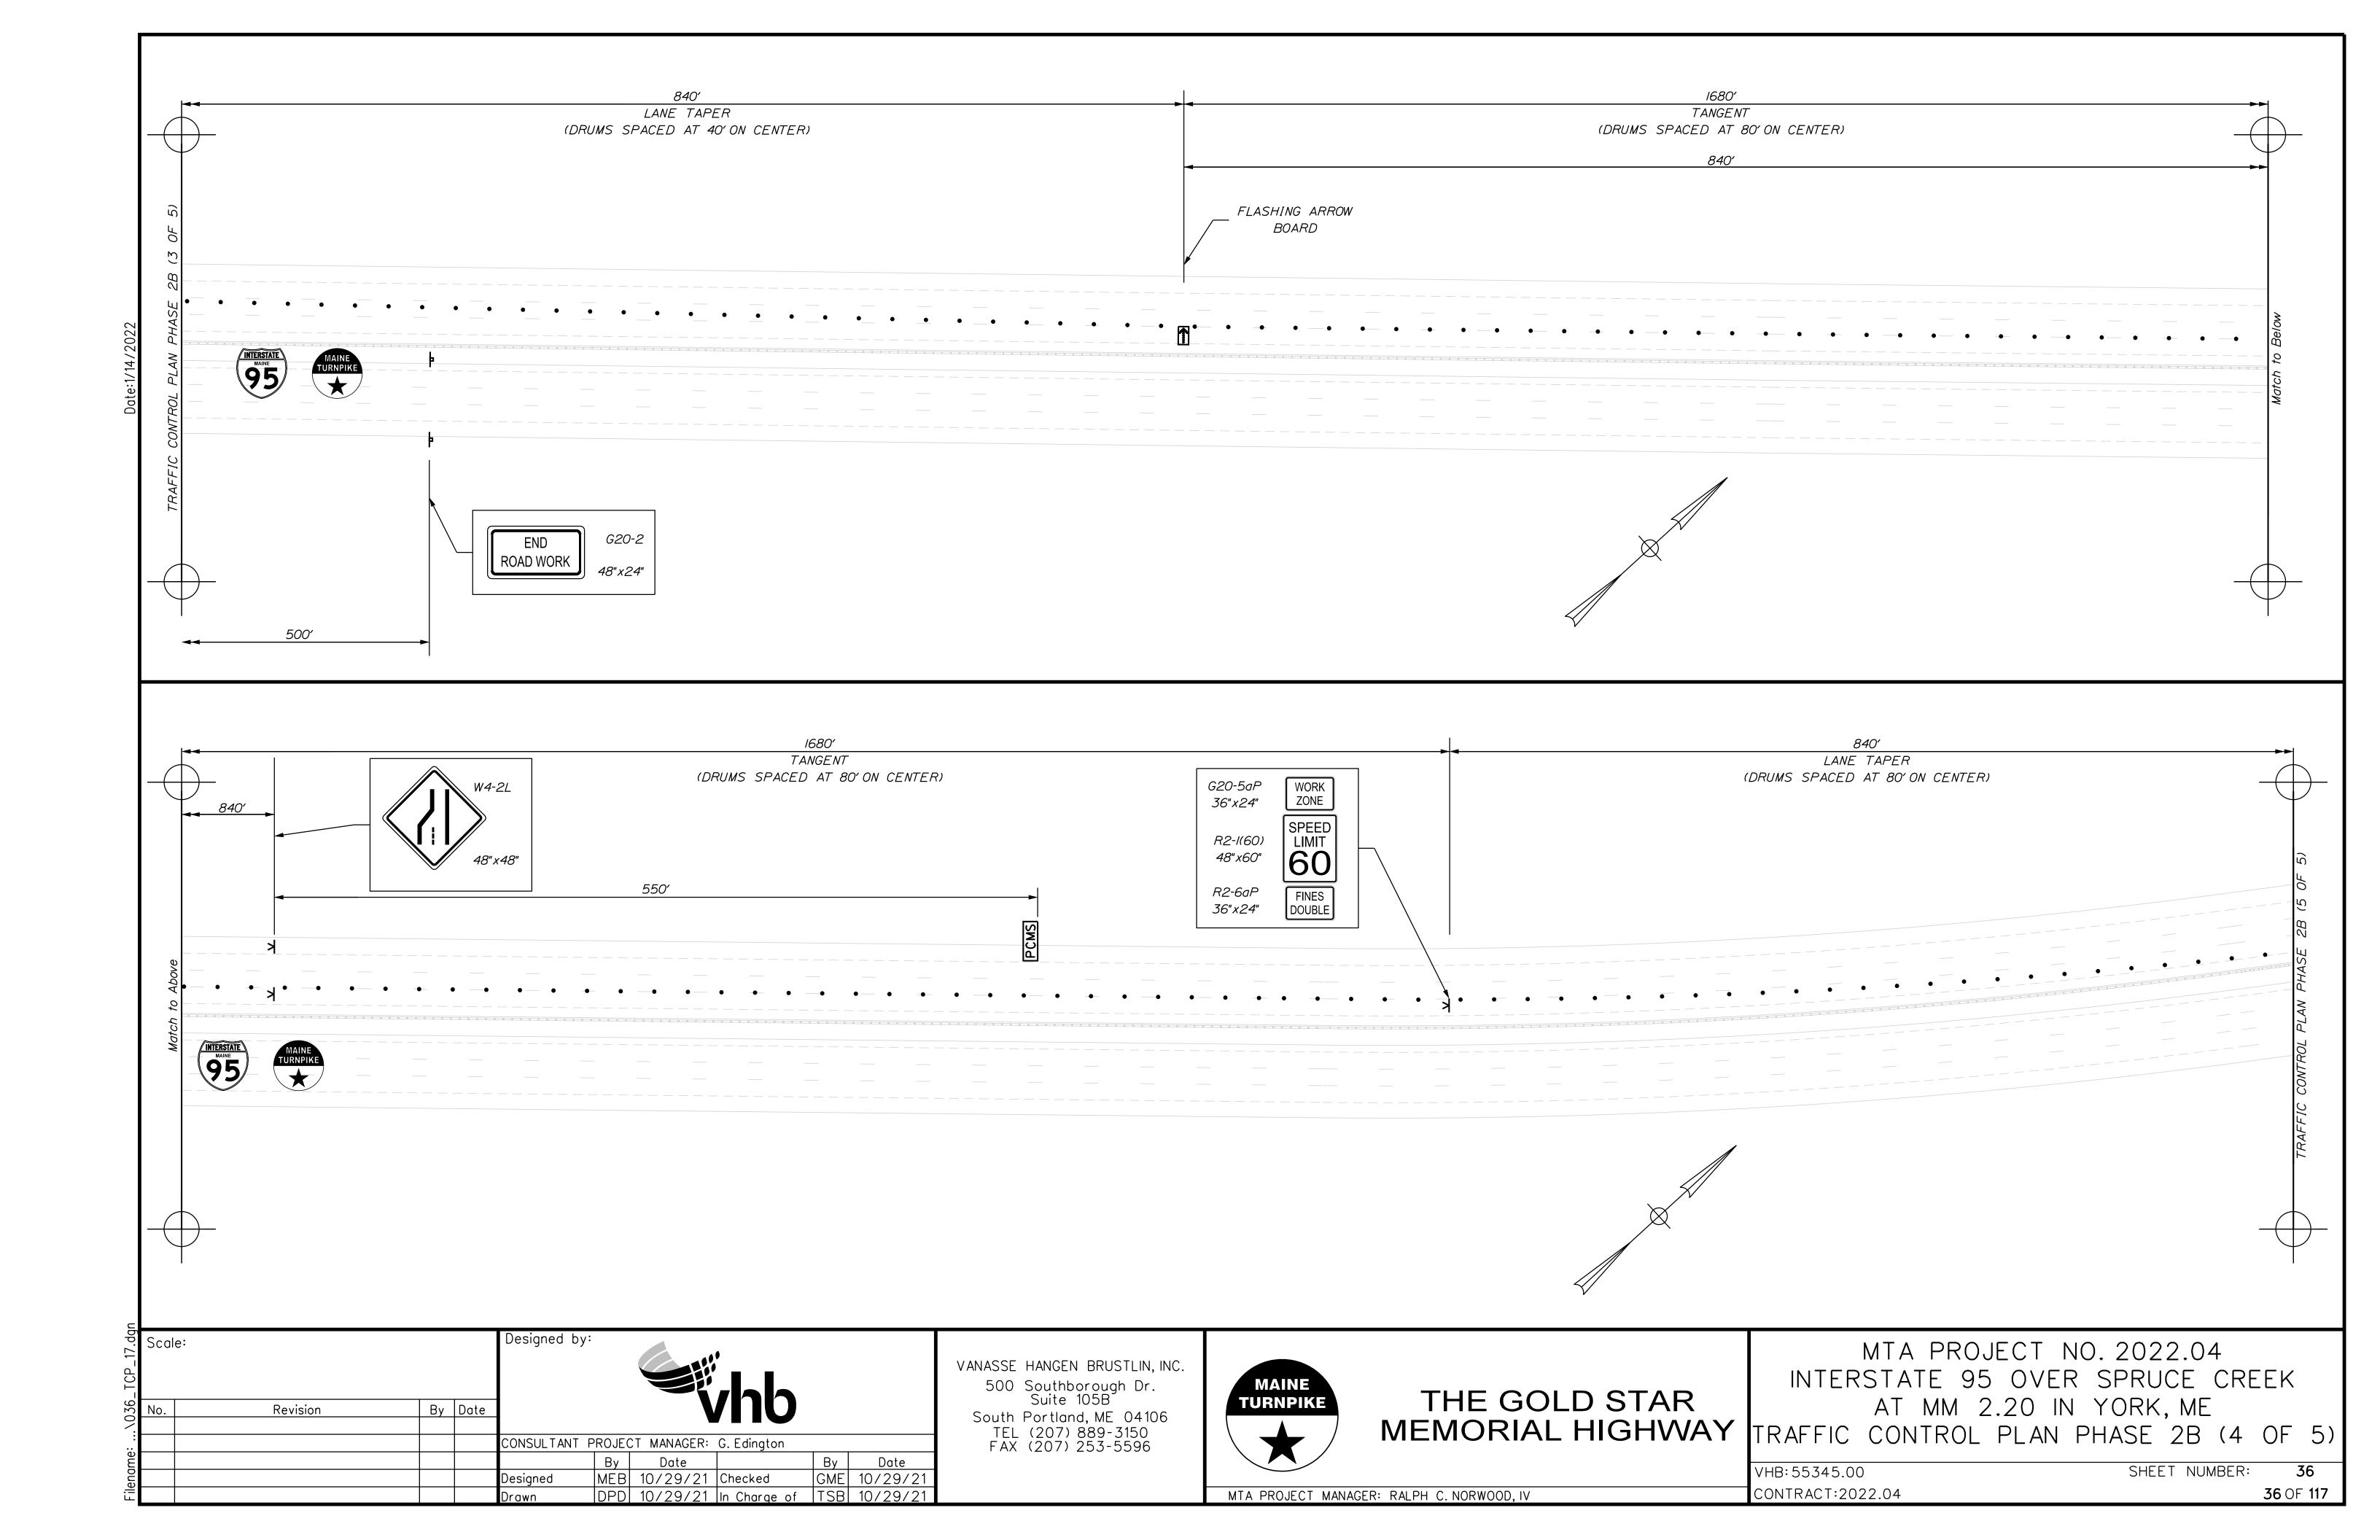

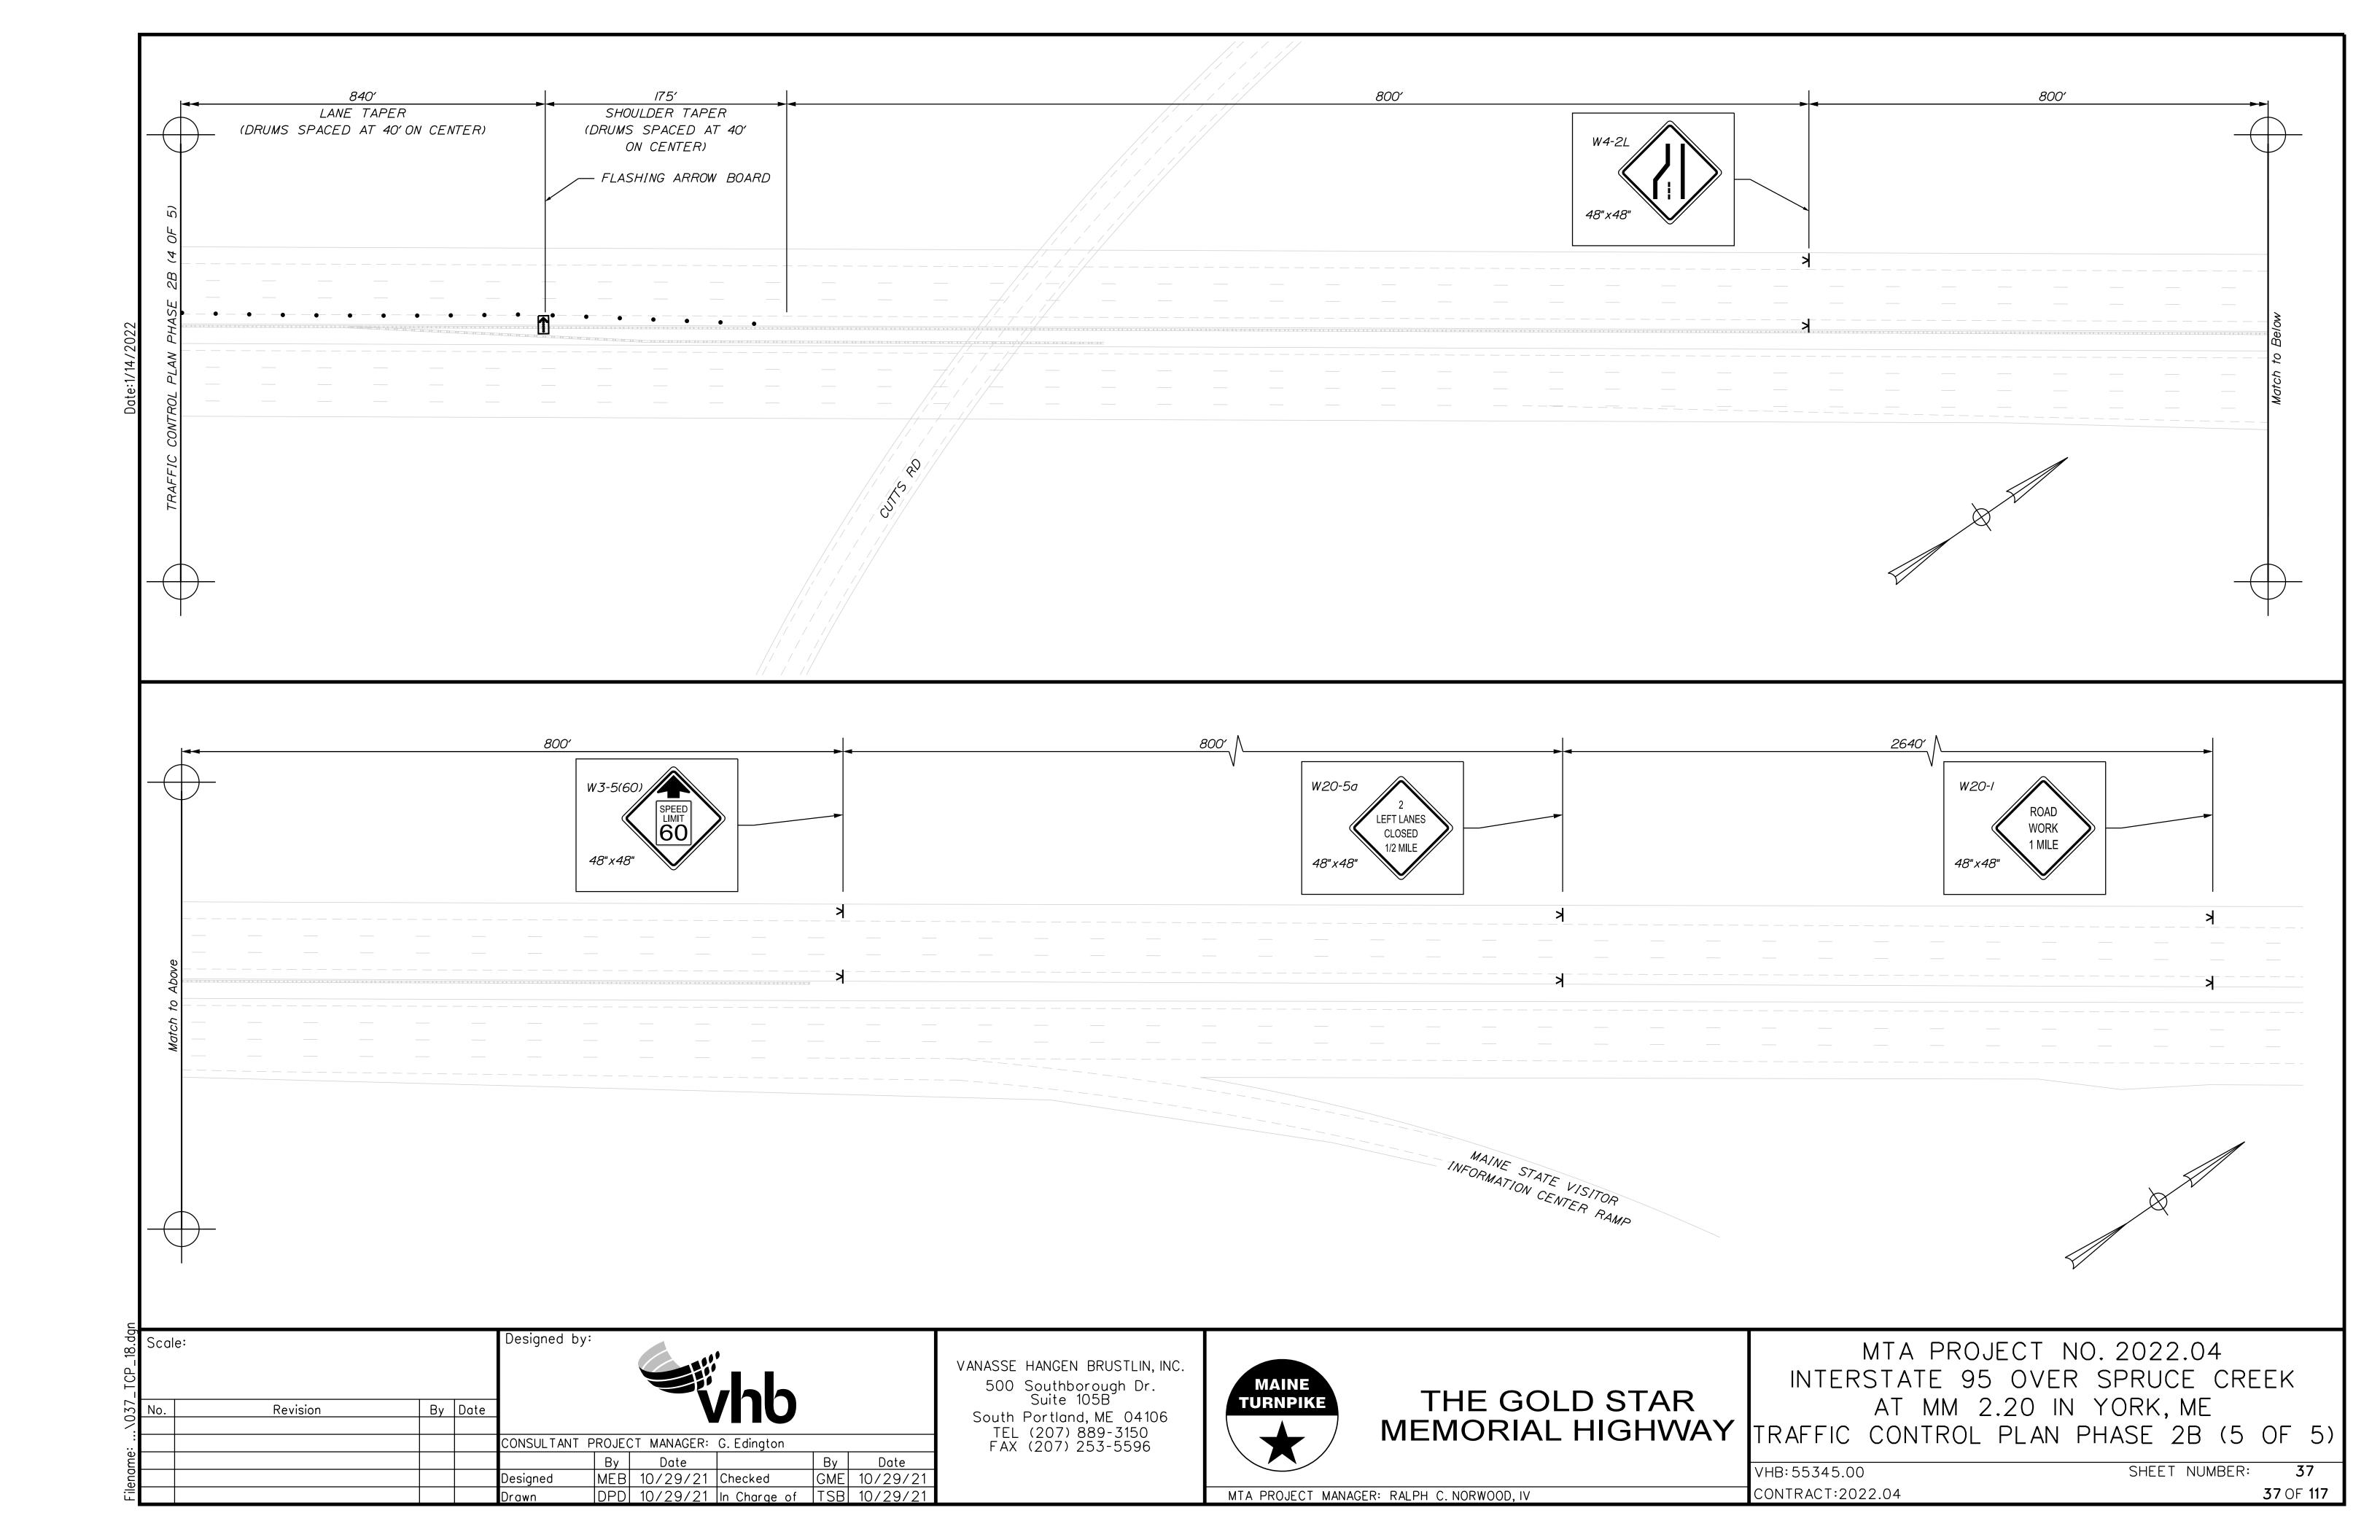

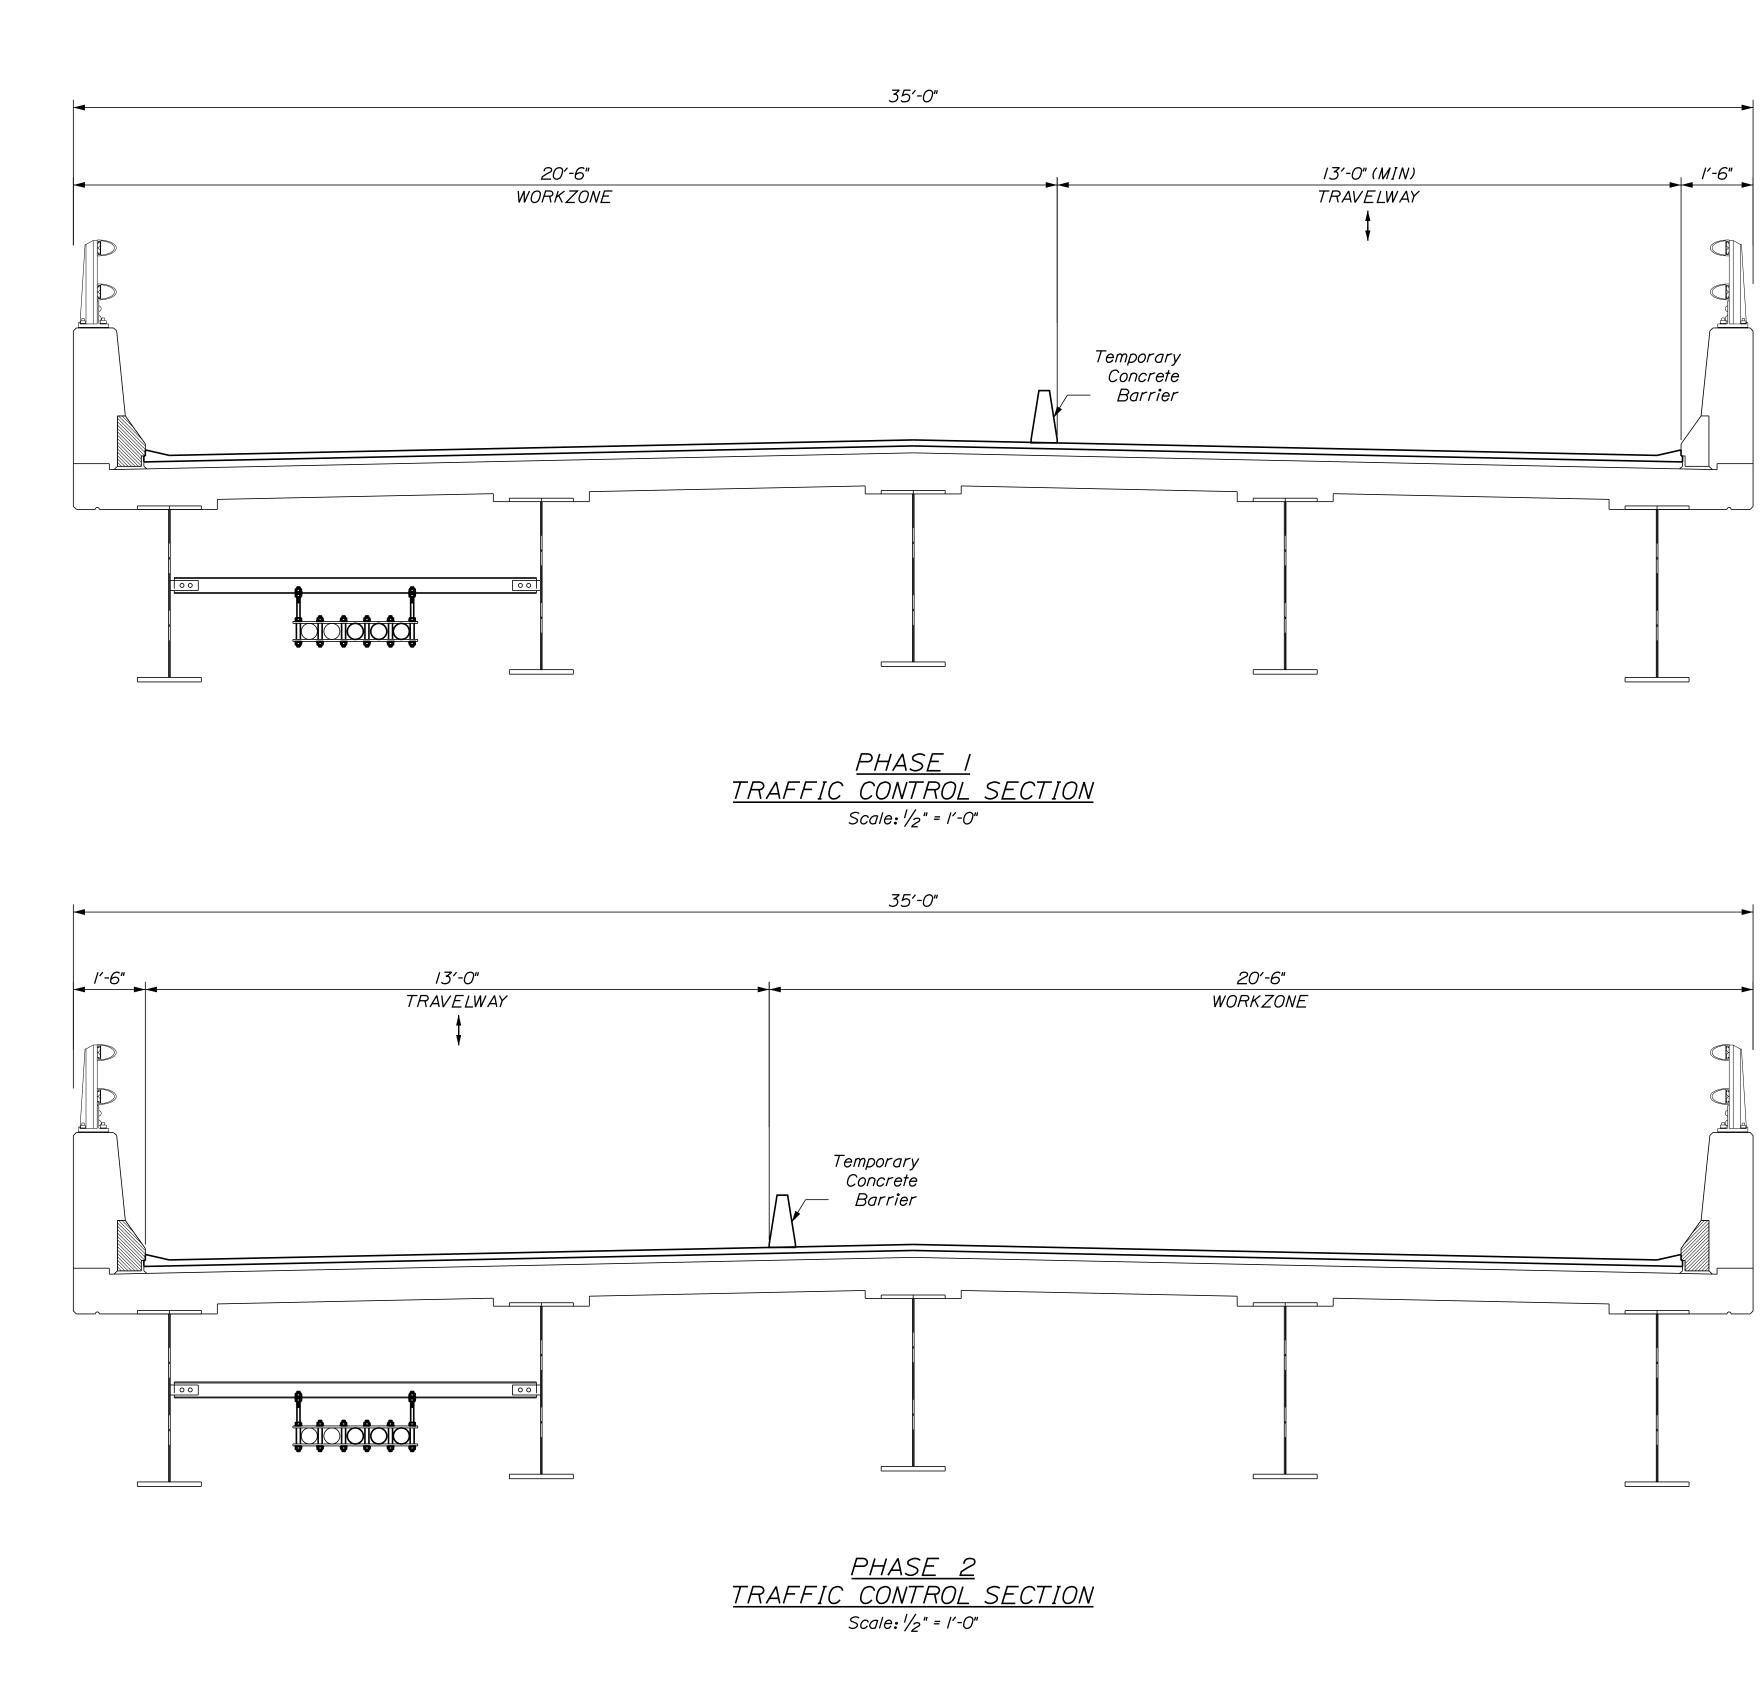

Designed by: Scale: AS NOTED By Date Revision CONSULTANT PROJECT MANAGER: G. Edington
 By
 Date
 By
 Date

 MEB 10/29/21 Checked
 GME 10/29/21

 DPD 10/29/21 In Charge of TSB 10/29/21
 Designed

VANASSE HANGEN BRUSTLIN, INC. 500 Southborough Dr. Suite 105B

South Portland, ME 04106 TEL (207) 889-3150 FAX (207) 253-5596



THE GOLD STAR MEMORIAL HIGHWAY

MTA PROJECT NO. 2022.04 LITTLEFIELD ROAD UNDERPASS AT MM 17.3 IN WELLS, ME LANE CLOSURE CRITICAL SECTION

SHEET NUMBER: VHB: 55345.00 CONTRACT:2022.04

MTA PROJECT MANAGER: RALPH C. NORWOOD, IV


OVERSIZED VEHICLE DETOUR FOR LITTLEFIELD ROAD UNDERPASS CLOSURE

	DE	TOUR S	SIGN SU	MMARY	
	Sign	Text Din (Inc	nensions hes)	Size	Quantity and Color
	Sigii	Letter Height	Vertical Spacing	3126	addinity and color
CS-4	VEHICLES OVER 12FT WIDE	6	6 6	96"x/8"	4 - Black on Orange
CS-5	PROHIBITED ON LITTLEFIELD RD AT TURNPIKE BRIDGE	6 6 6	4.5 4.5 4.5 4.5	96"x36"	4 - Black on White
G20-2	END ROAD WORK		nensions conform andard way	36"x18"	2 - Black on Orange
R10-6	STOP HERE ON RED	Signs"	- 2012 	24"x36"	2 - Black on White
W3-3				36"x36"	2 - Black on Orange (Red/Yellow/Green)
W5-3	ONE LANE BRIDGE			36"x36"	2 - Black on Orange
W20-1 (AHEAD)	ROAD WORK AHEAD	•		36"x36"	2 - Black on Orange

TRAFFIC CONTROL NOTES:

I. Advanced signing for the temporary signal system shall not be installed more than 2 days prior to the activation of the temporary signal system and shall be removed immediately after the removal of the temporary signal system.

2. The wide vehicle prohibition signs shall be in place anytime the available roadway width is less than 14'-0".

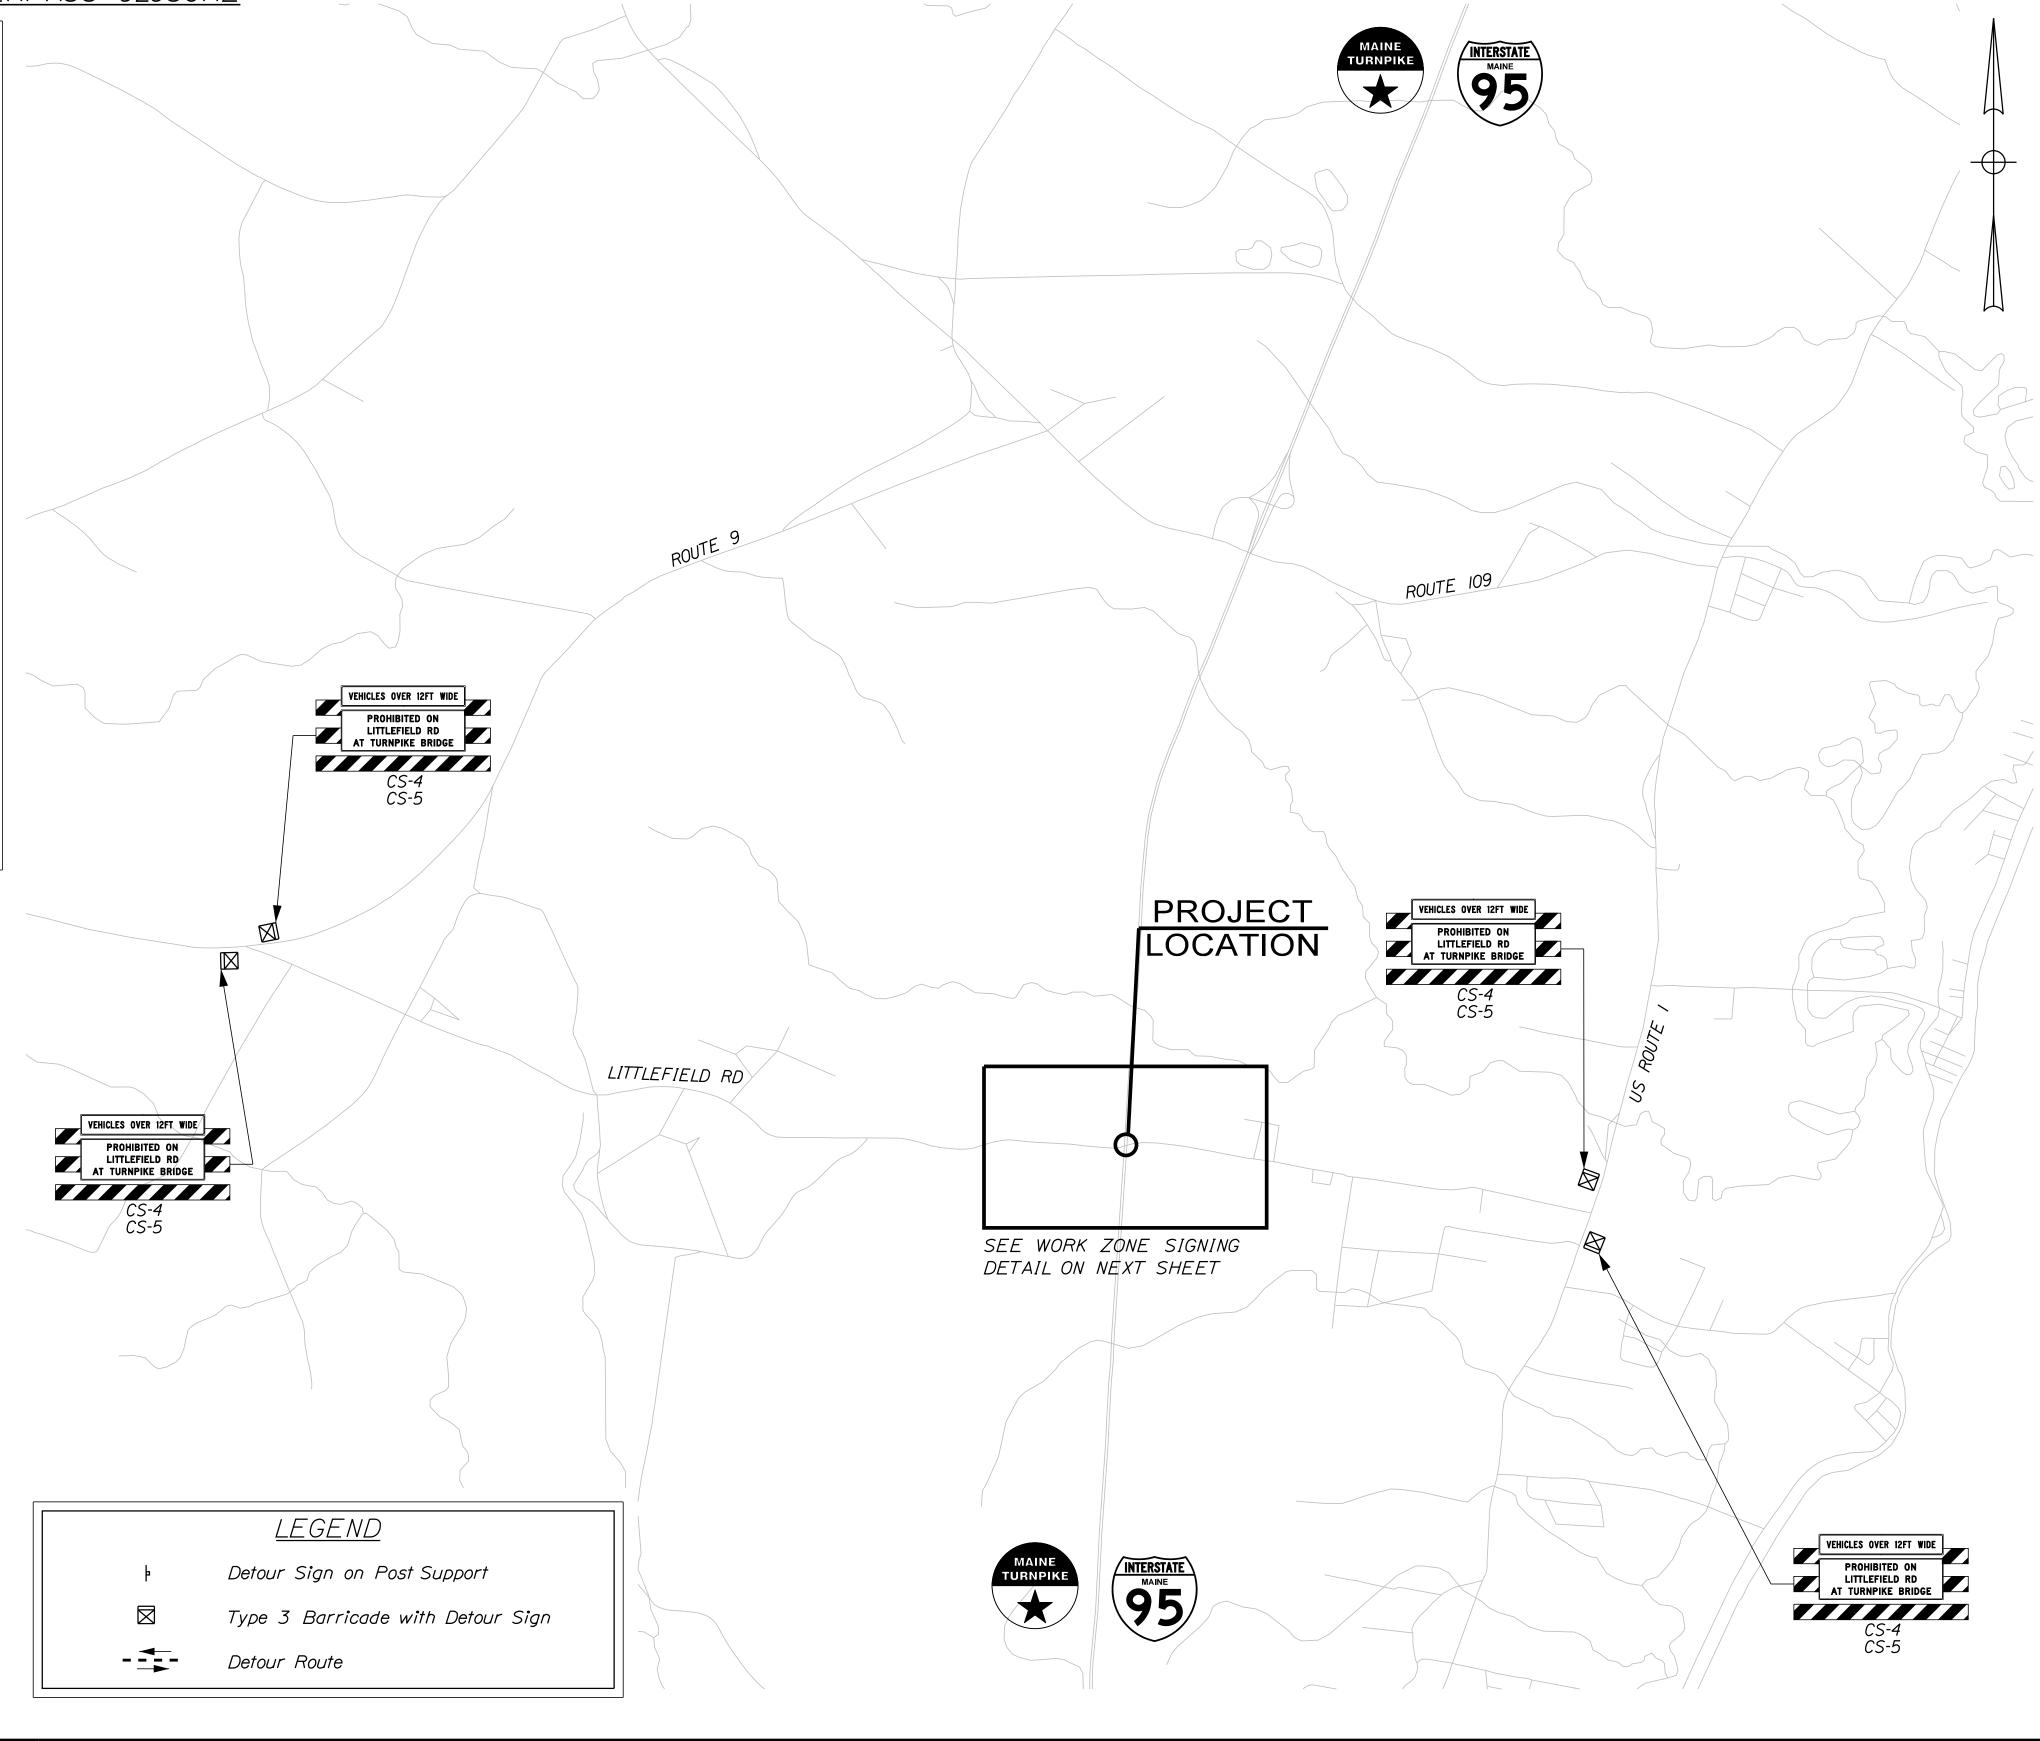

SHSB - Text Dimensions Shall Conform to "Standard Highway Signs Book" - 2012 Edition.

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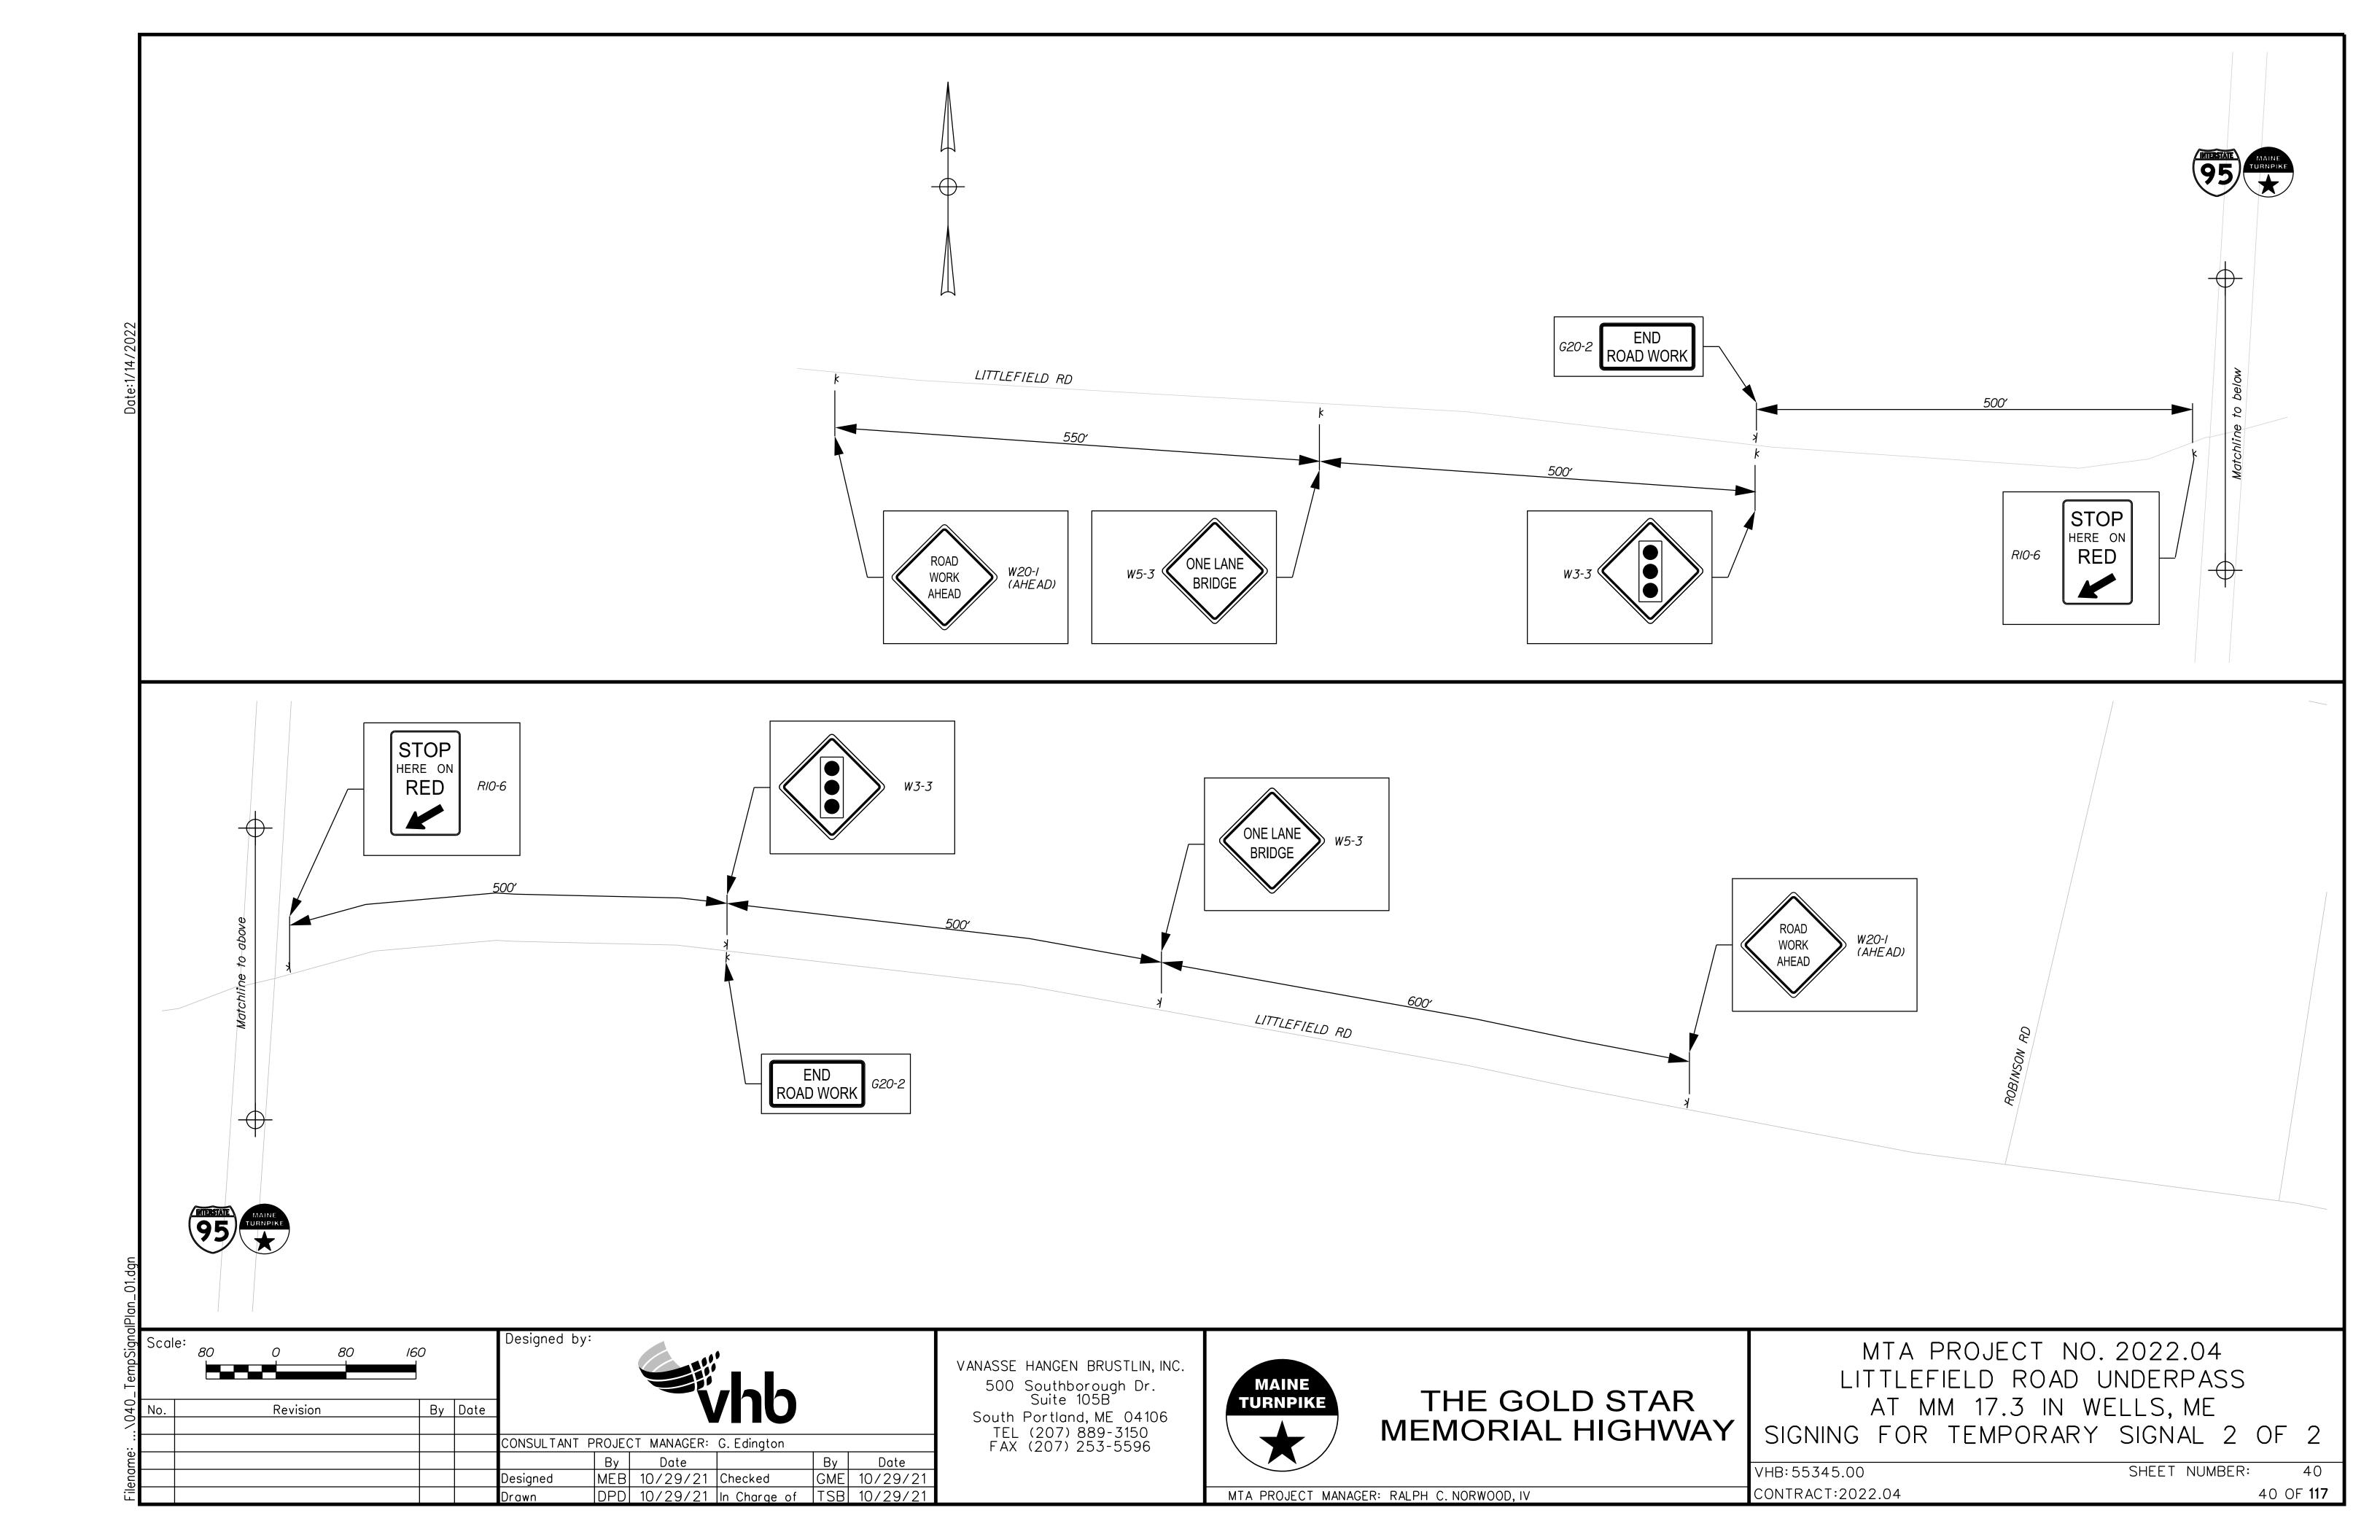
THE GOLD STAR MEMORIAL HIGHWAY


MTA PROJECT NO. 2022.04
LITTLEFIELD ROAD UNDERPASS
AT MM 17.3 IN WELLS, ME
SIGNING FOR TEMPORARY SIGNAL 1 OF 2

VHB: 55345.00 SHEE1


CONTRACT:2022.04

SHEET NUMBER: **39 39** OF **117**



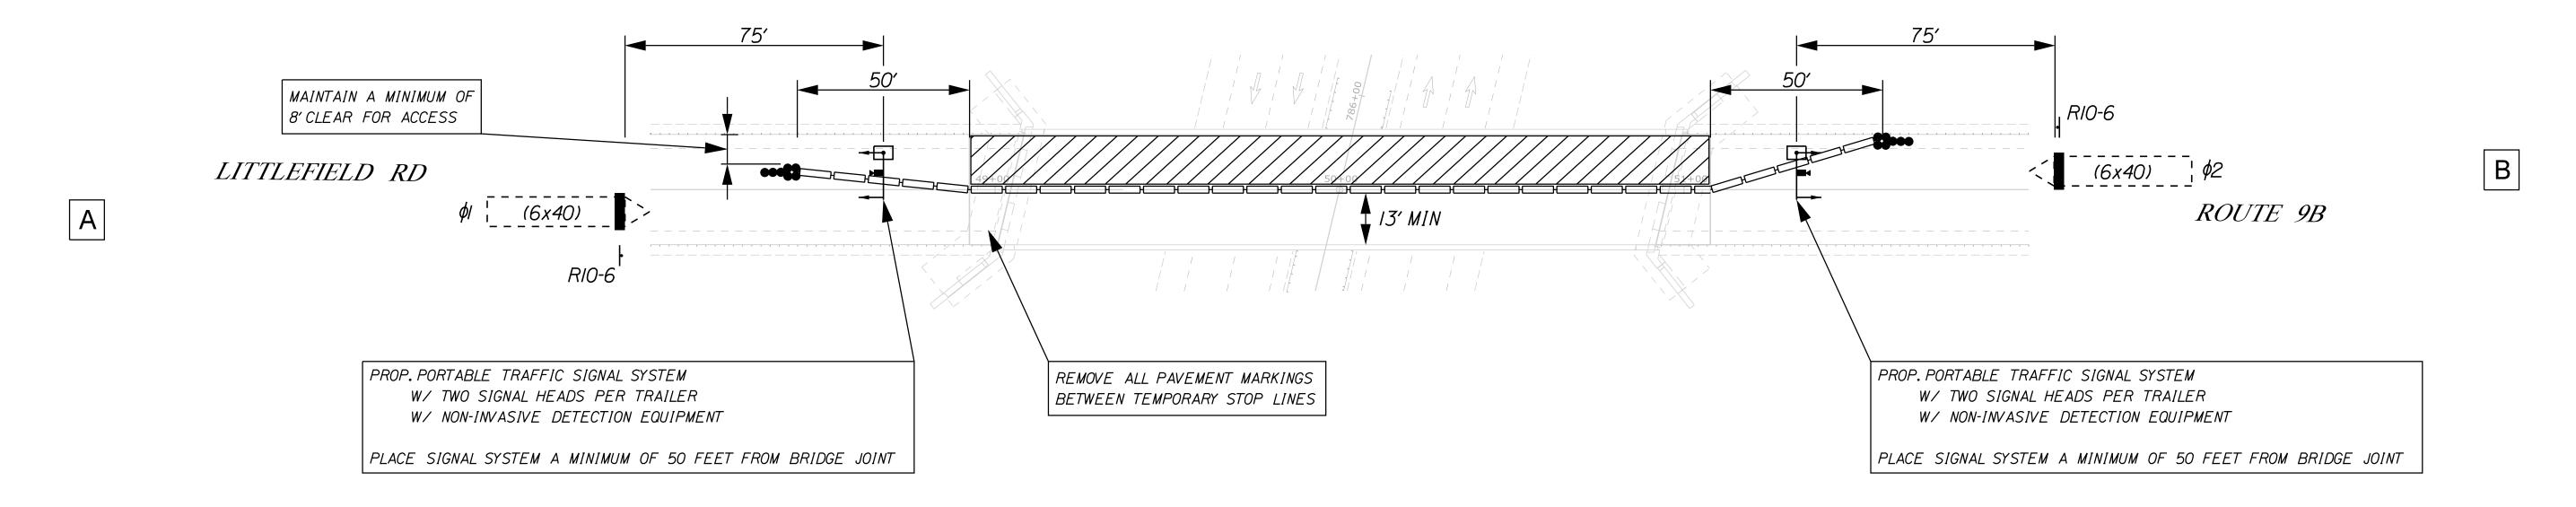

PROPOSED INDICATIONS

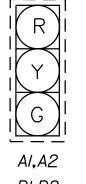

ALL INDICATIONS SHALL BE 12" LIGHT EMITTING DIODES (LED'S) WITH 5" LOUVERED


BACKPLATES

PROPOSED POST MOUNTED SIGNS



RIO-6 24" x 36" 2-PROPOSED

PHASE DIAGRAM

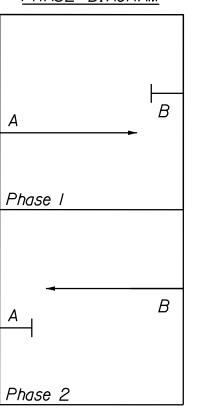

2022 EST. CONSTRUCTION DESIGN VOLUMES

145 →

←210

PROPOSED TEMPORARY NEMA 4 PHASE CONTROLLER SIGNAL PHASING & TIMING

	PHASE I	PHASE 2
MIN GREEN	10	10
EXTENSION	4	4
MAX /	30	30
MAX 2	-	-
VEH CLEAR	4	4
RED CLEAR	13	13
WALK	-	-
PED CLEAR	-	-
FLASH	FR	FR
RECALL	0FF	0FF
DETECTOR	NL	NL
PRE-EMPT PRIORITY	_	-
I - LOCKING		

L = LOCKING NL = NON-LOCKING

THE CONTRACTOR SHALL SET TIMING OF THE TEMPORARY TRAFFIC SIGNAL PER TIMING DATA PROVIDED. SIGNAL TIMING ADJUSTMENTS SHALL BE APPROVED BY THE RESIDENT AND ACCOMPLISHED AS DIRECTED BY THE RESIDENT. PAYMENT FOR ALL SIGNAL TIMING ADJUSTMENTS SHALL BE INCIDENTAL TO THE TRAFFIC SIGNAL SYSTEM.

<u>NOTES:</u>

- I. SEE LITTLEFIELD ROAD UNDERPASS TEMPORARY SIGNAL PLAN ADVANCE SIGNING FOR APPROACH SIGNS.
- 2. ADJUSTMENTS TO THE LOCATIONS OF THE STOP LINES RELATIVE TO THE BRIDGE JOINTS SHALL BE APPROVED BY THE RESIDENT AND MAY AFFECT THE PROPOSED SIGNAL TIMING.
- 3. THE TEMPORARY TRAILER MOUNTED SIGNAL SYSTEM IS SHOWN AS A FEASIBLE OPTION FOR TRAFFIC CONTROL. THE CONTRACTOR MAY PROPOSE AN ALTERNATIVE METHOD FOR MAINTAINING TRAFFIC DURING BRIDGE REPAIRS. ALL COSTS FOR MAINTENANCE OF TRAFFIC AT THE LITTLEFIELD ROAD BRIDGE SHALL BE INCIDENTAL TO ITEM 652.39.

<u>LEGEND</u>

CONSTRUCTION AREA

PORTABLE CONCRETE BARRIER CHANNELIZATION DEVICES

IMPACT ATTENUATION DEVICE

VEHICLE DETECTION ZONE PORTABLE TRAFFIC SIGNAL TRAILER

TYPE III BARRICADE

_TempSignalPlar	Scale	e: 25	0	<i>25</i>	50		Designed by:					
041	No.		Revision		Ву	Date	1					
$\stackrel{\smile}{:}$												
::							CONSULTANT P	ROJEC	CT MANAGER:	G. Edington		
me								Ву	Date		Ву	Date
ilename:							Designed	MÉB	10/29/21	Checked	GME	10/29/21
							Drawn	DPD	10/29/21	In Charge of	TSB	10/29/21

VANASSE HANGEN BRUSTLIN, INC. 500 Southborough Dr. Suite 105B

South Portland, ME 04106 TEL (207) 889-3150 FAX (207) 253-5596



THE GOLD STAR MEMORIAL HIGHWAY


MTA PROJECT NO. 2022.04 LITTLEFIELD ROAD UNDERPASS AT MM 17.3 IN WELLS, ME TEMPORARY SIGNAL PLAN - PHASE 1

VHB: 55345.00


SHEET NUMBER:

41


CONTRACT:2022.04 **41** OF **117**

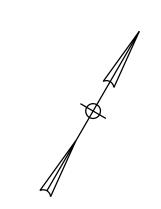



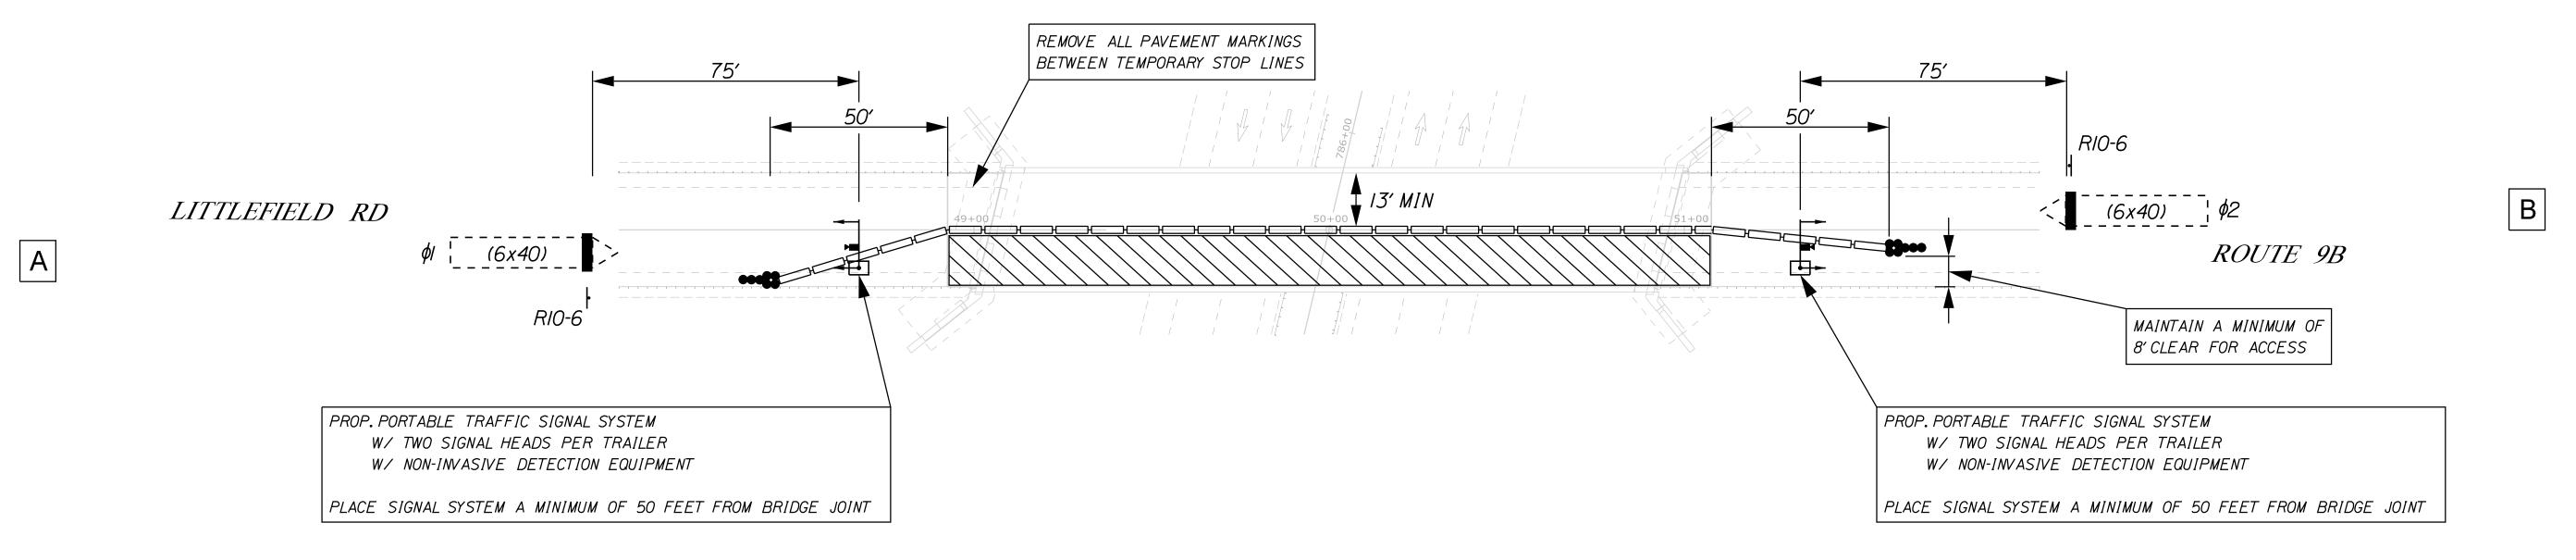

PROPOSED INDICATIONS

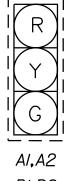


ALL INDICATIONS SHALL BE 12" LIGHT EMITTING DIODES (LED'S) WITH 5" LOUVERED BACKPLATES

PROPOSED POST MOUNTED SIGNS



RIO-6 24" x 36" 2-PROPOSED

<u>PHASE DIAGRAM</u>

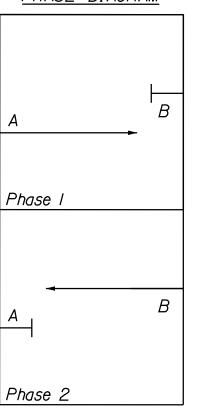

2022 EST. CONSTRUCTION DESIGN VOLUMES

145 →

←210

PROPOSED TEMPORARY NEMA 4 PHASE CONTROLLER SIGNAL PHASING & TIMING


	PHASE I	PHASE 2
MIN GREEN	10	10
EXTENSION	4	4
MAX /	30	30
MAX 2	-	-
VEH CLEAR	4	4
RED CLEAR	13	13
WALK	-	-
PED CLEAR	-	-
FLASH	FR	FR
RECALL	0FF	0FF
DETECTOR	NL	NL
PRE-EMPT PRIORITY	_	-
I - LOCKING	-	

L = LOCKING NL = NON-LOCKING

THE CONTRACTOR SHALL SET TIMING OF THE TEMPORARY TRAFFIC SIGNAL PER TIMING DATA PROVIDED. SIGNAL TIMING ADJUSTMENTS SHALL BE APPROVED BY THE RESIDENT AND ACCOMPLISHED AS DIRECTED BY THE RESIDENT. PAYMENT FOR ALL SIGNAL TIMING ADJUSTMENTS SHALL BE INCIDENTAL TO THE TRAFFIC SIGNAL SYSTEM.

<u>NOTES:</u>

- I. SEE LITTLEFIELD ROAD UNDERPASS TEMPORARY SIGNAL PLAN ADVANCE SIGNING FOR APPROACH SIGNS.
- 2. ADJUSTMENTS TO THE LOCATIONS OF THE STOP LINES RELATIVE TO THE BRIDGE JOINTS SHALL BE APPROVED BY THE RESIDENT AND MAY AFFECT THE PROPOSED SIGNAL TIMING.
- 3. THE TEMPORARY TRAILER MOUNTED SIGNAL SYSTEM IS SHOWN AS A FEASIBLE OPTION FOR TRAFFIC CONTROL. THE CONTRACTOR MAY PROPOSE AN ALTERNATIVE METHOD FOR MAINTAINING TRAFFIC DURING BRIDGE REPAIRS. ALL COSTS FOR MAINTENANCE OF TRAFFIC AT THE LITTLEFIELD ROAD BRIDGE SHALL BE INCIDENTAL TO ITEM 652.39.

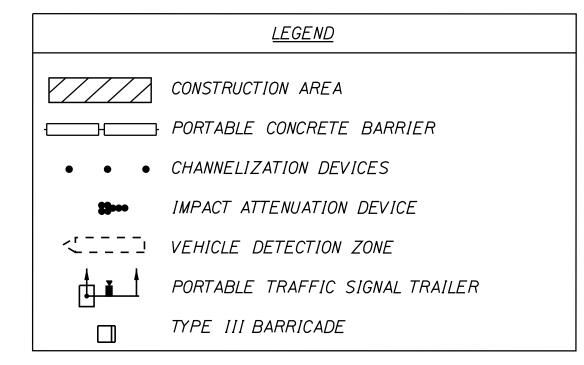

_ I empSignalF	Scale:	25 0	25	50			Designed by:					
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me								Ву	Date		Ву	Date
r Ilename:							Designed	MEB	10/29/21	Checked	GME	10/29/21
<u>=</u>							Drawn	DPD	10/29/21	In Charge of	TSB	10/29/21

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South Portland, ME 04106 TEL (207) 889-3150 FAX (207) 253-5596



THE GOLD STAR MEMORIAL HIGHWAY


MTA PROJECT NO. 2022.04 LITTLEFIELD ROAD UNDERPASS AT MM 17.3 IN WELLS, ME TEMPORARY SIGNAL PLAN - PHASE 2

VHB: 55345.00 CONTRACT:2022.04


SHEET NUMBER:

MTA PROJECT MANAGER: RALPH C. NORWOOD, IV


TYPICAL HORIZONTAL SURFACE CONCRETE REPAIR DETAILS

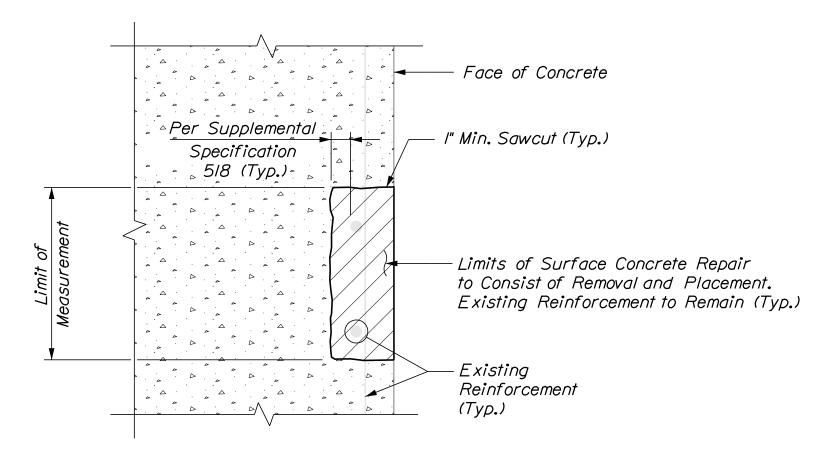

TYPICAL VERTICAL SURFACE CONCRETE REPAIR DETAILS

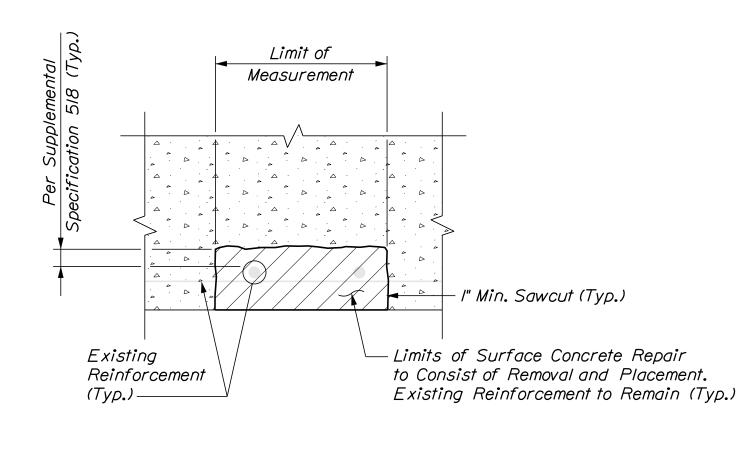


TYPICAL OVERHEAD SURFACE CONCRETE REPAIR DETAILS

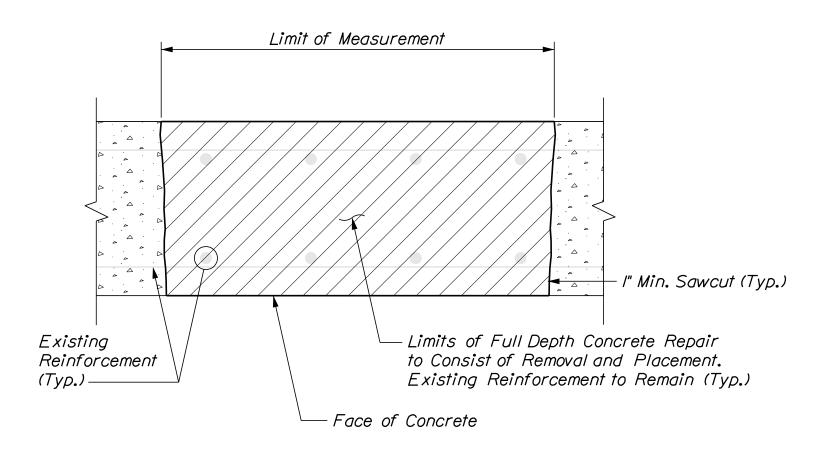

TYPICAL FULL DEPTH CONCRETE REPAIR DETAILS

CONCRETE HAUNCH REMOVAL NOTES:

- I. The removal of the portion of the concrete haunch shown shall be paid for at the contract unit price per linear foot under Item 202.1211, Removing Existing Girder Haunch. The Haunch on each side of the girder shall be measured separately for payment.
- 2. If over-removal results, apply two coats of epoxy resin to deck reinforcing steel exposed during haunch removal. All reasonable precautions shall be taken to avoid this condition. Epoxy resin and application shall be incidental to Item 202.1211, Removing Existing Girder Haunch.

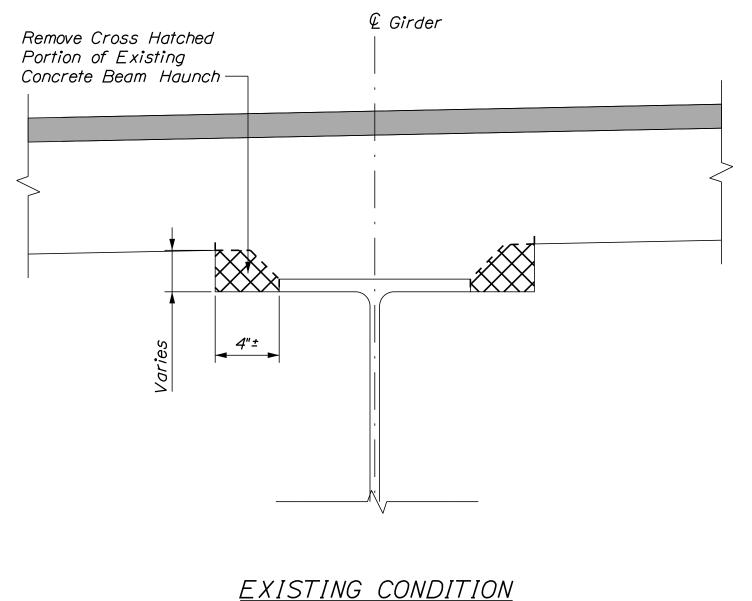

CONCRETE REPAIR NOTES

- I. Repair work shall include: surface concrete repairs, epoxy injection crack repair and providing access for inspection.
- 2. Where surface concrete repairs are specified the work shall include removal of unsound concrete and placement and curing of repair materials. Repairs shall be measured for payment under Items 202.1211, Removing Existing Girder Haunches, 202.122 Removing Existing Structural Concrete, 518.10 Abutment Repairs, 518.20 Pier Repairs, 518.75 Fascia and Overhang Repairs, 518.70 Repair of Overhead Surfaces <8 inches, and 518.80 Partial Depth Concrete Deck Repair.
- 3. Prior to the start of any concrete repairs the Resident and the Contractor shall sound all concrete surfaces and agree on the repair limits. Estimated repair quantities may increase at the Resident's discretion.
- 4. The estimated repair quantities are based on inspections completed in April December 2020.


CONCRETE SURFACE REPAIR NOTES

- I. Perform I" deep saw cuts along limits of removal.
- 2. Chip concrete to the depth specified in Supplemental Specification 518. If the removal limits change during the demolition process the Contractor shall notify the Resident. The Resident and Contractor shall agree on the revised pay limits prior to the Contractor continuing the removal.
- 3. Prepare and patch repair areas with Class AAA modified concrete.
- 4. Perform general finishing.

CONTRACT: 2022.04

EPOXY INJECTION CRACK REPAIR NOTES

- I. All crack repairs shall be completed by an individual qualified and experienced in the type of repairs proposed.
- 2. All crack repairs shall be completed in accordance with Supplemental Specification 518.
- 3. Where epoxy injection crack repair is specified the work shall include pressure injection of cracks I/I6" or more in width. Work shall be paid under Item 518.4 Epoxy Injection Crack Repair.

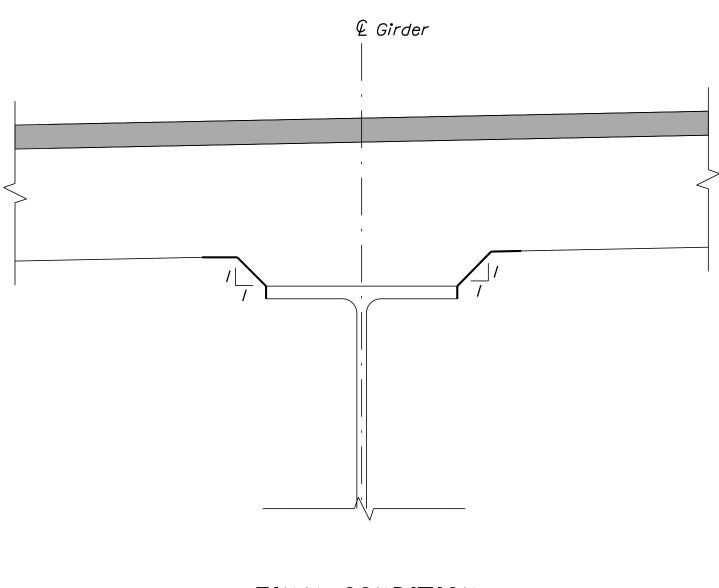

FINAL CONDITION

Not to Scale

CONCRETE HAUNCH REMOVAL DETAILS

<u>KEY</u>

Existing Concrete

/ / Proposed Concrete

VANASSE HANGEN BRUSTLIN, INC. 500 Southborough Dr. Suite 105B

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Not to Scale

THE GOLD STAR
MEMORIAL HIGHWAY


MTA PROJECT NO. 2022.04 2022 SOUTHERN BRIDGE REPAIRS CONCRETE REPAIR TYPICAL DETAILS

VHB: 55345.00 SHEET NUMBER:

MTA PROJECT MANAGER: Ralph Norwood, IV

43 OF **117**

43

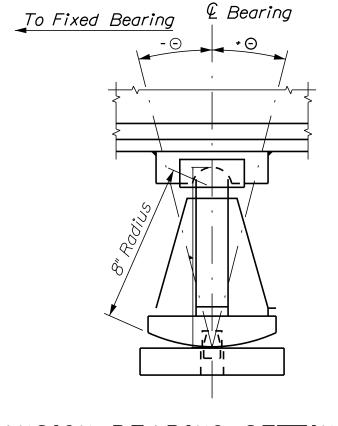

Temp.	Theta (deg.)⊙
(deg. F):	Abutment 2
30	-1 . 92
40	-0.64
45	0.00
50	0.64
60	1.92
70	<i>3.20</i>
80	4.47
90	5. 75

Temp. | Theta (deg.)⊙ (deg. F): Abutment 2 *30* -1.91 40 -0.64 *4*5 0.00 50 0.64 60 1.91 70 *3.*/9 80 *4.46* 90 *5.72*

EXPANSION BEARING SETTING DIAGRAM Not to Scale

ROUTE 236 BEARINGS TABLE

RAMP J BEARINGS TABLE

JOINT NOTES

(Fascia Curb Shown, Median Curb Similar)

Not to Scale

Top of Curb —

- I. Joint Detail at Curb applies to all locations which are receiving a new or replacement Asphaltic Plug Joint. Asphaltic Plug Joints shall be from the MaineDOT Qualified Products List.
- 2. Silicone Coated and Pre-Compressed Seal shall be an emseal bridge expansion joint system (BEJS) seal. Installation shall be in accordance with manufacturer specification. Payment shall be incidental to Item 520.23, Asphaltic Plug Joint.
- 3. After the installation of the asphaltic plug joint system. The bonded Silicone Coated and Pre-Compressed Seal shall be installed in the curbs as shown on the plans and as recommended by the manufacturer.
- 4. Individual pavement lifts for the approach pavement shall not exceed l'/2".

-Limits of Clear Existing Granite Protective Coating (Typ.) ± 6" Vertical Bridge (See Granite Curb Repair Note 5) Curb Type I - 1/2" Joint Sealant Full Length (See Granite Curb Repair Note 3) Existing Concrete Existing Non-Mortar Bedding Shrink Mortar CURB DETAIL

EXISTING GRANITE CURB DETAIL Scale: 3" = I'-0"

BEARING REPAIR NOTES

- I. Resetting the bearings shall be paid for under Item 523.1201, Reset Steel Bearings and all labor, equipment, and materials necessary to raise the existing bridge to accommodate this work shall be paid for under Item 524.7212, Jacking Existing Superstructure.
- 2. All existing dimensions and information shown on the plans are based on as-built and standard detail drawings. The Contractor shall field verify all relevant dimensions prior to submission of Jacking Plan.
- 3. See Special Provisions for lead paint removal requirements.
- 4. Bearings shall be reset prior to modifications of bridge
- 5. The temporary support and jacking system shall be designed by the Contractor. See Special Provision 524 for additional requirements.

GRANITE CURB REPAIR NOTES

- I. A bead of Hot-Applied Rubberized asphalt sealer shall be applied along curb lines after installation of base course. Payment shall not be made directly but shall be considered incidental to related contract items.
- 2. The Contractor shall treat corners and the vertical face of curbing in accordance with Special Provision section 508.
- 3. Joint sealant shall be a material from the MaineDOT approved products list as approved by the Resident. Joint sealant shall be incidental to item 518.391, Repairing Granite Curb Joint and Bedding Mortar.
- 4. Mortar for bedding and for joints in granite curb on bridges where required shall be an approved non-shrink mortar in accordance with Supplemental Specification 518.
- 5. Limits of clear protective coating shall be paid for under Item 5/5.202, Clear Protective Coating for Concrete Surfaces.

Designed by: Scale: AS NOTED By Date Revision CONSULTANT PROJECT MANAGER: G. Edington By Date Date MEB 10/29/21 Checked GME 10/29/21 Designed DPD 10/29/21 In Charge of TSB 10/29/21

(Bridge Rail not Shown for Clarity)

Scale: 3/4" = 1'-0"

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High Performance

Membrane Waterproofing

See Granite Curb

MTA PROJECT MANAGER: Ralph Norwood, IV

Repair Note 2

THE GOLD STAR MEMORIAL HIGHWAY


MTA PROJECT NO. 2022.04 2022 SOUTHERN BRIDGE REPAIRS

MISCELLANEOUS DETAILS


SHEET NUMBER: VHB: 55345.00

CONTRACT: 2022.04 44 OF **117**

44

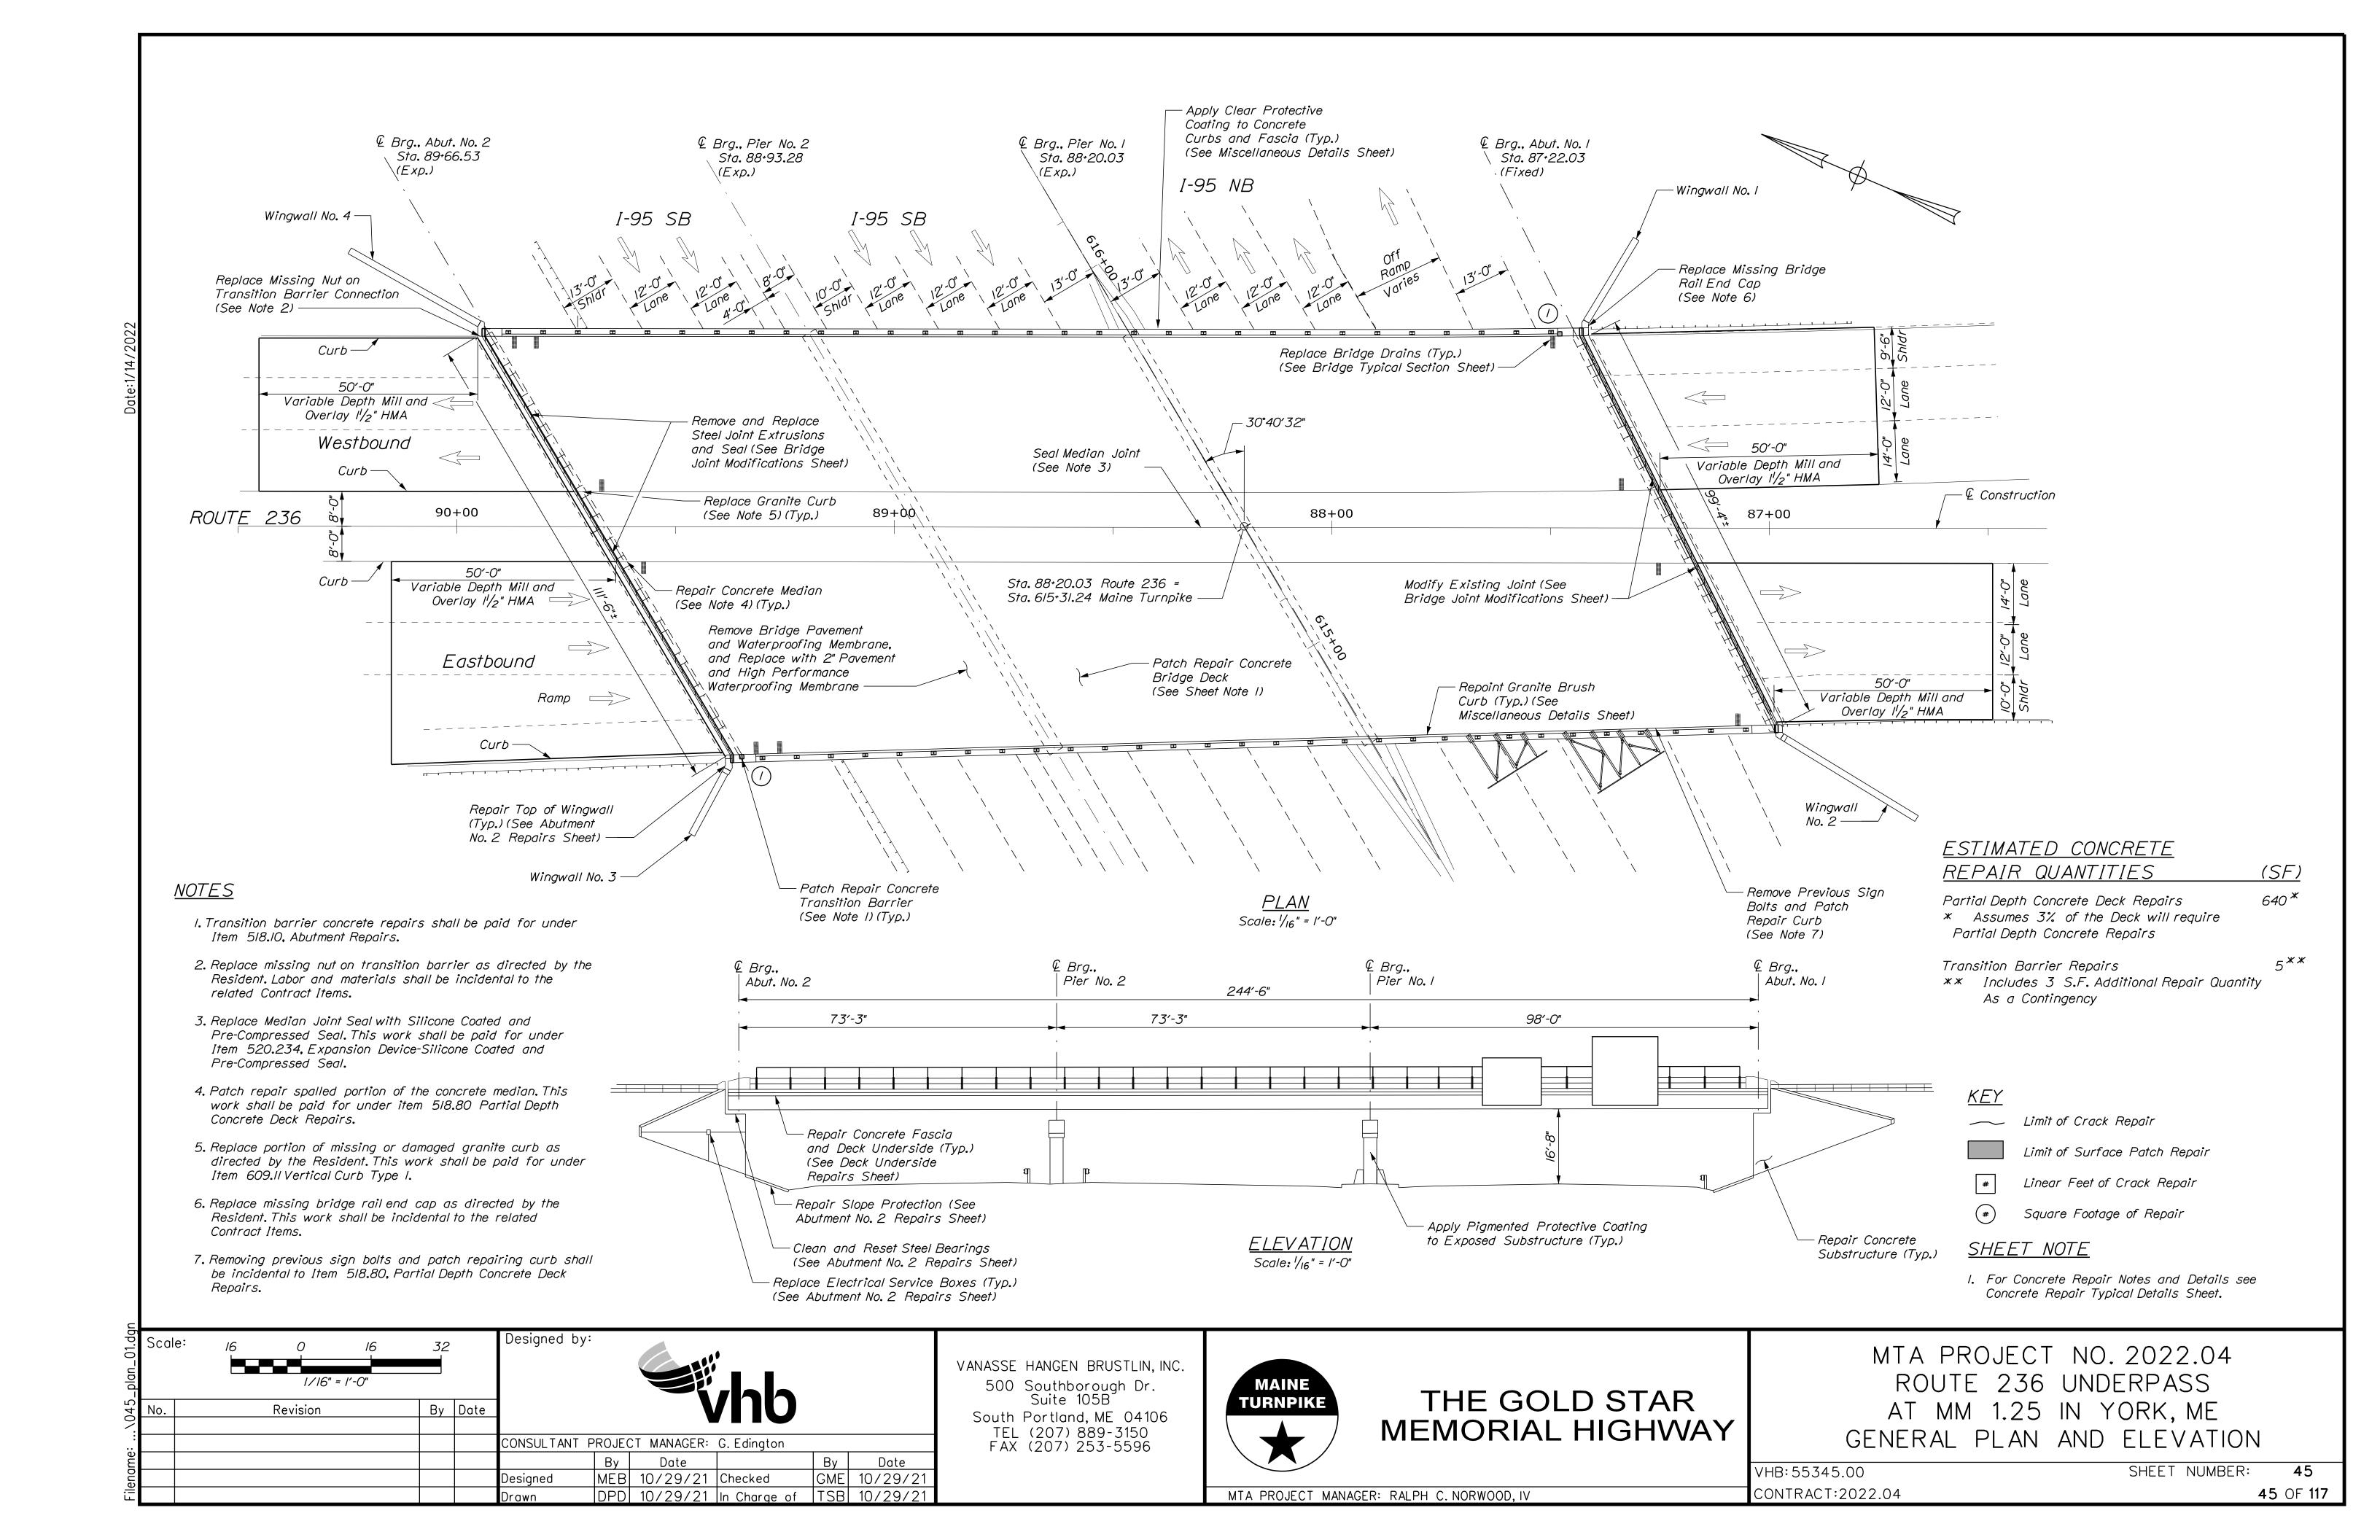

SUPERSTRUCTURE TYPICAL SECTION - EASTBOUND

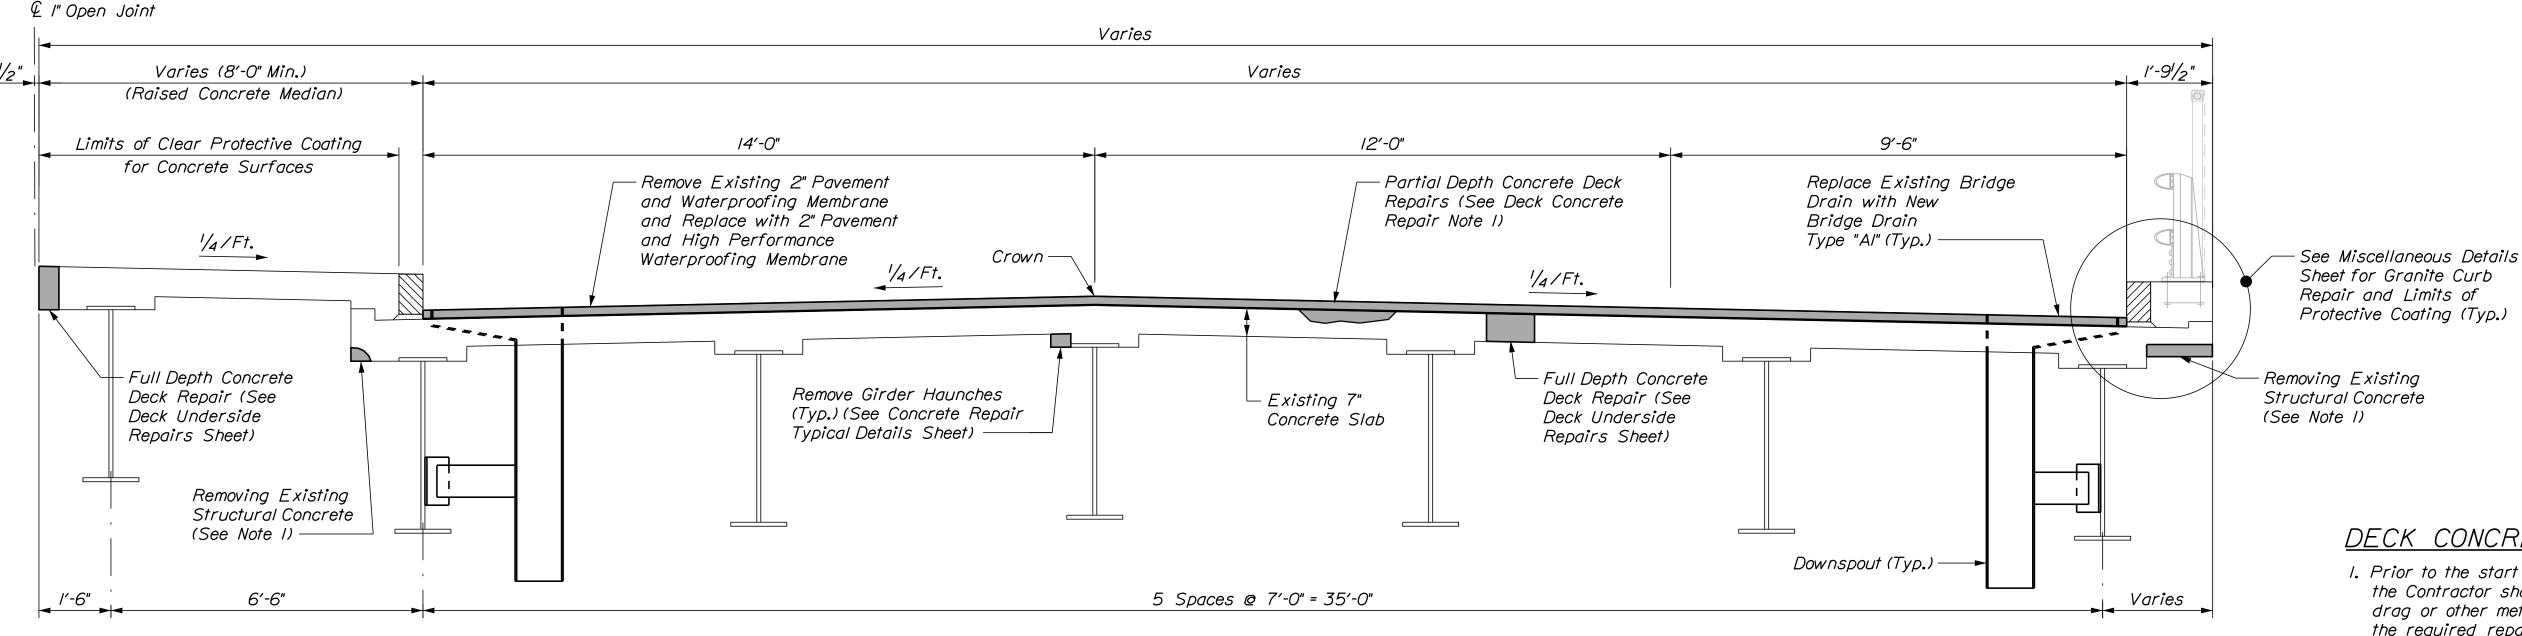

SUPERSTRUCTURE TYPICAL SECTION - WESTBOUND

NOTES

- I. Contractor shall coat all exposed reinforcing steel after removing structural concrete at the fascias and median haunch. Work shall be incidental to Item 202.122, Removing Existing Structural Concrete.
- 2. Replacing the bridge drains shall be paid for under Item 502.702, Replace Bridge Drain (Type AI).

DECK CONCRETE REPAIR NOTES

- I. Prior to the start of deck concrete repairs, the Resident and the Contractor shall sound all deck concrete using a chain drag or other method approved by the Resident to detemine the required repair limits. All costs for sounding the existing deck concrete shall be incidental to Item 518.80, Partial Depth Concrete Deck Repairs.
- 2. Sawcut I" deep along all limits of removal.
- 3. Chip concrete to the depth specified in Supplemental Specification 518. If the removal limits change during the demolition process, the Contractor shall notify the Resident. The Resident and Contractor shall agree on the revised pay limits prior to the Contractor continuing the removal.
- 4. Prepare and patch repair deteriorated areas. Install new reinforcing steel, as required. See Supplemental Specification 518.

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					Drawn	DPD	10/29/21	In Charge of	TSB	10/29/21

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MAINE
TURNPIKE


THE GOLD STAR MEMORIAL HIGHWAY


MTA PROJECT NO. 2022.04
ROUTE 236 UNDERPASS
AT MM 1.25 IN YORK, ME
BRIDGE TYPICAL SECTION


VHB:55345.00 CONTRACT:2022.04


SHEET NUMBER: 46


MTA PROJECT MANAGER: RALPH C. NORWOOD, IV

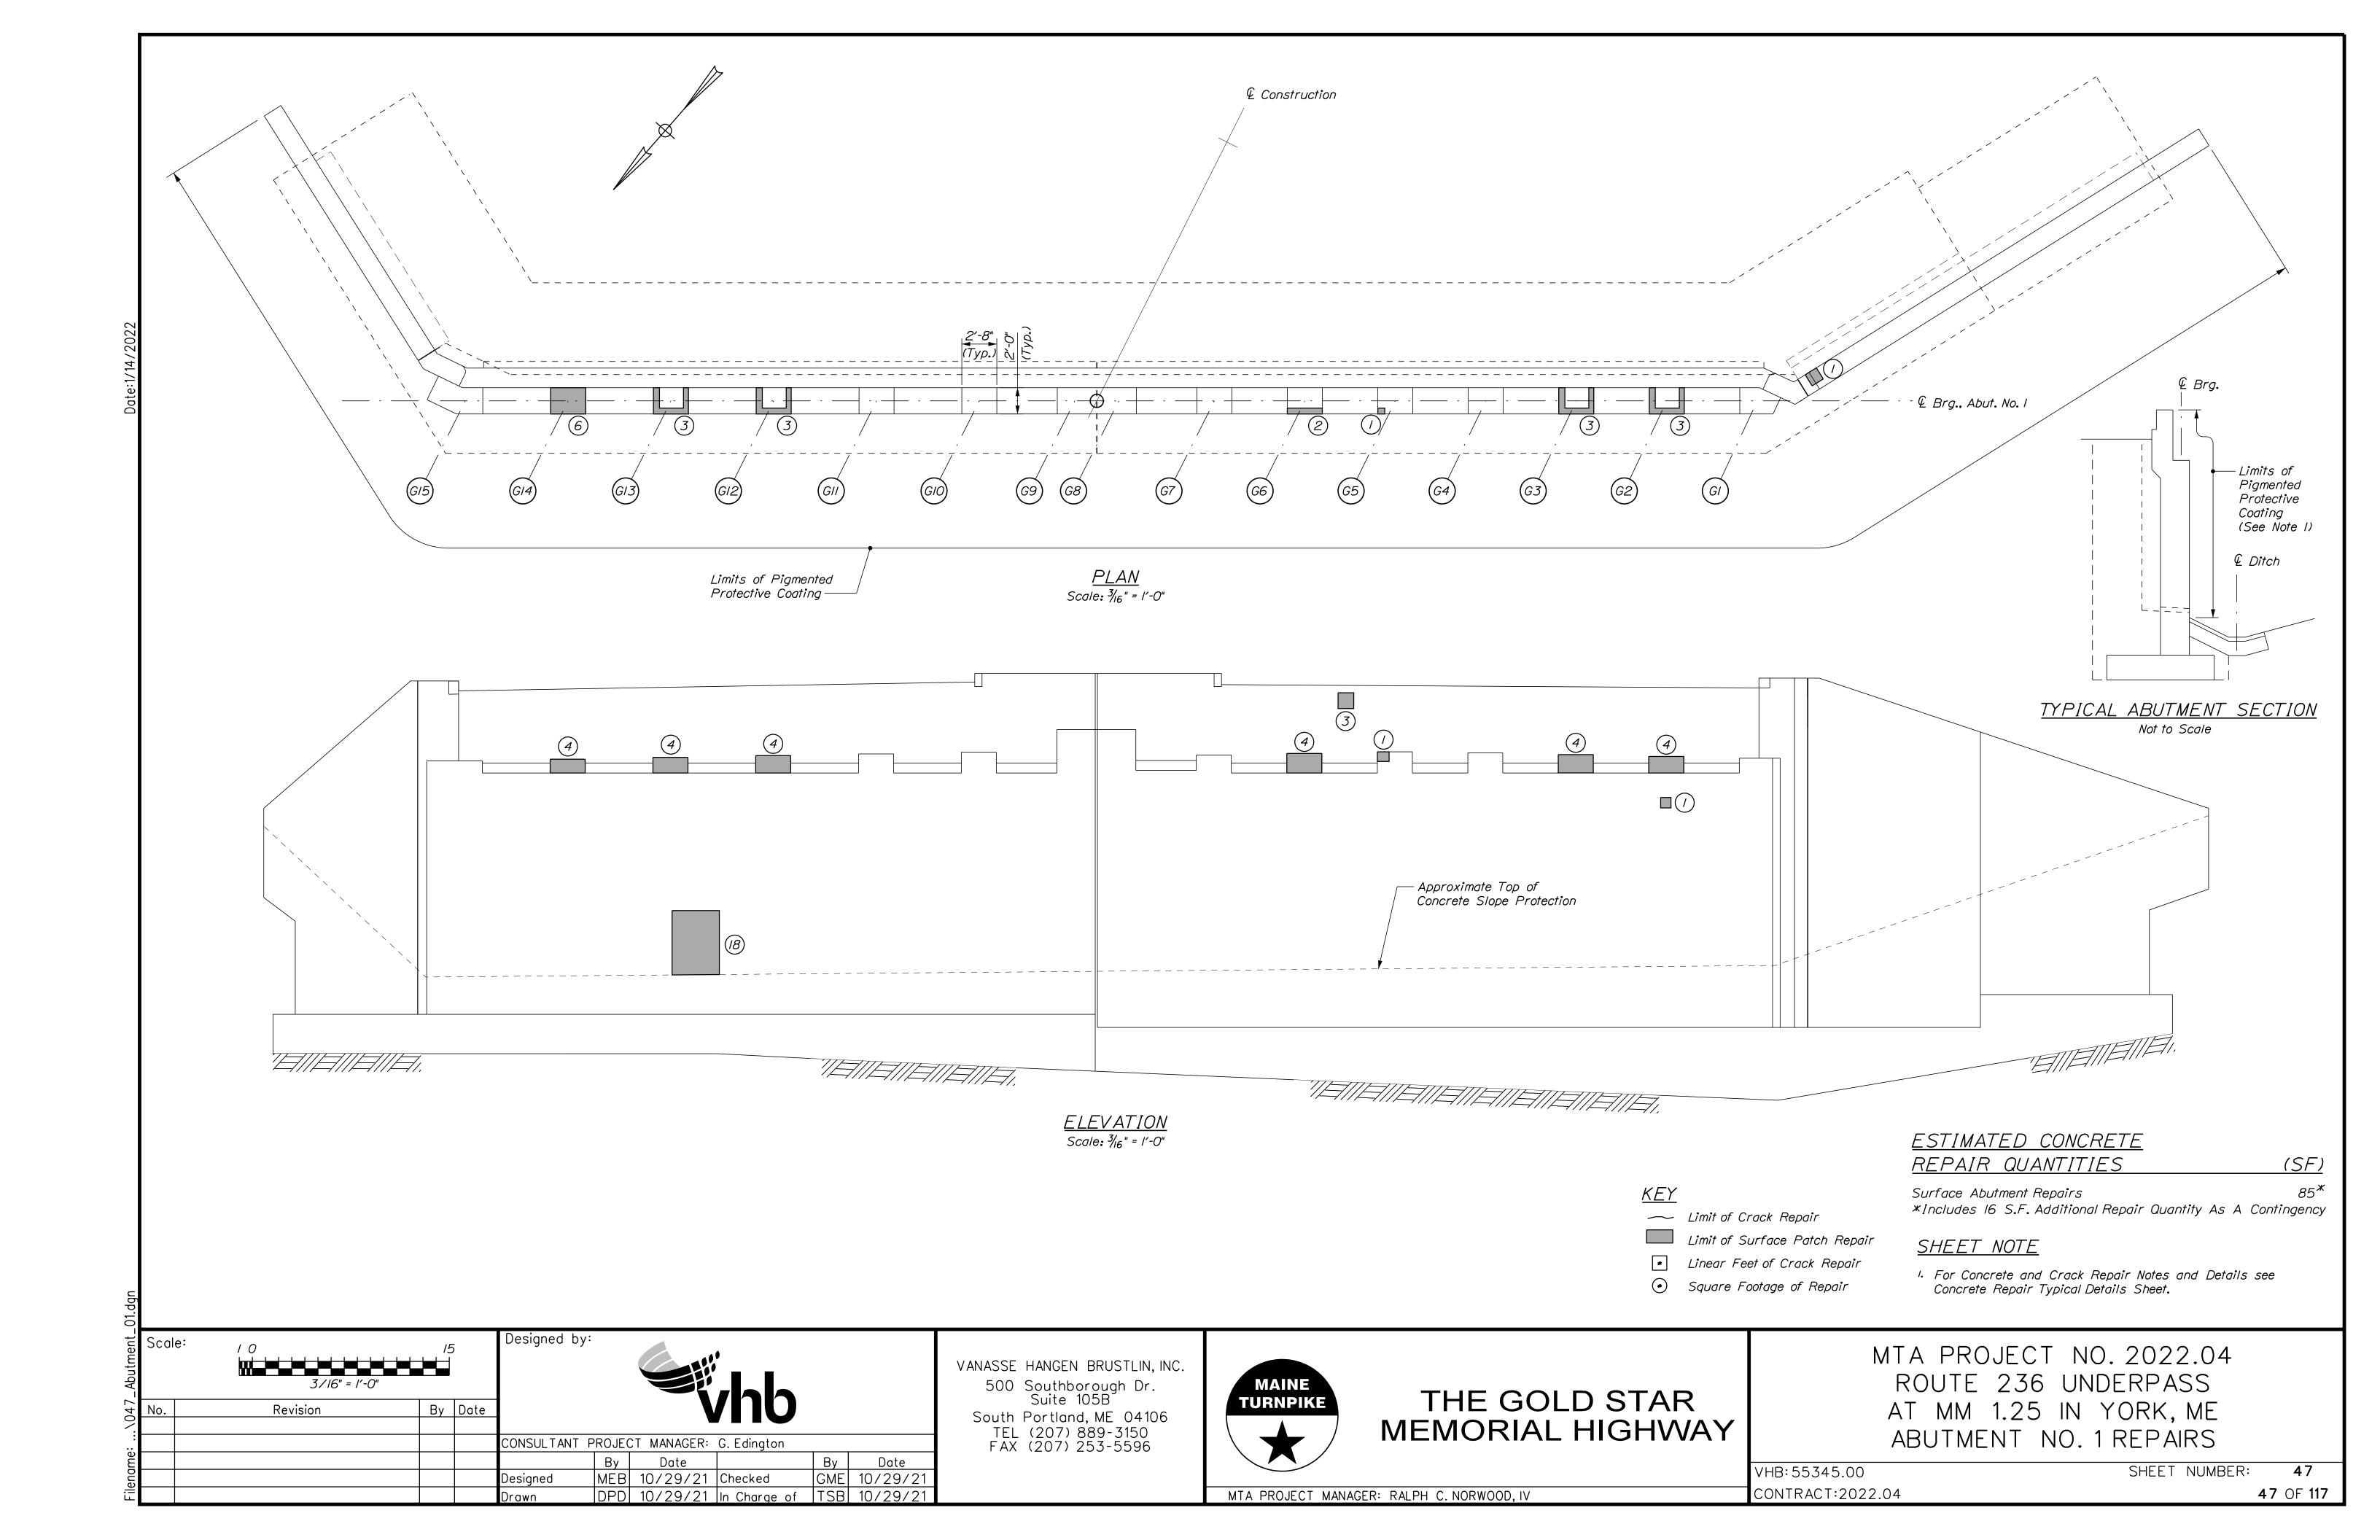


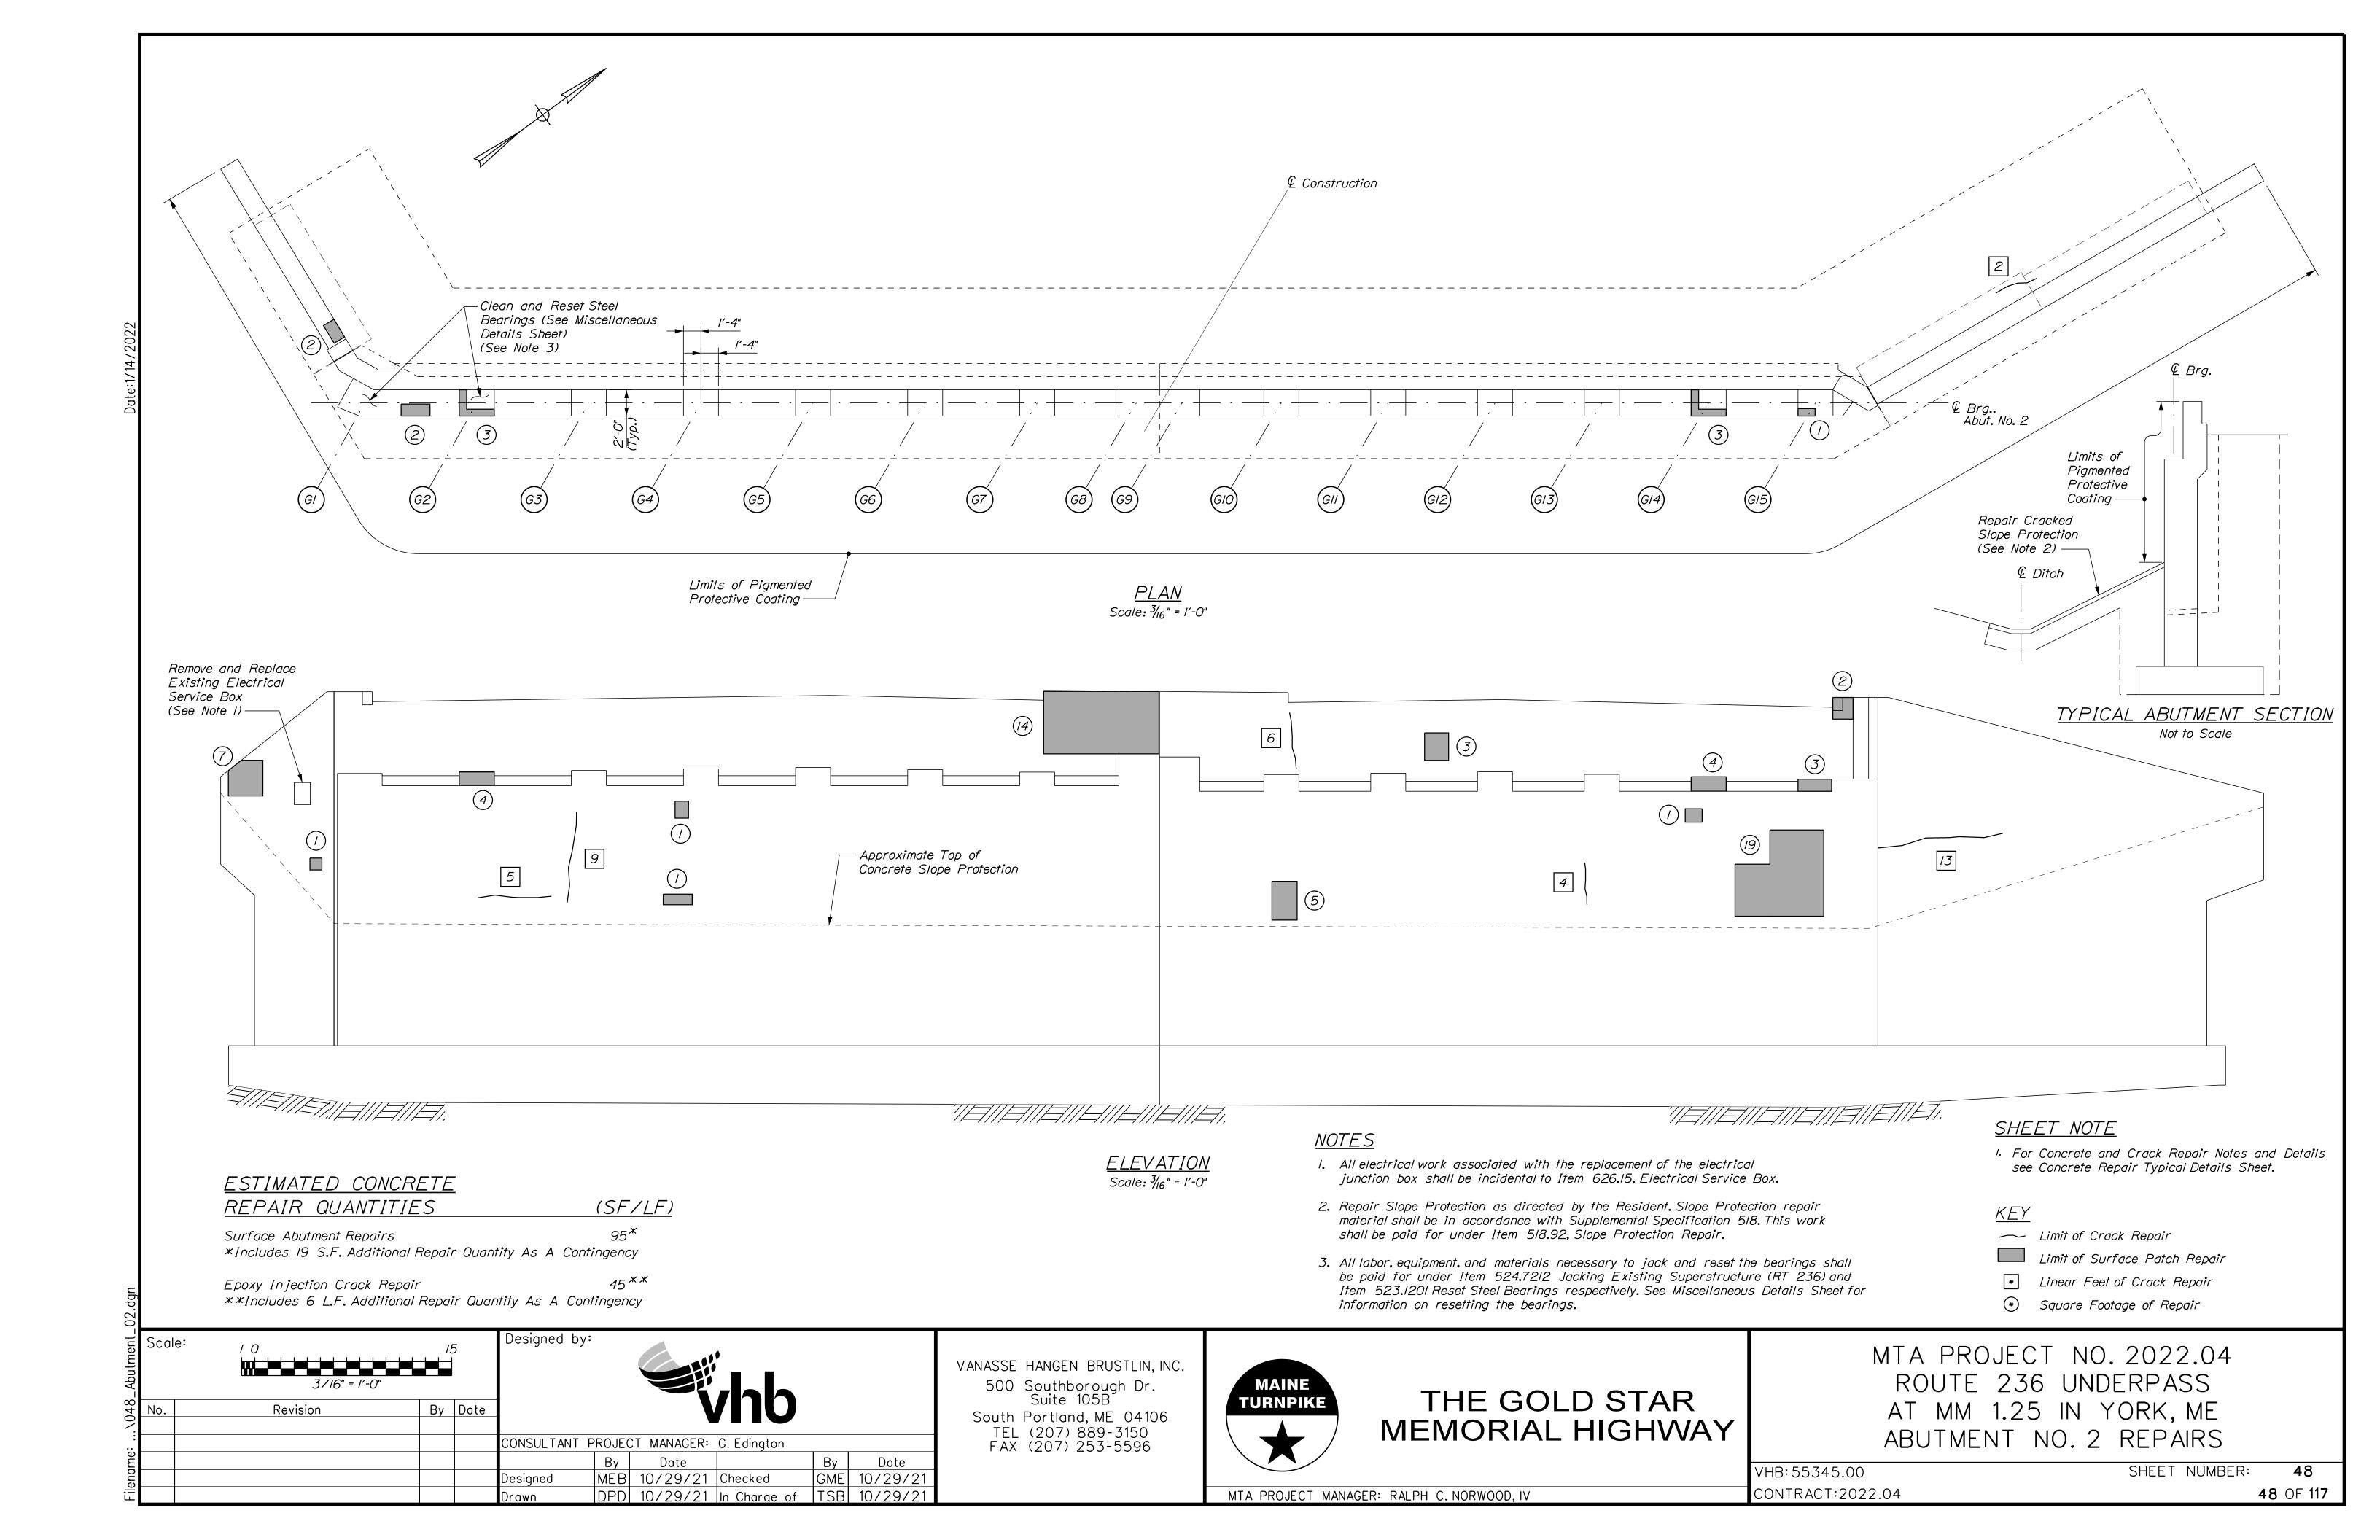

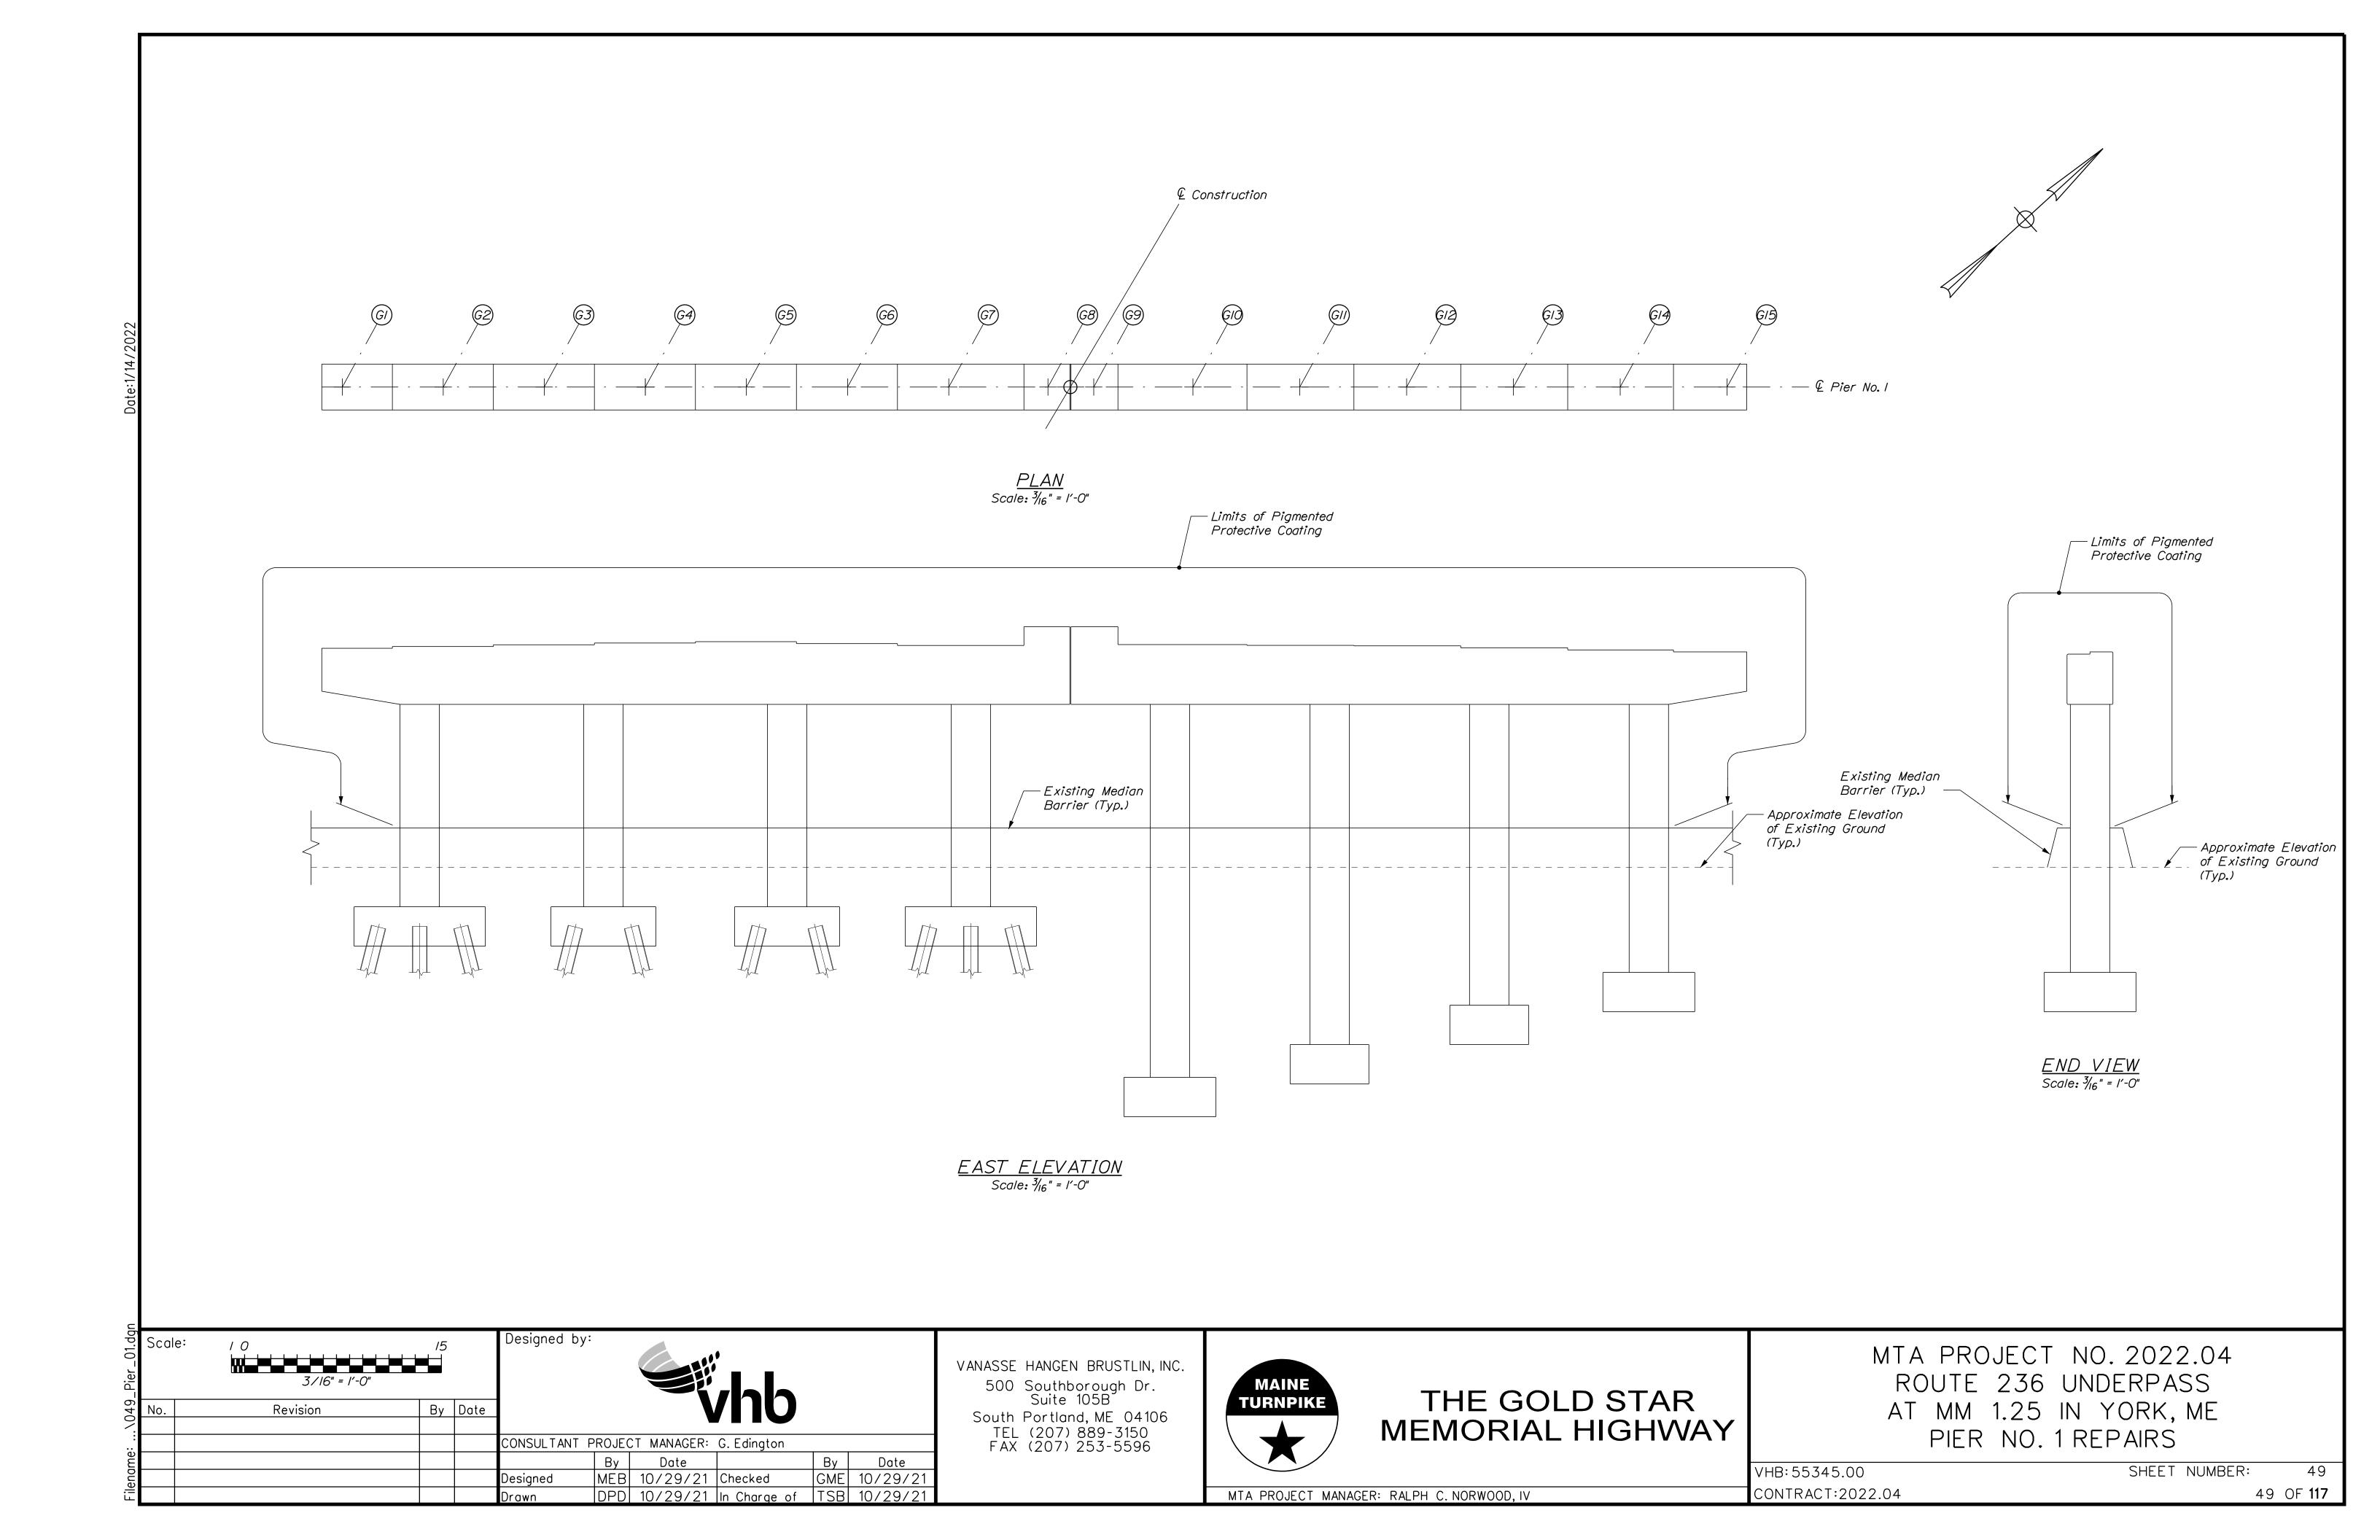

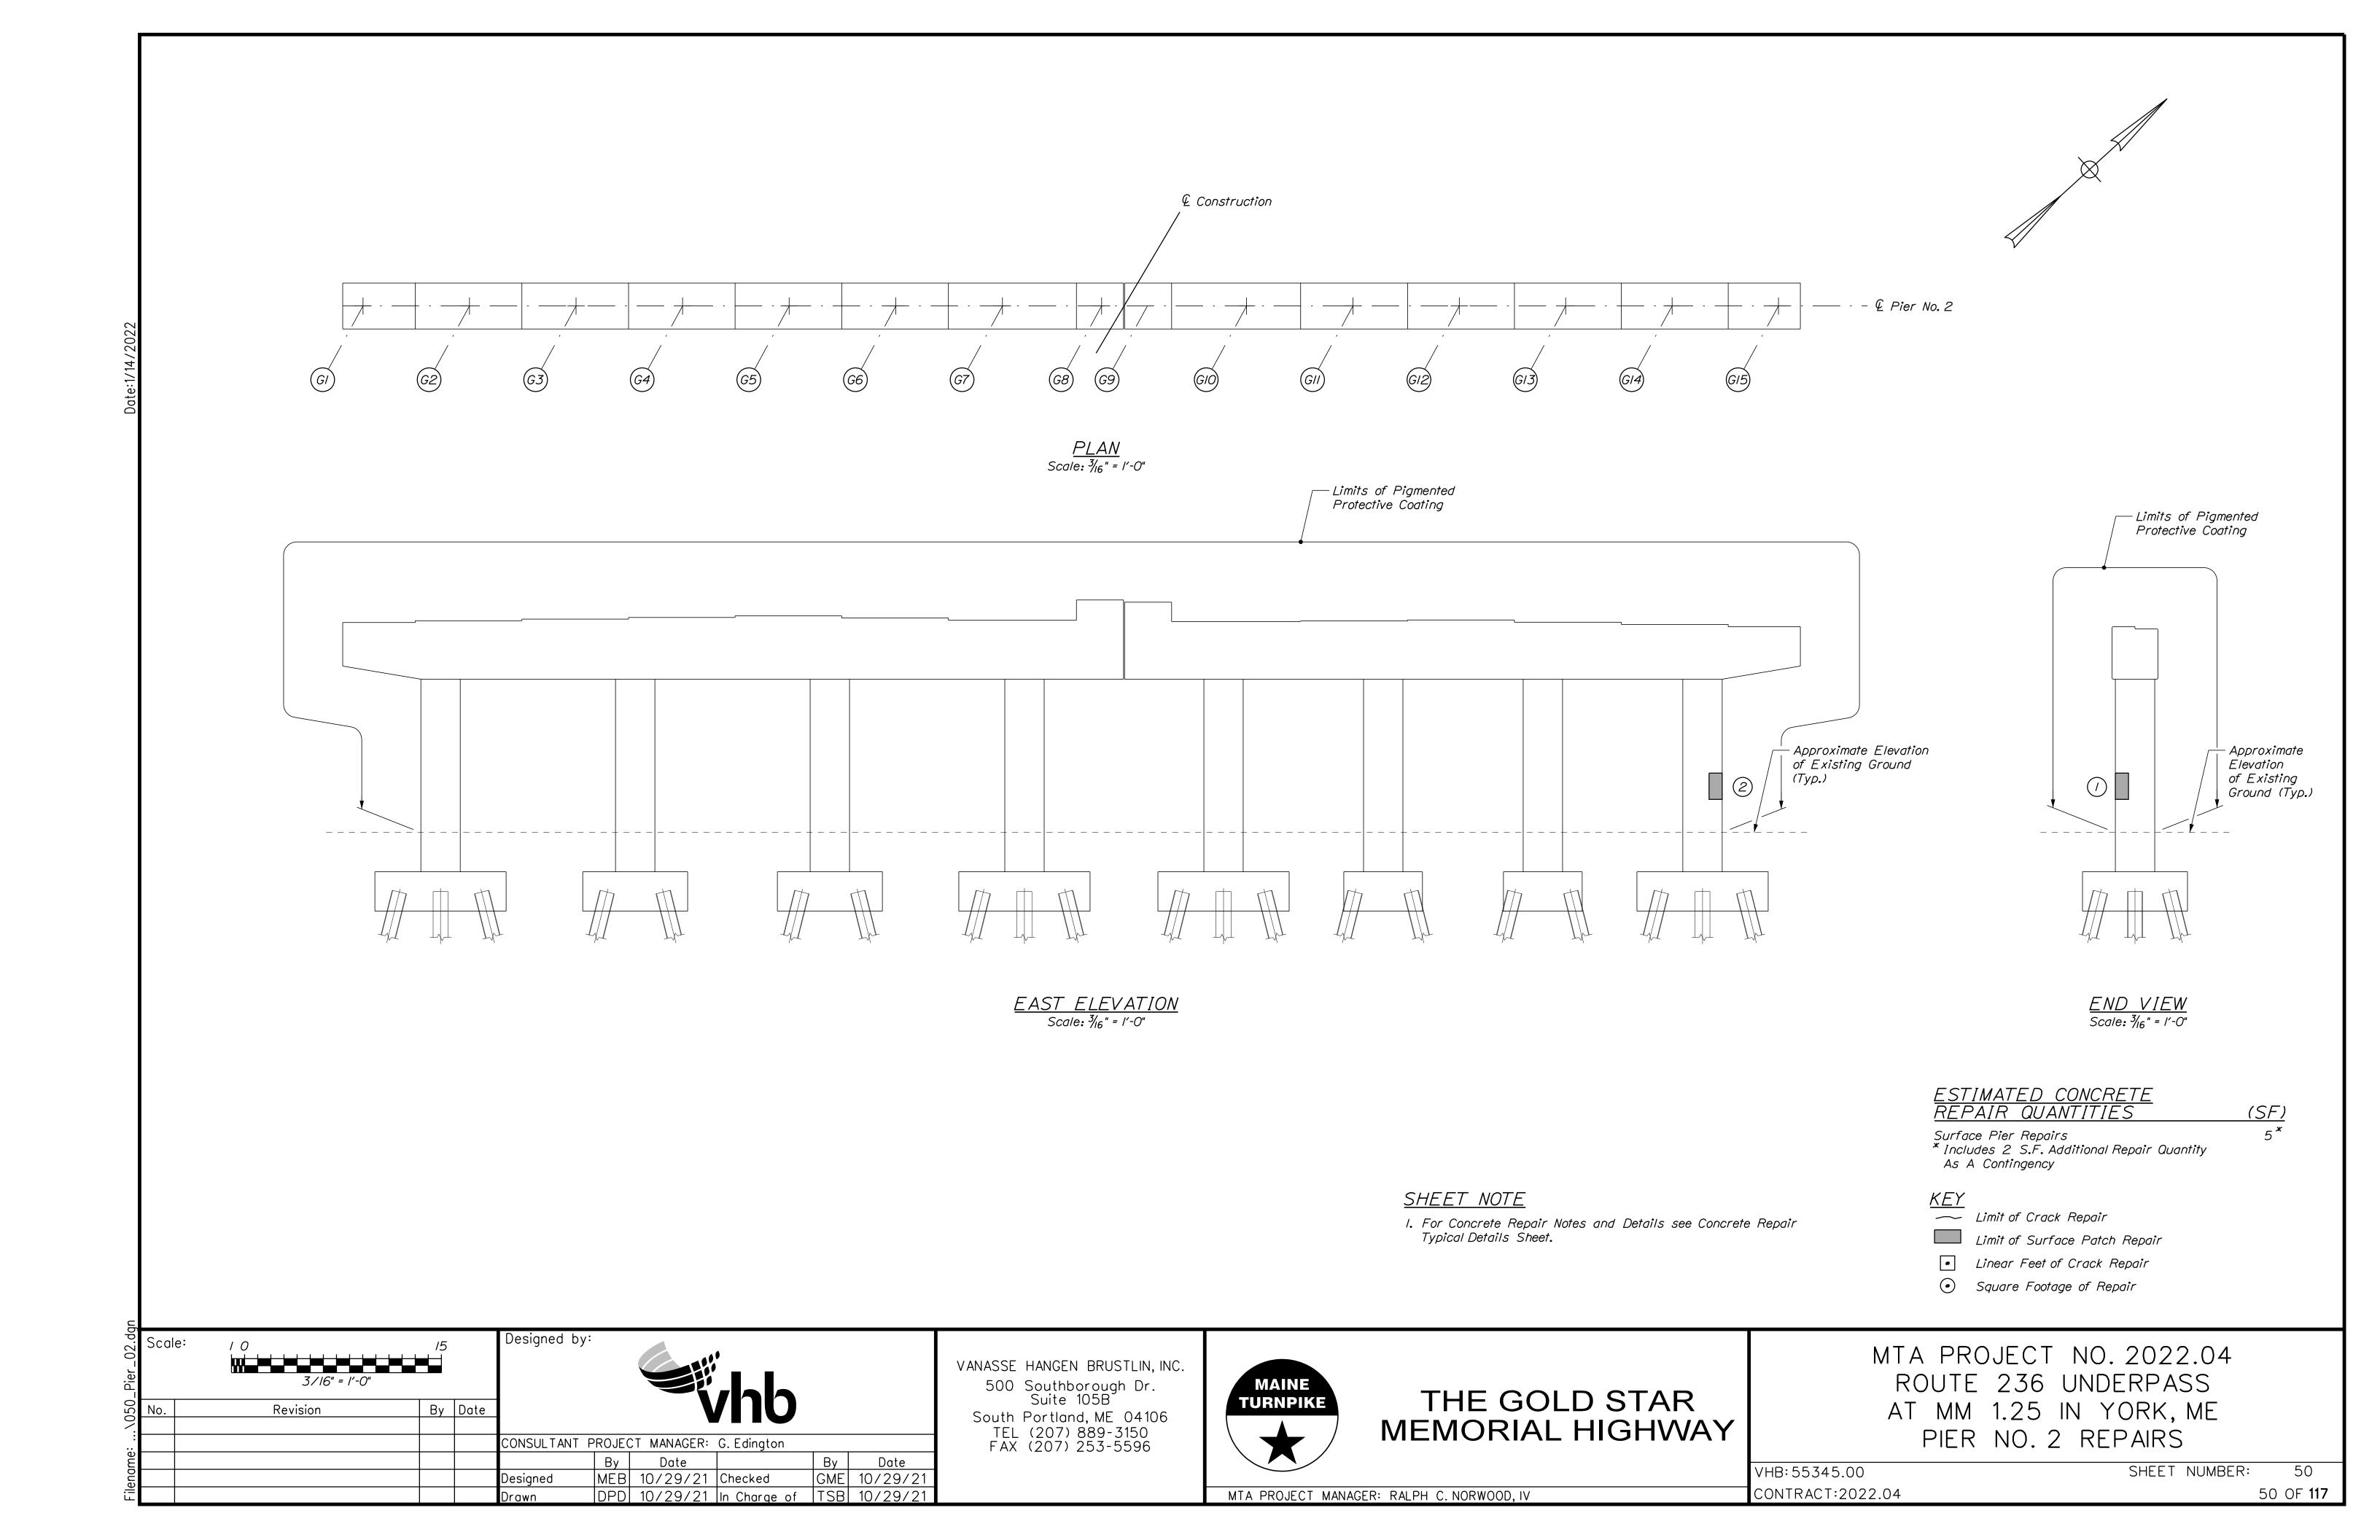


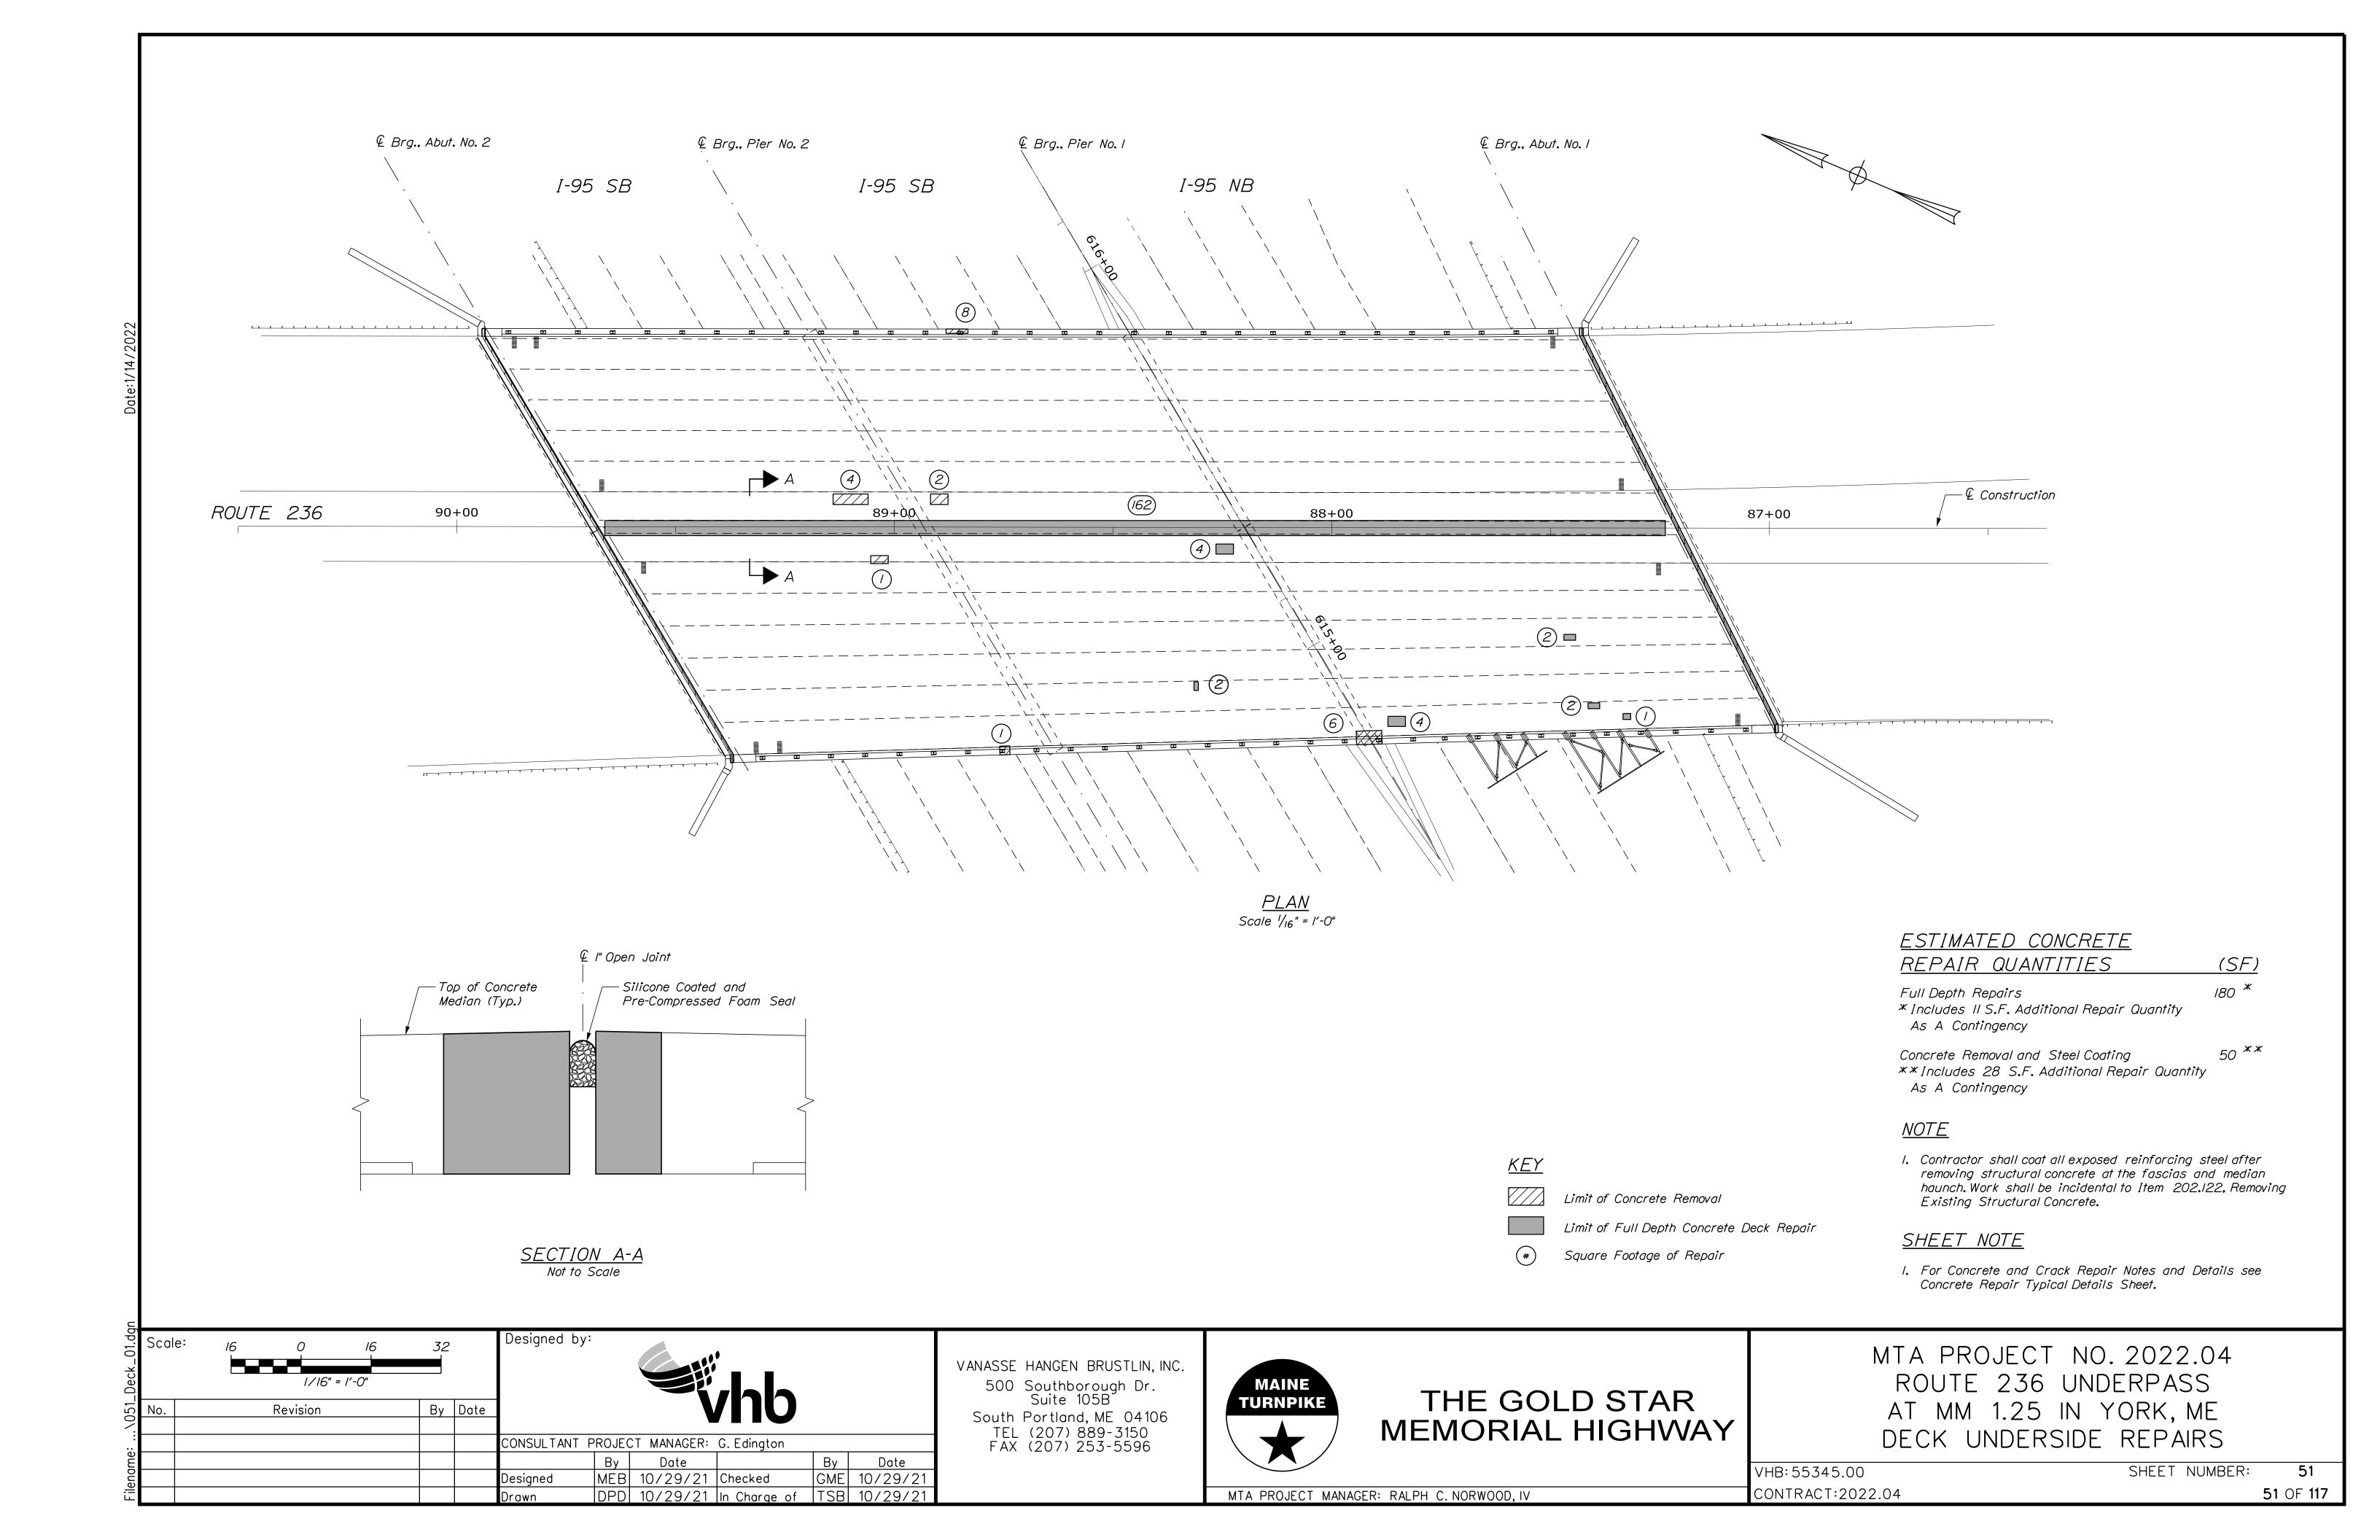

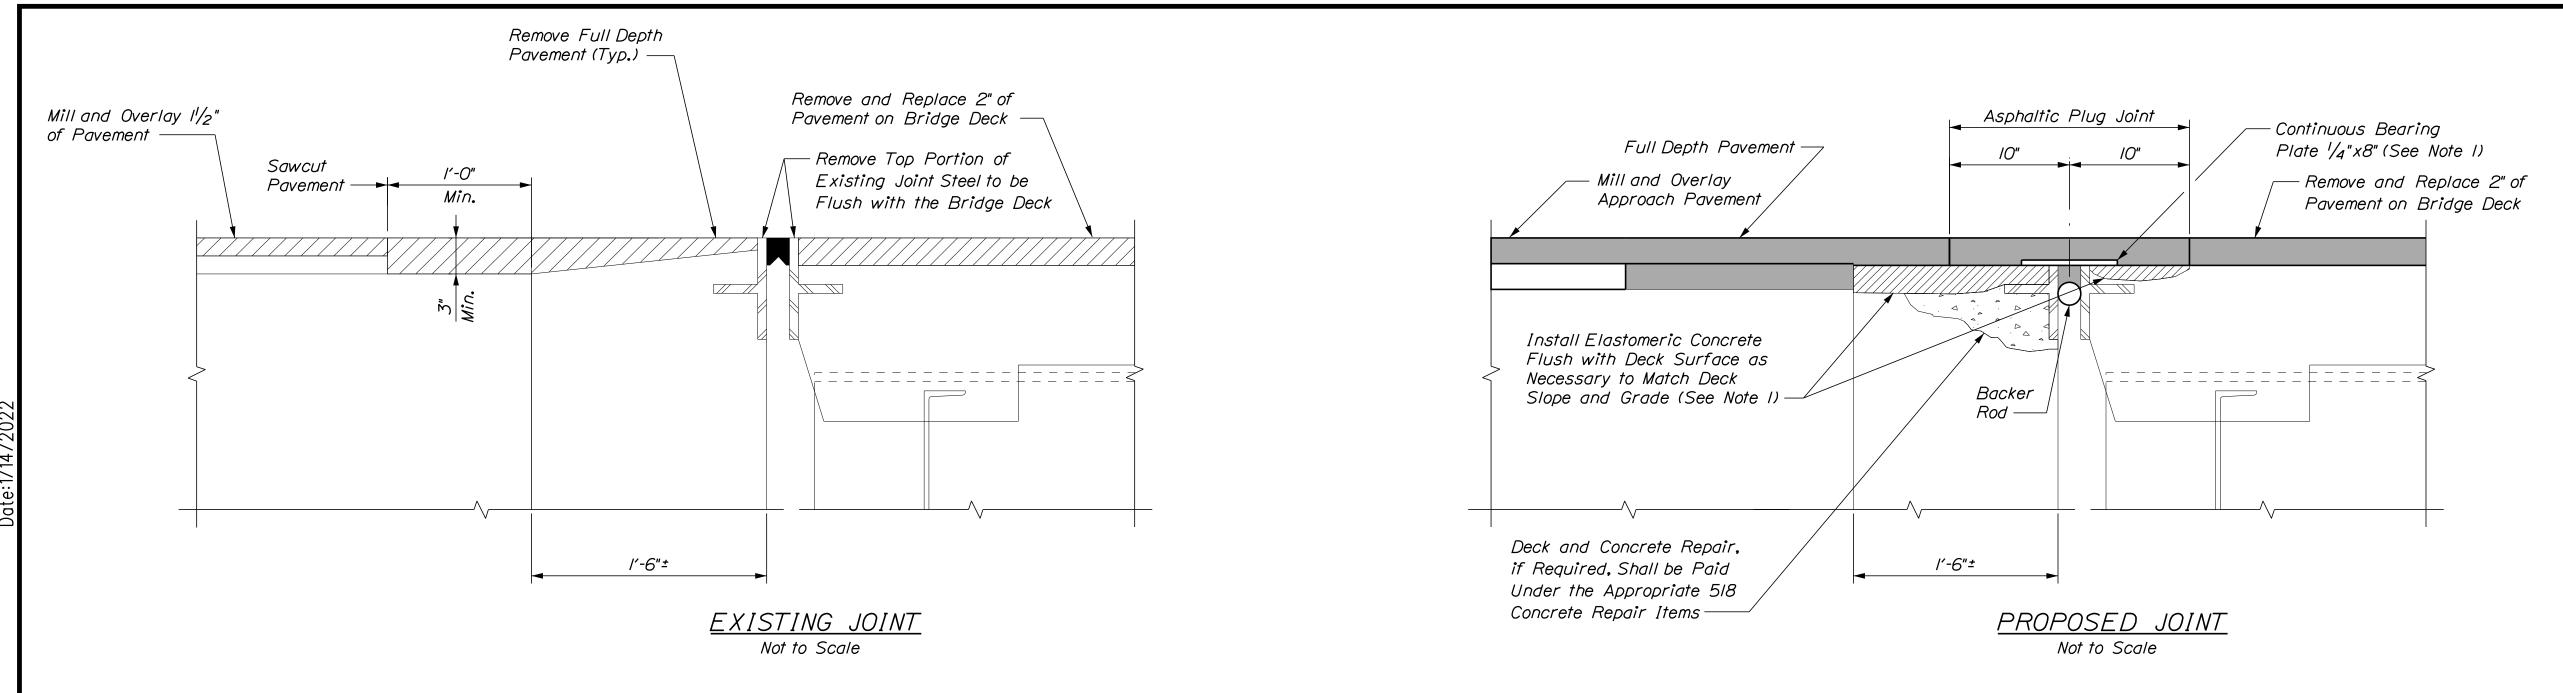

BRIDGE JOINT MODIFICATION (Abutment No. I)


			AS-BUIL	T JOINT	INSTAL	LATION	TABLE F	FOR ABL	JTMENT	NO. 2		
DIM.	Temp O°	O°	10°	20°	<i>30</i> °	40°	50°	60°	70°	80°	90°	100°
"A"	Opening	2 ¹⁵ /16"	23/4"	2%6"	23/8"	23/16"	2"	/ ¹³ / ₁₆ "	15/8"	17/16"	11/4"	11/16"

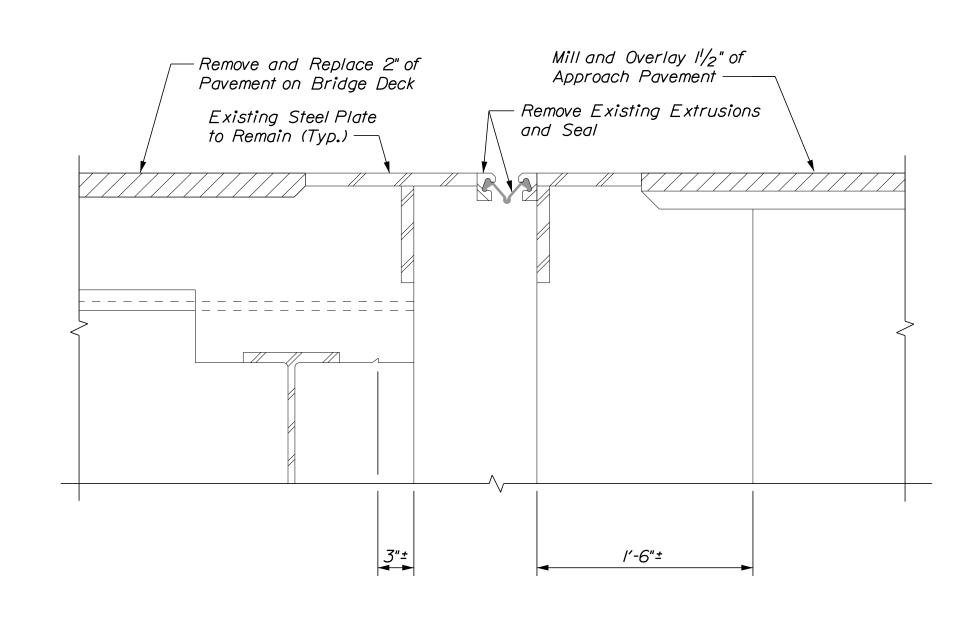

EXISTING JOINT

Not to Scale

BRIDGE JOINT MODIFICATION (Abutment No. 2)

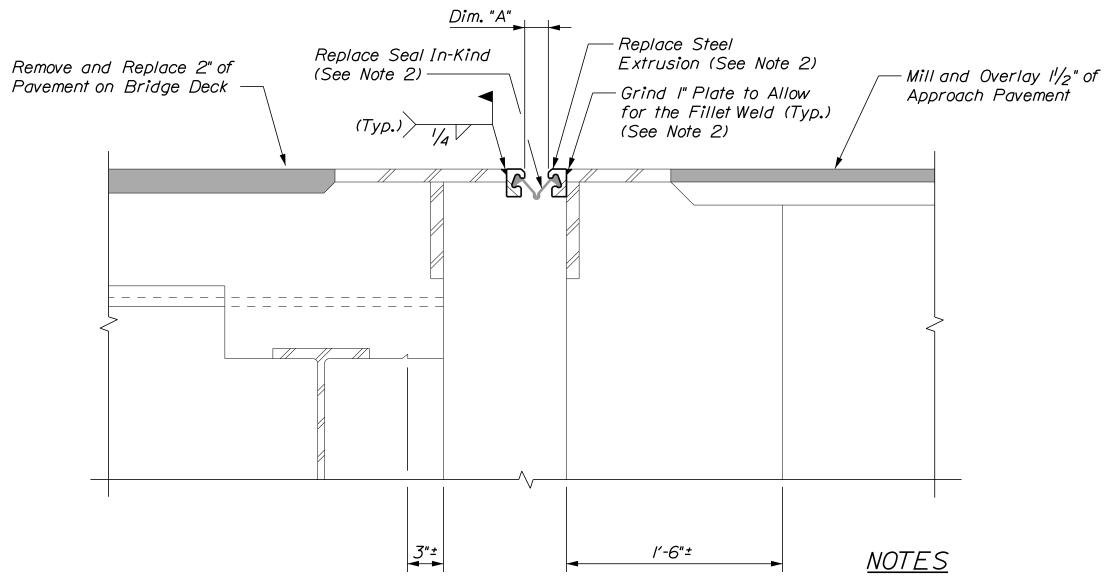

PROPOSED JOINT Not to Scale

I. Elastomeric Concrete and Continuous Bearing Plate shall be incidental to Item 520.23, Asphaltic Plug Joint (Route 236).


2. Replace Steel Extrusions and Joint Seal with a similar system from the MaineDOT Qualified Products List - Bridge Strip Seal Joint Systems. This work shall be paid for under Item 520.50, Remove and Replace Glad Seal (RT 236).

SHEET NOTE

I. See Miscellaneous Details sheet for Joint Detail at Curb for the Asphaltic Plug Joint treatment at the curb.

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				Drawn	DPD	10/29/21	In Charge of	TSB	10/29/2

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THE GOLD STAR MEMORIAL HIGHWAY

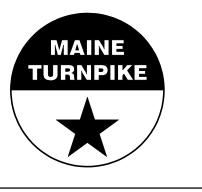
MTA PROJECT NO. 2022.04 ROUTE 236 UNDERPASS AT MM 1.25 IN YORK, ME BRIDGE JOINT MODIFICATIONS


VHB: 55345.00

SHEET NUMBER: 52

MTA PROJECT MANAGER: RALPH C. NORWOOD, IV

CONTRACT:2022.04 **52** OF **117**

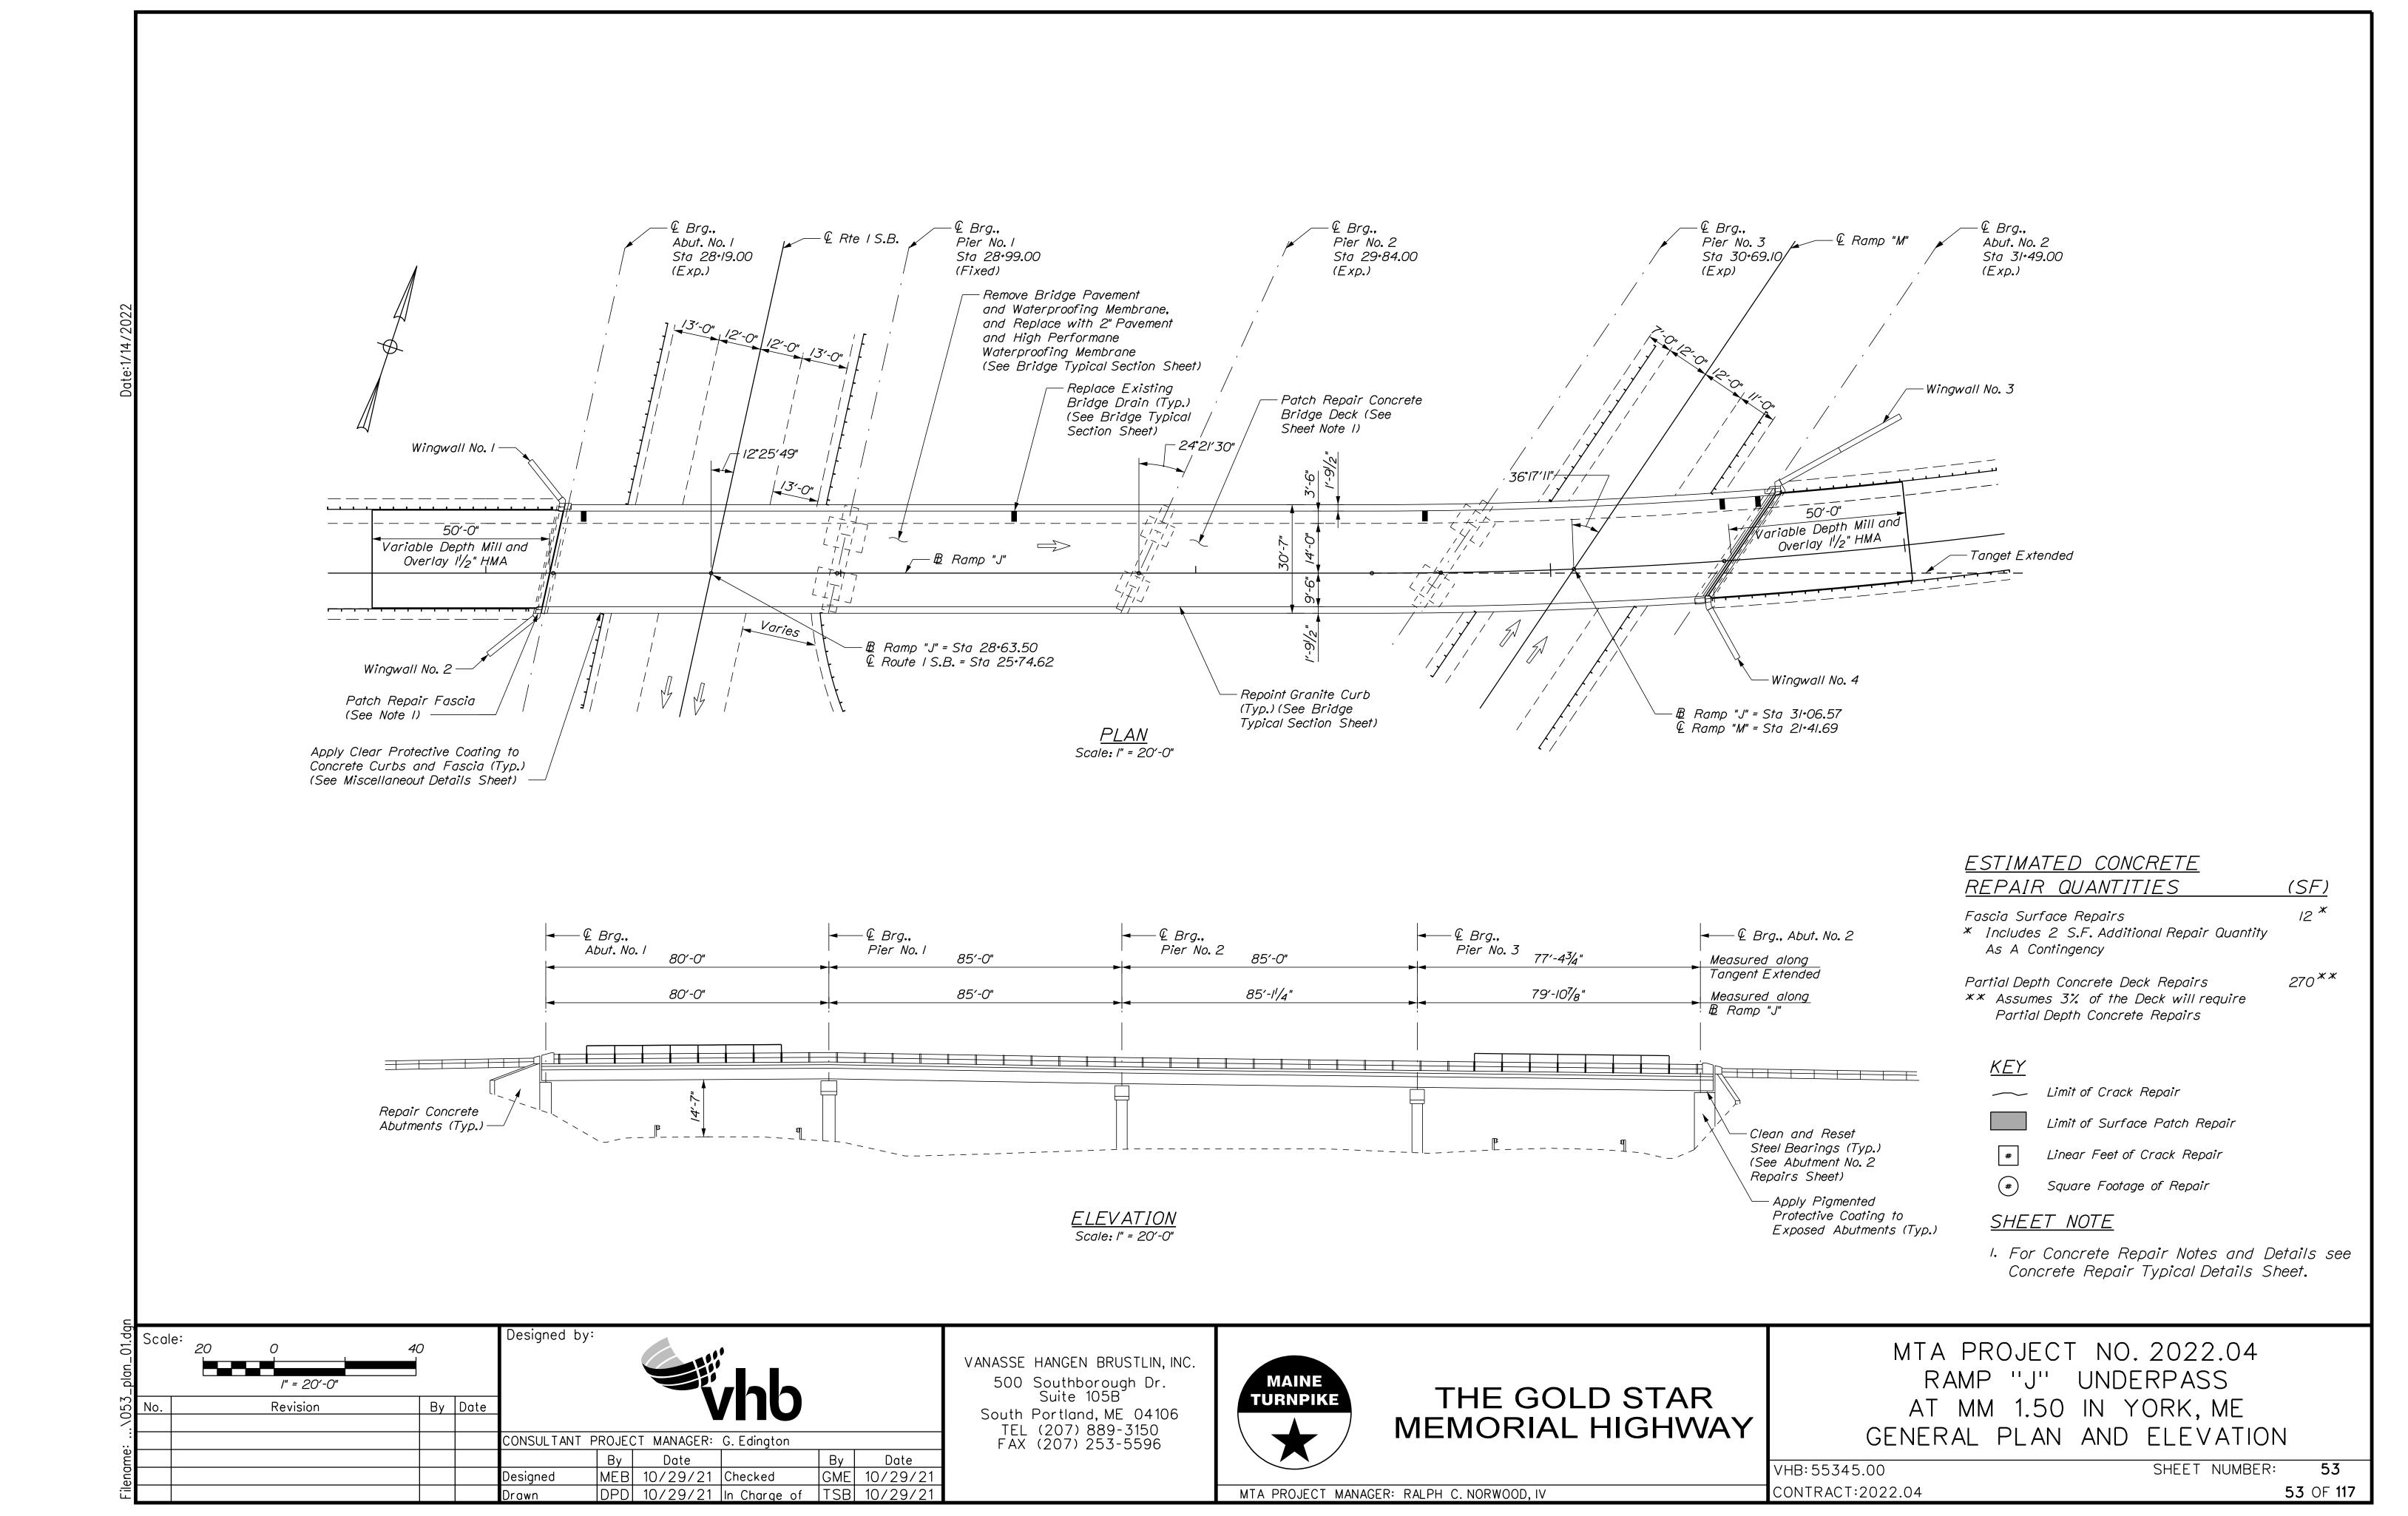

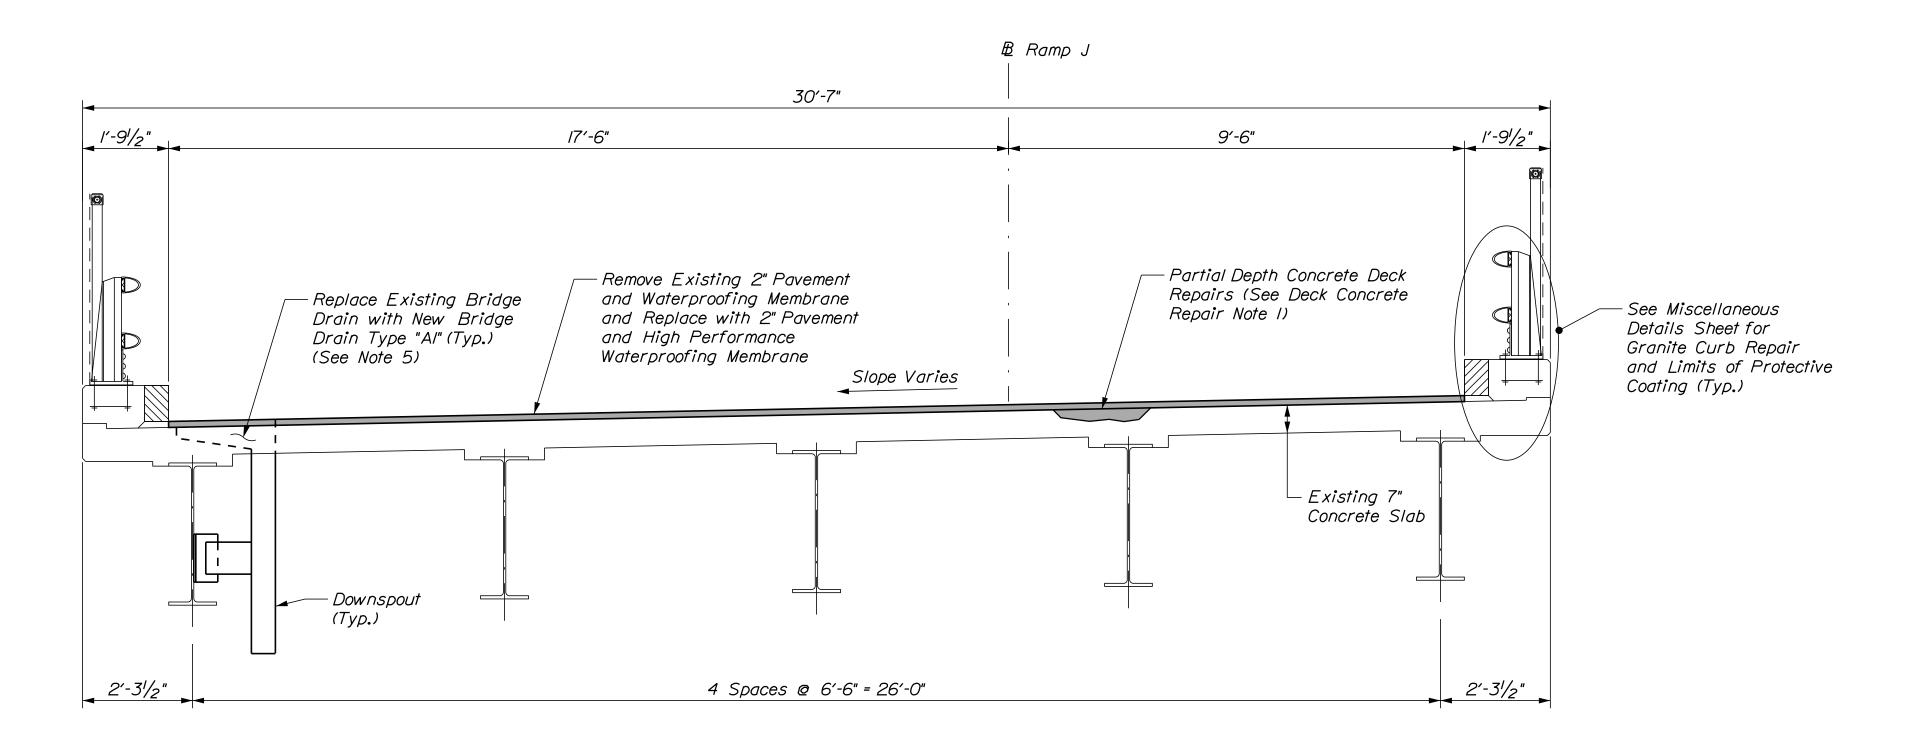

SUPERSTRUCTURE TYPICAL SECTION

DECK CONCRETE REPAIR NOTES

- I. Prior to the start of deck concrete repairs, the Resident and the Contractor shall sound all deck concrete using a chain drag or other method approved by the Resident to determine the required repair limits. All costs for sounding the existing deck concrete shall be incidental to Item 518.80 Partial Depth Concrete Deck Repairs.
- 2. Sawcut I" deep along all limits of removal.
- 3. Chip concrete to the depth specified in Supplemental Specification 518. If the removal limits change during the demolition process, the Contractor shall notify the Resident. The Resident and Contractor shall agree on the revised pay limits prior to the Contractor continuing the removals.
- 4. Prepare and patch repair deteriorated areas. Install new reinforcing steel, as required. See Supplemental Specification 518.
- 5. Replacing the bridge drains shall be paid for under Item 502.702, Replace Bridge Drain (Type AI).

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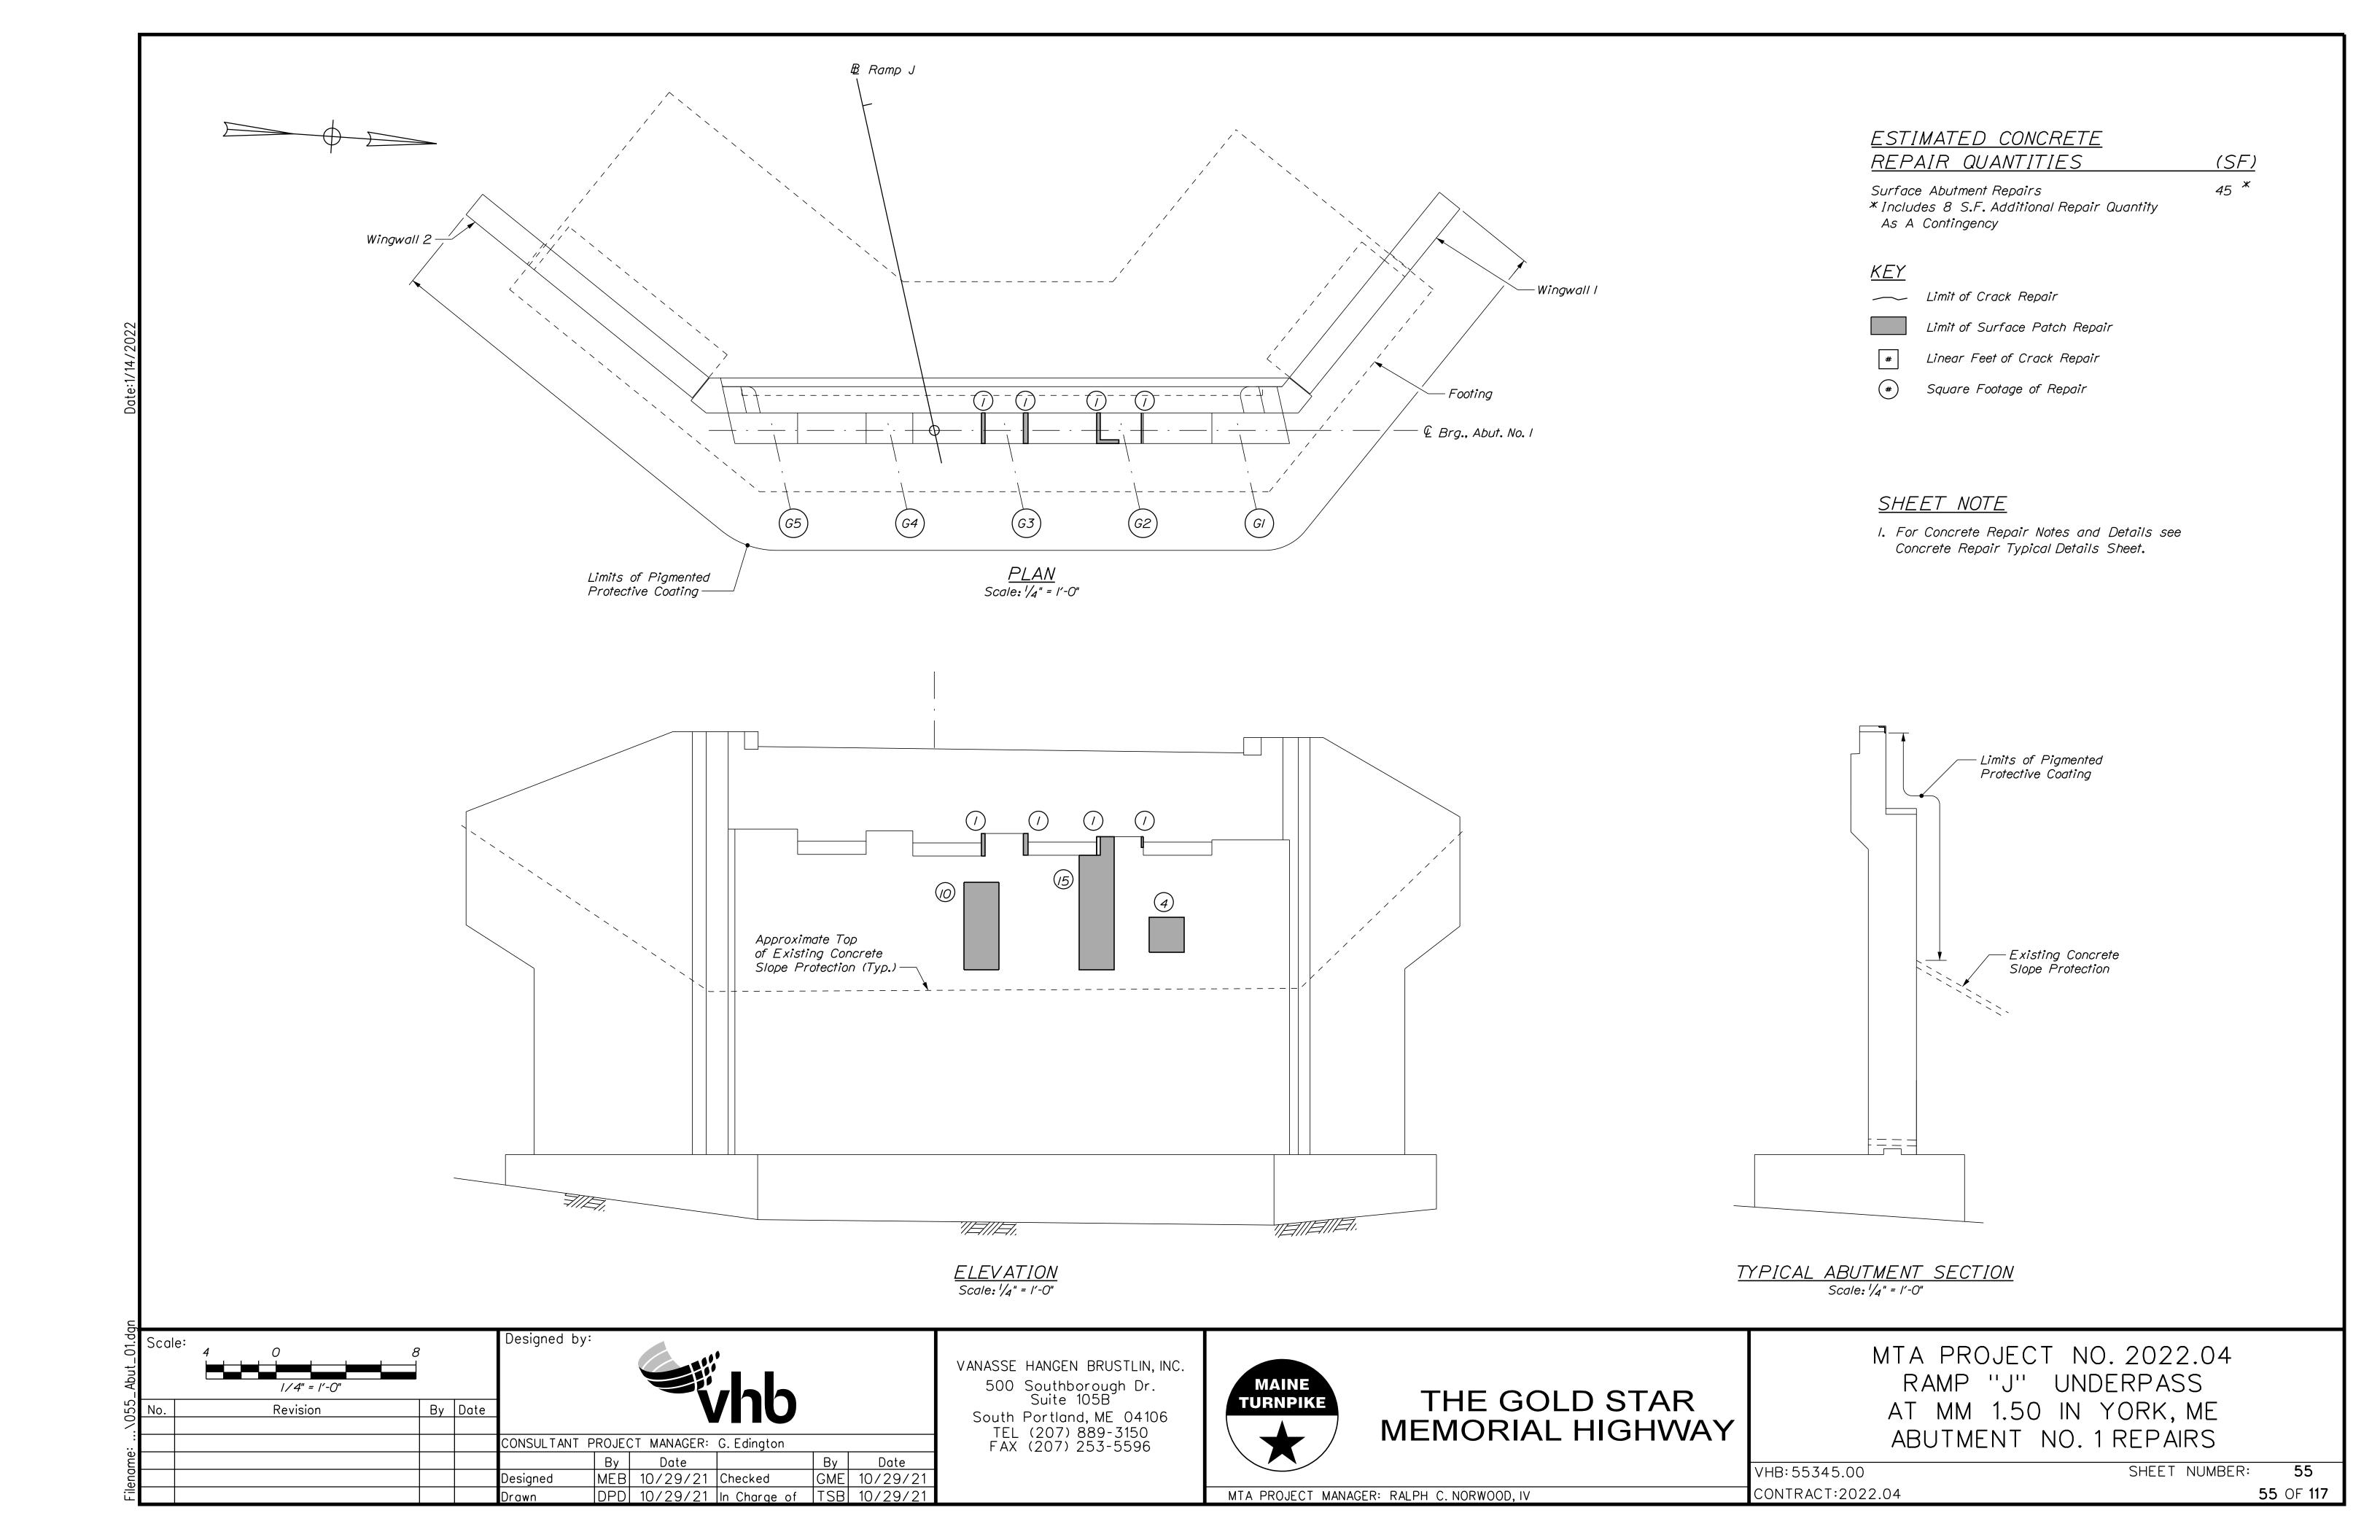
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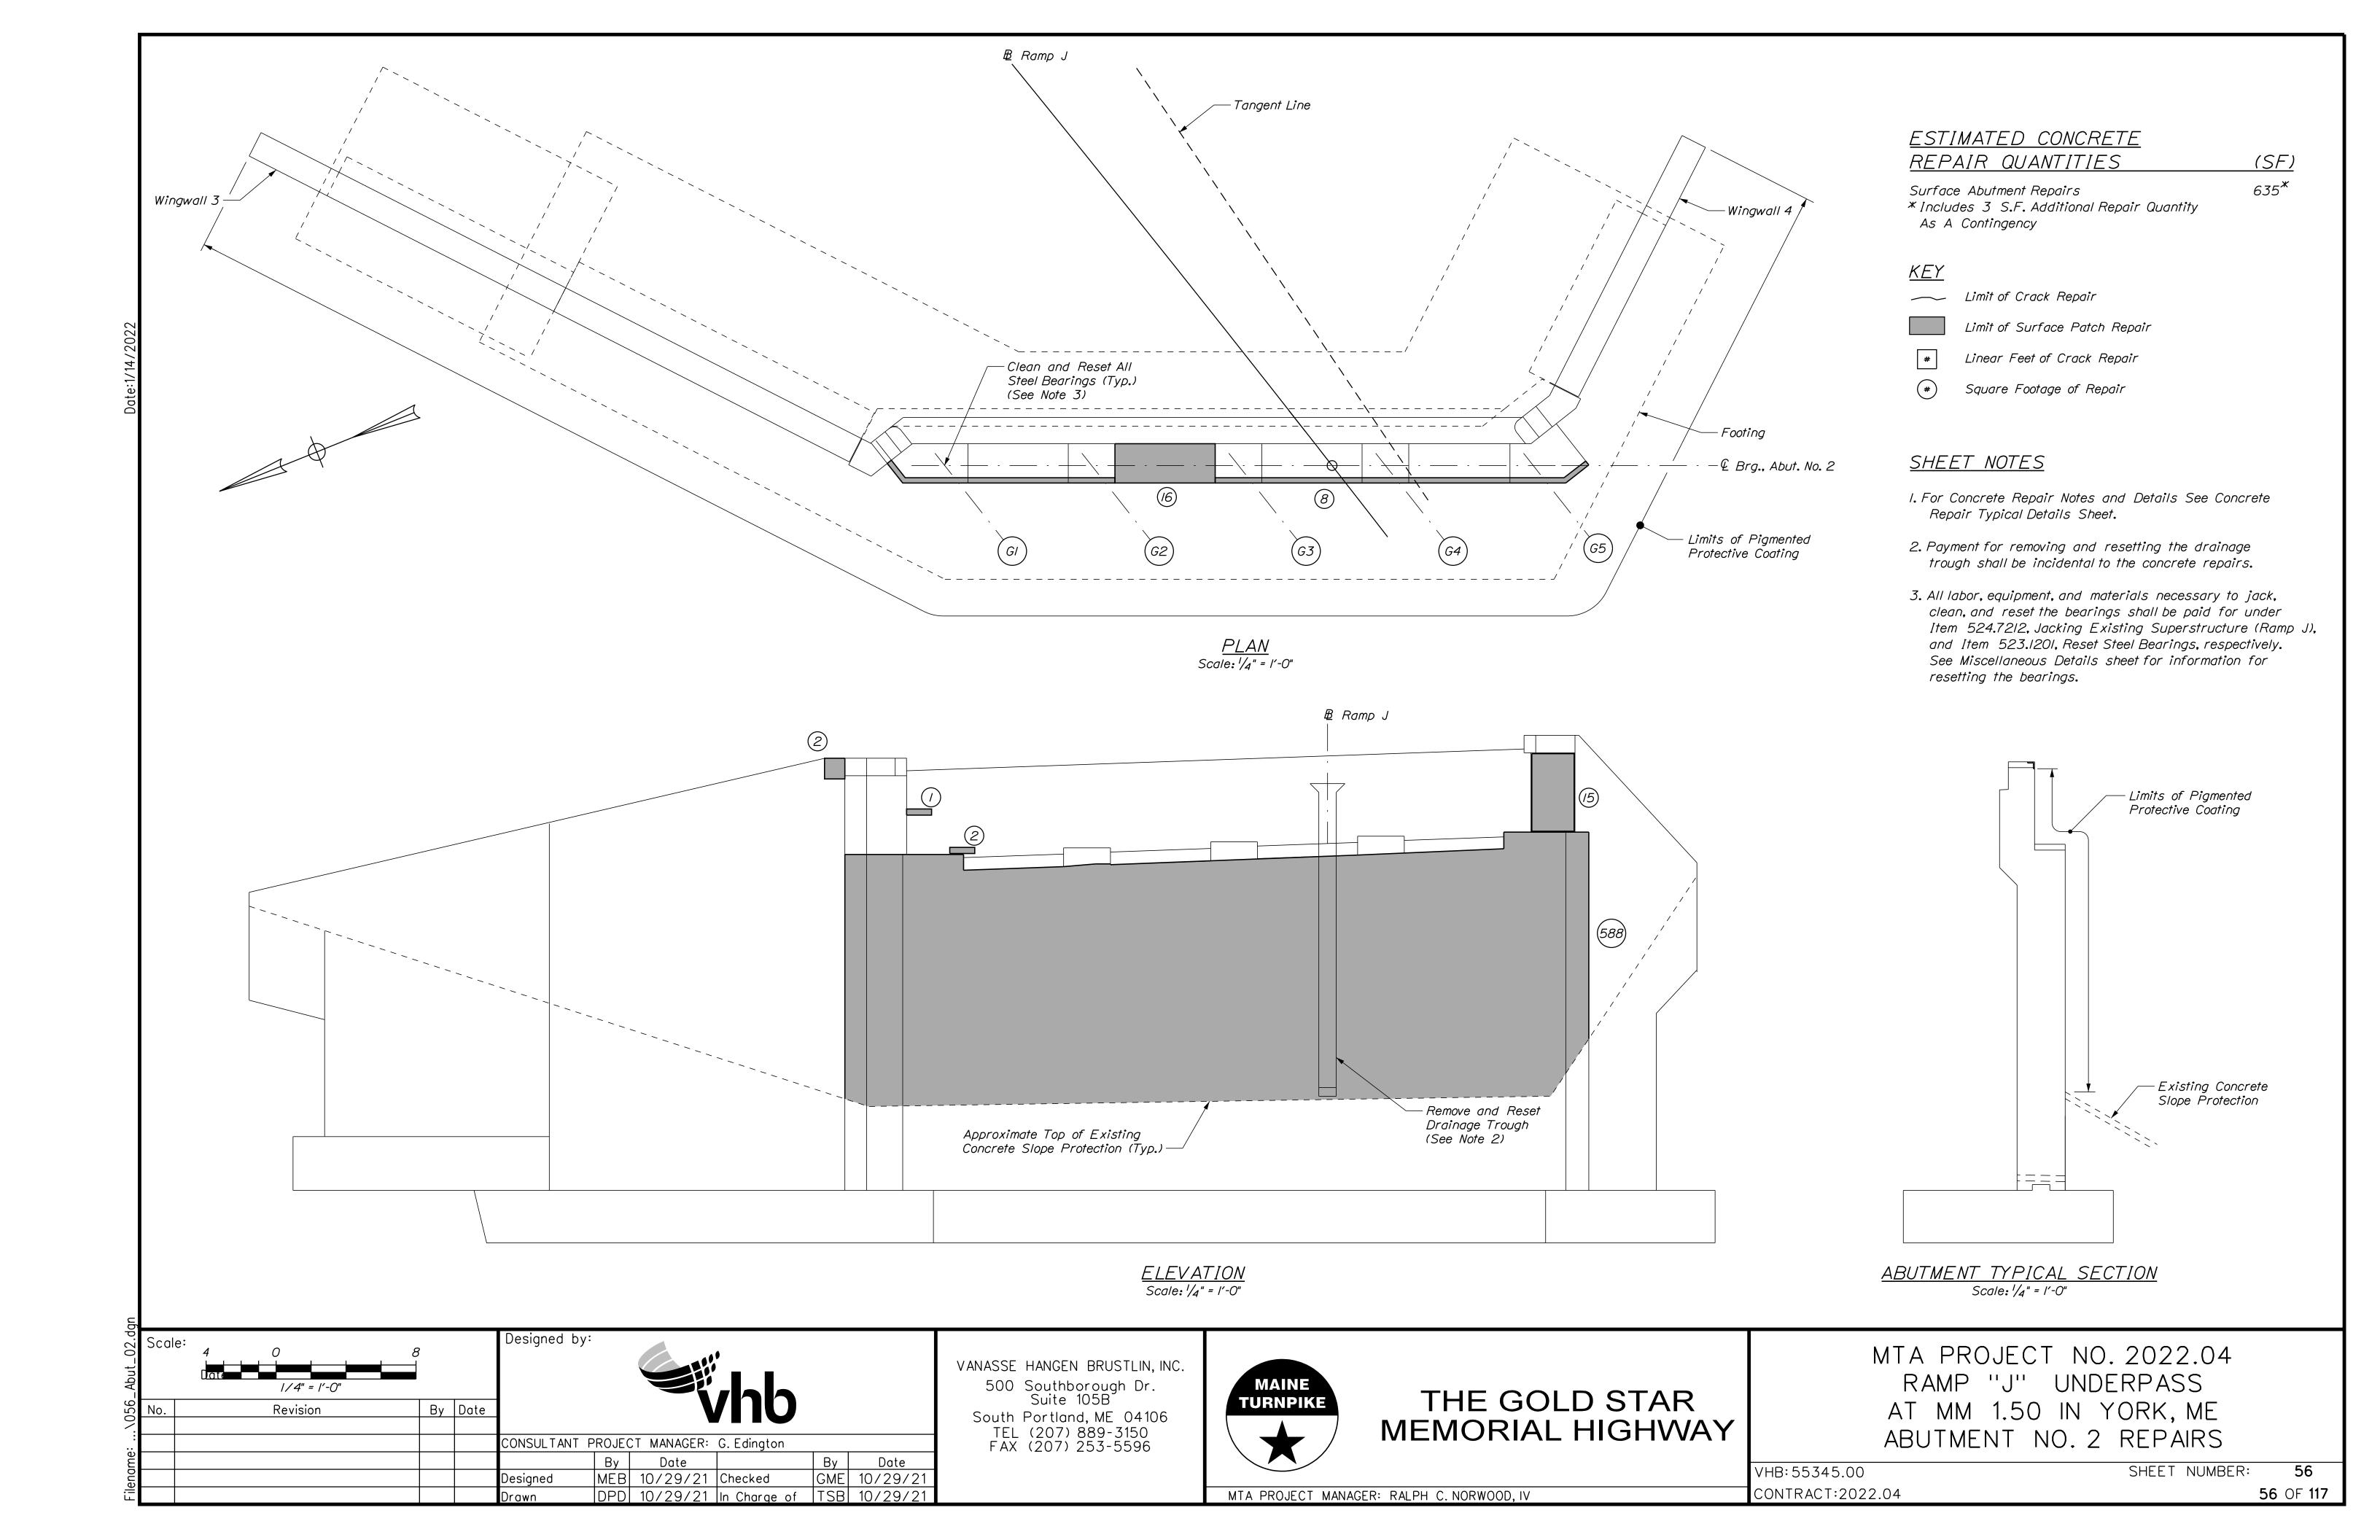



THE GOLD STAR MEMORIAL HIGHWAY MTA PROJECT NO. 2022.04
RAMP "J" UNDERPASS
AT MM 1.50 IN YORK, ME
BRIDGE TYPICAL SECTION


VHB:55345.00 CONTRACT:2022.04

SHEET NUMBER: 54 54 OF **117**





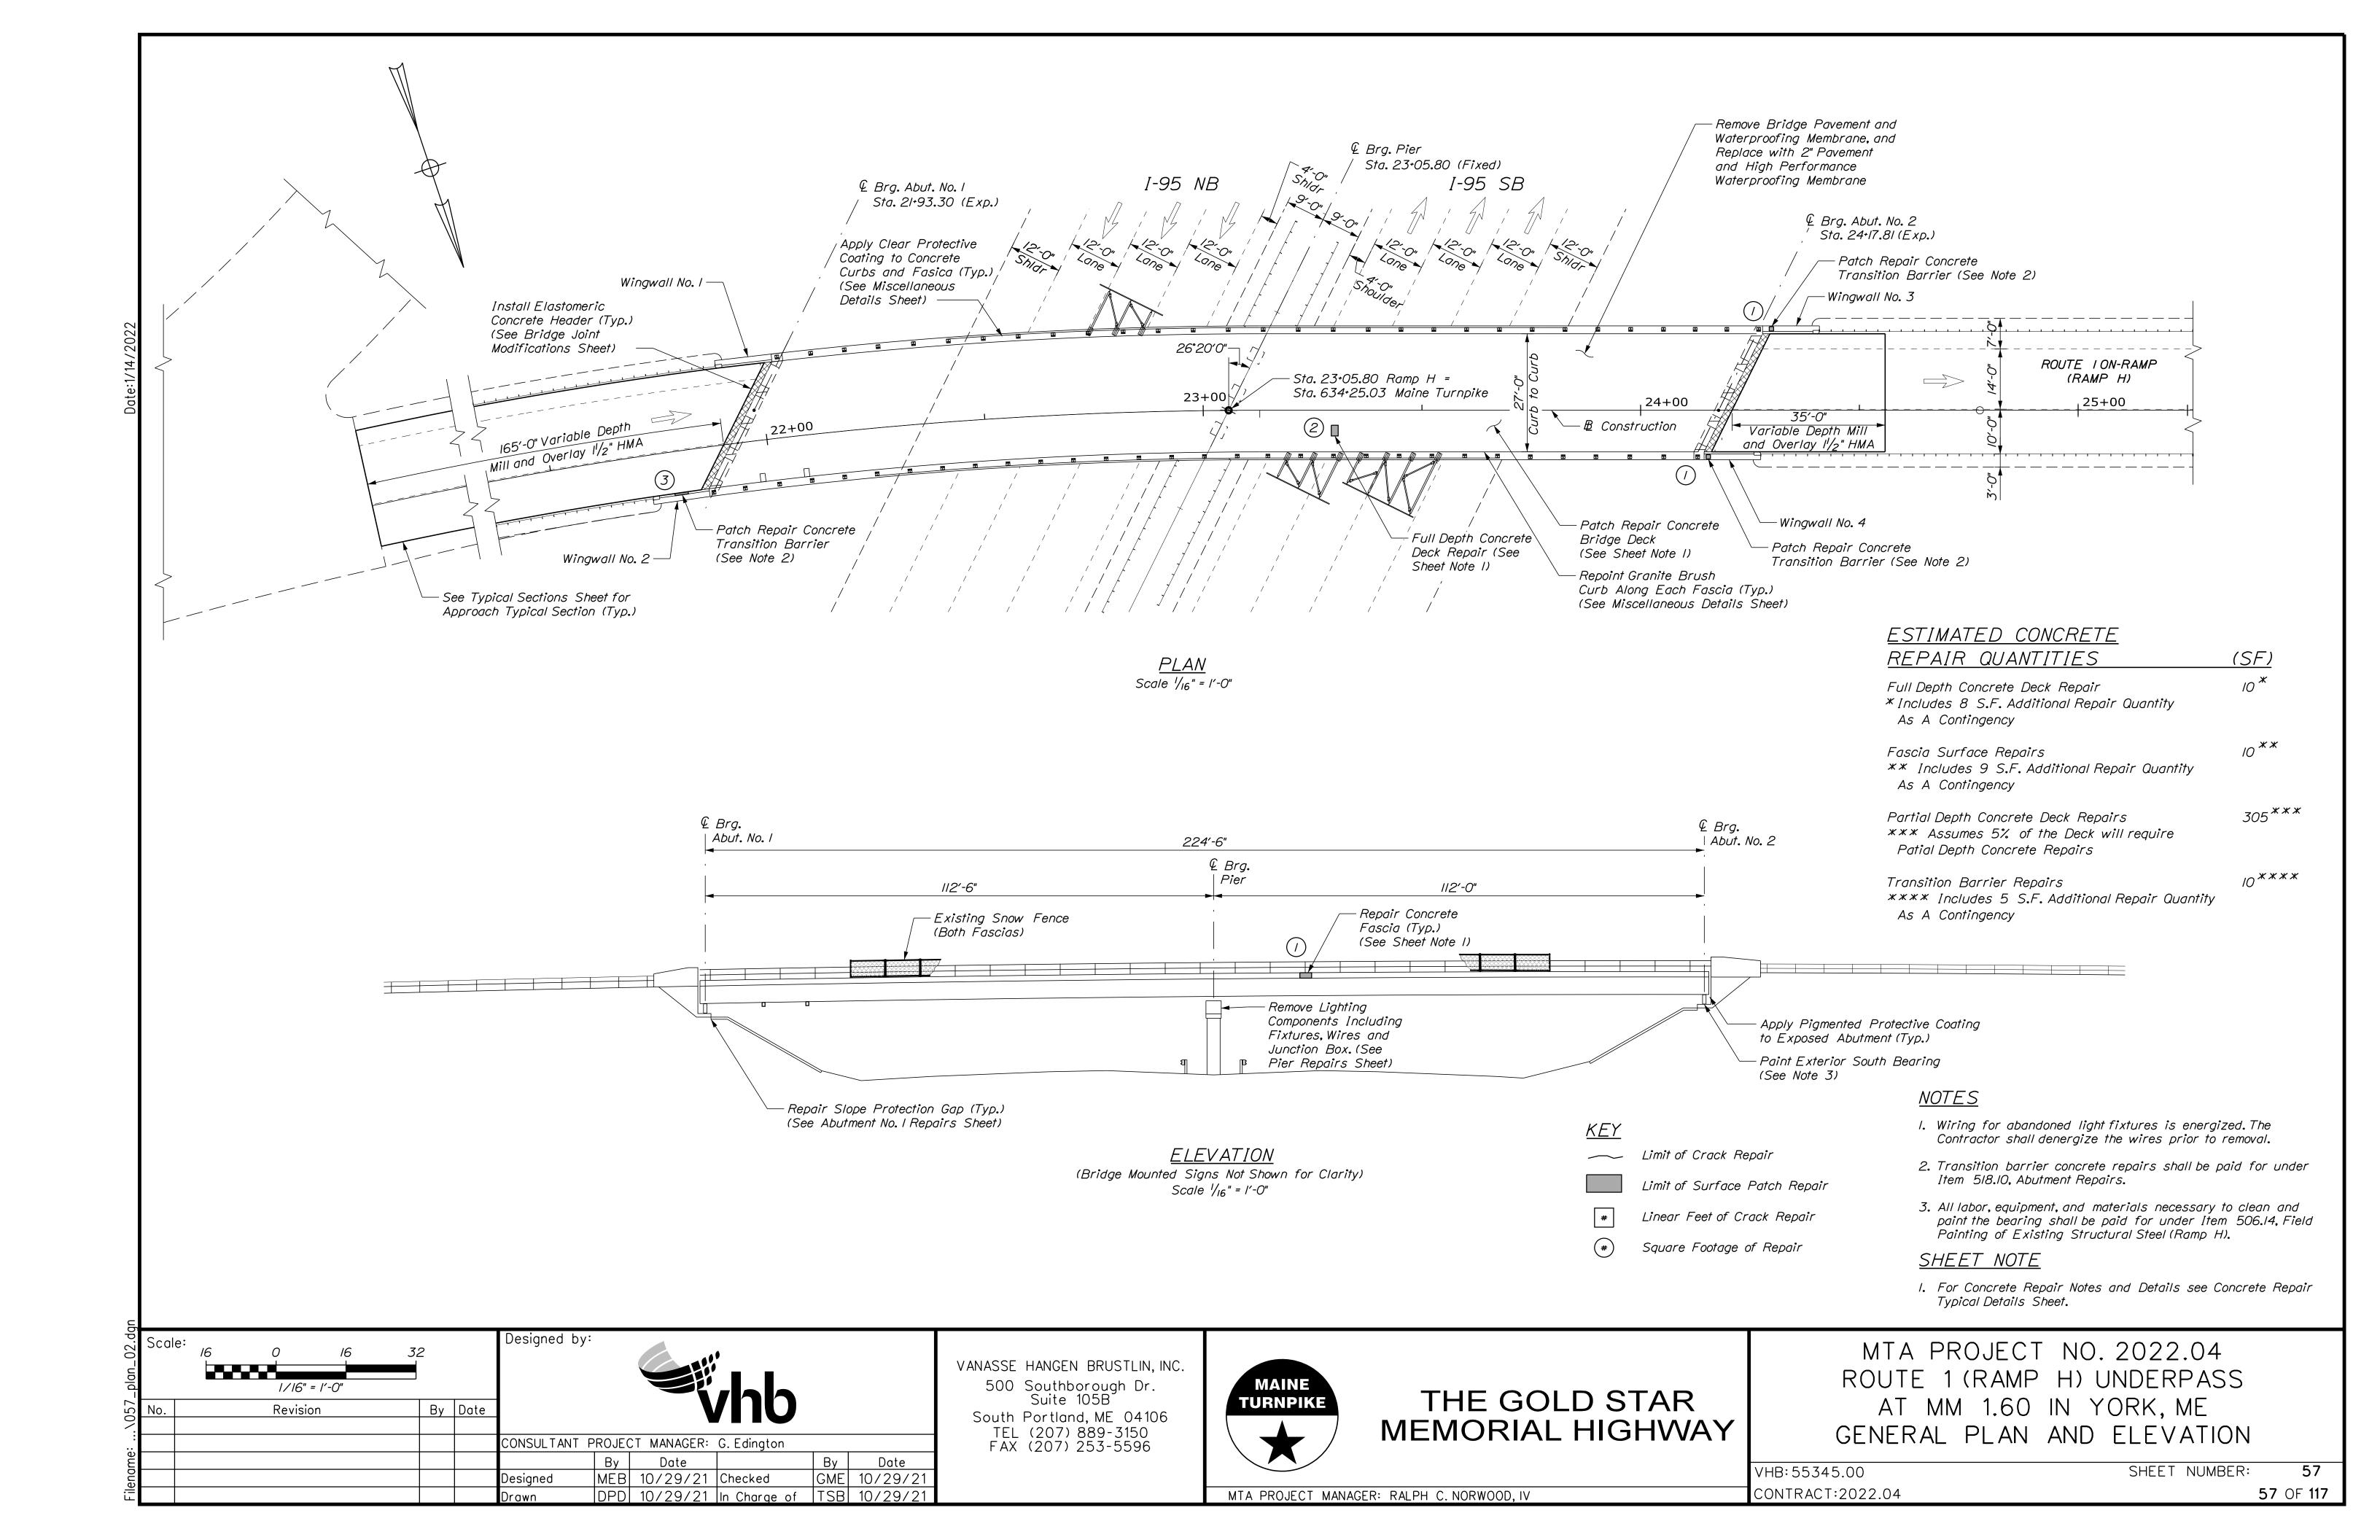

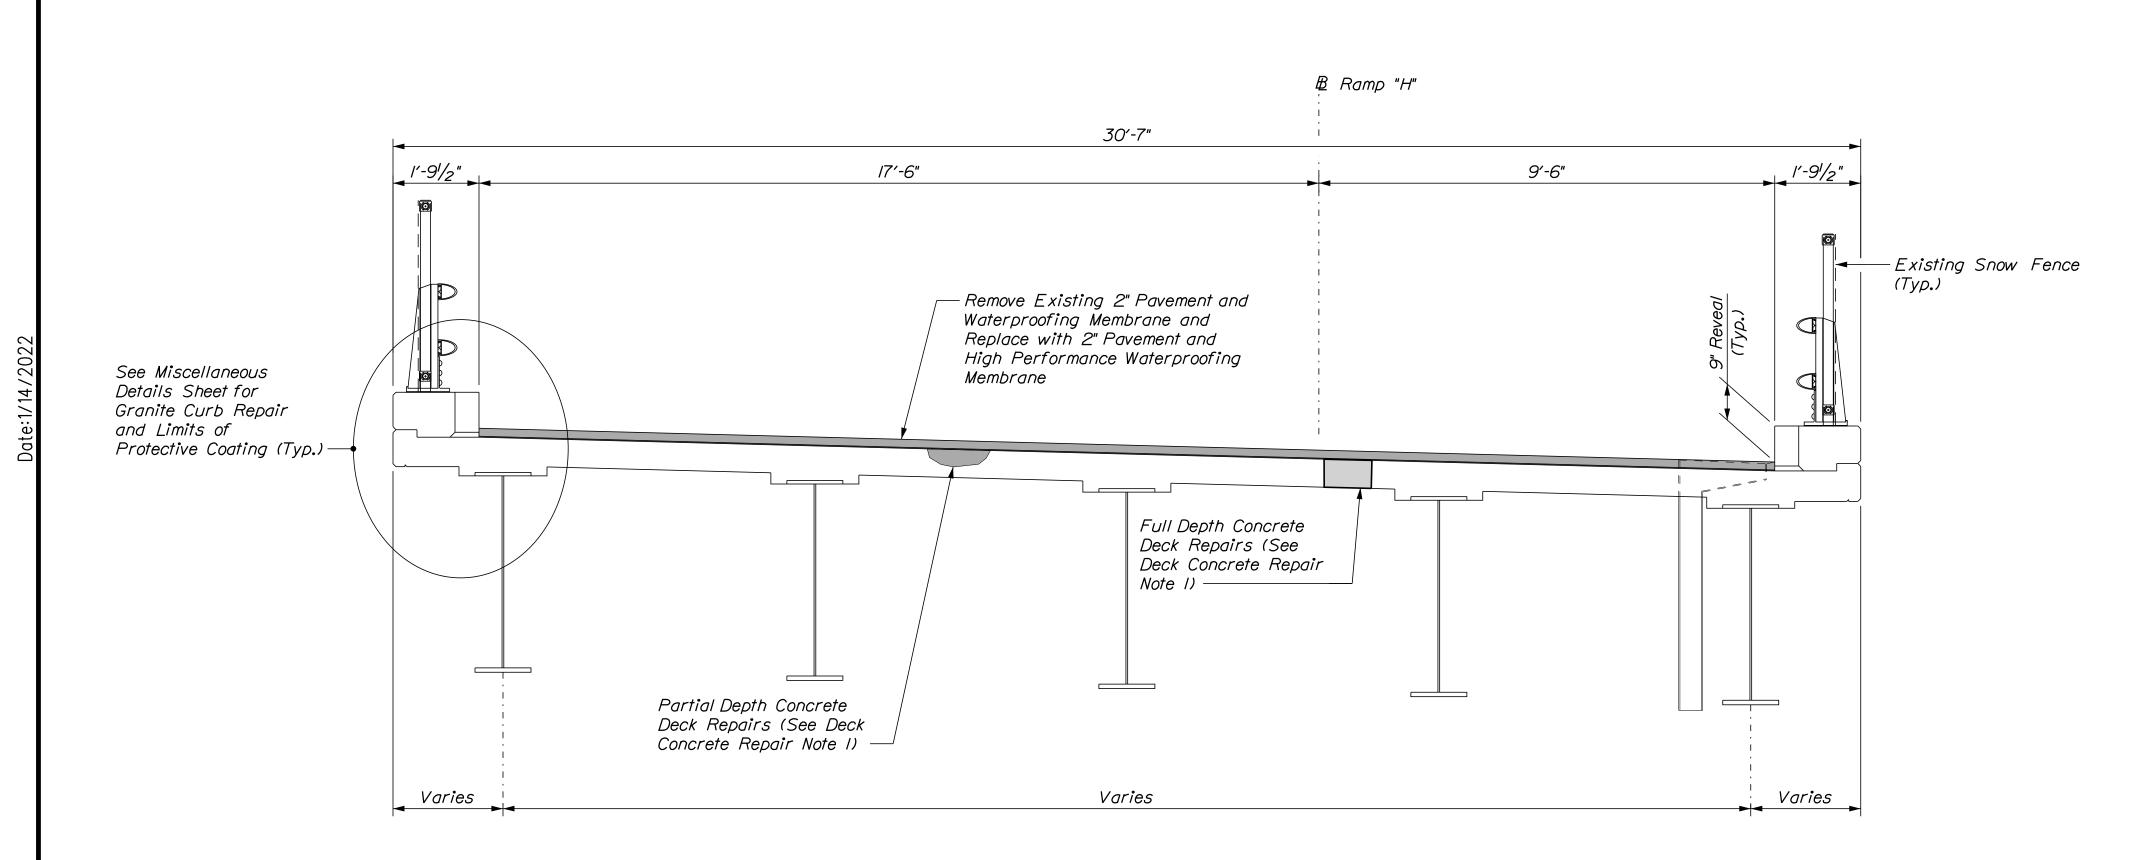

SUPERSTRUCTURE TYPICAL SECTION Scale: 1/2" = 1'-0"

Varies 1.5" Mill And Overlay — Existing Guardrail (Typ.) Match → — Existing Ground MILL AND OVERLAY TYPICAL SECTION


Not to Scale

DECK CONCRETE REPAIR NOTES


- I. Prior to the start of deck concrete repairs, the Resident and the Contractor shall sound all deck concrete using a chain drag or other method approved by the Resident to detemine the required repair limits. All costs for sounding the existing deck concrete shall be incidental to Item 518.80, Partial Depth Concrete Deck Repairs.
- 2. Sawcut I" deep along all limits of removal.
- 3. Chip concrete to the depth specified in Supplemental Specification 518. If the removal limits change during the demolition process, the Contractor shall notify the Resident. The Resident and Contractor shall agree on the revised pay limits prior to the Contractor continuing the removals.
- 4. Prepare and patch repair deteriorated areas. Install new reinforcing steel, as required. See Supplemental Specification 518.

SHEET NOTE

I. For Concrete Repair Notes and Details see Concrete Repair Typical Sections

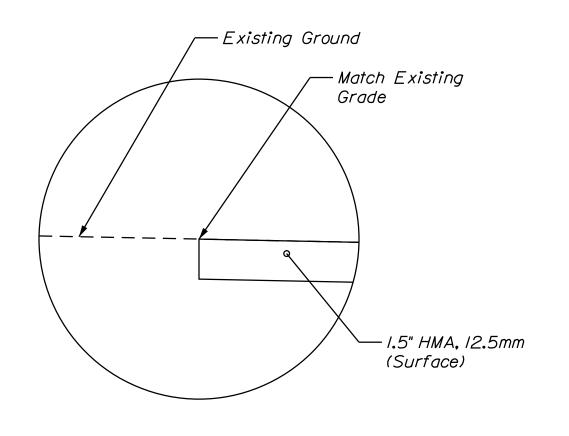

<u>DETAIL A</u> Not to Scale

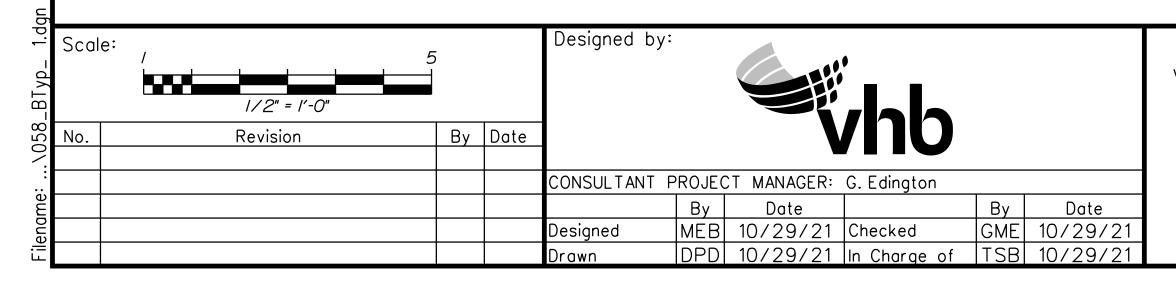

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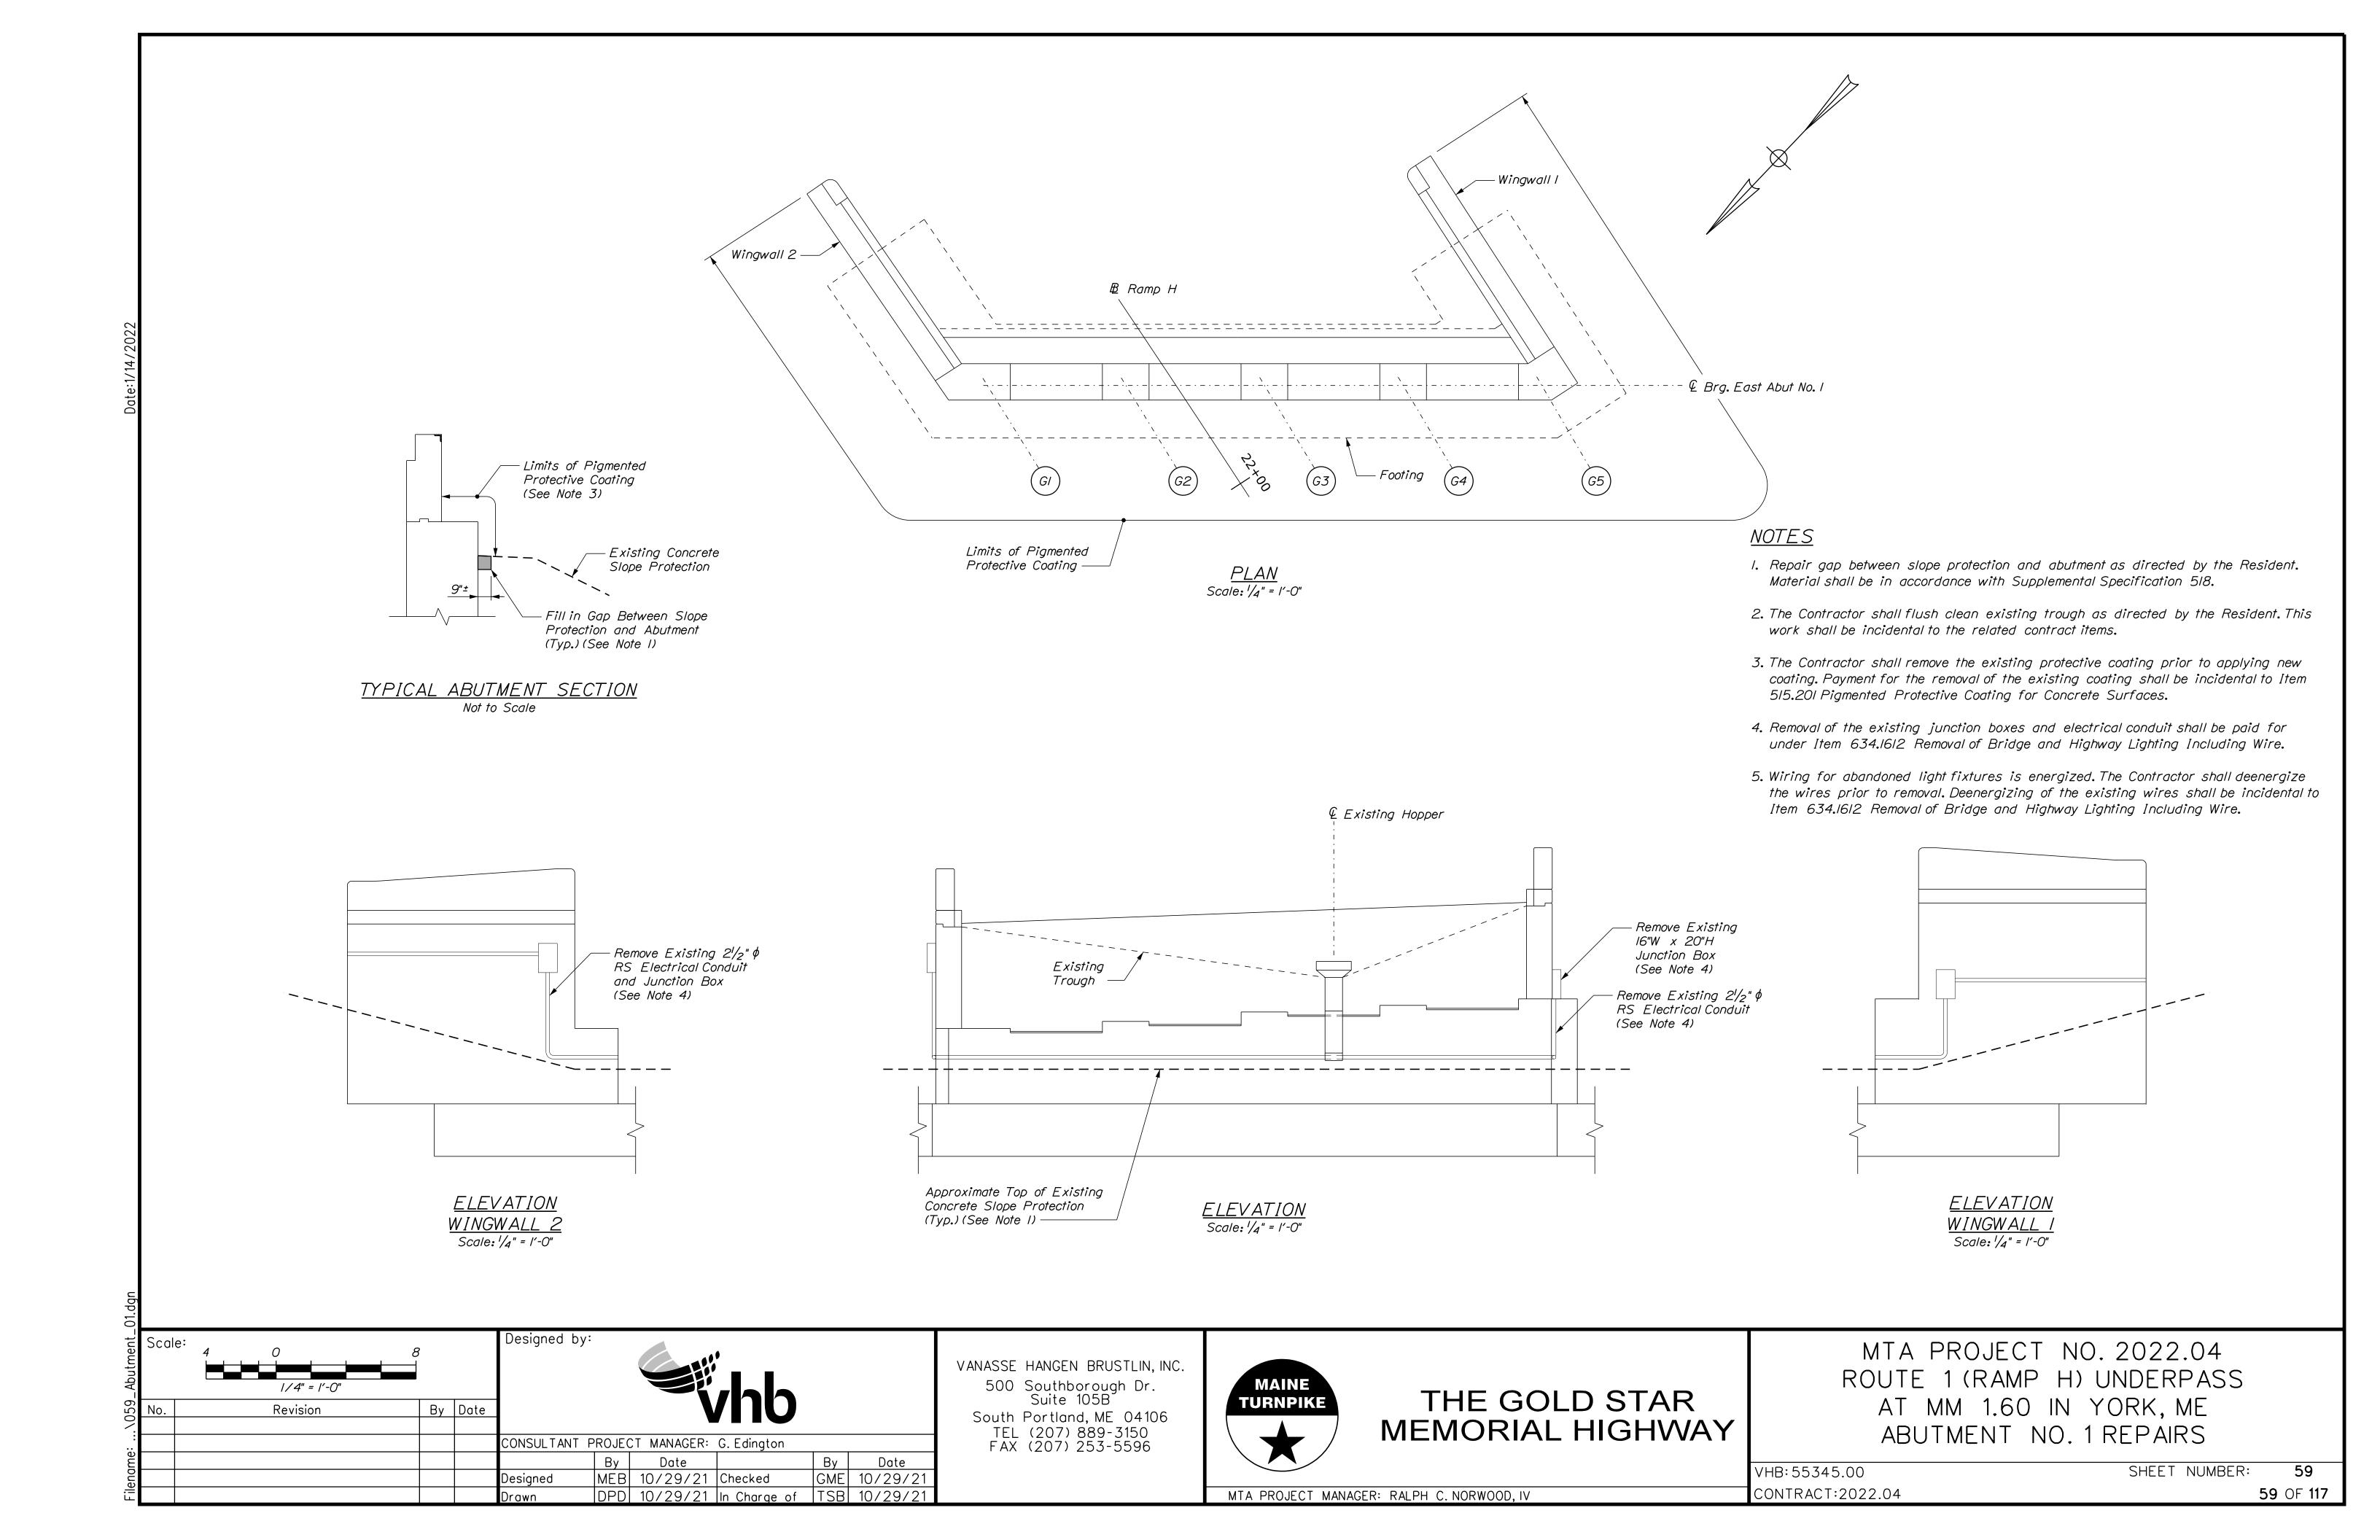
THE GOLD STAR MEMORIAL HIGHWAY


MTA PROJECT NO. 2022.04 ROUTE 1 (RAMP H) UNDERPASS AT MM 1.60 IN YORK, ME TYPICAL SECTIONS

VHB: 55345.00 CONTRACT:2022.04

SHEET NUMBER: 58

MTA PROJECT MANAGER: RALPH C. NORWOOD, IV



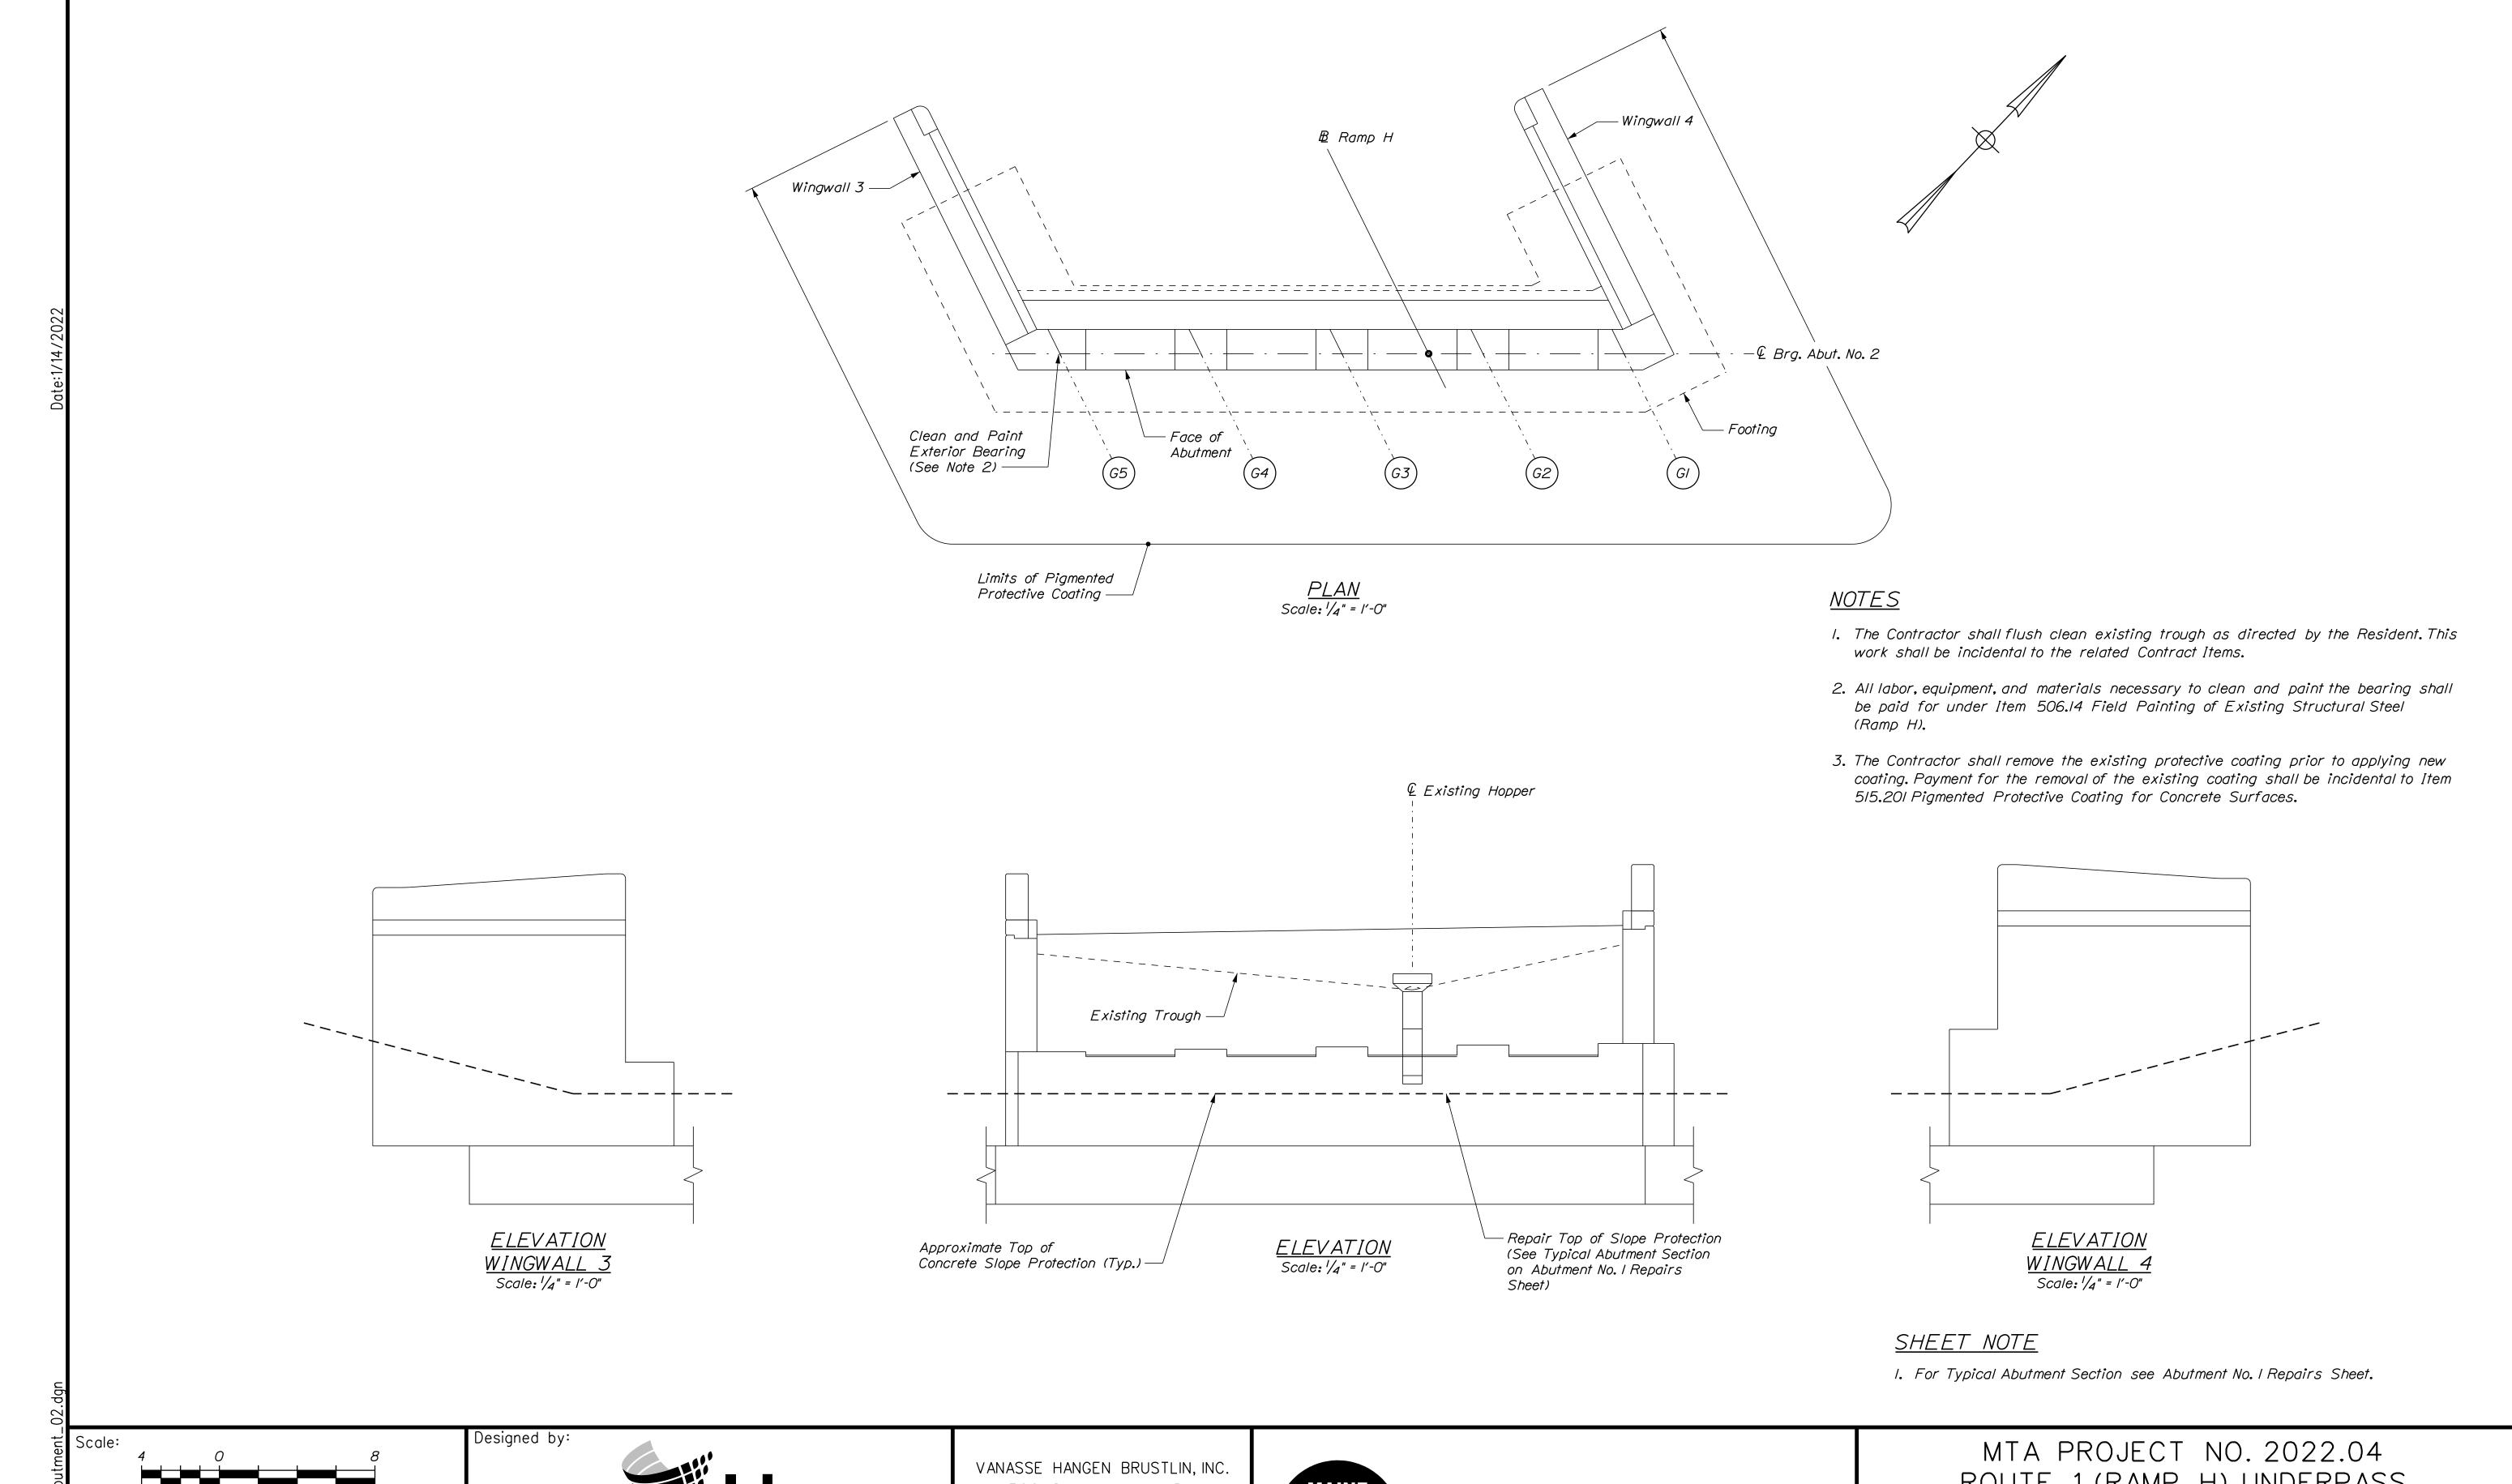

1/4" = 1'-0" Revision By Date CONSULTANT PROJECT MANAGER: G. Edington By Date GME 10/29/21 MEB 10/29/21 Checked Designed DPD 10/29/21 In Charge of TSB 10/29/21

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THE GOLD STAR MEMORIAL HIGHWAY


ROUTE 1 (RAMP H) UNDERPASS AT MM 1.60 IN YORK, ME ABUTMENT NO. 2 REPAIRS

VHB: 55345.00 CONTRACT:2022.04

60 SHEET NUMBER:


MTA PROJECT MANAGER: RALPH C. NORWOOD, IV



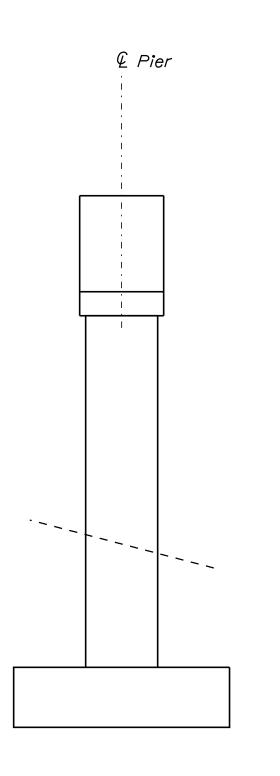


SOUTH ELEVATION

Scale: 1/4" = 1'-0"

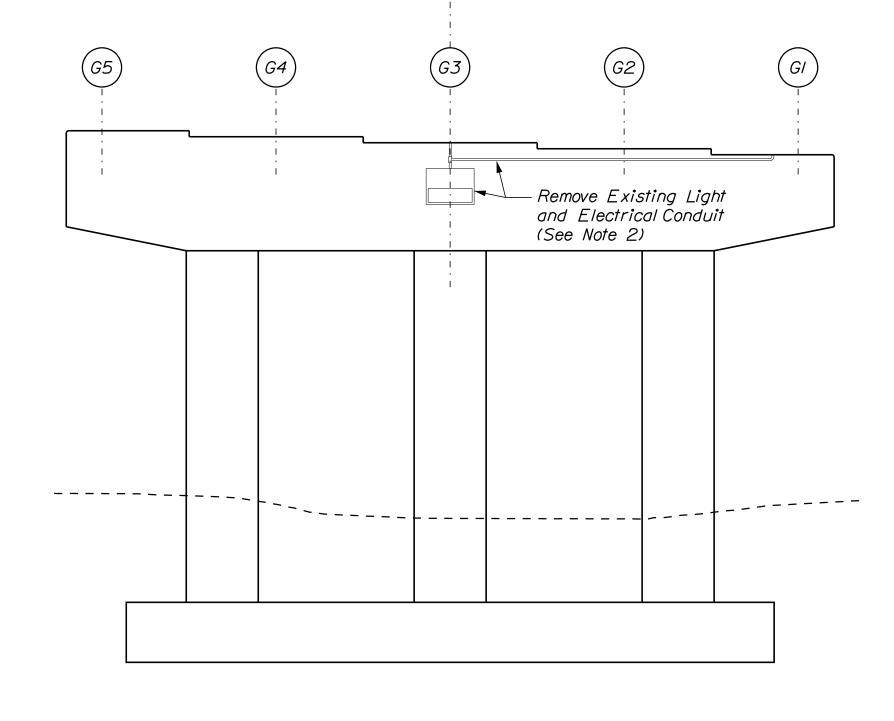

EAST ELEVATION

Scale: 1/4" = 1'-0"

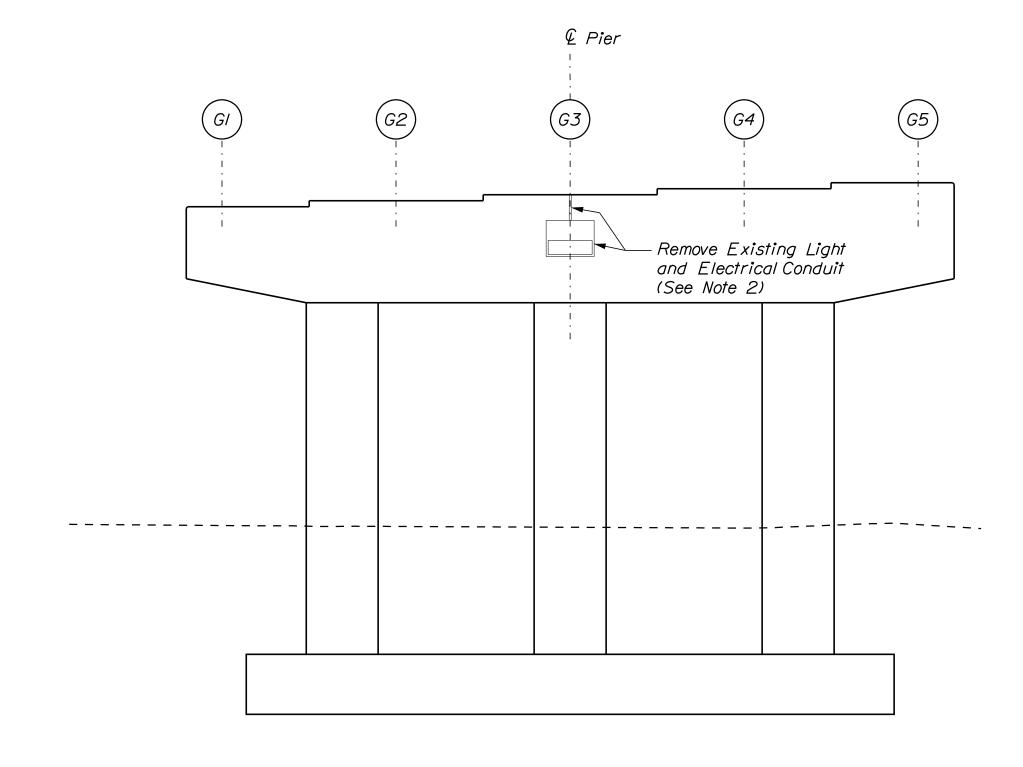

<u>WEST ELEVATION</u> Scale: 1/4" = 1'-0"

<u>NOTES</u>

- I. All labor, equipment, and materials necessary to remove existing light and electrical conduit shall be paid for under Item 634.1612 Removal of Bridge and Highway Lighting Including Wire.
- 2. Wiring for abandoned light fixtures is energized. The Contractor shall deenergize the wires prior to removal. Deenergizing of the existing wires shall be incidental to Item 634.1612 Removal of Bridge and Highway Lighting Including Wire.
- 3. Application of Pigmented Protective Coating to the pier of the Route I (Ramp H) Underpass is not required.

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TURNPIKE


THE GOLD STAR MEMORIAL HIGHWAY

MTA PROJECT NO. 2022.04 ROUTE 1 (RAMP H) UNDERPASS AT MM 1.60 IN YORK, ME PIER REPAIRS

VHB: 55345.00 CONTRACT:2022.04

61 SHEET NUMBER:

MTA PROJECT MANAGER: RALPH C. NORWOOD, IV

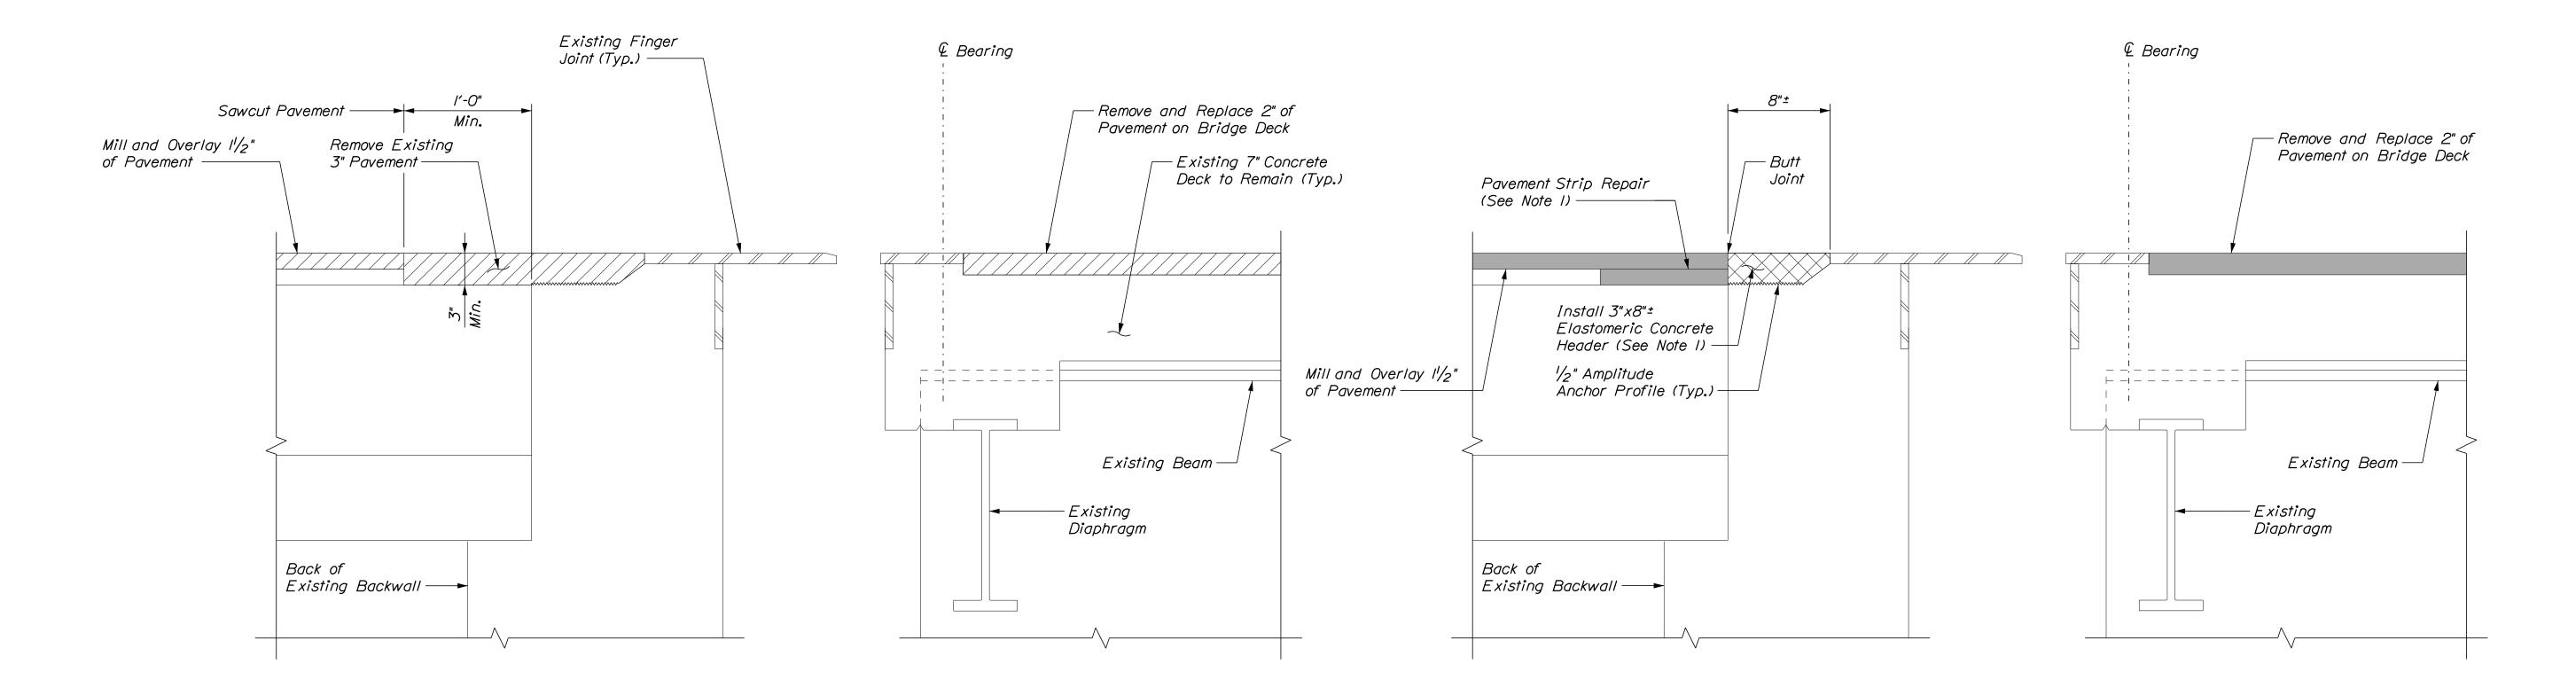

EXISTING EXPANSION JOINT SECTION

PROPOSED EXPANSION JOINT SECTION

SECTIONS AT EXPANSION JOINTS AT ABUTMENTS Not to Scale

<u>NOTE</u>

I. All labor, equipment, and materials necessary for installing the Pavement Strip Repair and Elastomeric Concrete Header shall be incidental to Item 520.2406, Bridge Joint Modification (Ramp H).

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				Drawn	DPD	10/29/21	In Charge of	TSB	10/29/21

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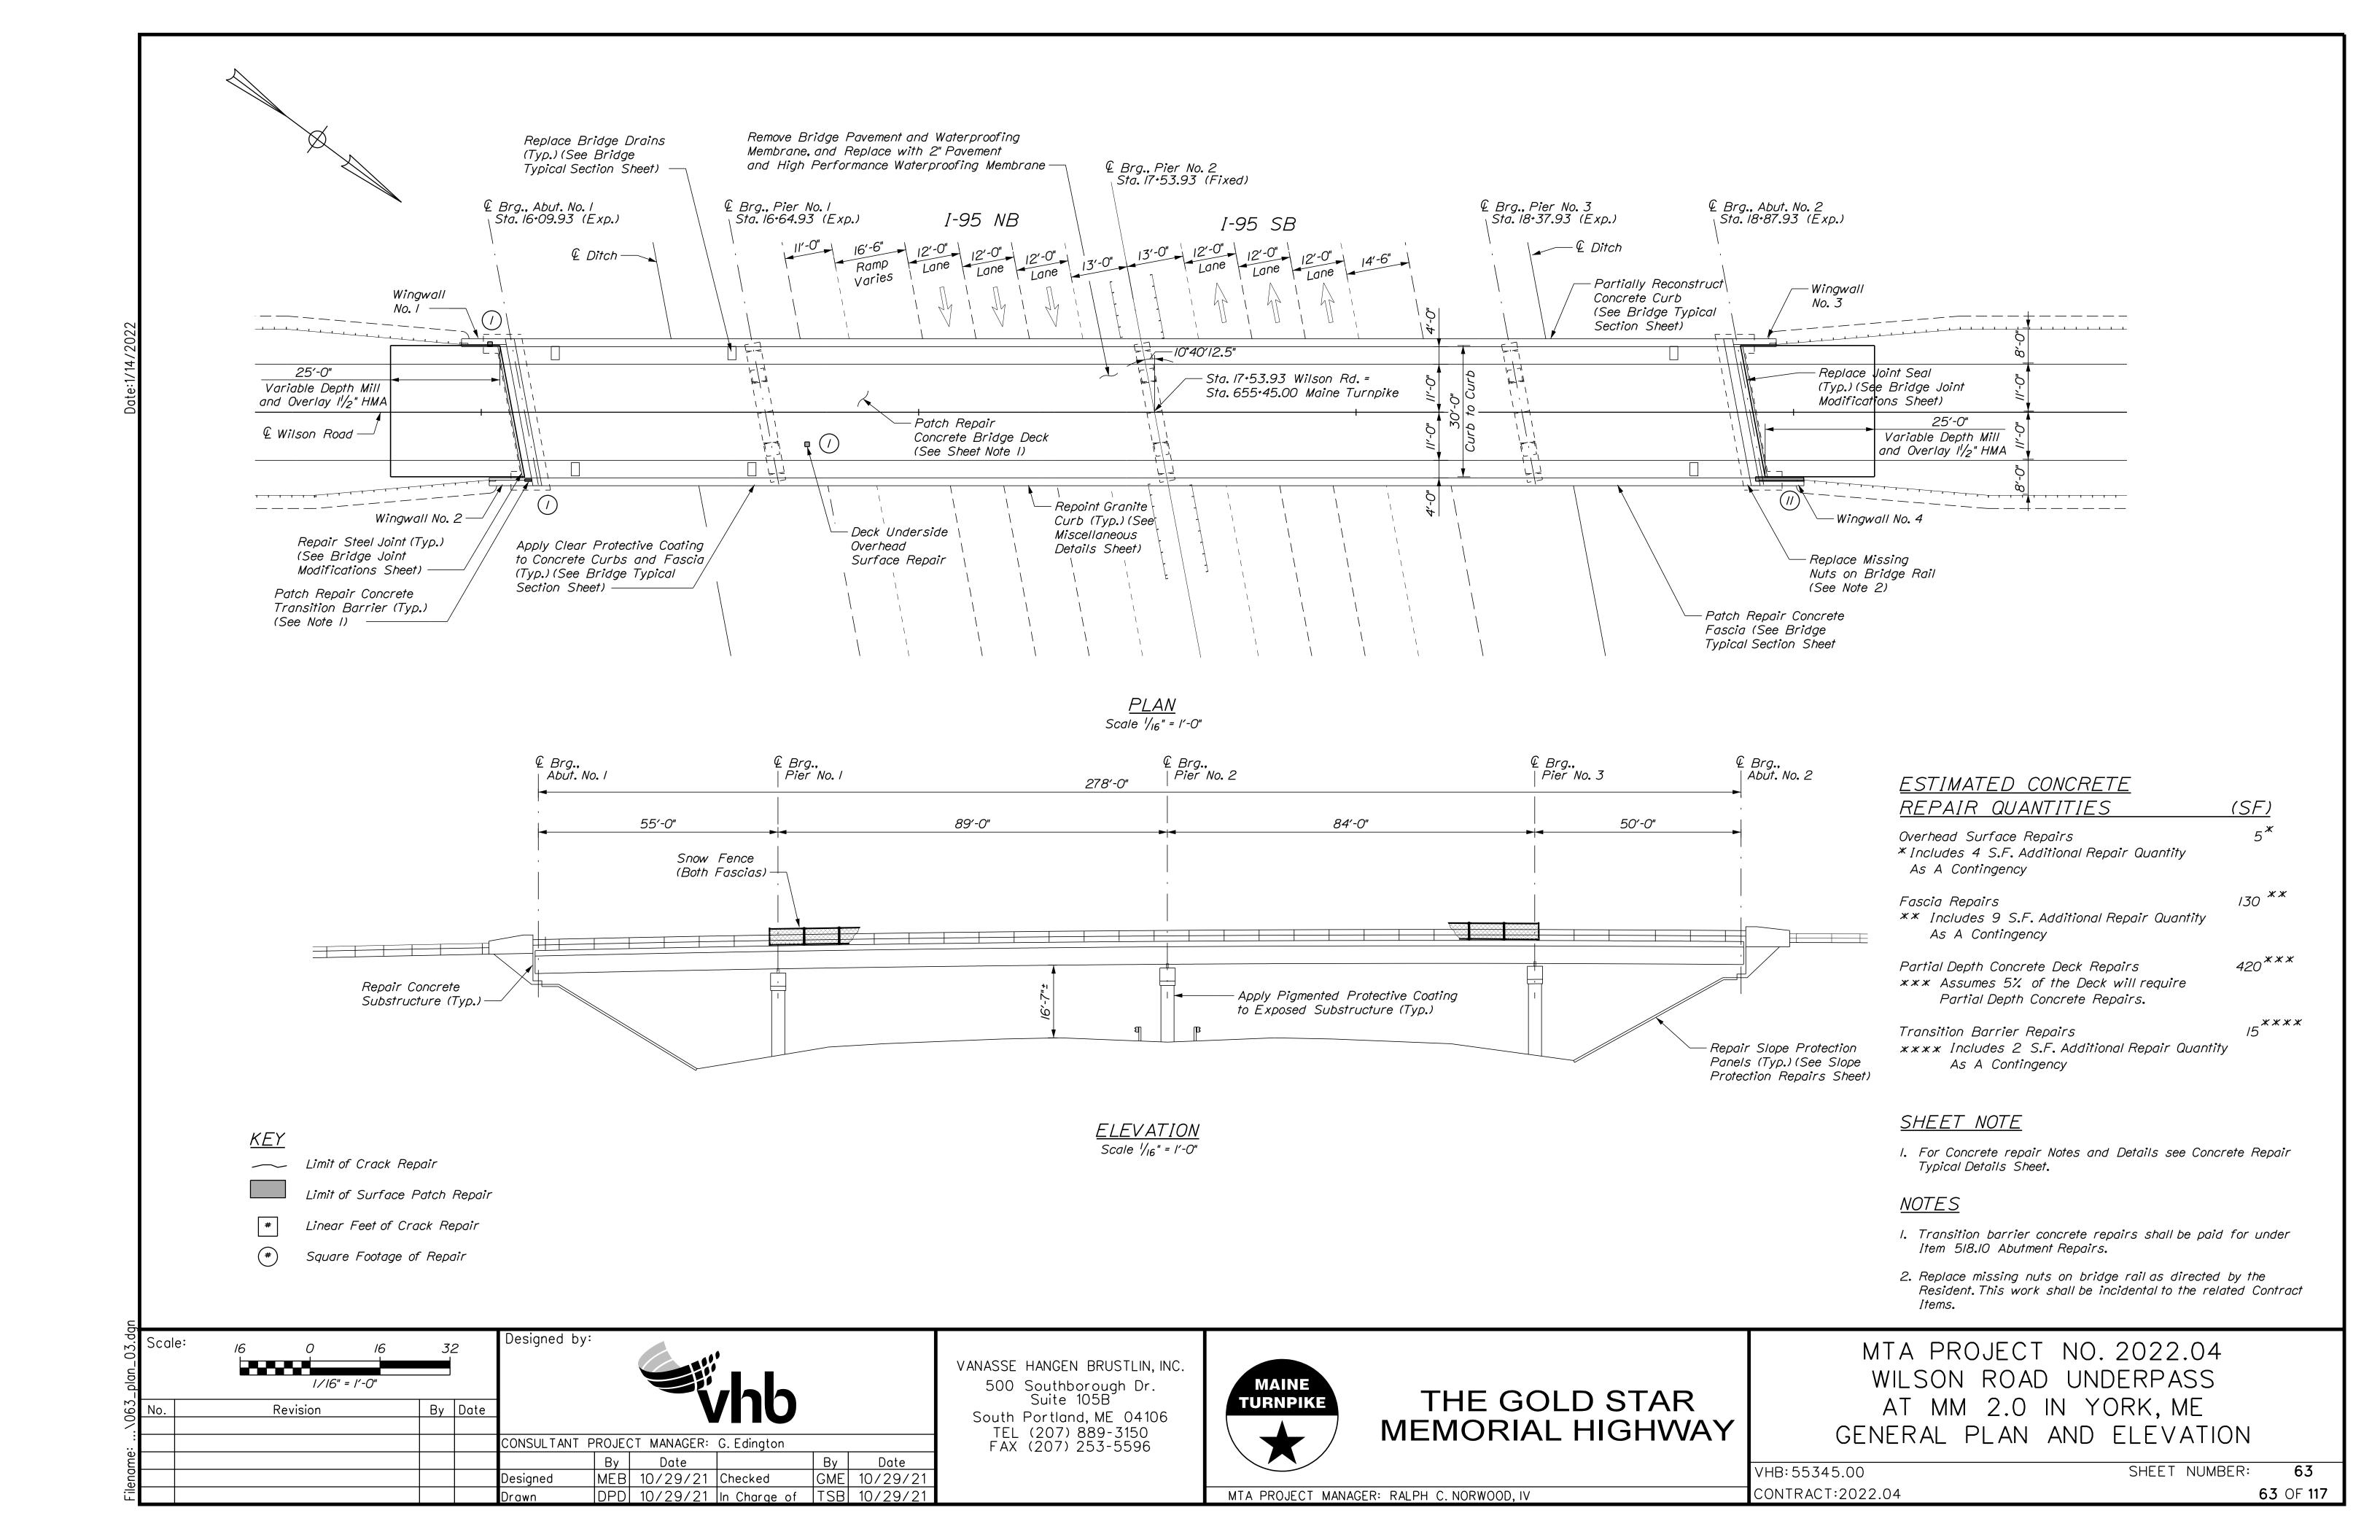
THE GOLD STAR MEMORIAL HIGHWAY


MTA PROJECT NO. 2022.04 ROUTE 1 (RAMP H) UNDERPASS AT MM 1.60 IN YORK, ME BRIDGE JOINT MODIFICATIONS

VHB: 55345.00 CONTRACT:2022.04


MTA PROJECT MANAGER: RALPH C. NORWOOD, IV


SHEET NUMBER: 62 **62** OF **117**



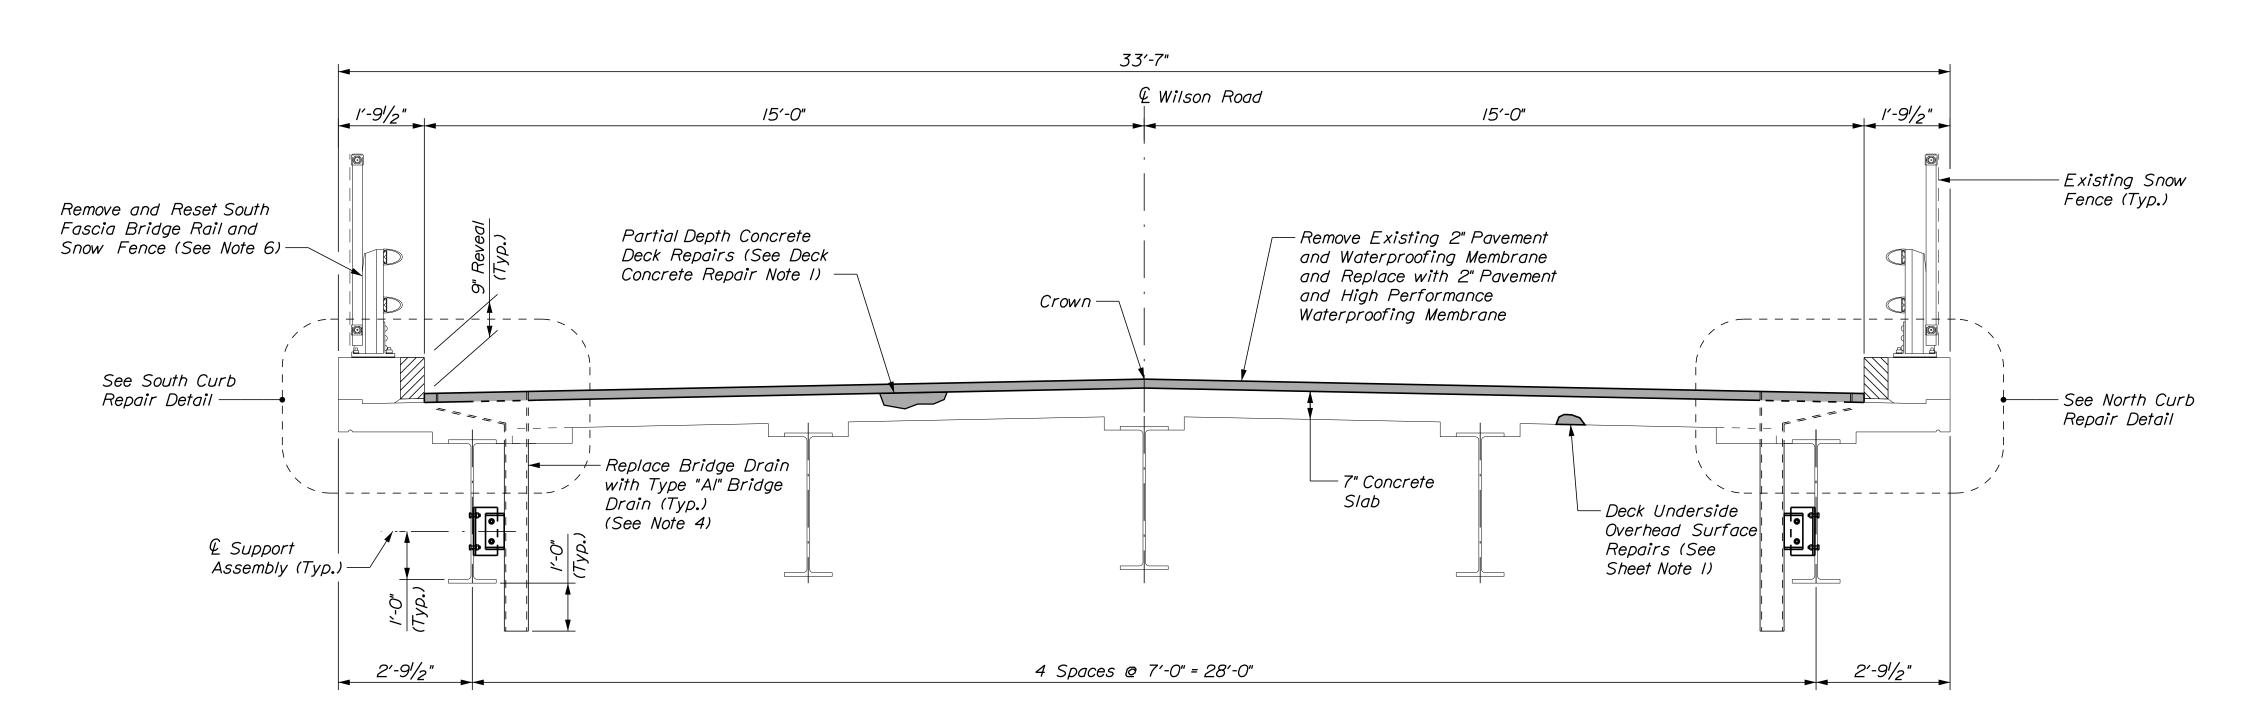

Scale: 1/2" = 1'-0"

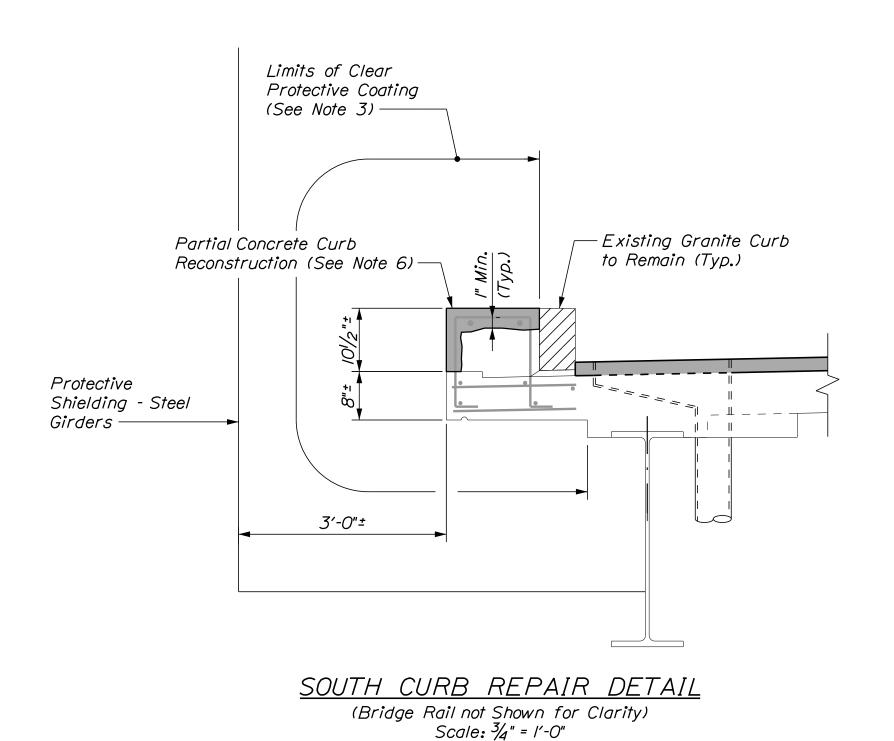

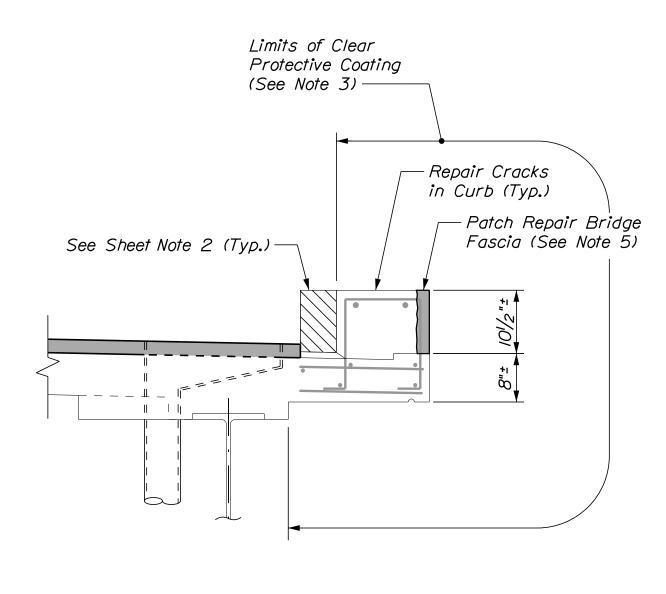

NORTH CURB REPAIR DETAIL

(Bridge Rail not Shown for Clarity)

Scale: 3/4" = 1'-0"

<u>ESTIMATED CONCRETE</u> REPAIR QUANTITIES

Epoxy Injection Crack Repair

(LF) 90 *

* Includes 5 L.F. Additional Repair Quantity
As A Contingency

DECK CONCRETE REPAIR NOTES

- I. Prior to the start of the deck concrete repairs, the Resident and the Contractor shall sound all deck concrete using a chain drag or other method approved by the Resident to determine the required repair limits. All costs for sounding the existing deck concrete shall be incidental to Item 518.80 Partial Depth Concrete Deck Repairs.
- 2. Sawcut I" deep along all limits of removal.
- 3. Chip concrete to the depth specified in Supplemental Specifications 518. If the removal limits change during the demolition process, the Contractor shall notify the Resident. The Resident and Contractor shall agree on the revised pay limits prior to the Contractor continuing the removals.
- 4. Prepare and patch repair deteriorated areas. Install new reinforcing steel, as required. See Supplemental Specifications 518.
- 5. Selectively patch repair the north bridge fascia as directed by the Resident. Patch repair of the north fascia shall be paid for under Item 518.75 Fascia and Overhang Repairs.
- 6. Reconstruct the south concrete bridge curb as shown in the South Curb Repair Detail. All labor, equipment, and materials necessary to partially reconstruct the south concrete bridge curb, including removing and resetting the existing bridge rail and snow fence, shall be paid for under Item 518.76, Partial Concrete Curb Reconstruction. See Special Provision Section 518 for additional requirements.
- 7. Limits of clear protective coating shall be paid for under Item 515.202, Clear Protective Coating for Concrete Surfaces.
- 8. Replacing the bridge drains shall be paid under Item 502.702, Replace Bridge Drain (Type AI).

SHEET NOTES

- I. For Concrete repair Notes and Details see Concrete Repair Typical Details Sheet.
- 2. For Existing Granite Curb Detail see Miscellaneous Details Sheet.

Scale: AS NOTED

| No. | Revision | By | Date | CONSULTANT | PROJECT | MANAGER: G. Edington | By | Date | By | Date | By | Date | Consultant | Designed | MEB | 10/29/21 | Checked | GME | 10/29/21 | Drawn | DPD | 10/29/21 | In Charge of | TSB | 10/29/21 |

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THE GOLD STAR
MEMORIAL HIGHWAY


MTA PROJECT NO. 2022.04
WILSON ROAD UNDERPASS
AT MM 2.0 IN YORK, ME
BRIDGE TYPICAL SECTION


VHB: 55345.00

SHEET NUMBER:

64

CONTRACT:2022.04 64 OF 117

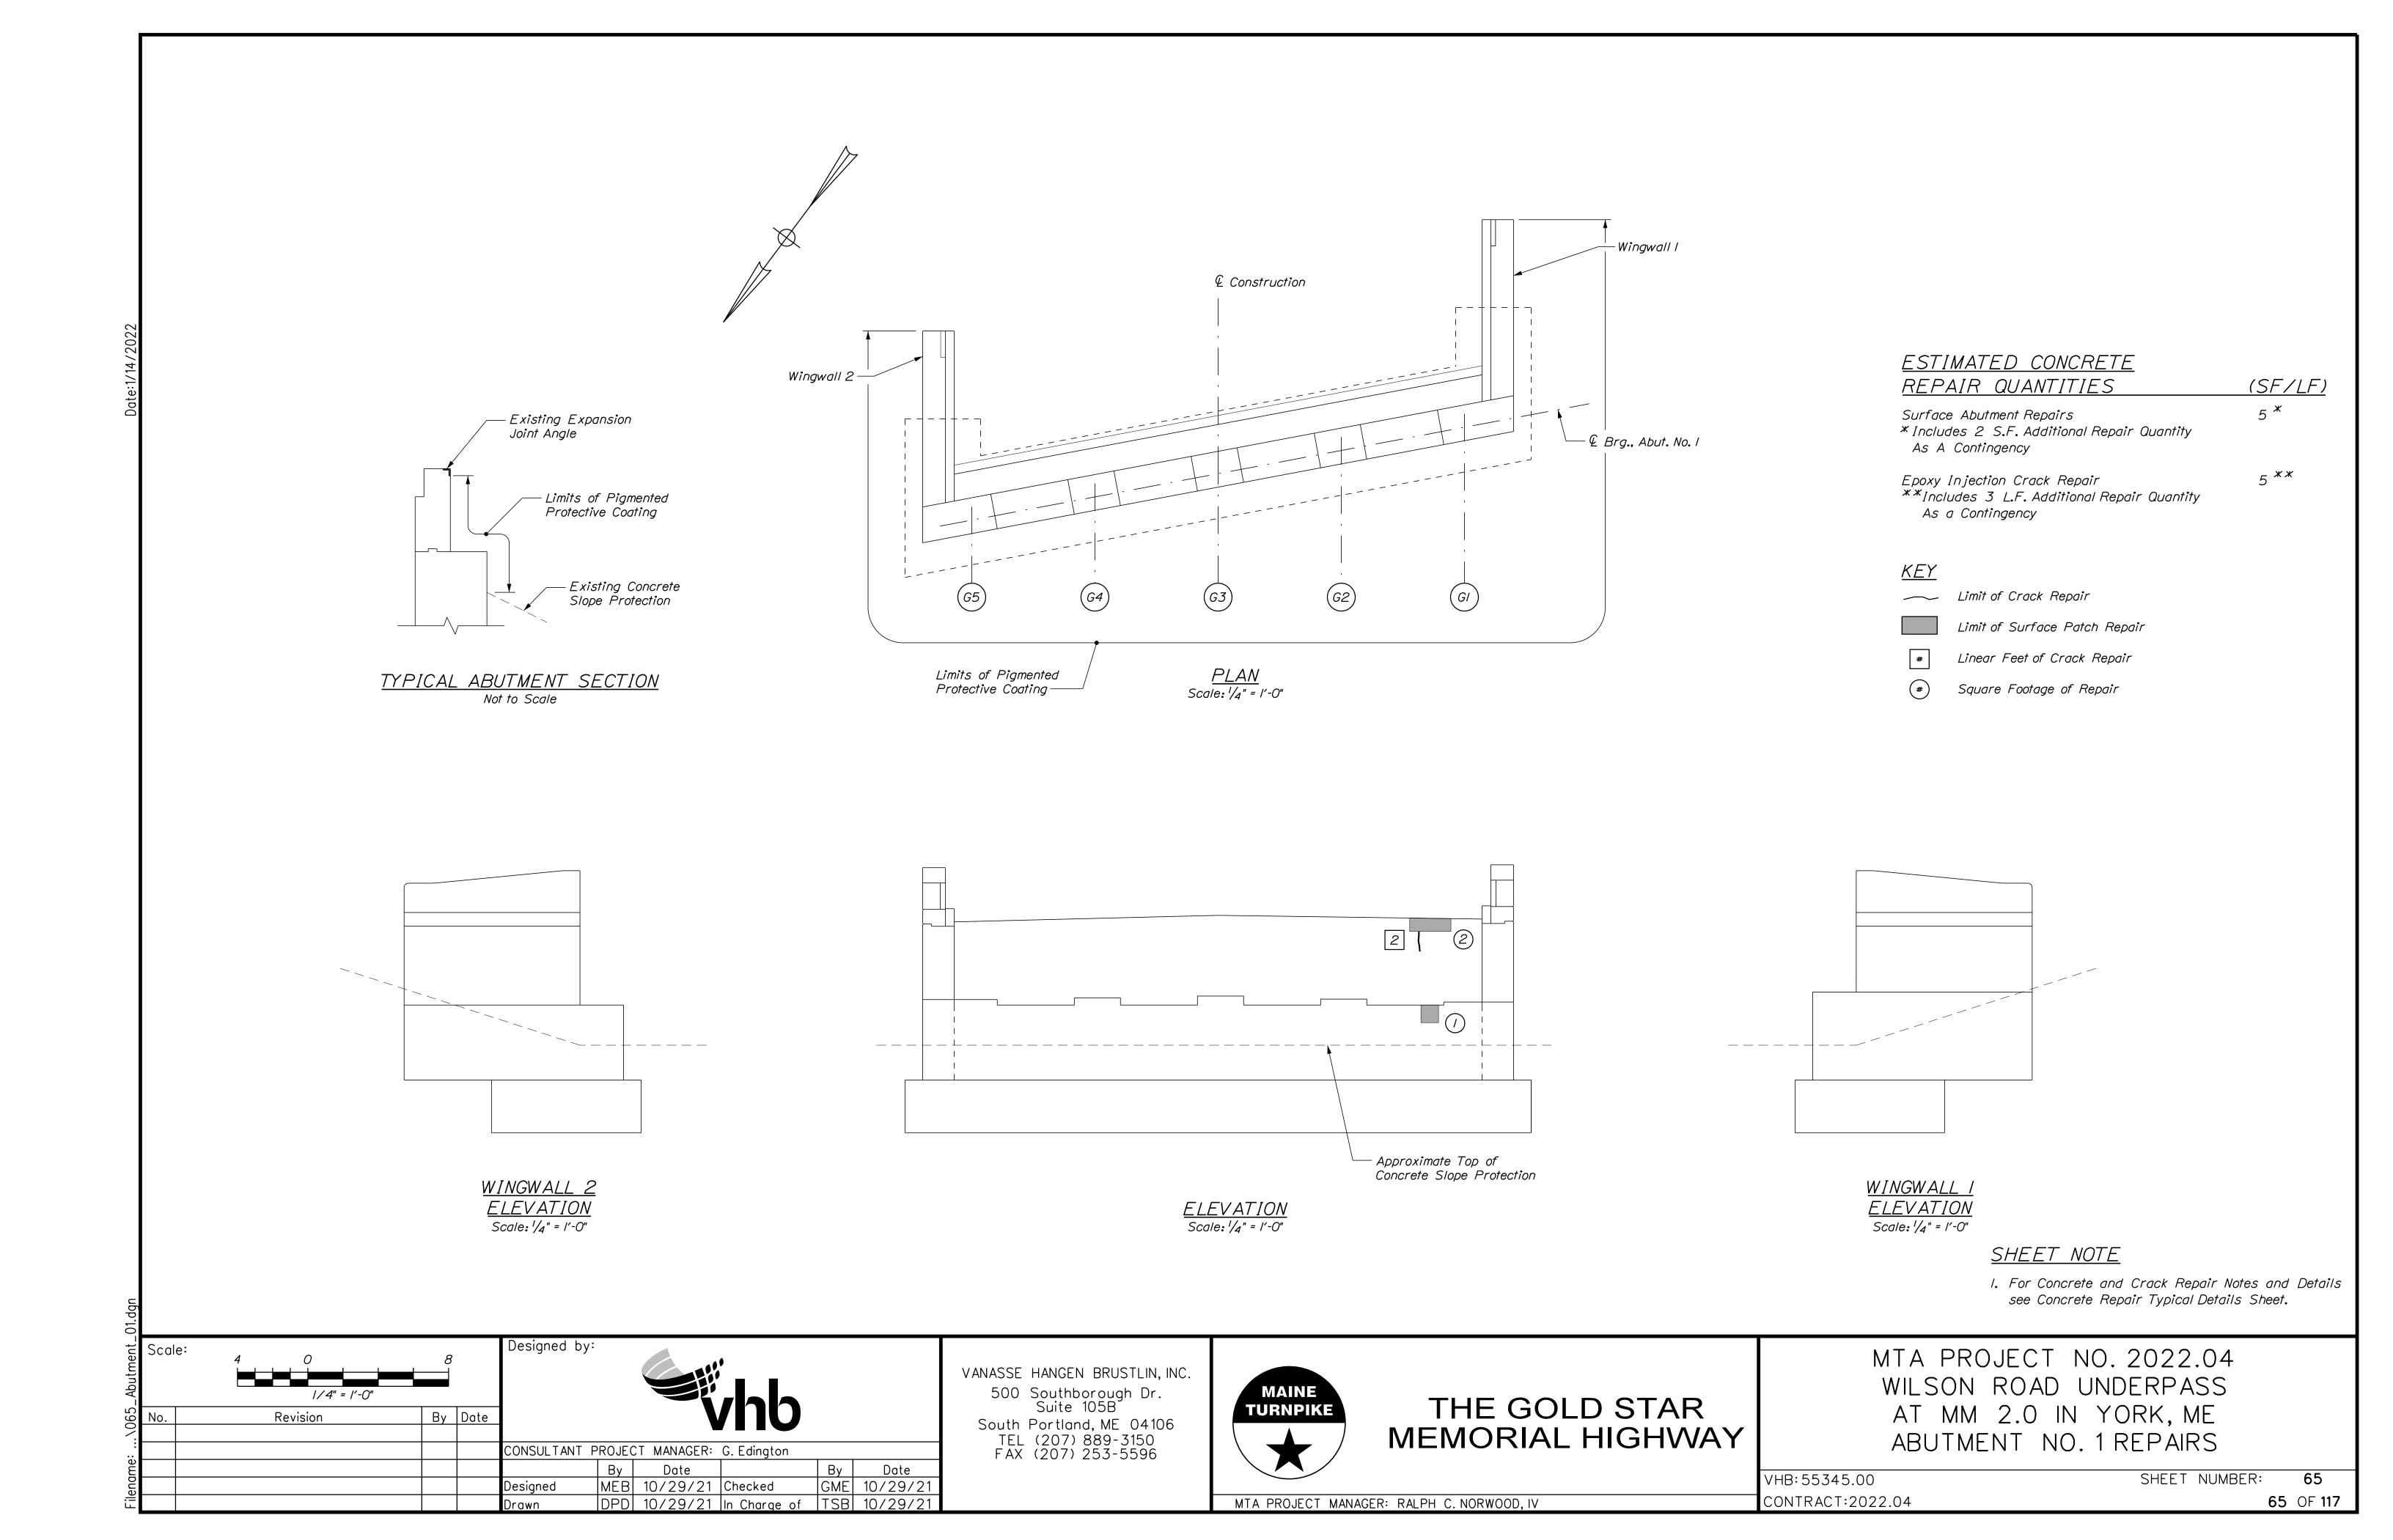


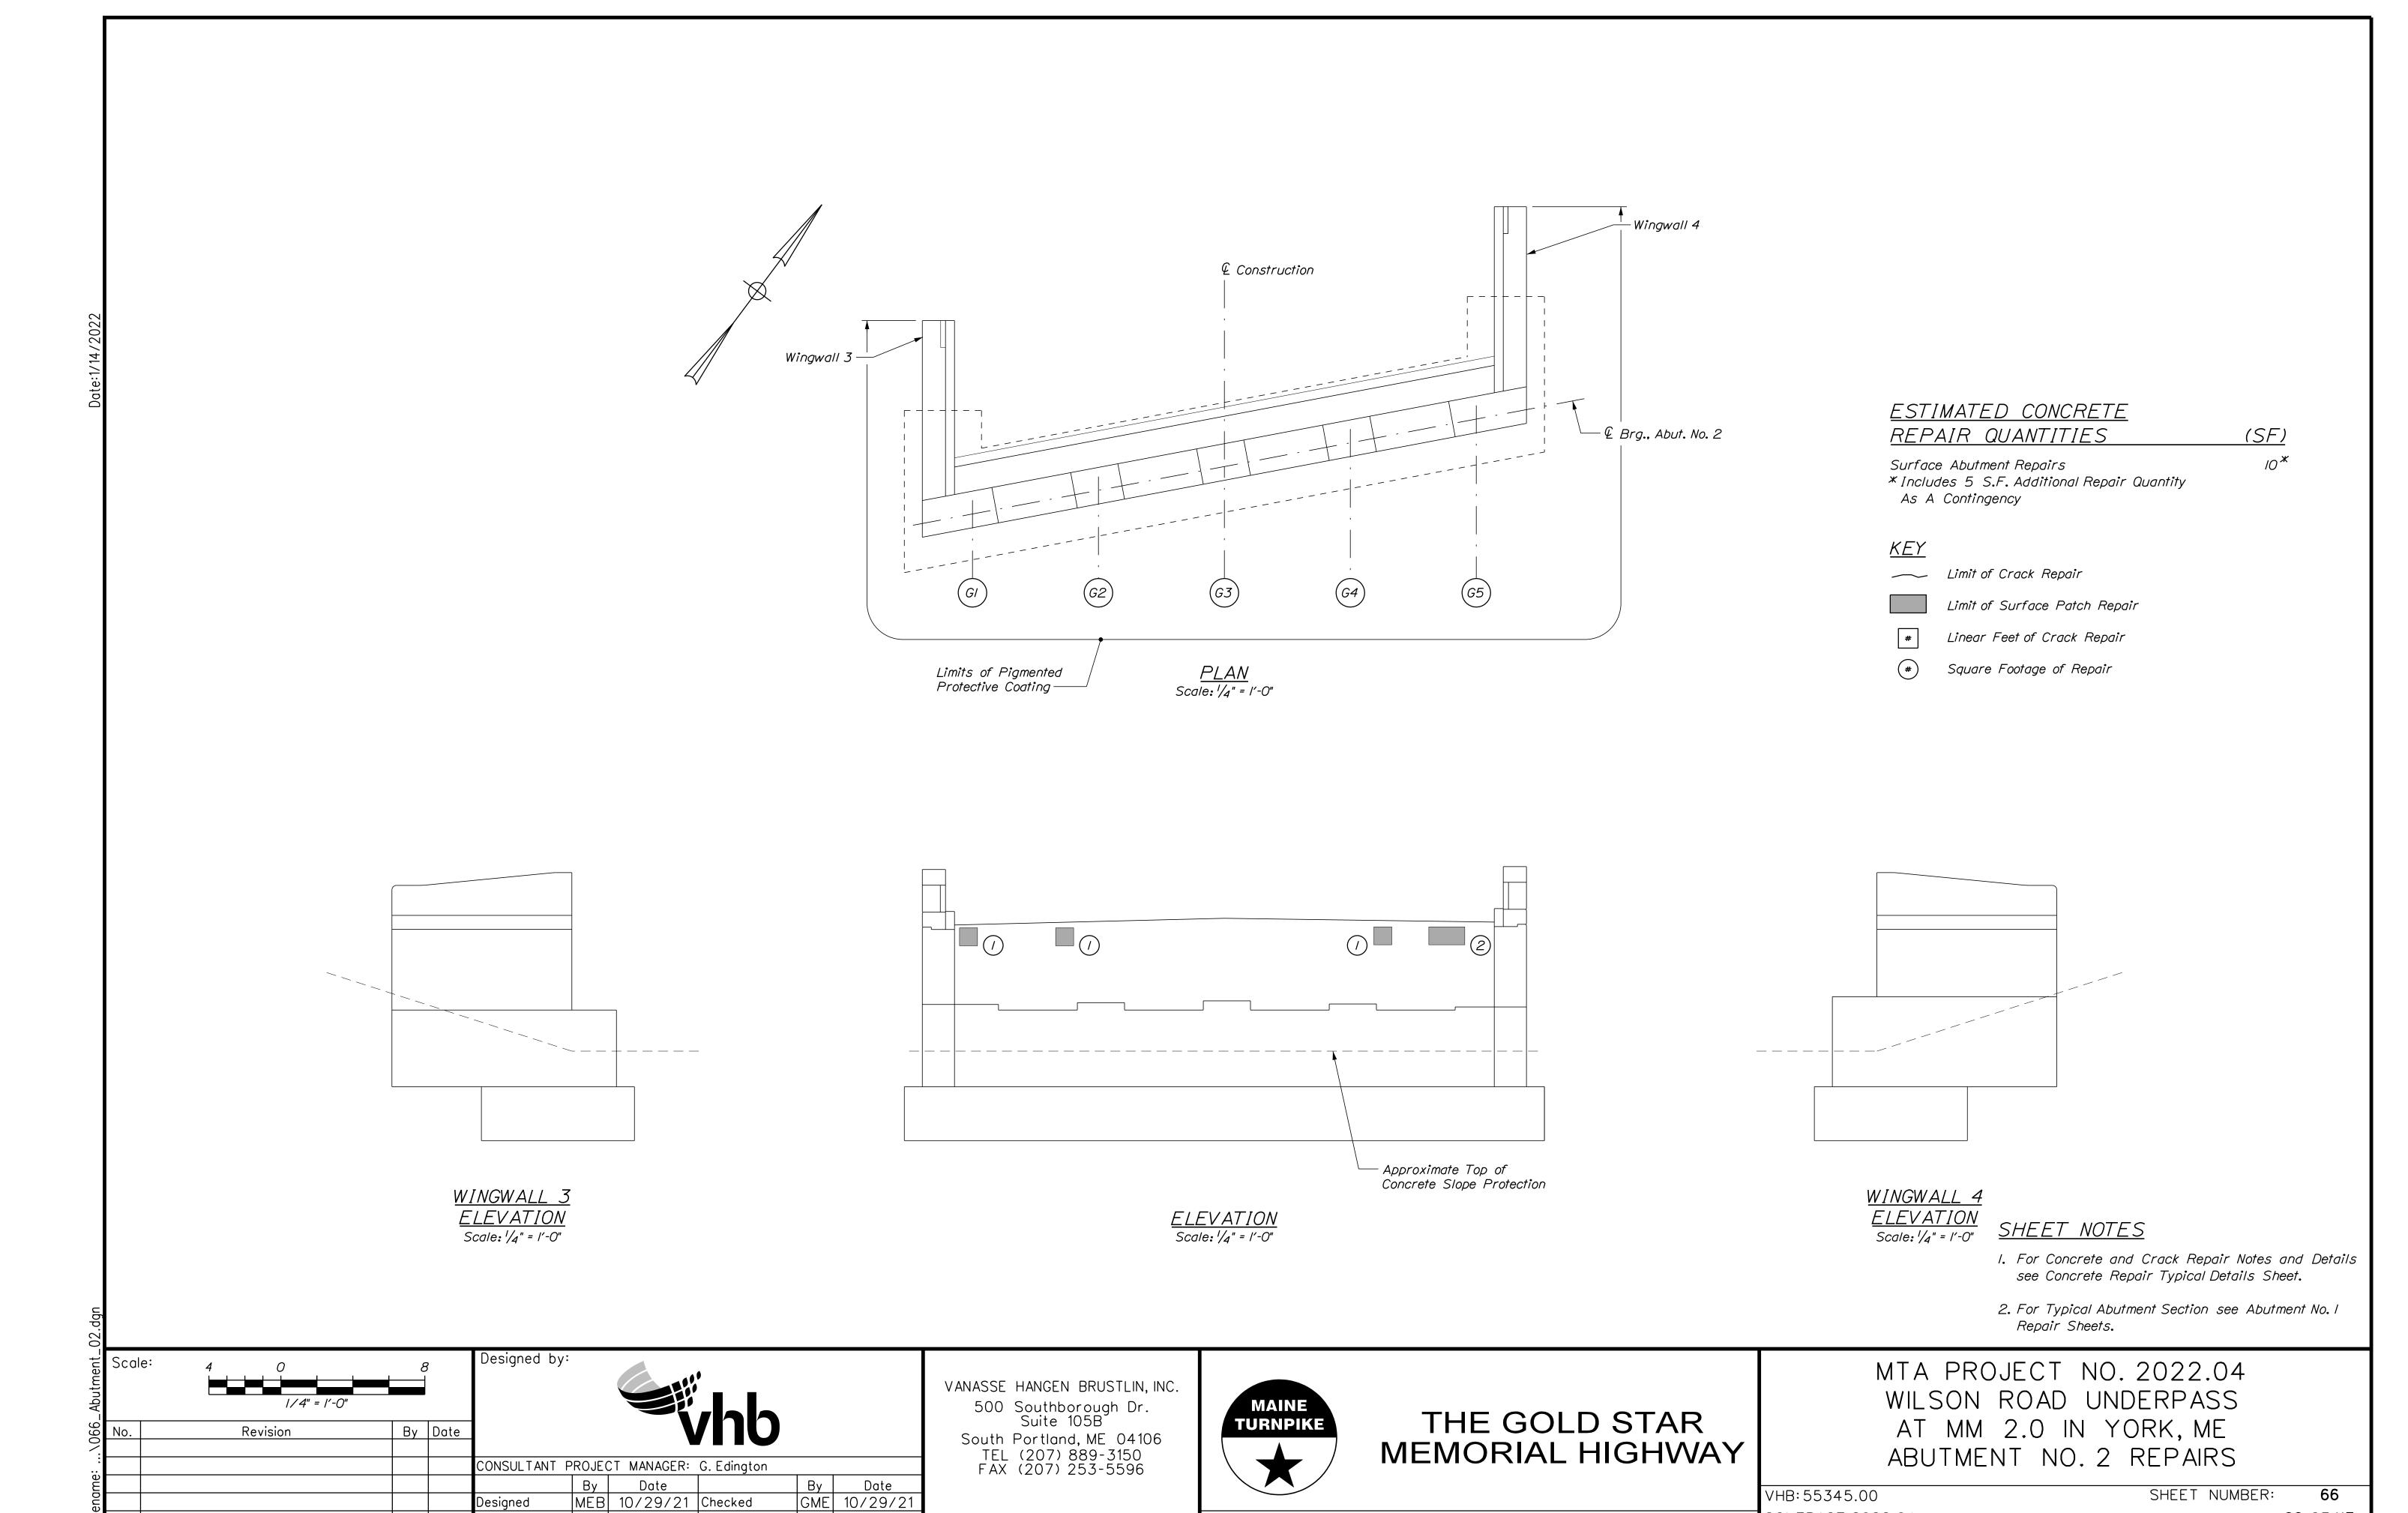

MTA PROJECT MANAGER: RALPH C. NORWOOD, IV

DPD 10/29/21 In Charge of TSB 10/29/21

CONTRACT: 2022.04 66 OF 117

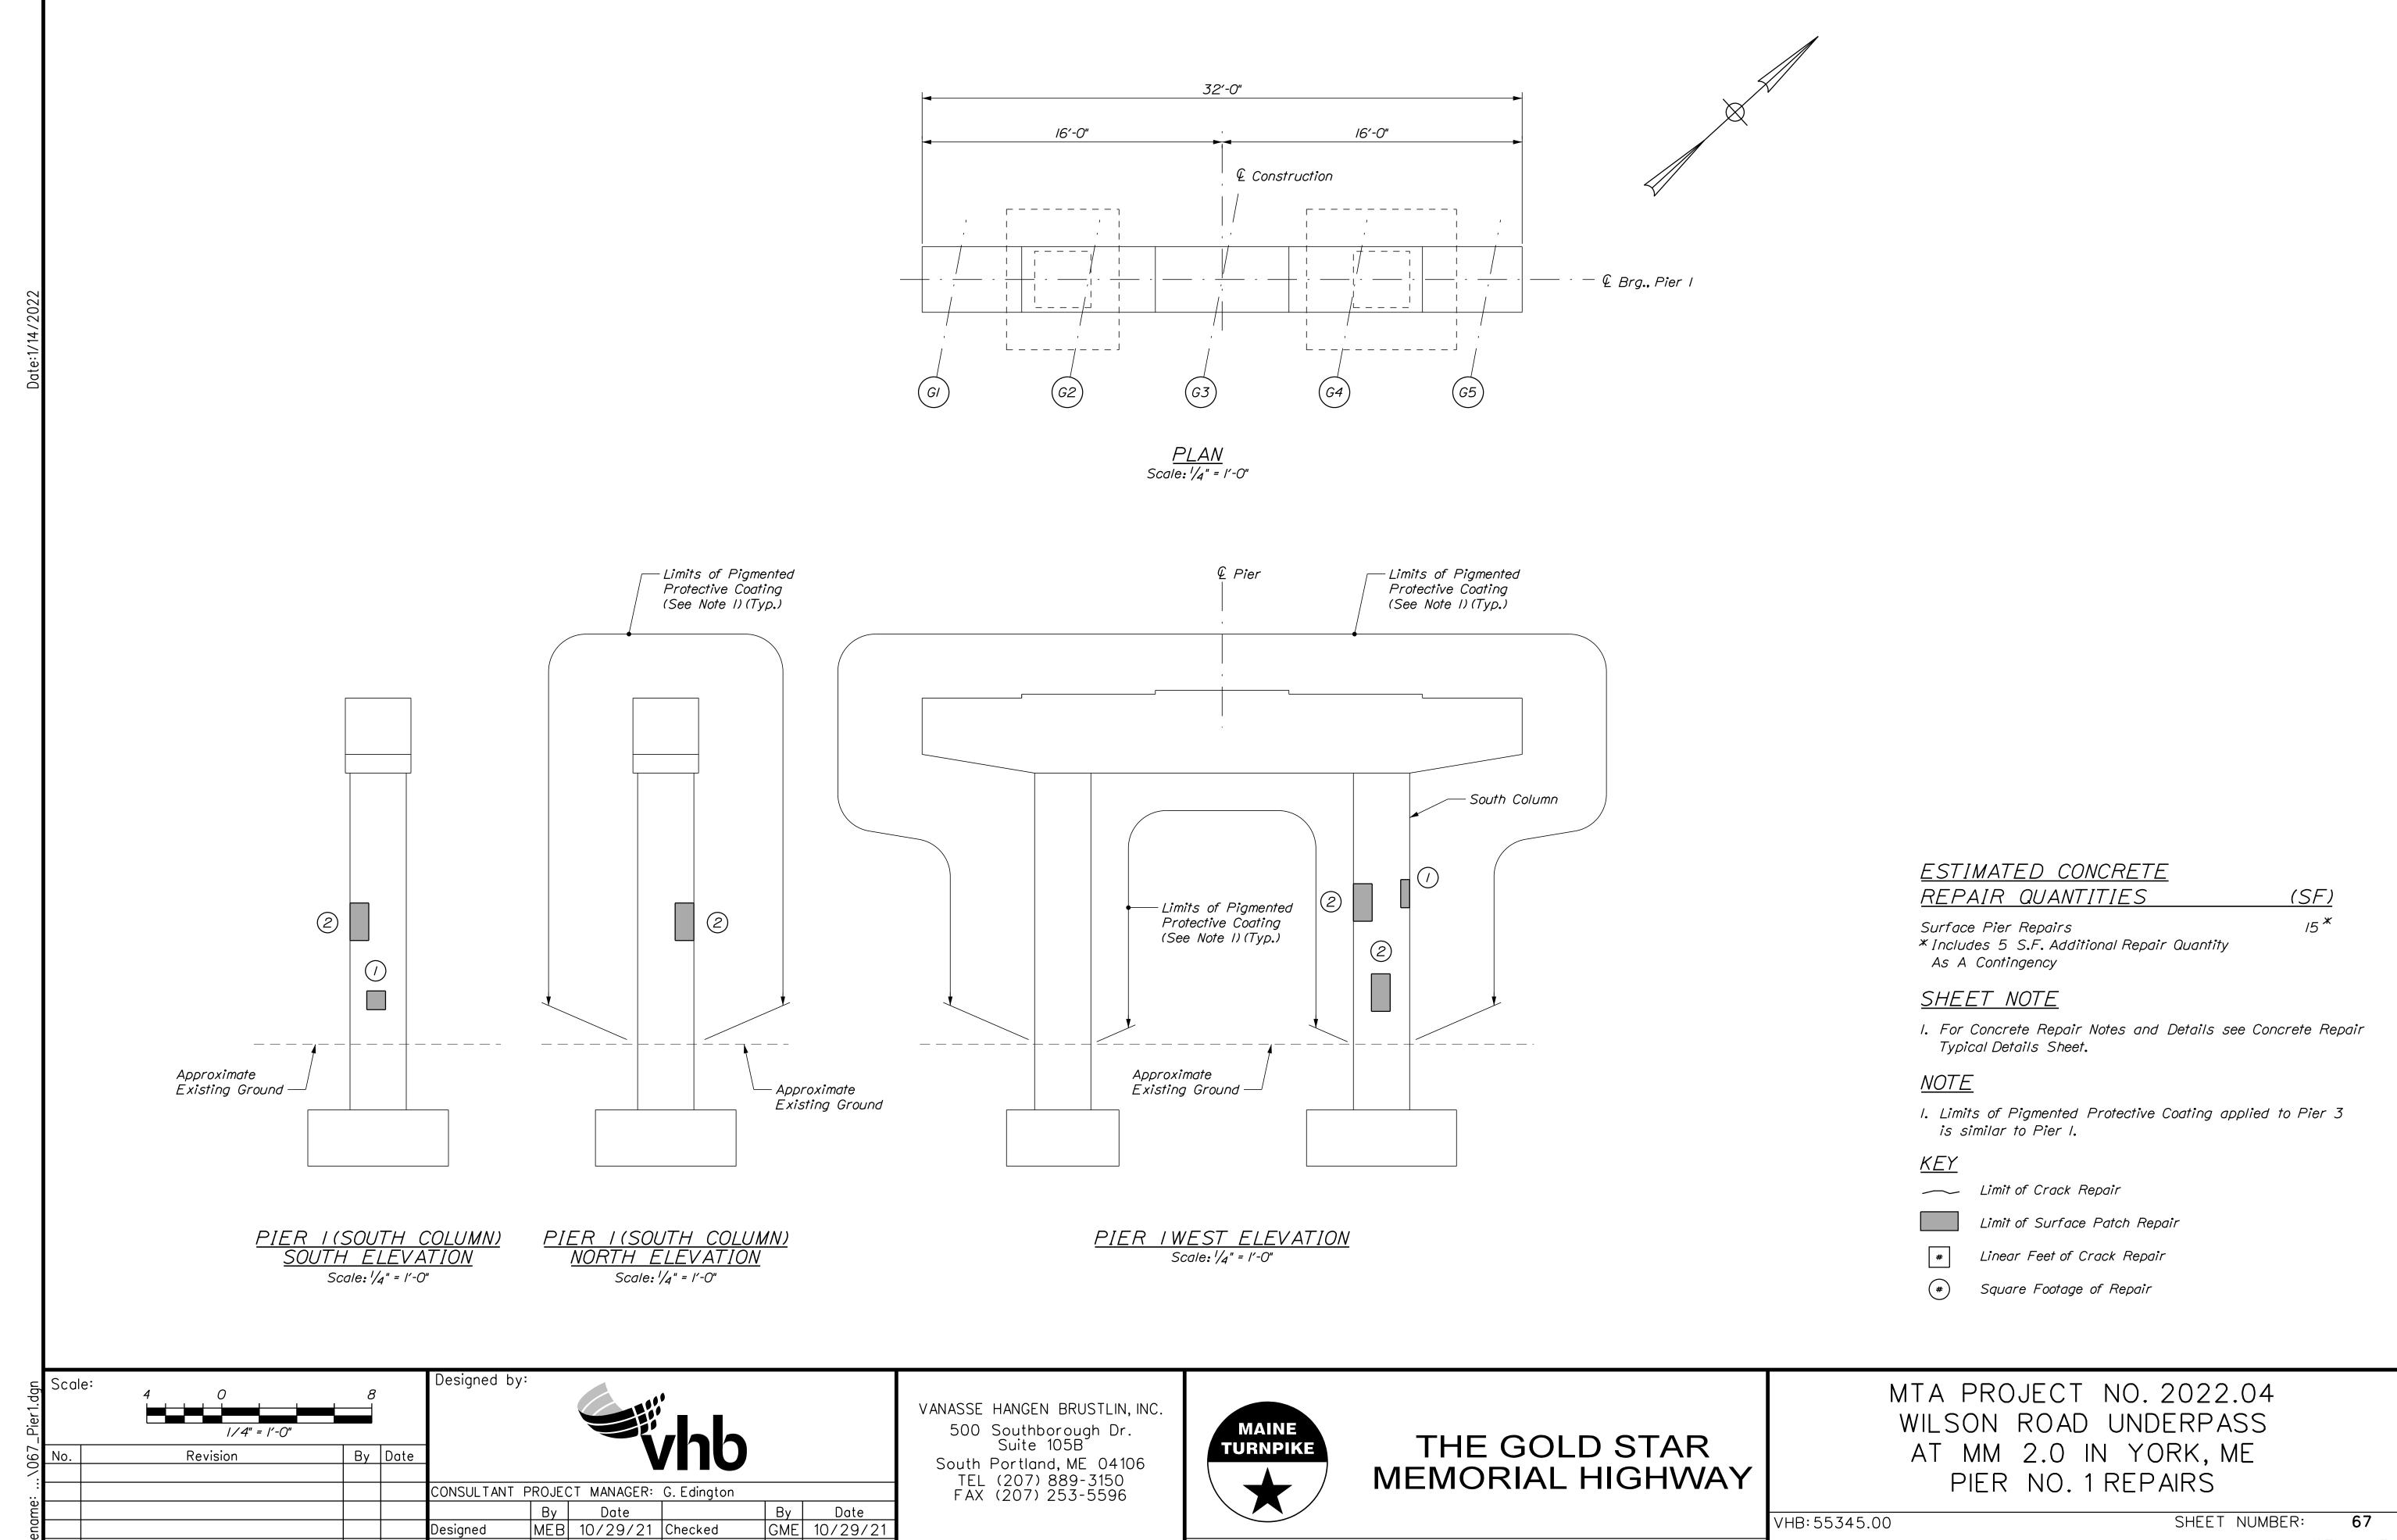


MTA PROJECT MANAGER: RALPH C. NORWOOD, IV


DPD 10/29/21 In Charge of TSB 10/29/21

67 OF 117

CONTRACT:2022.04

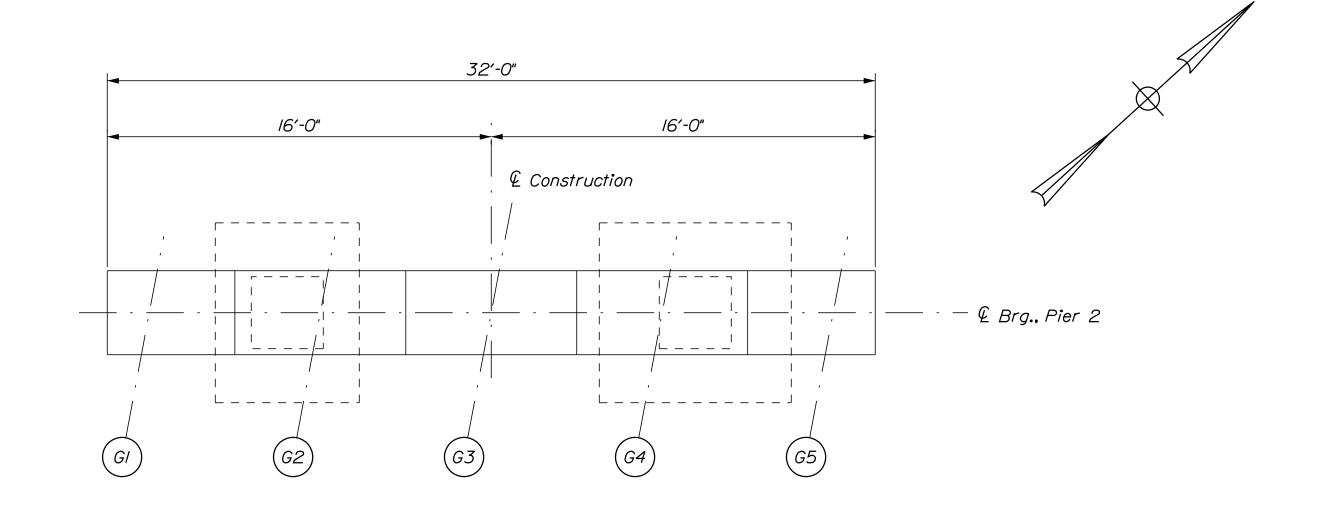

<u>PLAN</u> Scale: ¹/₄" = 1'-0"

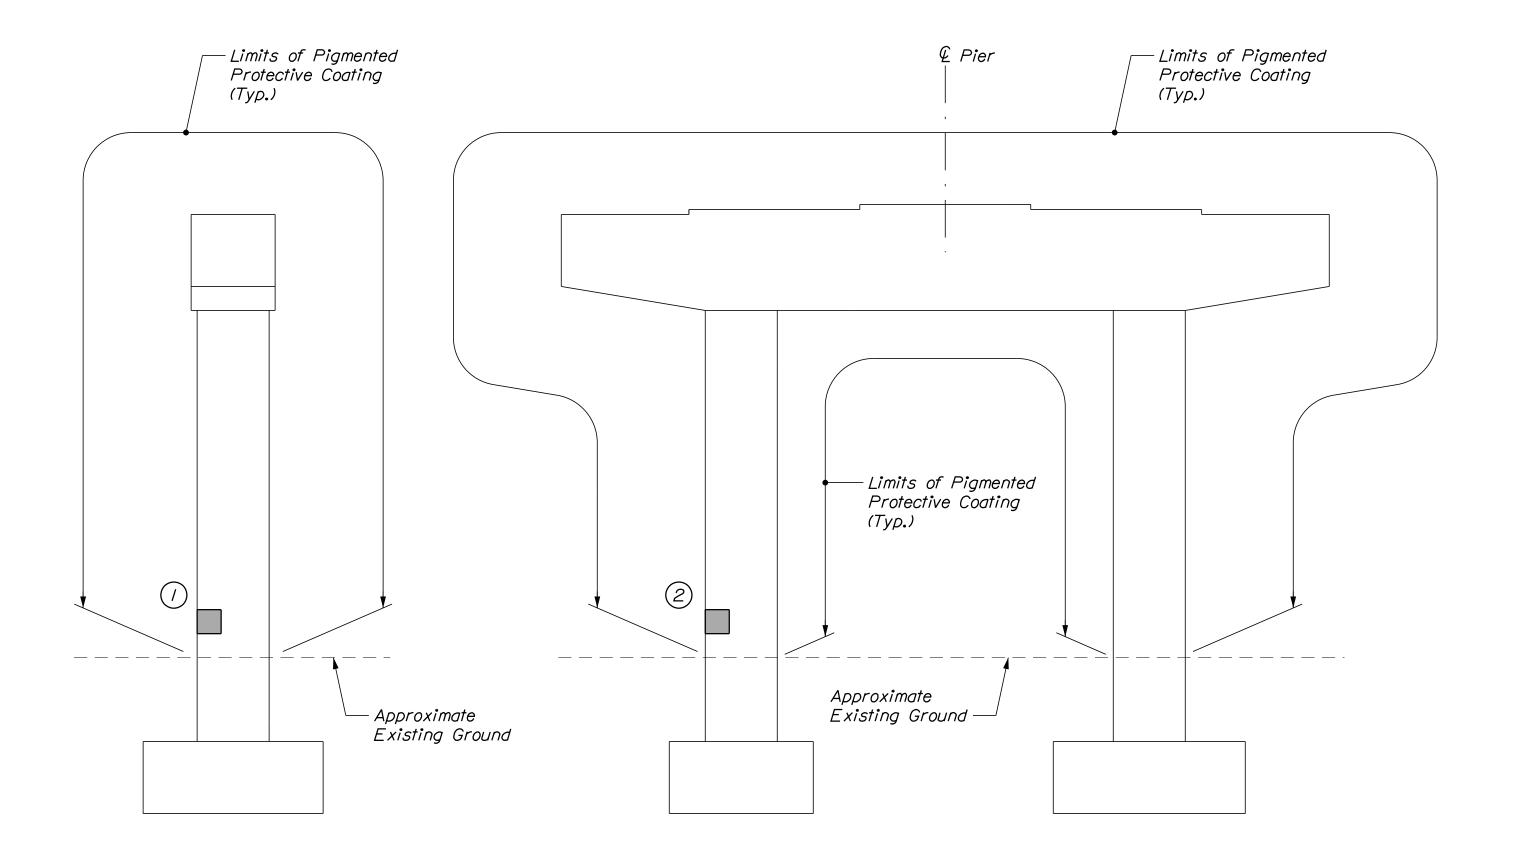

PIER 2 SOUTH ELEVATION

Scale: 1/4" = 1'-0"

PIER 2 WEST ELEVATION

Scale: 1/4" = 1'-0"

ESTIMATED CONCRETE

REPAIR QUANTITIES

(SF)

Surface Pier Repairs

* Includes 2 S.F. Additional Repair Quantity

As A Contingency

SHEET NOTE

I. For Concrete Repair Notes and Details see Concrete Repair Typical Details Sheet.

<u>KEY</u>

____ Limit of Crack Repair

Limit of Surface Patch Repair

Linear Feet of Crack Repair

#) Square Footage of Repair

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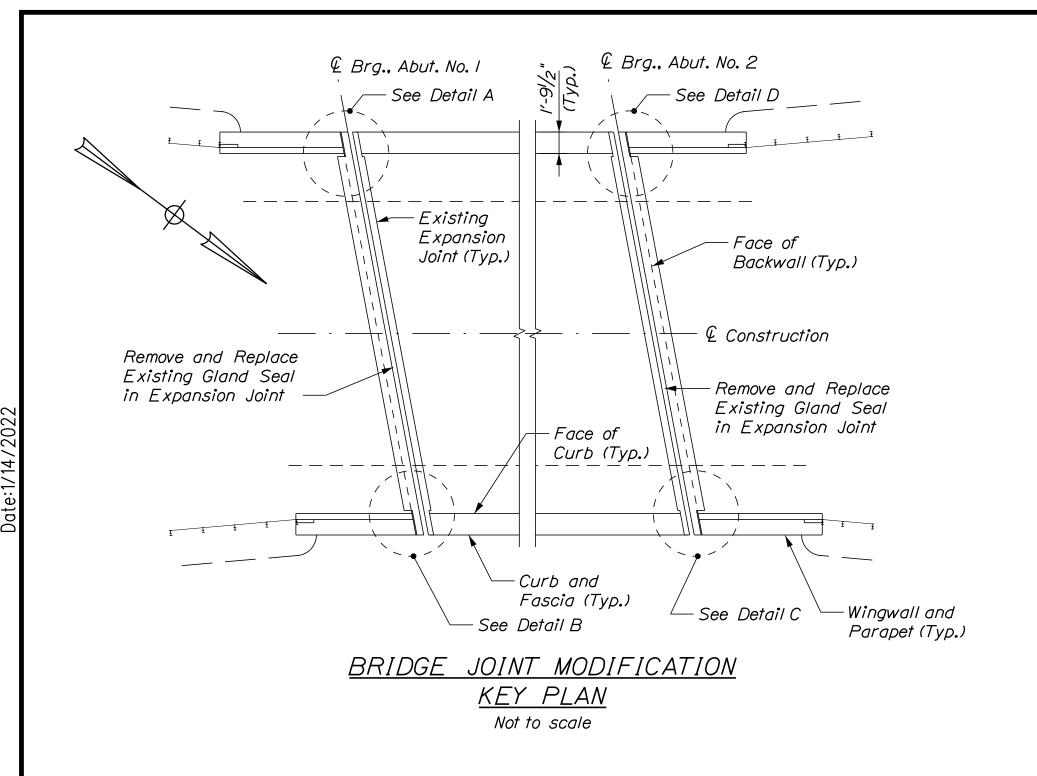


THE GOLD STAR MEMORIAL HIGHWAY

MTA PROJECT NO. 2022.04
WILSON ROAD UNDERPASS
AT MM 2.0 IN YORK, ME
PIER NO. 2 REPAIRS


VHB: 55345.00 CONTRACT: 2022.04 SHEET NUMBER: 68

MTA PROJECT MANAGER: RALPH C. NORWOOD, IV



BRIDGE JOINT MODIFICATION NOTES:

- I. Replace the entire existing gland seal in the deck end expansion joints at both abutments. The existing gland seal is called out as a S-300 Watson Bowman Acme on the 1988 rehabilitation plans. Field investigation indicates that is the type of gland seal currently installed.
- 2. Install steel joint end cover plates as shown in the details on this sheet to seal holes at face of curb that are currently allowing roadway drainage onto fascia girder and bridge seat. Grind top of existing expansion joint angle and extrusion as required to provide a smooth surface for the cover plates to bear on. Dimensions of joint end cover plates shown in these plans are based on limited field measurements. The Contractor shall take sufficient field measurements to confirm the proposed dimensions of the plates. If adjustments to plate dimensions are required for proper fit up based on Contractor's field measurements, the Contractor shall submit plans annotated with the revised dimensions to the Resident prior to fabrication.
- 3. Prior to installation of joint end cover plates, place non-shrink concrete repair material to fill any voids in backwall or concrete deck end below or adjacent to the cover plates. Use foam backer rod or forms as necessary to contain the repair material.
- 4. After the joint end cover plates are installed, place elastomeric joint sealant along interface with face of curb and any other unwelded edges of the plates or adjacent openings to prevent water intrusion through joint.
- 5. At the locations shown in these plans where the steel extrusion in the curb has separated from the concrete, reweld the extrusion to the embedded steel plate or where there is insufficient remaining embedded steel plate due to corrosion seal the gap with elastomeric sealant.
- 6. See Bridge Joint Modifications Sheet 2 of 2 for sections and joint end cover plate details.
- 7. All labor, equipment, and material to complete the installation of the joint end cover plates shall be paid for under Item 530.2407, Bridge Joint Steel Modification.

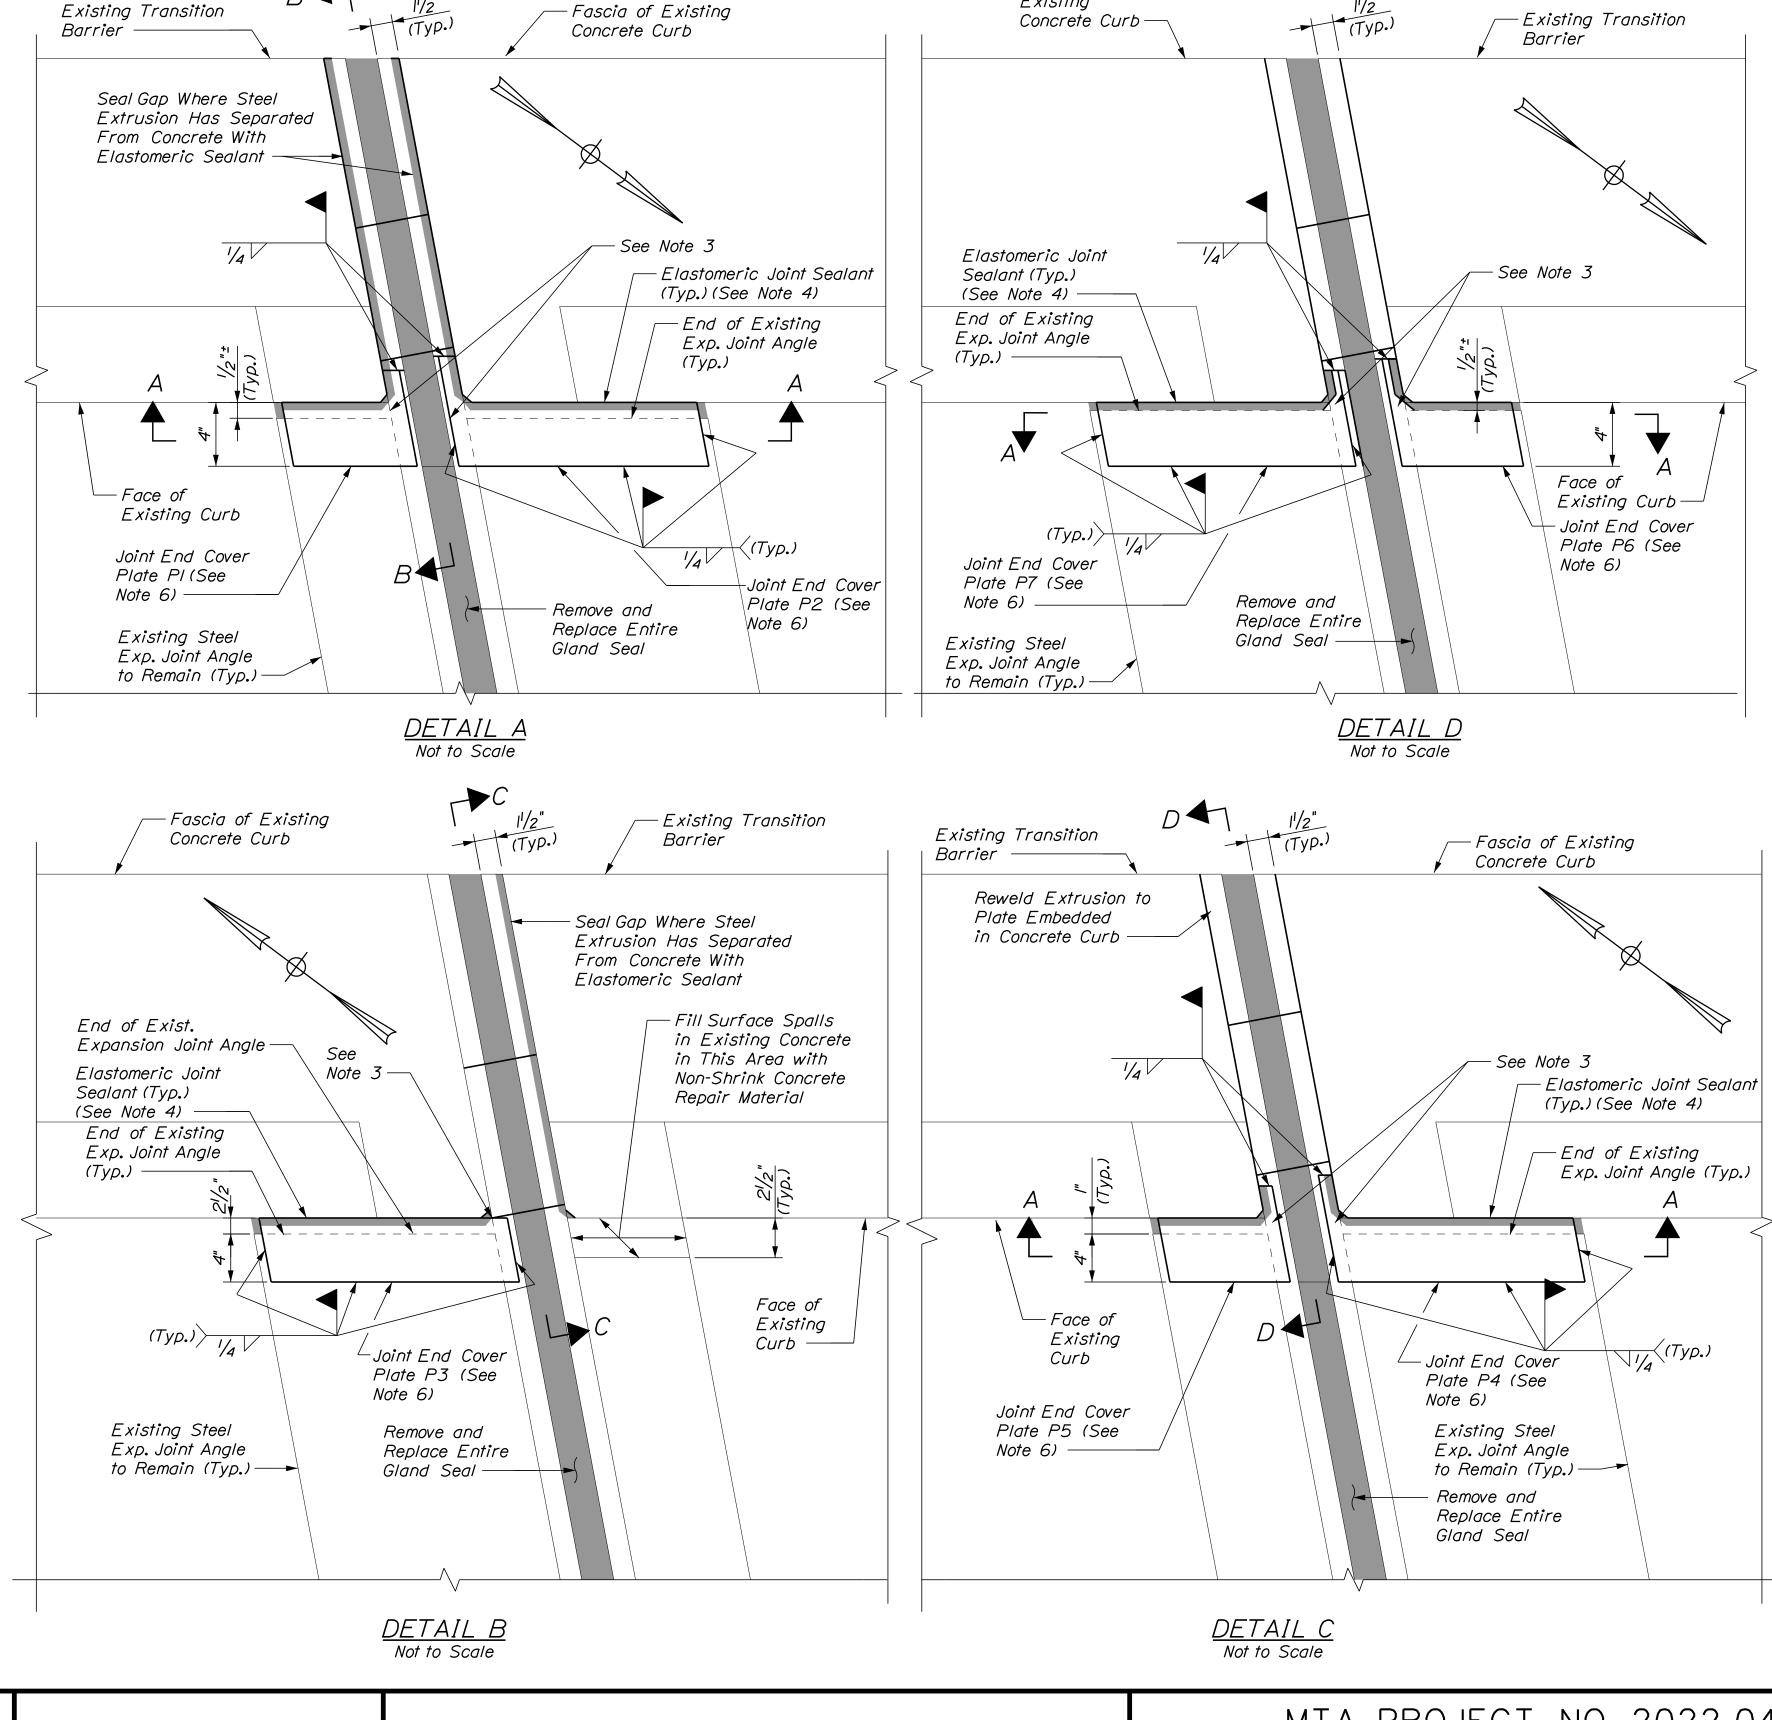

Fascia of

Existing

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Suite 105B
South Portland, ME 04106

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THE GOLD STAR MEMORIAL HIGHWAY


MTA PROJECT NO. 2022.04
WILSON ROAD UNDERPASS
AT MM 2.0 IN YORK, ME
BRIDGE JOINT MODIFICATIONS (1 OF 2)


VHB: 55345.00 SHEET NUMBER:

CONTRACT:2022.04

MTA PROJECT MANAGER: RALPH C. NORWOOD, IV

T NUMBER: **69 69** OF **117**

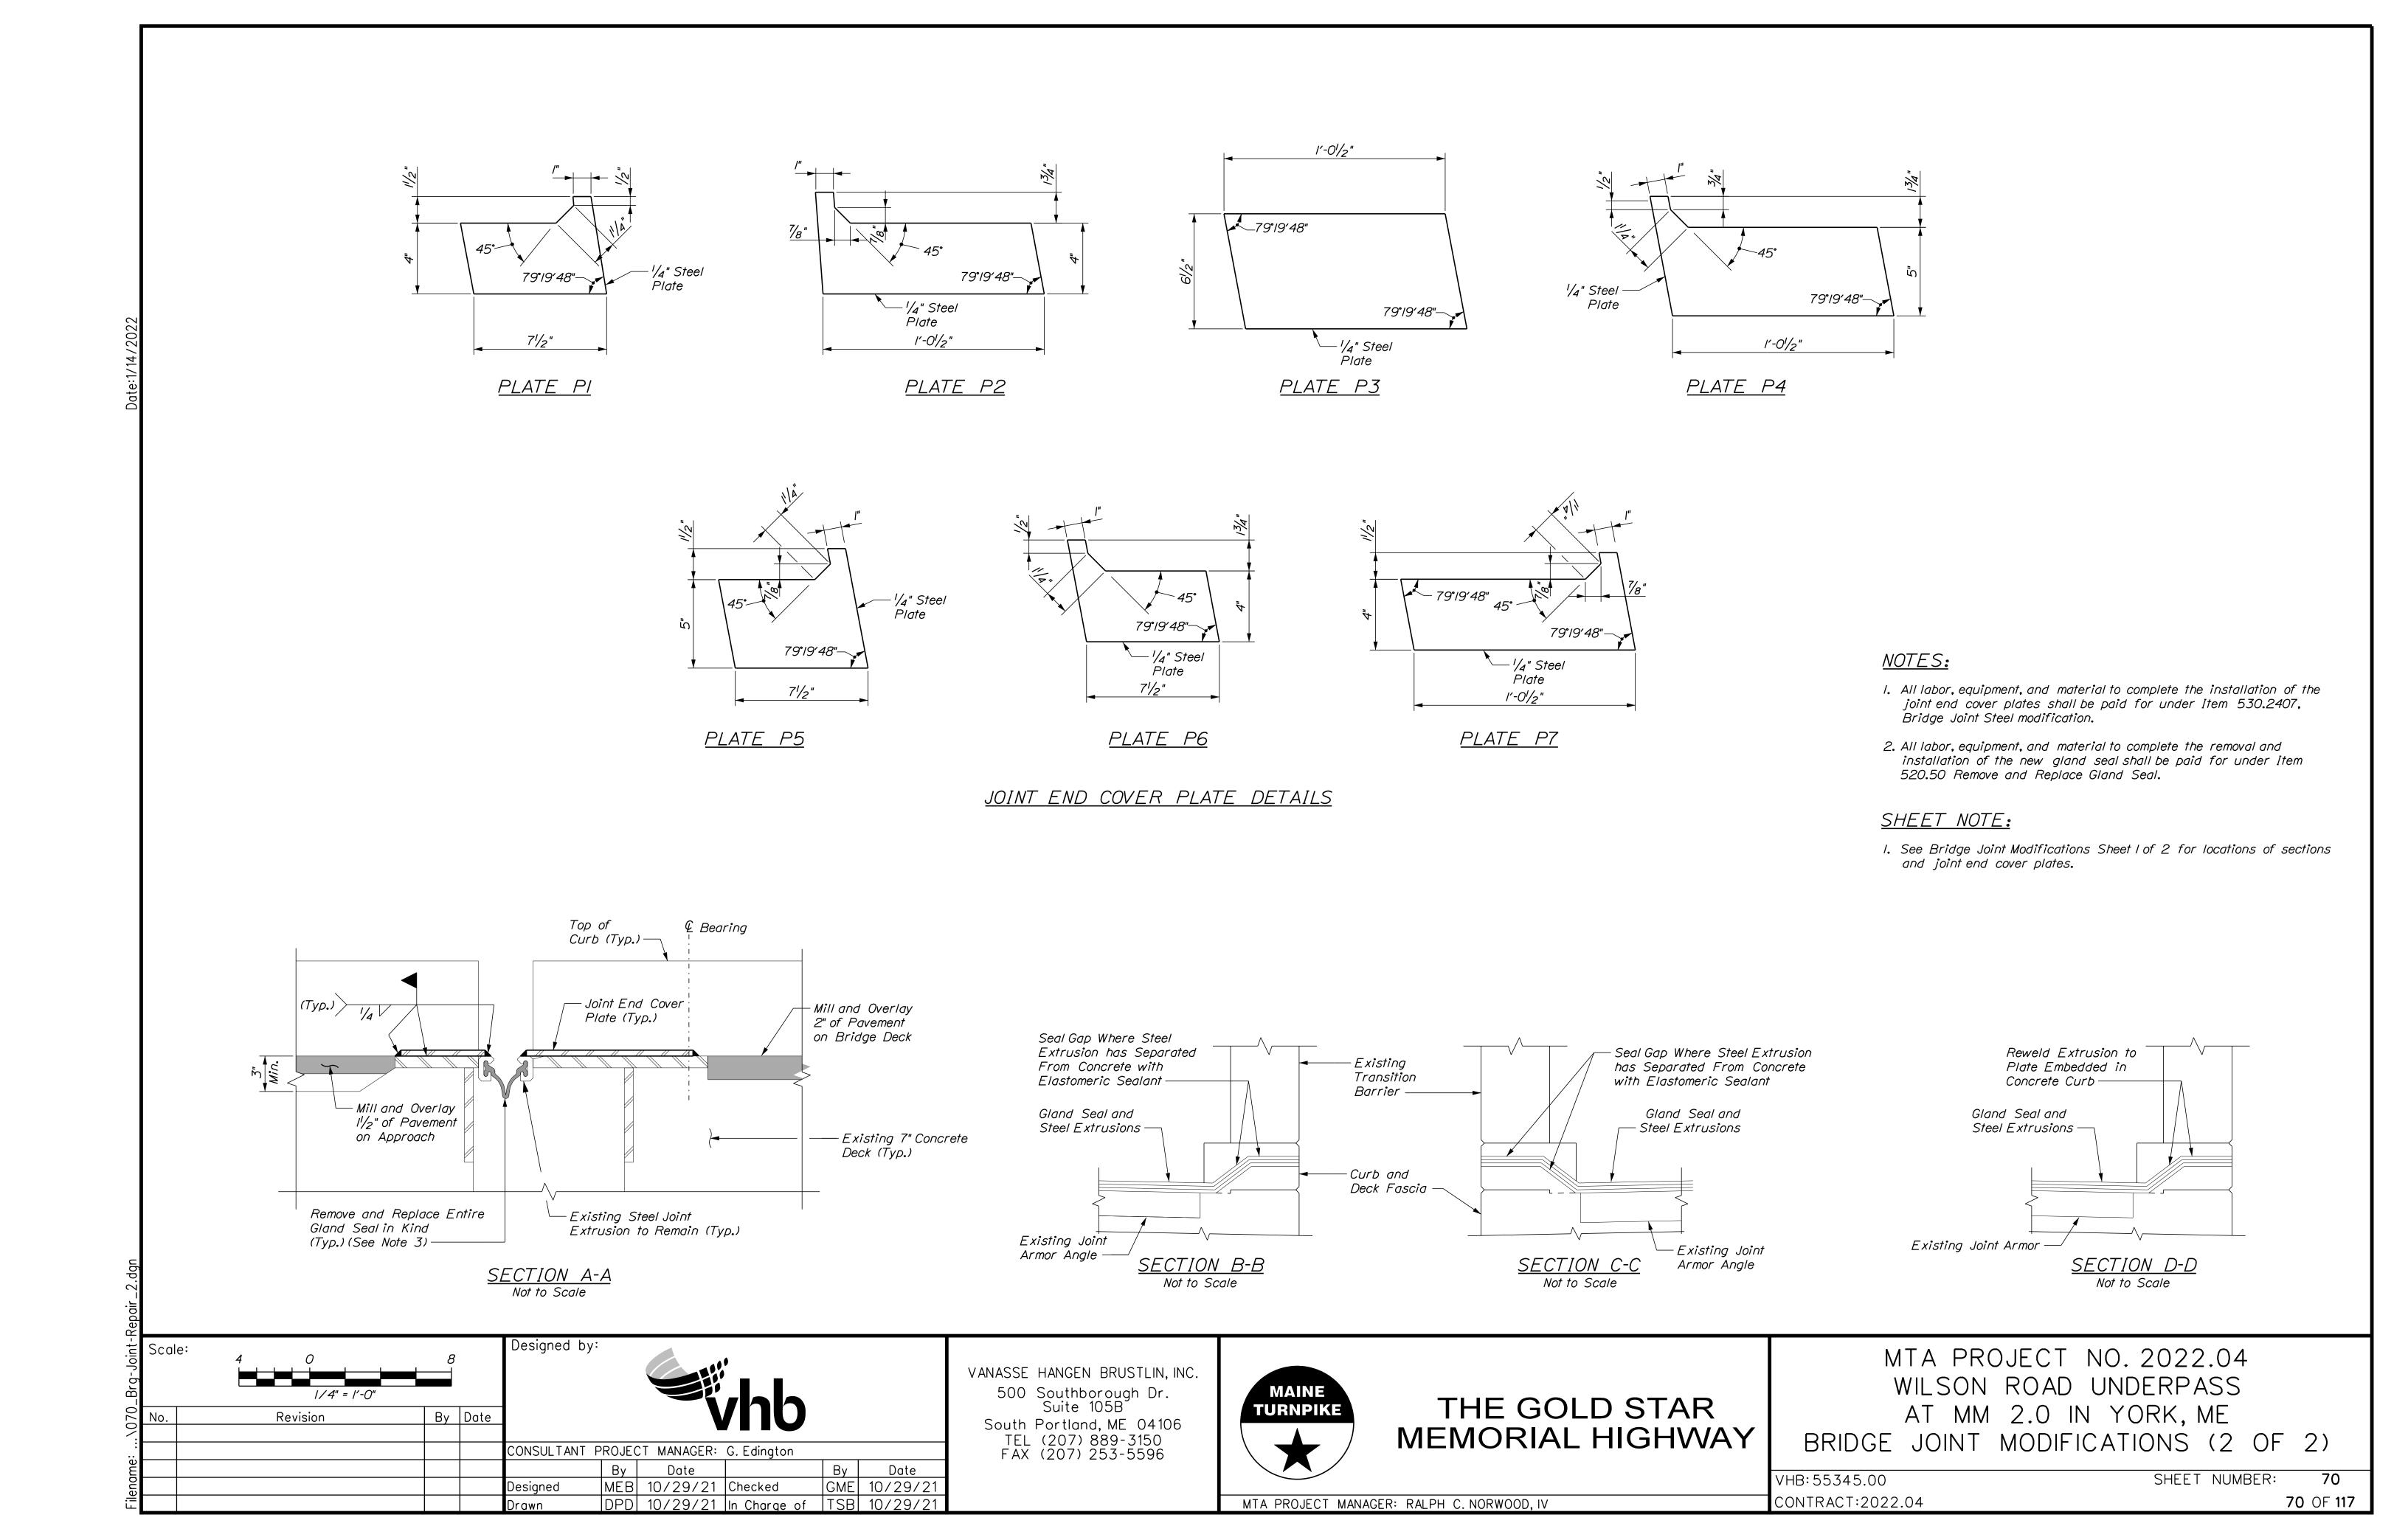

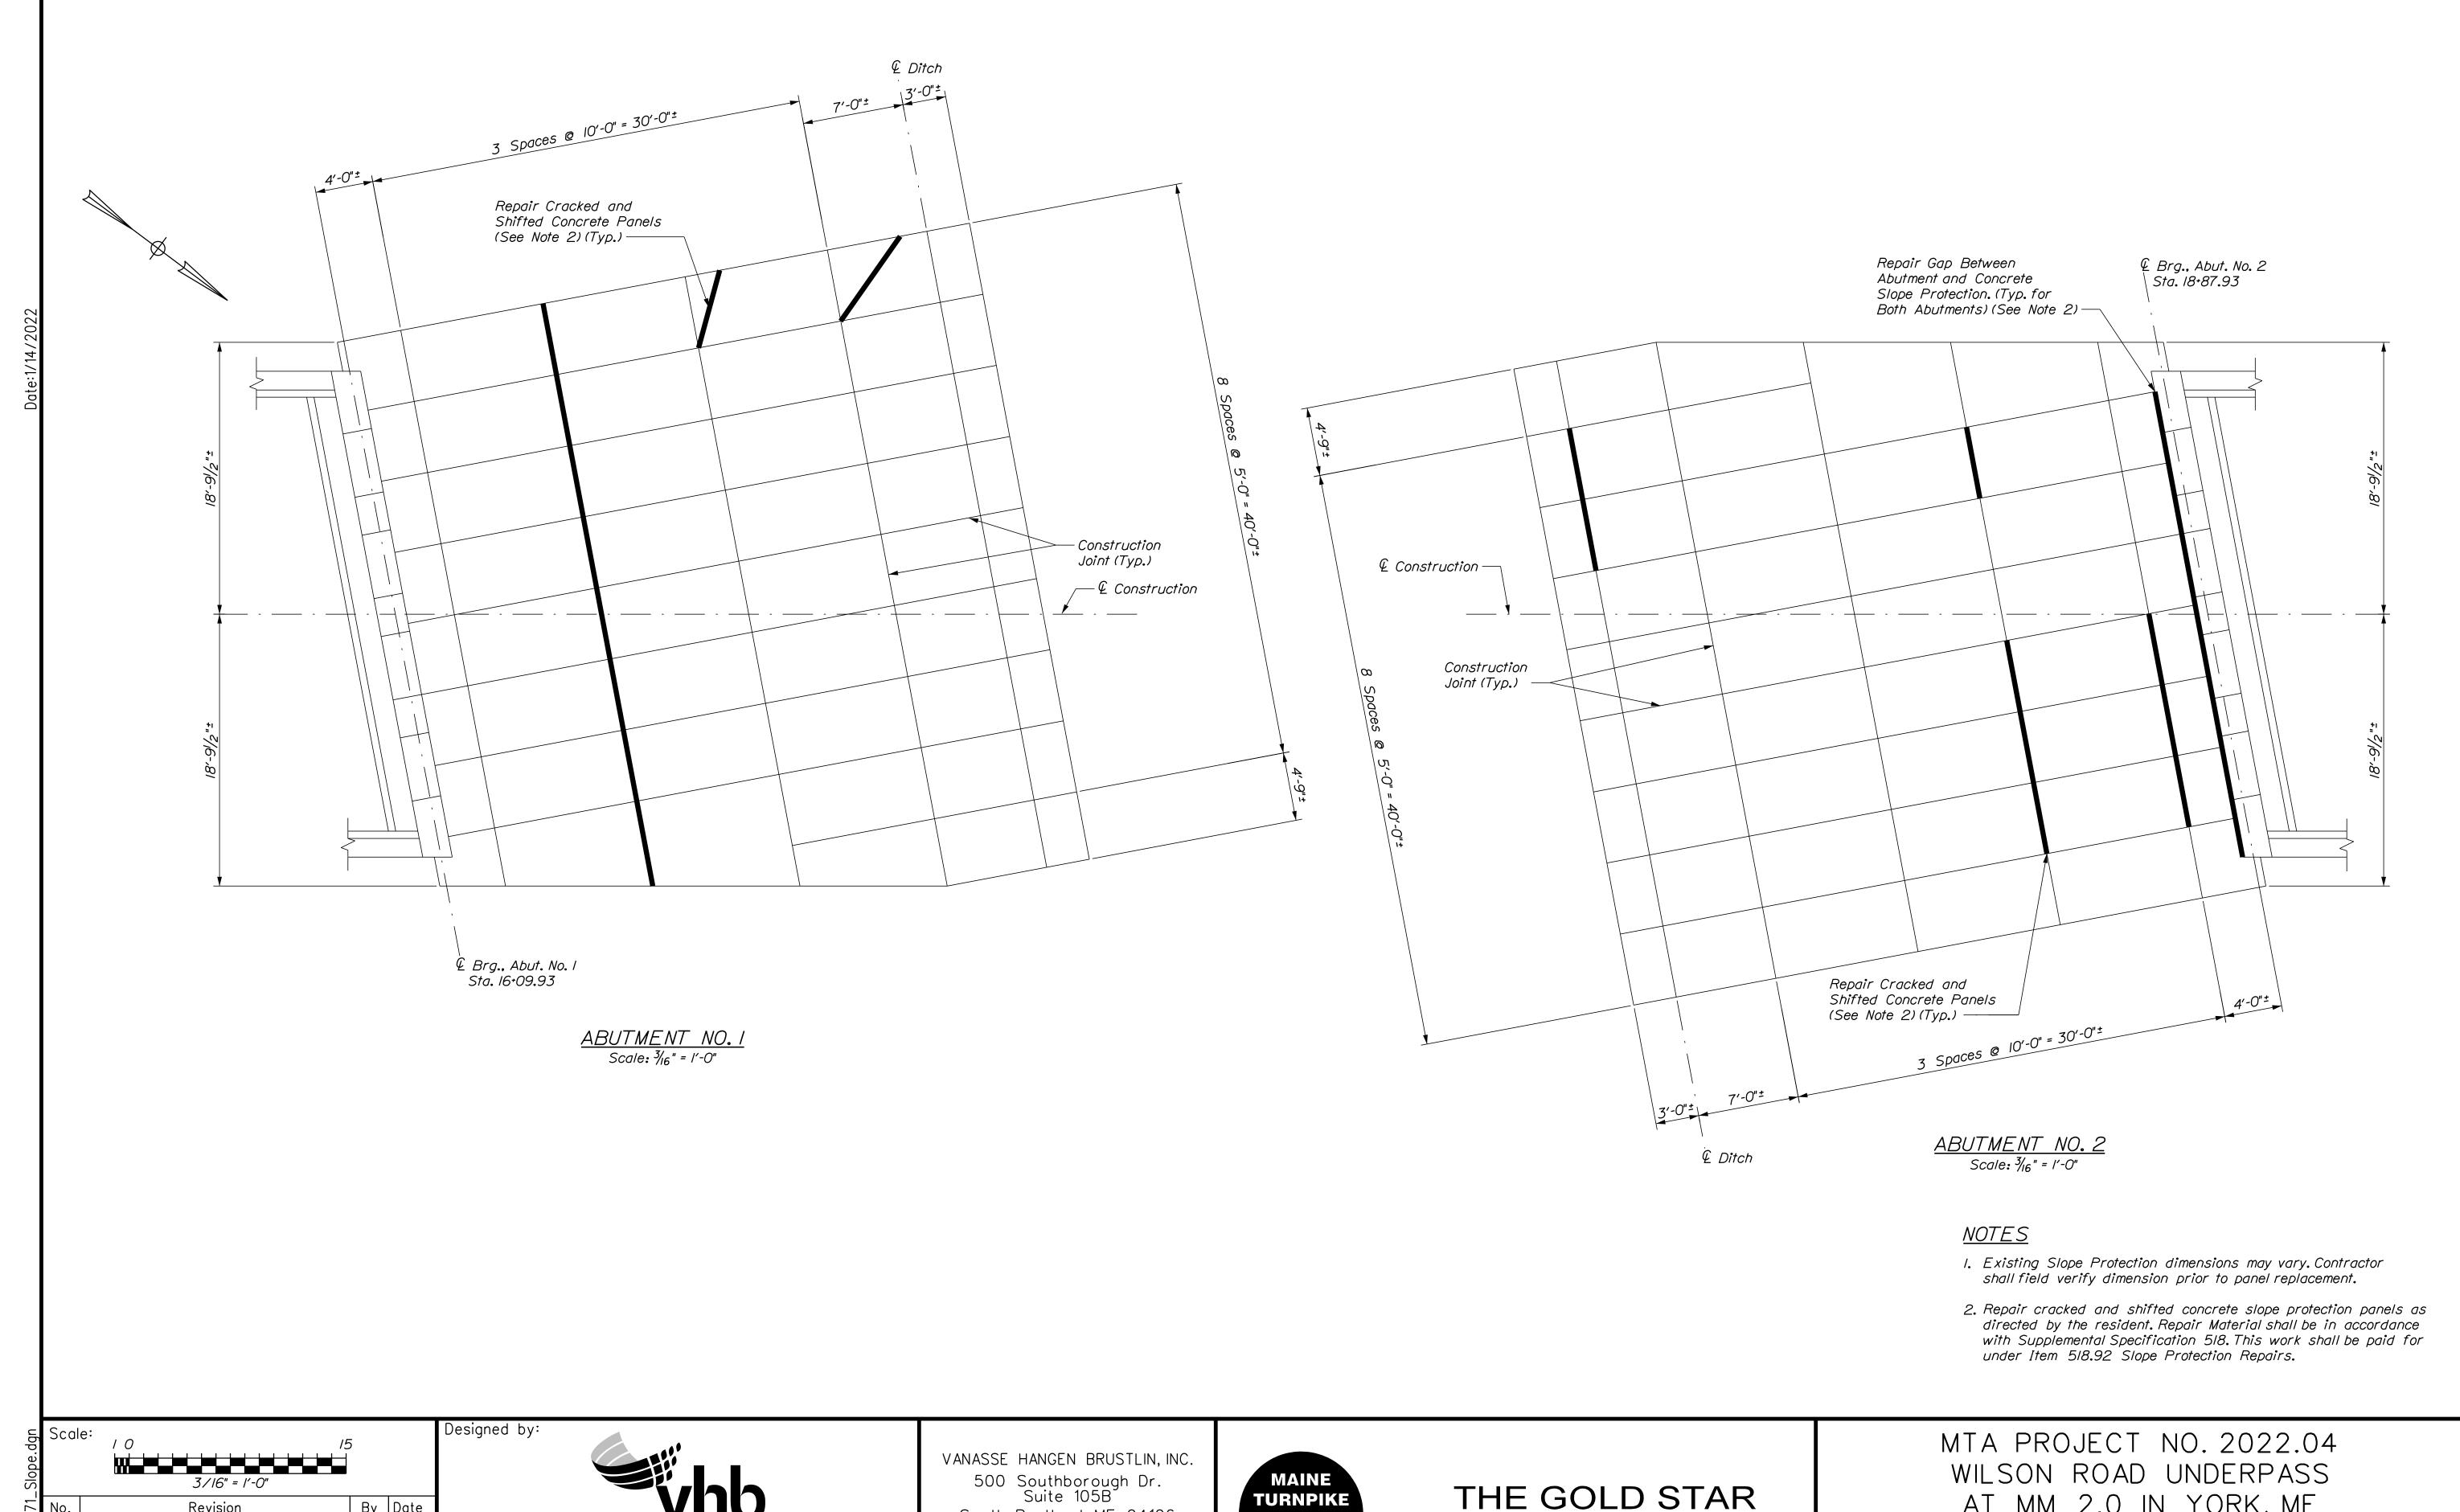

By Date Revision CONSULTANT PROJECT MANAGER: G. Edington By Date MEB 10/29/21 Checked GME 10/29/21 Designed DPD 10/29/21 In Charge of TSB 10/29/21

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MEMORIAL HIGHWAY


AT MM 2.0 IN YORK, ME SLOPE PROTECTION REPAIRS


VHB: 55345.00


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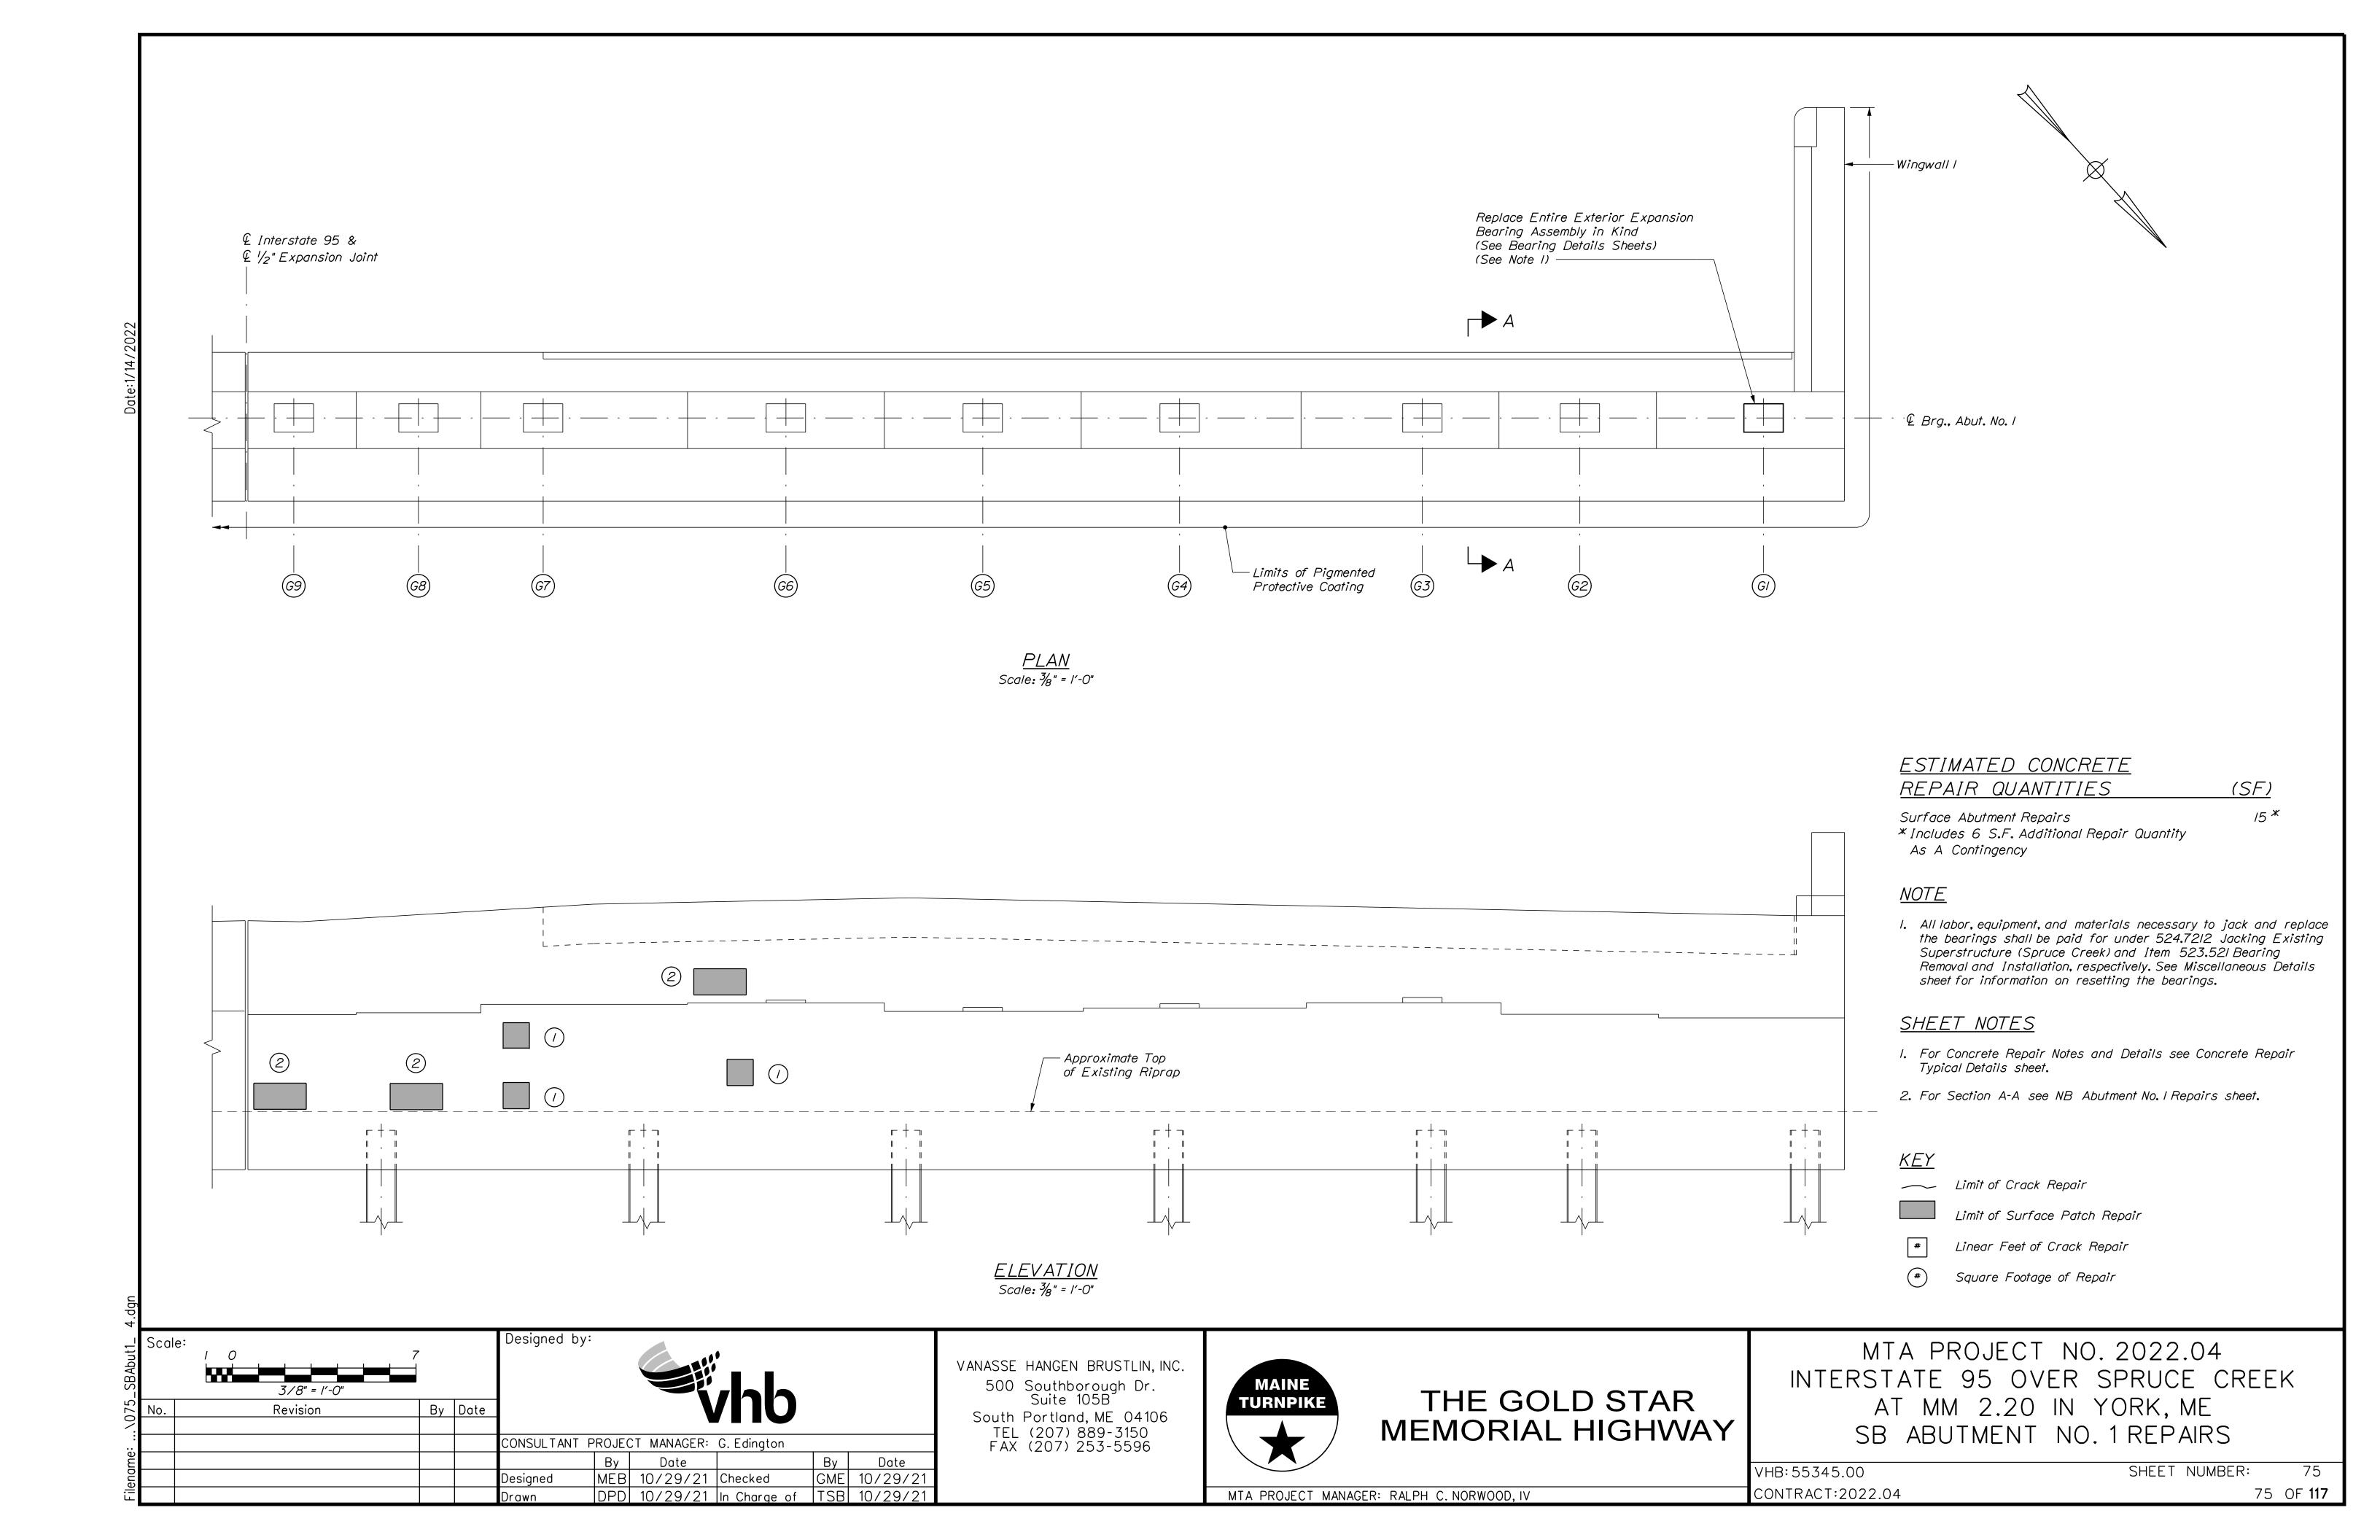
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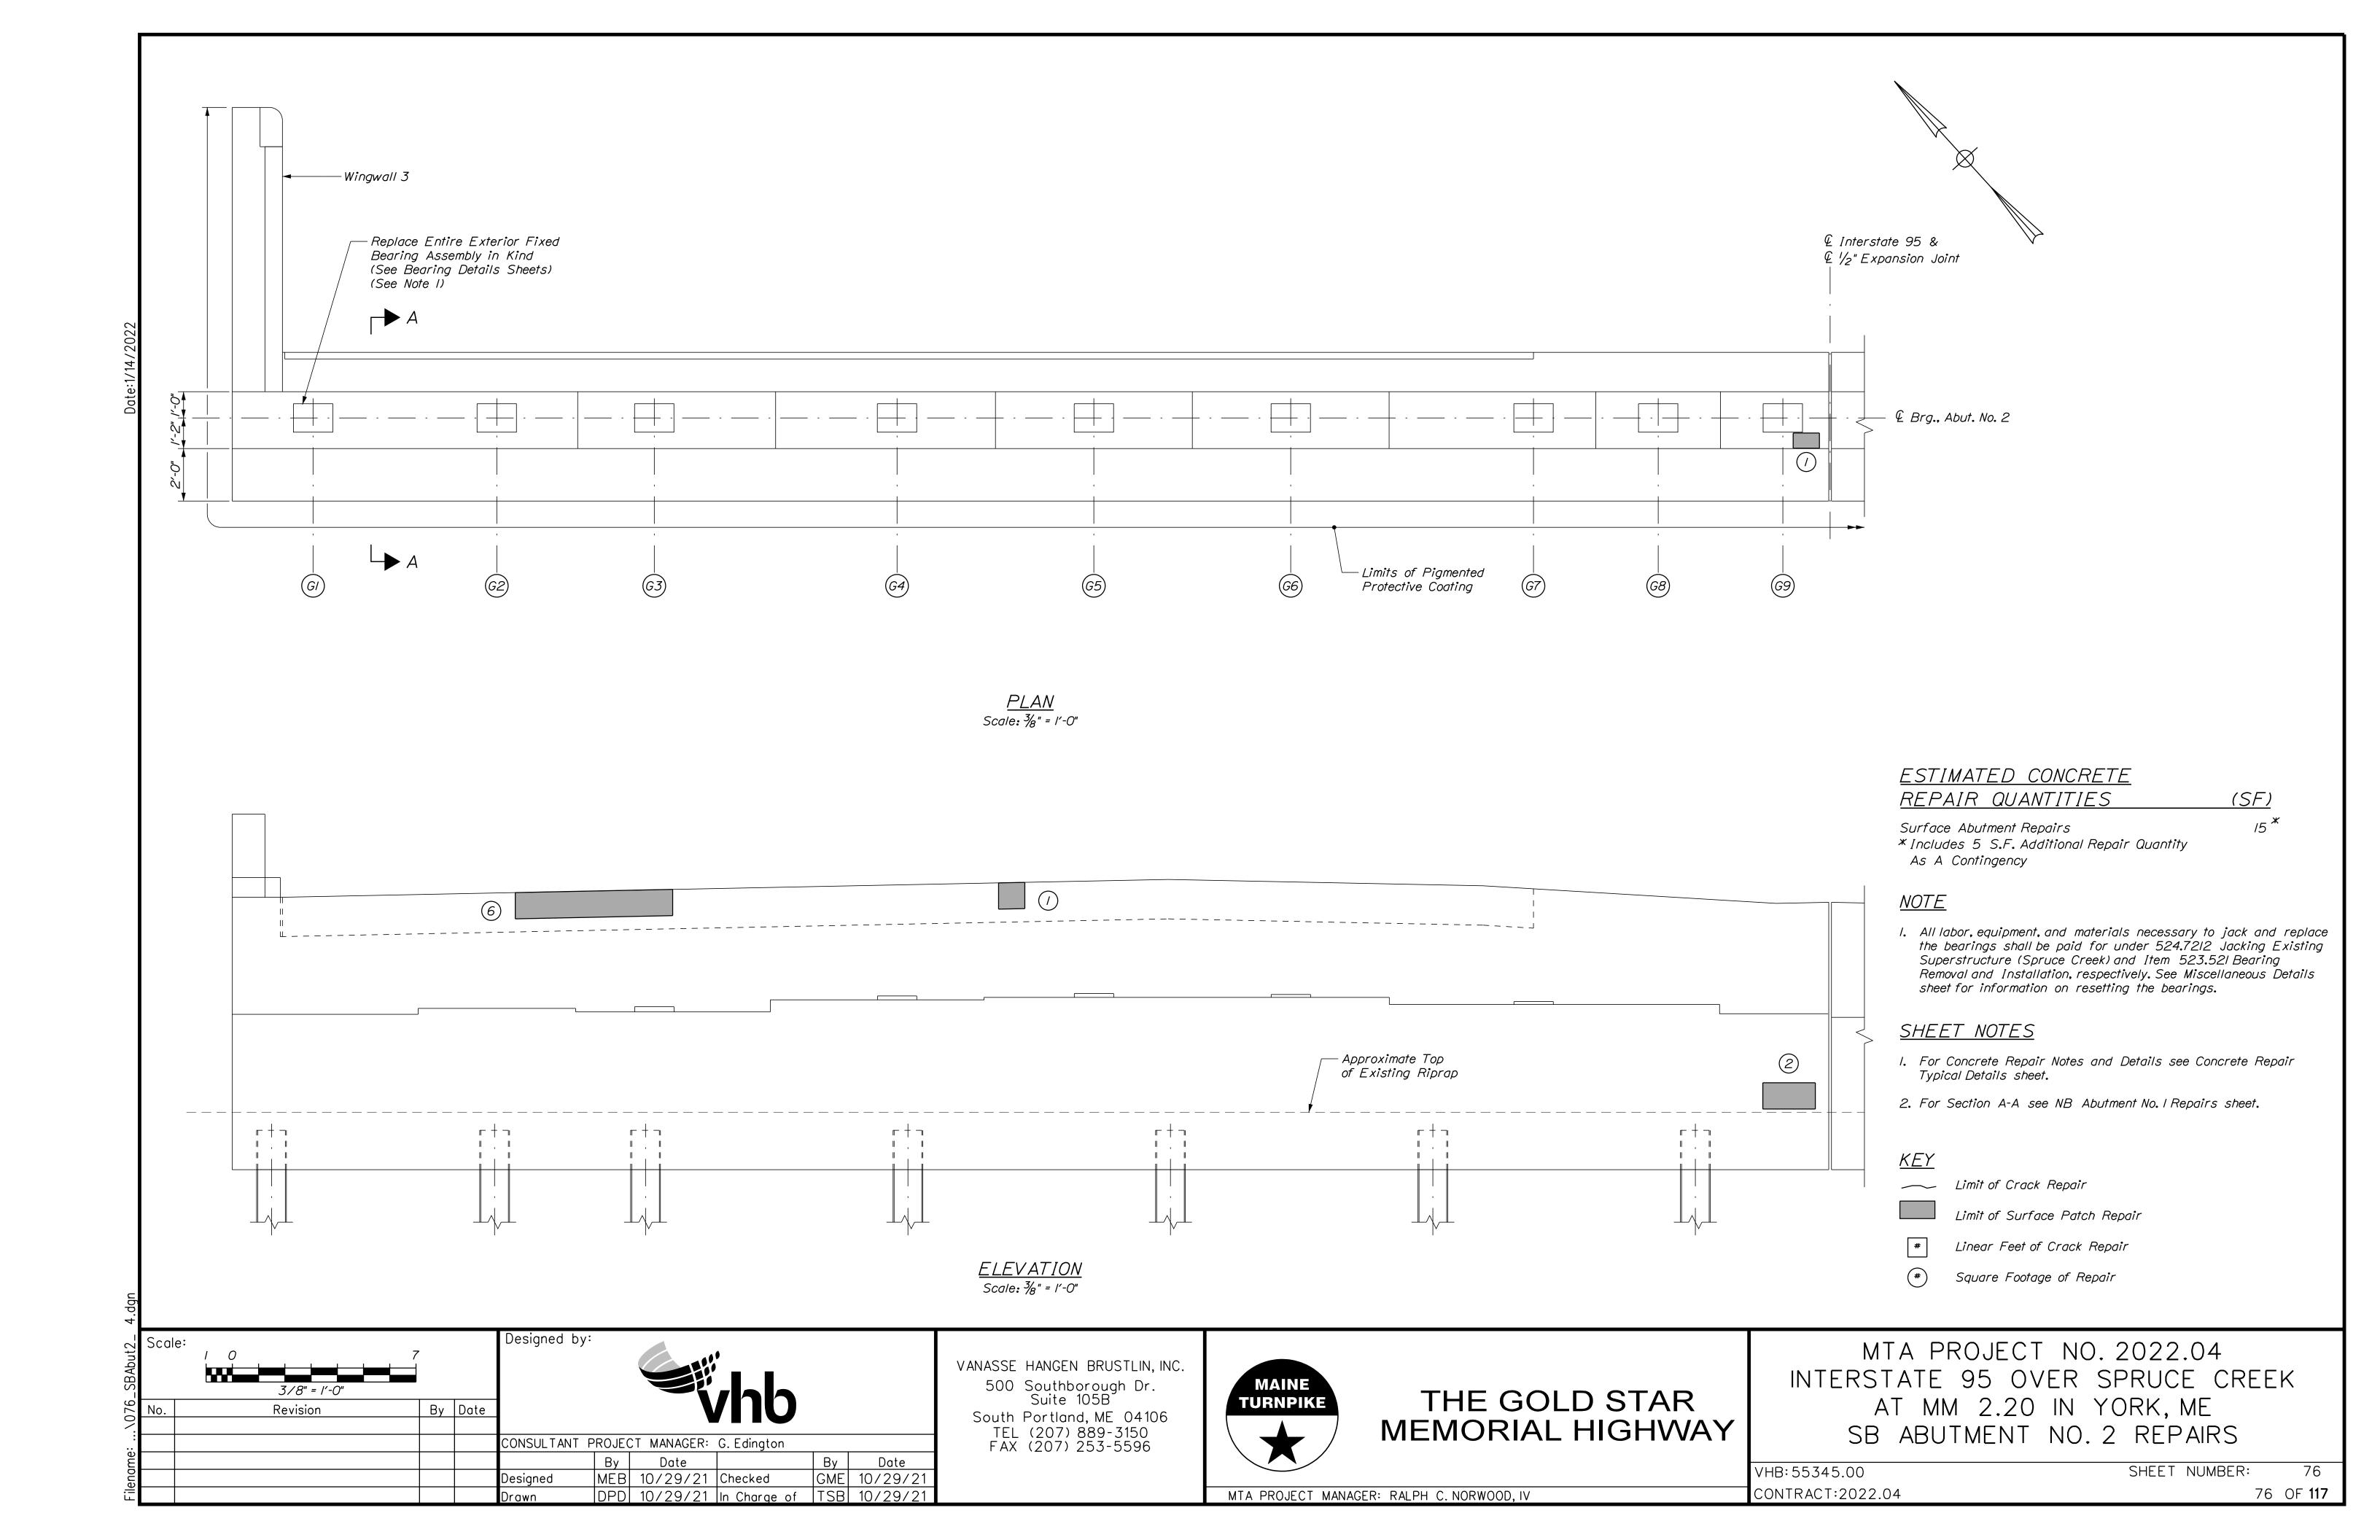
CONTRACT:2022.04 **71** OF **117**







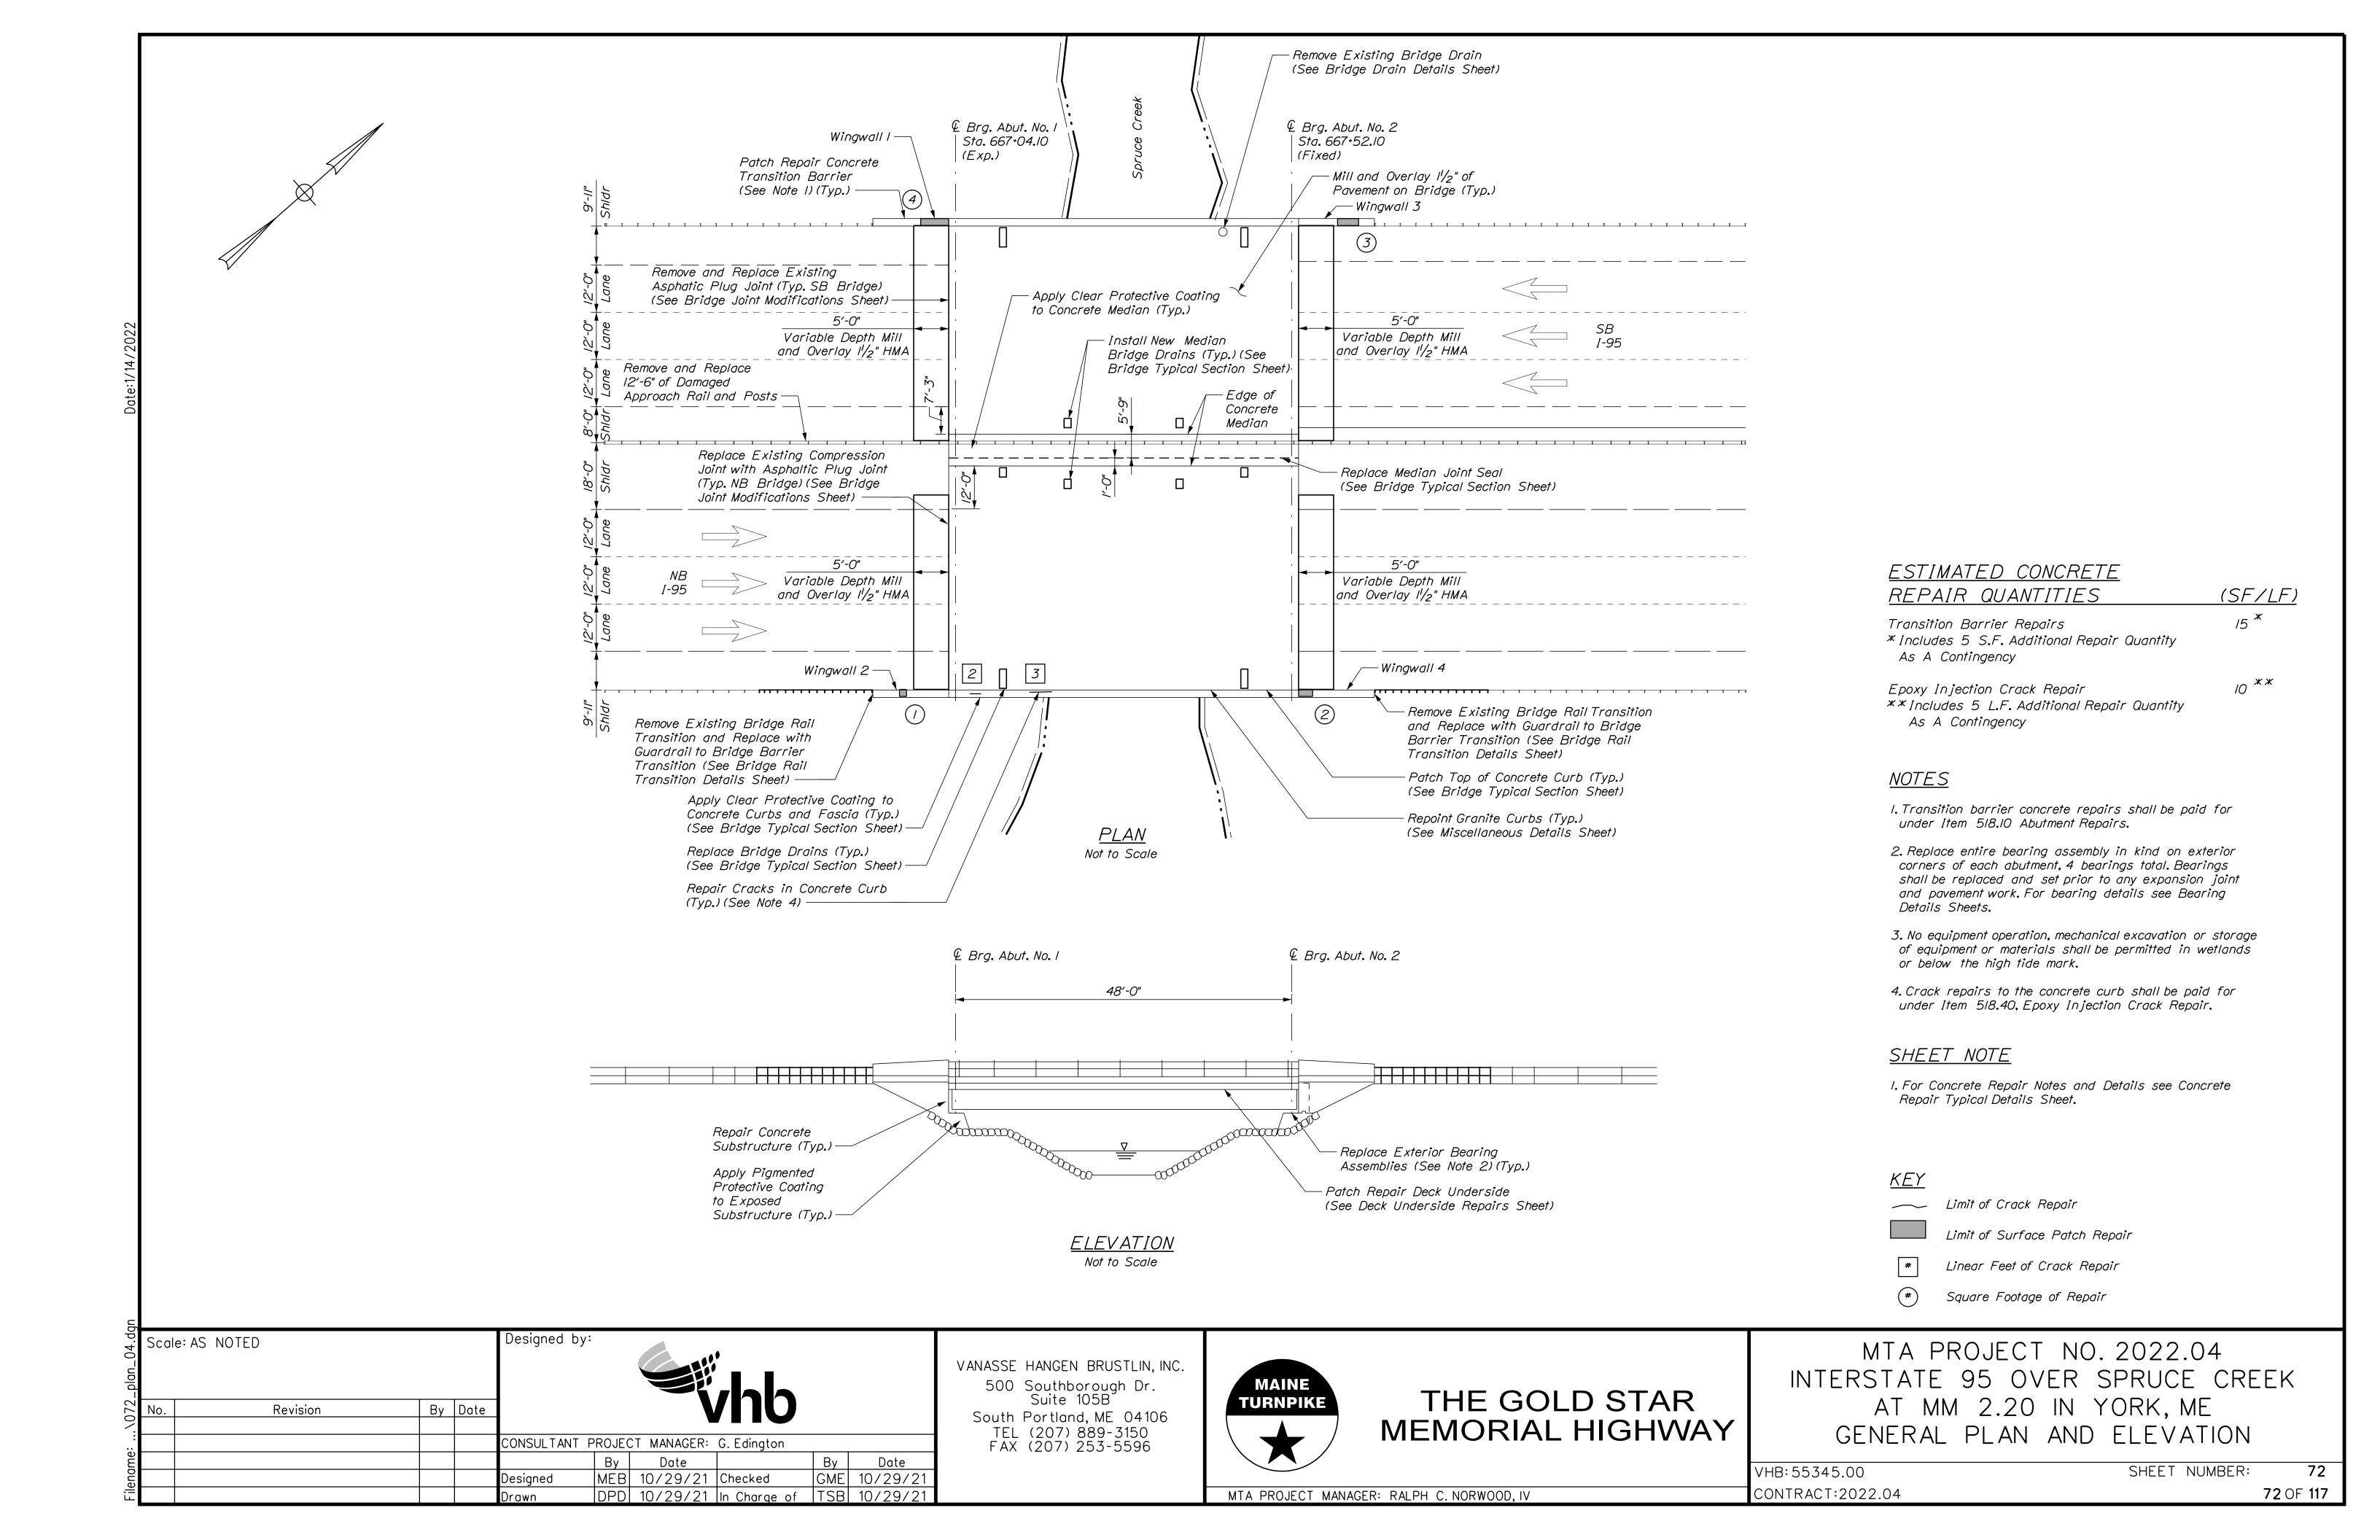

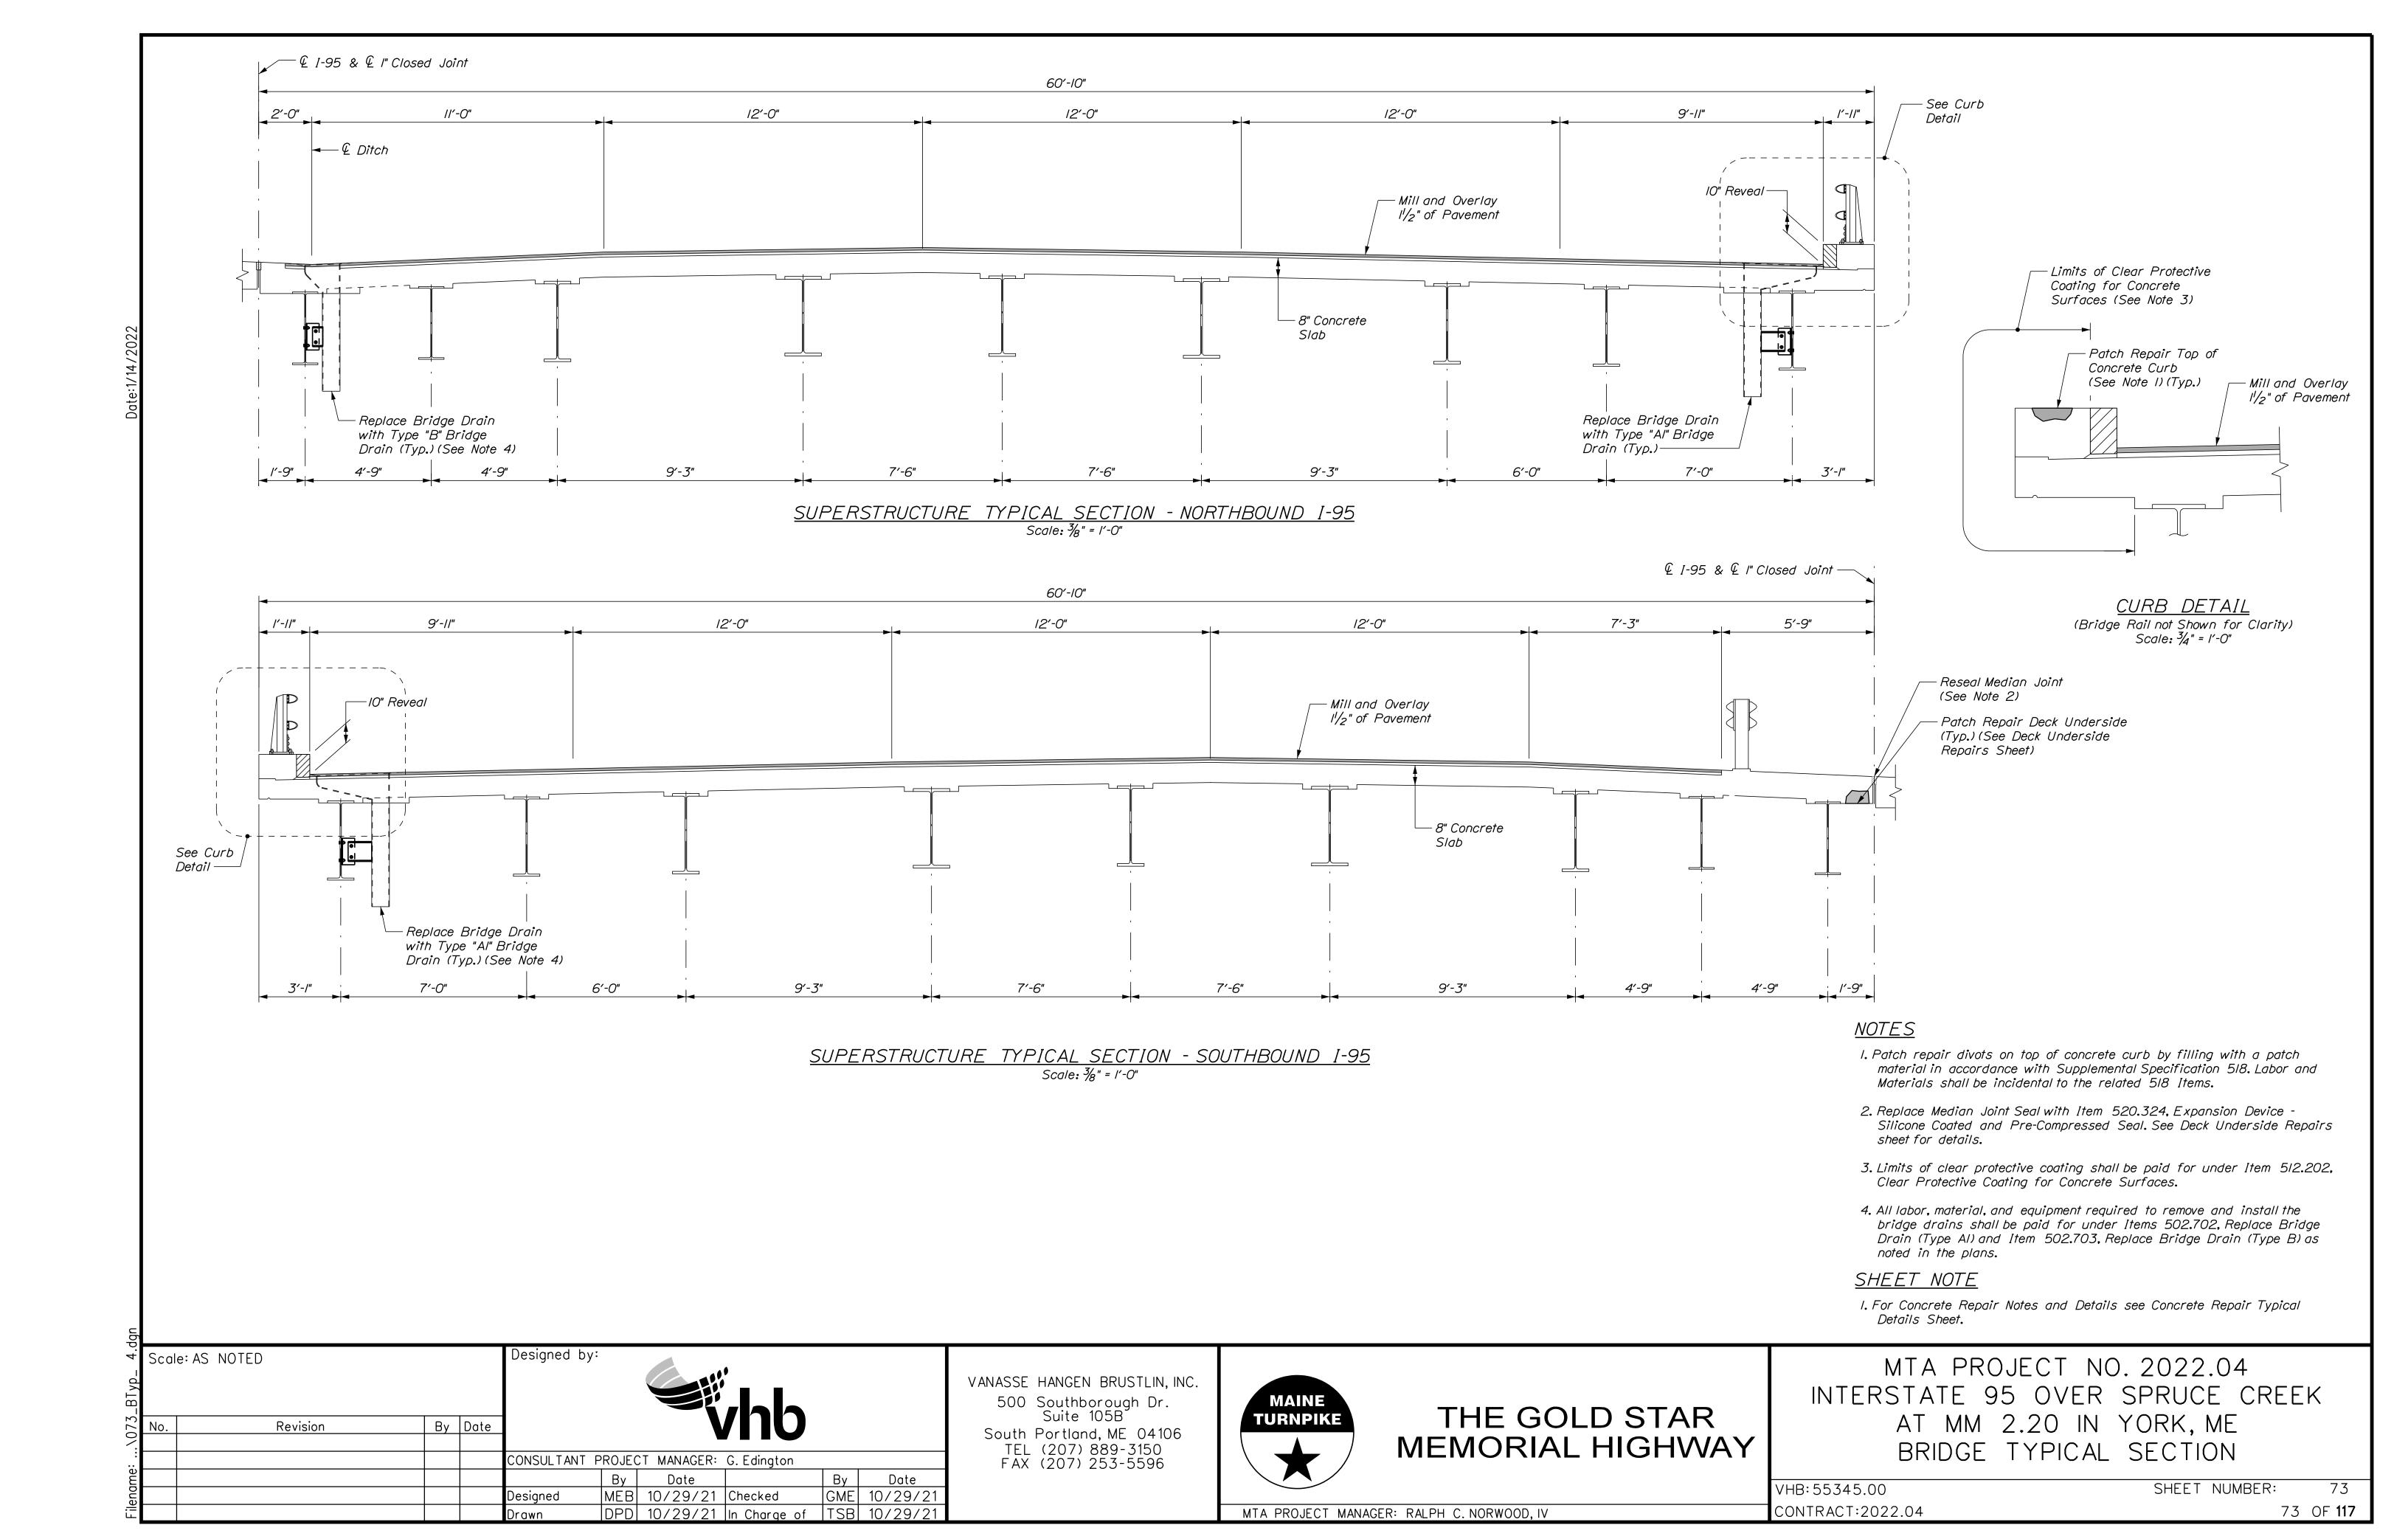


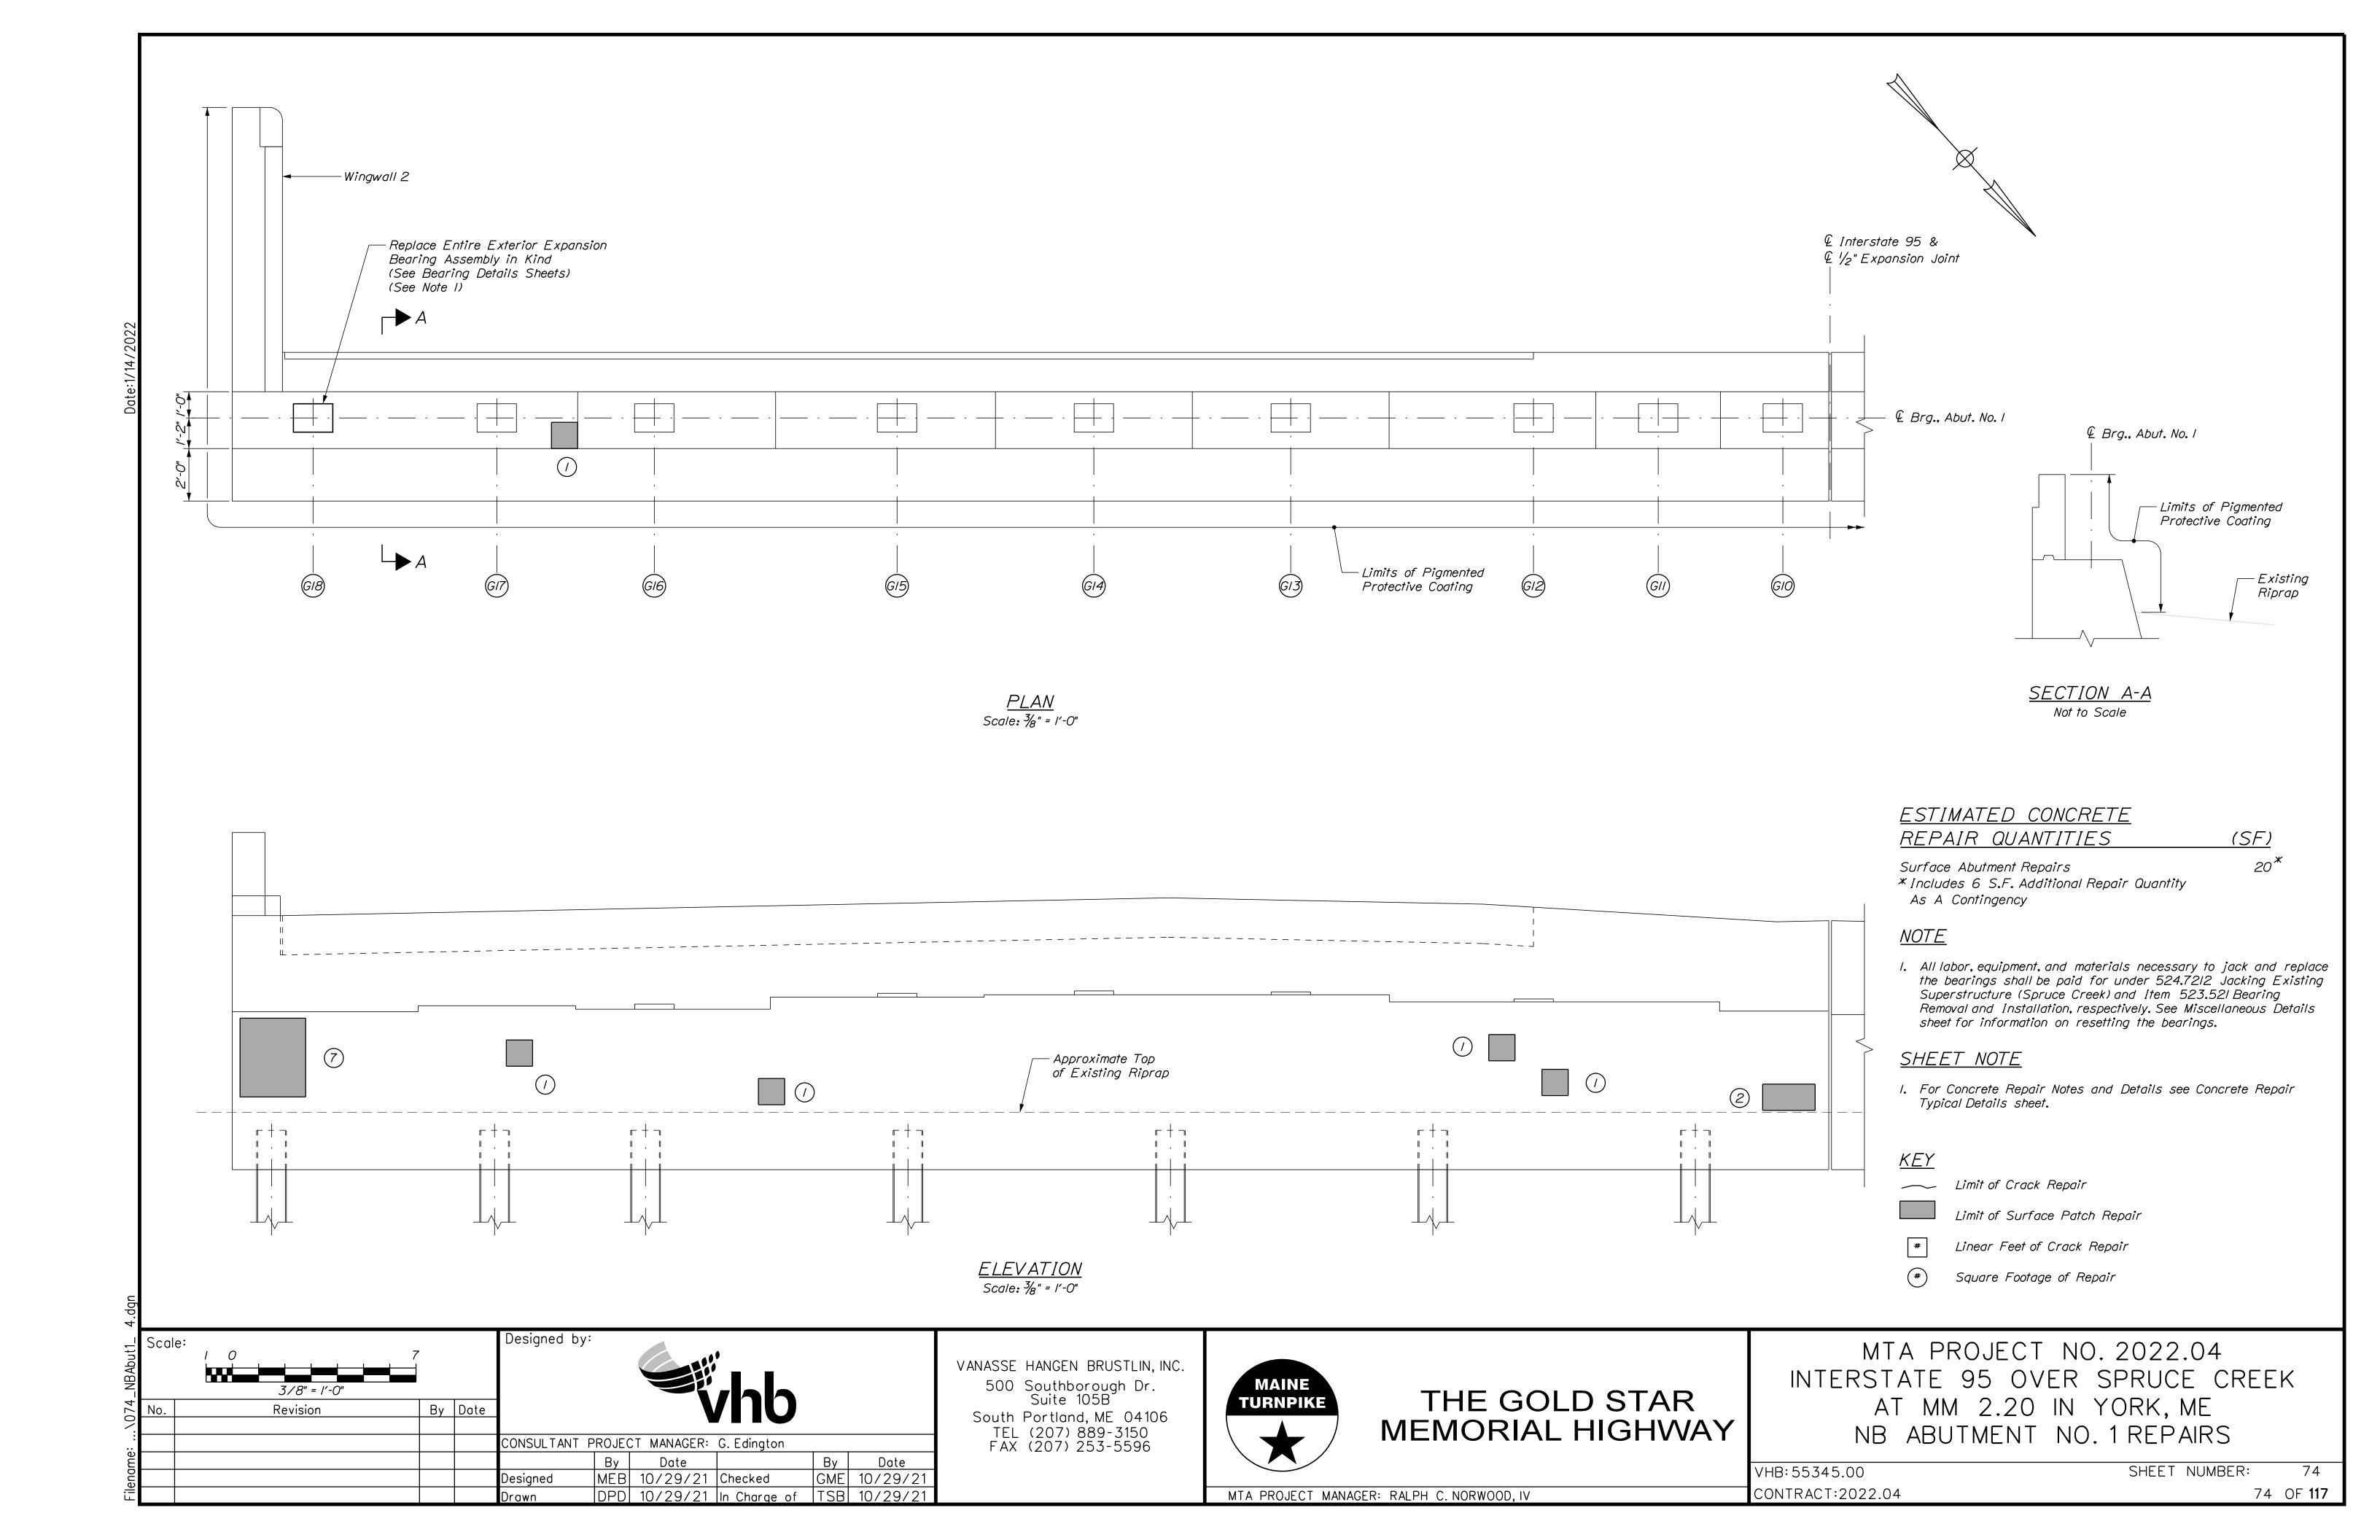

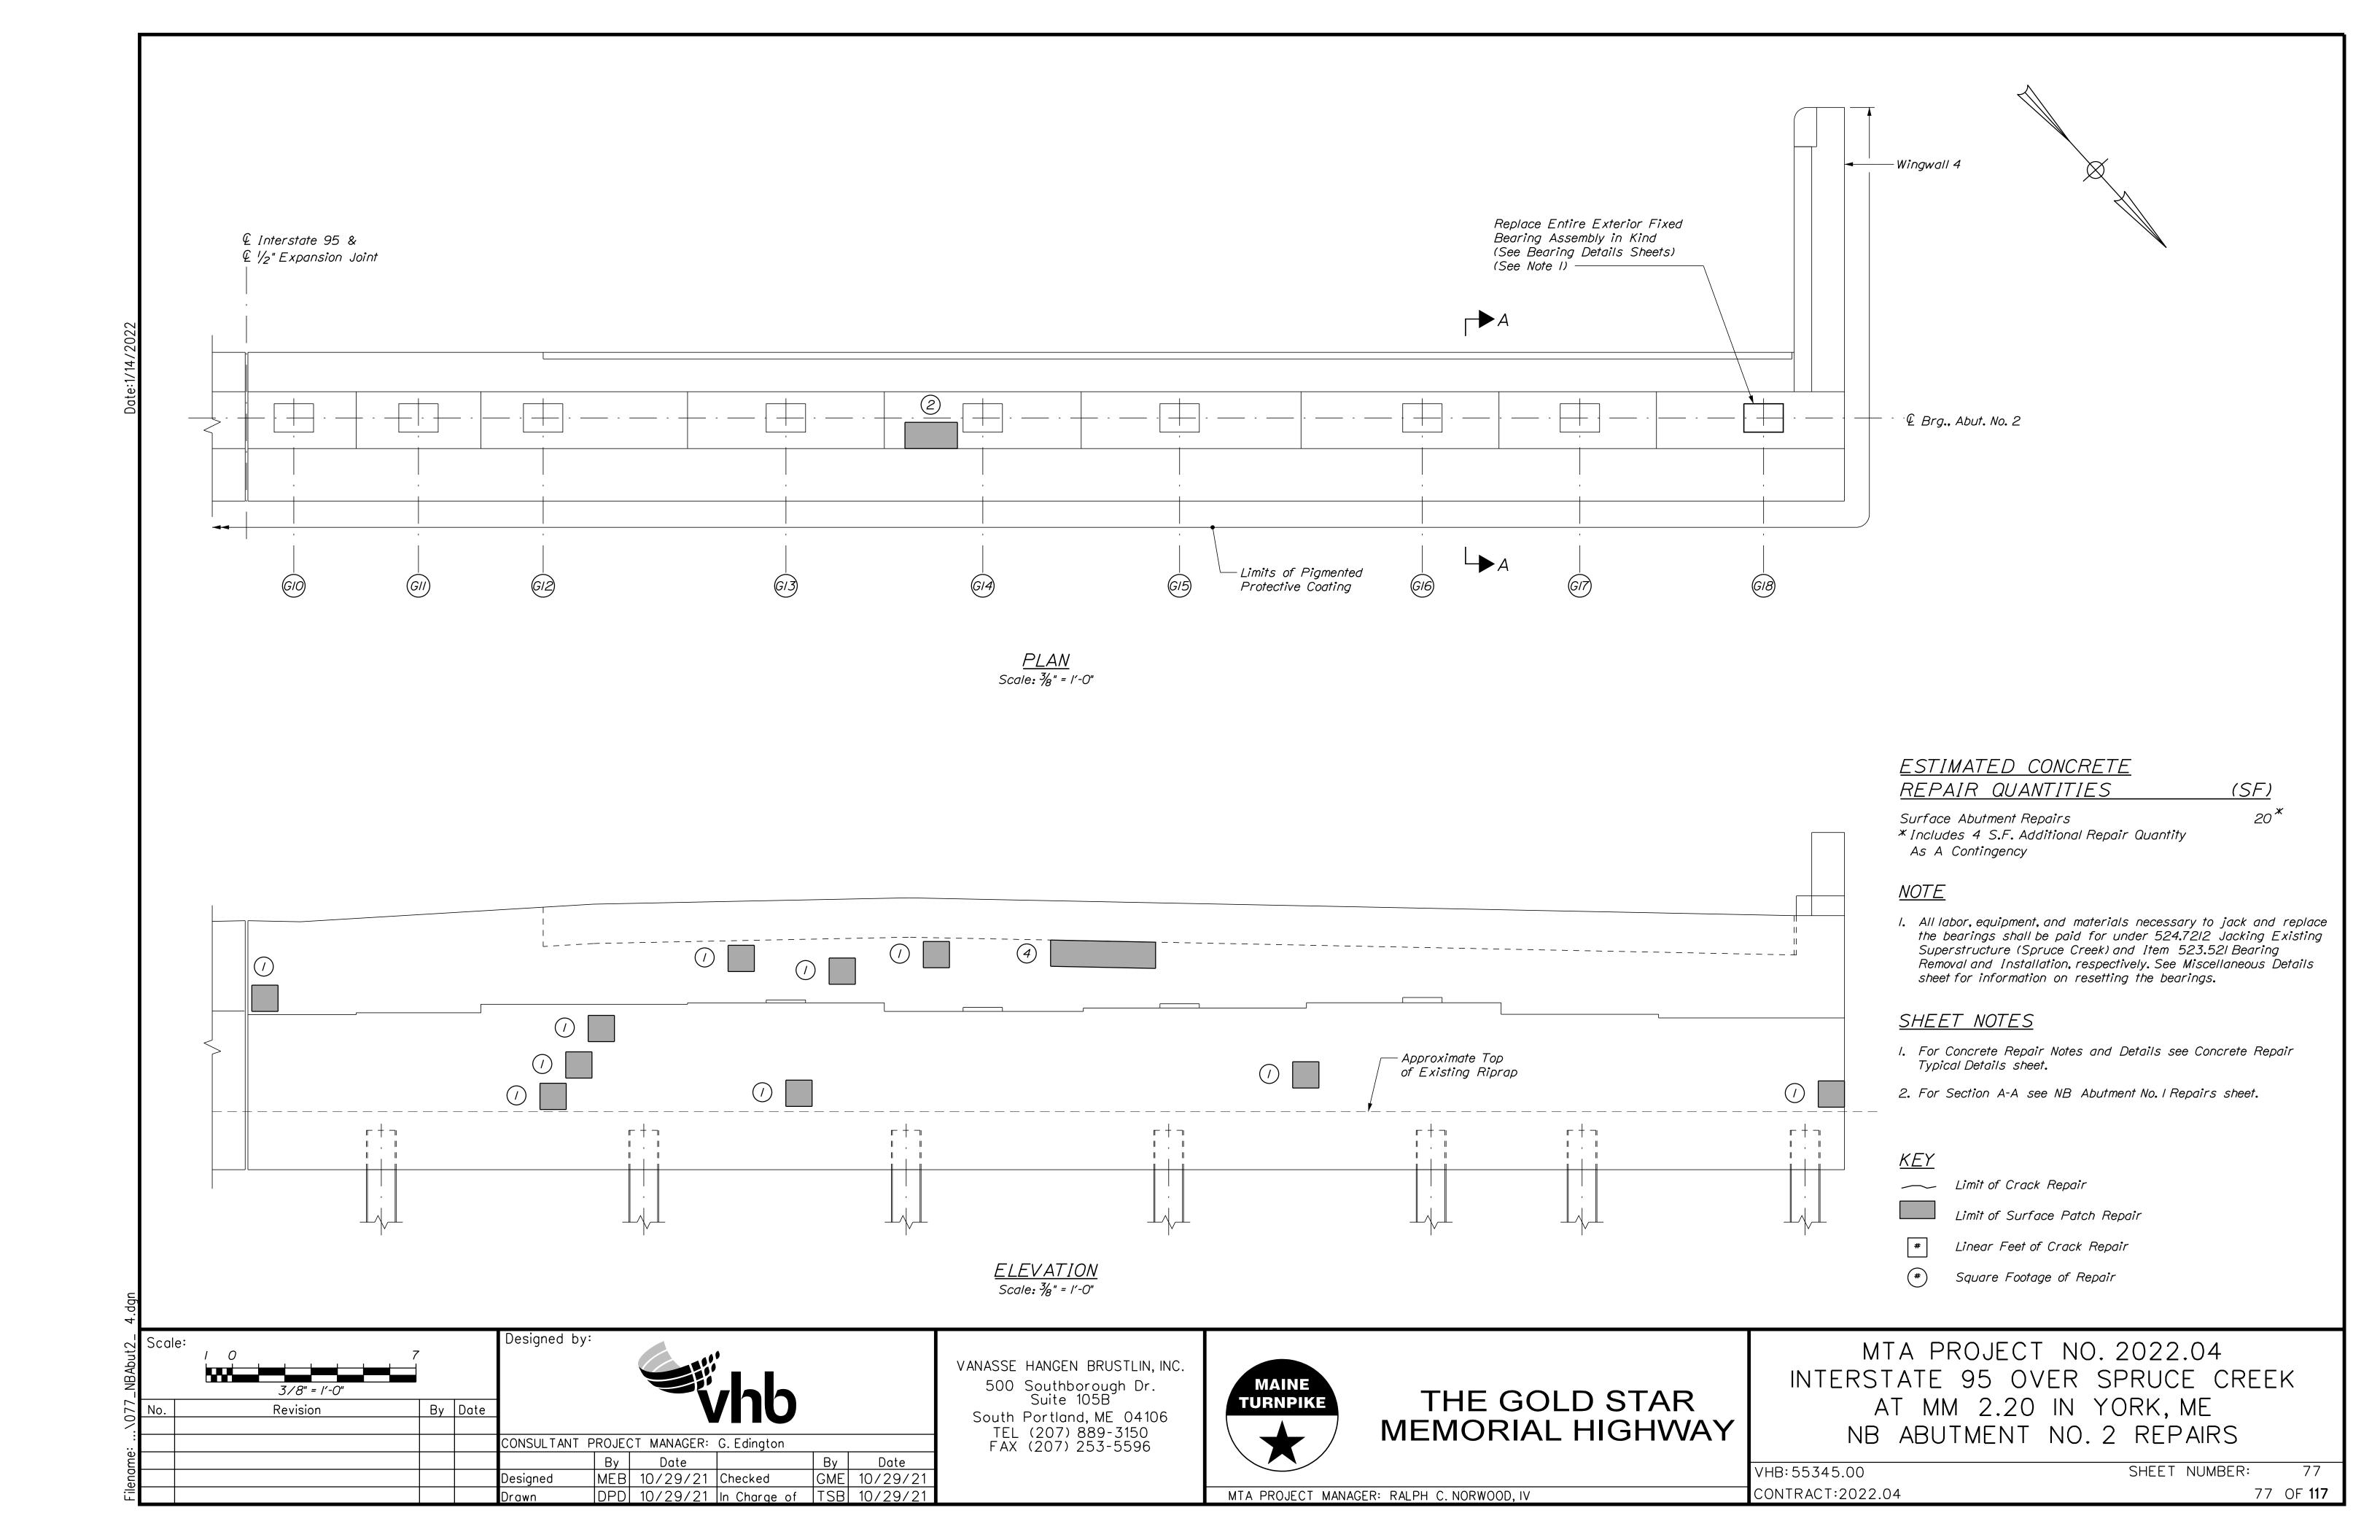

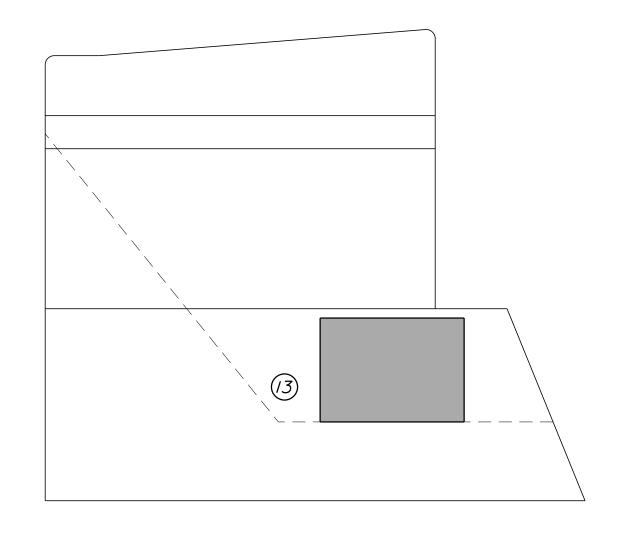


WINGWALL 2 (SOUTHEAST)

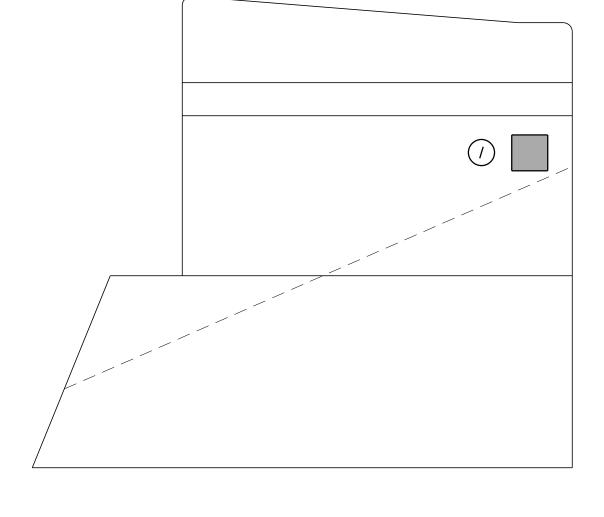

<u>ABUTMENT NO. 1</u> WINGWALL ELEVATIONS

Scale: 3/8" = 1'-0" WINGWALL / (SOUTHWEST)

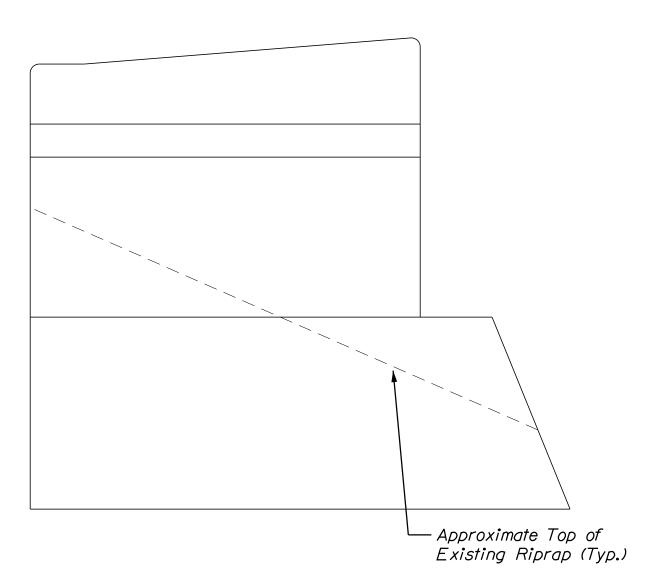

<u>ABUTMENT NO. 2</u>

3

WINGWALL 4 (NORTHEAST)

WINGWALL 3 (NORTHWEST)

WINGWALL ELEVATIONS Scale: 3/8" = 1'-0"

<u>SHEET NOTE</u>

As A Contingency

As A Contingency

I. For Crack and Concrete Repair Notes and Details see Concrete Repair Typical Details Sheet.

(SF/LF)

20 *****

5^{**}

78

<u> KEY</u>

____ Limit of Crack Repair

Limit of Surface Patch Repair

ESTIMATED CONCRETE

* Includes 6 S.F. Additional Repair Quantity

Epoxy Injection Crack Repair

** Includes 2 L.F. Additional Repair Quantity

REPAIR QUANTITIES


Surface Abutment Repairs

Linear Feet of Crack Repair

Square Footage of Repair

WW 4.dgn	Scale	: 1 0 3/8" = 1'-0"	7		Designed by	<i>/</i> :				
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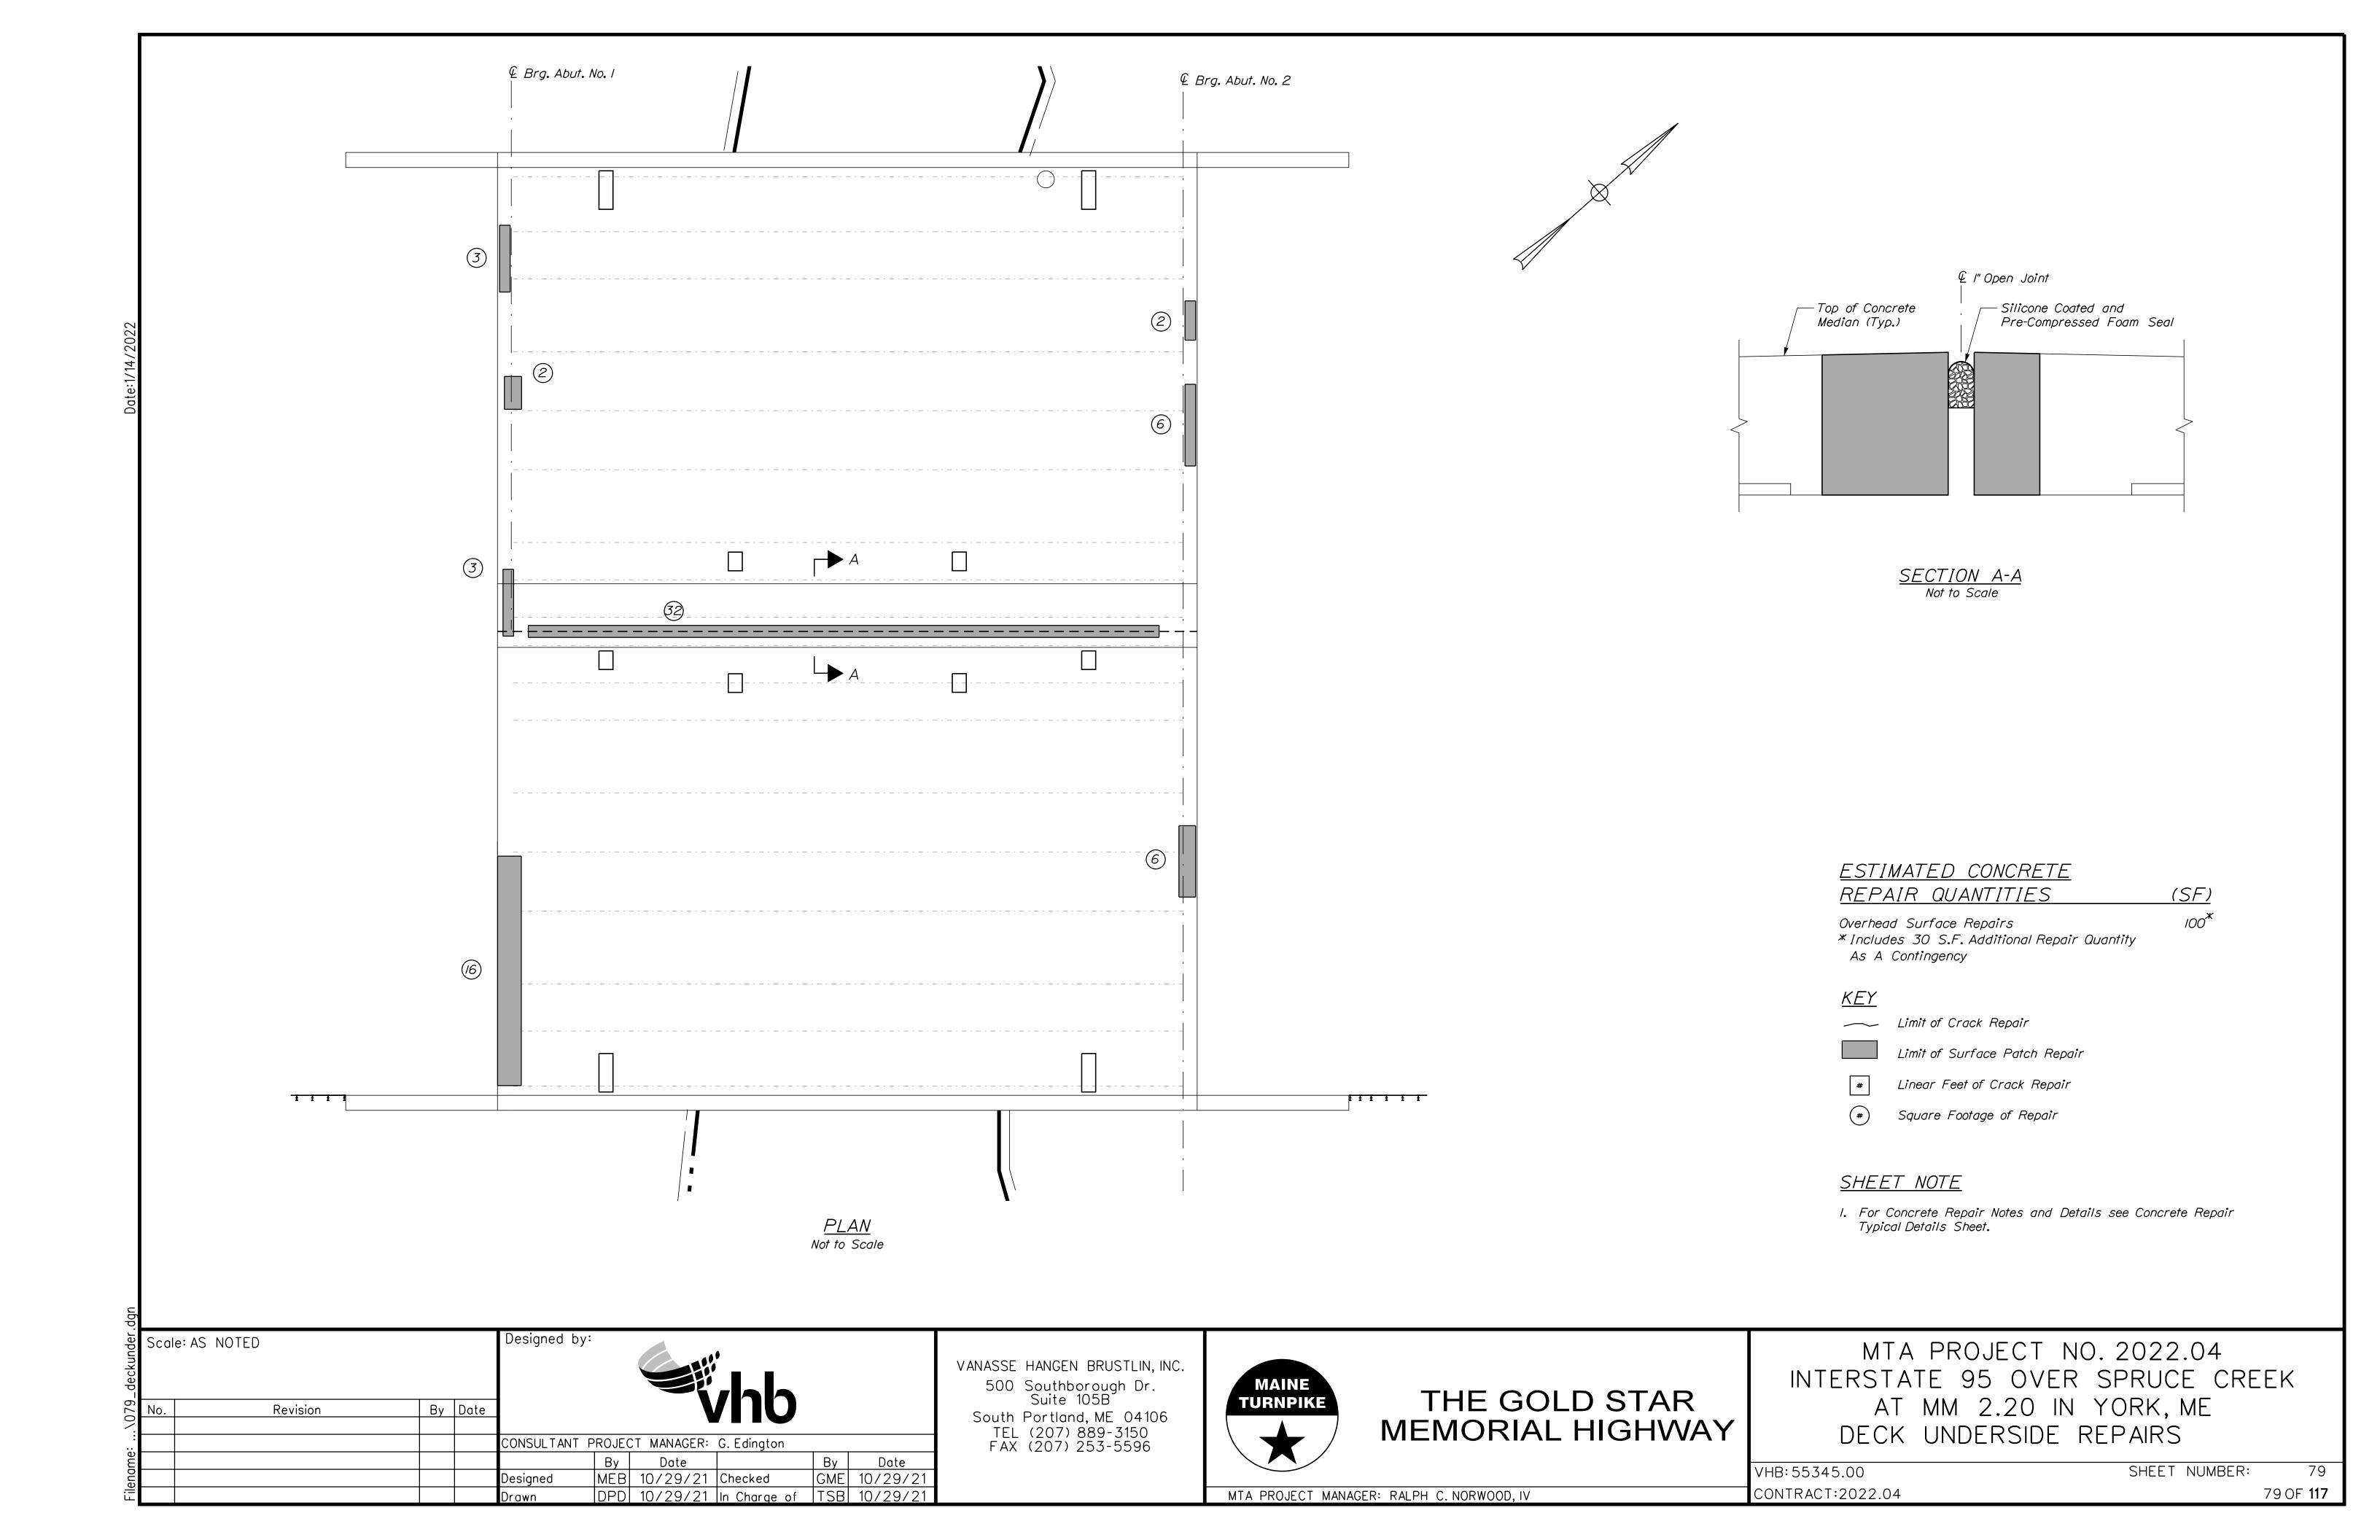
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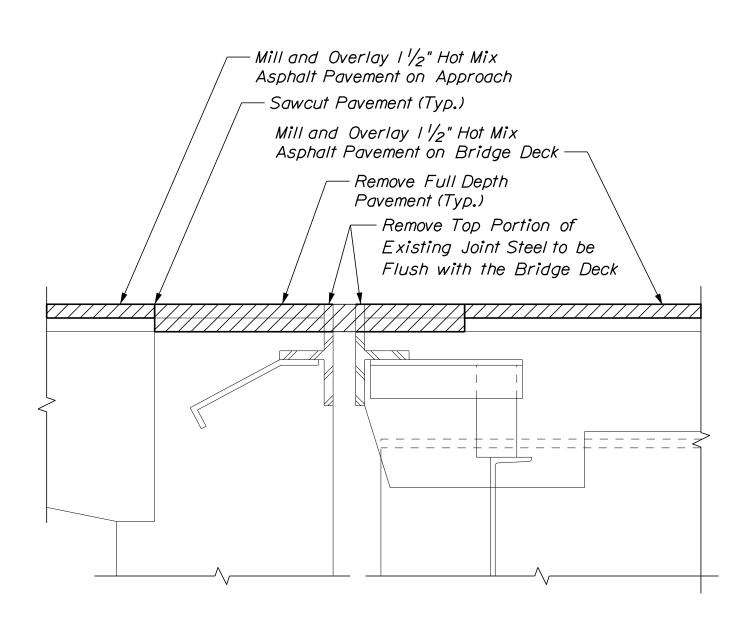


THE GOLD STAR MEMORIAL HIGHWAY

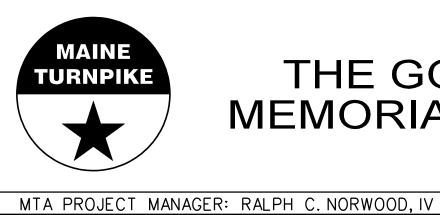MTA PROJECT NO. 2022.04 INTERSTATE 95 OVER SPRUCE CREEK AT MM 2.20 IN YORK, ME WINGWALL REPAIRS


SHEET NUMBER: VHB: 55345.00 CONTRACT:2022.04 78 OF **117**






EXISTING NB BRIDGE JOINT

Not to Scale

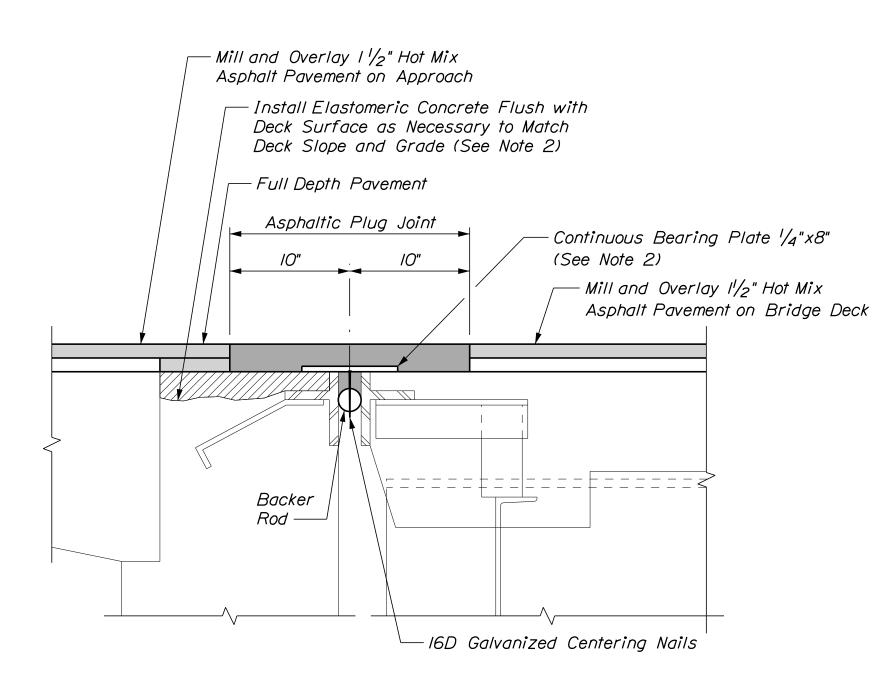


PROPOSED NB BRIDGE JOINT

Not to Scale

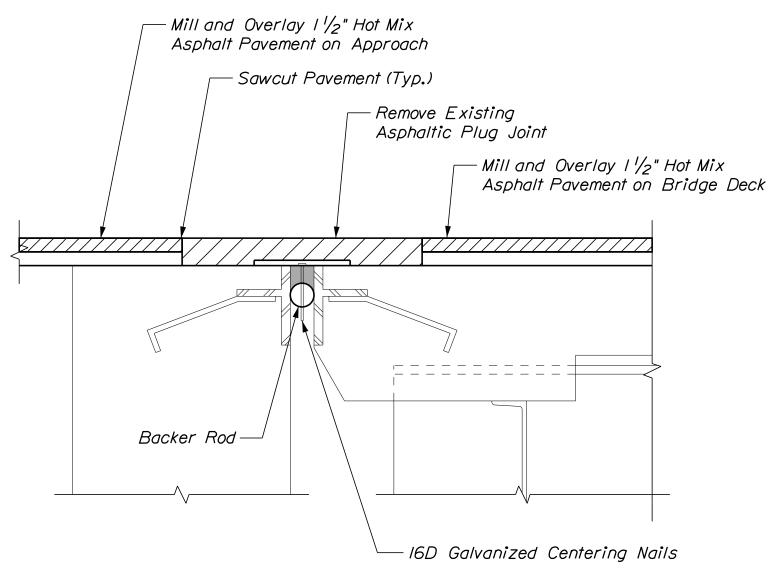

EXISTING SB BRIDGE JOINT

Not to Scale

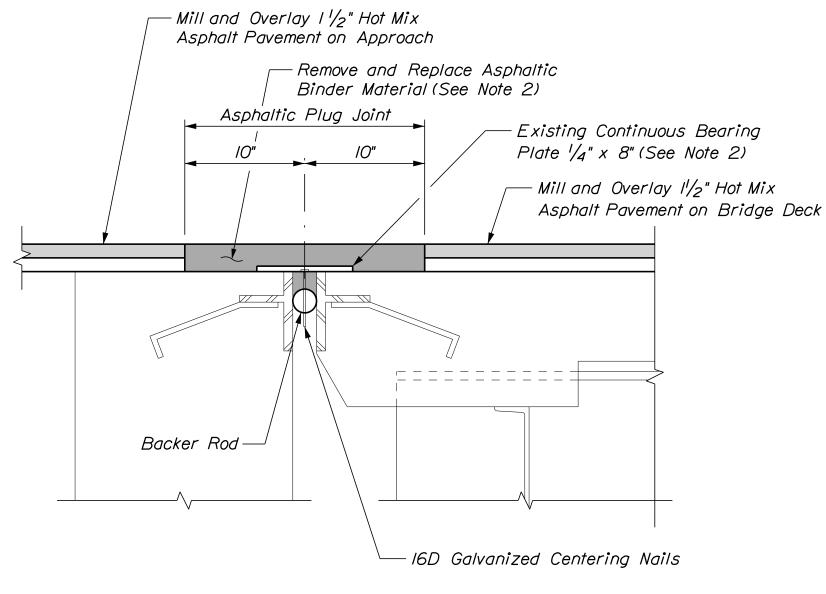

PROPOSED SB BRIDGE JOINT

Not to Scale

<u>NOTES</u>

- I. Repair concrete deck and backwall as directed by the Resident.

 Deck and backwall and concrete repair, if required, shall be paid for under the appropriate 518 concrete repair items.
- 2. Elastomeric Concrete and Continuous Bearing Plate shall be incidental to Item 520.23 Asphaltic Plug Joint (Spruce Creek NB) and (Spruce Creek SB).
- 3. See Miscellaneous Detail sheet for the joint treatment at the bridge curbs.

SHEET NOTE

I. See Miscellaneous Details sheet for Joint Detail at Curb for the Asphaltic Plug Joint treatment at the curb.

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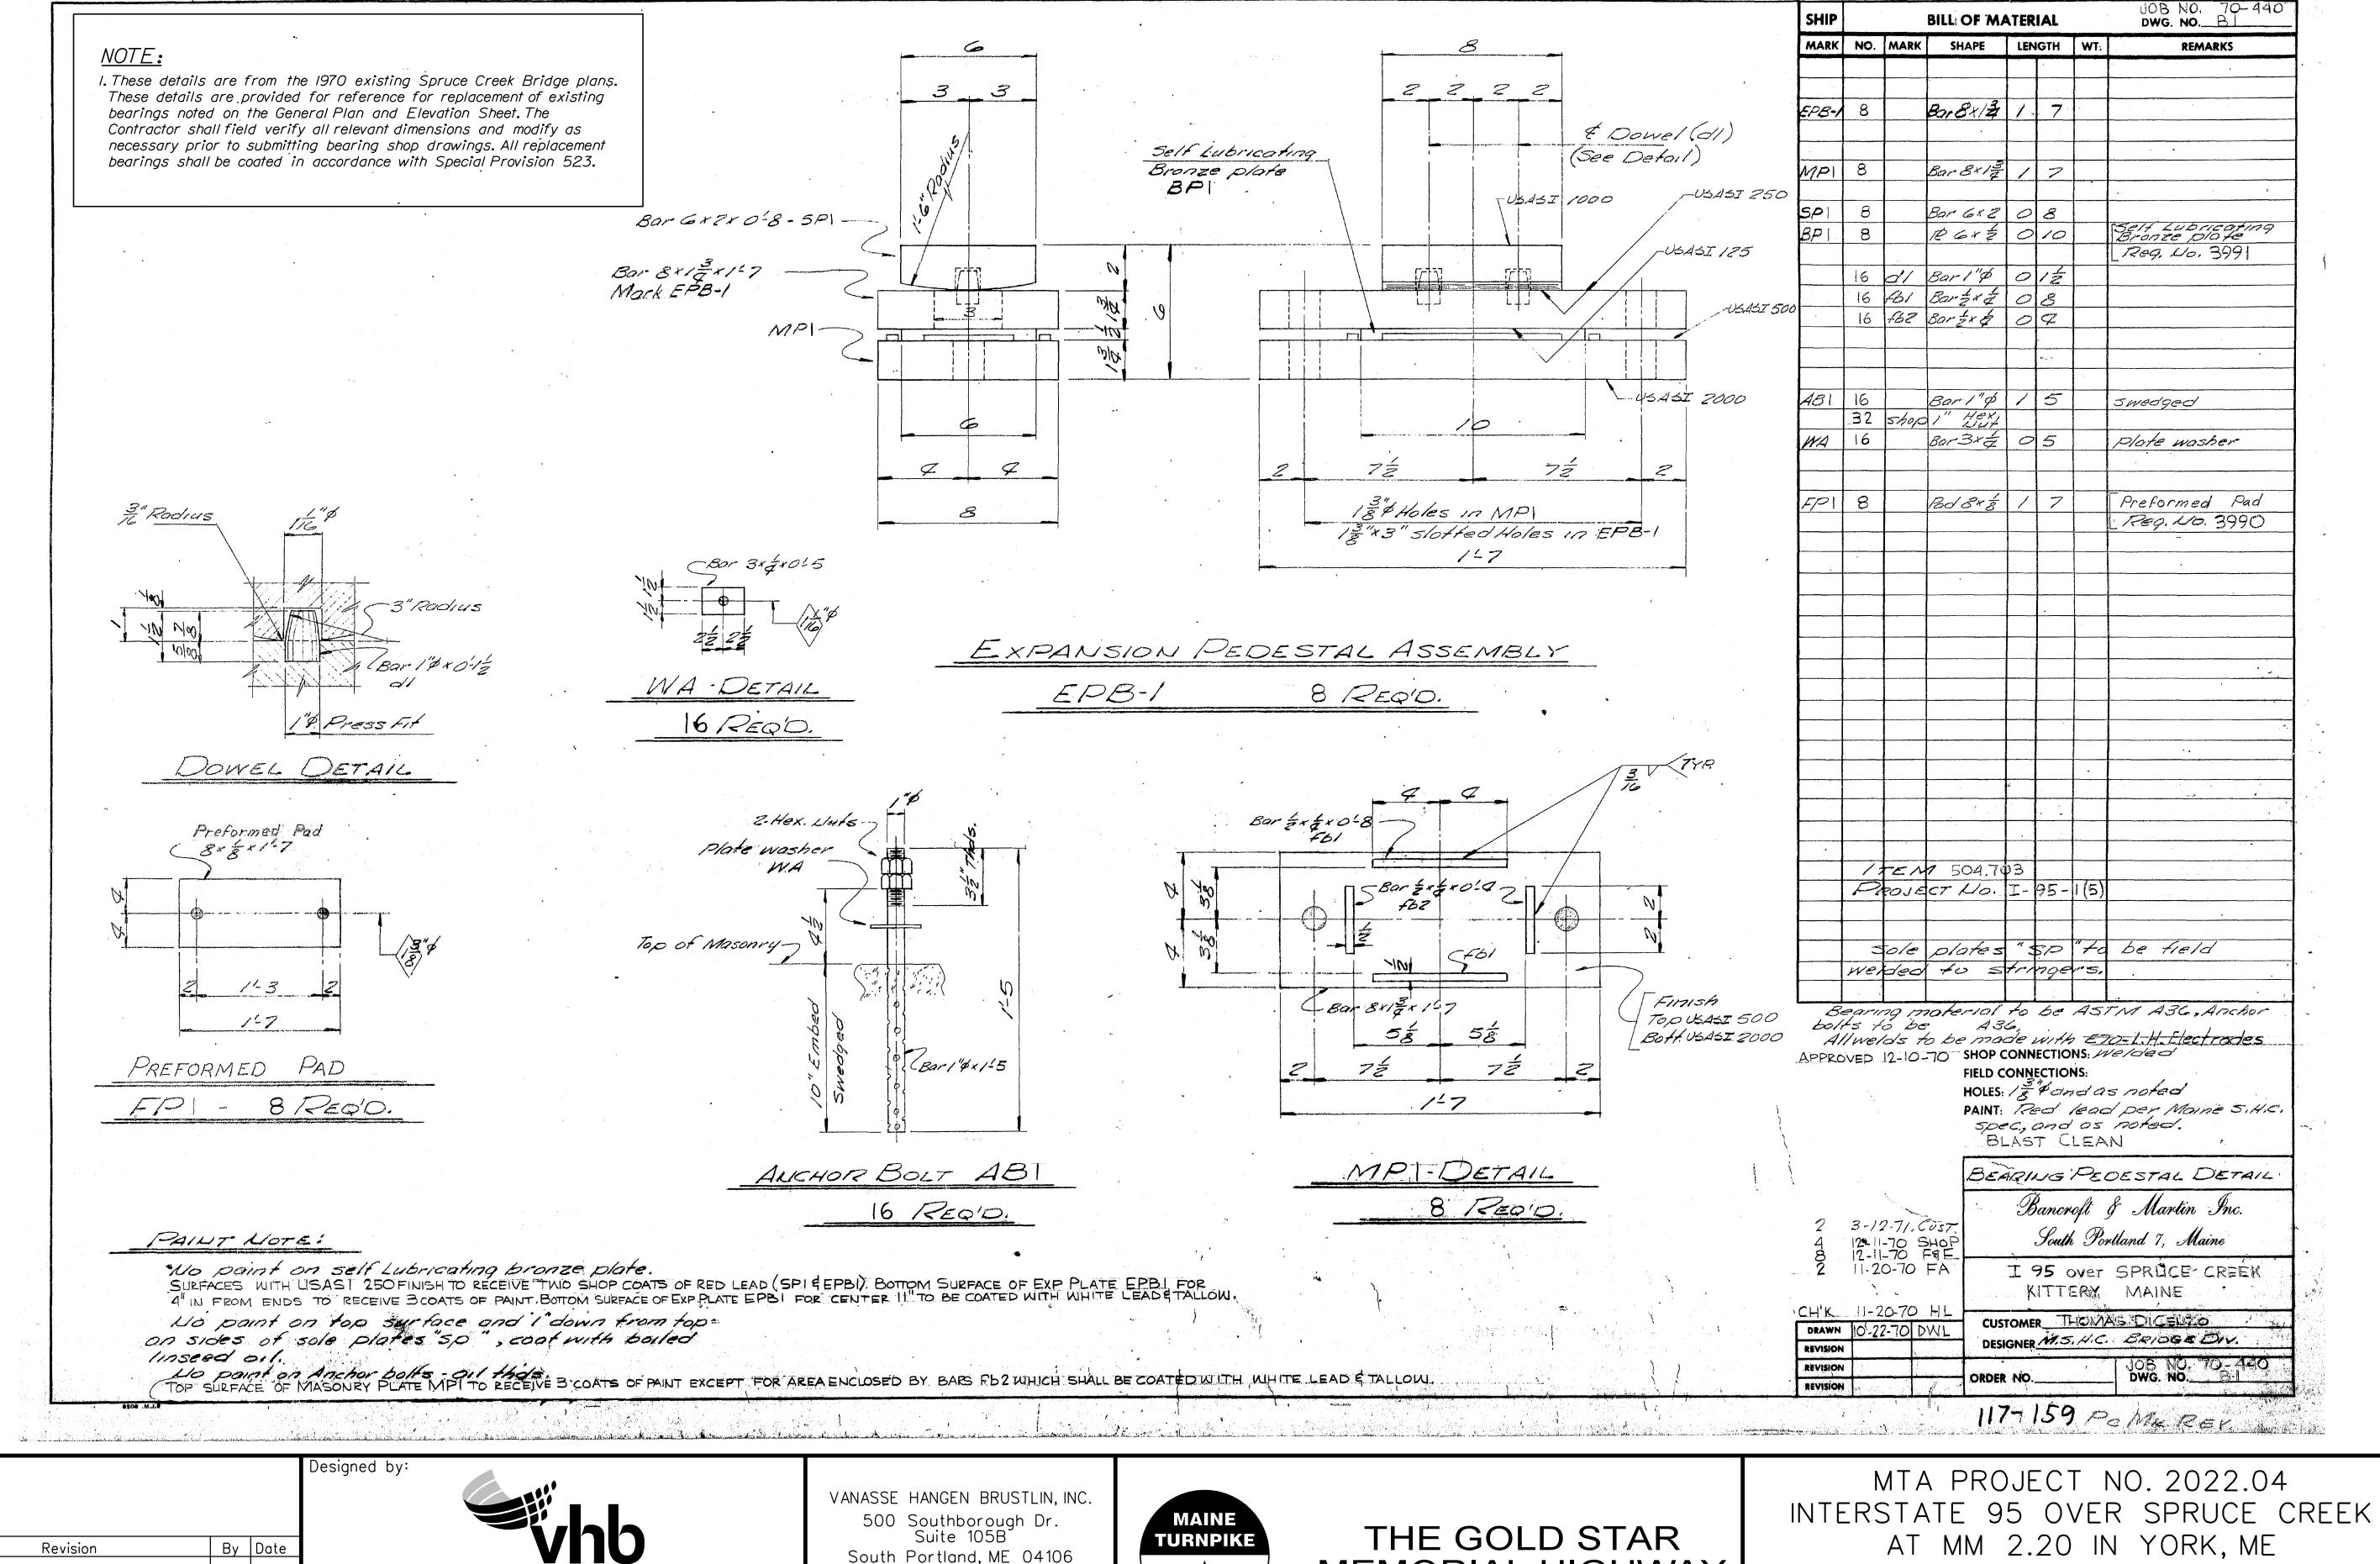
THE GOLD STAR
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MTA PROJECT NO. 2022.04
INTERSTATE 95 OVER SPRUCE CREEK
AT MM 2.20 IN YORK, ME
BRIDGE JOINT MODIFICATIONS

VHB: 55345.00 SHEET NUM
CONTRACT: 2022.04

MTA PROJECT MANAGER: RALPH C. NORWOOD, IV

SHEET NUMBER: 80 80 OF 117



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CONSULTANT PROJECT MANAGER: G. Edington By Date MEB 10/29/21 | Checked GME 10/29/21 Designed DPD 10/29/21 In Charge of TSB 10/29/21

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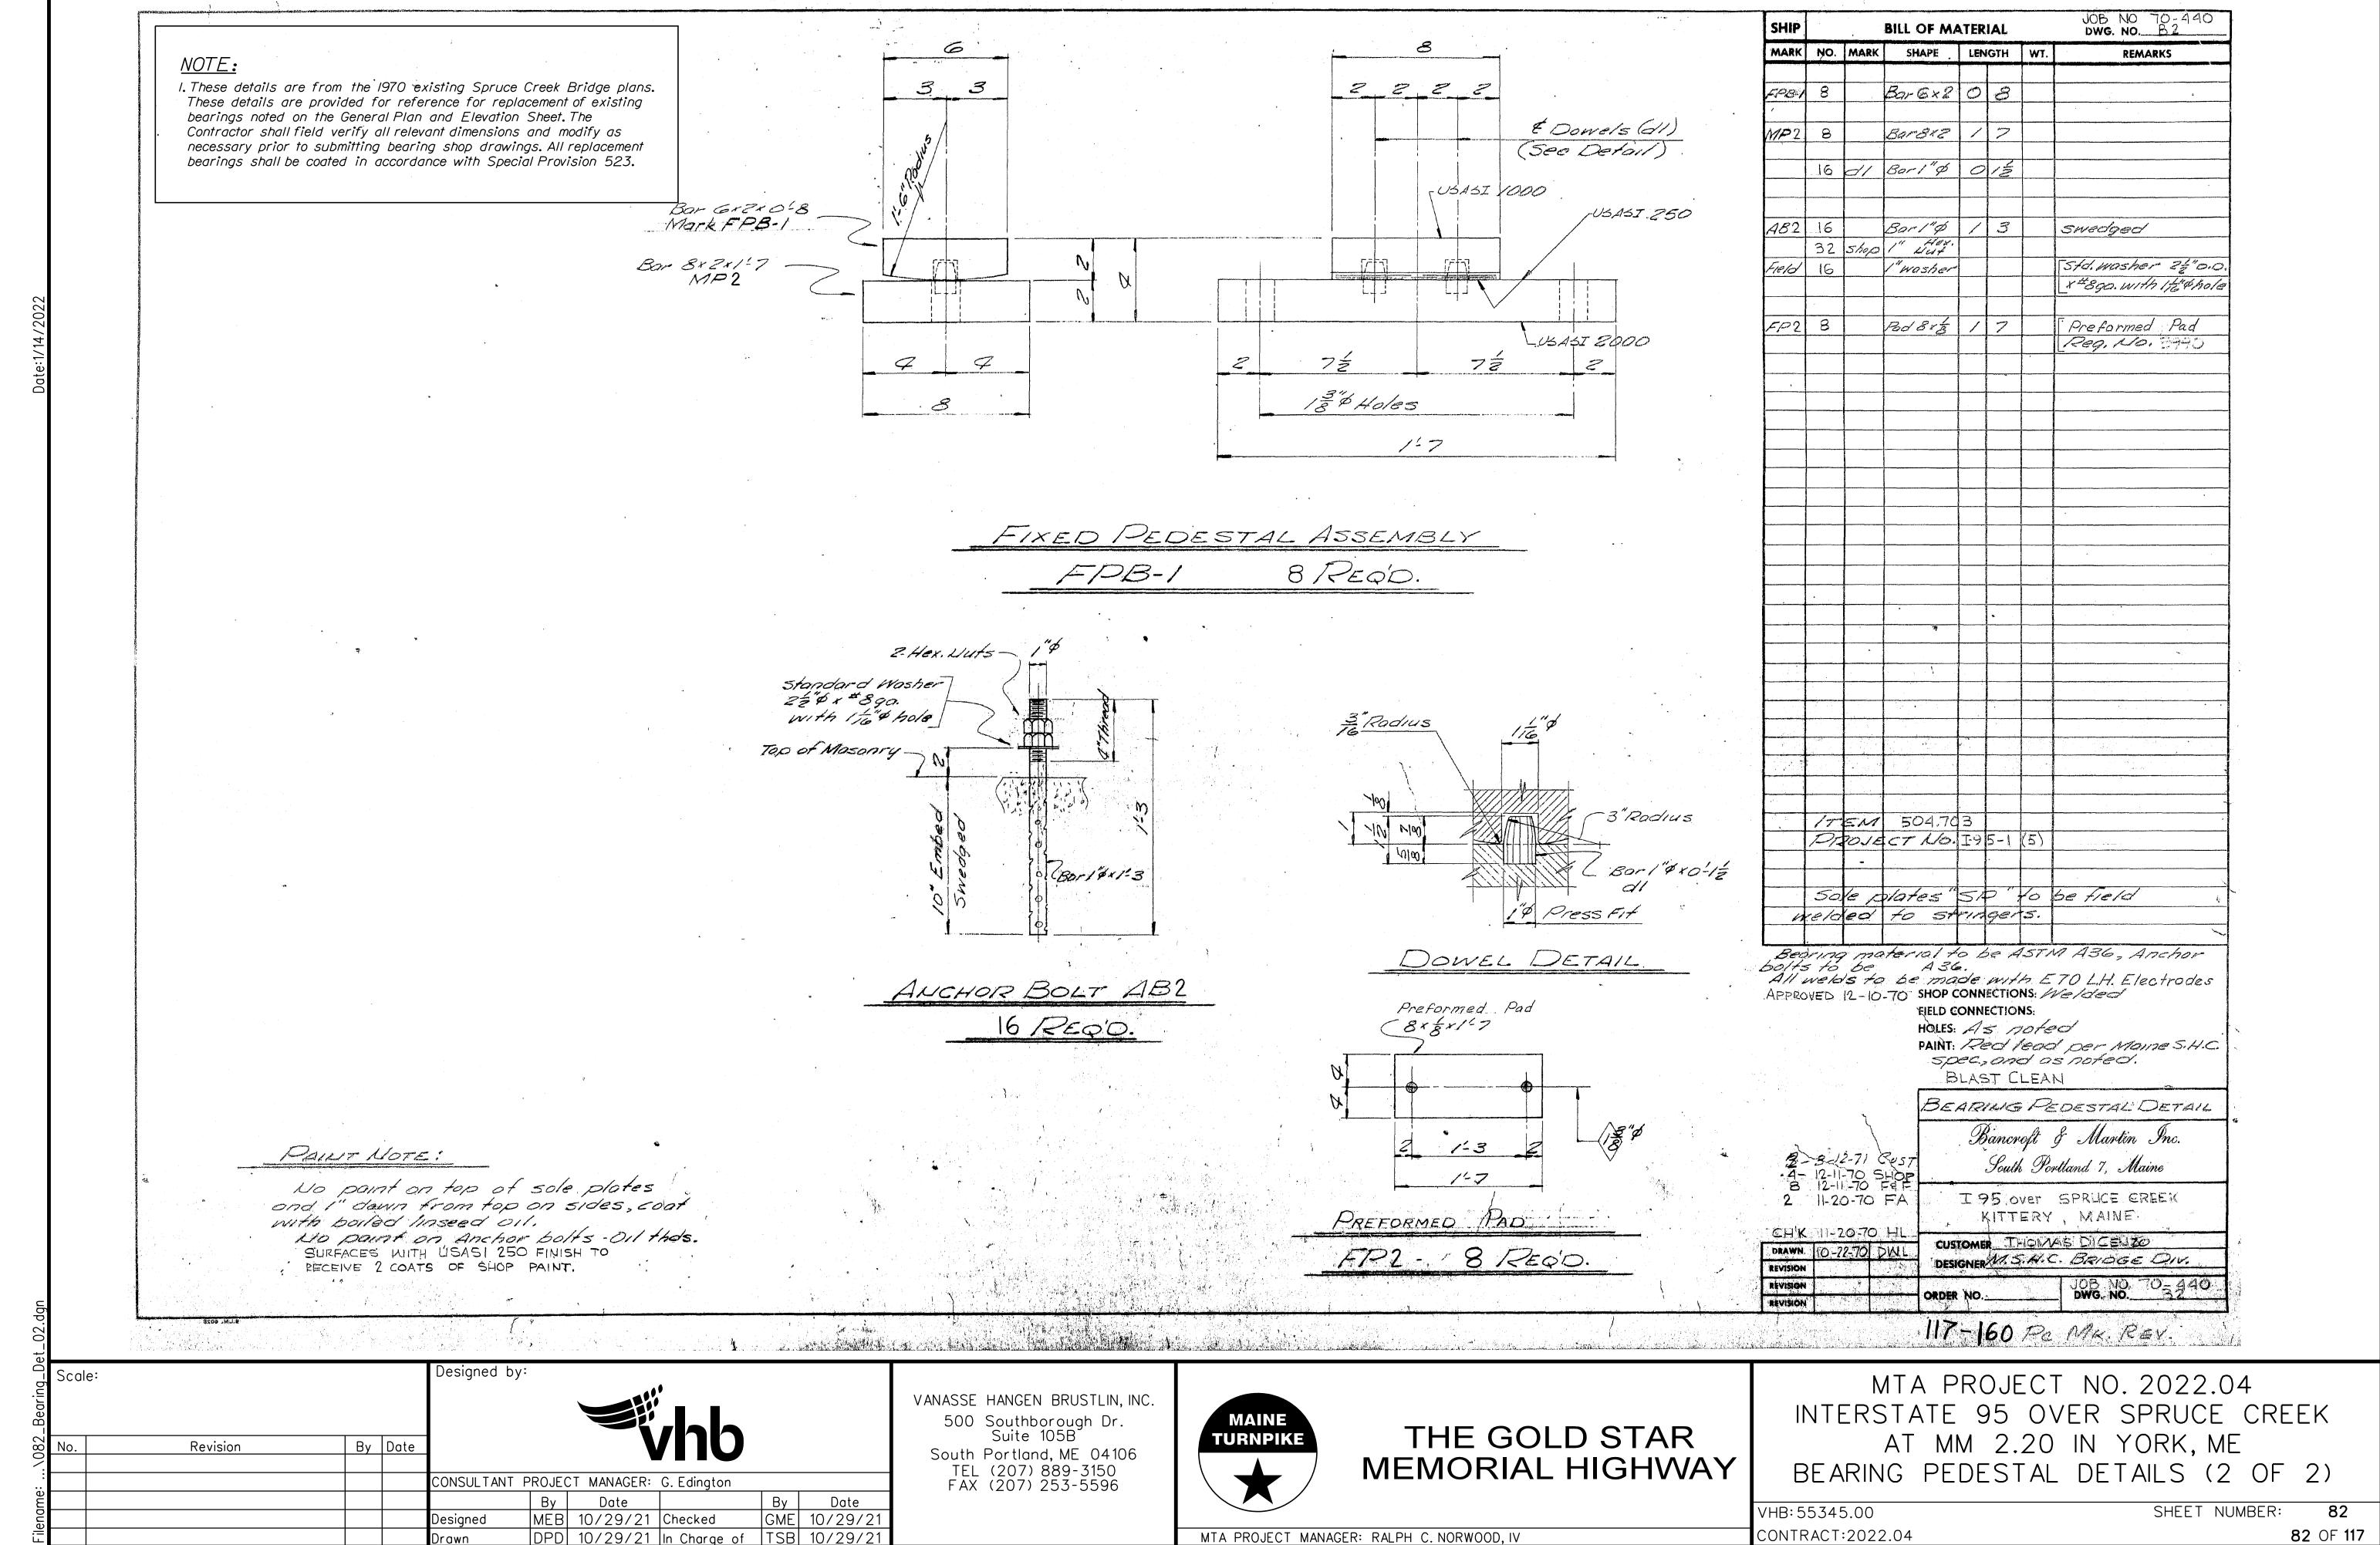
MTA PROJECT MANAGER: RALPH C. NORWOOD, IV

MEMORIAL HIGHWAY


BEARING PEDESTAL DETAILS (1 OF 2)


VHB: 55345.00 CONTRACT:2022.04

SHEET NUMBER: 81 **81** OF **117**




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Bridge Transition - Type I Not to Scale

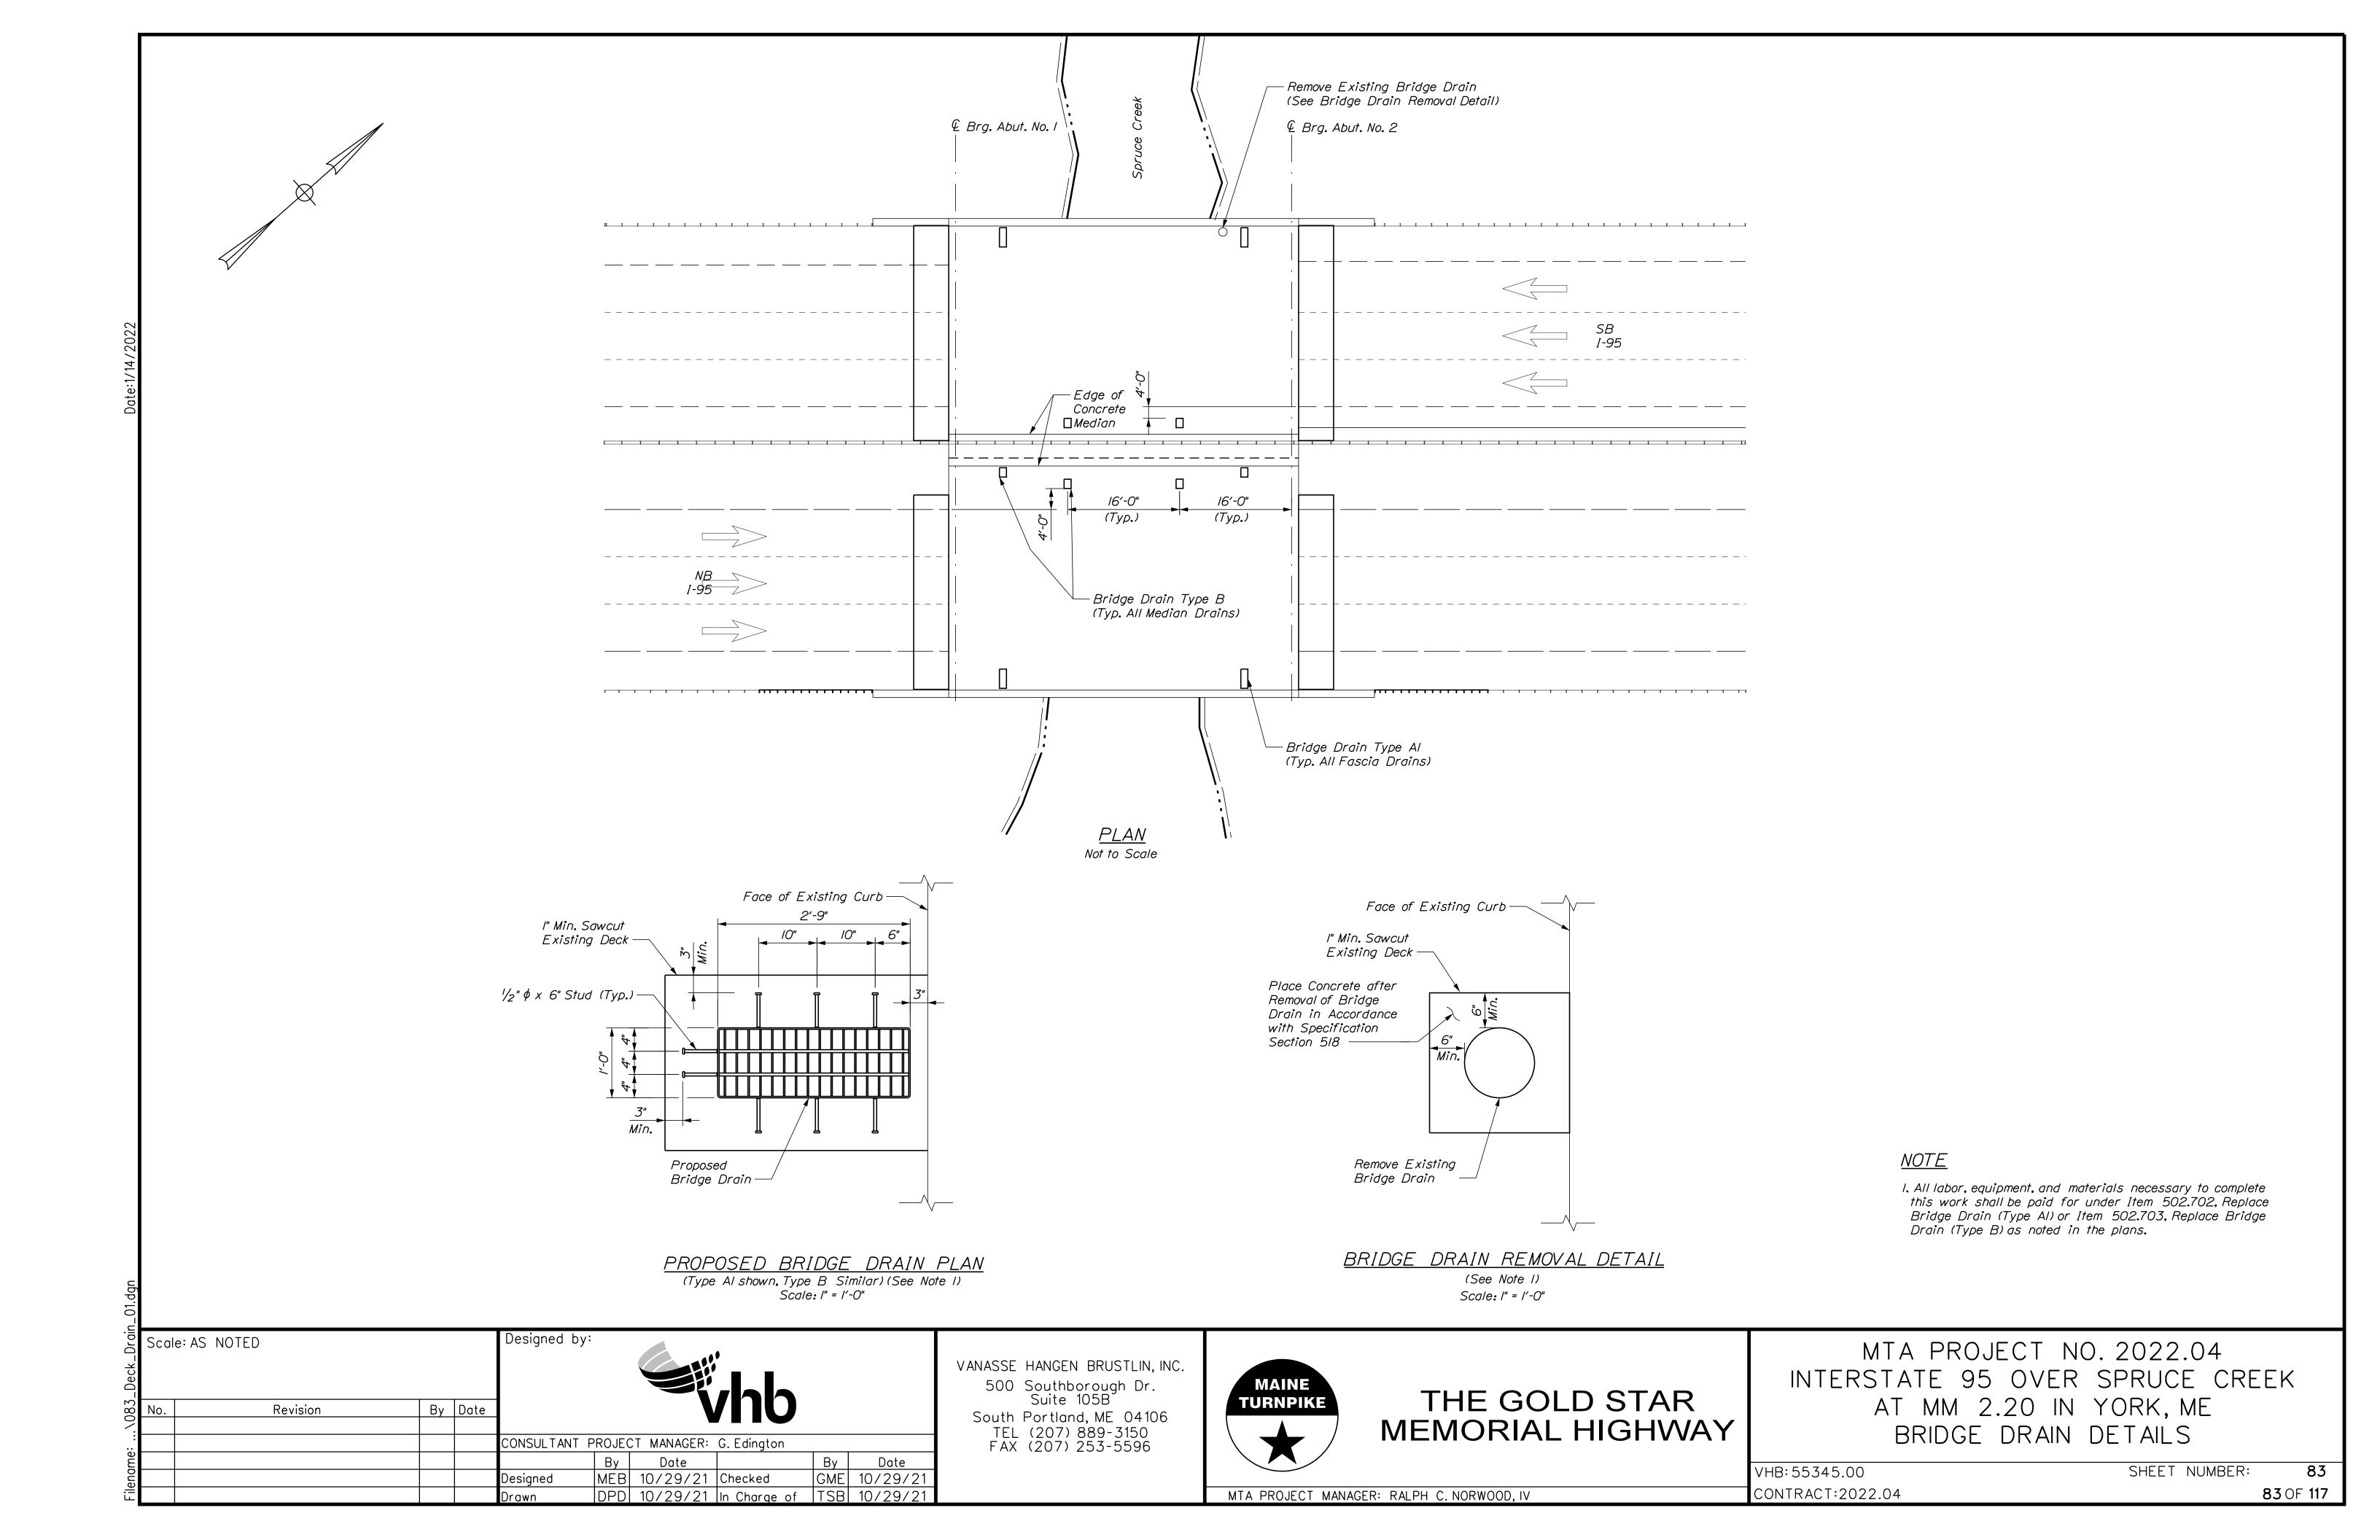

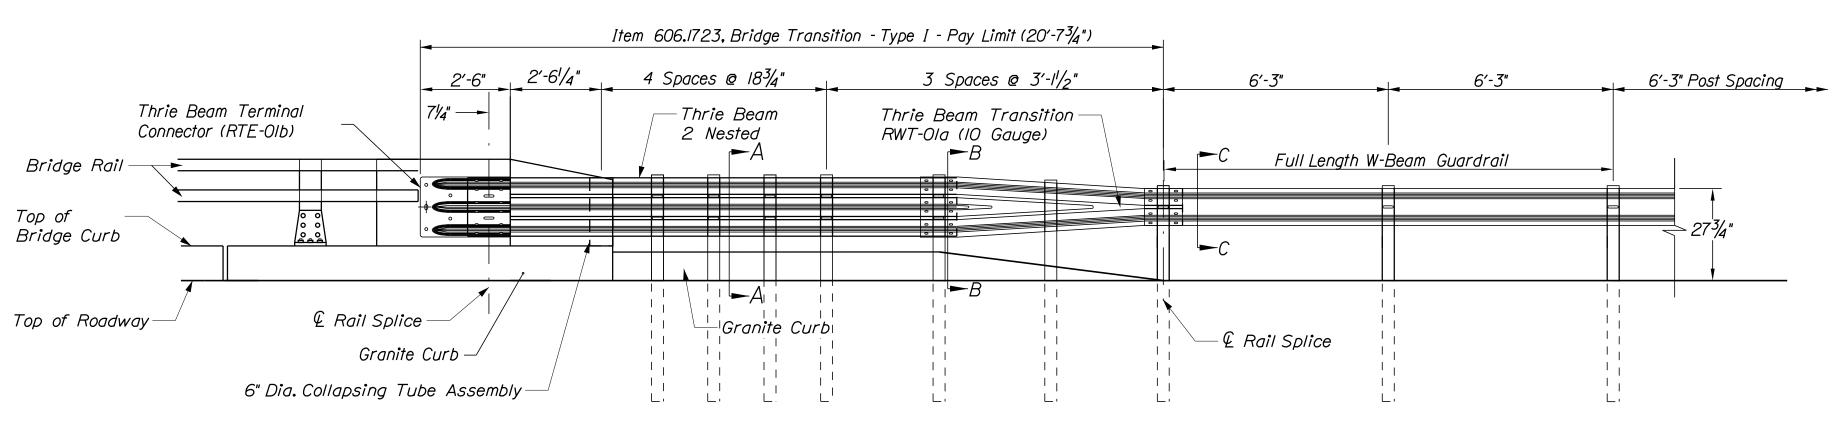
Section A-A Section B-B Section C-C

CURB NOTES:

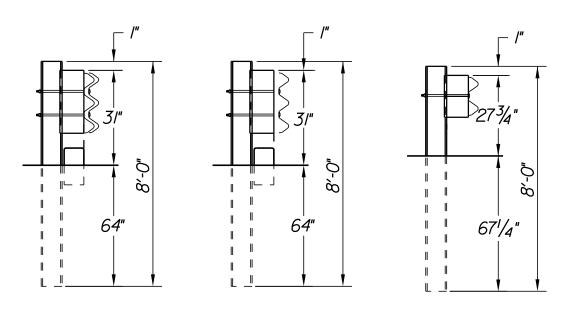- I. Curbing shall be either precast concrete, cast-in-place concrete or granite to meet dimensions shown on the plans.
- 2. Concrete curbs used in conjunction with thrie beam bridge transitions shall be Type 2, see details this sheet. Concrete curbs shall be set to form a continuous gutterline without any drainage cuts.
- 3. Sawcutting existing pavement, concrete fill, and pavement to limits shown shall be incidental to the Bridge Transition pay item.


GENERAL NOTES:

- I. Additional holes may be made in the thrie beam panels by drilling, punching, or other means that produce a neat, clean hole. Burning holes will not be allowed.
- 2. Thrie beam shall be placed with the composite blockout face in front of or directly above the curb face.
- 3. Rail element shall meet all requirements of AASHTO M-180 except as modified on the plans. The thrie beam transition to W-Beam shall be of the same material, but shall not be less than 10 gauge.
- 4. After installation is complete, upset the thread on the anchor bolts in three places around each bolt, at the junction of the nut and the exposed thread, with a center punch or similar tool.
- 5. Standard barrier hardware has been used to develop these guardrail attachments. Designations provided in parentheses relate to standard elements detailed in "A Guide to Standardized Barrier Rail Hardware." 1979. AASHTO-AGC-ARTBA Joint Cooperate Committee.
- 6. I" hole in concrete shall be formed by a I" I.D. PVC sleeve as approved by the engineer.
- 7. Guardrail height shall be adjusted uniformly between section callouts.

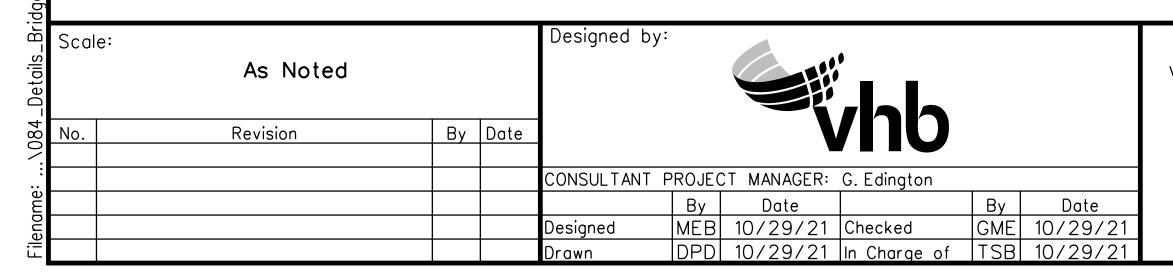



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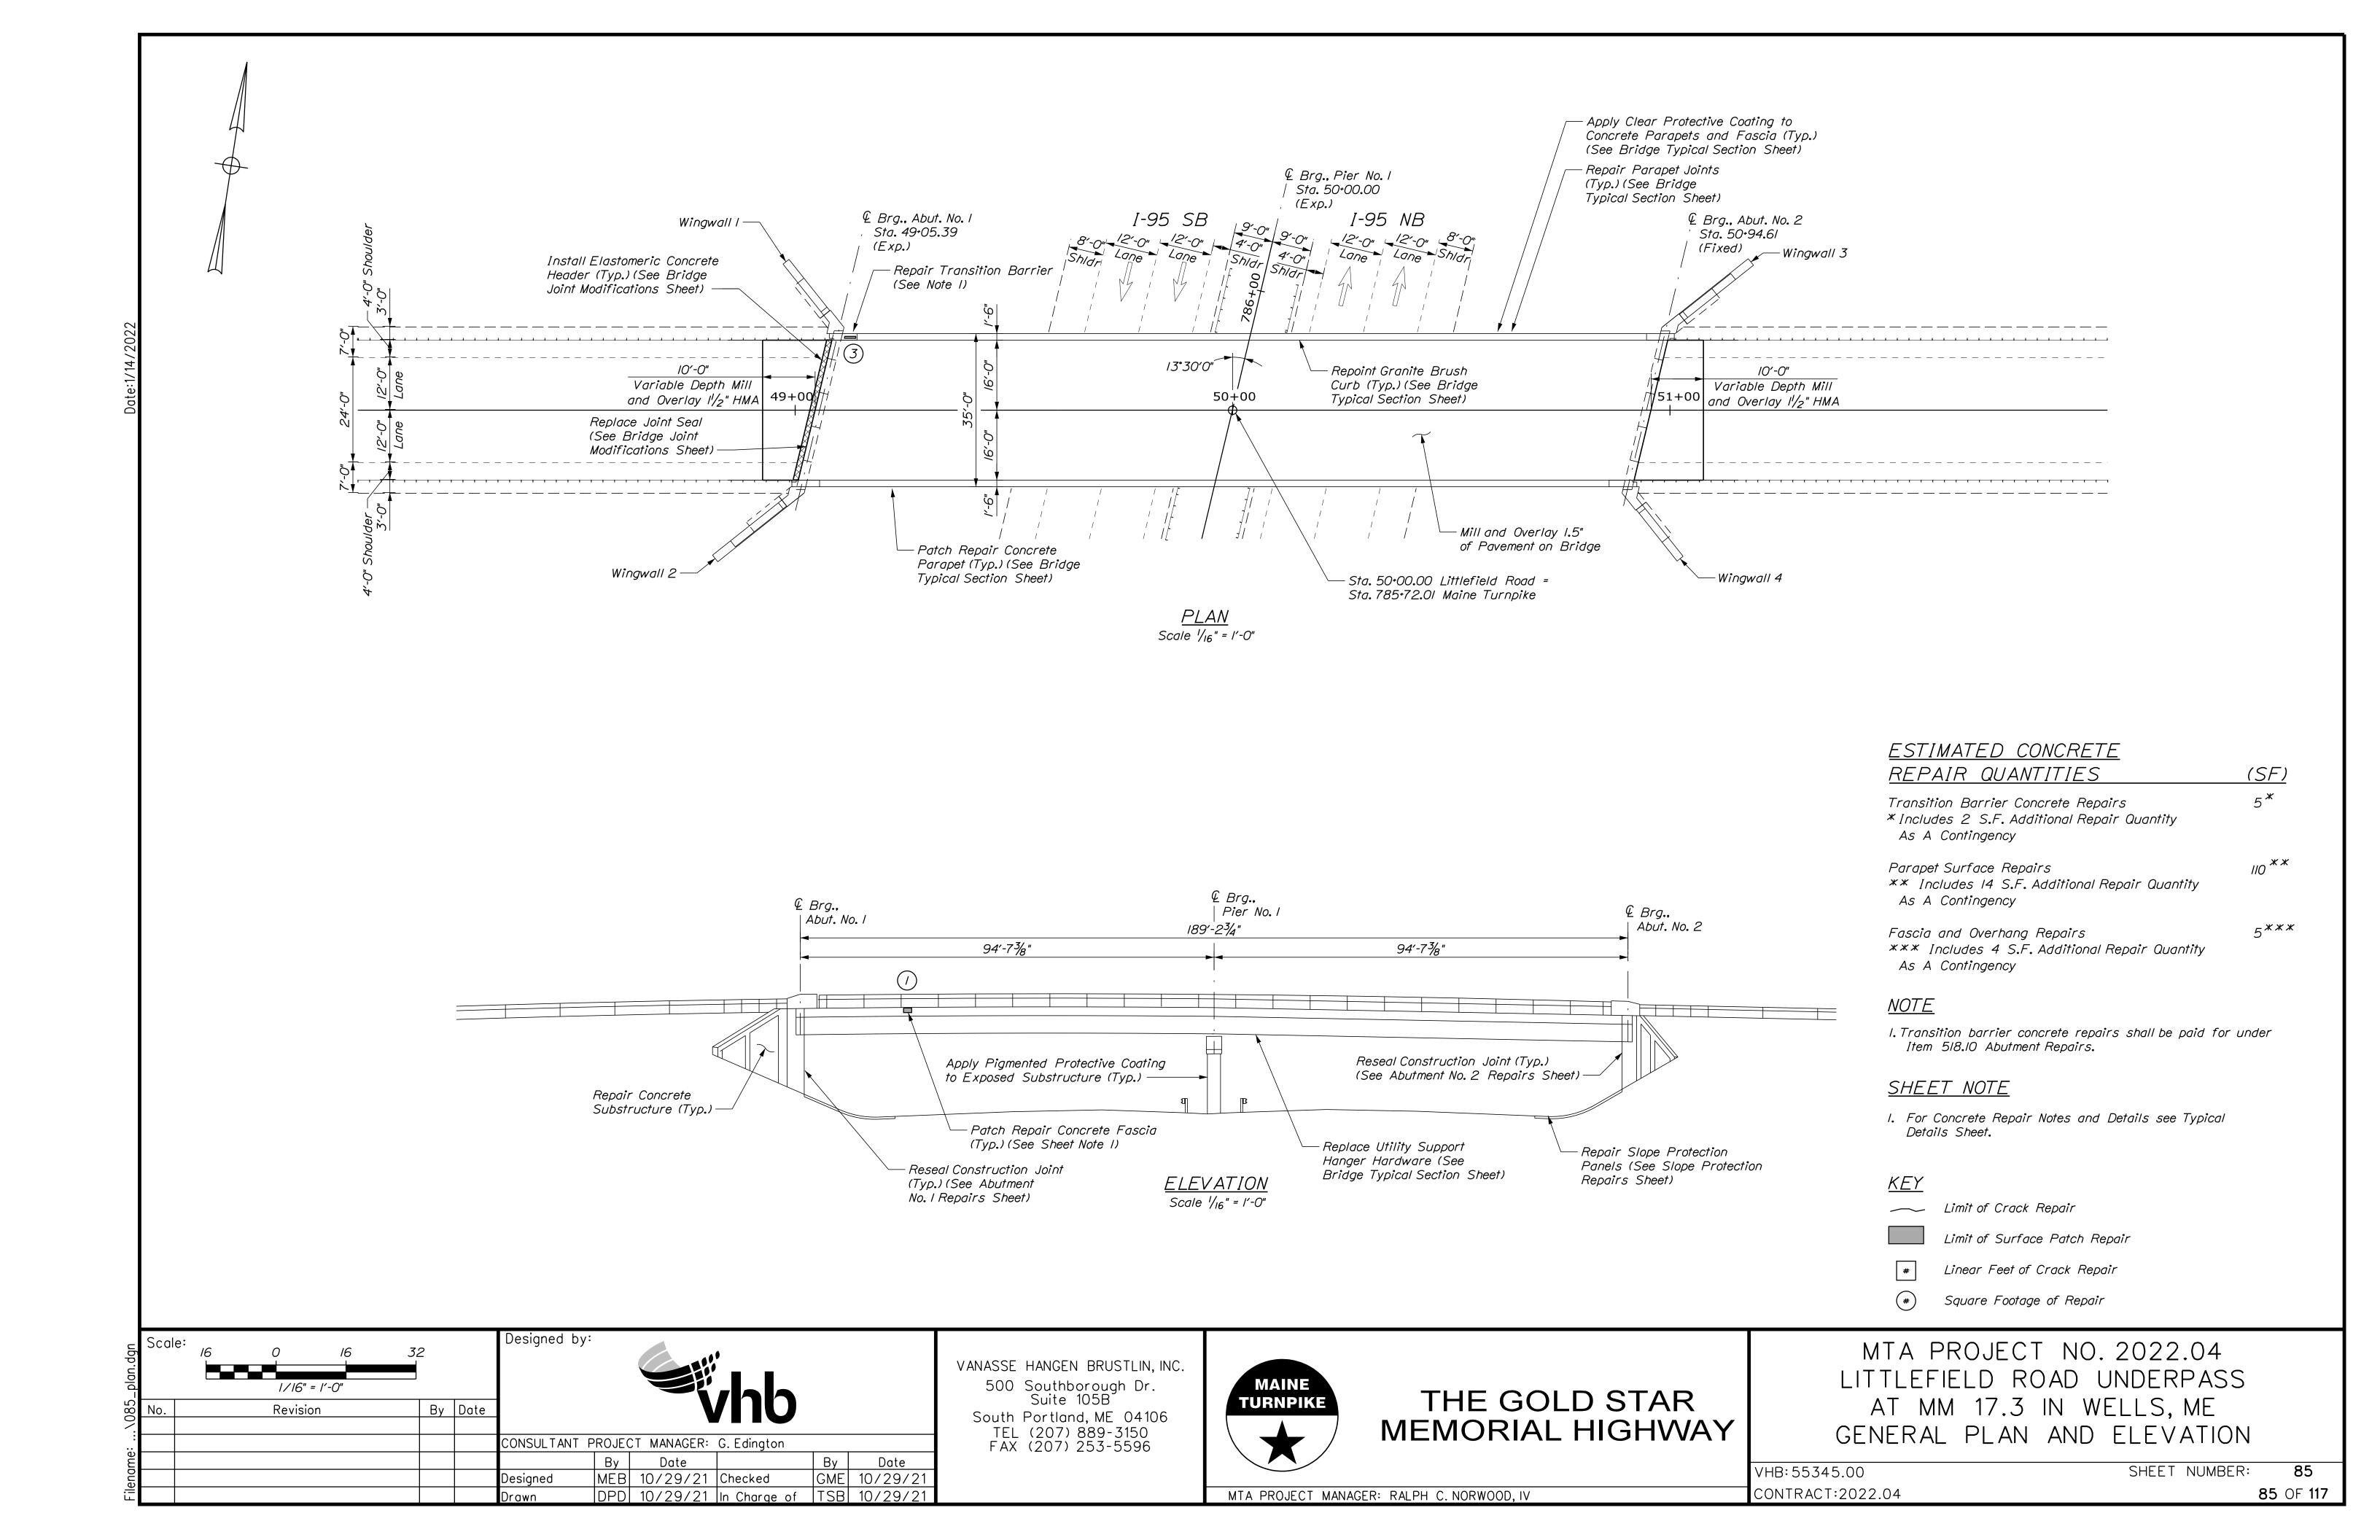
THE GOLD STAR MEMORIAL HIGHWAY

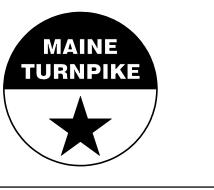MTA PROJECT NO. 2022.04 INTERSTATE 95 OVER SPRUCE CREEK AT MM 2.20 IN YORK, ME BRIDGE RAIL TRANSITION DETAILS


VHB: 55345.00 SHEET NUMBER: CONTRACT:2022.04


MTA PROJECT MANAGER: RALPH C. NORWOOD, IV

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Scale: 1/2" = 1'-0"



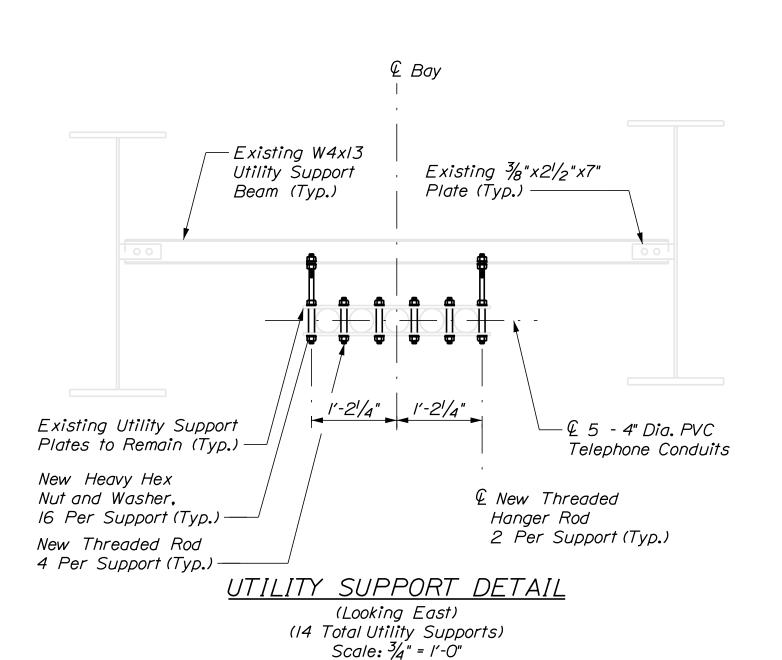

PARAPET DETAIL

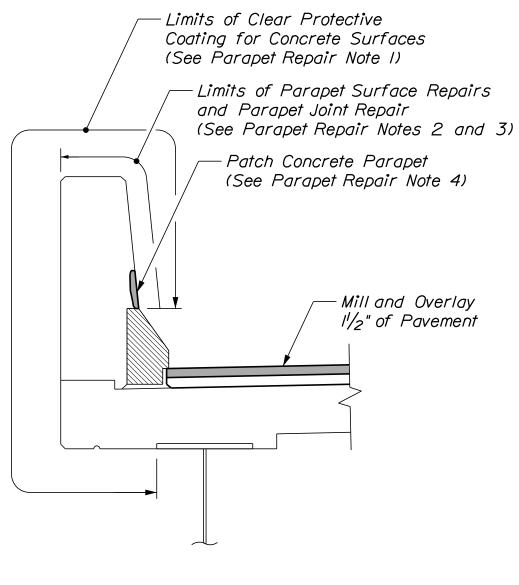(Bridge Rail not Shown for Clarity)

Scale: 3/4" = 1'-0"

UTILITY SUPPORT HANGER NOTES


- I. The utility support hardware shall be replaced at all utility support hangers. The existing composite support hardware shall be re-used. The conduit shall be temporarily supported at the location being replaced. The Contractor shall design and submit installation and temporary support plan at least three weeks prior to performing this work. The Contractor shall be fully responsible for replacing the existing composite square tube and pipe hardware if damaged during removal and re-installation.
- 2. Contractor shall field verify threaded rod lengths prior to rod and hardware procurement. The rod length and hardware depicted in the plan set is based on limited field measurements within the shoulder of each bridge location. Field cutting new threaded rod will not be permitted.
- 3. All labor, equipment, and materials necessary to repair the utility conduit hangers shall be paid for under Item 830.17, Utility Conduit Hanger System Hardware.

MATERIAL NOTE

I. All utility support hardware shall consist of $\frac{3}{4}$ " dia. Grade A36 threaded rod, $\frac{1}{4}$ " Grade A563 heavy hex locking nuts and associated washers. All hardware shall be hot dipped galvanized.

PARAPET REPAIR NOTES

- I. Limits of clear protective coating shall be paid for under Item 515.202, Clear Protective Coating for Concrete Surfaces.
- 2. Prior to application of clear protective coating the Contractor shall fill all honeycomb voids with an approved nonshrink grout. All costs for this work shall be paid for under Item 518.94, Parapet Surface Repairs.
- 3. Repair parapet joints as directed by the Resident. Joint sealant shall be from MaineDOT Qualified Product List for Silicone and Polyurethane Joint Sealant. Work shall be paid for under Item 518.48 Reseal Joints.
- 4. Patch Repairs to concrete parapet shall be paid under Item 518.93 Parapet Repairs.
- 5. Joint Sealant shall be a material from the Maine DOT approved products list as approved by the resident. Joint Sealant shall be incidental to Item 518.391 Repair Granite Curb Joint and Bedding Mortar.
- 6. The Contractor shall treat corners and vertical face for curbing in accordance with special provision section 508.

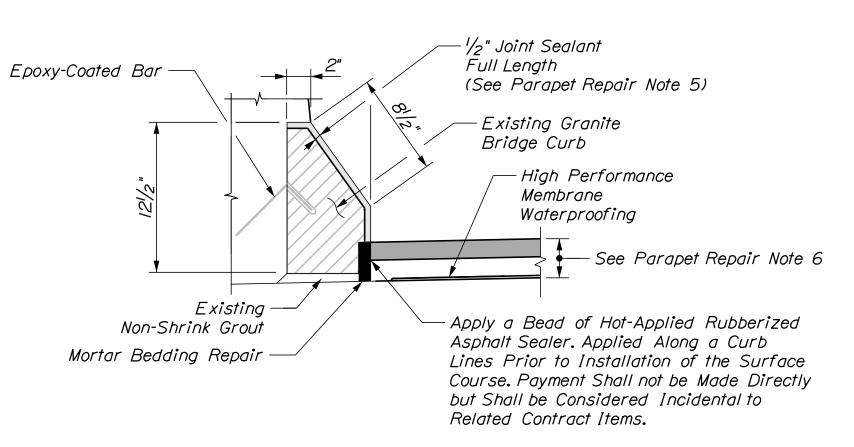

EXISTING GRANITE CURB DETAIL

11/2" = 1'-0"

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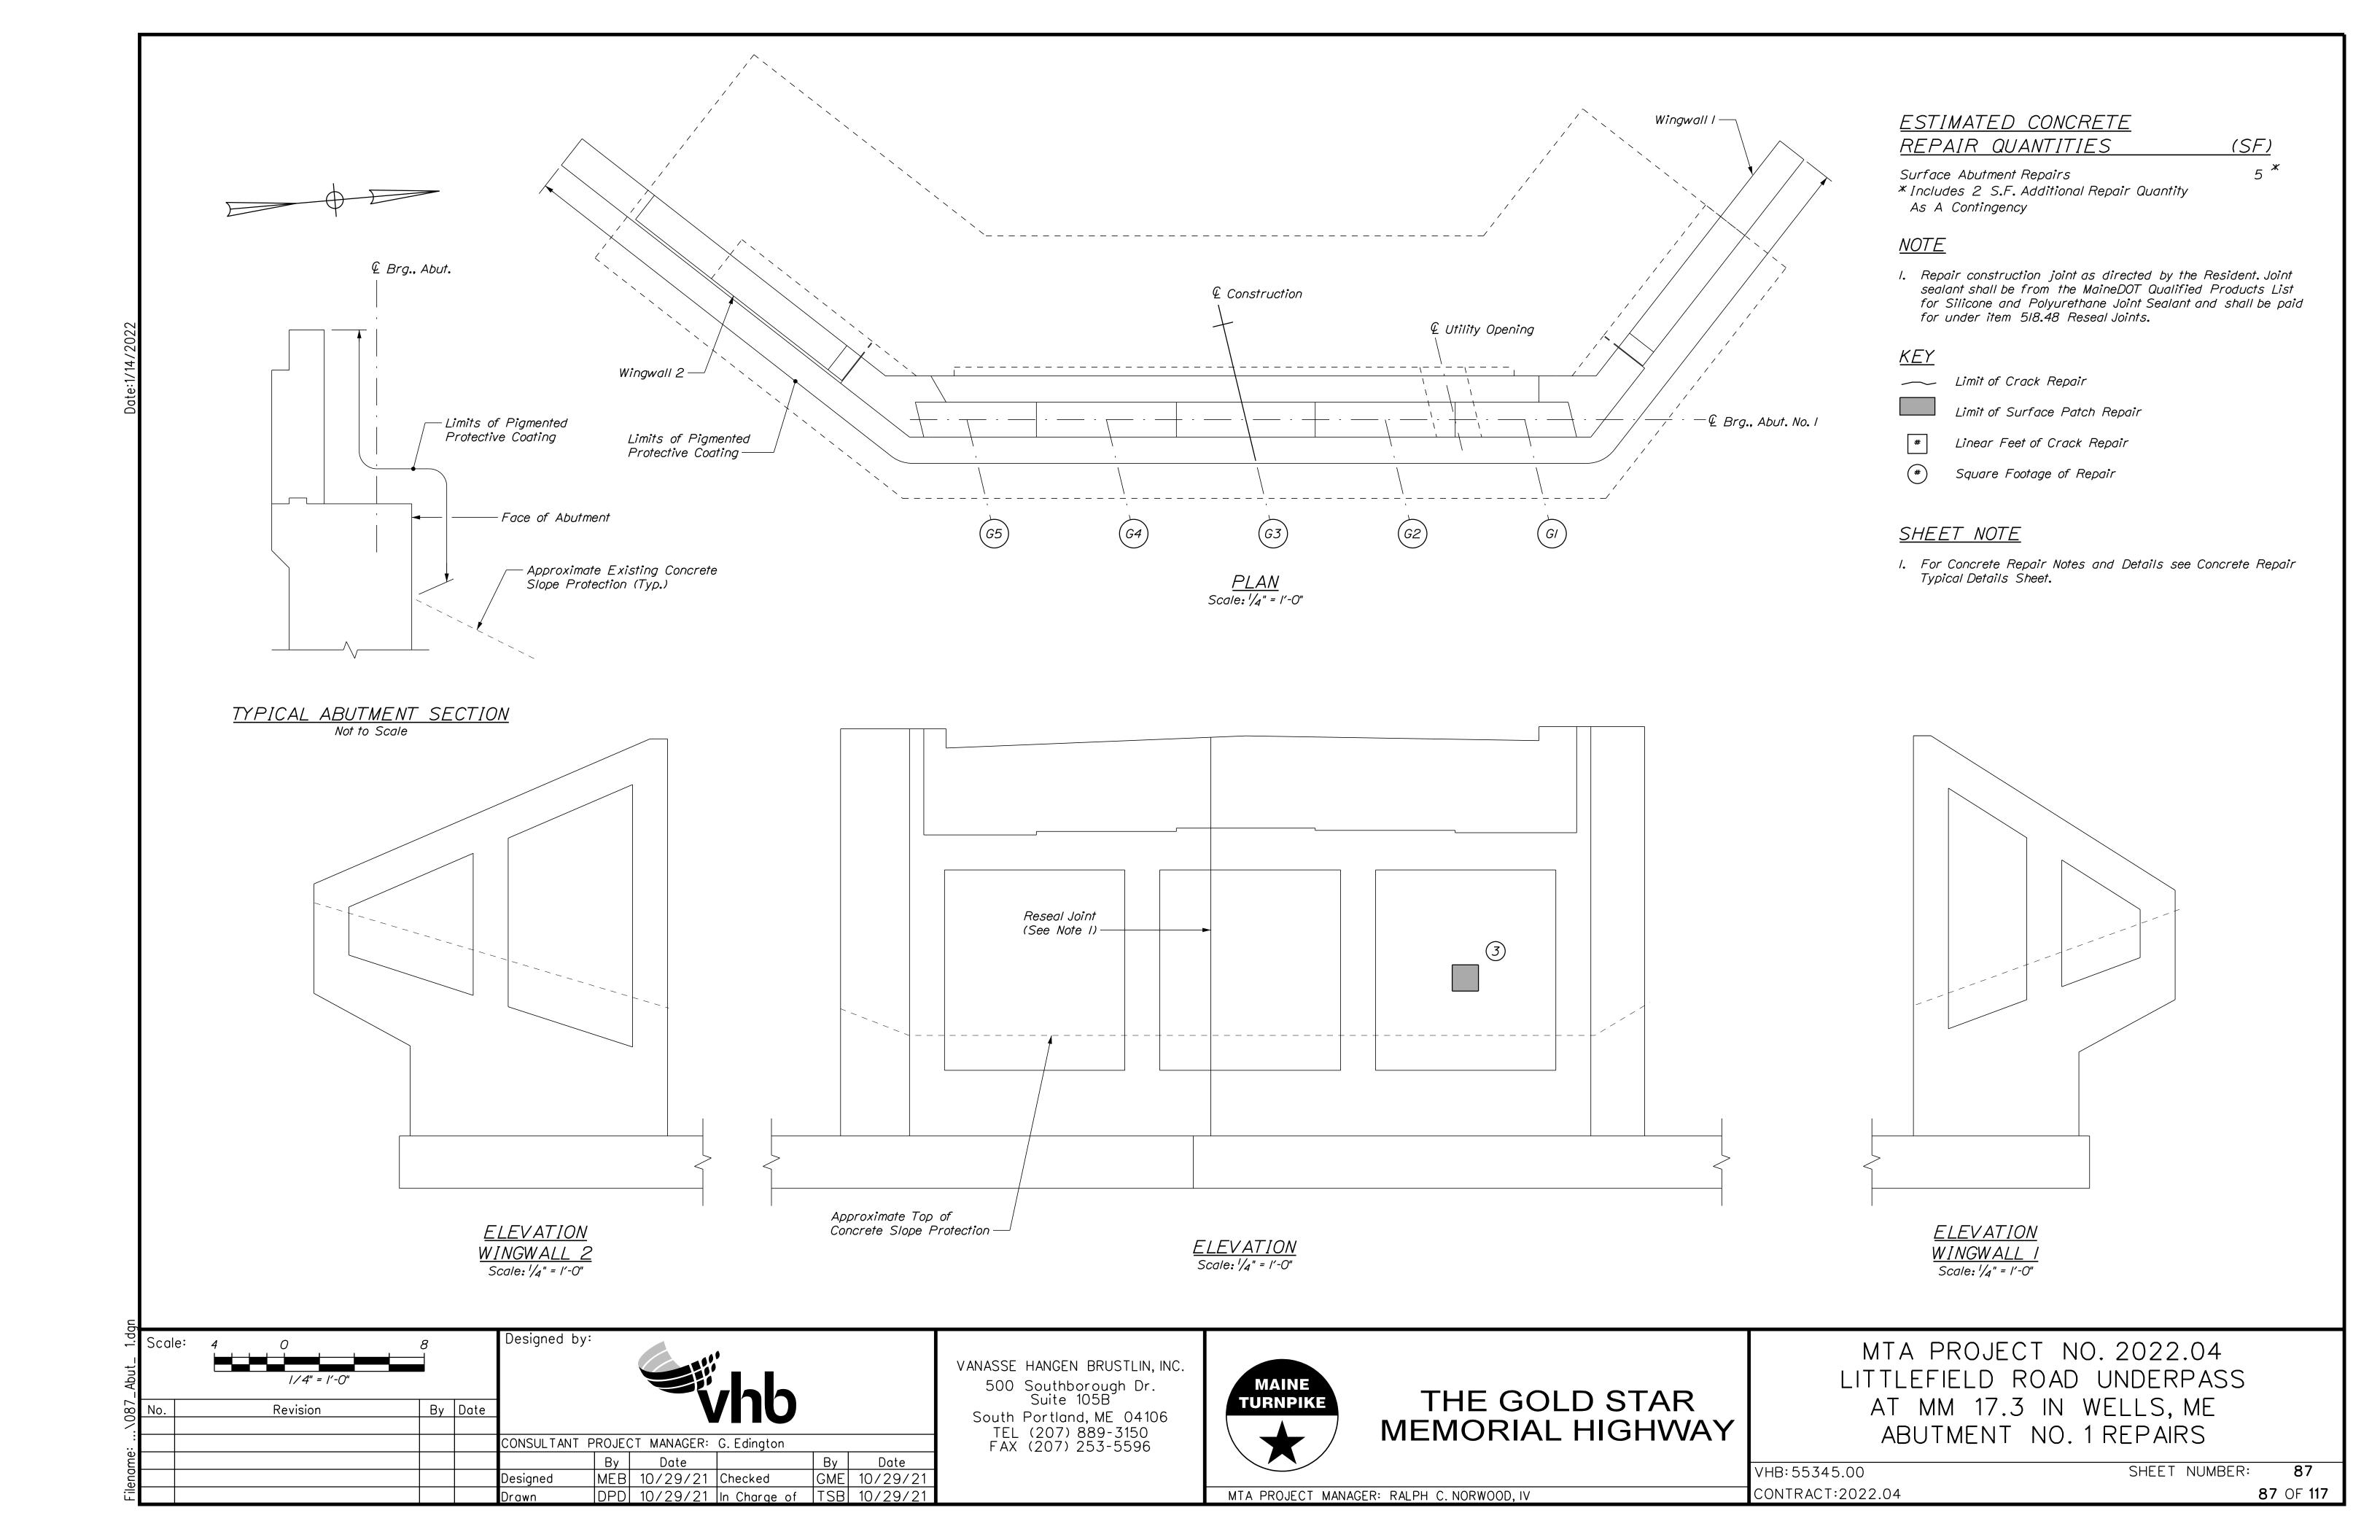
THE GOLD STAR
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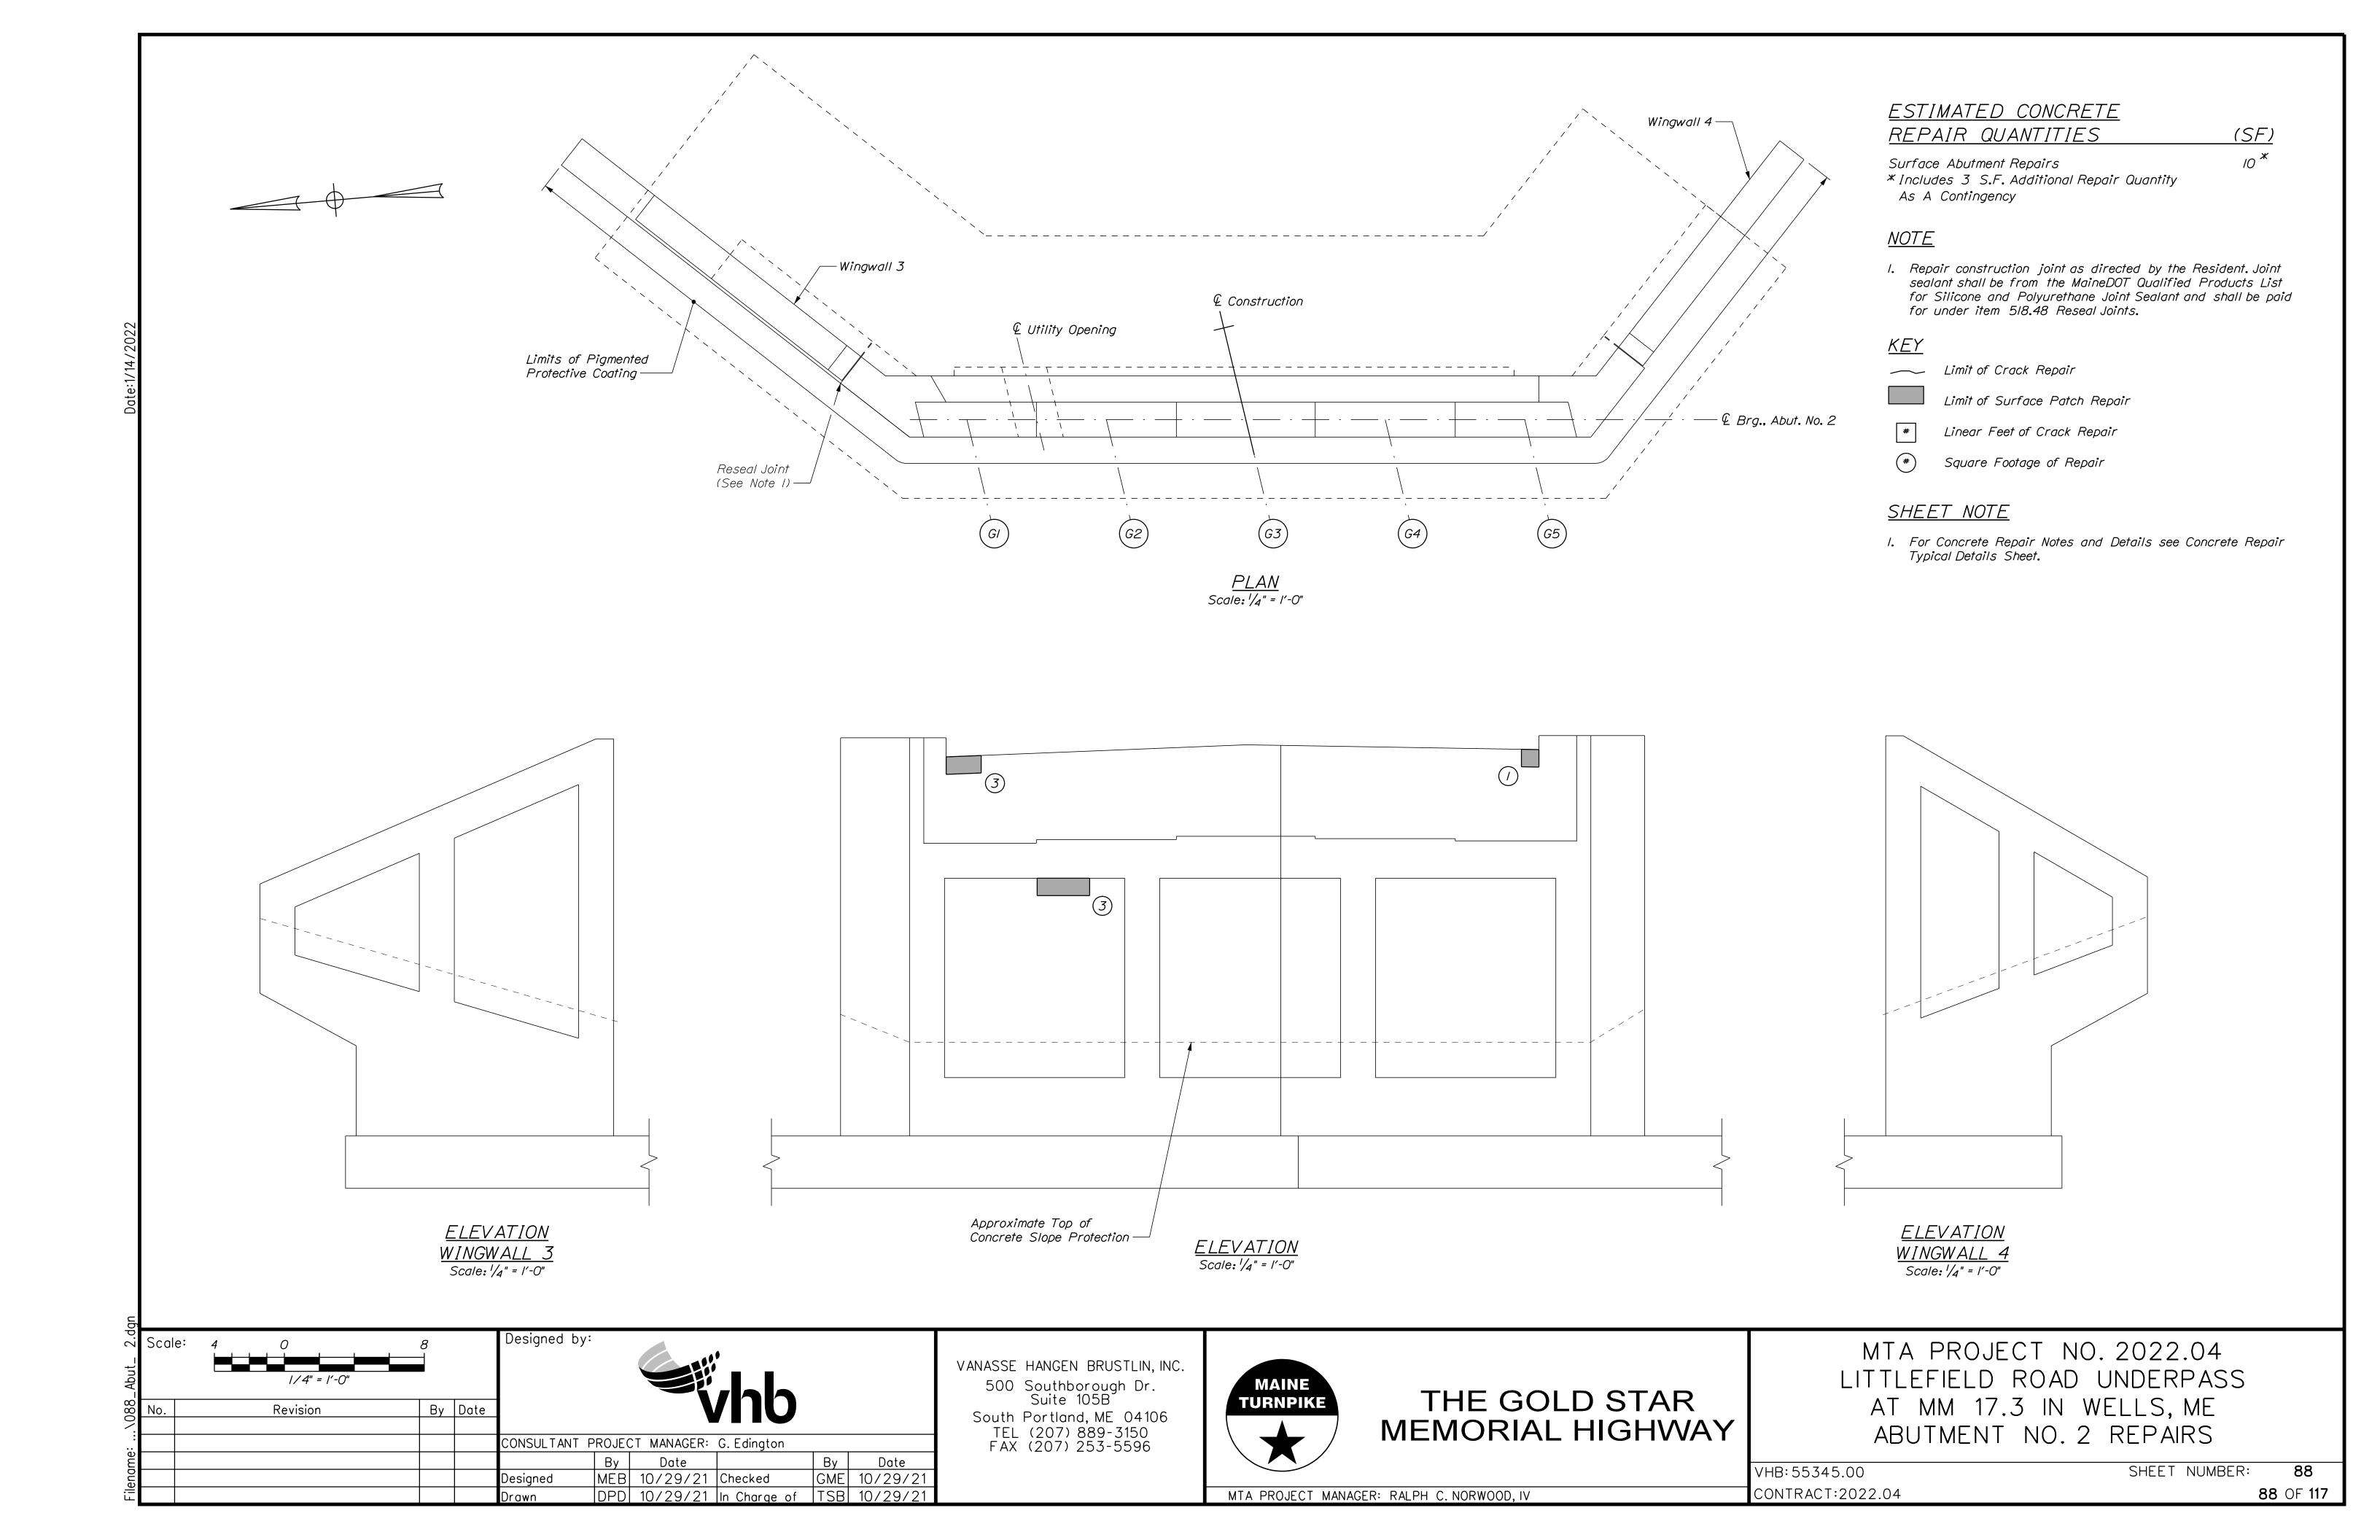
MTA PROJECT NO. 2022.04
LITTLEFIELD ROAD UNDERPASS
AT MM 17.3 IN WELLS, ME
BRIDGE TYPICAL SECTION


VHB: 55345.00


CONTRACT:2022.04


SHEET NUMBER: **86** OF **117**





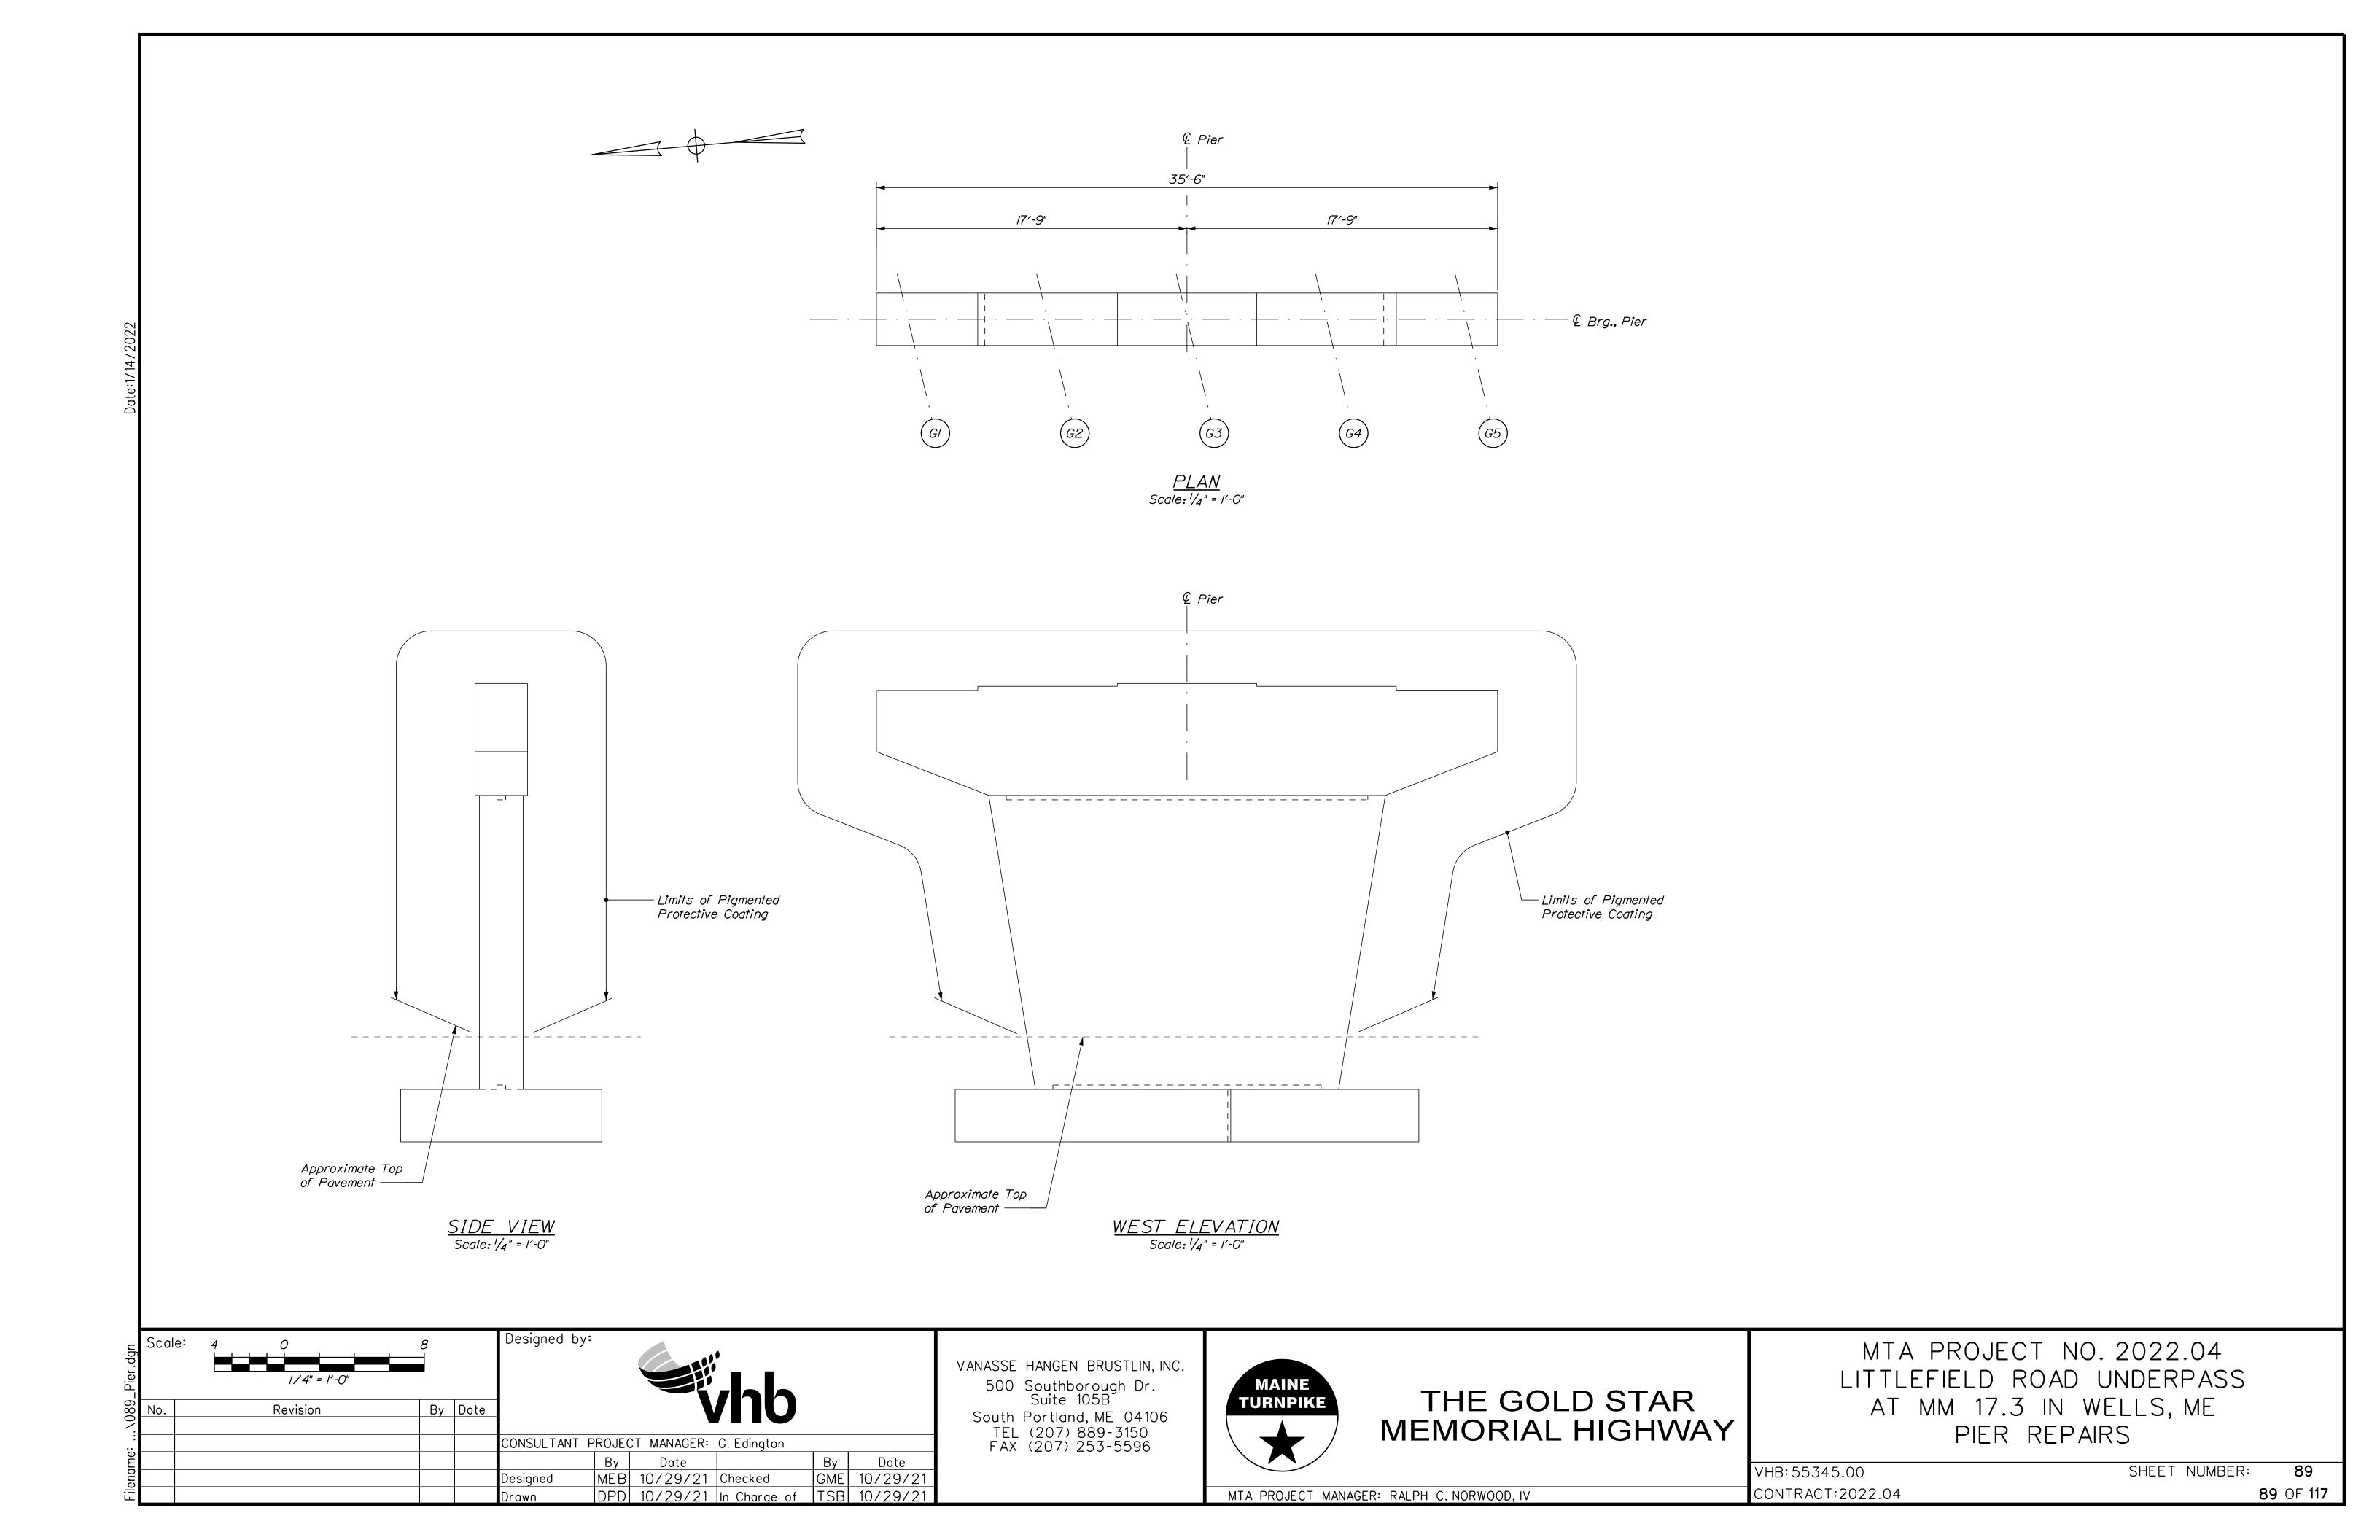

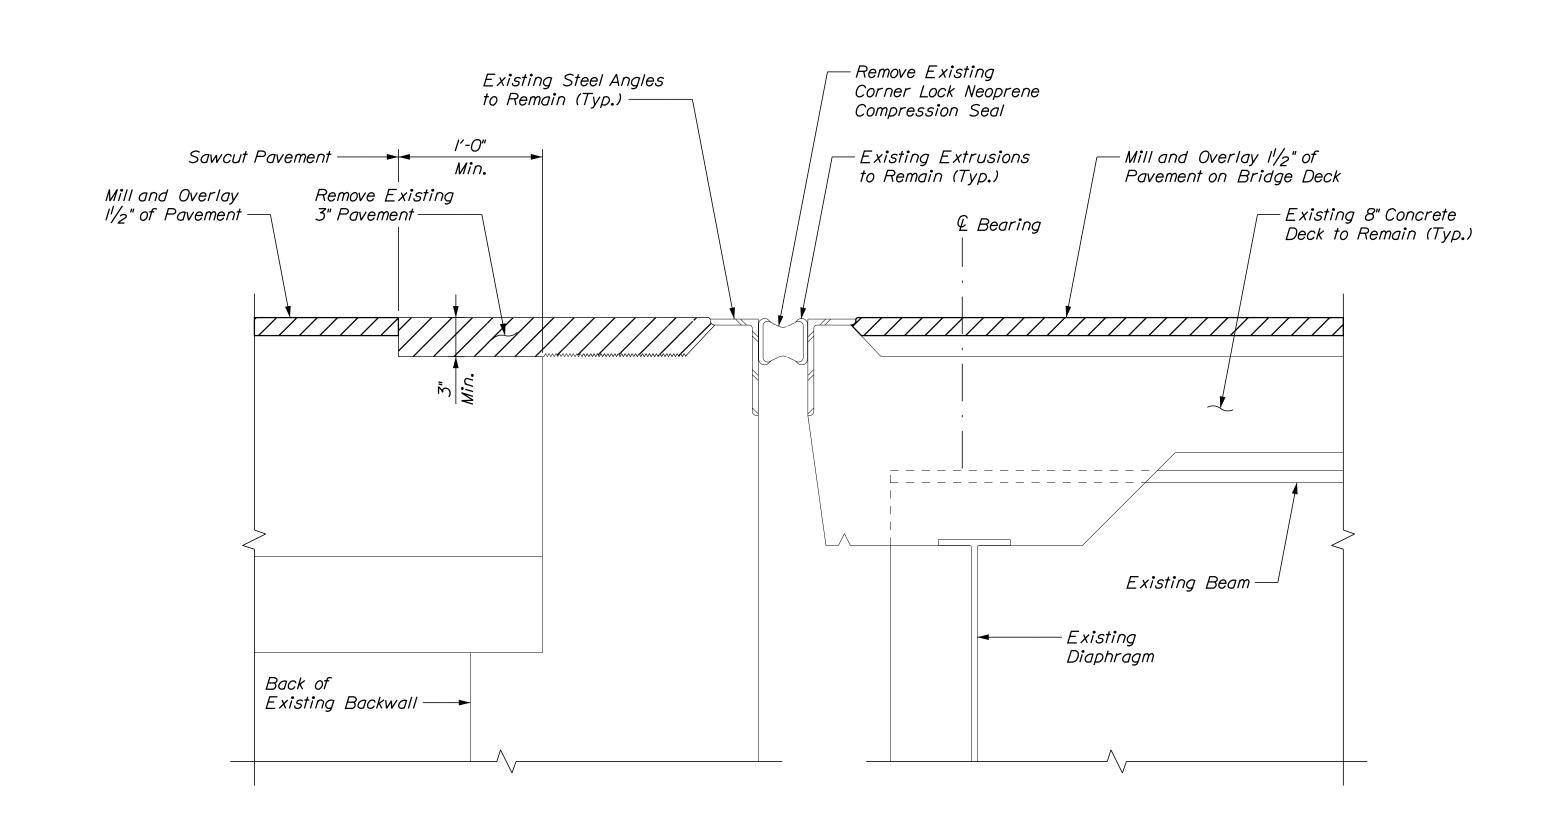

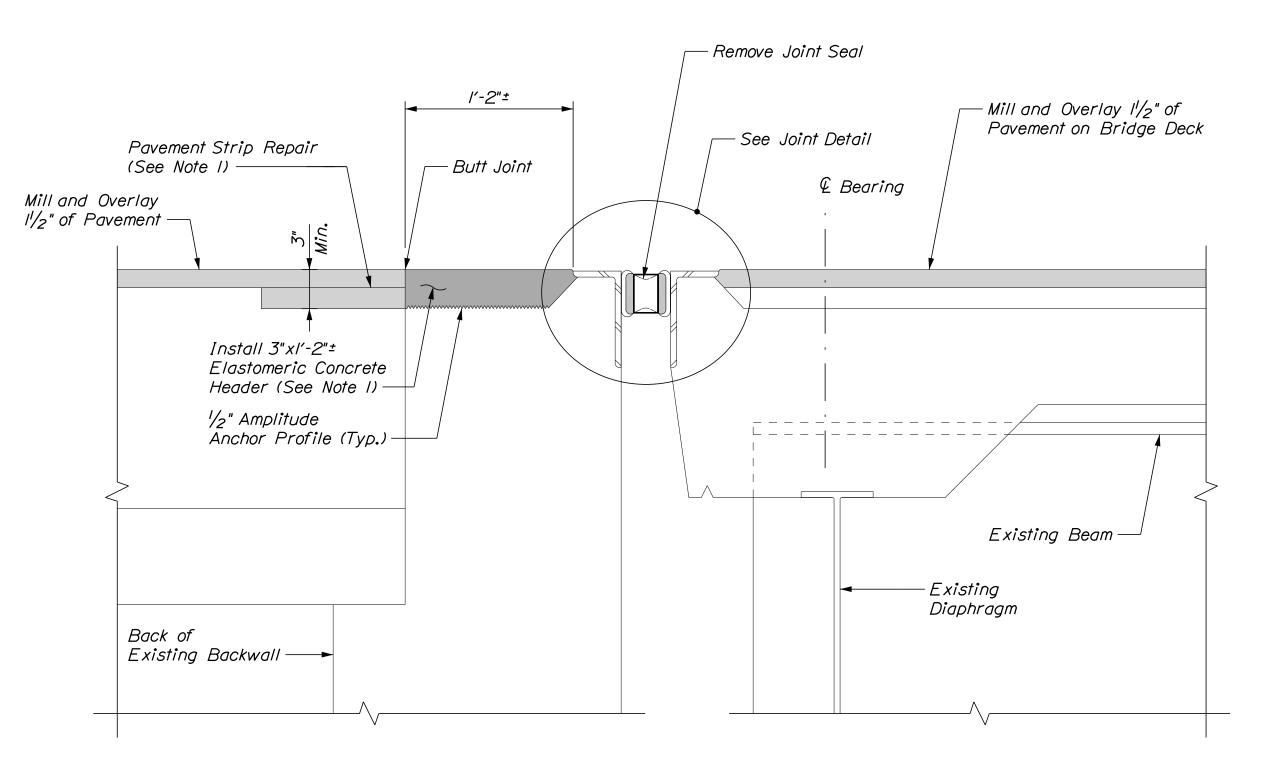

EXISTING EXPANSION JOINT SECTION

PROPOSED EXPANSION JOINT SECTION

SECTIONS AT EXPANSION JOINT

AT ABUTMENT I

Not to Scale

Replace Joint Seal with Silicone
Coated Precompressed Seal
(See Note 2)

Fill Existing Joint Extrusions
with Sika 35. (Typ.) (See Note 3)

NOTES

I. Pavement Header
Printers

<u>JOINT DETAIL</u>

- I. Pavement Strip Repair and Elastomeric Concrete Header shall be incidental to Item 520.2406, Bridge Joint Modification (Littlefield Road).
- 2. Silicone Coated and Pre-Compressed Seal shall be paid under Item 520.234, Expansion Device Silicone Coated and Pre-Compressed Seal.
- 3. Filling existing joint extrusions with Sika 35 shall be incidental to Item 520.234, Expansion Device Silicone Coated and Pre-Compressed Seal.

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MAINE
TURNPIKE


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MTA PROJECT NO. 2022.04
LITTLEFIELD ROAD UNDERPASS
AT MM 17.3 IN WELLS, ME
BRIDGE JOINT MODIFICATIONS

VHB: 55345.00 CONTRACT: 2022.04 SHEET NUMBER: 90

MTA PROJECT MANAGER: RALPH C. NORWOOD, IV

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<u>NOTE</u>

I. The bottom slope protection panel shall be sawcut 2'-0" from existing ground and replaced in-kind as directed by the Resident. Class A Concrete shall be used for replacing concrete slope protection. This work shall be paid for under Item 518.921 Slope Protection Concrete Repairs.
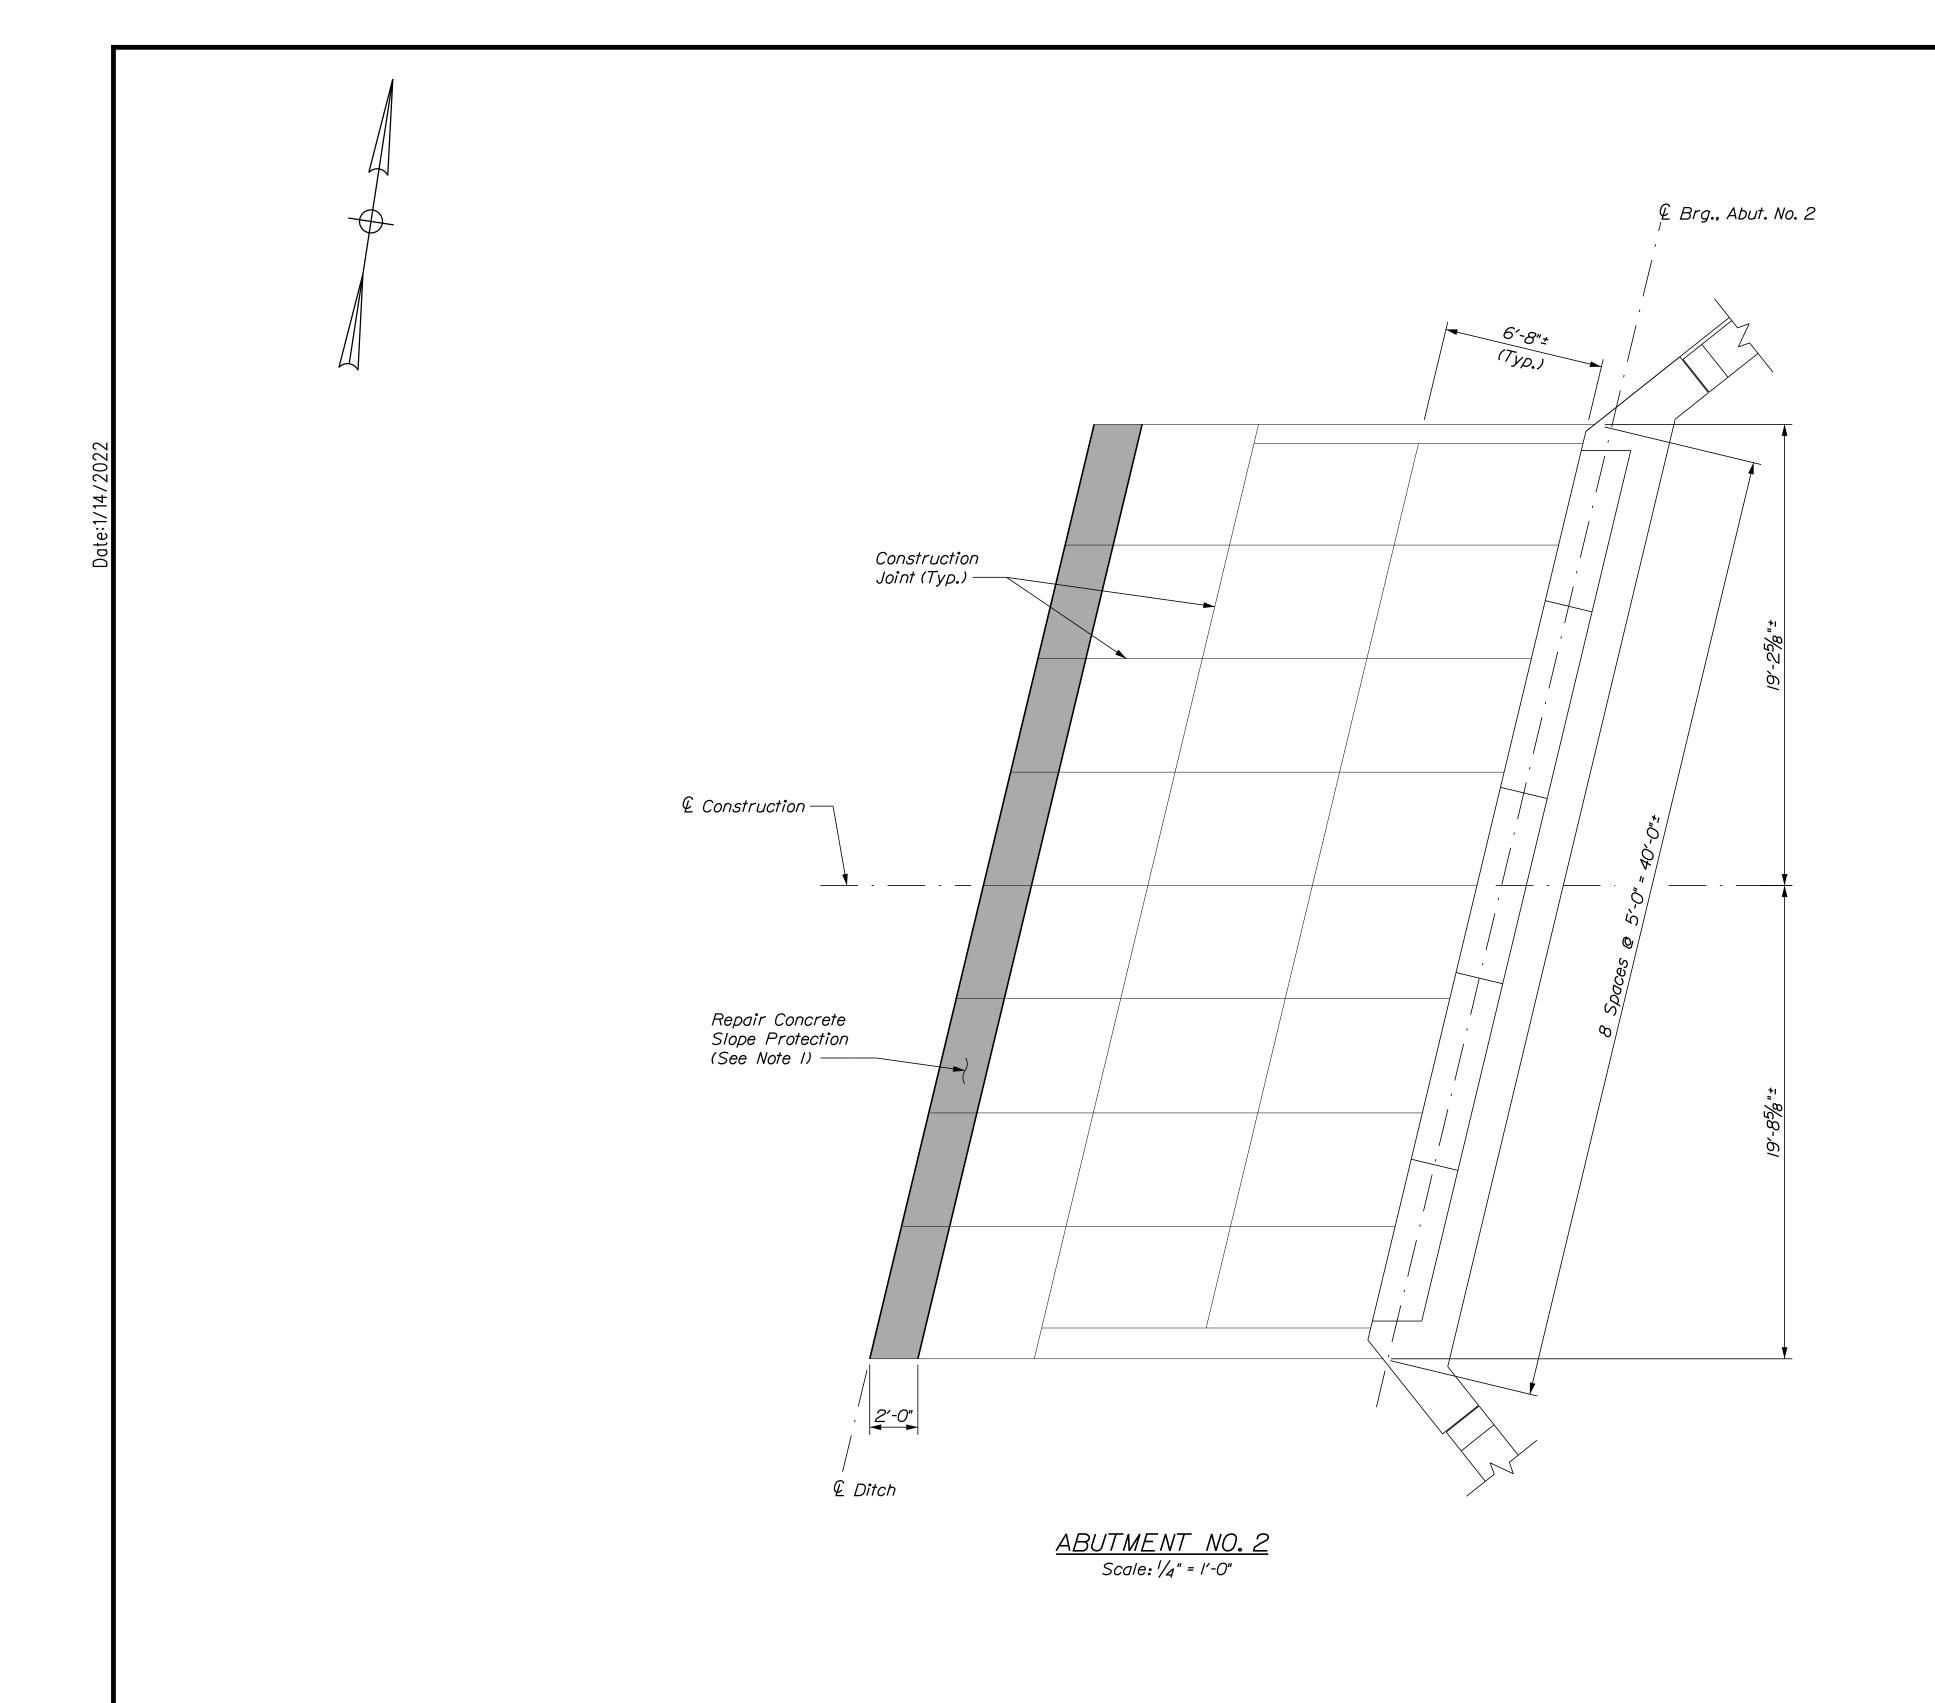
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THE GOLD STAR MEMORIAL HIGHWAY

MTA PROJECT NO. 2022.04 LITTLEFIELD ROAD UNDERPASS AT MM 17.3 IN WELLS, ME SLOPE PROTECTION REPAIRS

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NORTHBOUND EVR EARTHWORK SUMMARY

NOTHING BUTTON	Otto Somment	
COMMON EXCAVATION FOR ESTIMATE		
COMMON EXCAVATION (FROM CROSS SECTIONS)	987	
EARTH FROM RAMP REMOVAL	167	
GRUBBING IN FILL	288	
TOTAL COMMON EXCAVATION (for estimate)	1,442	,
FILL FOR BORROW CALCULATIONS		
COMMON FILL (FROM CROSS SECTIONS)	<u> </u>	
GRUBBING IN FILL	288	
TOTAL FILL	447	,
AVAILABLE COMMON EXCAVATION FOR BORROW CALCULA	ATIONS	
(1) TOTAL COMMON EXCAVATION	1,442	,
DEDUCTIONS:		
GRUBBING IN CUT	579_	
GRUBBING IN FILL	288	
(2) TOTAL DEDUCTIONS	867	_
TOTAL AVAILABLE COMMON EXCAVATION (1) MINUS (2)	575)
COMPUTATION FOR COMMON BORROW FOR ESTIMATE		
(3)TOTAL FILL	447	_
TOTAL AVAIL. NON-ROCK EXCAV. 57	$75 \times 0.90 = 518$	
(4)TOTAL AVAILABLE EXCAVATION	518)
SURPLUS MATERIAL = AVAILABLE EXCAVATION MINUS TOTAL	L FILL 71	_
<u>SOUTHBOUND EVR EARTHW</u>	ORK SUMMARY	

COMMON EXCAVATION FOR ESTIMATE		
COMMON EXCAVATION (FROM CROSS SECTIONS)	339	
EARTH FROM RAMP REMOVAL	65	
GRUBBING IN FILL	100	
MUCK EXCAVATION	151	
TOTAL COMMON EXCAVATION (for estimate)		655
FILL FOR BORROW CALCULATIONS		
COMMON FILL (FROM CROSS SECTIONS)	152	
GRUBBING IN FILL	100	
MUCK EXCAVATION	151	
TOTAL FILL		403
AVAILABLE COMMON EXCAVATION FOR BORROW CALCULATIONS		
(1) TOTAL COMMON EXCAVATION		655
DEDUCTIONS:		
GRUBBING IN CUT	77	
GRUBBING IN FILL	100	
MUCK EXCAVATION	<u> 151</u>	
(2) TOTAL DEDUCTIONS		328
TOTAL AVAILABLE COMMON EXCAVATION (1) MINUS (2)		327
COMPUTATION OF GRANULAR BORROW FOR ESTIMATE		
GRANULAR BORROW TO REPLACE MUCK	151	
GRANULAR BORROW =	<u> </u>	151
COMPUTATION FOR COMMON BORROW FOR ESTIMATE		
(3)TOTAL FILL		403
TOTAL AVAIL. NON-ROCK EXCAV. $327 \times 0.90 = $	294	
(4)TOTAL AVAILABLE EXCAVATION		294
BORROW NEEDED = TOTAL FILL MINUS TOTAL AVAILABLE EXCAVAT	ΠΟΝ <u> </u>	109
GRANULAR BORROW TO REPLACE MUCK	151_	
SURPLUS MATERIAL = AVAILABLE EXCAVATION MINUS TOTAL FILL PLUS GI	RANULAR BORROW	42

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				Drawn	BMD	10/29/21	In Charge of	AG	10/29/2

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Suite 105B
South Portland, ME 04106
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THE GOLD STAR MEMORIAL HIGHWAY

LITTLEFIELD ROAD
EMERGENCY VEHICLE RAMPS
EARTHWORK SUMMARY

 VHB: 55345.00
 SHEET NUMBER: 92

 CONTRACT: 2022.04
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- 3. ALL EXISTING DELINEATOR AND MILE MARKER POSTS WITHIN LIMITS OF DISTURBANCE SHALL BE REMOVED AND RESET UPON COMPLETION OF THE CONTRACT. PAYMENT WILL BE MADE UNDER ITEM 606.3561.
- 4. EXISTING ROW FENCE AND EXISTING CHAIN LINK
 FENCE AND GATES WITHIN THE LIMITS OF WORK, AS SHOWN
 ON THE PLANS OR AS DIRECTED BY THE RESIDENT, SHALL
 BE REMOVED AND DISPOSED. THIS WORK SHALL BE
 INCIDENTAL TO THE PROPOSED FENCE ITEMS. PROPOSED
 CHAIN LINK FENCE AND PIPE ENTRY GATE SHALL BE
 INSTALLED CONTINUOUSLY WITH NO GAPS. IF REQUIRED,
 CONNECTION FOR PROPOSED FENCE TO EXISTING FENCE
 SHALL BE INCIDENTAL TO THE CONTRACT.
- 5. THE PROPOSED ELEVATIONS ARE BASED ON THE NAVD 88 DATUM.
- 6. THE CONTRACTOR SHALL TAKE ALL PRECAUTIONS
 NECESSARY TO AVOID IMPACTS BEYOND WHAT IS SHOWN IN
 THESE PLANS TO DELINEATED WETLAND AREAS.

EARTHWORK

- I. THE CLEARING LIMITS SHALL BE 10' BEYOND AND PARALLEL TO CONSTRUCTION SLOPE LINES OR AS SHOWN ON THE PLANS. THE ACTUAL CLEARING LINES SHALL BE ESTABLISHED IN THE FIELD BY THE CONTRACTOR AND SHALL BE APPROVED BY THE RESIDENT PRIOR TO ANY CLEARING TAKING PLACE. ALL CLEARING SHALL BE DONE WITHIN THE ROW. NO CLEARING SHALL TAKE PLACE IN JUNE OR JULY.
- 2. THE NORMAL GRUBBING WIDTH IN THE FILLS SHALL BE VARIABLE LEFT OR RIGHT, WHEN SUBGRADE IS LESS THAN 5' ABOVE OLD GROUND. THE GRUBBING DEPTH HAS BEEN ESTIMATED AS 12".
- 3. MUCK EXCAVATION HAS BEEN ESTIMATED IN ALL WETLAND AREAS AT A 2' DEPTH. THE CONTRACTOR SHALL CONFIRM WITH THE RESIDENT THE ACTUAL LIMITS AND DEPTH BEFORE PLACING ANY AGGREGATE.
- 4. WASTE MATERIALS SHALL BE DISPOSED OFF THE PROJECT SITE, IN ACCORDANCE WITH CHAPTER 404, DEPARTMENT OF ENVIRONMENTAL PROTECTION SOLID WASTE MANAGEMENT RULES.
- 5. EXCAVATIONS ACCOMPLISHED AS PART OF THIS PROJECT SHALL BE CONSTRUCTED IN ACCORDANCE WITH OSHA SUBPART P OF 29 CFR PART 1926.650-652 (CONSTRUCTION STANDARDS FOR EXCAVATION).
- 6. THE CONTRACTOR SHALL MINIMIZE SLOPE DISTURBANCES WHERE POSSIBLE, AS DIRECTED BY THE RESIDENT.
- 7. GRANULAR BORROW USED TO BACKFILL MUCK EXCAVATION, IN LOW WET AREAS I' ABOVE WATER LEVEL, OR OLD GROUND SHALL MEET REQUIREMENTS FOR GRANULAR BORROW MATERIAL FOR UNDERWATER BACKFILL AS SPECIFIED IN STANDARD SPECIFICATION 703.19.

GUARDRAIL

- I. COMPOSITE OFFSET BLOCKS SHALL BE USED WITH GUARDRAIL.
- 2. AT THE END OF EACH WORK DAY, ALL GUARDRAIL WITHIN WORK AREAS ACCESSIBLE TO TRAFFIC SHALL HAVE AN APPROVED CRASHWORTHY END TREATMENT.
- 3. CONNECTIONS FOR PROPOSED GUARDRAIL TO EXISTING GUARDRAIL SHALL BE INCIDENTAL TO THE PROPOSED GUARDRAIL ITEMS.
- 4. CONTRACTOR SHALL STOCKPILE ALL GUARDRAIL TO BE REMOVED AND RESET, AND REMOVED AND DISPOSED UNTIL GUARDRAIL INSTALLATION HAS BEEN COMPLETED.
- 5. POST HOLES FROM GUARDRAIL REMOVED OR RESET SHALL BE FILLED AND COMPACTED WITH GRANULAR BORROW AND PAVEMENT TO MATCH SURROUNDING PAVEMENT THICKNESS.

<u>DRAINAGE</u>

- I. NO EXISTING DRAINAGE SHALL BE ABANDONED, REMOVED OR PLUGGED WITHOUT PRIOR APPROVAL OF THE RESIDENT.
- 2. INLETS AND OUTLETS OF ALL CULVERTS SHALL BE RIPRAPPED UNLESS OTHERWISE NOTED ON THE PLANS OR DIRECTED BY THE RESIDENT.
- 3. ALL DITCH ELEVATIONS AND OFFSETS SHOWN ON THE CROSS SECTIONS ARE FOR THE FINISHED DITCH FLOW LINE.
- 4. IF FOUNDATION MATERIAL IS REQUIRED UNDER CULVERTS, IT SHALL MEET THE REQUIREMENTS FOR GRANULAR BORROW UNDERWATER BACKFILL AS SPECIFIED IN STANDARD SPECIFICATION 703.19 AND BE PAID FOR AS 203.25 GRANULAR BORROW.

EROSION CONTROL

- I. THE ANTICIPATED EROSION CONTROL DEVICES ARE SHOWN ON THE PLANS. THE CONTRACTOR SHALL PROPOSE ACTUAL TYPE AND LOCATION OF DEVICES FOR APPROVAL BY THE RESIDENT. ADDITIONAL DEVICES MAY BE PROPOSED BY THE CONTRACTOR TO IMPLEMENT ADDITIONAL MEASURES. ANY ADDITIONAL MEASURES APPROVED BY THE RESIDENT WILL BE MEASURED FOR PAYMENT.
- 2.4" LOAM HAS BEEN ESTIMATED FOR 100% OF THE DISTURBED AREA UNLESS OTHERWISE SPECIFIED ON THE PLANS. ACTUAL PLACEMENT OF THE LOAM SHALL BE AS DESIGNATED BY THE RESIDENT.
- 3. ALL SLOPES SHALL BE SEEDED WITH SEEDING METHOD #2.
- 4. TEMPORARY SEED SHALL BE APPLIED TO ALL DISTURBED AREAS THAT WILL NOT BE COMPLETED WITHIN 30 DAYS.
- 5. ALL TEMPORARY AND PERMANENT EROSION CONTROL DEVICES SHALL BE INSTALLED IN ACCORDANCE WITH THE MAINE DEPARTMENT OF TRANSPORTATION BEST MANAGEMENT PRACTICES.
- 6. TEMPORARY STONE CHECK DAMS SHALL BE INSTALLED IN ACCORDANCE WITH THE MAINE DEPARTMENT OF TRANSPORTATION BEST MANAGEMENT PRACTICES. STONE CHECK DAMS SHALL BE SPACED APPROXIMATELY 100 FEET FOR DITCH GRADES LESS THAN 3% AND SPACED APPROXIMATELY 50 FEET FOR DITCH GRADES STEEPER THAN 5%. SEE MAINEDOT BEST MANAGEMENT PRACTICES FOR FURTHER DETAILS.
- 7. EROSION CONTROL BLANKET, ITEM 613.319 SHALL BE INSTALLED ON 2:1 SLOPES FROM THE TOP TO TOE OF SLOPE. LOAM AND SEED SHALL BE PLACED PRIOR TO THE INSTALLATION OF THE EROSION CONTROL BLANKET, LIMITS OF THE EROSION CONTROL BLANKET IN DITCHES SHALL BE 6'WIDE OR AS DESIGNATED BY THE RESIDENT.

UTILITY

I. EXISTING UTILITIES ON THESE PLANS WERE COMPILED FROM FIELD SURVEY AND VARIOUS OTHER SOURCES. LOCATIONS ARE NOT GUARANTEED TO BE ACCURATE NOR IS IT GUARANTEED THAT ALL UTILITIES ARE SHOWN, NO SEPARATE OR ADDITIONAL COMPENSATION WILL BE ALLOWED TO THE CONTRACTOR DUE TO ANY VARIANCE BETWEEN THE DATA SHOWN ON THE PLANS AND THE ACTUAL FIELD CONDITIONS ENCOUNTERED. NO WORK SHALL BE STARTED UNTIL THE OWNERS OF THE VARIOUS UTILITIES ARE NOTIFIED BY THE CONTRACTOR OF THE PROPOSED CONSTRUCTION, THE CONTRACTOR SHALL CONTACT DIG SAFE (I-888-DIG-SAFE OR 811) PRIOR TO STARTING WORK. IN ADDITION, DIG SMART OF MAINE SHALL BE CONTACTED PRIOR TO STARTING ANY WORK WITHIN MTA RIGHT-OF-WAY. CONTRACTOR SHALL BE RESPONSIBLE FOR ANY COSTS. PROOF OF UTILITY LOCATION FROM BOTH DIG SAFE AND DIG SMART (WHEN APPLICABLE) SHALL BE SUBMITTED PRIOR TO THE COMMENCEMENT OF ANY WORK.

2. ALL UTILITY FACILITIES SHALL BE ADJUSTED BY THE RESPECTIVE UTILITIES UNLESS NOTED.

- 3. THE UTILITIES INVOLVED IN THIS CONTRACT ARE:

 CENTRAL MAINE POWER (CMP)

 CONSOLIDATED COMMUNICATIONS

 KENNEBUNK & WELLS WATER DISTRICT

 CHARTER COMMUNICATIONS, INC.
- 4. GRADING AROUND UTILITY POLES AND GUY WIRES, EXISTING OR PROPOSED, SHALL BE DONE BY HAND.

<u>ITEM 603.179 - 18" CULVERT PIPE OPTION III</u> HDPE ONLY

<u>LOCATION</u>	QUANTITY (LF)
<i>LITTLEFIELD RD NB EVR</i>	
<i>30+38</i>	<i>38</i>
<i>35+50</i>	50
LITTLEFIELD RD SB EVR	
41+56.96	30

<u>ITEM 606.242 - GUARDRAIL TYPE 3D - OVER 15'</u> RADIUS

<u>STATION</u>	TO	STAT	<u> ION</u>	<u>(</u>	<u>OFFSET</u>	<u>RADIUS</u>	<u>QUANTITY</u>	(<u>LF)</u>
LITTLEFI	ELD	RD	SB	EVR				
40+17 TO	40+	<i>2</i> 7			LT	<i>30′</i>	25	

<u>ITEM 606.265 - TERMINAL END - SINGLE RAIL</u> <u>GALVANIZED STEEL</u>

<u>STATION</u>	<u>OFFSET</u>	QUANTITY (EA)
LITTLEFIELD RD SB EVR		
<i>40+36</i>	LT	1

ITEM 606.278 - TERMINAL END - ANCHORED END

<u>STATION TO STATION</u>	<u>OFFSET</u>	QUANTITY (EA)
LITTLEFIELD RD SB EVR 40+27 TO 40+36	LT	1

<u>ITEM 606.353 - REFLECTORIZED FLEXIBLE GUARDRAIL</u> <u>MARKER</u>

<u>STATION</u>	<u>OFFSET</u>	QUANTITY (EA)
LITTLEFIELD RD SB EVR 40+36		2
70.30	<i>L</i> /	2

ITEM 606.3631 - GUARDRAIL REMOVE AND DISPOSE

<u>STATION</u>	QUANTITY (LF)
LITTLEFIELD RD SB EVR	
40+17	<i>25</i>

ITEM 607.17 - CHAIN LINK FENCE - 6 FOOT

<u>STATION TO STATION</u>	<u>OFFSET</u>	QUANTITY (LF)
LITTLEFIELD RD NB EVR		
34+84 TO 34+86	RT	20
<i>34+86 TO 35+02</i>	LT	20

ITEM 607.2325 - PIPE ENTRY GATE

<u>STATION</u> LITTLEFIELD RD	ND EVD	QUANTITY (EA)
34·86	ND EVA	1
<i>LITTLEFIELD RD</i> 45+47	SB EVR	1

ITEM 610.08 - PLAIN RIPRAP

STATION	<u>OFFSET</u>	QUANTITY (CY)
LITTLEFIELD RD NB EVR 30+33	RT	1.2
30+40 35+25	LT LT	0.9 8.3
35+50 35+50	LT RT	1.2 1.2
<i>LITTLEFIELD RD SB EVR</i> 41+56 . 96	LT	1.0
<i>41+56.96</i>	RT	1.0

ITEM 610.181 - TEMPORARY STONE CHECK DAM

<u>STATION</u>	<u>OFFSET</u>	QUANTITY (CY)
LITTLEFIELD RD NB EVR		
30+40 TO 35+45	LT	<i>8.</i> 0
31+50 TO 35+45	RT	6.0

ITEM 613.319 - EROSION CONTROL BLANKET

<u>STATION TO STATION</u> LITTLEFIELD RD NB EVR	<u>OFFSET</u>	QUANTITY (SY)
30+40 TO 35+50	LT	<i>356</i>
31+50 TO 35+50	RT	293
35+50 TO 35+60	LT	9
NEAR FORMER RAMP GATE		42
LITTLEFIELD RD SB EVR		
41+48 TO 42+75	LT	68

ITEM 620.58 - EROSION CONTROL GEOTEXTILE

<u>STATION</u>	<u>OFFSET</u>	<u>QUANTITY (SY)</u>
LITTLEFIELD RD NB EVR		
<i>30+33</i>	RT	7 . 9
<i>30+40</i>	LT	5 . 4
<i>35+25</i>	LT	17.4
<i>35+50</i>	LT	8 . 8
<i>35+50</i>	RT	7 . /
LITTLEFIELD RD SB EVR		
<i>41+56.96</i>	LT	4.4
<i>41+56.96</i>	RT	4. 7

ITEM 656.632 - 30" TEMPORARY SILT FENCE

<u>STATION TO STATION</u>	<u>OFFSET</u>	QUANTITY (LF
LITTLEFIELD RD NB EVR		
30+15 TO 30+75	RT	77
30+15 TO 32+50	LT	189
31+00 TO 35+76	RT	500
35+31 TO 35+76	LT	<i>52</i>
LITTLEFIELD RD SB EVR		
40+38 TO 46+14 . 56	RT	<i>673</i>
45+50 TO 46+14 . 56	LT	79

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Suite 105B
South Portland, ME 04106


South Portland, ME 04106 TEL (207) 889-3150 FAX (207) 253-5596




THE GOLD STAR MEMORIAL HIGHWAY


LITTLEFIELD ROAD
EMERGENCY VEHICLE RAMPS
GENERAL AND CONSTRUCTION NOTES

VHB: 55345.00 SHEET NUMBER: 93
CONTRACT: 2022.04 93 OF 117

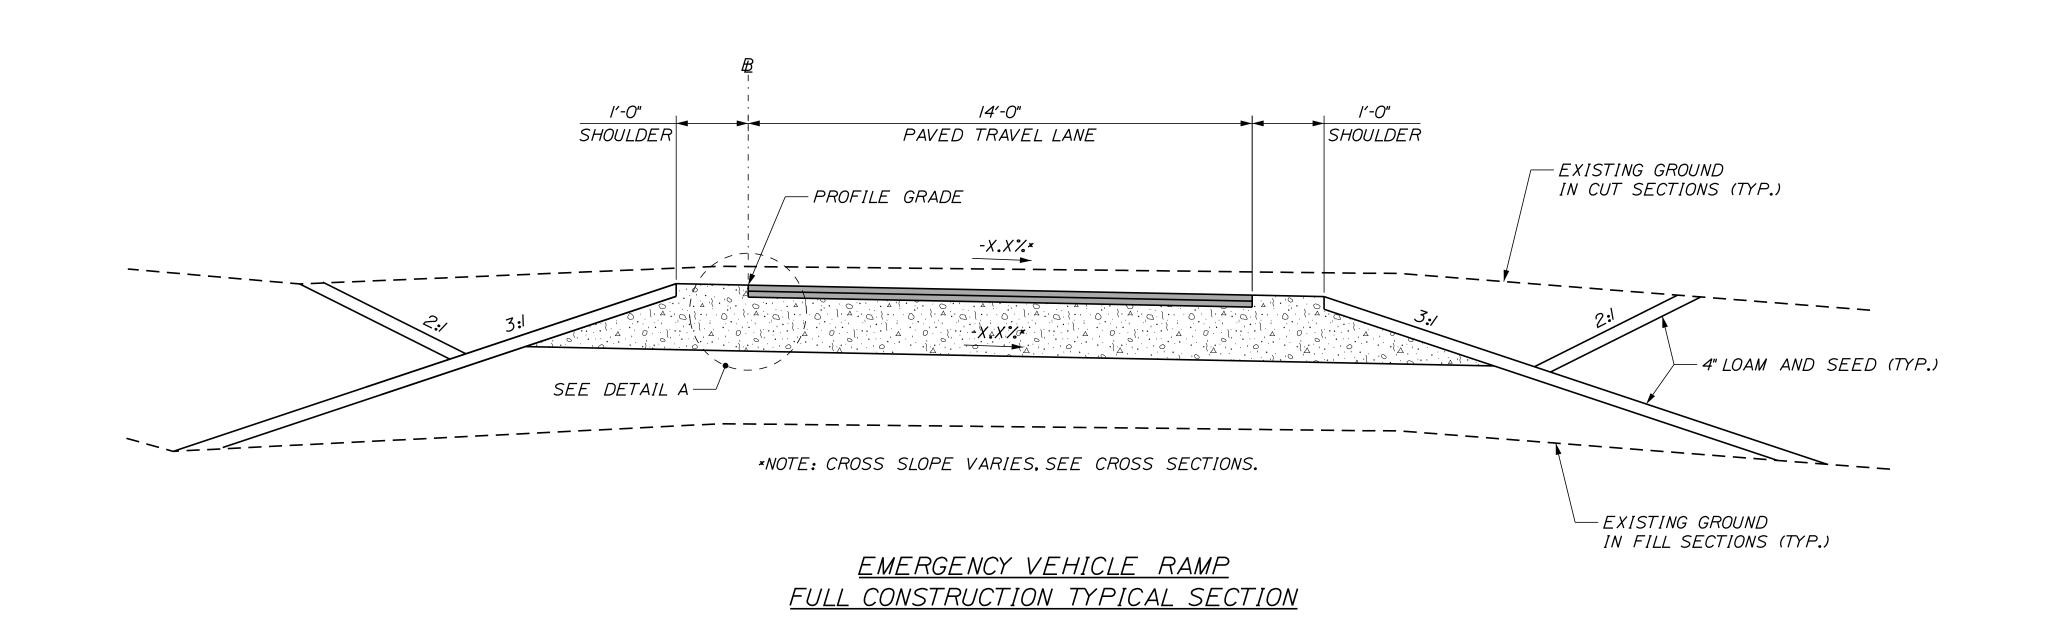

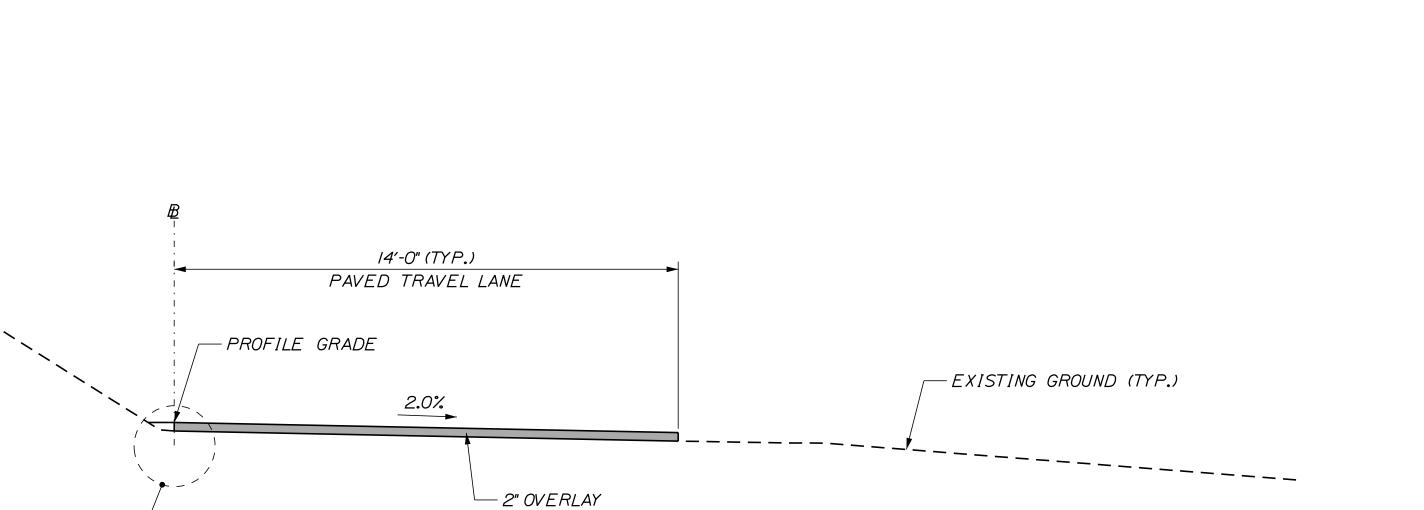


EMERGENCY VEHICLE RAMP OVERLAY TYPICAL SECTION

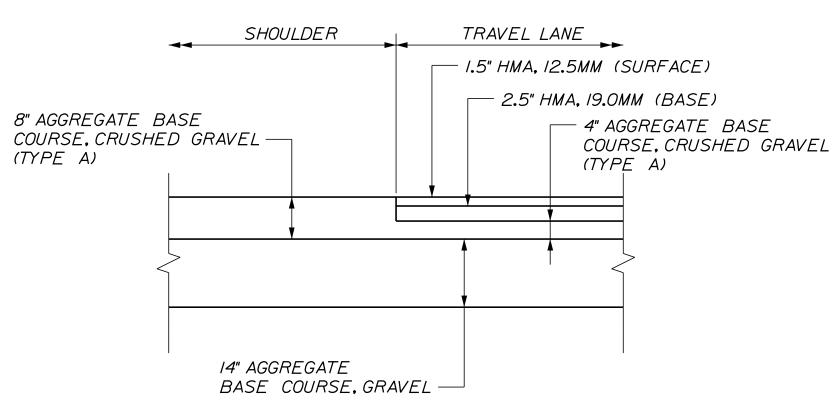

<u>DETAIL A</u>

TYPICAL EMERGENCY VEHICLE RAMP SECTION NOTES

- I. THE PAVEMENT, BASE, AND SUBBASE DEPTHS AS SHOWN ON PLANS ARE INTENDED TO BE NOMINAL.
- 2. ALL NECESSARY PAVEMENT CUTTING SHALL BE SAWCUT AND DONE IN SUCH A MANNER AS TO LEAVE A CLEAN VERTICAL FACE. SAWCUT SHALL BE PAID FOR UNDER ITEM 419.30, SAWCUT BITUMINOUS PAVEMENT.
- BITUMINOUS TACK COAT IS REQUIRED BETWEEN ALL LIFTS OF 3. PAVEMENT. BITUMINOUS TACK COAT IS REQUIRED ON ALL EXISTING PAVED OR MILLED SURFACES PRIOR TO PLACING PROPOSED PAVEMENT.

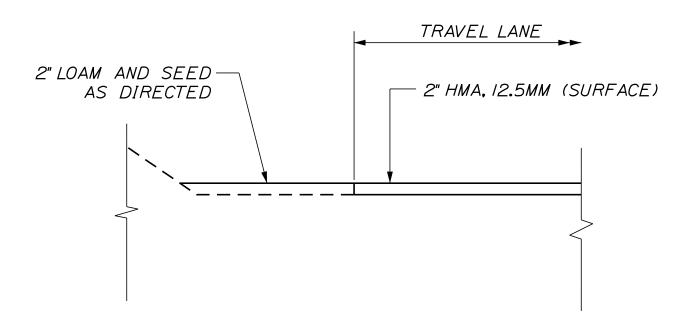

<u>DETAIL B</u>

Scale:	NOT TO	SCALE			Designed by	/:				
No.	Revision		Ву	Date				VI	U	
					CONSULTANT	PROJEC	CT MANAGER:	G. Edington		
						Ву	Date		Ву	Date
					Designed	BMD	10/29/21	Checked	ECF	10/29
					Drawn	BMD	10/29/21	In Charge of	AG	10/29

SEE DETAIL B-

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TURNPIKE

THE GOLD STAR MEMORIAL HIGHWAY

LITTLEFIELD ROAD EMERGENCY VEHICLE RAMPS TYPICAL ROADWAY SECTIONS

SHEET NUMBER: VHB: 55345.00 CONTRACT: 2022.04

MTA PROJECT MANAGER: RALPH C. NORWOOD, IV

94 OF 117

DIMENSIONS FOR SLOPE OF 2:1 G STONE STONE E F (FT) | (FT) | (FT) | (FT) | (FT) | DEPTH (CY)12" | 1.00 | 4.00 | 3.00 | 2.00 | 6.00 | 1.00 | 0.50 | 0.43 1.00 | 4.50 | 3.37 | 2.25 | 6.75 | 1.63 | 0.50 1.00 | 5.00 | 3.75 | 2.50 | 7.50 | 2.25 | 0.50 0.70 1.00 | 6.00 | 4.50 | 3.00 | 9.00 | 3.50 | 0.50 | 1.00 | 7.00 | 5.25 | 3.50 | 10.50 | 4.75 | 0.50


DIMENSIONS FOR SLOPE OF 4:1 (FT) | (FT) | (FT) | (FT) | (FT) | DEPTH | (CY) 1.00 | 8.00 | 6.00 | 2.00 | 6.00 | 0.00 | 0.50 0.73

1.00 | 9.00 | 6.75 | 2.25 | 6.75 | 0.00 | 0.50 0.93 1.00 | 10.00 | 7.50 | 2.50 | 7.50 | 0.00 | 0.50 1.13 | 1.00 | 12.00 | 9.00 | 3.00 | 9.00 | 0.00 | 0.50 1.62 1.00 | 14.00 | 10.50 | 3.50 | 10.50 | 0.00 | 0.50

DIMENSIONS FOR SLOPE OF 6:/ G STONE STONE $E \mid F$ (FT) (FT) (FT) (FT) (FT) DEPTH (CY) 12" | 0.50 | 9.00 | 7.50 | 1.50 | 4.50 | 0.00 | 0.50 0.50 | 10.50 | 8.75 | 1.75 | 5.50 | 0.00 | 0.50 0.98 0.50 | 12.00 | 10.00 | 2.00 | 6.50 | 0.00 | 0.50 1.19 24" | 0.50 | 15.00 | 12.50 | 2.50 | 8.00 | 0.00 | 0.50 1.81

NOTES:

- I. THE DIMENSIONS SHOWN ARE APPROXIMATE AND MAY BE MODIFIED BY THE RESIDENT.

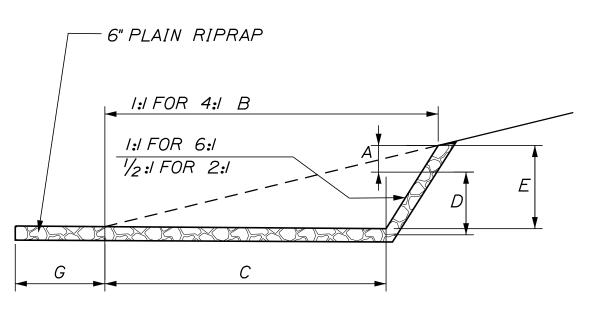

SECTION B-B


SECTION A-A

PLAIN RIPRAP --


(ITEM 610.08)


6" PLAIN RIPRAP

EROSION CONTROL GEOTEXTILE FABRIC

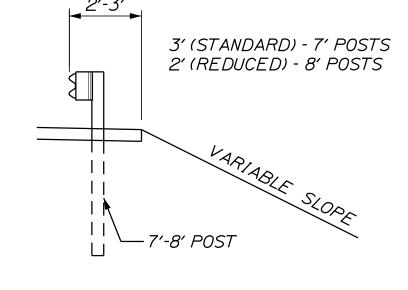

CROSS SECTION

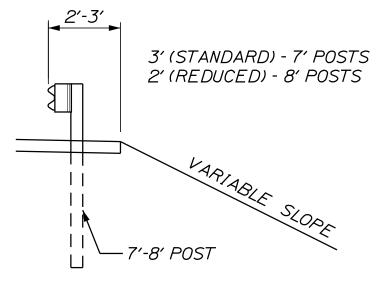

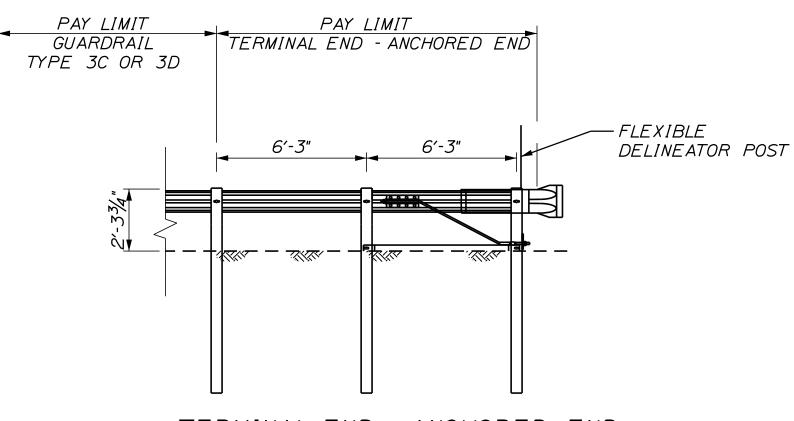

TERMINAL END - ANCHORED END (ITEM 606.278) NOT TO SCALE


30" | 0.50 | 18.00 | 15.00 | 3.00 | 9.50 | 0.00 | 0.50




2. STONE QUANTITIES ARE FOR ONE END OF THE PIPE.

ROADWAY CULVERT END SLOPE TREATMENT NOT TO SCALE

		SIGN	SUMN	1ARY	
		Text Dimens		C:=-	Ourotitu and Calor
	Sign	Letter Vertical Height Spacing		Size	Quantity and Color
RI-I	STOP	Text Dimens Shall Confo to "Stando Highway	orm ard	36"×36"	12 - WHITE ON RED
R5-II	AUTHORIZED VEHICLES ONLY	Signs" - 20	012 	30"x24"	14 - BLACK ON WHITE
R6-IR	ONE WAY			36"x12"	6 - BLACK ON WHITE

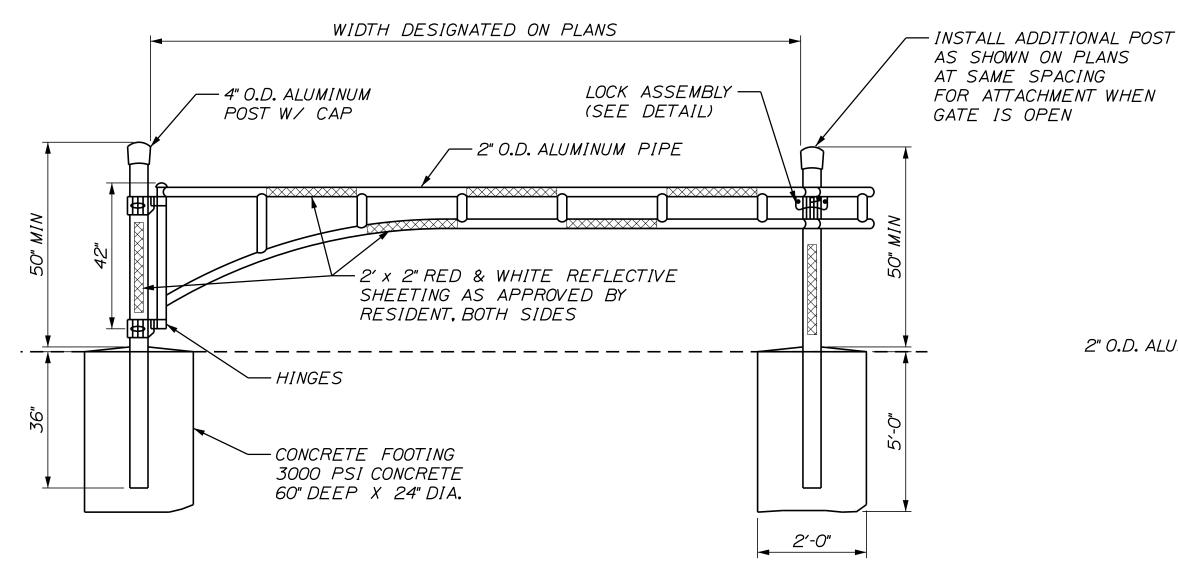

PIPE ENTRY GATE NOT TO SCALE

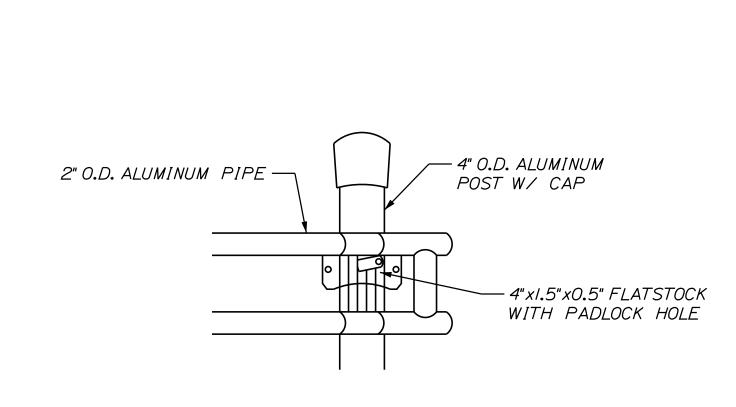

GENERAL GUARDRAIL INSTALLATION NOTES:

DOCUMENTS.

ANY MOT FEATURES.

THE GUARDRAIL INSTALLATION.

I. THE CONTRACTOR SHALL FOLLOW ALL MANUFACTURER'S INSTALLATION

TO BE INSTALLED. THE CONTRACTOR SHALL NOTIFY THE RESIDENT ENGINEER OF ANY CONFLICTS OR IRREGULARITIES BETWEEN THE

MANUFACTURER'S INSTALLATION INSTRUCTIONS AND THE CONTRACT

2. THE CONTRACTOR IS REQUIRED TO HAVE AN APPROVED CRASH END TREATMENT ON ALL GUARDRAIL ENDS PRIOR TO THE REMOVAL OF

3. THE CONTRACTOR SHALL REMOVE AND DISPOSE OF ALL CUT BOLTS,

DISCARD PARTS, TRASH, PAVEMENT DEBRIS, ETC., AFTER COMPLETING

INSTRUCTIONS FOR THE INSTALLATION OF ALL GUARDRAIL COMPONENTS

LOCK ASSEMBLY NOT TO SCALE

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No.	Revision	Ву	Date]			VII	U	
				CONSULTANT F	ROJEC	T MANAGER:	G. Edington		
					Ву	Date		Ву	Date
				Designed	BMD	10/29/21	Checked	EĆF	10/29/21
				Drawn	BMD	10/29/21	In Charge of	AG	10/29/21

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TEL (207) 889-3150 FAX (207) 253-5596




THE GOLD STAR MEMORIAL HIGHWAY


LITTLEFIELD ROAD EMERGENCY VEHICLE RAMPS DETAILS & SIGN SUMMARY

VHB: 55345.00

CONTRACT: 2022.04 95 OF 117

SHEET NUMBER:

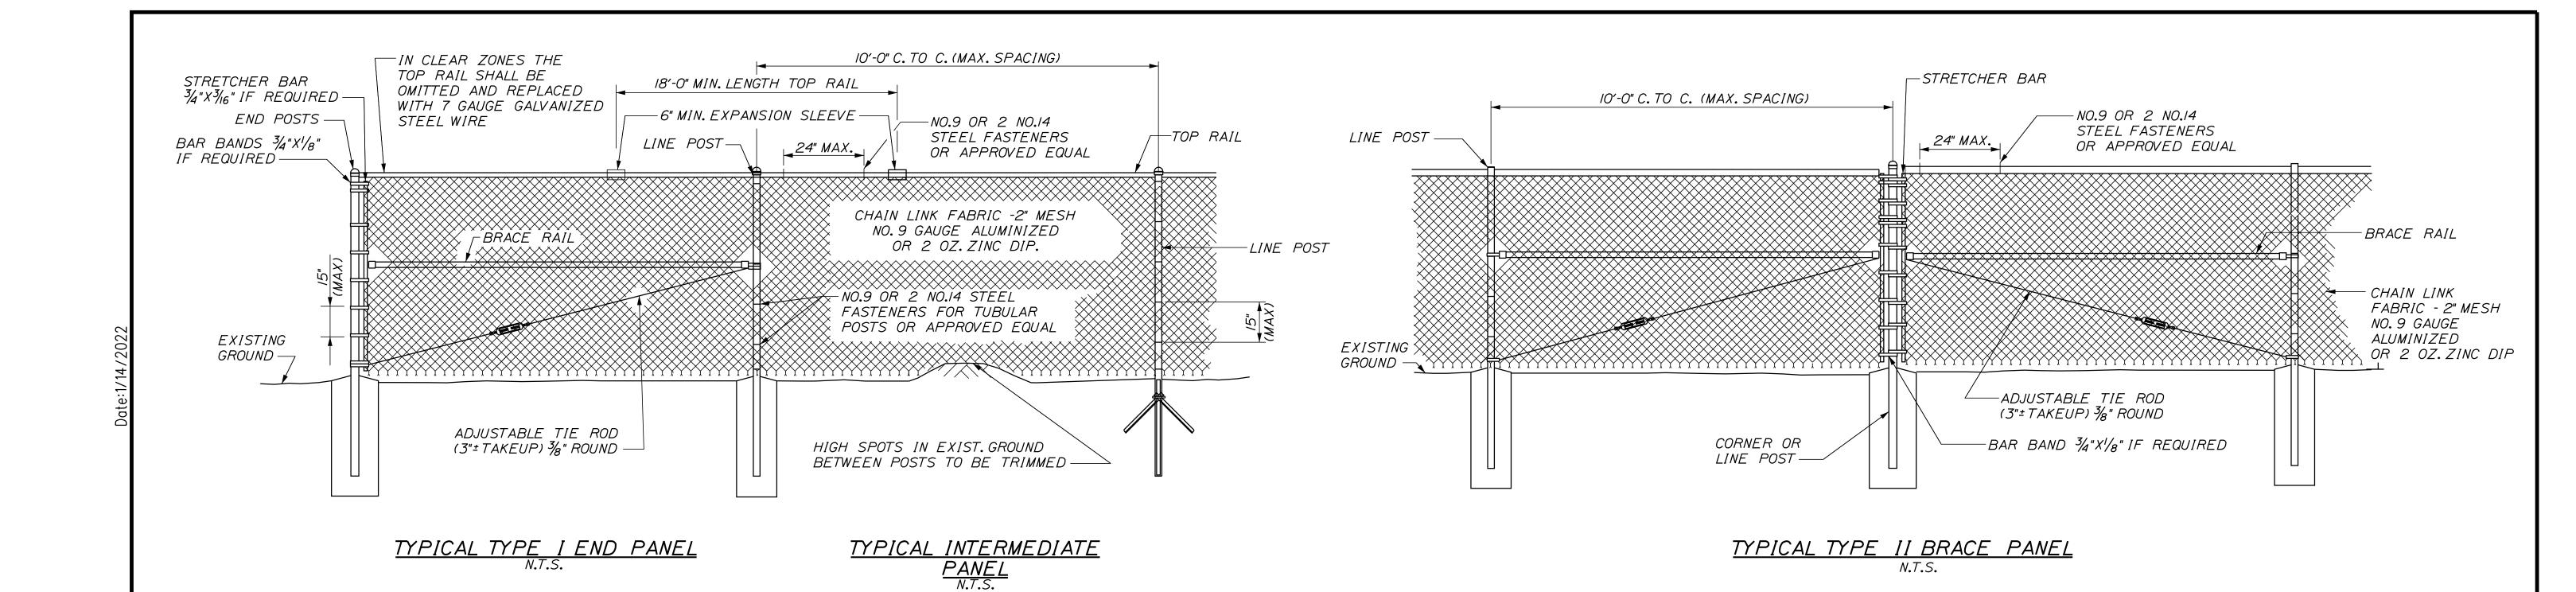

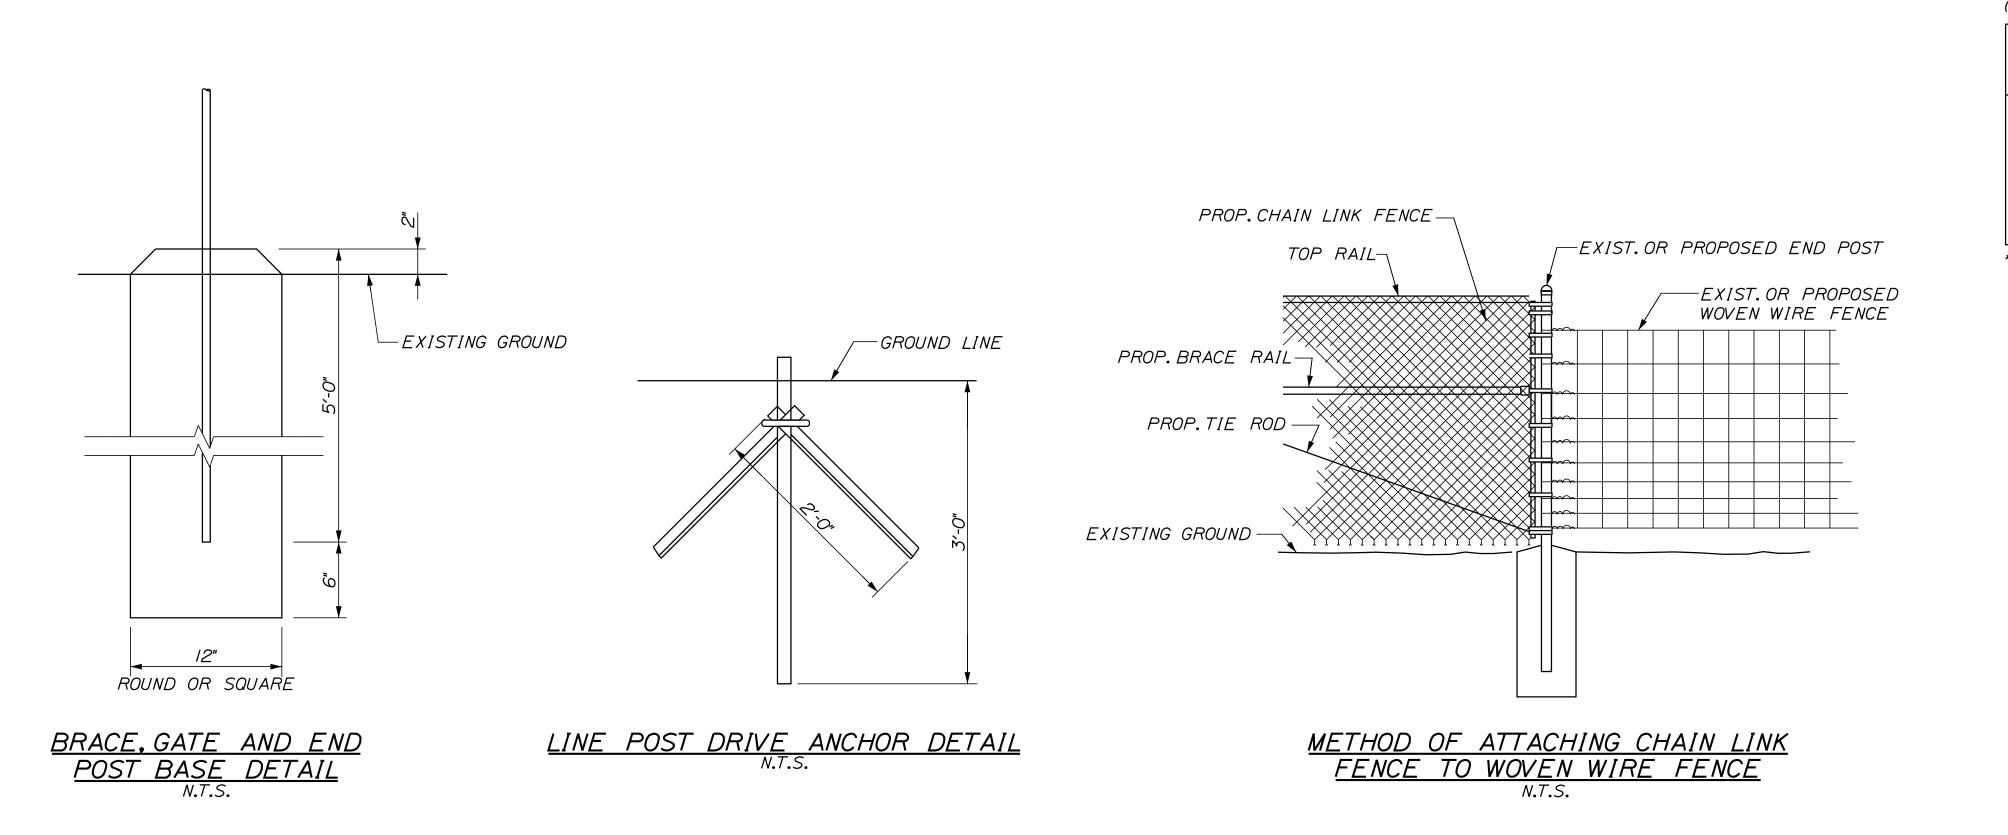

BENDING MOMENTS BASED ON GRADE I (SCHEDIIE 40 STEEL)

ISCHEDULE 40 STEEL	L)					
CHAIN LINK FENCE	SHAPE	NOMINAL SIZE (INCHES)	BENDING MOMENT* (LBSIN.)			
END & CORNER POSTS	φ	2 I.D.	14,025			
LINE POSTS	ϕ	I-1/2 I.D.	8,150			
TOP & BRACE RAILS	φ	1-1/4 I.D.	5,875			

* MATERIAL FOR GRADE 2 END, CORNER & LINE POSTS AND TOP & BRACE RAILS MUST MEET OR EXCEED BENDING MOMENTS FOR GRADE ISTEEL AS NOTED ABOVE.

<u>NOTES</u>

- I. BRACE PANELS SHALL BE INSTALLED WHERE THE CHANGE IN GRADE BETWEEN ANY THREE POSTS EXCEEDS 15 PERCENT.
- 2. NO ADDITIONAL PAYMENT WILL BE MADE FOR LONGER POSTS NECESSITATED BY LARGE GRADE DIFFERENTIAL.
- 3. TYPE I BRACING WILL BE USED AT FENCE ENDS. TYPE II BRACING WILL BE USED AT CORNER POSTS.
- 4. WHEN LEDGE IS ENCOUNTERED, STEEL POSTS SHALL BE SET AND GROUTED 12" DEEP UNLESS THE POSTS PENETRATE THE GROUND TO THE DEPTH INDICATED ON THE DRAWINGS.
- 5. CONCRETE FOR POST FOUNDATION SHALL BE CLASS B.
- 6. BRACE, GATE AND END POSTS SHALL BE SET IN CONCRETE.
- 7. CHAIN LINK FENCE SHALL BE INSTALLED WITH BARBS DOWN.
- 8. ALL COMPONENTS OF CHAIN LINK FENCE SHALL BE IN ACCORDANCE WITH AASHTO MI81.

Scale	NOT TO SCALE	-		Designed by	<i>y</i> :			h	
No.	Revision	Ву	Date	1			VII	U	
				CONSULTANT	PROJEC	T MANAGER:	G. Edington		
-					Ву	Date		Ву	Date
				Designed	BMD	10/29/21	Checked	ECF	10/29

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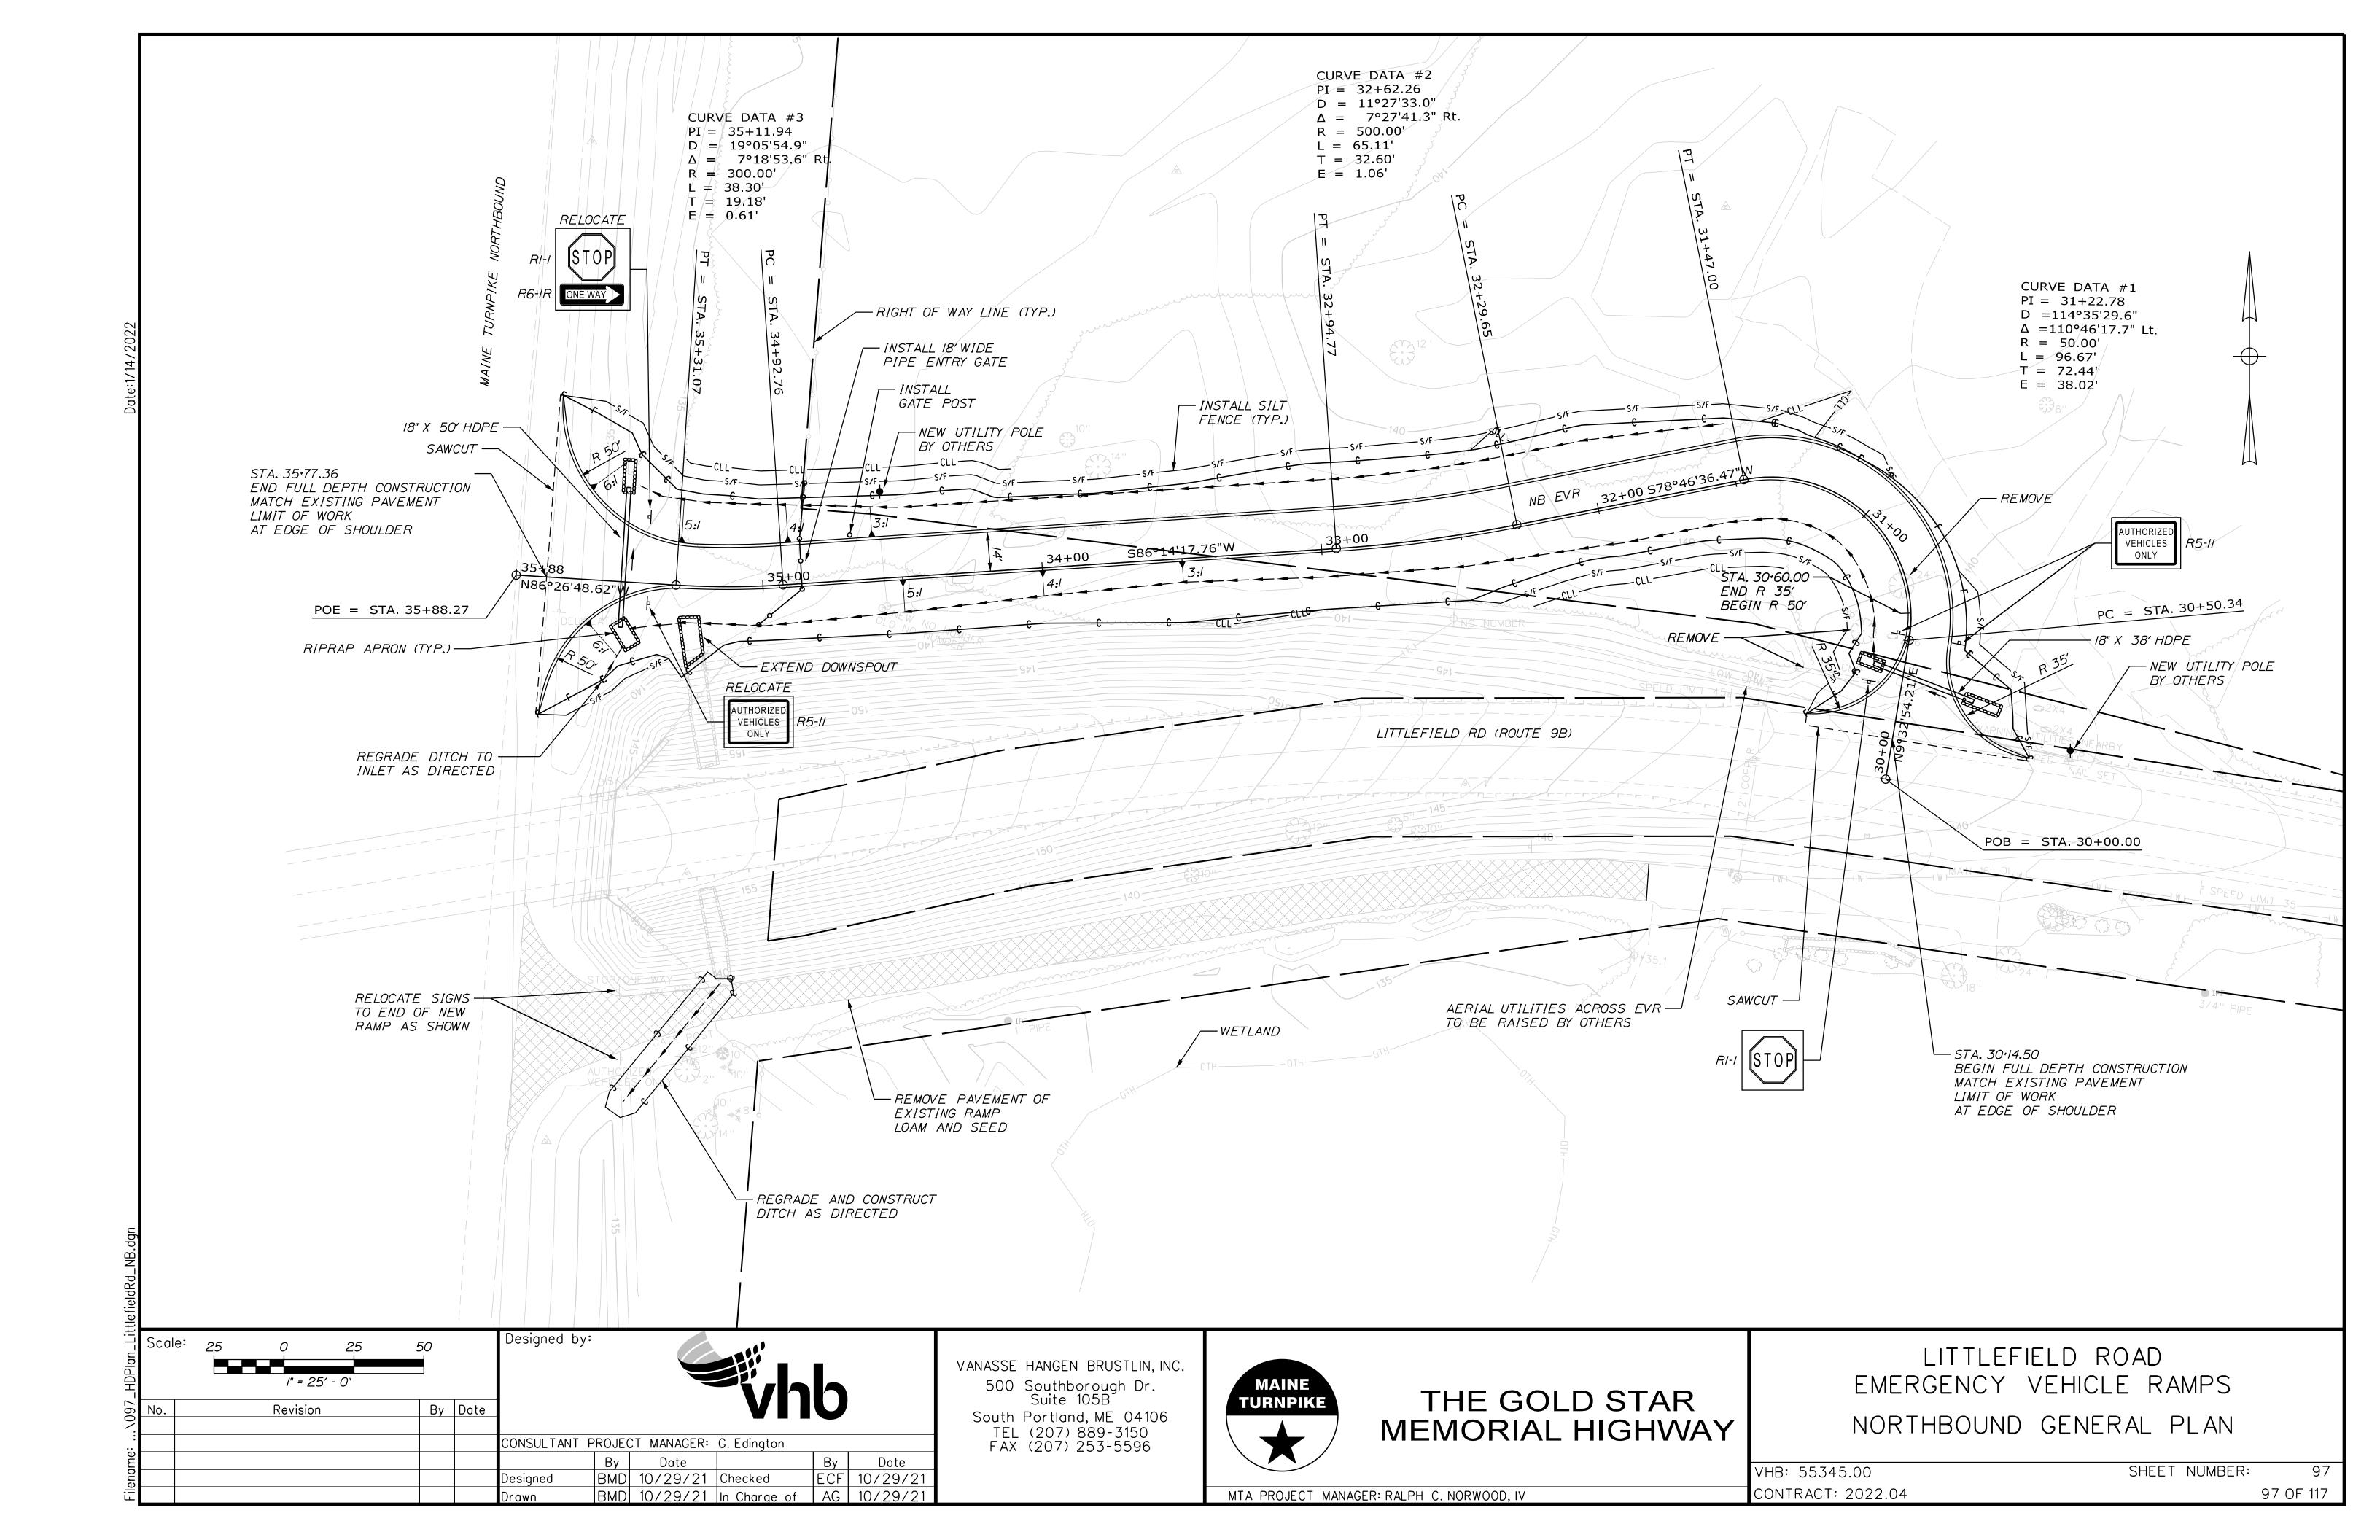
THE GOLD STAR MEMORIAL HIGHWAY


LITTLEFIELD ROAD EMERGENCY VEHICLE RAMPS FENCING DETAILS


SHEET NUMBER: VHB: 55345.00 96 CONTRACT: 2022.04


MTA PROJECT MANAGER: RALPH C. NORWOOD, IV

96 OF 117



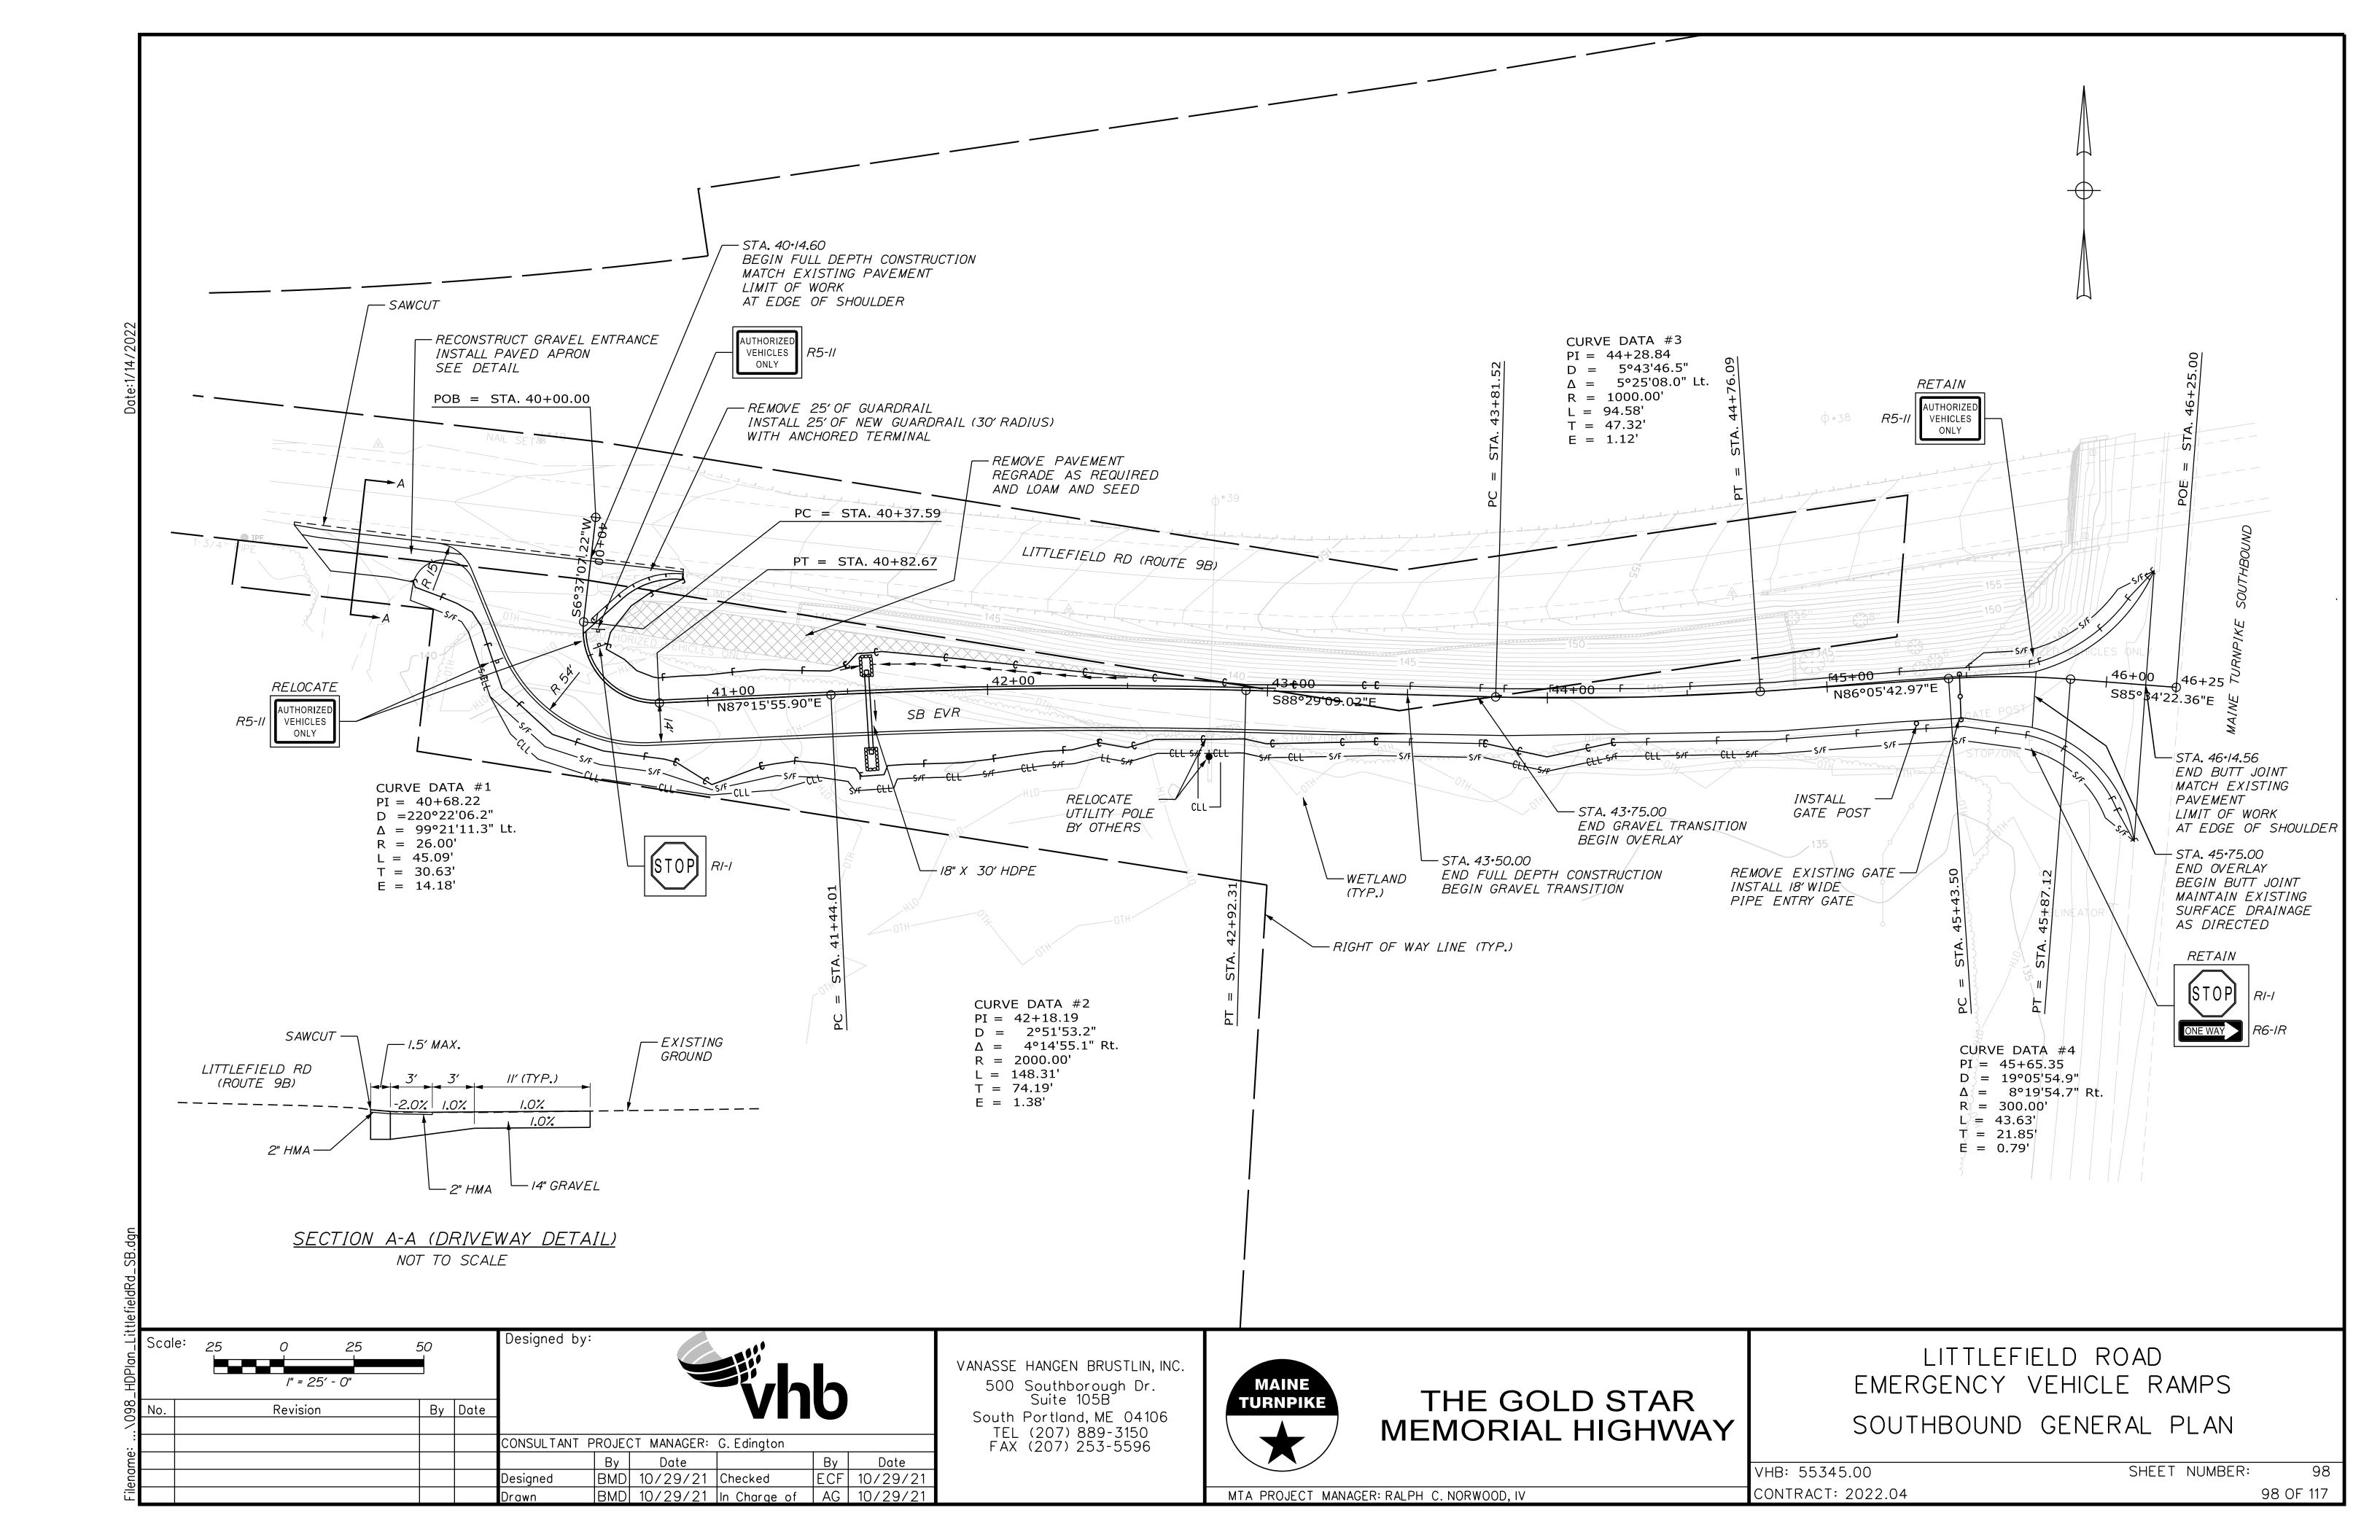

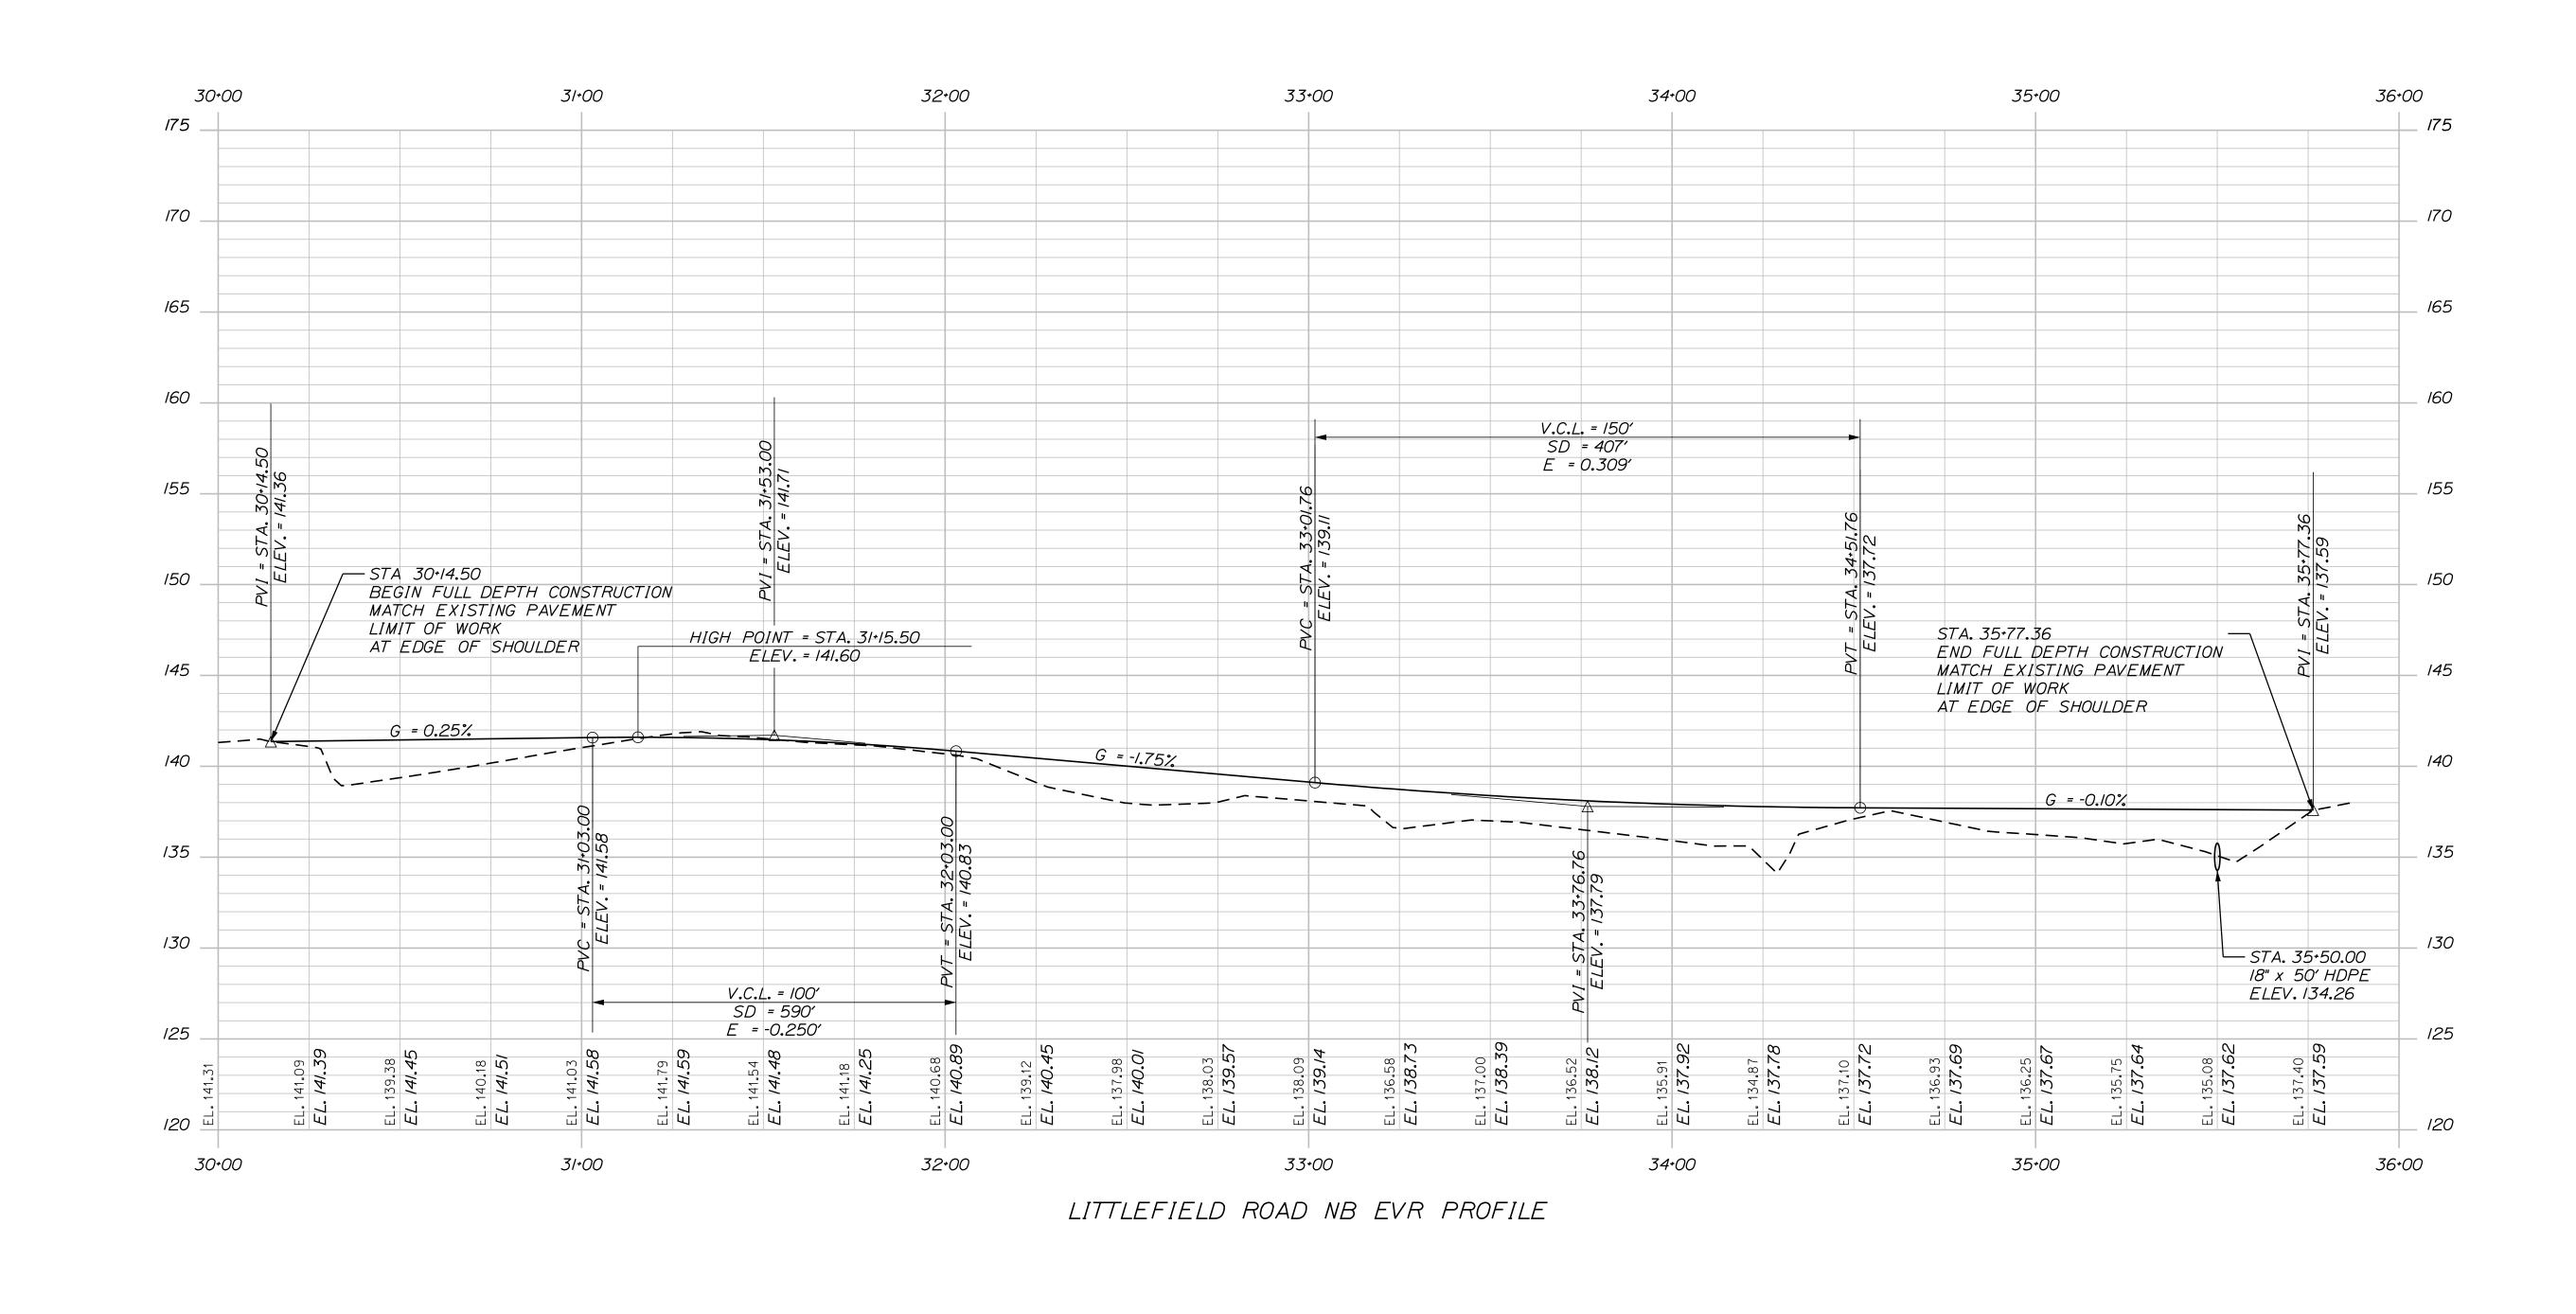

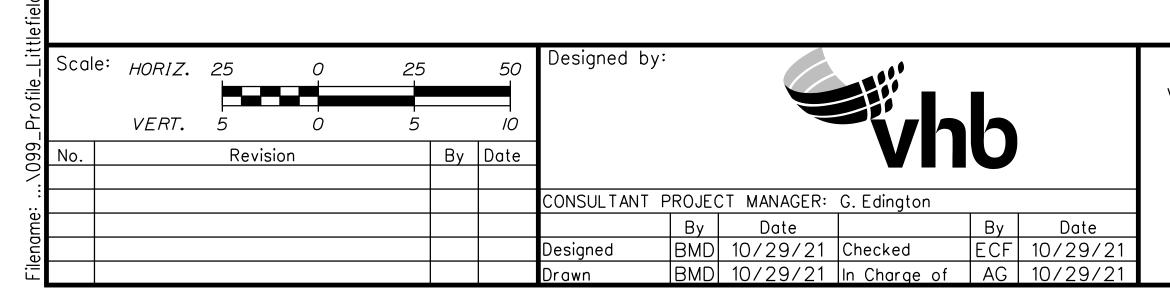


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500 Southborough Dr.
Suite 105B
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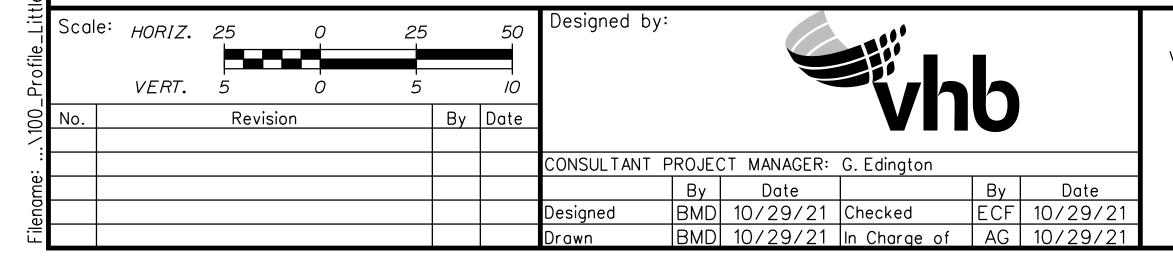


THE GOLD STAR MEMORIAL HIGHWAY

LITTLEFIELD ROAD EMERGENCY VEHICLE RAMPS NORTHBOUND PROFILE

VHB: 55345.00 SHEET NUMBER: 99 CONTRACT: 2022.04 99 OF 117



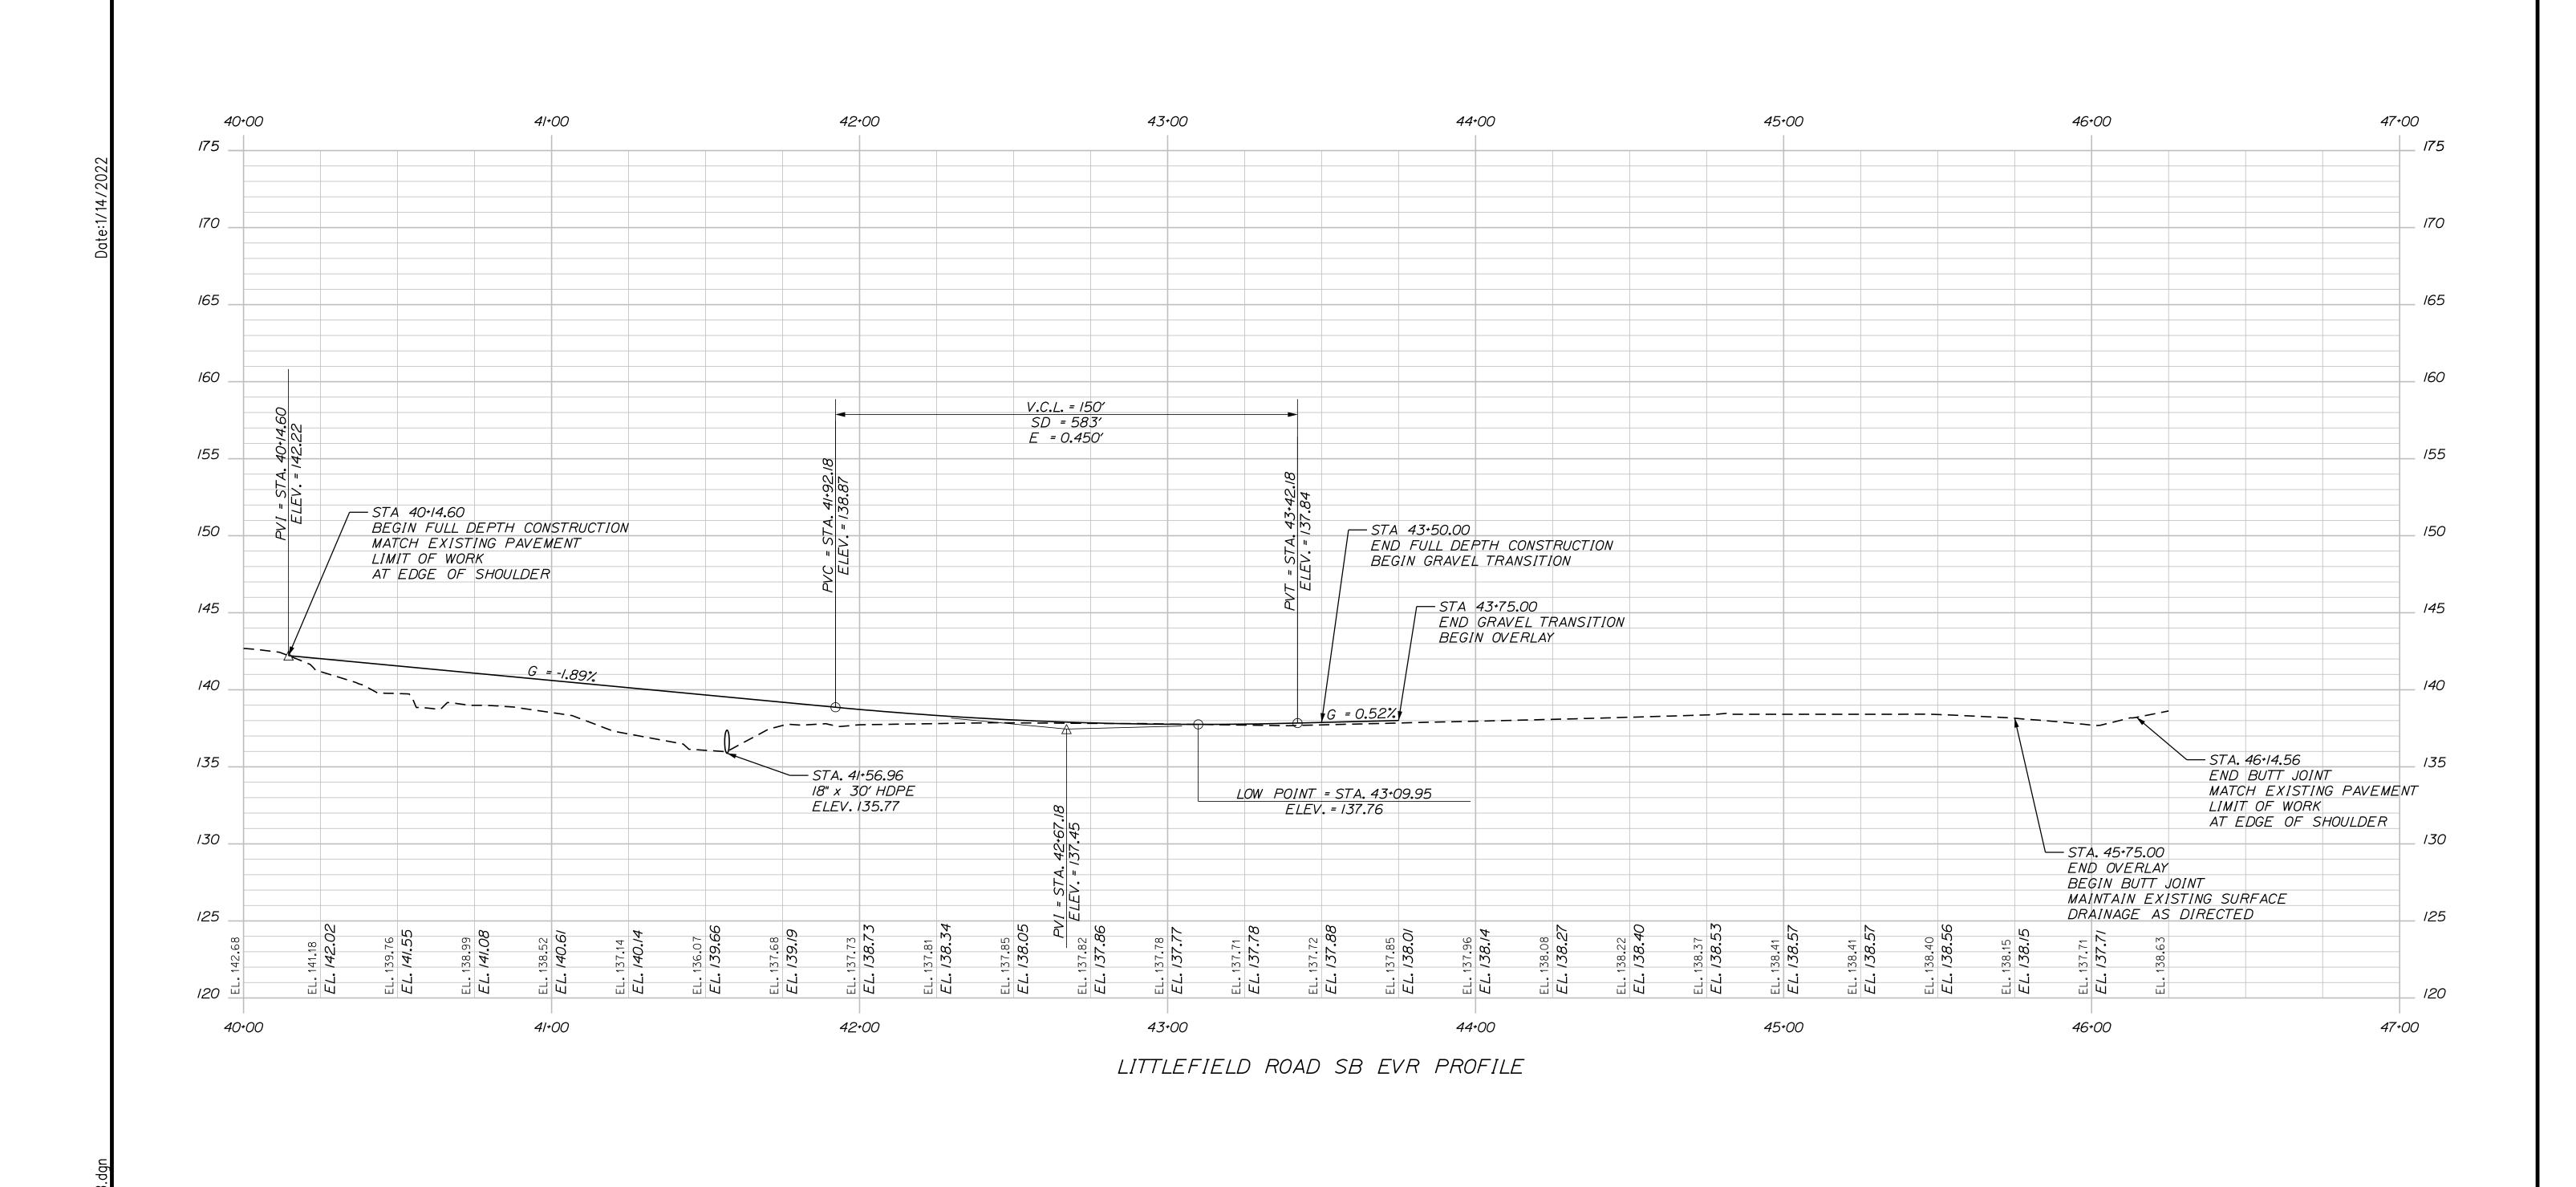

VANASSE HANGEN BRUSTLIN, INC.

500 Southborough Dr.
Suite 105B


South Portland, ME 04106
TEL (207) 889-3150
FAX (207) 253-5596





THE GOLD STAR MEMORIAL HIGHWAY


LITTLEFIELD ROAD EMERGENCY VEHICLE RAMPS SOUTHBOUND PROFILE


VHB: 55345.00 SHEET NUMBER: 100 CONTRACT: 2022.04 100 OF 117

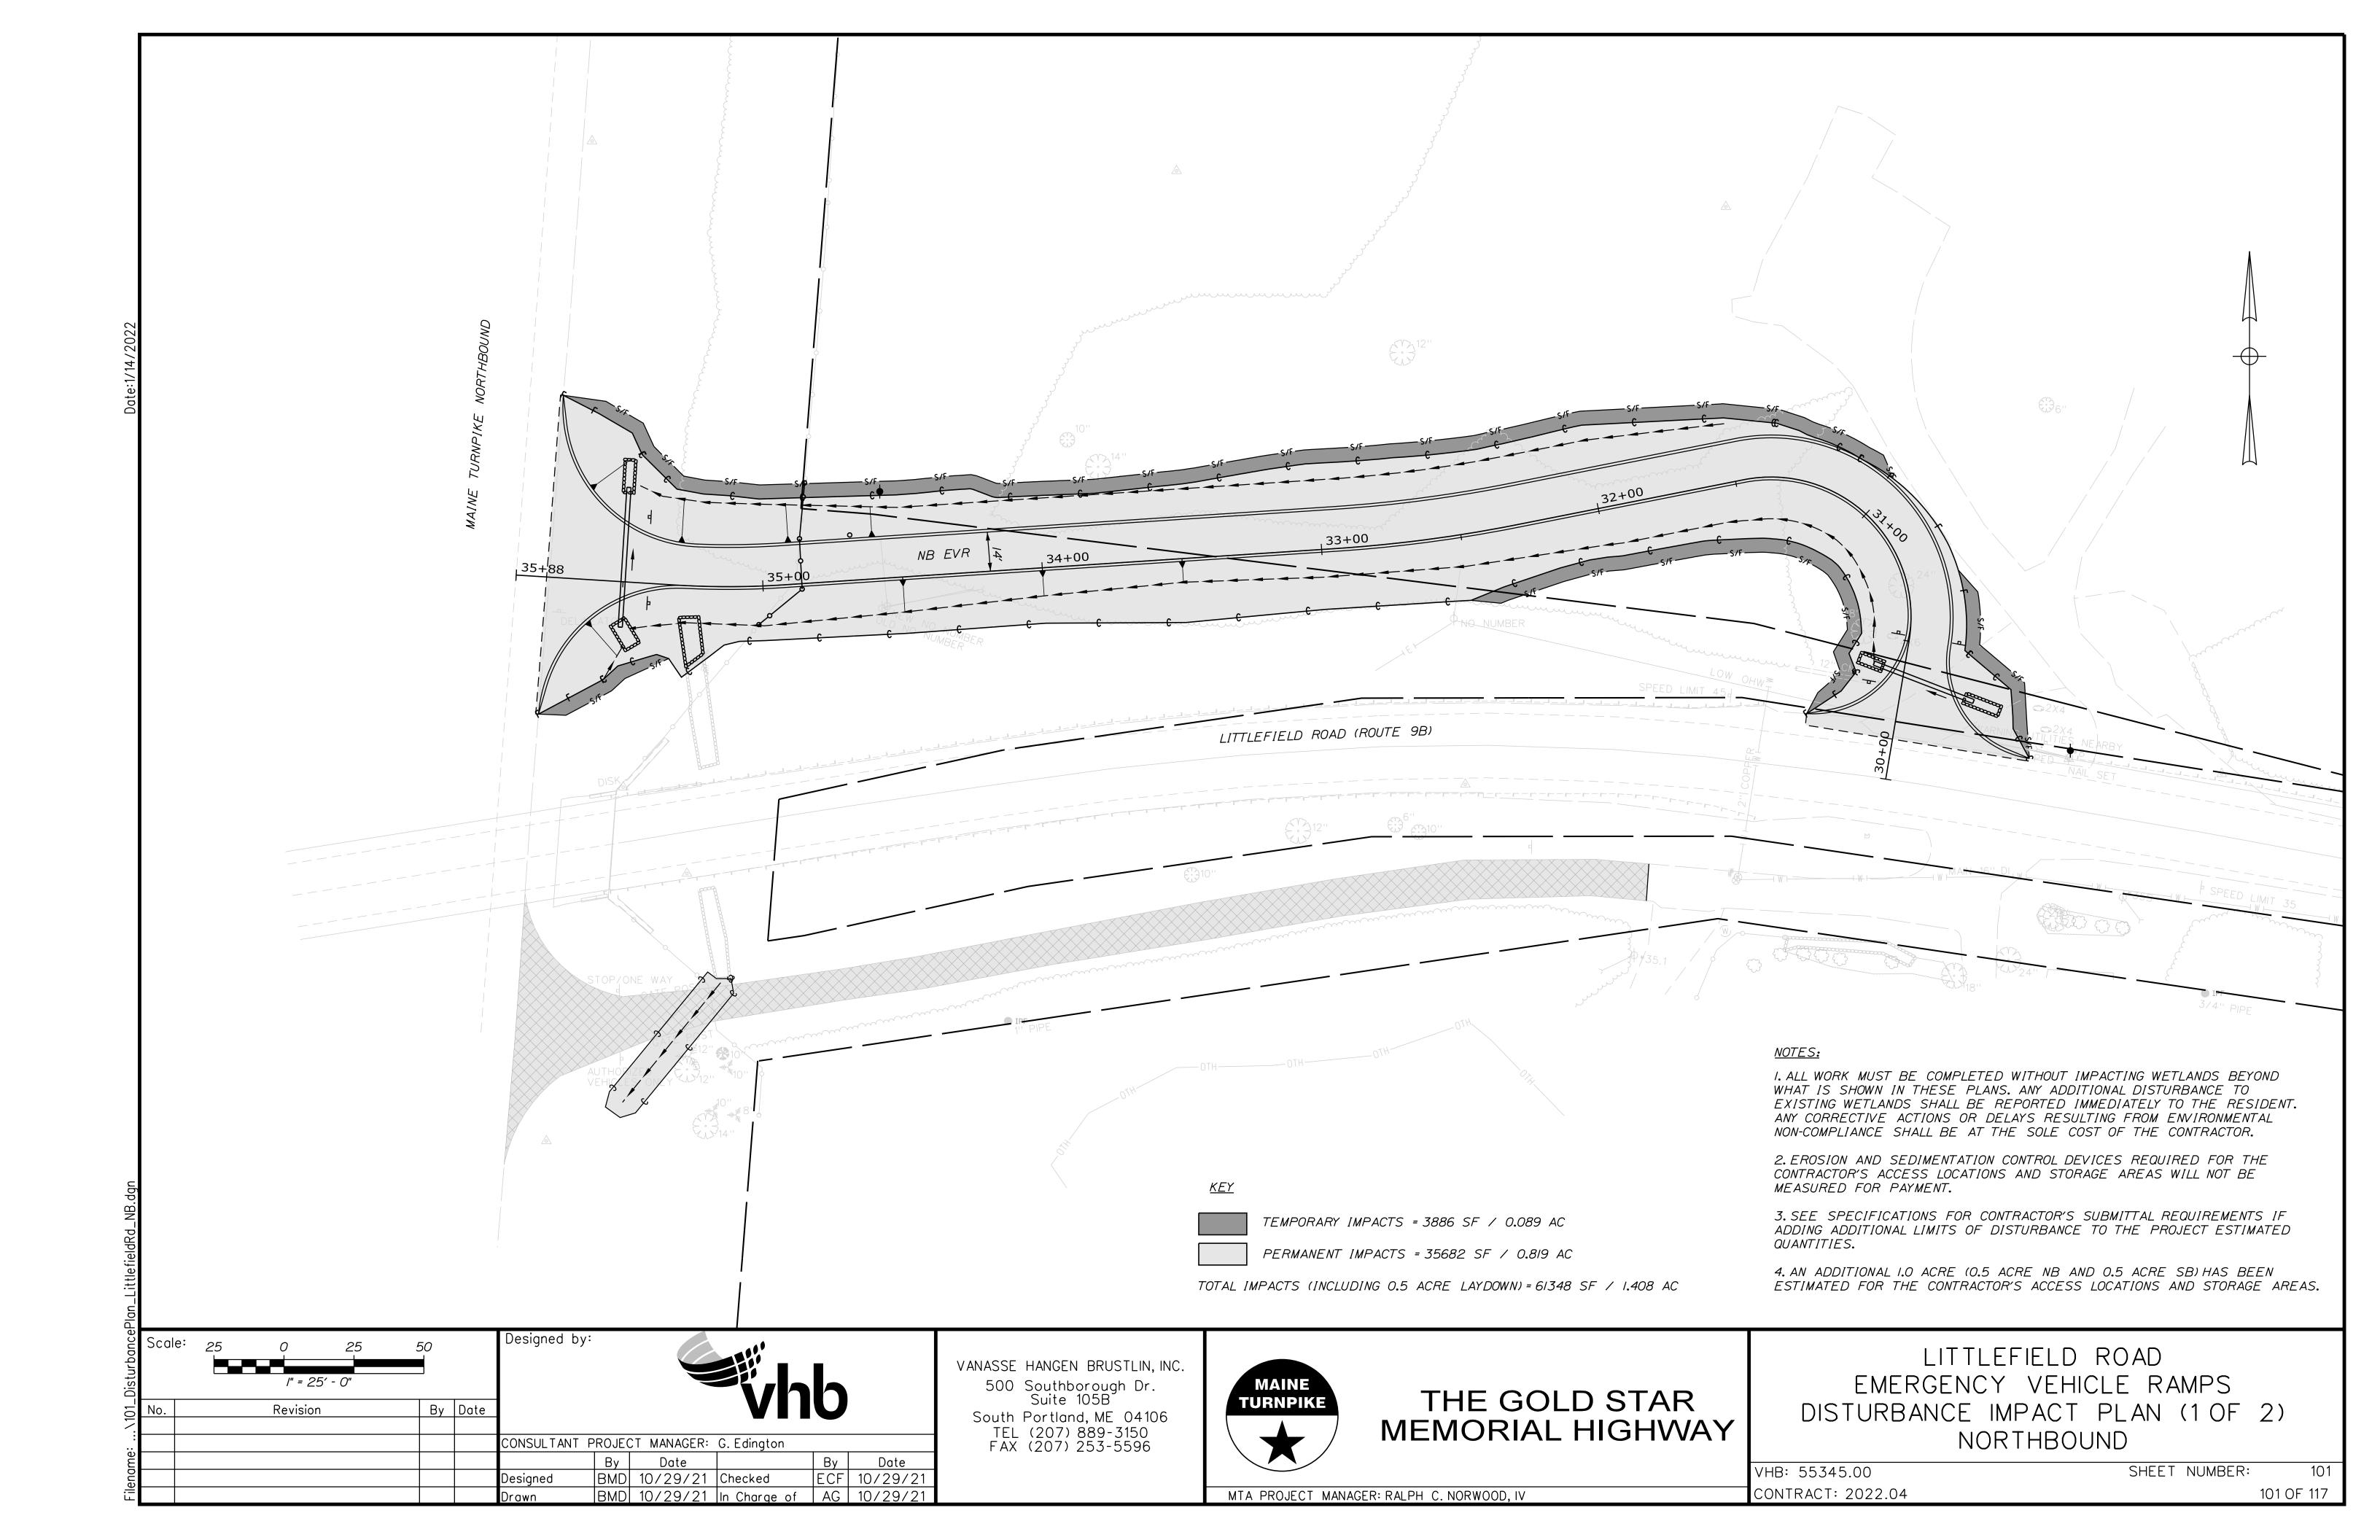

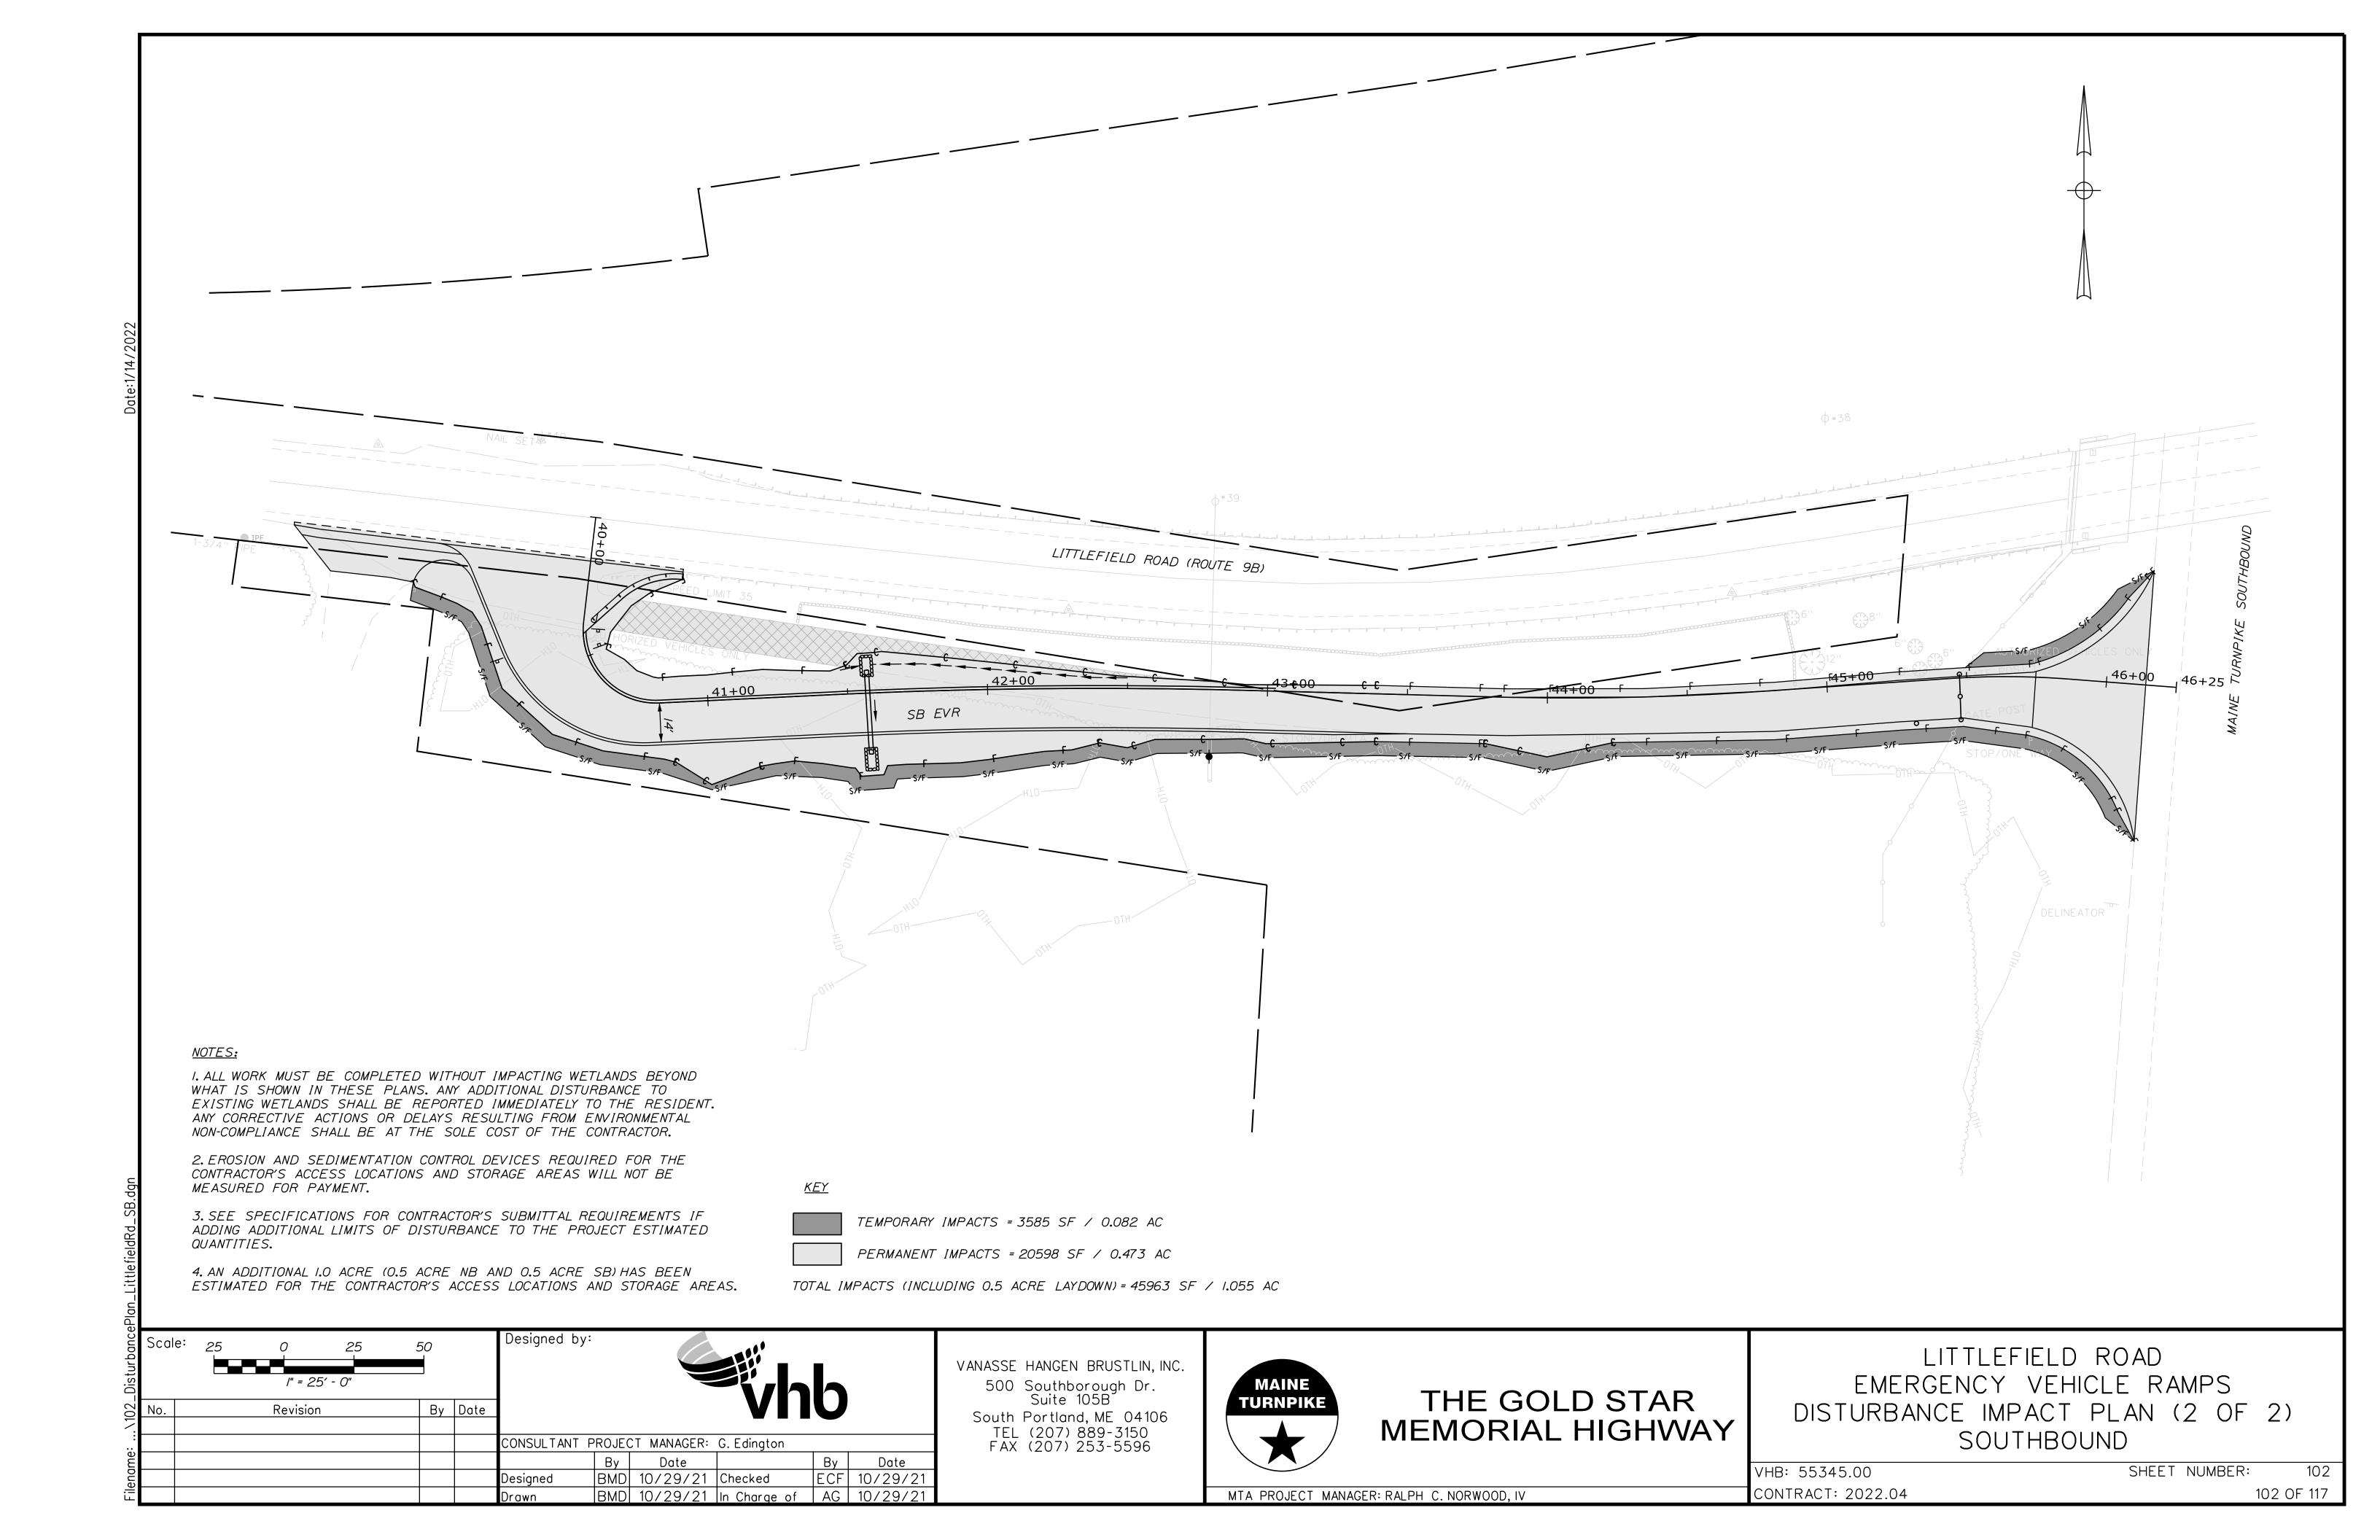

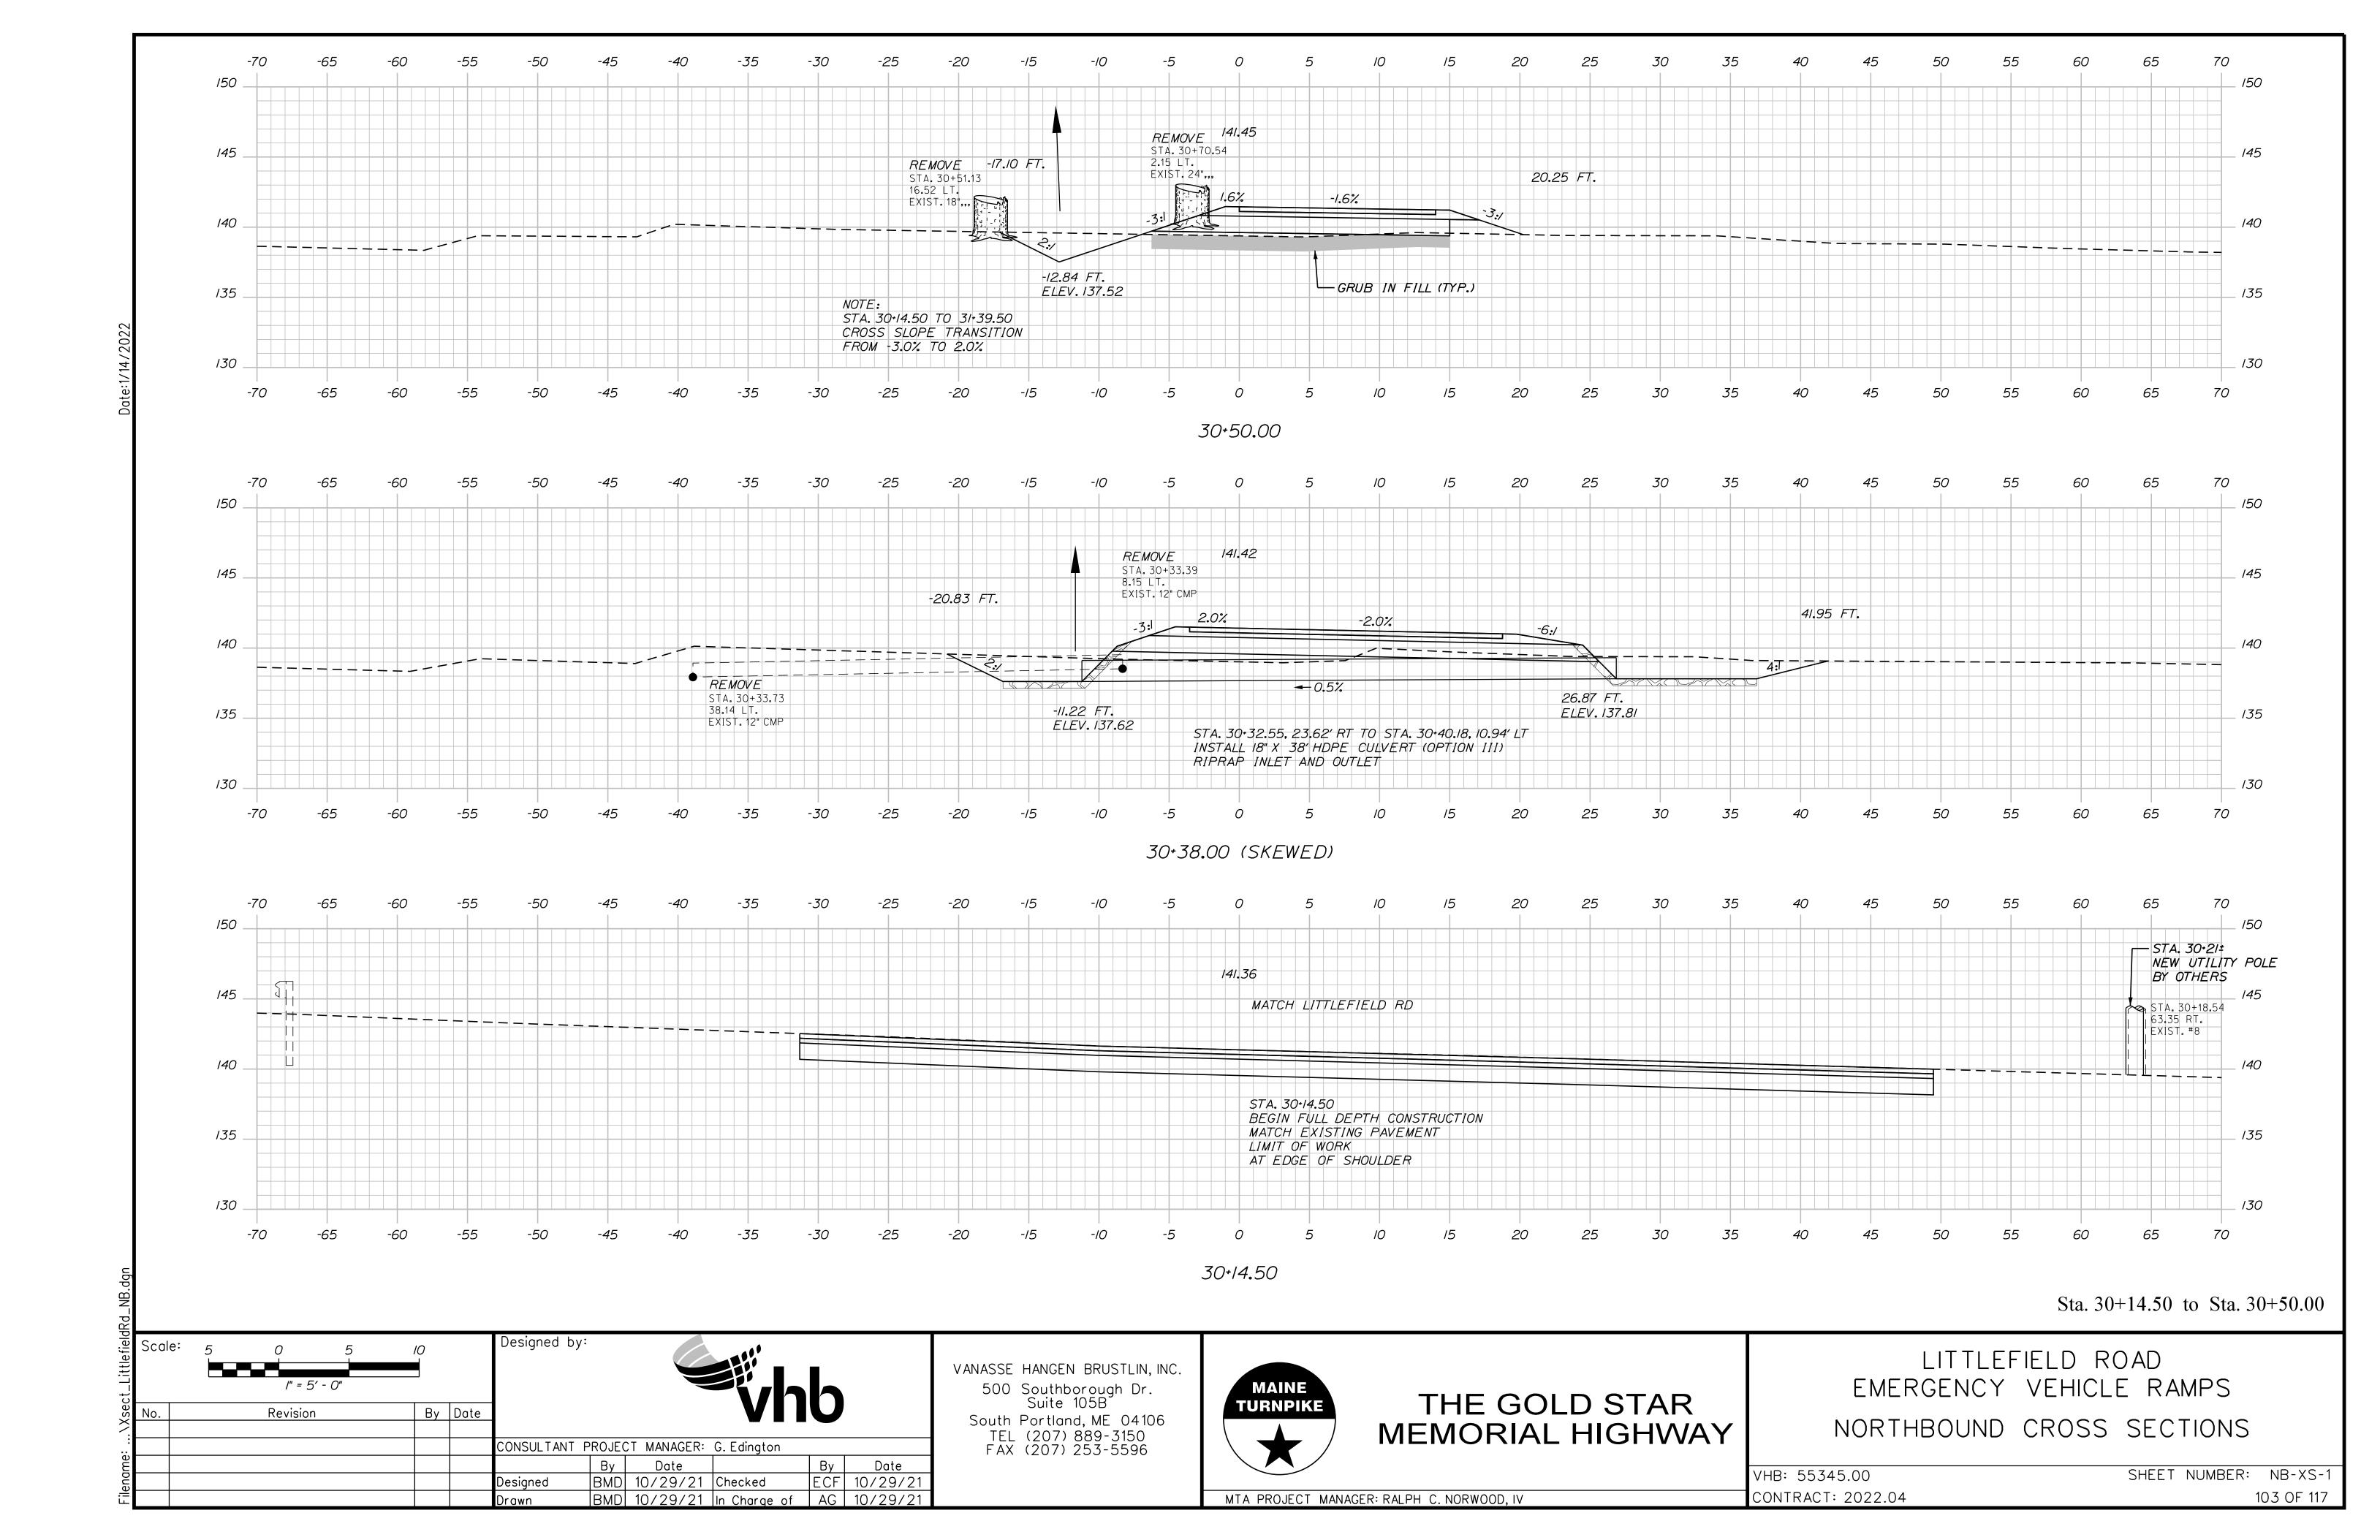

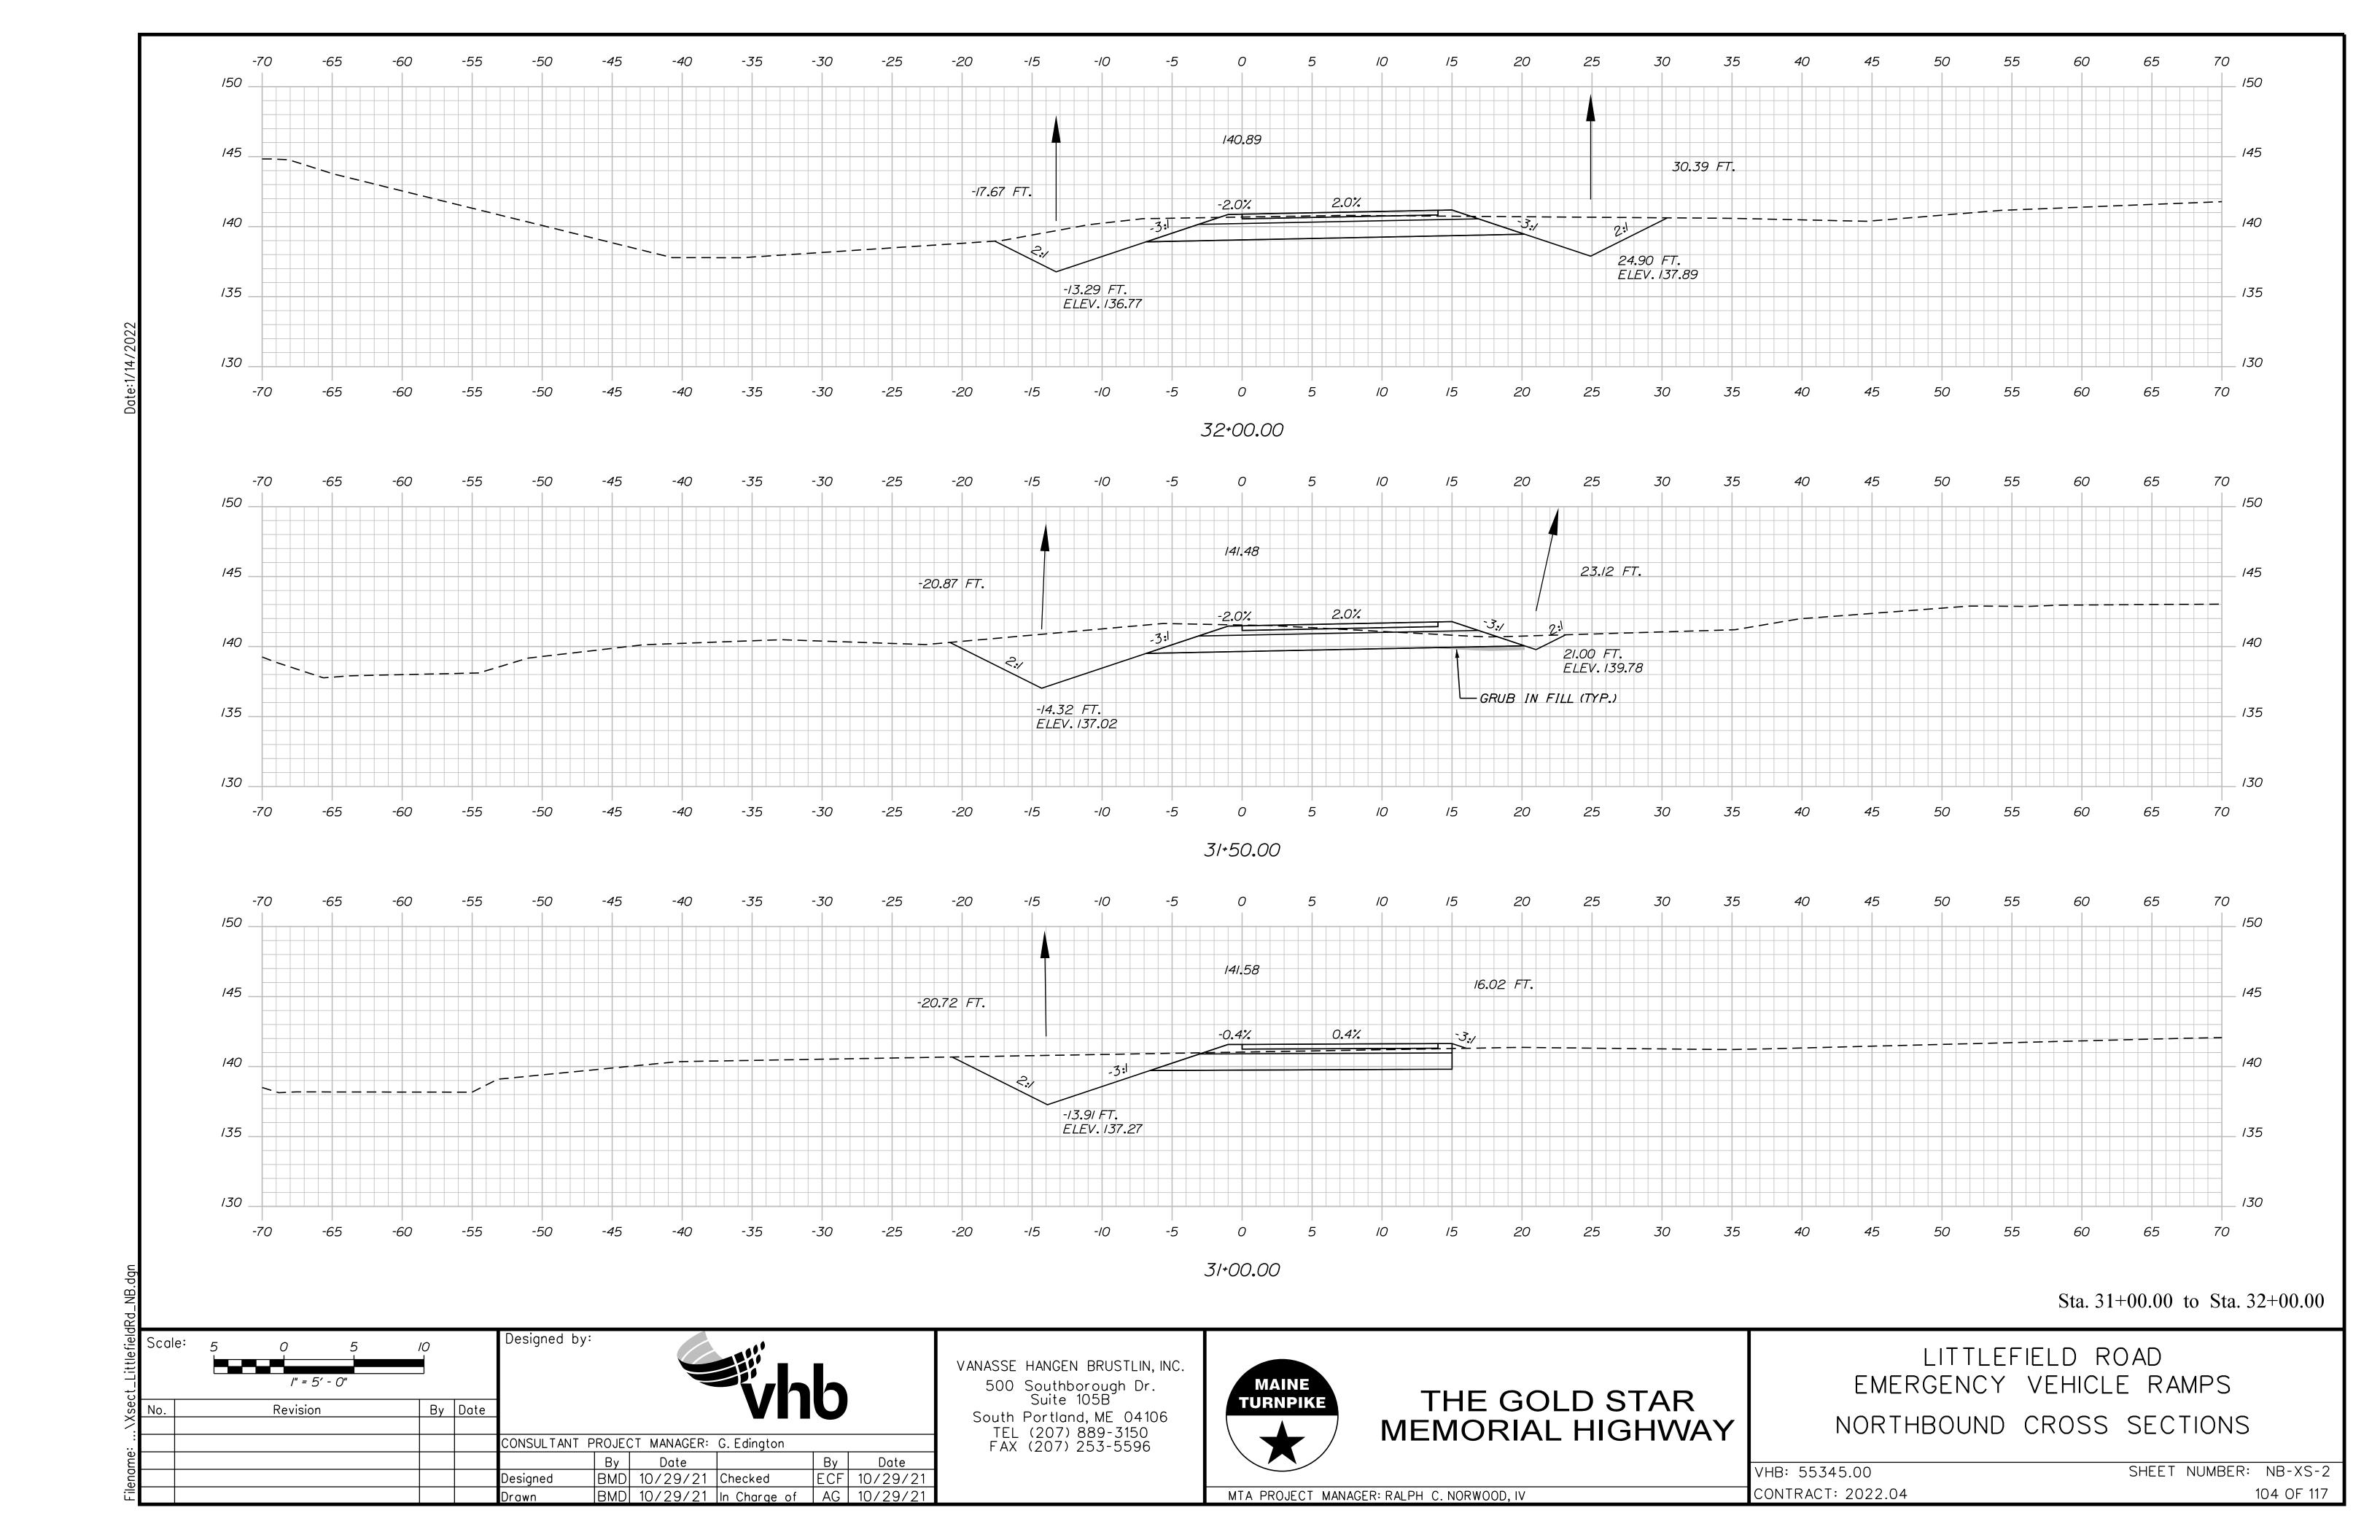

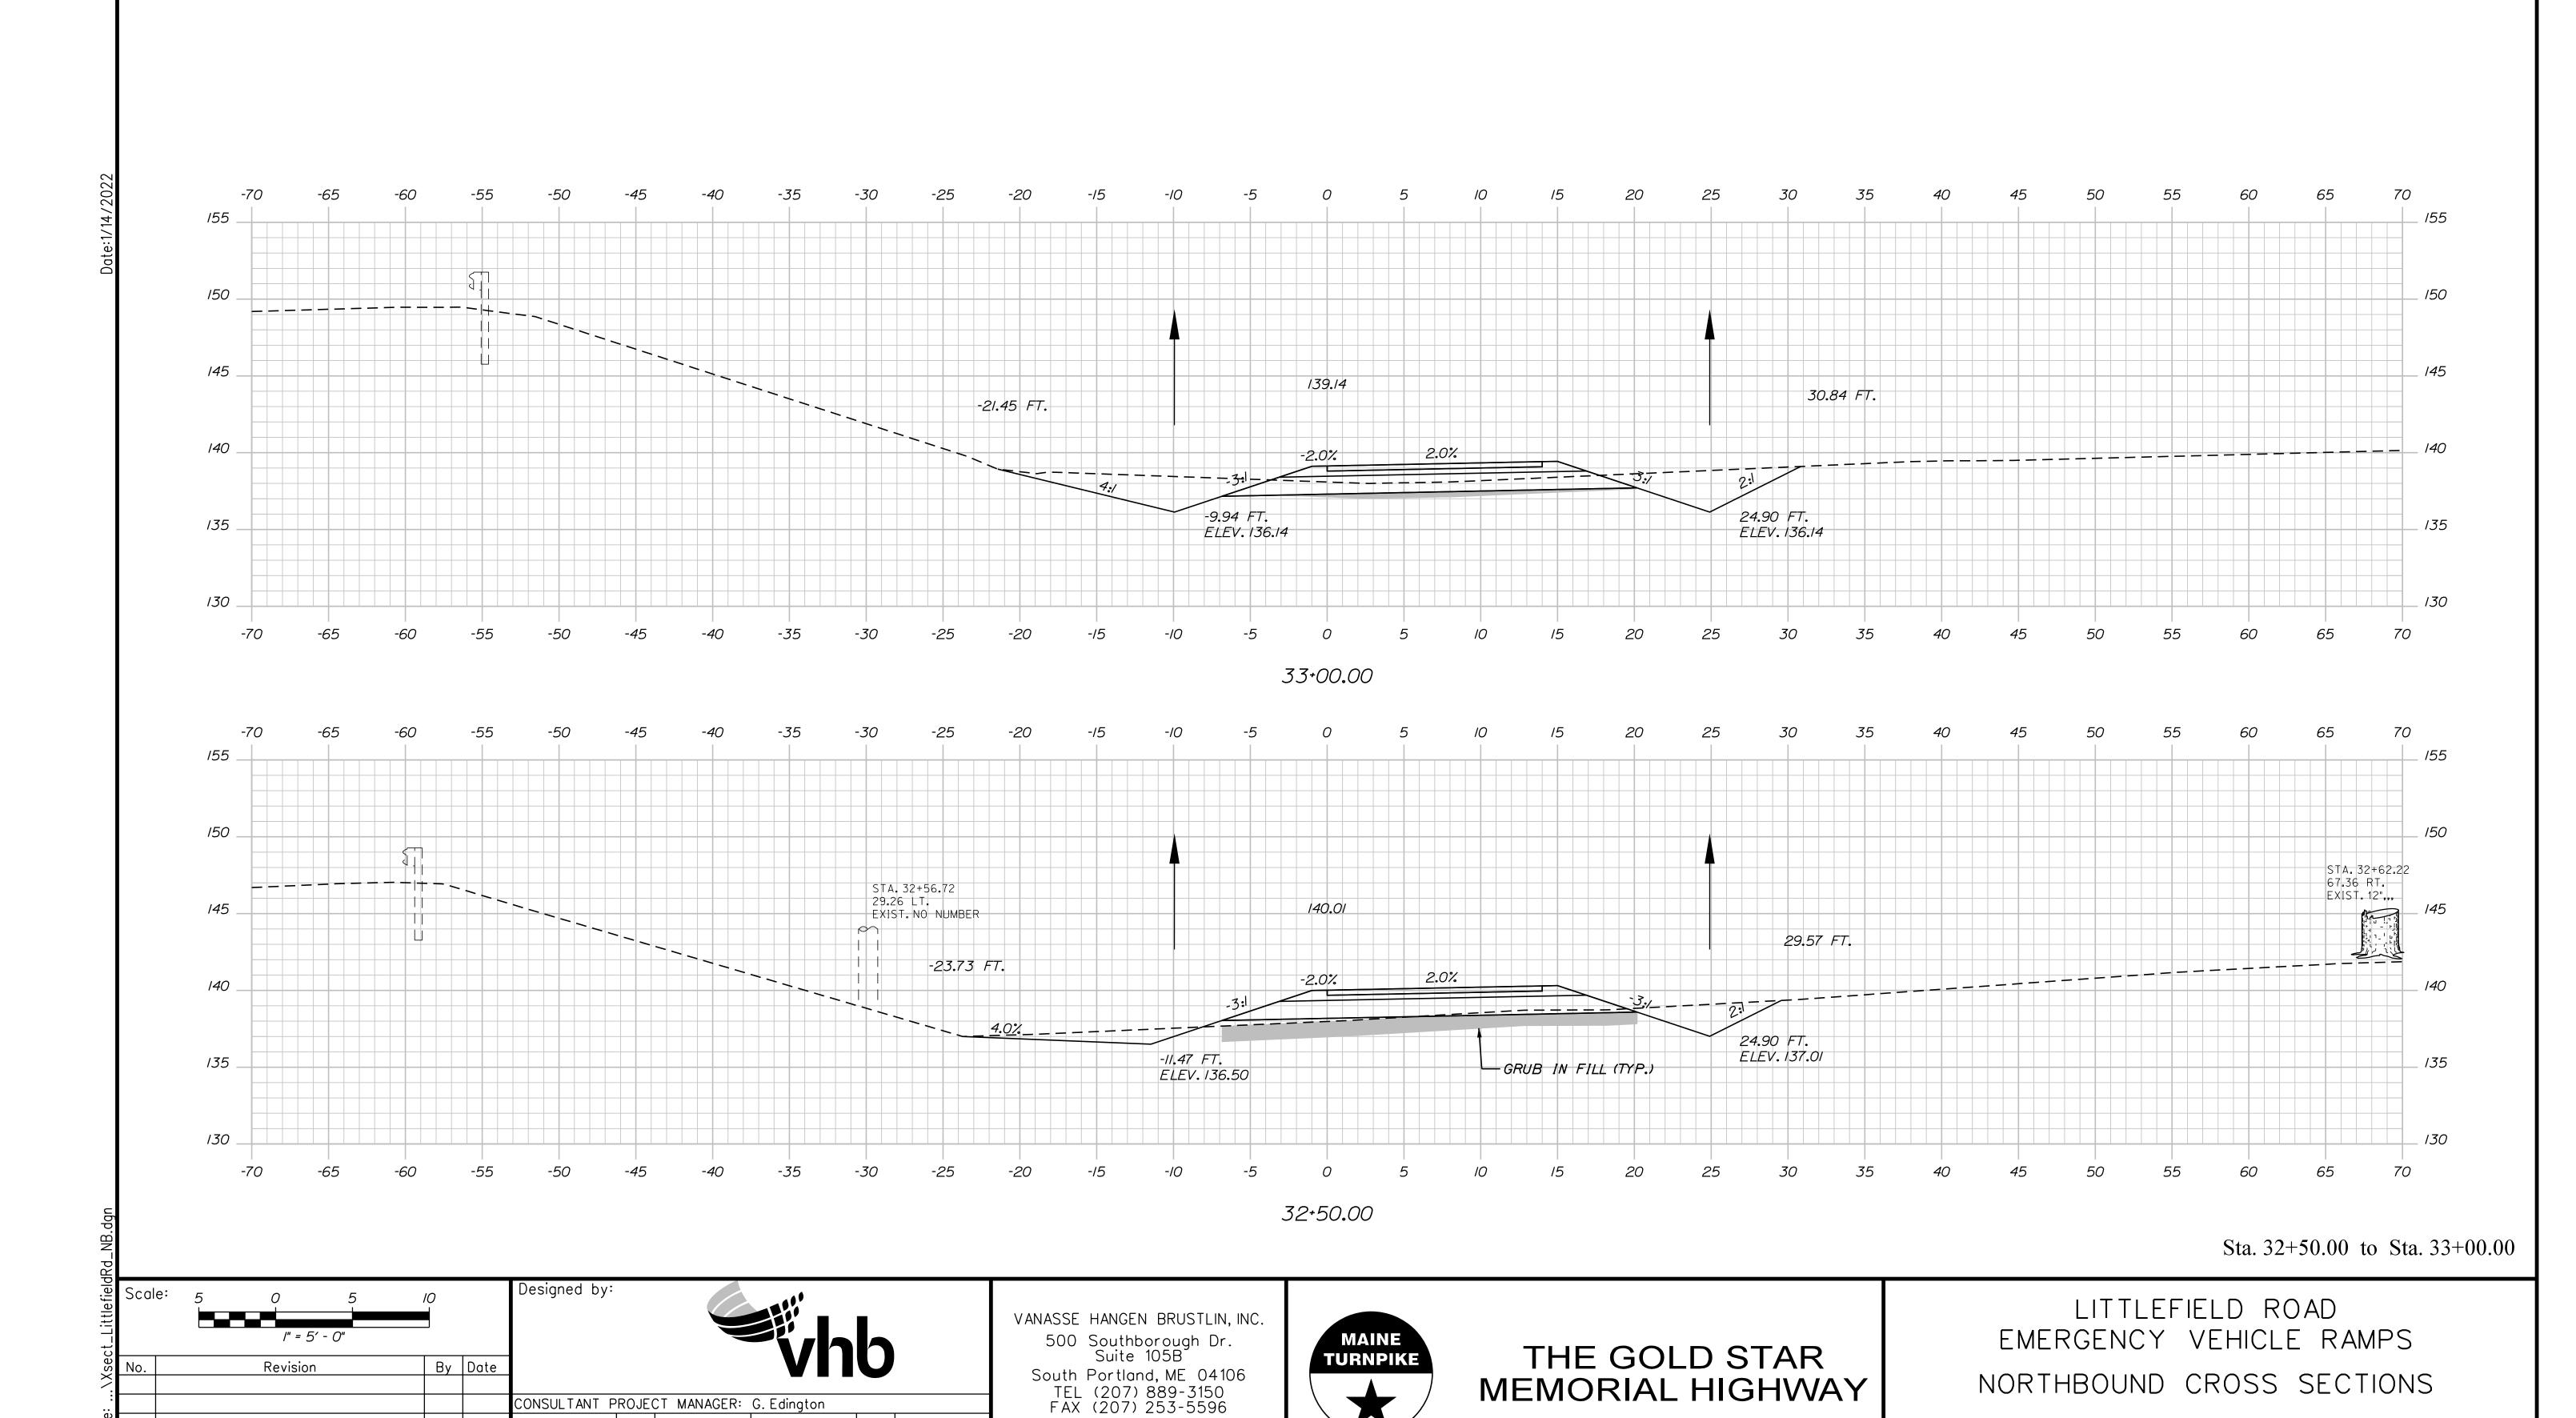

SHEET NUMBER: NB-XS-3

105 OF 117

VHB: 55345.00


CONTRACT: 2022.04

By Date ECF 10/29/21

BMD 10/29/21 Checked

BMD 10/29/21 In Charge of AG 10/29/21

Designed

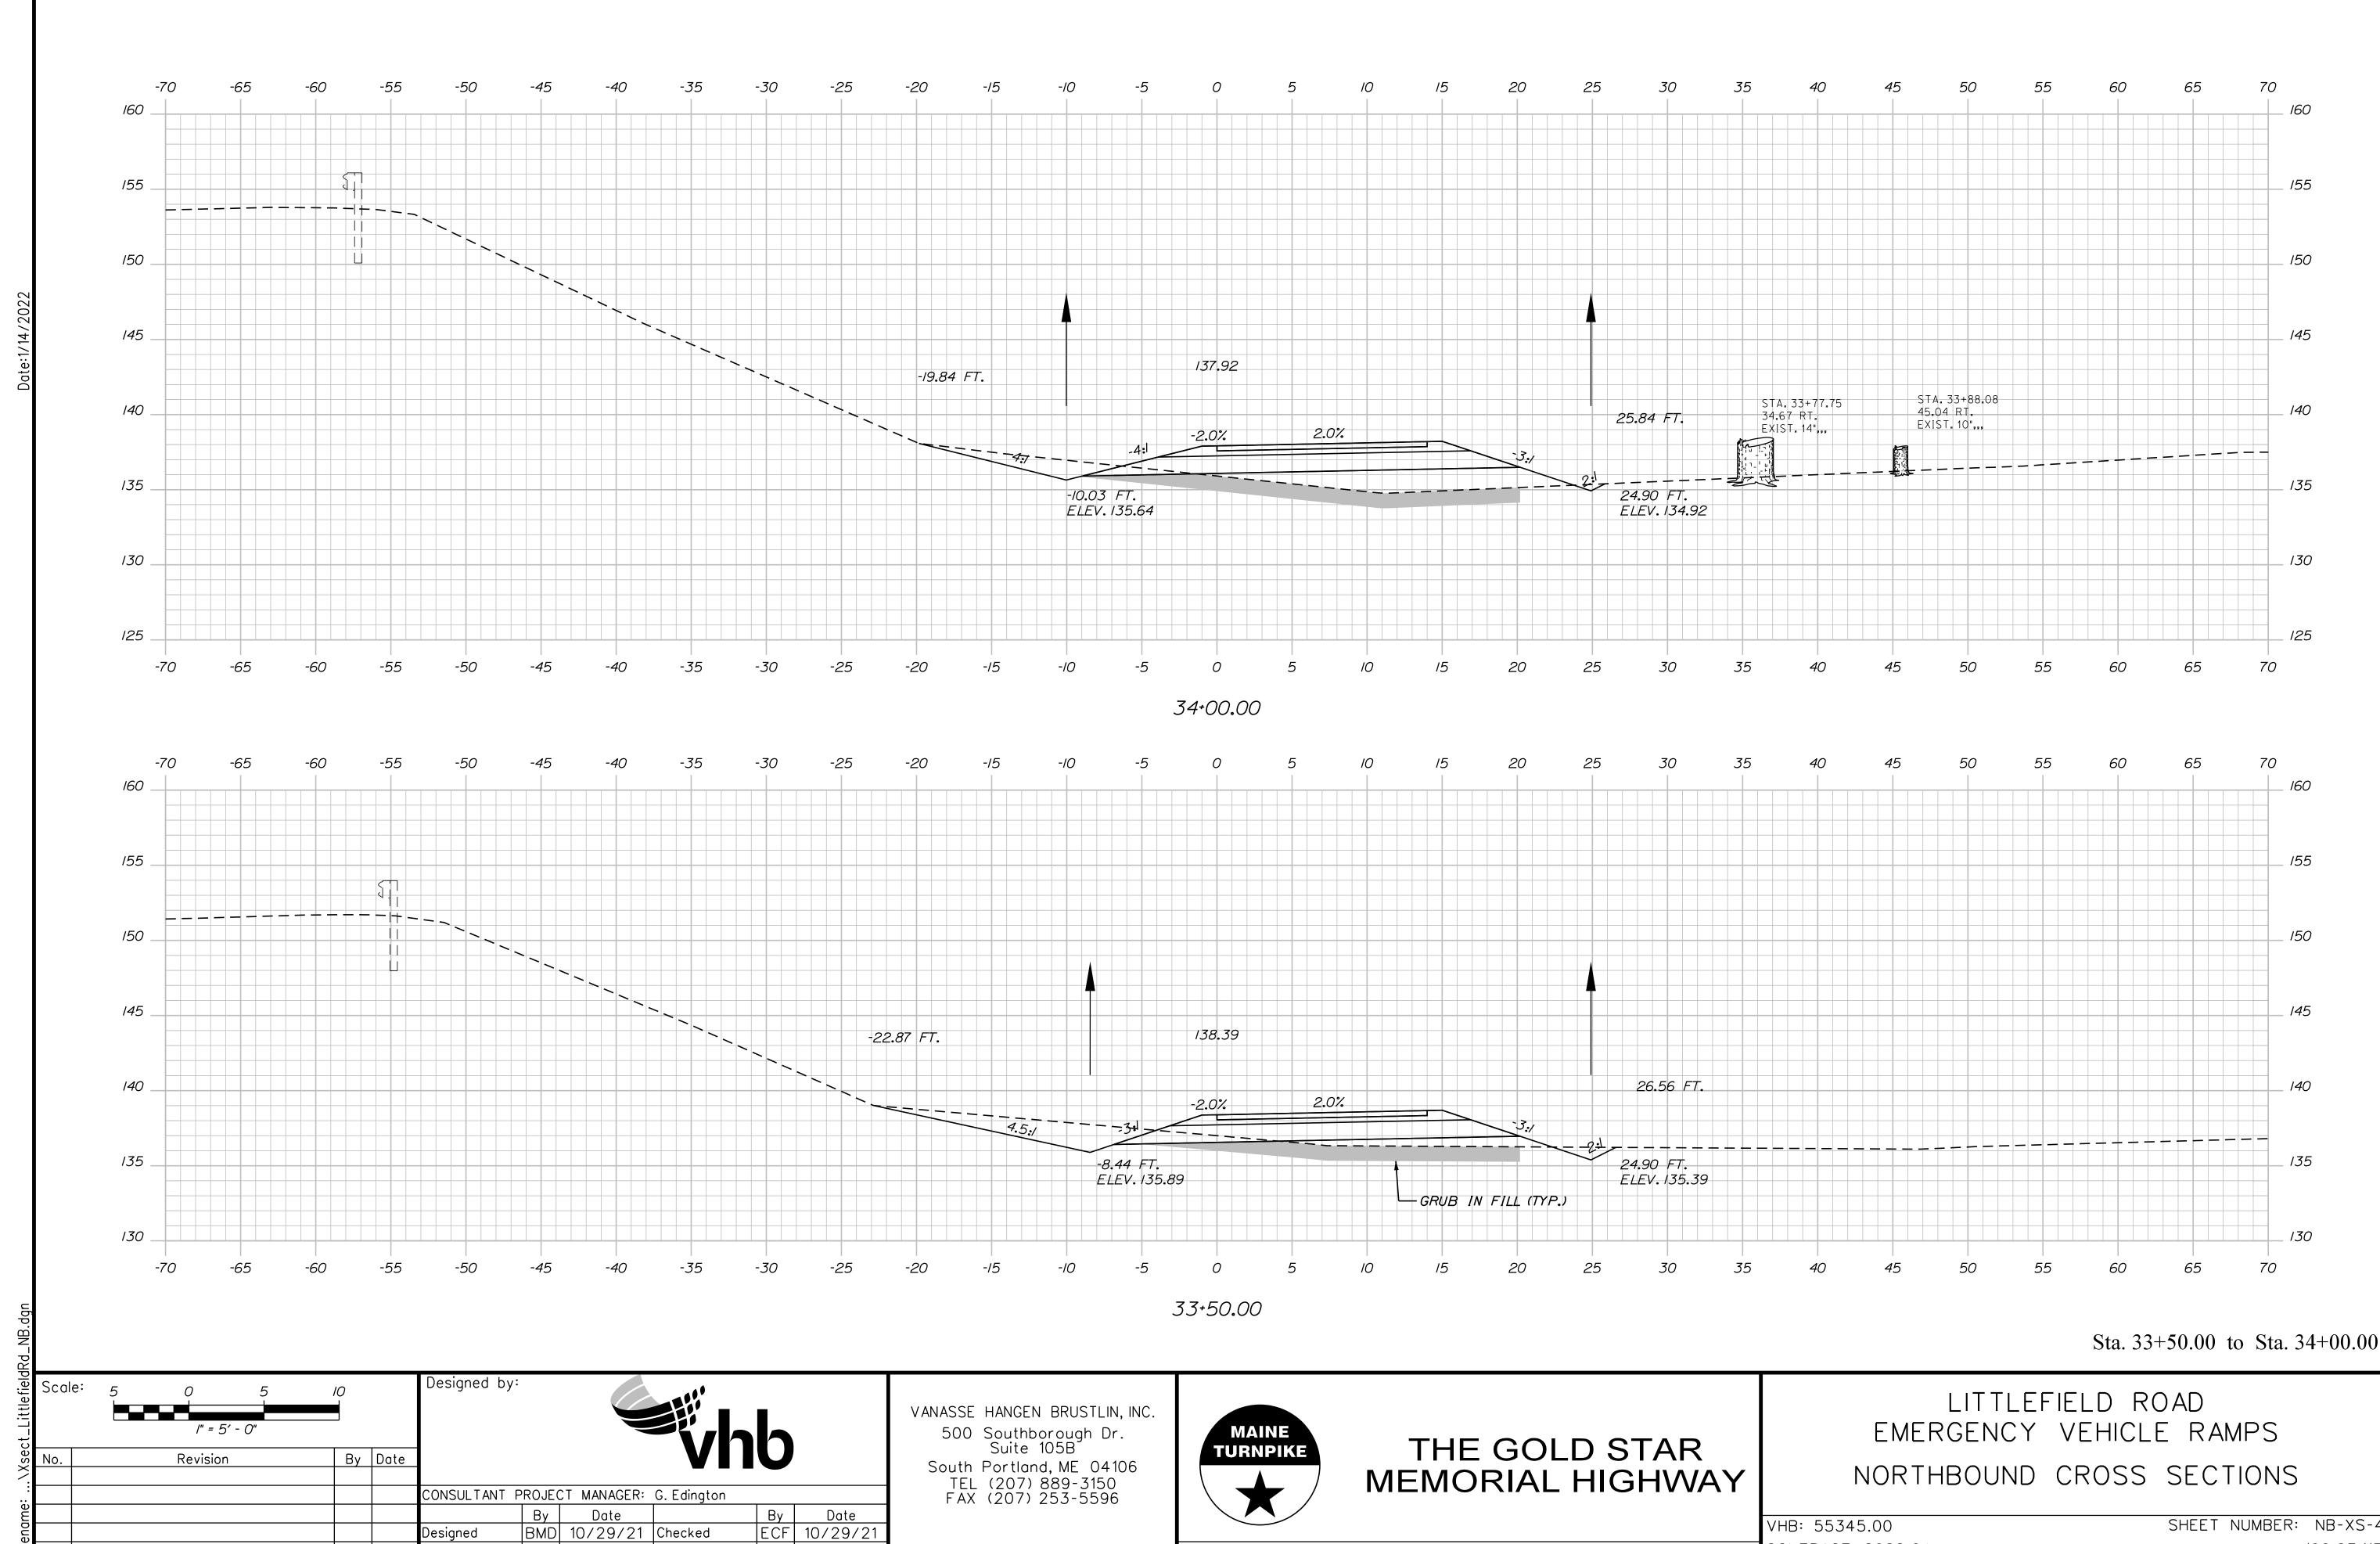


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BMD 10/29/21 In Charge of AG 10/29/21

Designed

SHEET NUMBER: NB-XS-4 VHB: 55345.00 CONTRACT: 2022.04 106 OF 117

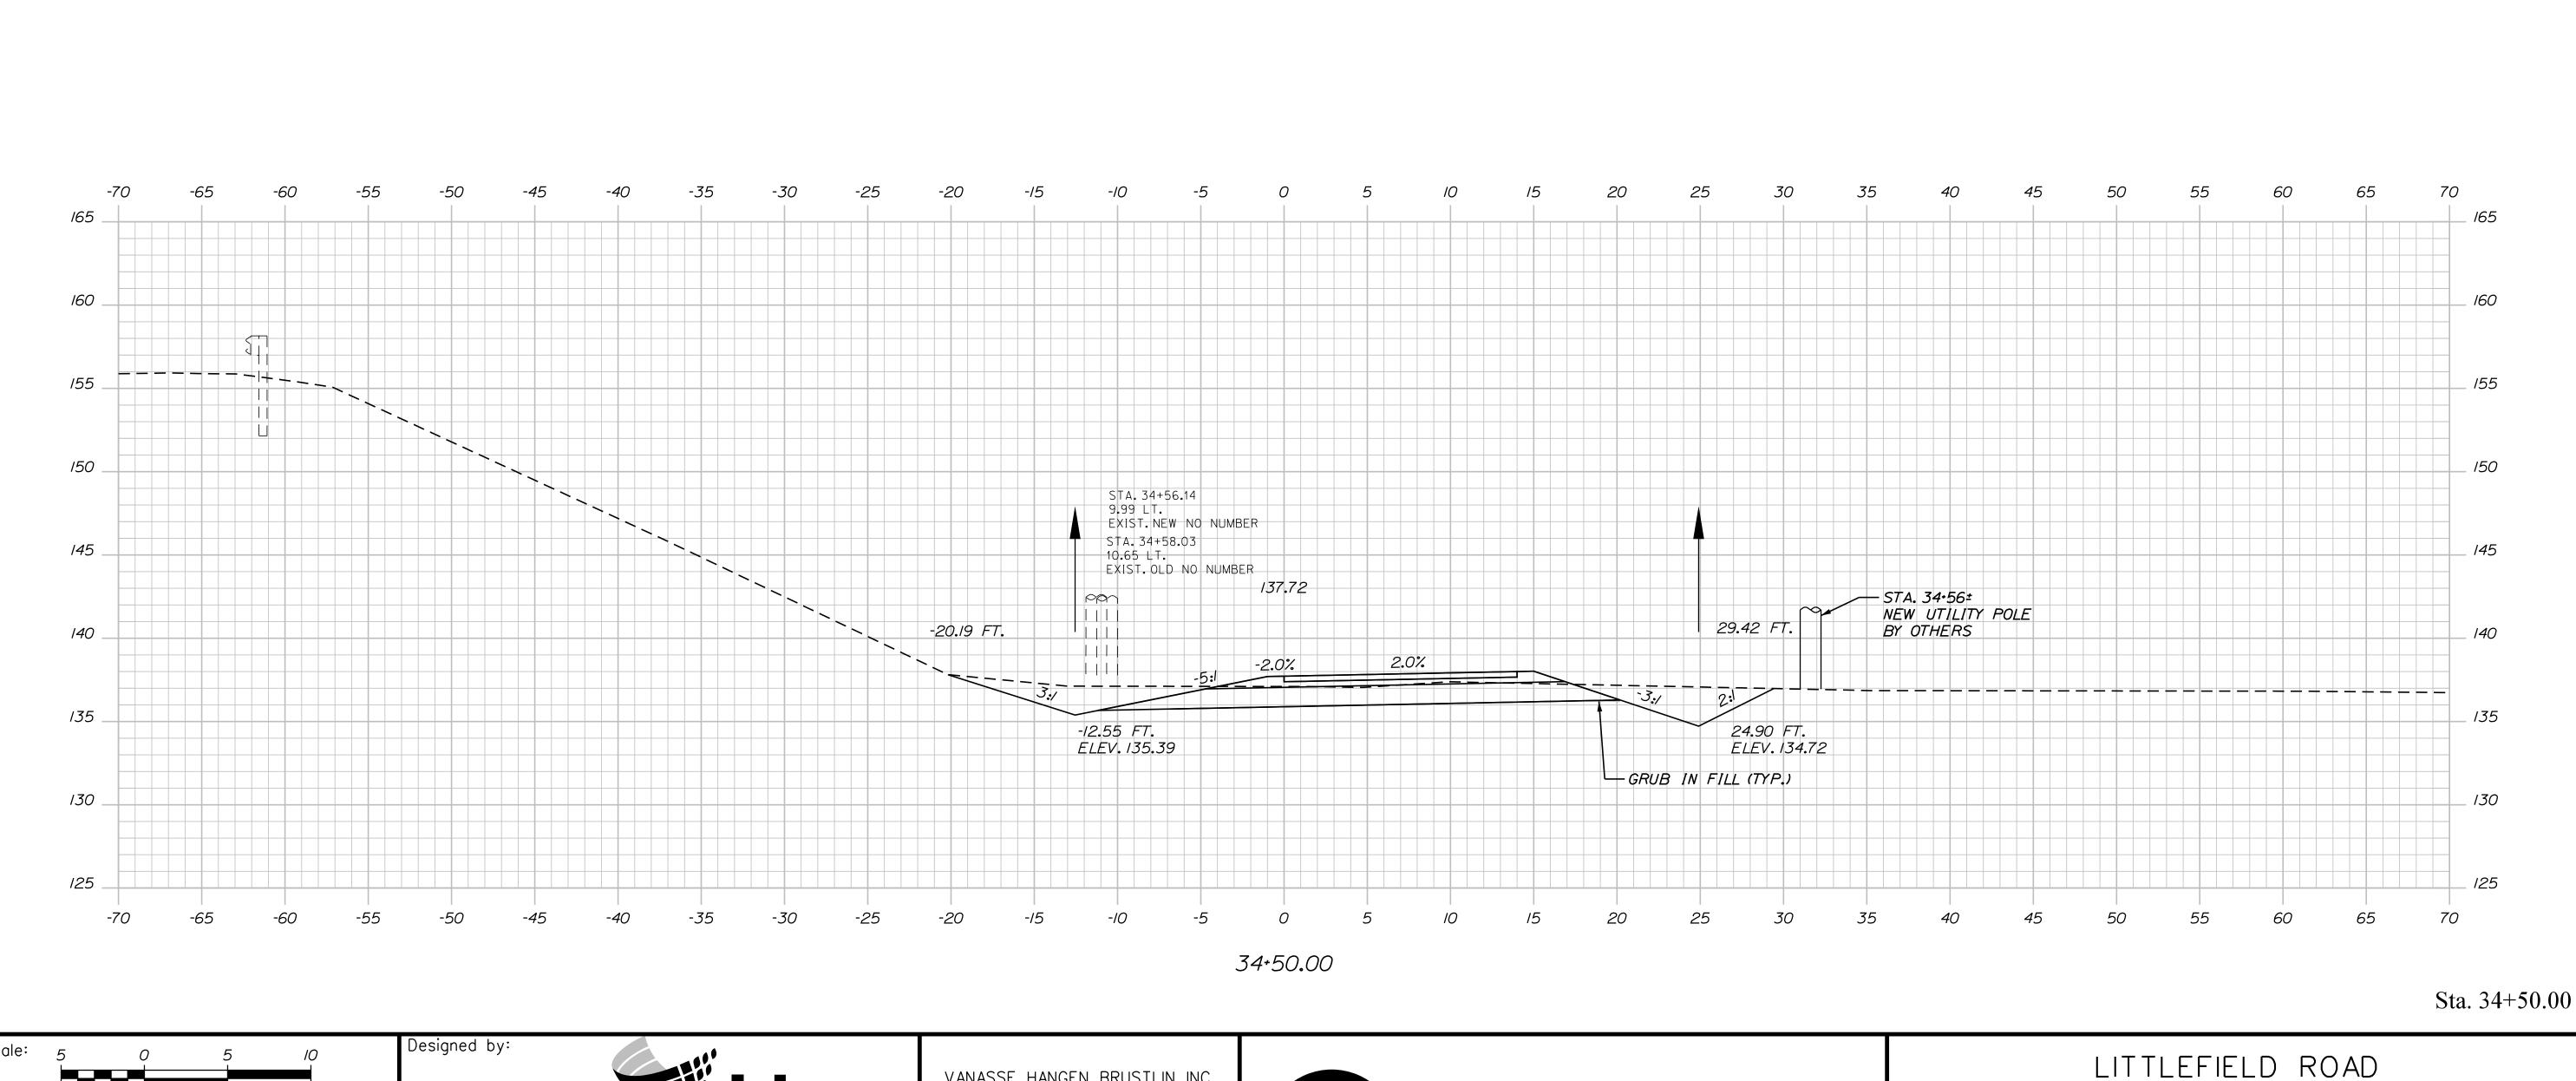

VANASSE HANGEN BRUSTLIN, INC.

500 Southborough Dr.
Suite 105B


South Portland, ME 04106
TEL (207) 889-3150
FAX (207) 253-5596

MAINE
TURNPIKE

THE GOLD STAR MEMORIAL HIGHWAY

LITTLEFIELD ROAD
EMERGENCY VEHICLE RAMPS
NORTHBOUND CROSS SECTIONS

VHB: 55345.00 SHEET NUMBER: NB-XS-5 CONTRACT: 2022.04 107 OF 117

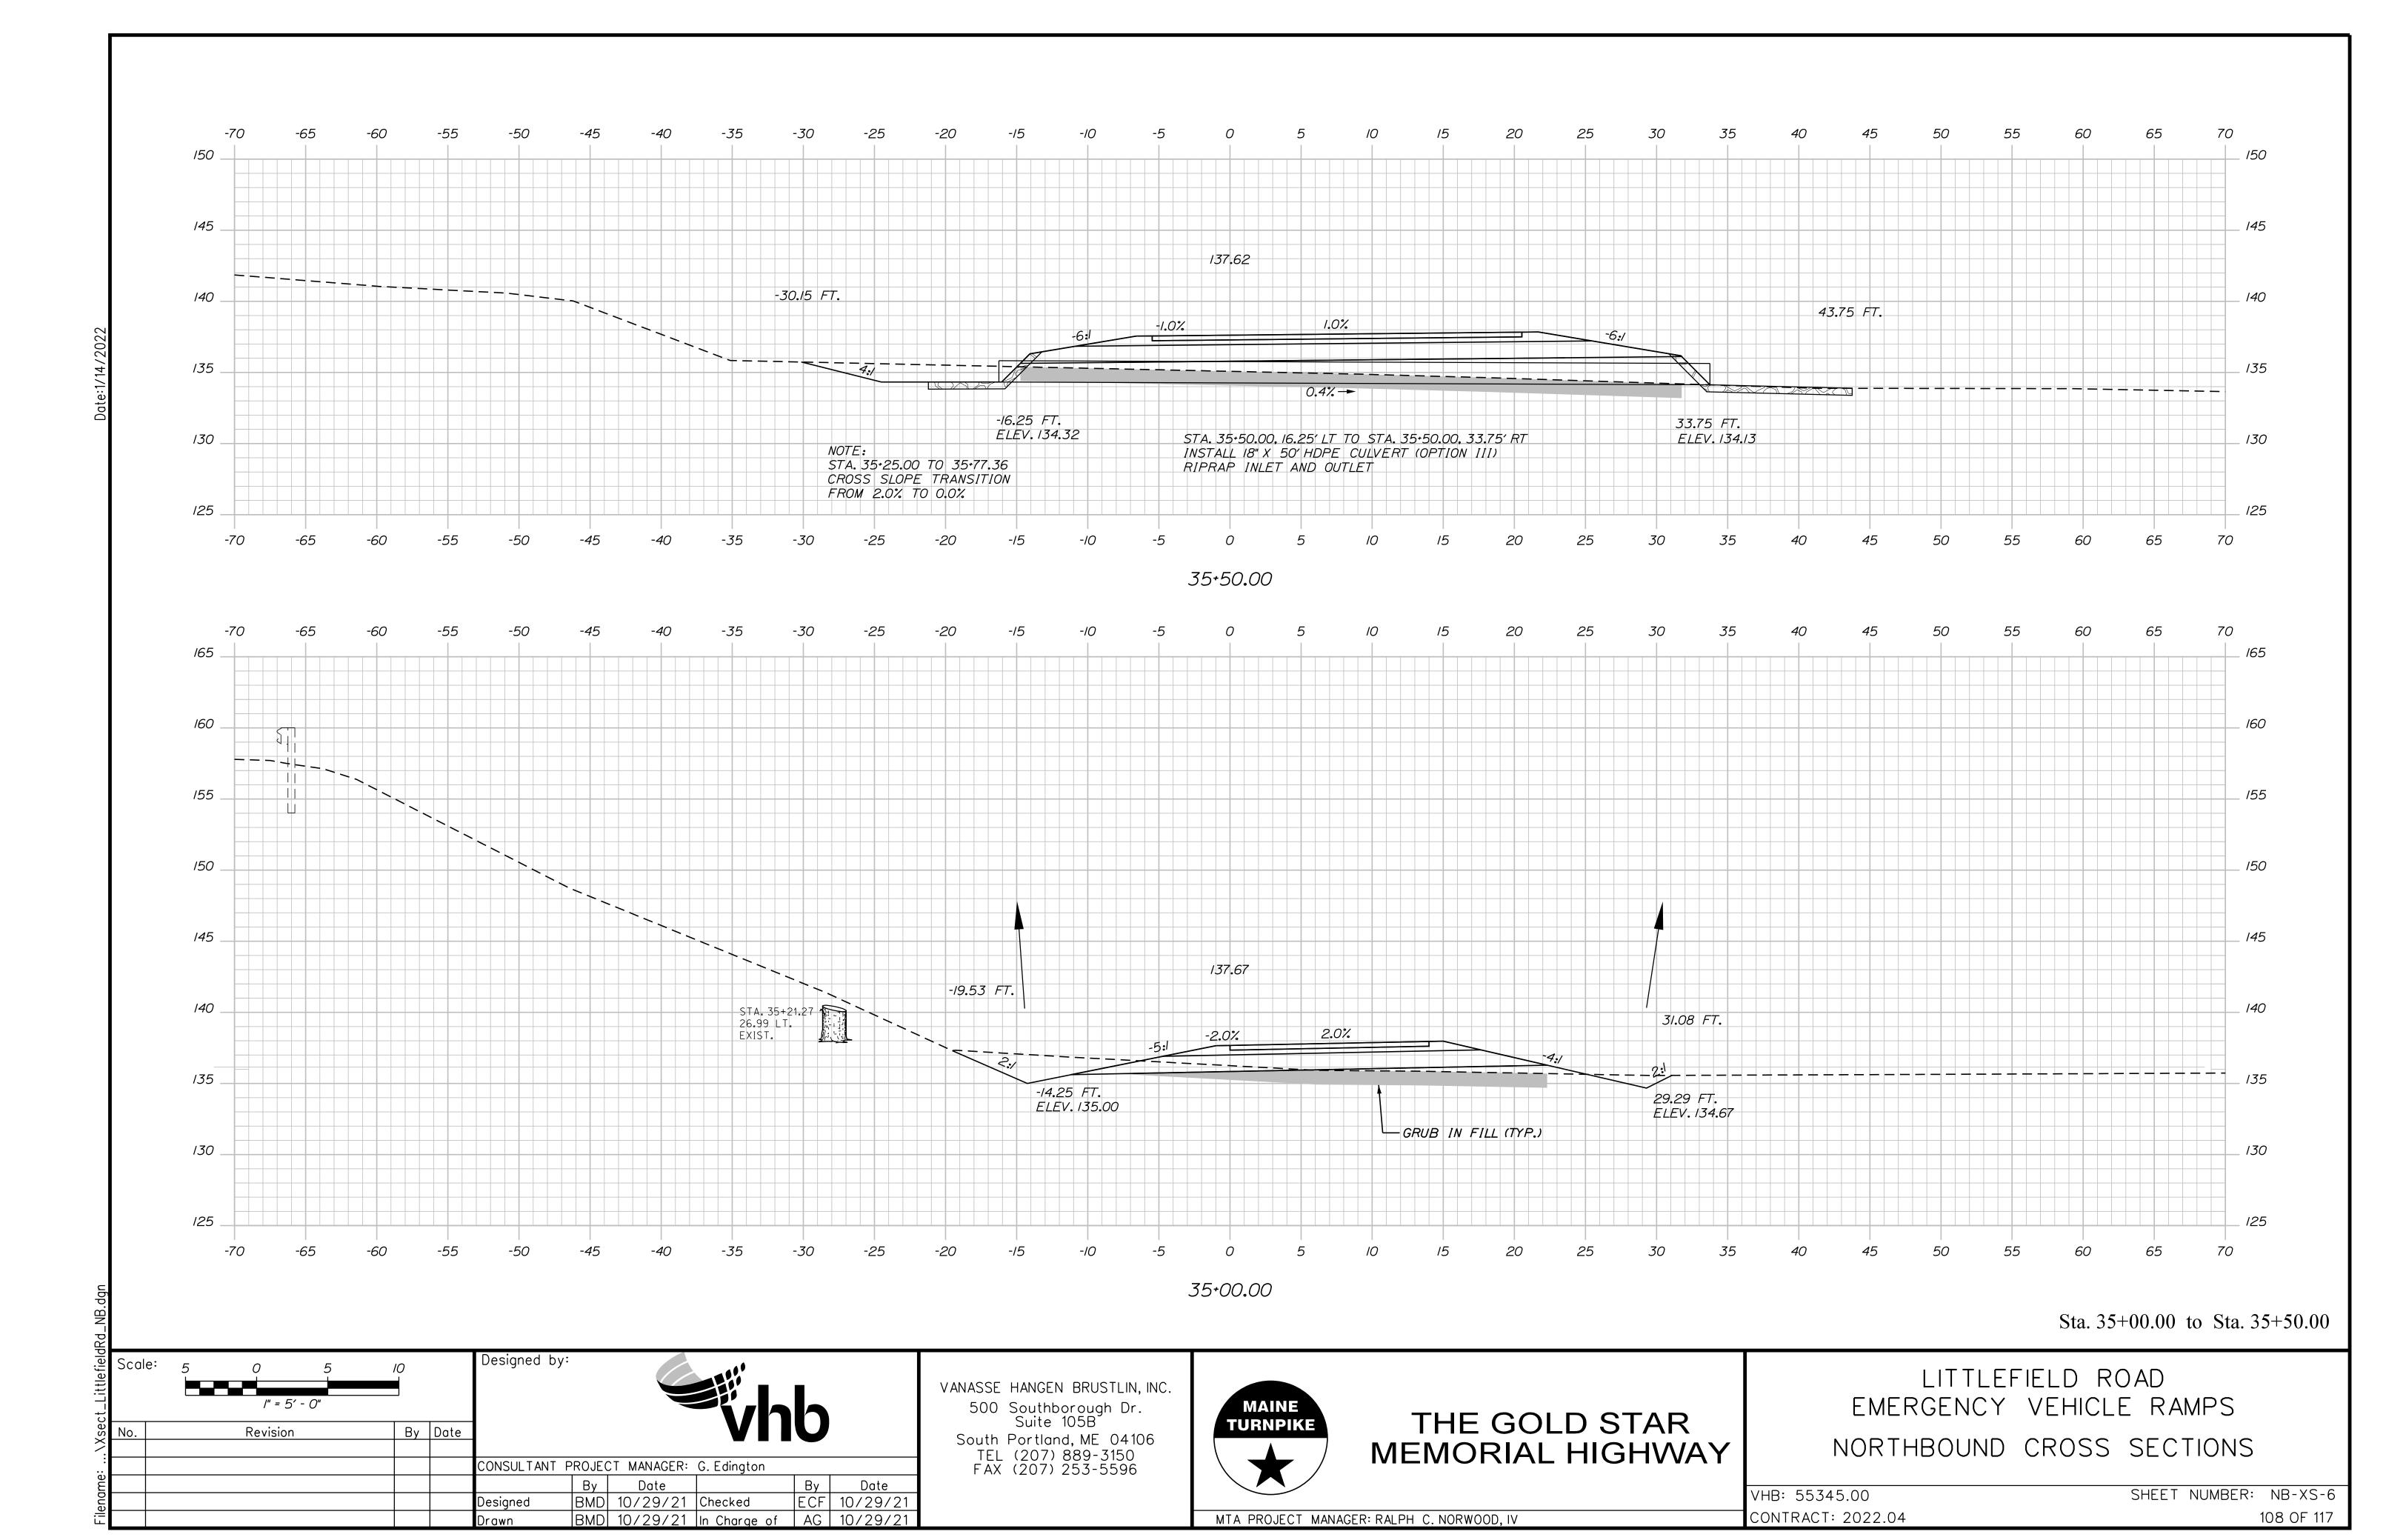

70 145 137.59 MATCH MAINE TURNPIKE NORTHBOUND 140 STA. 35+77.36

END FULL DEPTH CONSTRUCTION

MATCH EXISTING PAVEMENT

LIMIT OF WORK

AT EDGE OF SHOULDER 65 70 *35+77.36* Sta. 35+77.36 Designed by: Scale: LITTLEFIELD ROAD VANASSE HANGEN BRUSTLIN, INC. EMERGENCY VEHICLE RAMPS 500 Southborough Dr. Suite 105B THE GOLD STAR **TURNPIKE** By Date Revision

CONSULTANT PROJECT MANAGER: G. Edington By Date ECF 10/29/21 BMD 10/29/21 Checked Designed BMD 10/29/21 In Charge of AG 10/29/21


South Portland, ME 04106 TEL (207) 889-3150 FAX (207) 253-5596




MEMORIAL HIGHWAY

NORTHBOUND CROSS SECTIONS

SHEET NUMBER: NB-XS-7 VHB: 55345.00 CONTRACT: 2022.04 109 OF 117

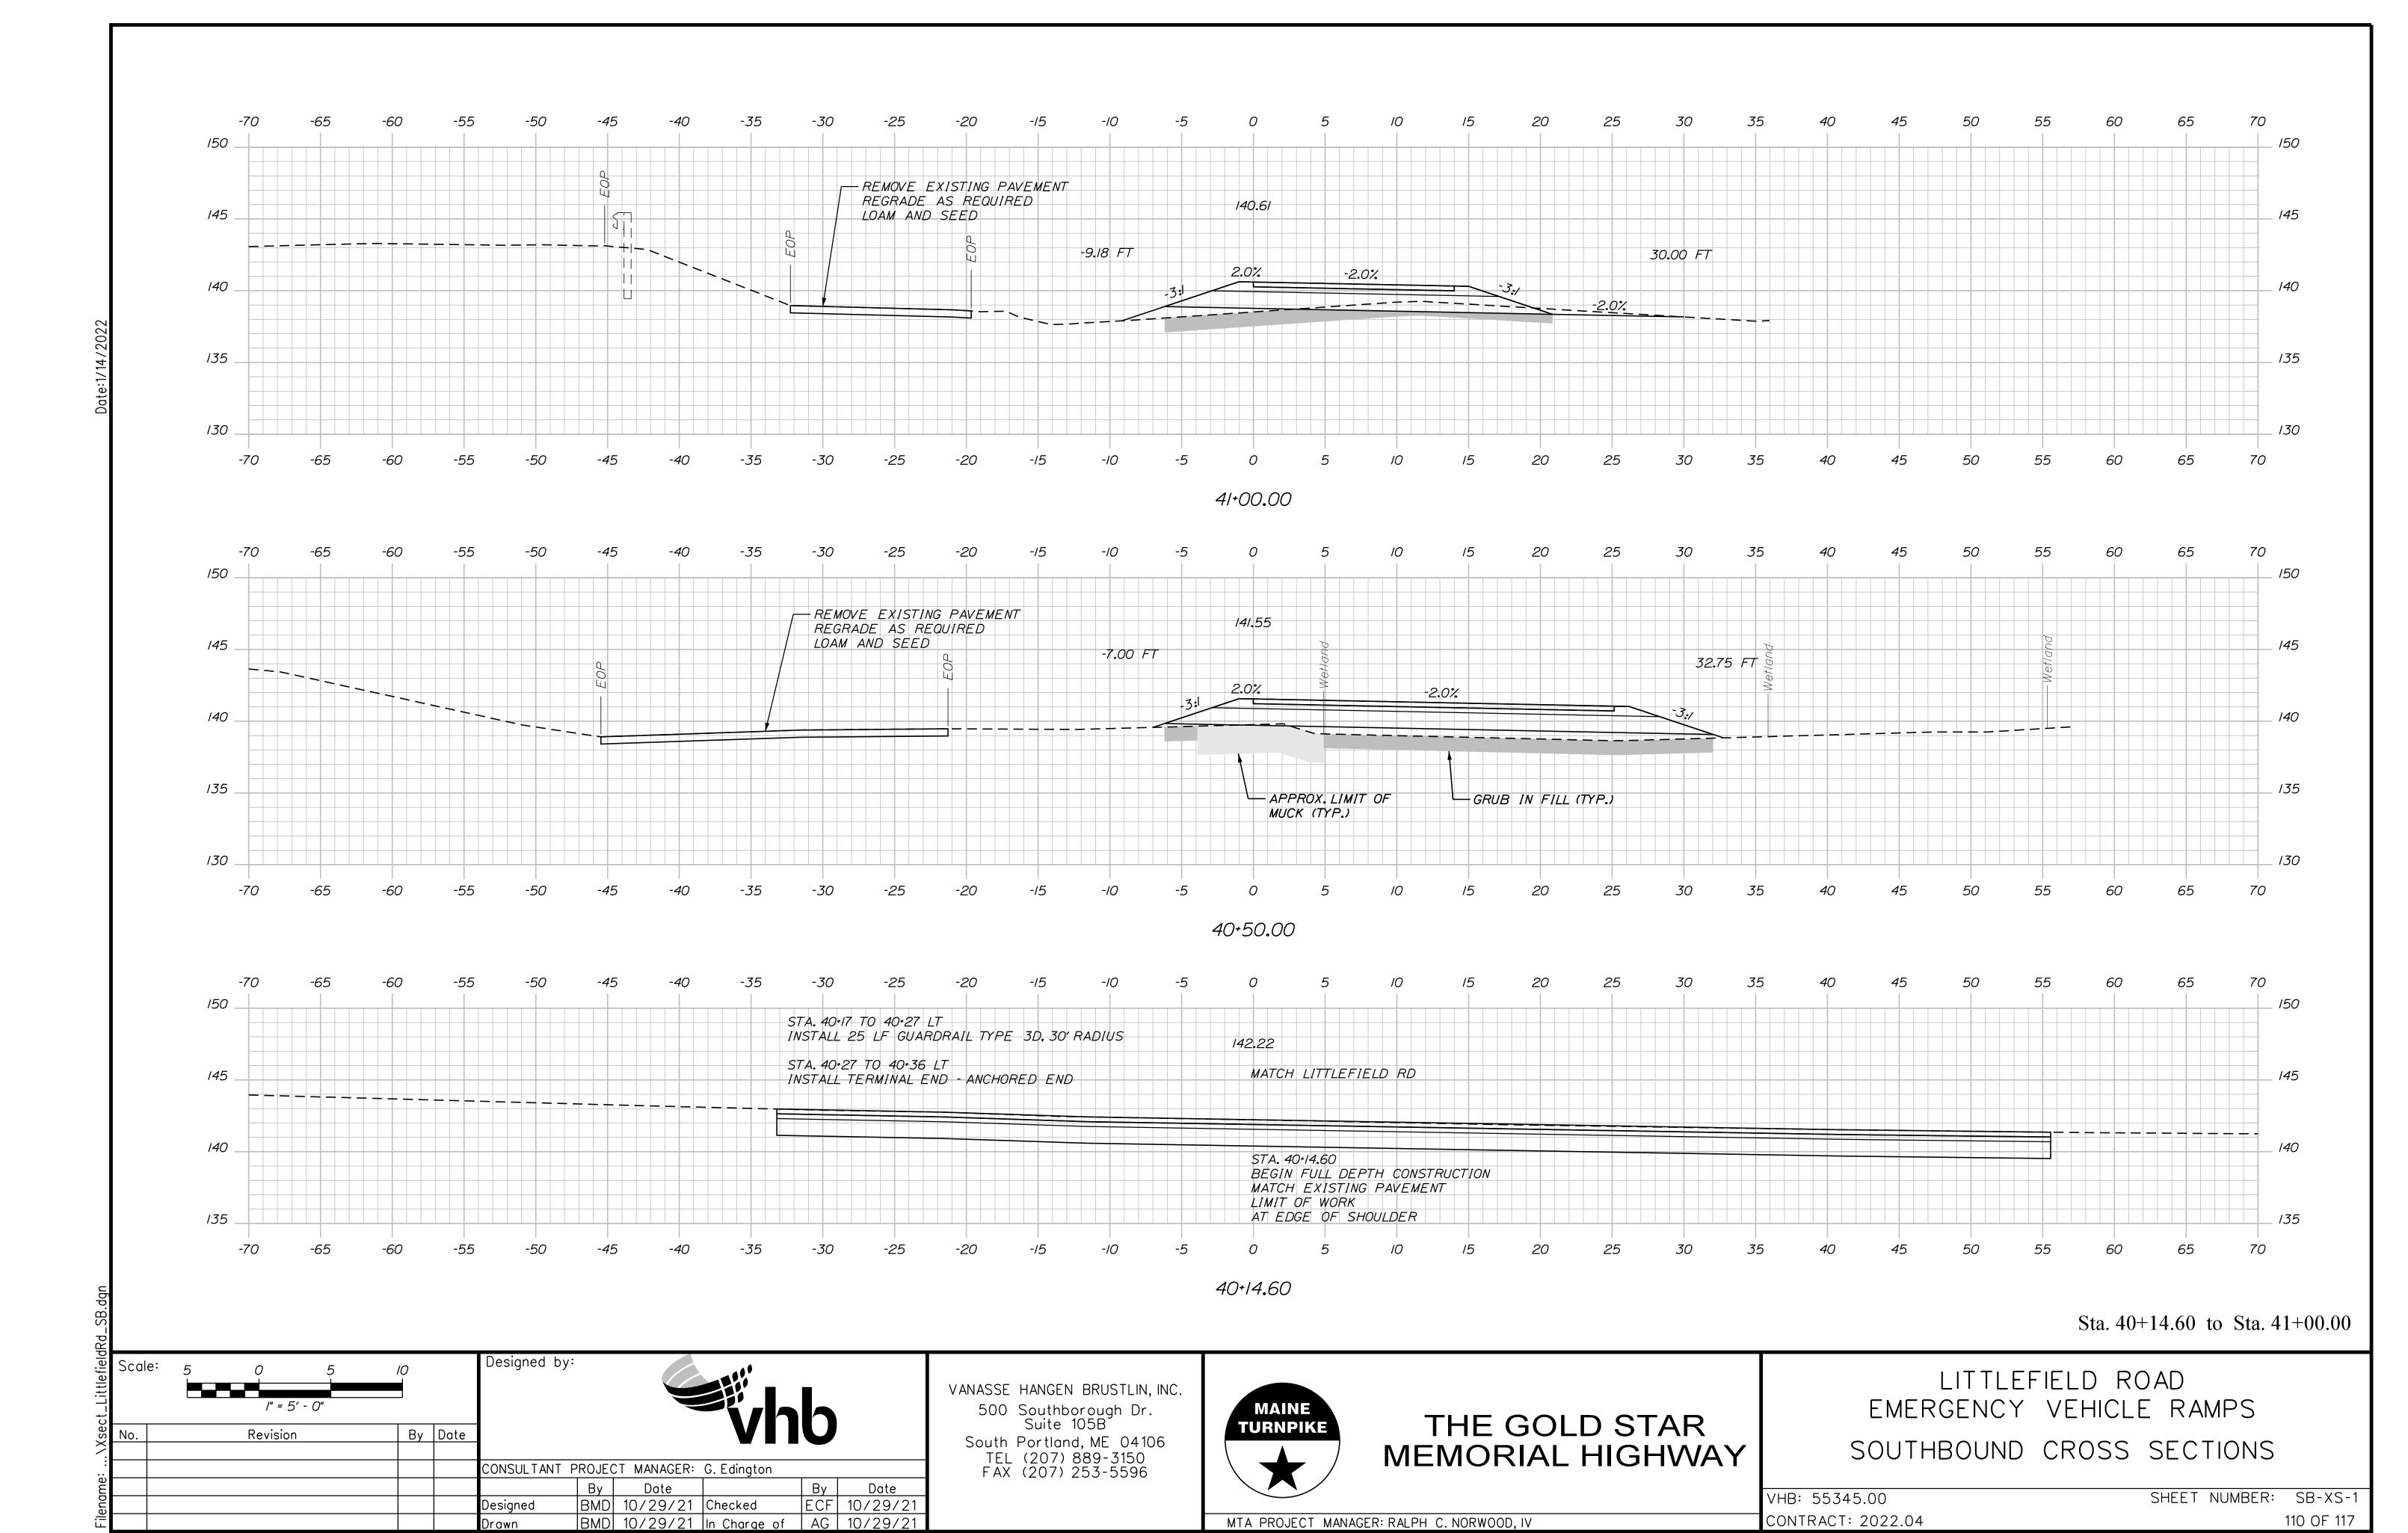

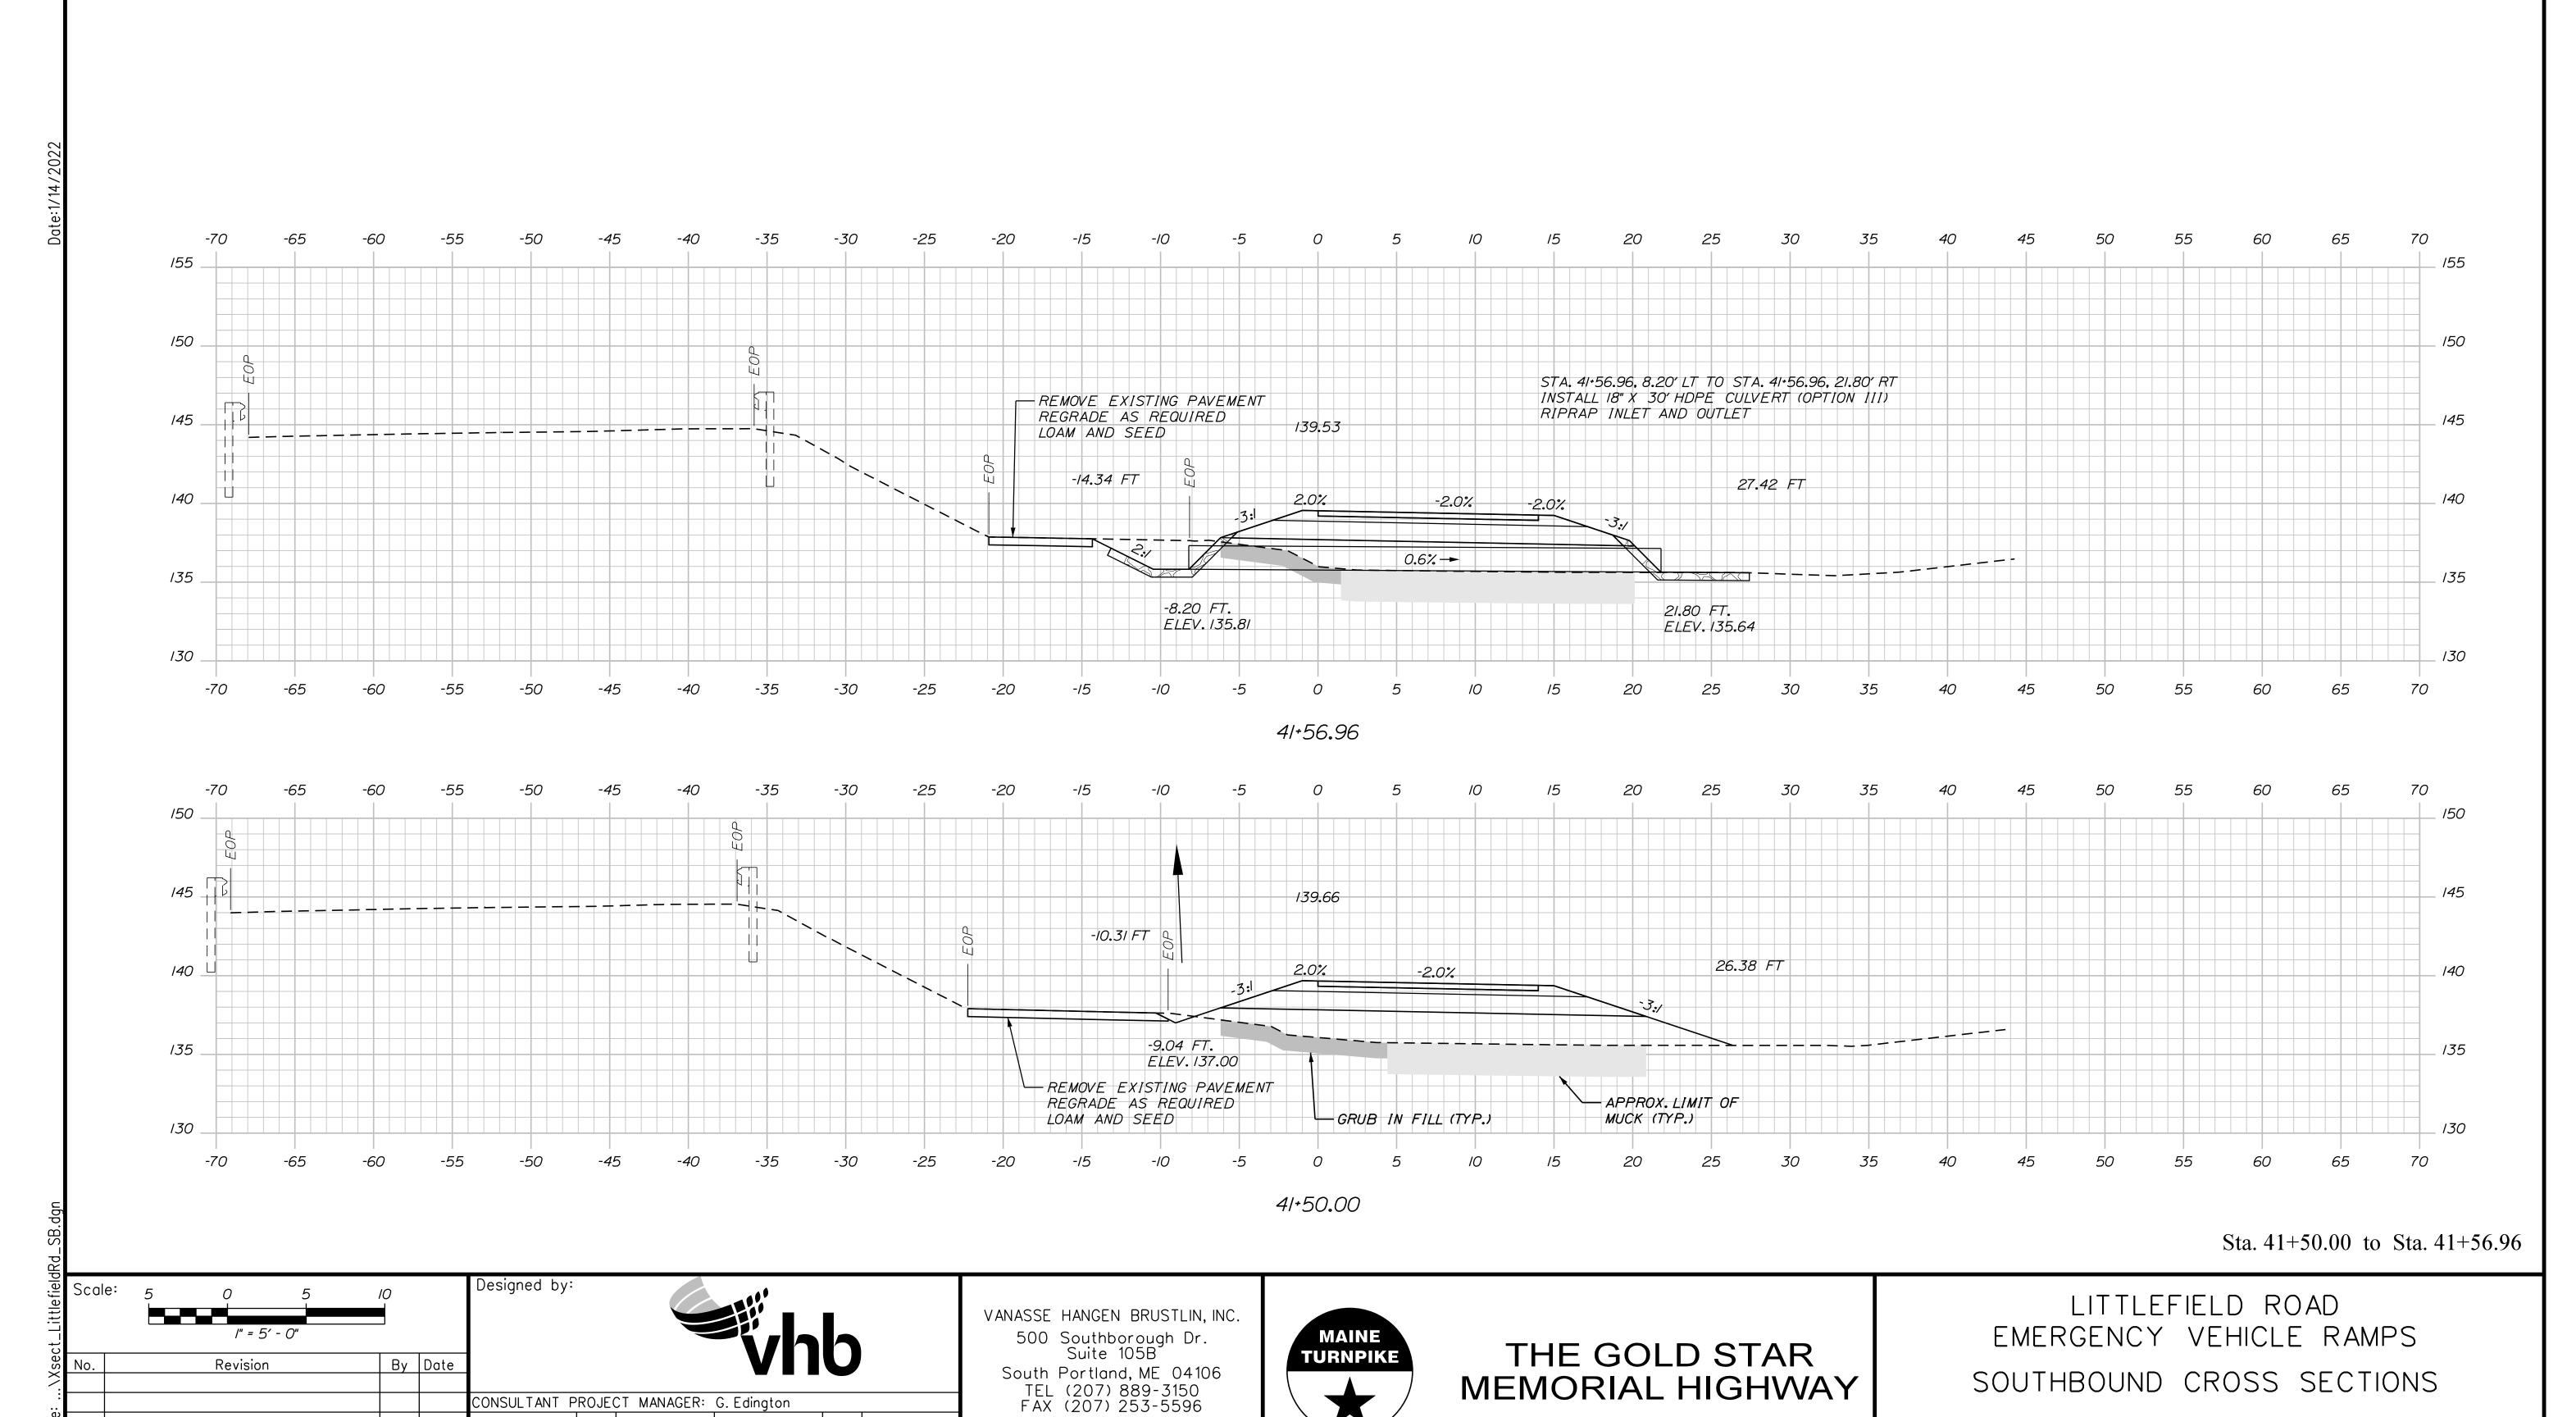

SHEET NUMBER: SB-XS-2

111 OF 117

VHB: 55345.00


CONTRACT: 2022.04

By Date ECF 10/29/21

BMD 10/29/21 Checked

BMD 10/29/21 In Charge of AG 10/29/21

Designed

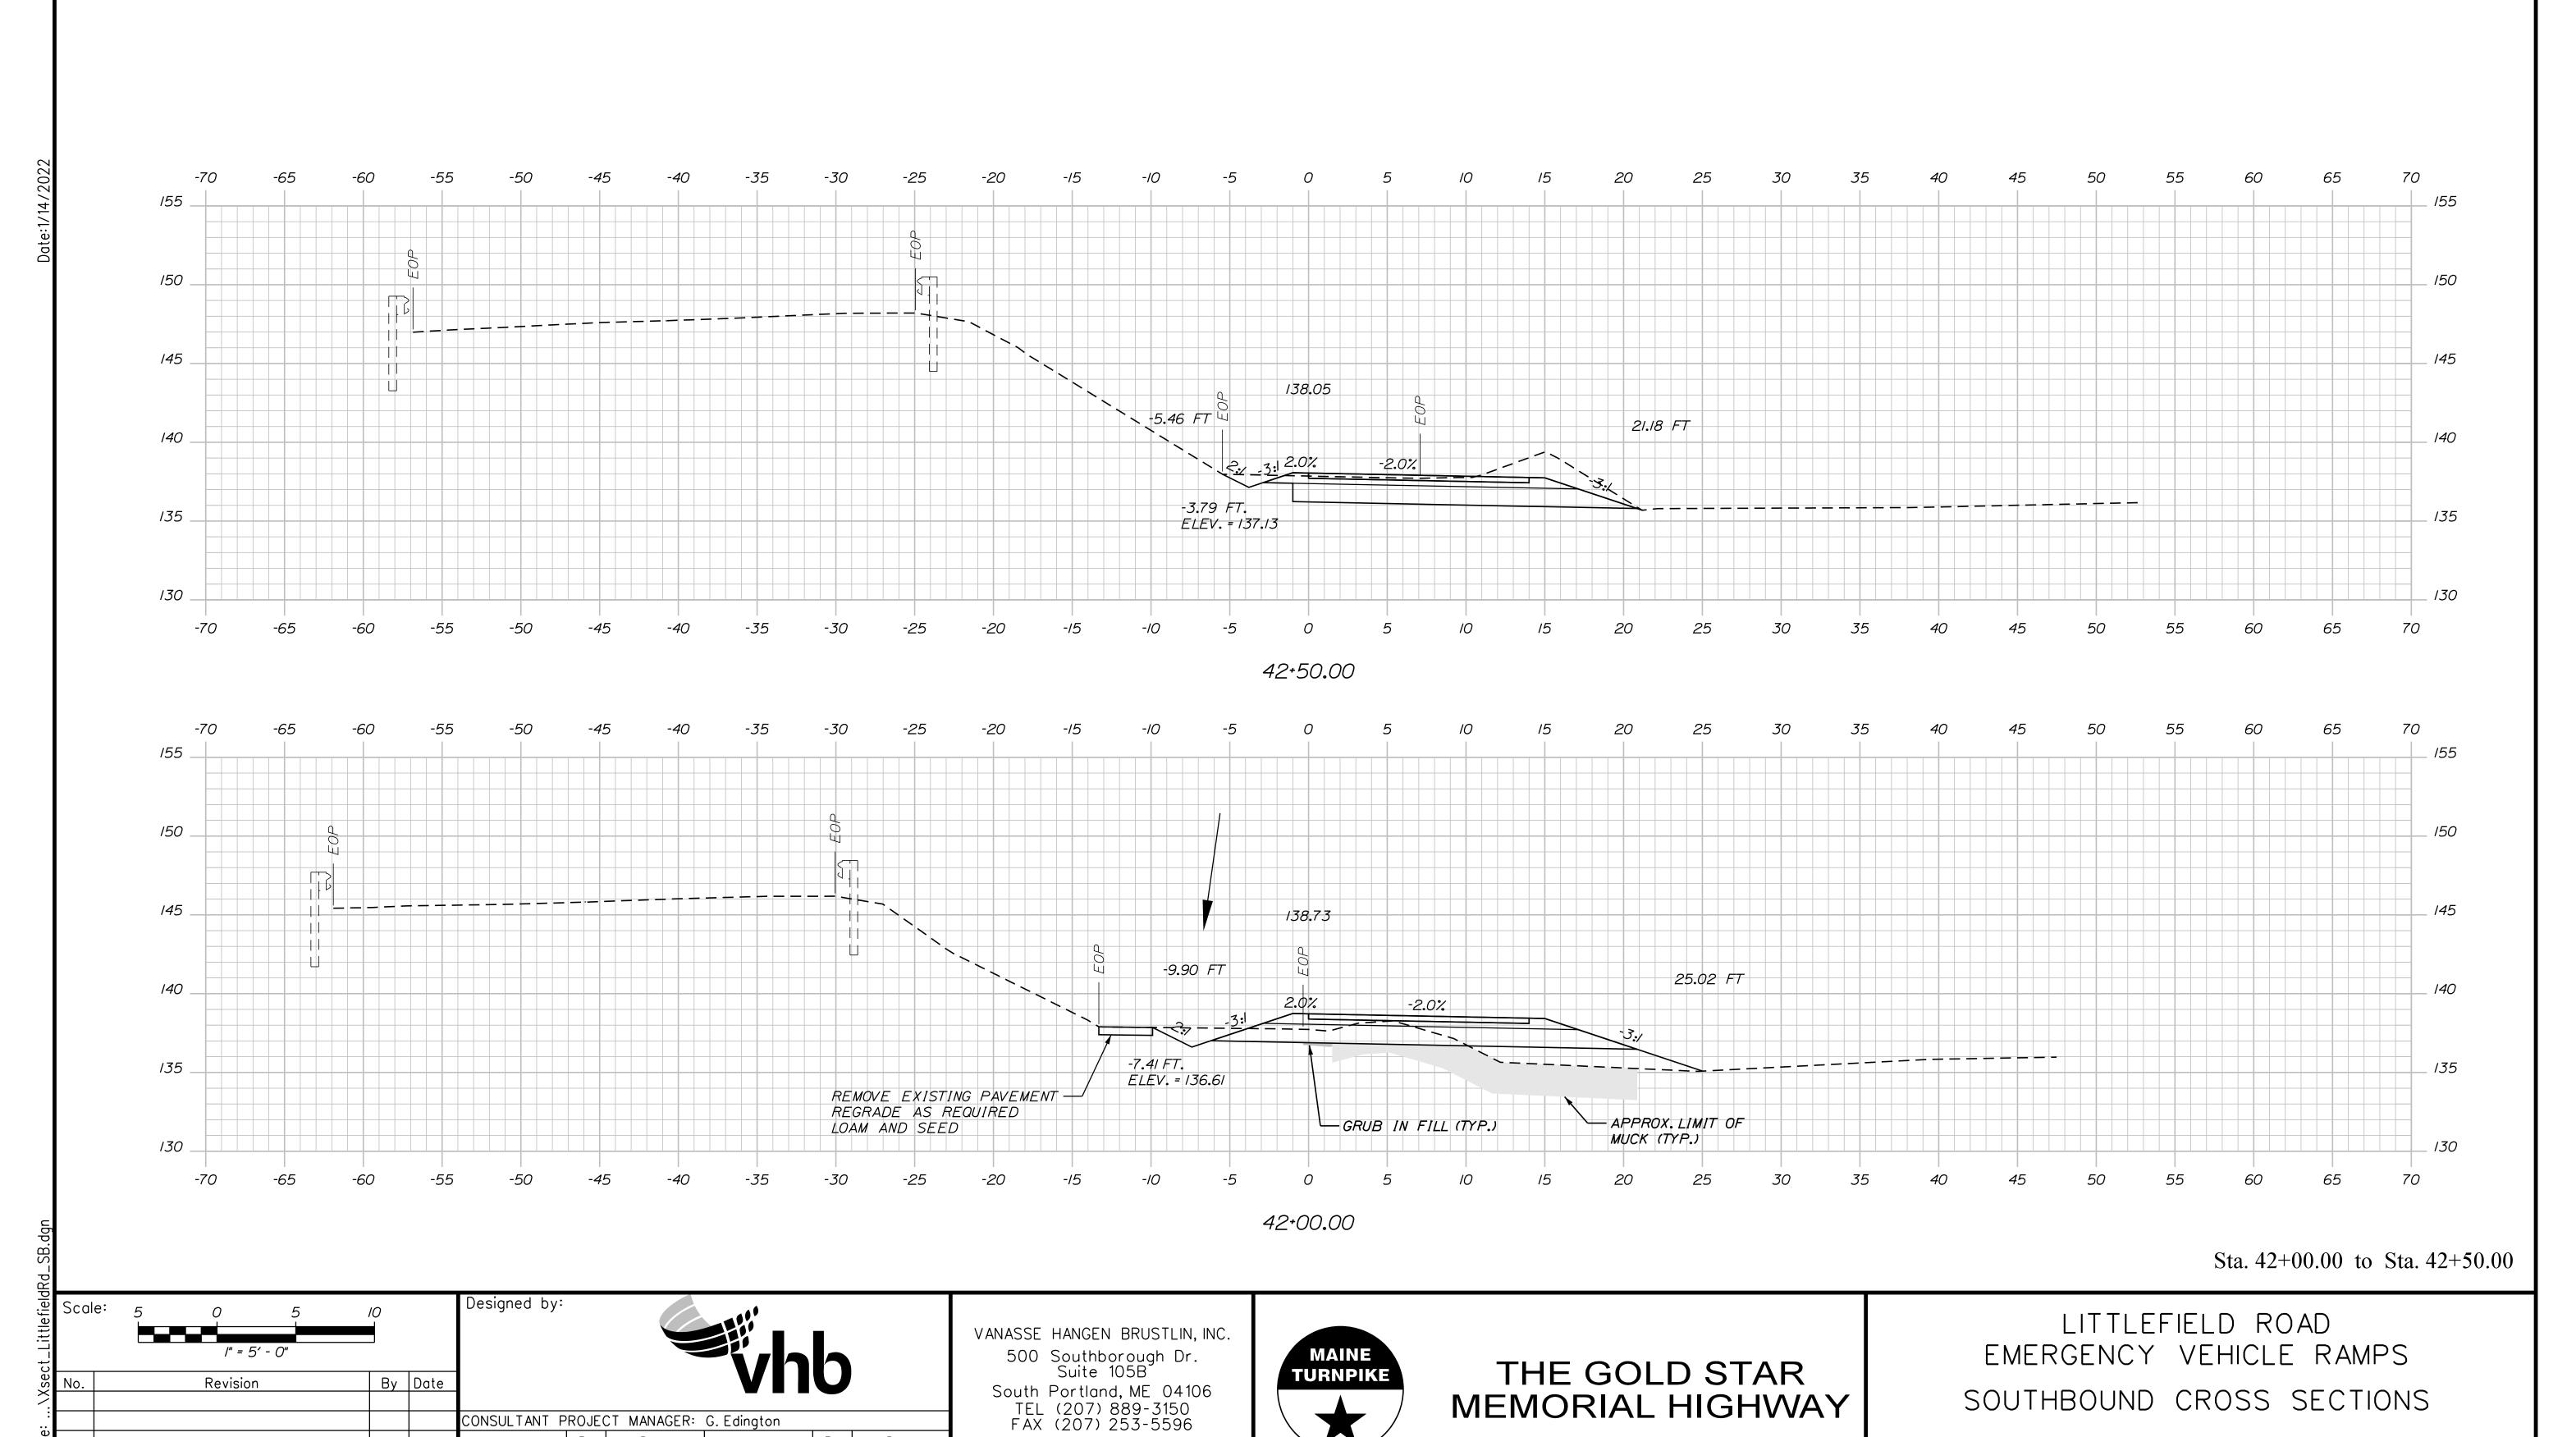

SHEET NUMBER: SB-XS-3

112 OF 117

VHB: 55345.00

CONTRACT: 2022.04


CONSULTANT PROJECT MANAGER: G. Edington


Designed


BMD 10/29/21 Checked

BMD 10/29/21 In Charge of AG 10/29/21

By Date ECF 10/29/21

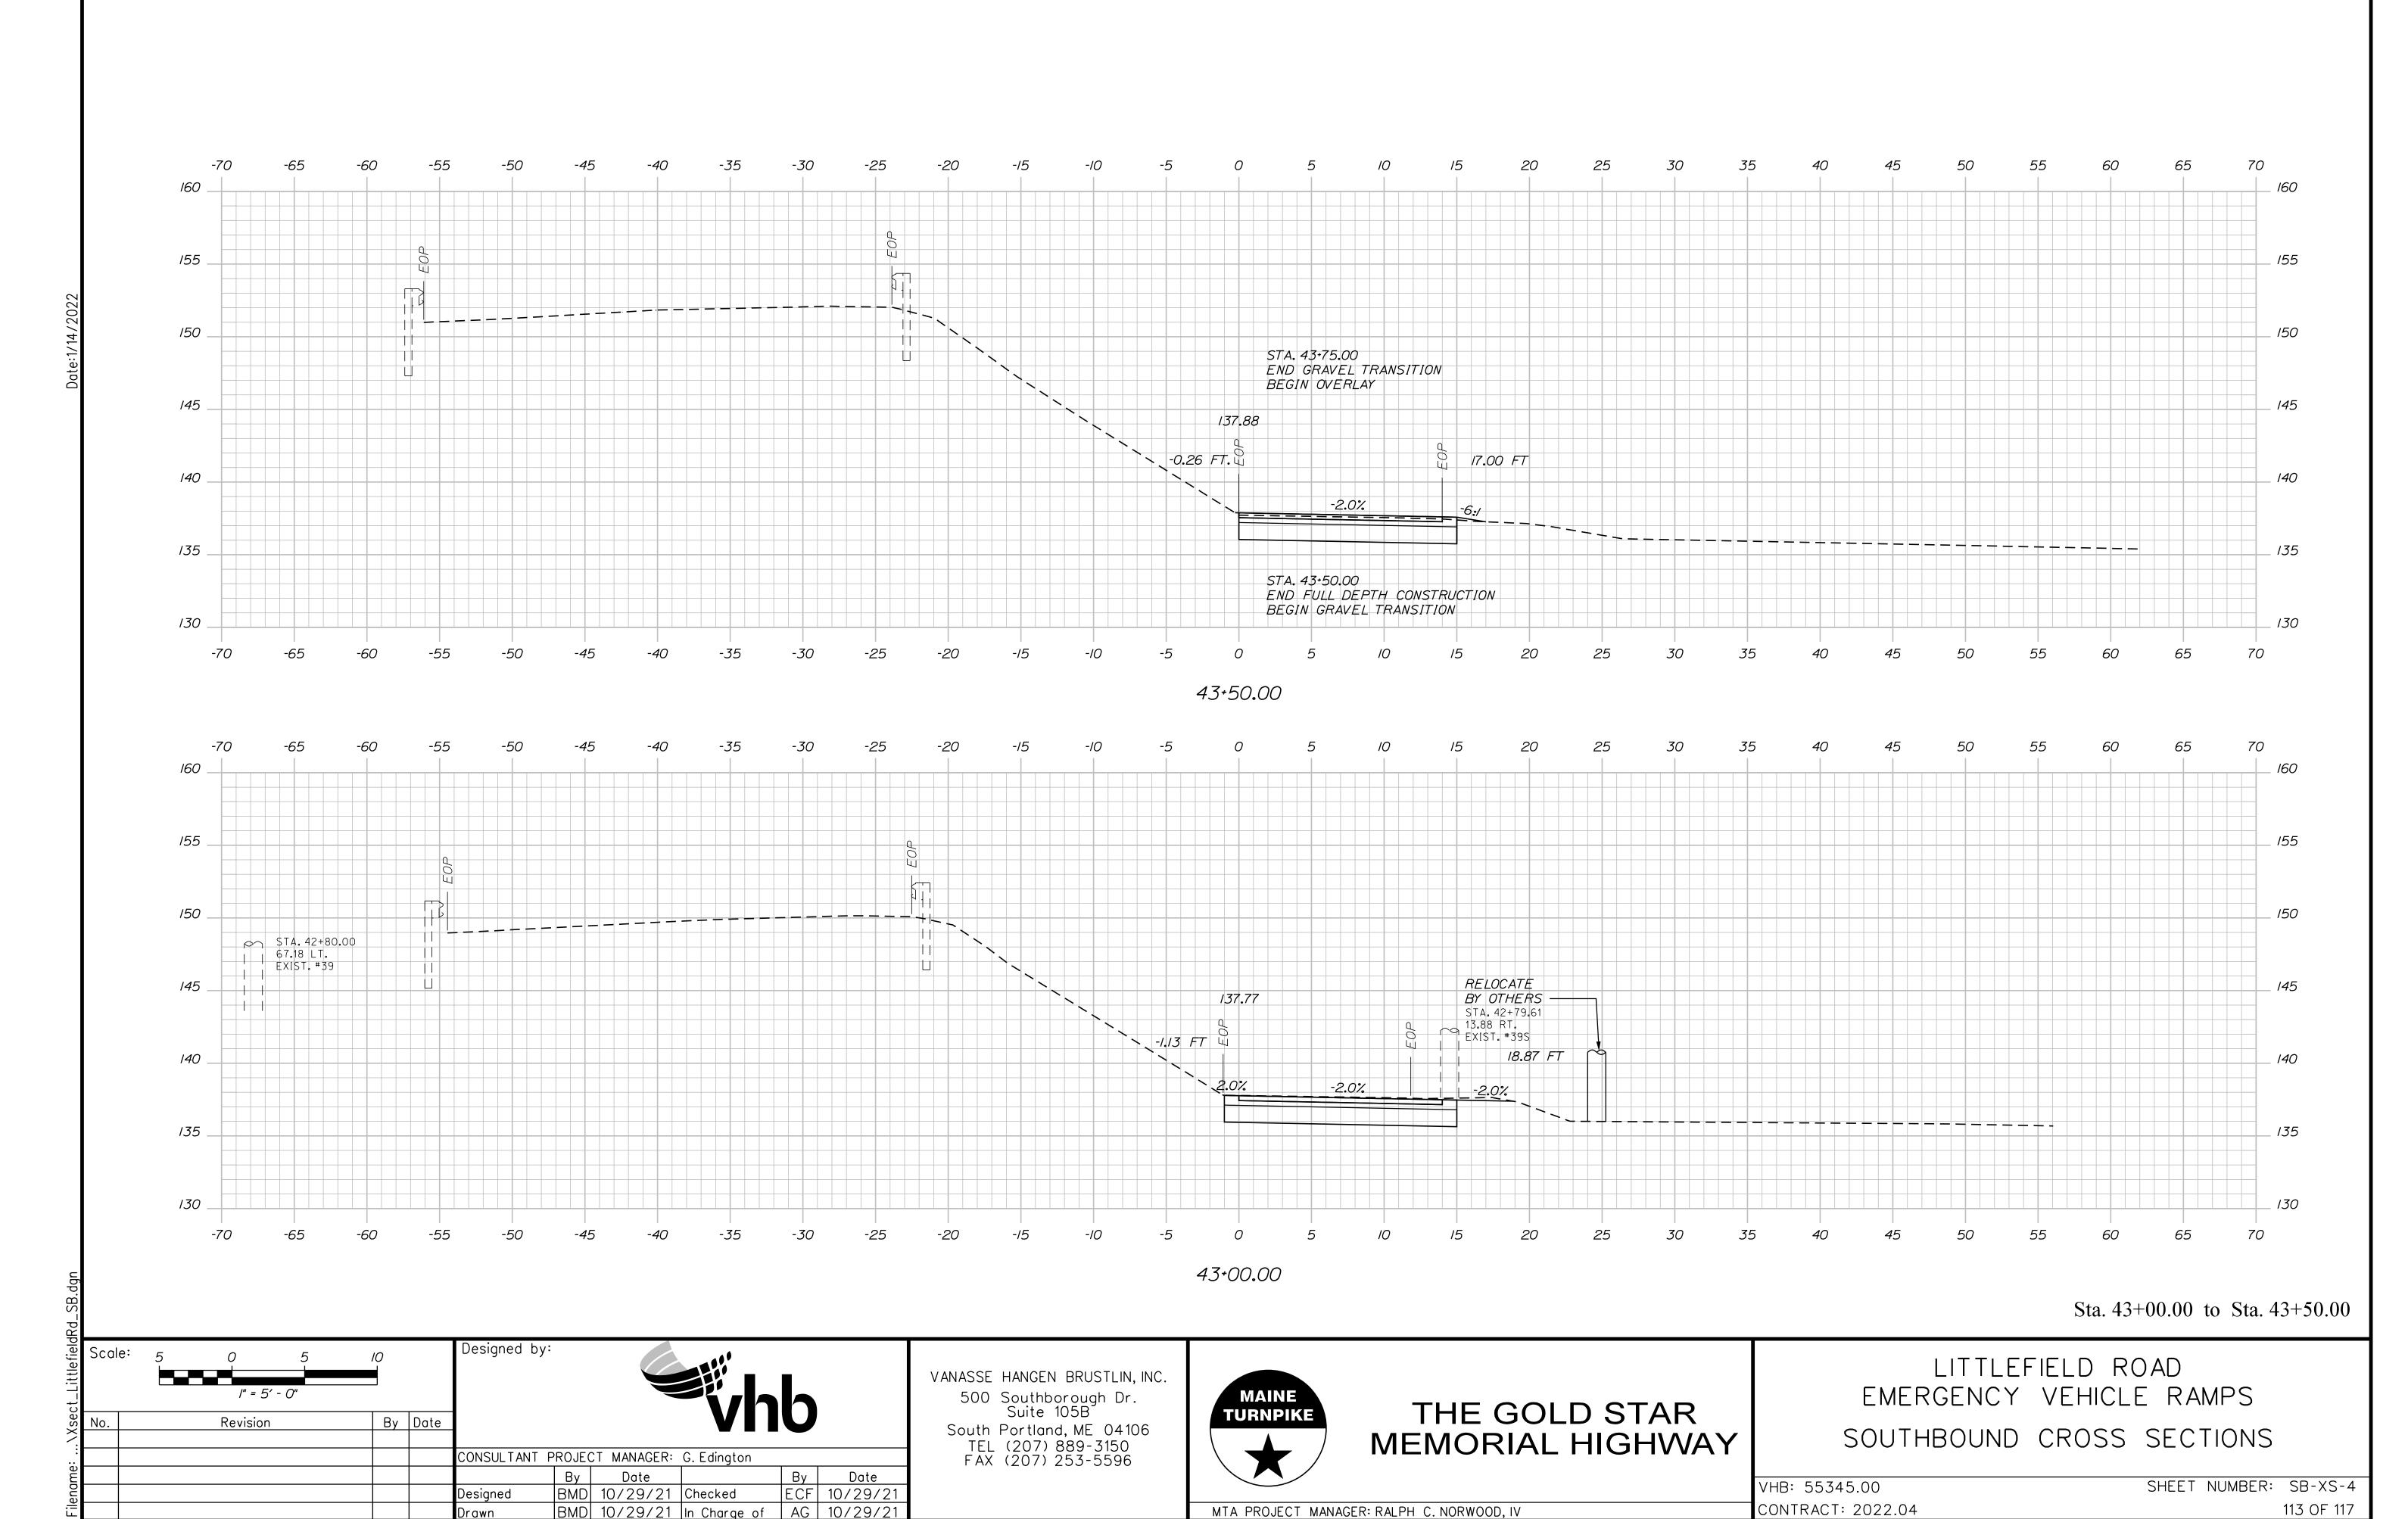

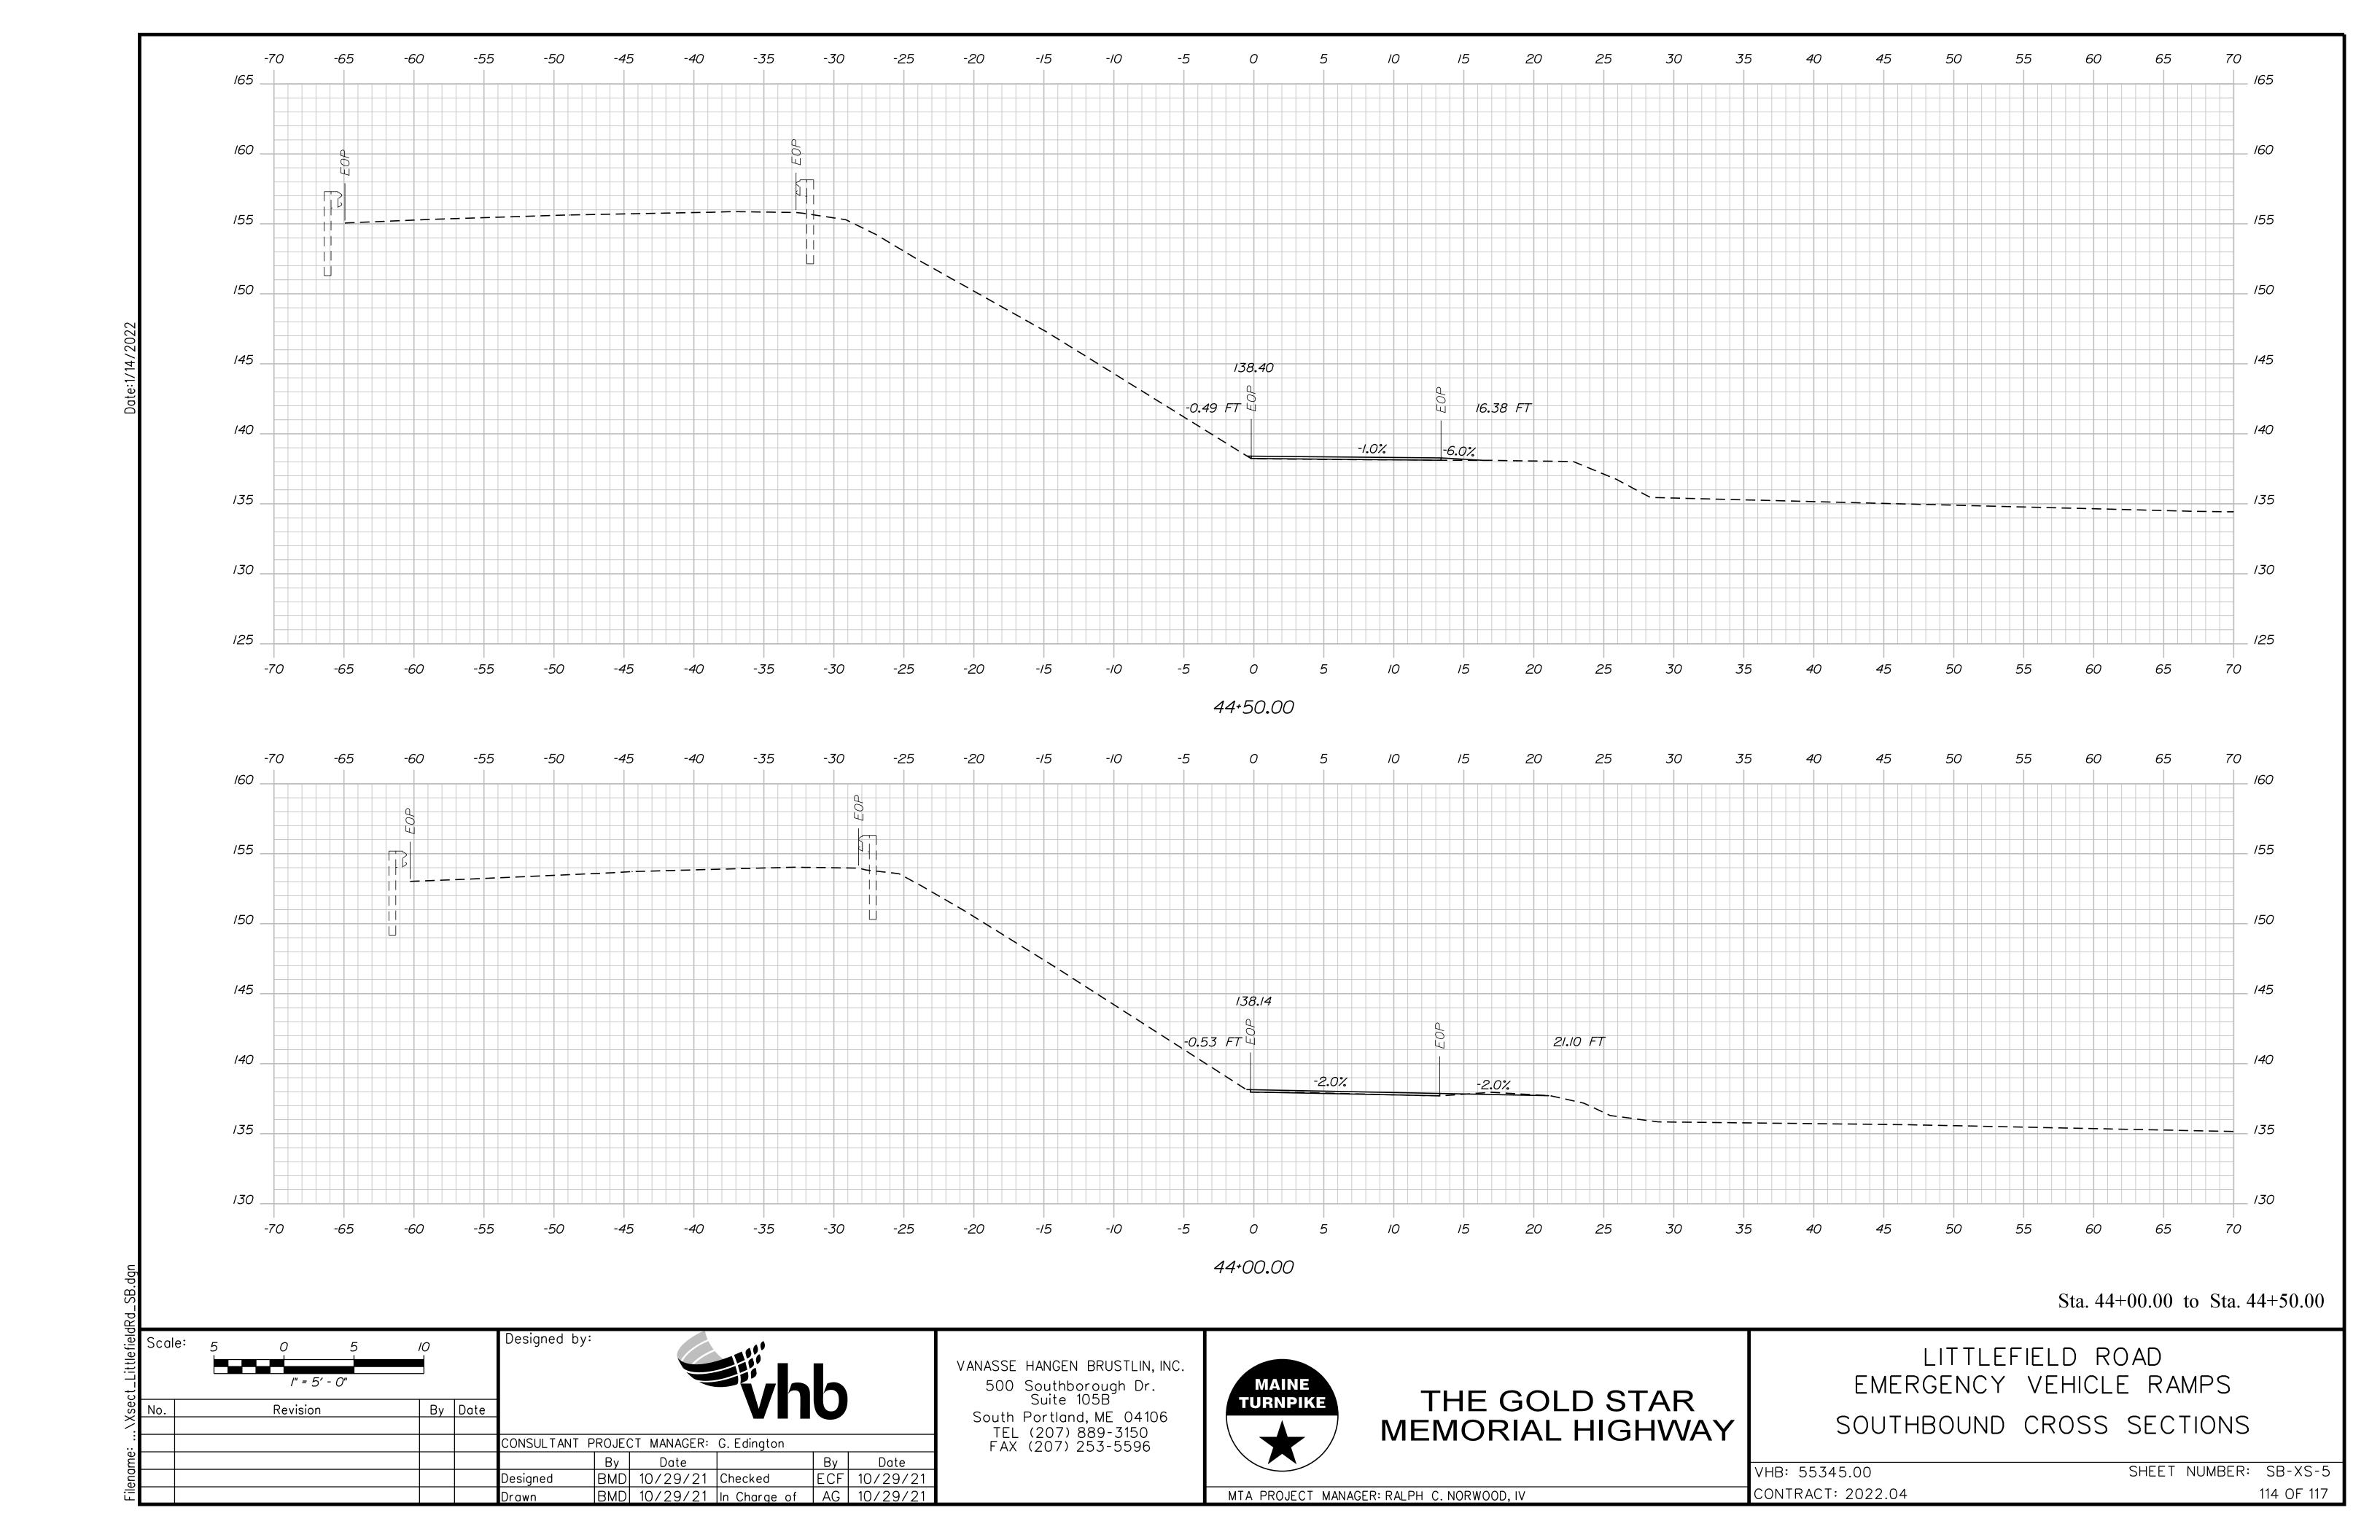

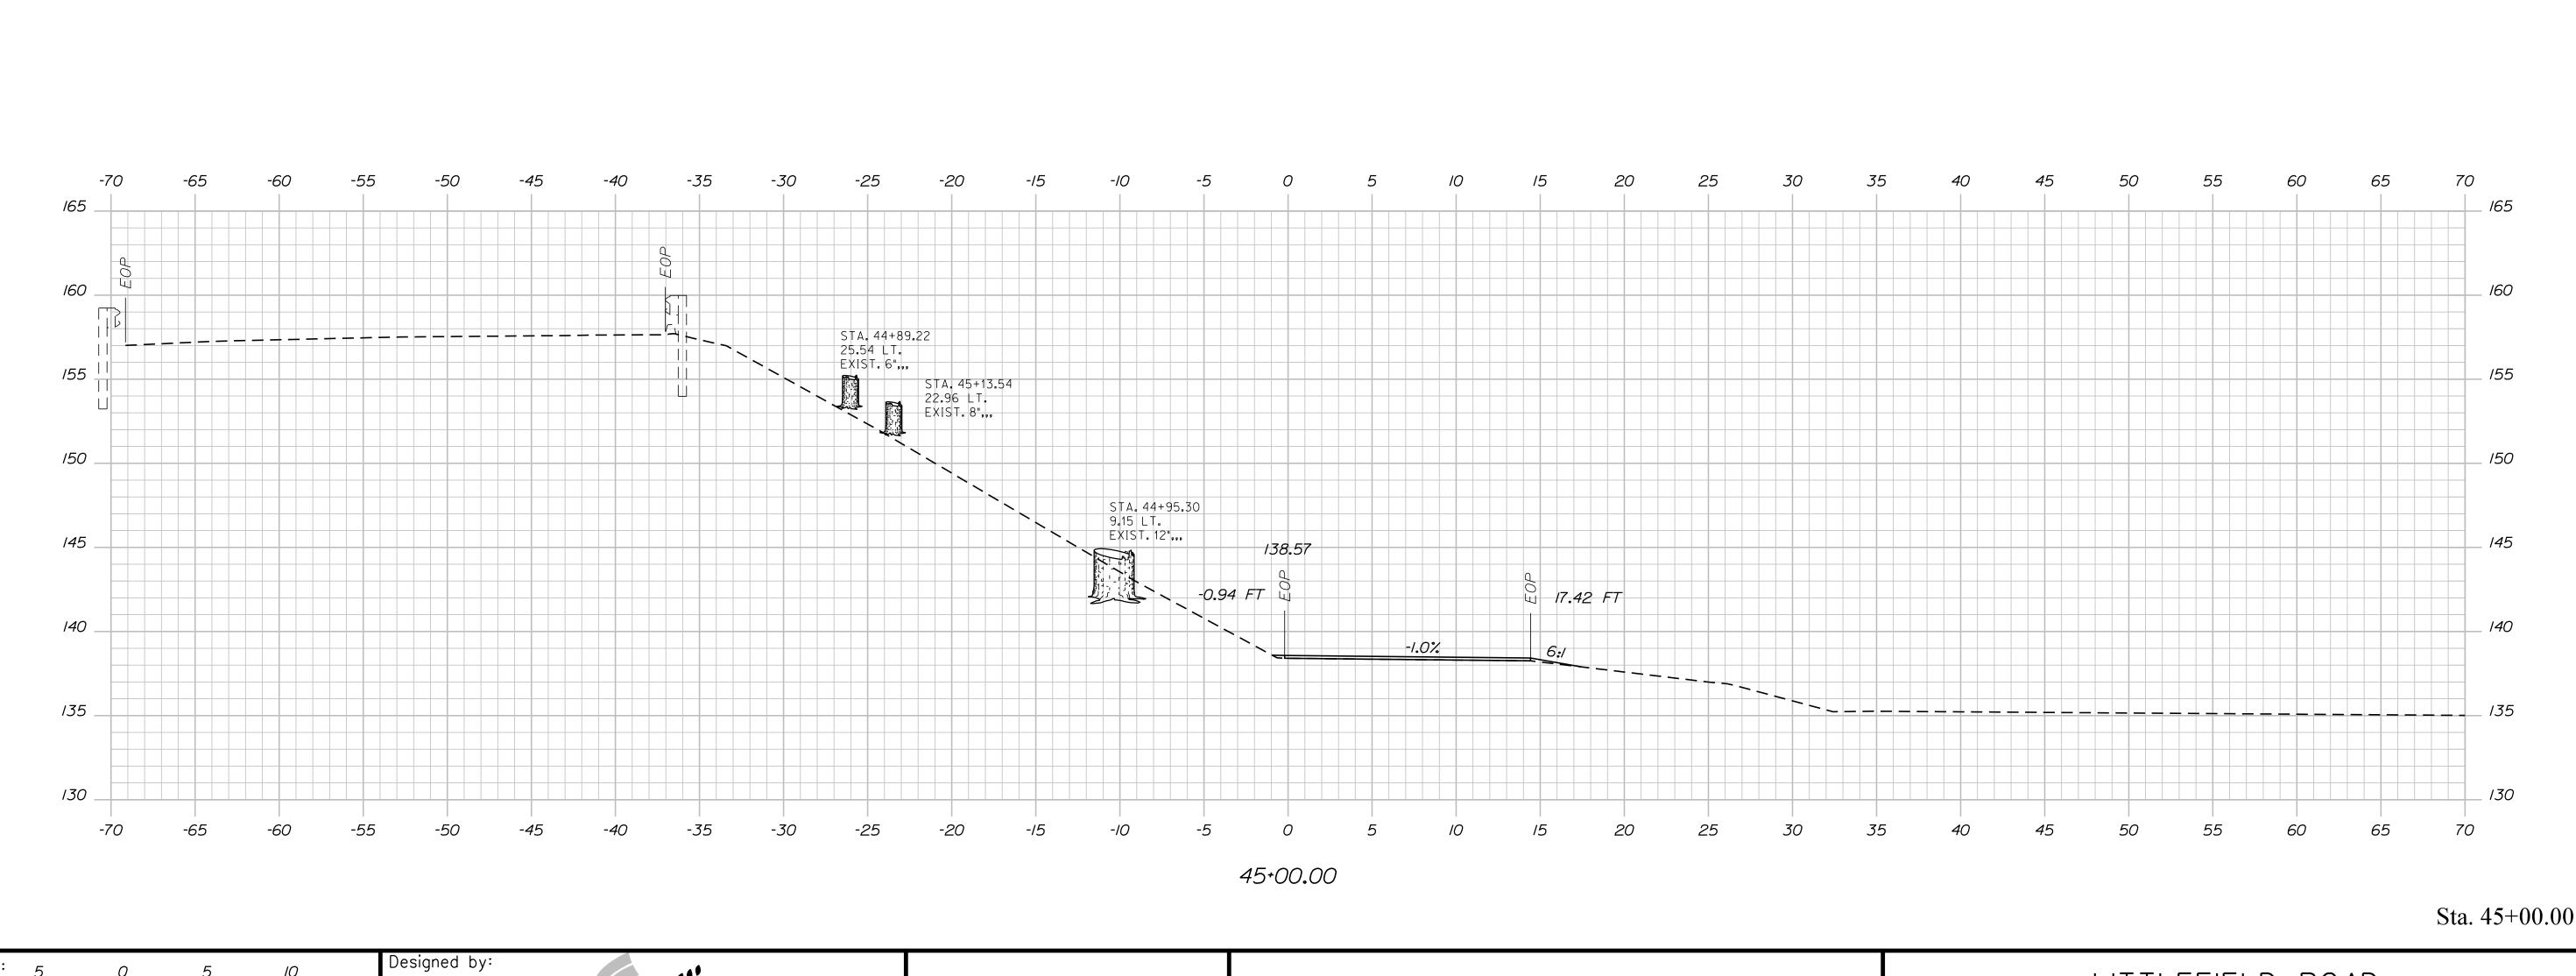

VANASSE HANGEN BRUSTLIN, INC.

500 Southborough Dr.
Suite 105B


South Portland, ME 04106
TEL (207) 889-3150
FAX (207) 253-5596



THE GOLD STAR MEMORIAL HIGHWAY

LITTLEFIELD ROAD
EMERGENCY VEHICLE RAMPS
SOUTHBOUND CROSS SECTIONS

VHB: 55345.00 SHEET NUMBER: SB-XS-6 CONTRACT: 2022.04 115 OF 117

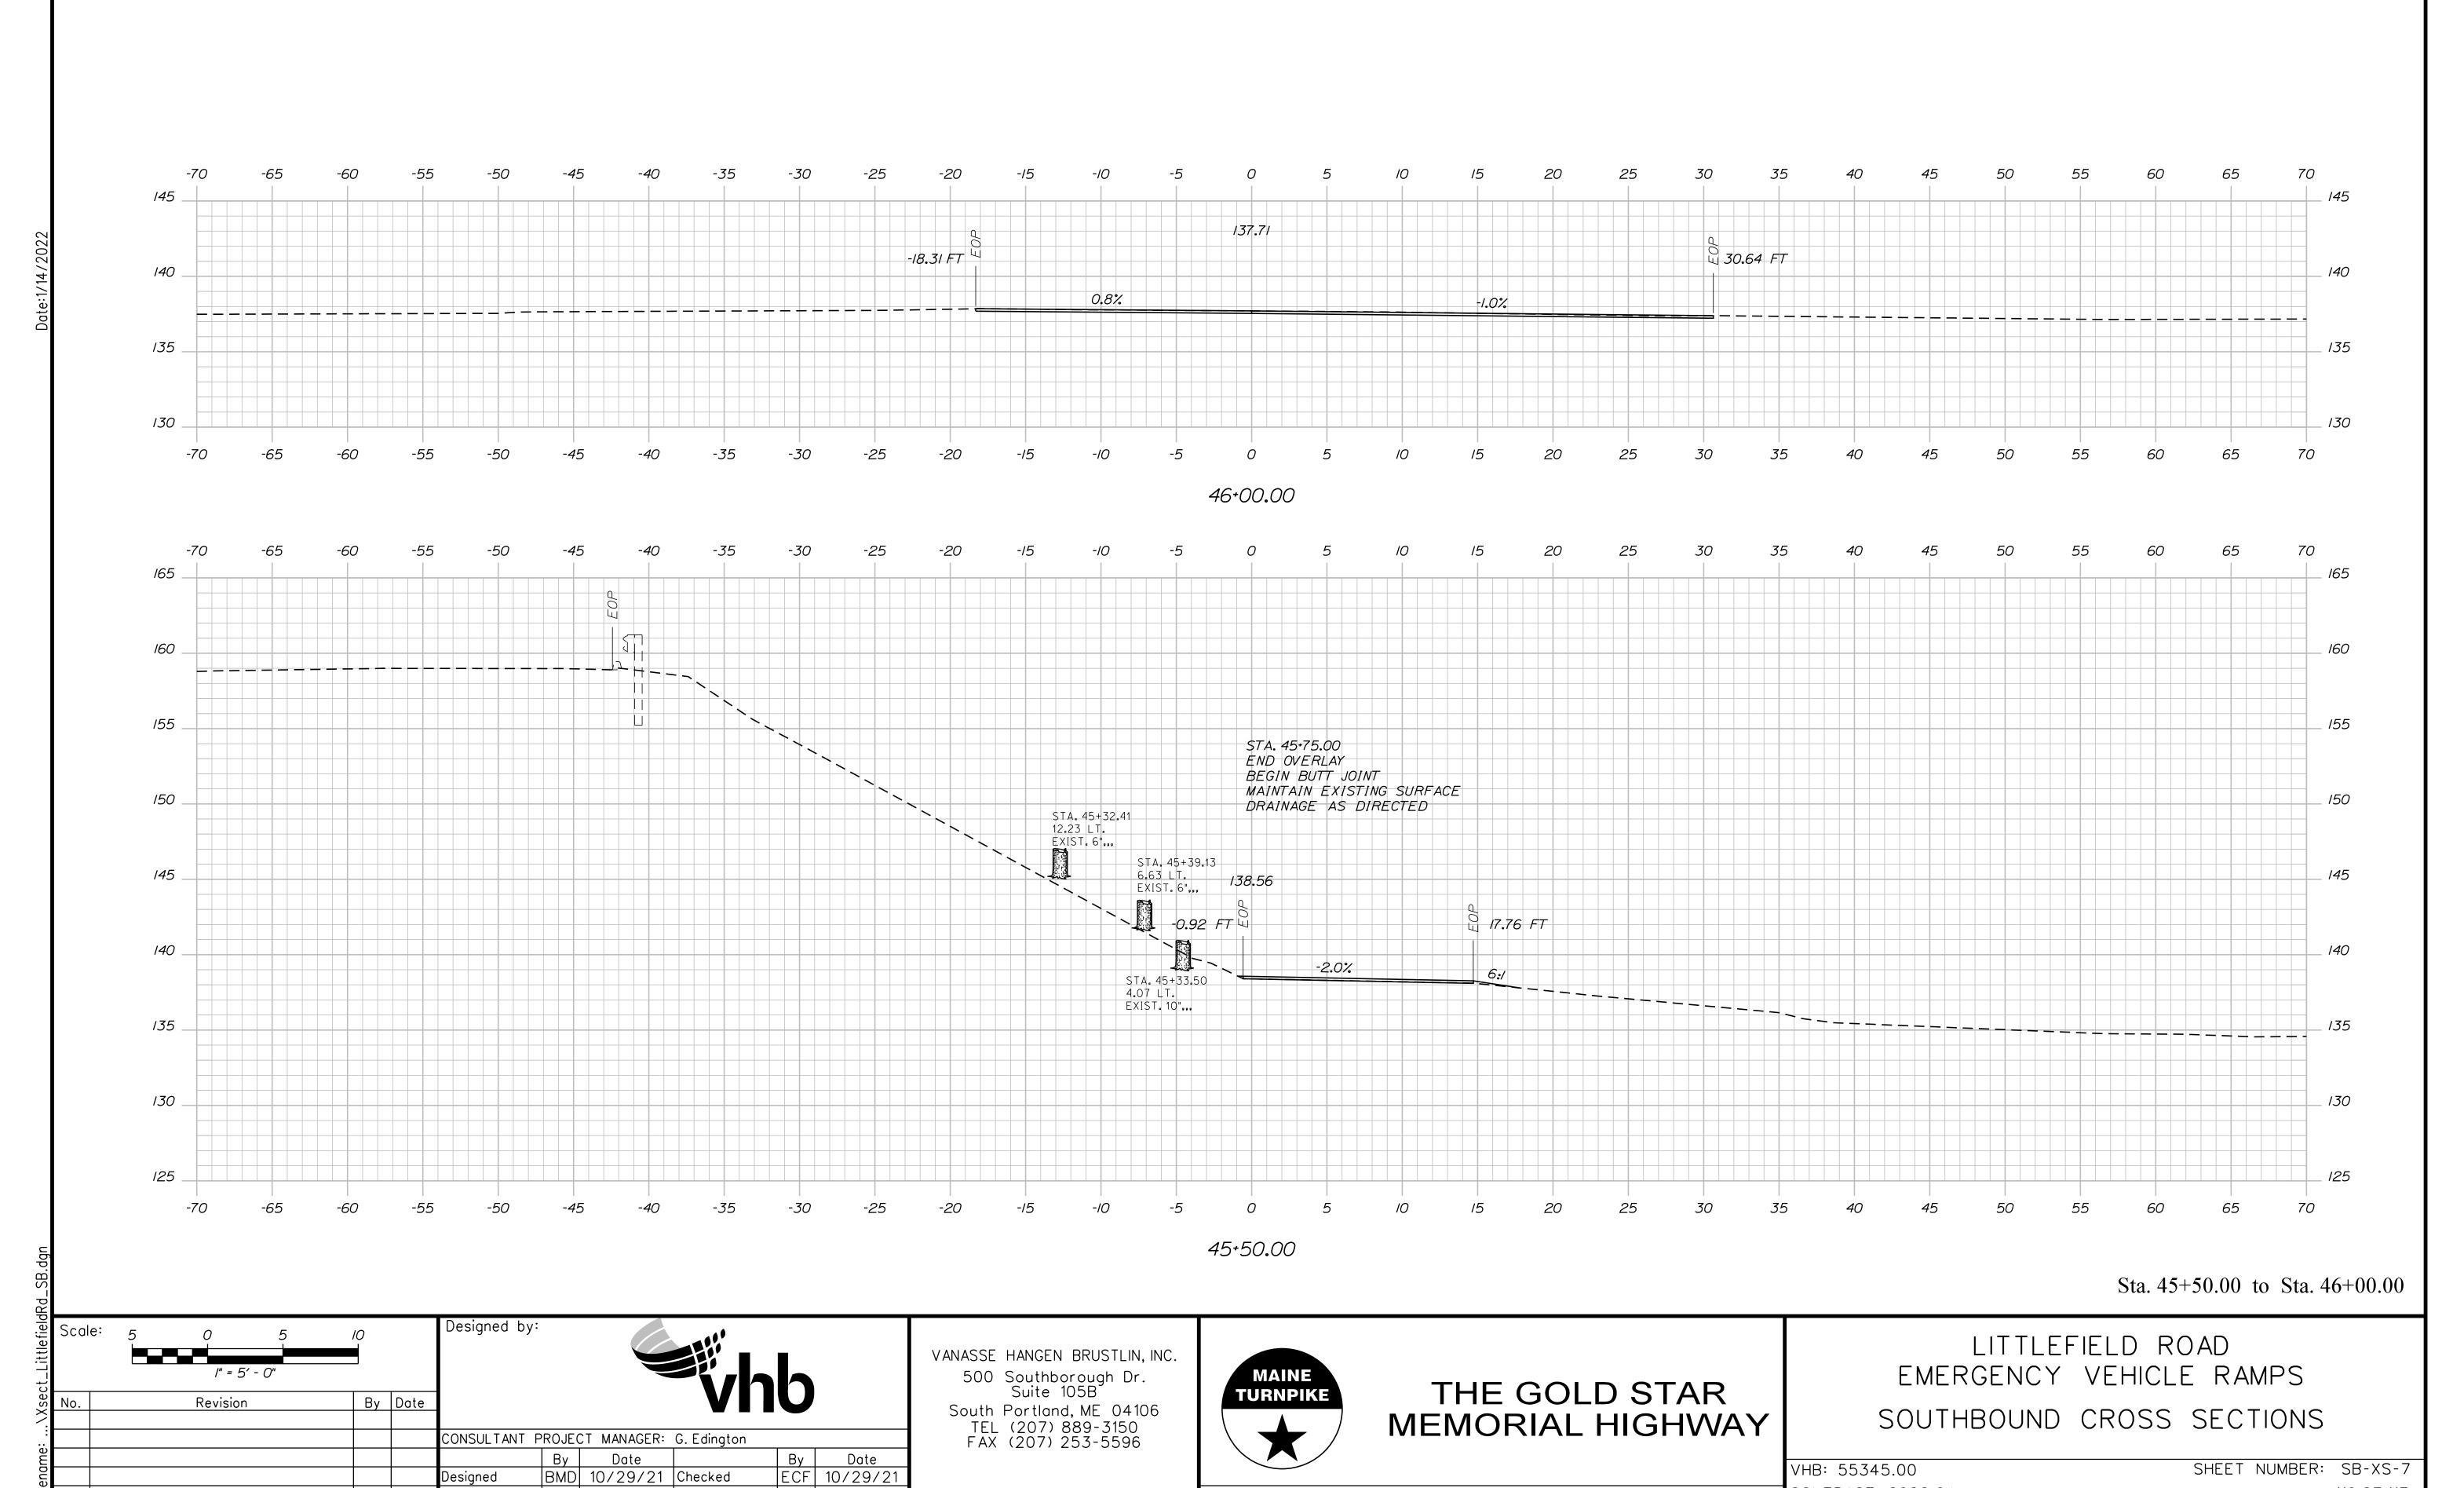

BMD 10/29/21 Checked

BMD 10/29/21 In Charge of AG 10/29/21

Designed

SHEET NUMBER: SB-XS-7

116 OF 117

VHB: 55345.00

CONTRACT: 2022.04

MATCH MAINE TURNPIKE SOUTHBOUND 140 STA. 46+14.56 135 . 135 END BUTT JOINT MATCH EXISTING PAVEMENT LIMIT OF WORK AT EDGE OF SHOULDER 130 65 70 46+14.56 Sta. 46+14.56 Designed by: LITTLEFIELD ROAD VANASSE HANGEN BRUSTLIN, INC. EMERGENCY VEHICLE RAMPS 500 Southborough Dr. Suite 105B THE GOLD STAR **TURNPIKE** By Date Revision South Portland, ME 04106

CONSULTANT PROJECT MANAGER: G. Edington By Date ECF 10/29/21 BMD 10/29/21 Checked

BMD 10/29/21 In Charge of AG 10/29/21

Designed

TEL (207) 889-3150 FAX (207) 253-5596

MEMORIAL HIGHWAY

SOUTHBOUND CROSS SECTIONS

SHEET NUMBER: SB-XS-8 VHB: 55345.00 CONTRACT: 2022.04 117 OF 117