INDEX OF SHEETS


Estimated Quantities

Concrete Repair Typical Details

Bridge Plan and Elevation

Bridge Plan and Elevation

Maintenance of Traffic Details (7 Sheets)

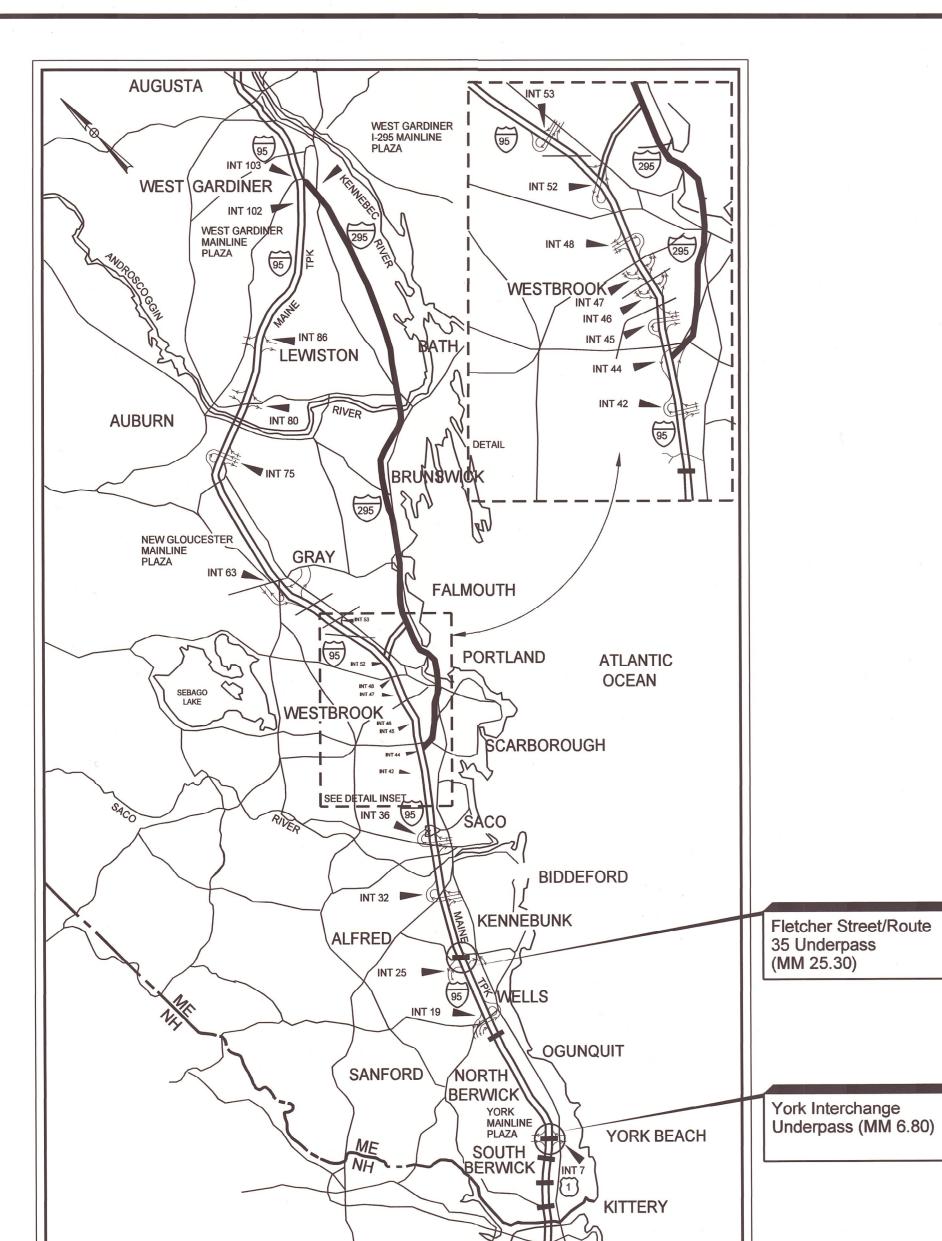

THE GOLD STAR **TURNPIKE** MEMORIAL HIGHWAY

MAINE TURNPIKE AUTHORITY

DANIEL E. WATHEN, CHAIR MICHAEL J. CIANCHETTE, VICE CHAIR ANDREW J. MCLEAN, MEMBER JANE L. LINCOLN, MEMBER THOMAS J. ZUKE, MEMBER BRUCE A. VAN NOTE, EX-OFFICIO MEMBER


BRIDGE REPAIRS

YORK INTERCHANGE UNDERPASS (MM 6.80) FLETCHER STREET/ROUTE 35 UNDERPASS (MM 25.30)

CONTRACT 2024.06

LOCATION MAP

MAINE TURNPIKE AUTHORITY

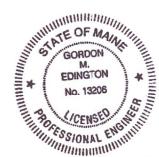





4/23/2024

DATE

	ESTIMATED QUANTITIES				
ITEM NO.	DESCRIPTION	UNIT	YORK INTERCHANGE UNDERPASS	FLETCHER STREET/ROUTE 35 UNDERPASS	QUANTITY TOTAL
202.202	Removing Pavement Surface	SY	1,850	1,550	3,400
202.2021	Removing Pavement Surface - Sidewalk	SY		22	22
403.208	Hot Mix Asphalt, 12.5 mm Nominal Maximum Size	TON	155	130	285
403.209	Hot Mix Asphalt - 9.5 mm (sidewalks, drives, & incidentals)	TON		4	4
409.15	Bituminous Tack Coat RS-I or RSIh - Applied	GAL	71	63	134
502.7011	Weep Drain Extensions	EΑ		12	12
5/5.202	Clear Protective Coating for Concrete Surfaces	SY	490	520	1,010
518.101	Abutment Repairs	CF	24	23	47
518.391	Repairing Granite Curb Joint and Bedding Mortar	LF		10	10
518.4	Epoxy Injection Crack Repair	LF	30		30
518.48	Reseal Joints	LF		43	43
5/8.864	Elastomeric Concrete Header Repair	CF	150	24	174
5/8.92	Steel Curb Plate Removal	EΑ	4		4
520.23	Asphaltic Plug Joint	LF		83	83
520.234	Expansion Device - Silicone Coated and Pre-Compressed Seal	LF	230		230
520.923	Bridge Joint Modification (York Interchange Underpass)	EΑ	4		4
609.31	Curb Type 3	LF		37	37
609.40	Reset Curb Type 5	LF	4		4
652.30	Flashing Arrow Board	EΑ	1		1
652.312	Type III Barricade	EΑ	4	3	7
652.33	Drum	EΑ	85		85
652.34	Cone	EΑ		25	25
652.35	Construction Signs	SF	148	117	265
652.361	Maintenance of Traffic Control Devices (York Interchange Underpass)	LS	1		1
<i>652.361</i>	Maintenance of Traffic Control Devices (Fletcher Street/Route 35 Underpass)	LS		/	1
652 . 381	Traffic Officers	HR		675	675
652.41	Portable - Changeable Message Sign	EΑ	2	2	4
<i>656.</i> 75	Temporary Soil Erosion and Water Pollution Control	LS		i	1
659.10	Mobilization	LS		1	1

Scale: AS NOTED			Designed b	y:			h		
No.	Revision	Ву	Date	-			VII	U	
				CONSULTANT	PROJEC	CT MANAGER:	G. Edington		
					Ву	Date		Ву	Date
				Designed	MFS	4/23/24	Checked	MEB	4/23/24
				Drawn	MJC	4/23/24	In Charge of	GME	4/23/24

VANASSE HANGEN BRUSTLIN, INC.

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MTA PROJECT MANAGER: Ryan Barnes, PE, CPESC

MTA PROJECT NO. 2024.06
BRIDGE REPAIRS
ESTIMATED QUANTITIES

 VHB: 55729.00
 SHEET NUMBER: 2

 CONTRACT: 2024.06
 2 OF 18

SPECIFICATIONS

Design: AASHTO LRFD Bridge Design Specifications, 2020.

Construction: State of Maine Department of Transportation Standard Specifications, 2014 Edition. with all revisions thereto.

> State of Maine Department of Transportation Standard Details for Highways and Bridges, 2020 Edition, with all revisions thereto.

> AASHTO LRFD Bridge Construction Specifications, Fourth Edition

NEW MATERIALS

Structural Steel:

Concrete (Unless noted otherwise)	
Structural Steel: All Material (except as noted) High Strength Bolts (except as noted)	
BASIC DESIGN STRESSES (N	<u>EW MATERIALS)</u>
Concrete	f'c = 4,500 psi

Reinforcing Steel fy = 60,000 psi

ASTM A 709/A 709M, Grade 36..... Fy = 36,000 psi ASTM A 325..... Fu = 120,000 psi

TRAFFIC AND DESIGN LOADING DATA

YORK INTERCHANGE UNDERPASS

AADT	<i>40</i>
FLETCHER STREET/ROUTE 35 UNDERPASS	
DESIGN LIVE LOAD (for existing components)	1 3, 480

Functional Class..... Major Collector

Design Live Load (for existing components) HL 93

GENERAL CONSTRUCTION NOTES

- I. All details shall be in conformance with Maine Department of Transportation (MaineDOT) 2020 Standard Details for Highways and Bridges with all updates and MaineDOT Best Management Practices for Erosion and Sediment Control, latest revision unless otherwise noted in these plans.
- 2. All work shall be completed within the Right of Way.
- 3. The Contractor shall submit proposed staging area(s) and field trailer location to the Resident for approval prior to starting work.
- 4. Any portions of the existing bridges removed by the Contractor shall become the property of the Contractor. The steel portions of the existing bridges may be coated with a lead-based paint system. The Contractor is responsible for the containment, proper management and disposal of all lead-contaminated hazardous waste generated by the work of this project.
- 5. Copies of the As-Built plans are posted on the Maine Turnpike Authority website at www.maineturnpike.com/projects/construction-contracts. The completeness and accuracy of these plans is not guaranteed.
- 6. Chamfer all exposed new concrete edges $\frac{3}{4}$ " unless otherwise noted.
- 7. For all structures clear protective coating for concrete surfaces shall be applied to the following areas:
 - All exposed median concrete.
 - All bridge curbs, parapets, sidewalks and transition barriers as shown in these plans.
- 8. The Contractor shall place approach pavement at all locations to achieve a smooth transition between existing and proposed pavement.
- 9. Prior to the removal of any pavement, the Contractor shall document the location, type and color of all pavement striping and provide that information to the Resident. The Maine Turnpike Authority will place all new striping at no cost to the Contractor.

EROSION CONTROL NOTES

I. All temporary and permanent erosion control devices shall be installed in accordance with the Maine Department of Transportation Best Management Practices.

UTILITIES NOTES

- I. Existing utilities were not located for these plans. No work shall be started until the owners of the various utilities are notified by the Contractor of the proposed construction. The Contractor is also required to call Dig Safe at I-888-344-7233 at least 72 hours prior to the start of the work.
- 2. The Contractor shall contact all non-members through www.OKtoDIG.com or as otherwise required by the Maine Public Utilities Commission. All proposed excavation locations shall be marked at the time of notification. No excavation shall be permitted until the authority has located and marked it's underground utilities. The Resident Engineer shall be provided a digital copy of all Dig Safe tickets within 24 hours of their release for project notifications and 3rd party utility locater coordination.
- 3. The Contractor shall notify the Resident IO calendar days prior to submitting a utility locate request through Dig Safe so that the Resident can arrange for Maine Turnpike underground utility location. All proposed sign locations and excavation locations shall be marked at the notification time.
- 4. Contractor shall protect all existing utilities from damage during the construction as approved by the utility owners.

CONTRACT: 2024.06

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No.	Revision	Ву	Date				VII	U	
				CONSULTANT	PROJEC	CT MANAGER:	G. Edington		
					Ву	Date		Ву	Date
				Designed	MFS	4/23/24	Checked	MEB	4/23/24
				Drawn	MJC	4/23/24	In Charge of	GME	4/23/24

VANASSE HANGEN BRUSTLIN, INC. 500 Southborough Dr. Suite 105B South Portland, ME 04106

TURNPIKE TEL (207) 889-3150 FAX (207) 253-5596




MTA PROJECT NO. 2024.06 BRIDGE REPAIRS GENERAL NOTES


SHEET NUMBER: VHB: 55729.00

MTA PROJECT MANAGER: Ryan Barnes, PE, CPESC


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TYPICAL HORIZONTAL SURFACE CONCRETE REPAIR DETAILS

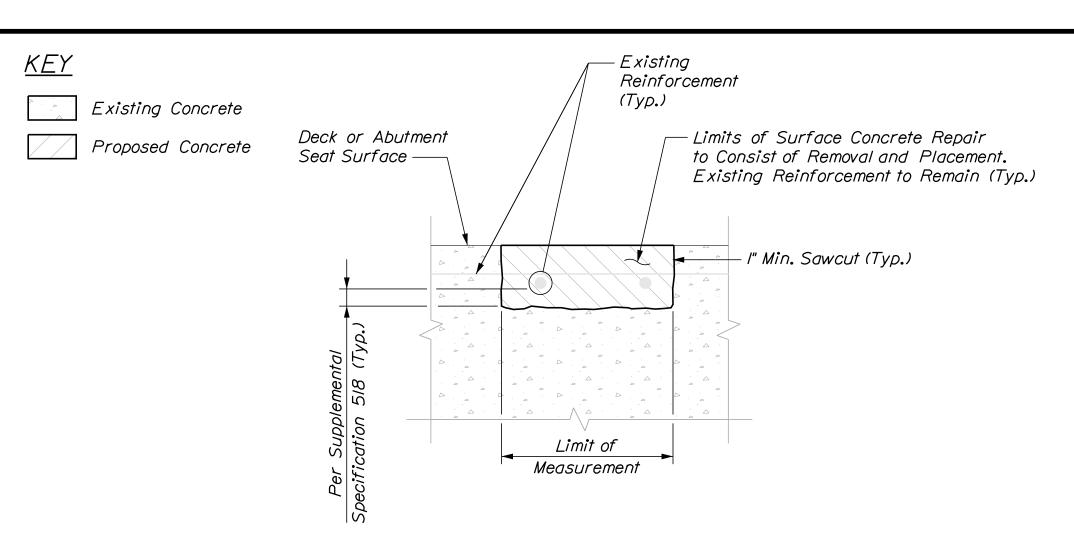

TYPICAL VERTICAL SURFACE CONCRETE REPAIR DETAILS

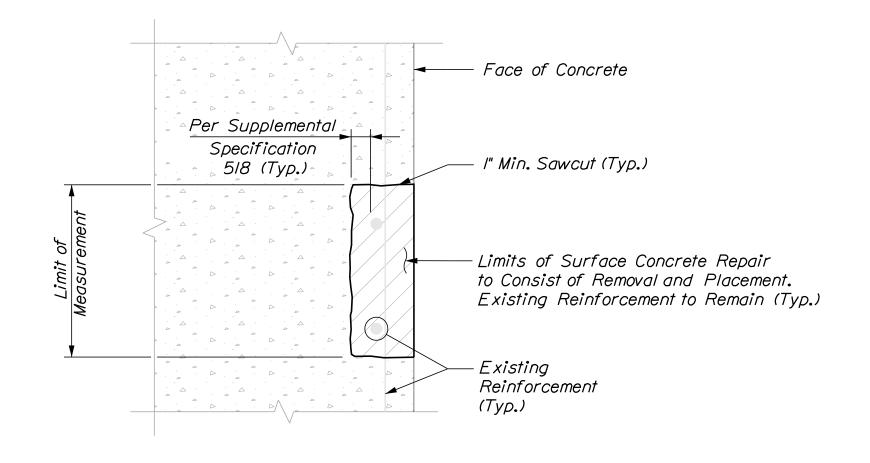


WEEP DRAIN EXTENSION

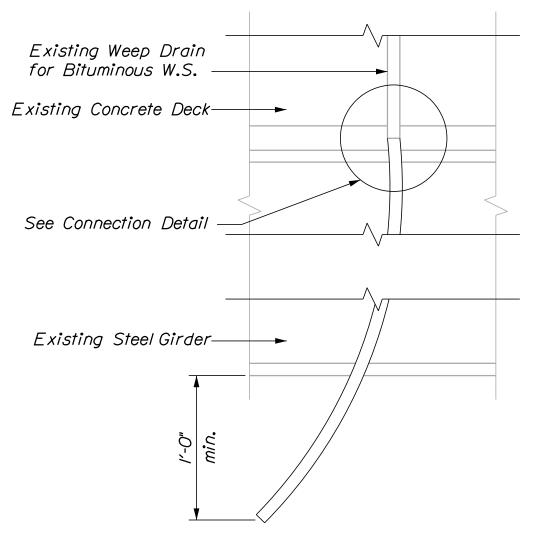
Not to Scale

Limit of Measurement I' Min. Sawcut (Typ.) Existing Reinforcement (Typ.) Face of Concrete

TYPICAL FULL DEPTH CONCRETE REPAIR DETAILS

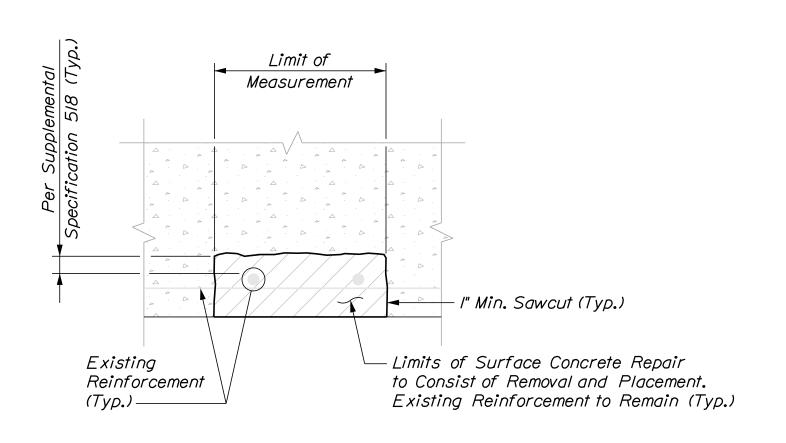

TYPICAL OVERHEAD SURFACE CONCRETE REPAIR DETAILS

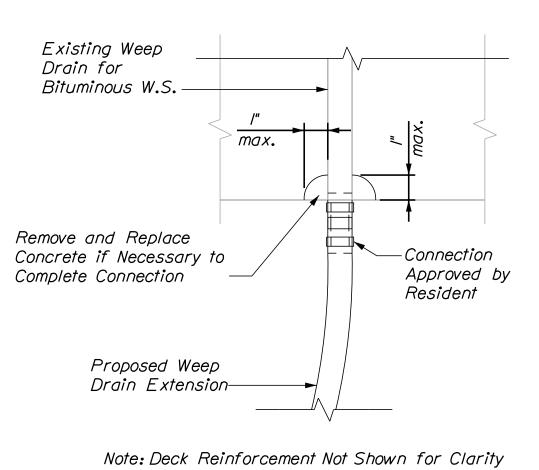

WEEP DRAIN CONNECTION DETAIL

Not to Scale

CONCRETE REPAIR NOTES

- I. Repair work shall include: surface concrete repairs, epoxy injection crack repair and providing access for inspection.
- 2. Where surface concrete repairs are specified the work shall include removal of unsound concrete and placement and curing of repair materials. Repairs shall be measured for payment under Item 518.89, Concrete Median Repair.
- 3. Prior to the start of any concrete repairs the Resident and the Contractor shall sound all concrete surfaces and agree on the repair limits. Estimated repair quantities may increase or decrease at the Resident's discretion.
- 4. The estimated repair quantities are based on inspections completed in September 2023 October 2023.

CONCRETE REPAIR PROCEDURE

- I. Perform I" deep saw cuts along limits of removal.
- 2. Chip concrete to the depth specified in Supplemental Specification 518. If the removal limits change during the demolition process the Contractor shall notify the Resident. The Resident and Contractor shall agree on the revised pay limits prior to the Contractor continuing the removal.
- 3. Prepare and patch repair areas with Class AAA modified concrete or other materials selected from the applicable non-emergency list of materials in Supplemental Specification 518.
- 4. Perform general finishing.

EPOXY INJECTION CRACK REPAIR NOTES

- I. All crack repairs shall be completed by an individual qualified and experienced in the type of repairs proposed.
- 2. All crack repairs shall be completed in accordance with Supplemental Specification 518.
- 3. Where epoxy injection crack repair is specified the work shall include pressure injection of cracks I/I6" or more in width. Work shall be paid under Item 518.4 Epoxy Injection Crack Repair.

WEEP DRAIN EXTENSION NOTES:

I. All PVC deck weeps which drain onto piers, abutments or structural steel shall be extended and diverted away from bridge components below deck, and shall extend I ft below bottom flange, as directed by the Resident. Payment shall be made under pay Item 502.70II, Weep Drain Extensions.

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MTA PROJECT NO. 2024.06

BRIDGE REPAIRS

CONCRETE REPAIR TYPICAL DETAILS

VHB: 55729.00 SHEET NUMBER:

CONTRACT: 2024.06

MTA PROJECT MANAGER: Ryan Barnes, PE, CPESC

4 OF 18

MAINTENANCE OF TRAFFIC GENERAL NOTES

- I. All traffic control equipment and devices shall conform to the 2014 edition of the Maine Department of Transportation (MaineDOT) Standard Specifications, Maine Turnpike Authority (MTA) Supplemental Specifications, contract specifications and applicable traffic control standards and practices.
- 2. Any signs, equipment, or devices found to be damaged or unserviceable shall be replaced at the Contractor's expense.
- 3. Temporary lane closures will be required, with advanced approval, whenever work will occur within four feet of the traveled way. Temporary lane closures shall be removed if no work is occurring. See Special Provisions for more information including available lane closure times.
- 4. Lane closure requests shall be submitted by the Resident by Noon on the Thursday prior to the week of the proposed lane closures. The Contractor shall plan all lane closure requests accordingly.
- 5. Approach ends of temporary concrete barrier shall be placed outside of the highway clear zone (minimum 34 feet from the traveled way) or protected by temporary impact attenuators or with guardrail overlaps as approved by the Resident.
- 6. Maximum spacing for channelizing devices (drums) shall be: 80' on center along tangents 40' on center along tapers
- 7. Work zone speed limits shall only be permitted when temporary mainline lane closures are in place.
- 8. Work shall only occur on one bridge at a time.

YORK INTERCHANGE UNDERPASS NOTES

I. York Interchange Underpass will be completed under left lane and right lane closures. See Lane closure plans.

FLETCHER STREET / ROUTE 35 UNDERPASS NOTES

- I. Fletcher Street work will be completed under flagging operations. See Flagging Plan.
- 2. The Flagging operation shall require Traffic Officers to control the existing signalized intersections on each end of the work zone. When Traffic Officers are controlling the intersections, the existing traffic signals shall be turned Off. The traffic signals shall be turned on when the Traffic Officers are not present.

FLETCHER STREET/ ROUTE 35 UNDERPASS SINGLE LANE CLOSURE / SHOULDER CLOSURE

	CONSTRUCTION SIGN SUMMARY									
			nensions hes)	C :						
	Sign	Letter Vertical Height Spacing		Size	Quantity and Color					
G20-2	END ROAD WORK			36"x18"	3 - Black on Orange					
W20-I	ROAD WORK AHEAD	Signs"	- 2012	36"x36"	5 - Black on Orange					
W20-4	ONE LANE ROAD AHEAD			36"x36"	2 - Black on Orange					
W20-7				36" x 36"	3 - Black on Orange					
R9-9	SIDEWALK			24"xI2"	2 - Black on Orange					

Designed by: By Date Revision CONSULTANT PROJECT MANAGER: G. Edington By Date MDS 4/23/24 MLG 4/23/24 | Checked Designed JAR 4/23/24 In Charge of GME 4/23/24

VANASSE HANGEN BRUSTLIN, INC. 500 Southborough Dr. Suite 105B South Portland, ME 04106 TEL (207) 889-3150 FAX (207) 253-5596





YORK INTERCHANGE UNDERPASS TEMPORARY SINGLE LANE CLOSURES


Text Dimensions Size	CON	STRUCT	ION SIC	GN SUMN	IARY
Shall Conform to 'Standard' Highway Signs' - 2012 36'x36' 1 - Black on Orange 1 - Black on White 1 - Black on White 1 - Black on White 1 - Black on Orange 1 - B	Sign	(Inc	hes) Vertical	Size	Quantity and Color
W4-2L		Shall C to "Sta	`onform andard	36"x18"	3 - Black on Orange
W9-3L	W4-2L	Signs"	- 2012 	36"x36"	I - Black on Orange
W9-3R Right College	W4-2R			36"×36"	I - Black on Orange
W20-1 W2	W9-3L LEFT LANE CLOSED AHEAD			36"x36"	I - Black on Orange
W20-1 RIGHT LANE MUST TURN RIGHT RII-2 ROAD CLOSED A8"x30" I - Black on White A8"x30" I - Black on White A8"x30" I - Black on White A8"x30" I - Black on Orange A8"x36" I - Black on Orange	W9-3R RIGHT LANE CLOSED AHEAD			36"x36"	I - Black on Orange
R3-7R RIGHT LANE MUST TURN RIGHT RII-2 ROAD CLOSED 48"x30" I - Black on White 48"x36" I - Black on Orange M4-9L DETOUR 30"x24" I - Black on Orange	W20-1 ROAD WORK AHEAD			48" x 48"	2 - Black on Orange
R3-7R MUST TURN RIGHT RII-2 ROAD CLOSED A8"x30"	W20-1 ROAD WORK AHEAD			36"x36"	3 - Black on Orange
M4-9L DETOUR 48 x 30 I - Black on While 1 - Black on Orange 30"x24" I - Black on Orange	R3-7R MUST			30" x 30"	I - Black on White
M4-9L DETOUR 30"x24" 1 - Black on Orange				48" x 30"	I - Black on White
M4-9L 30"x24" I - Black on Orange	M4-9L DETOUR ←			48"x36"	I - Black on Orange
M4-IOR DETOUR 48"xI8" I - Black on Orange	M4-9L DETOUR ←			30"x24"	I - Black on Orange
	M4-IOR DETOUR			48"x/8"	I - Black on Orange
		,			


MTA PROJECT NO. 2024.06 BRIDGE REPAIRS MAINTENANCE OF TRAFFIC DETAILS (01 OF 02)


SHEET NUMBER: VHB: 55729.00 CONTRACT: 2024.06

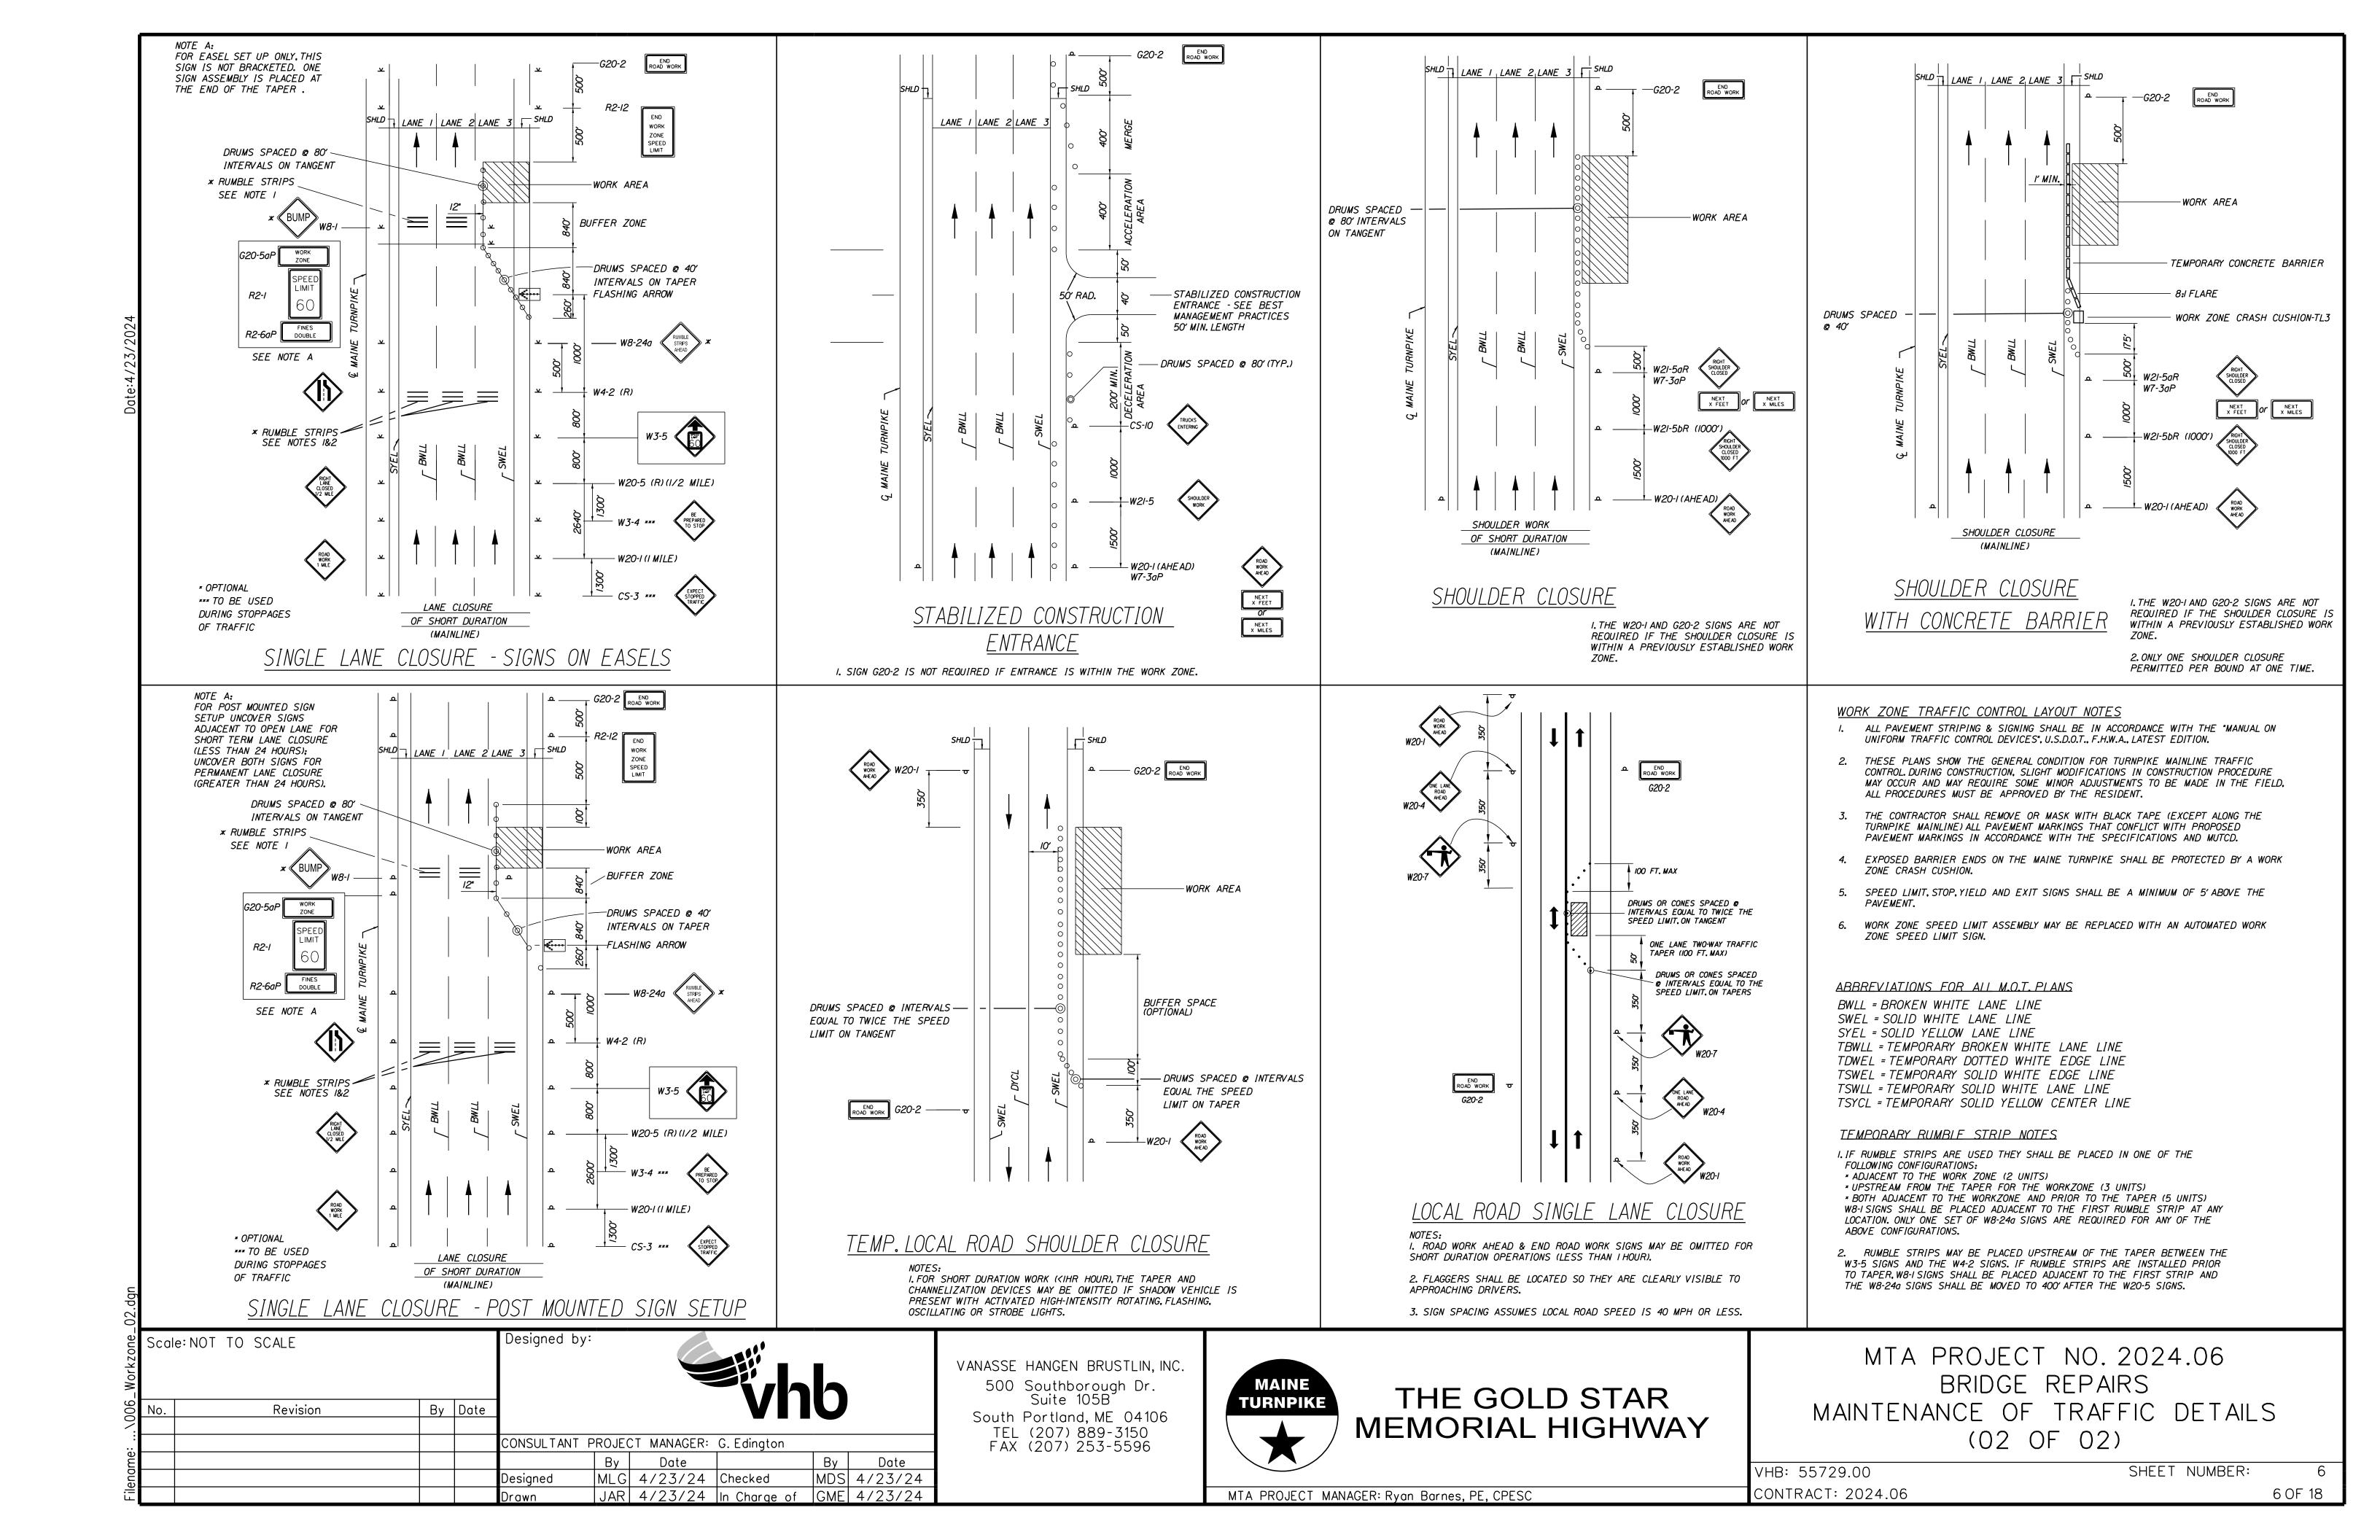


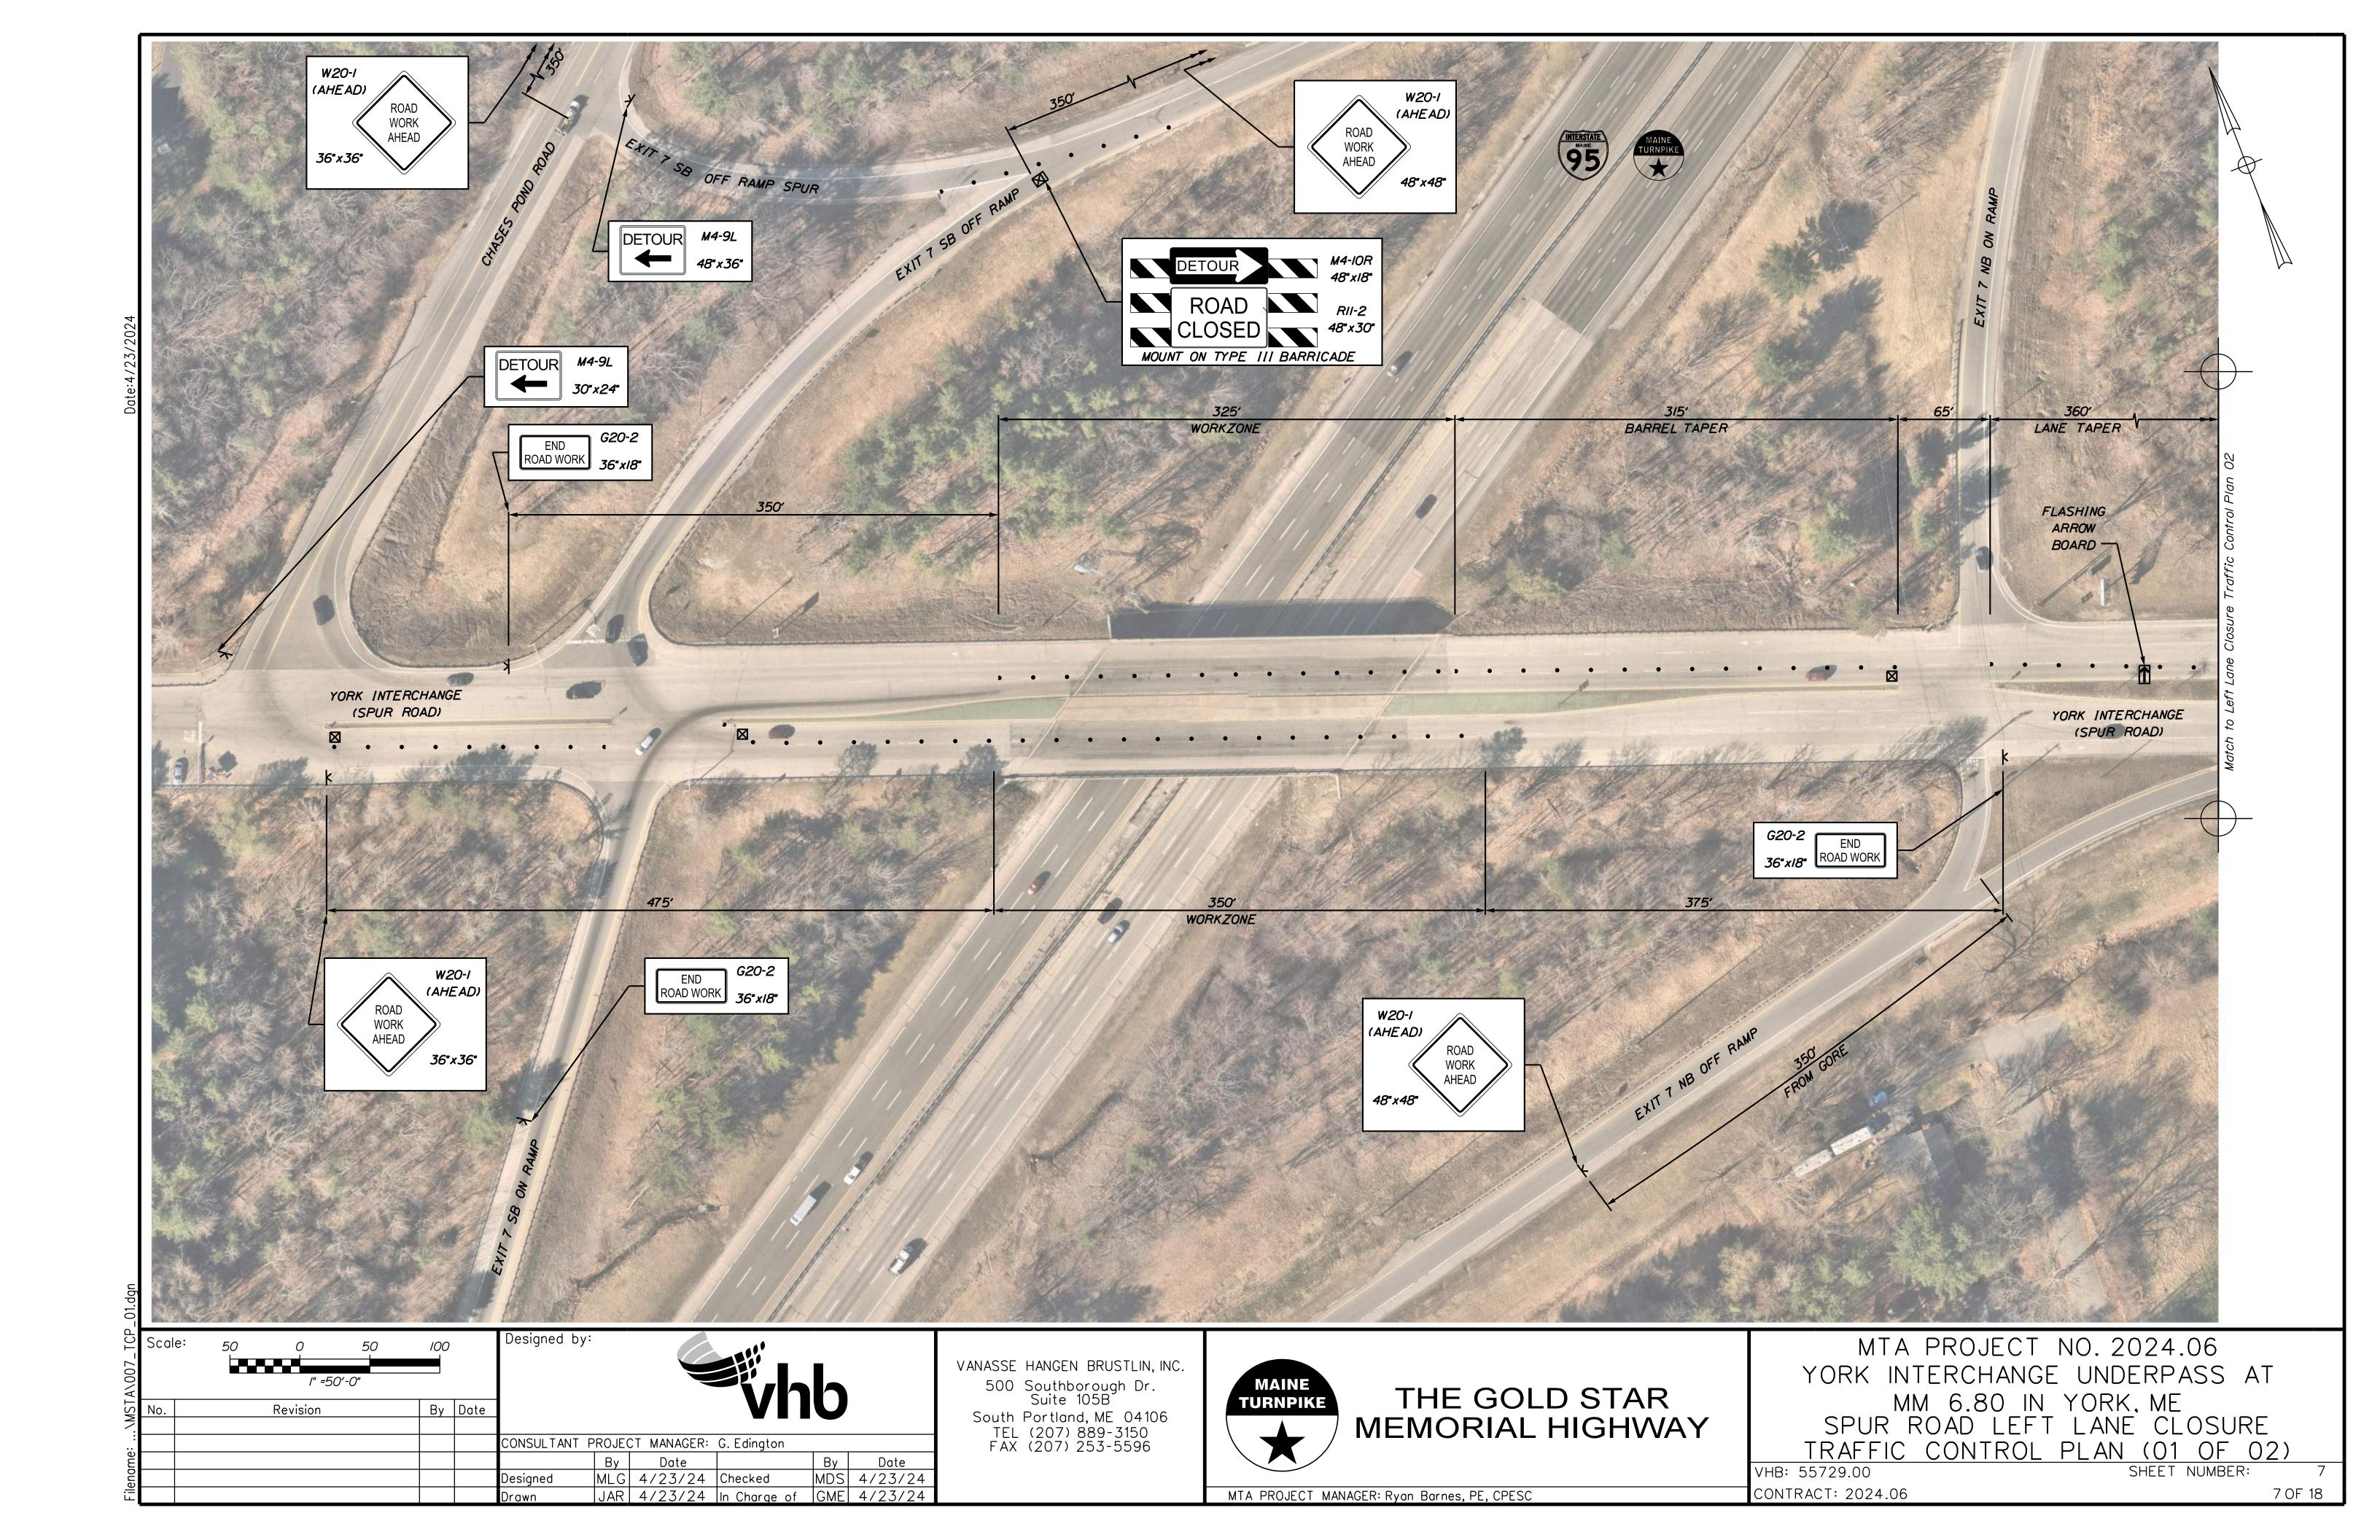


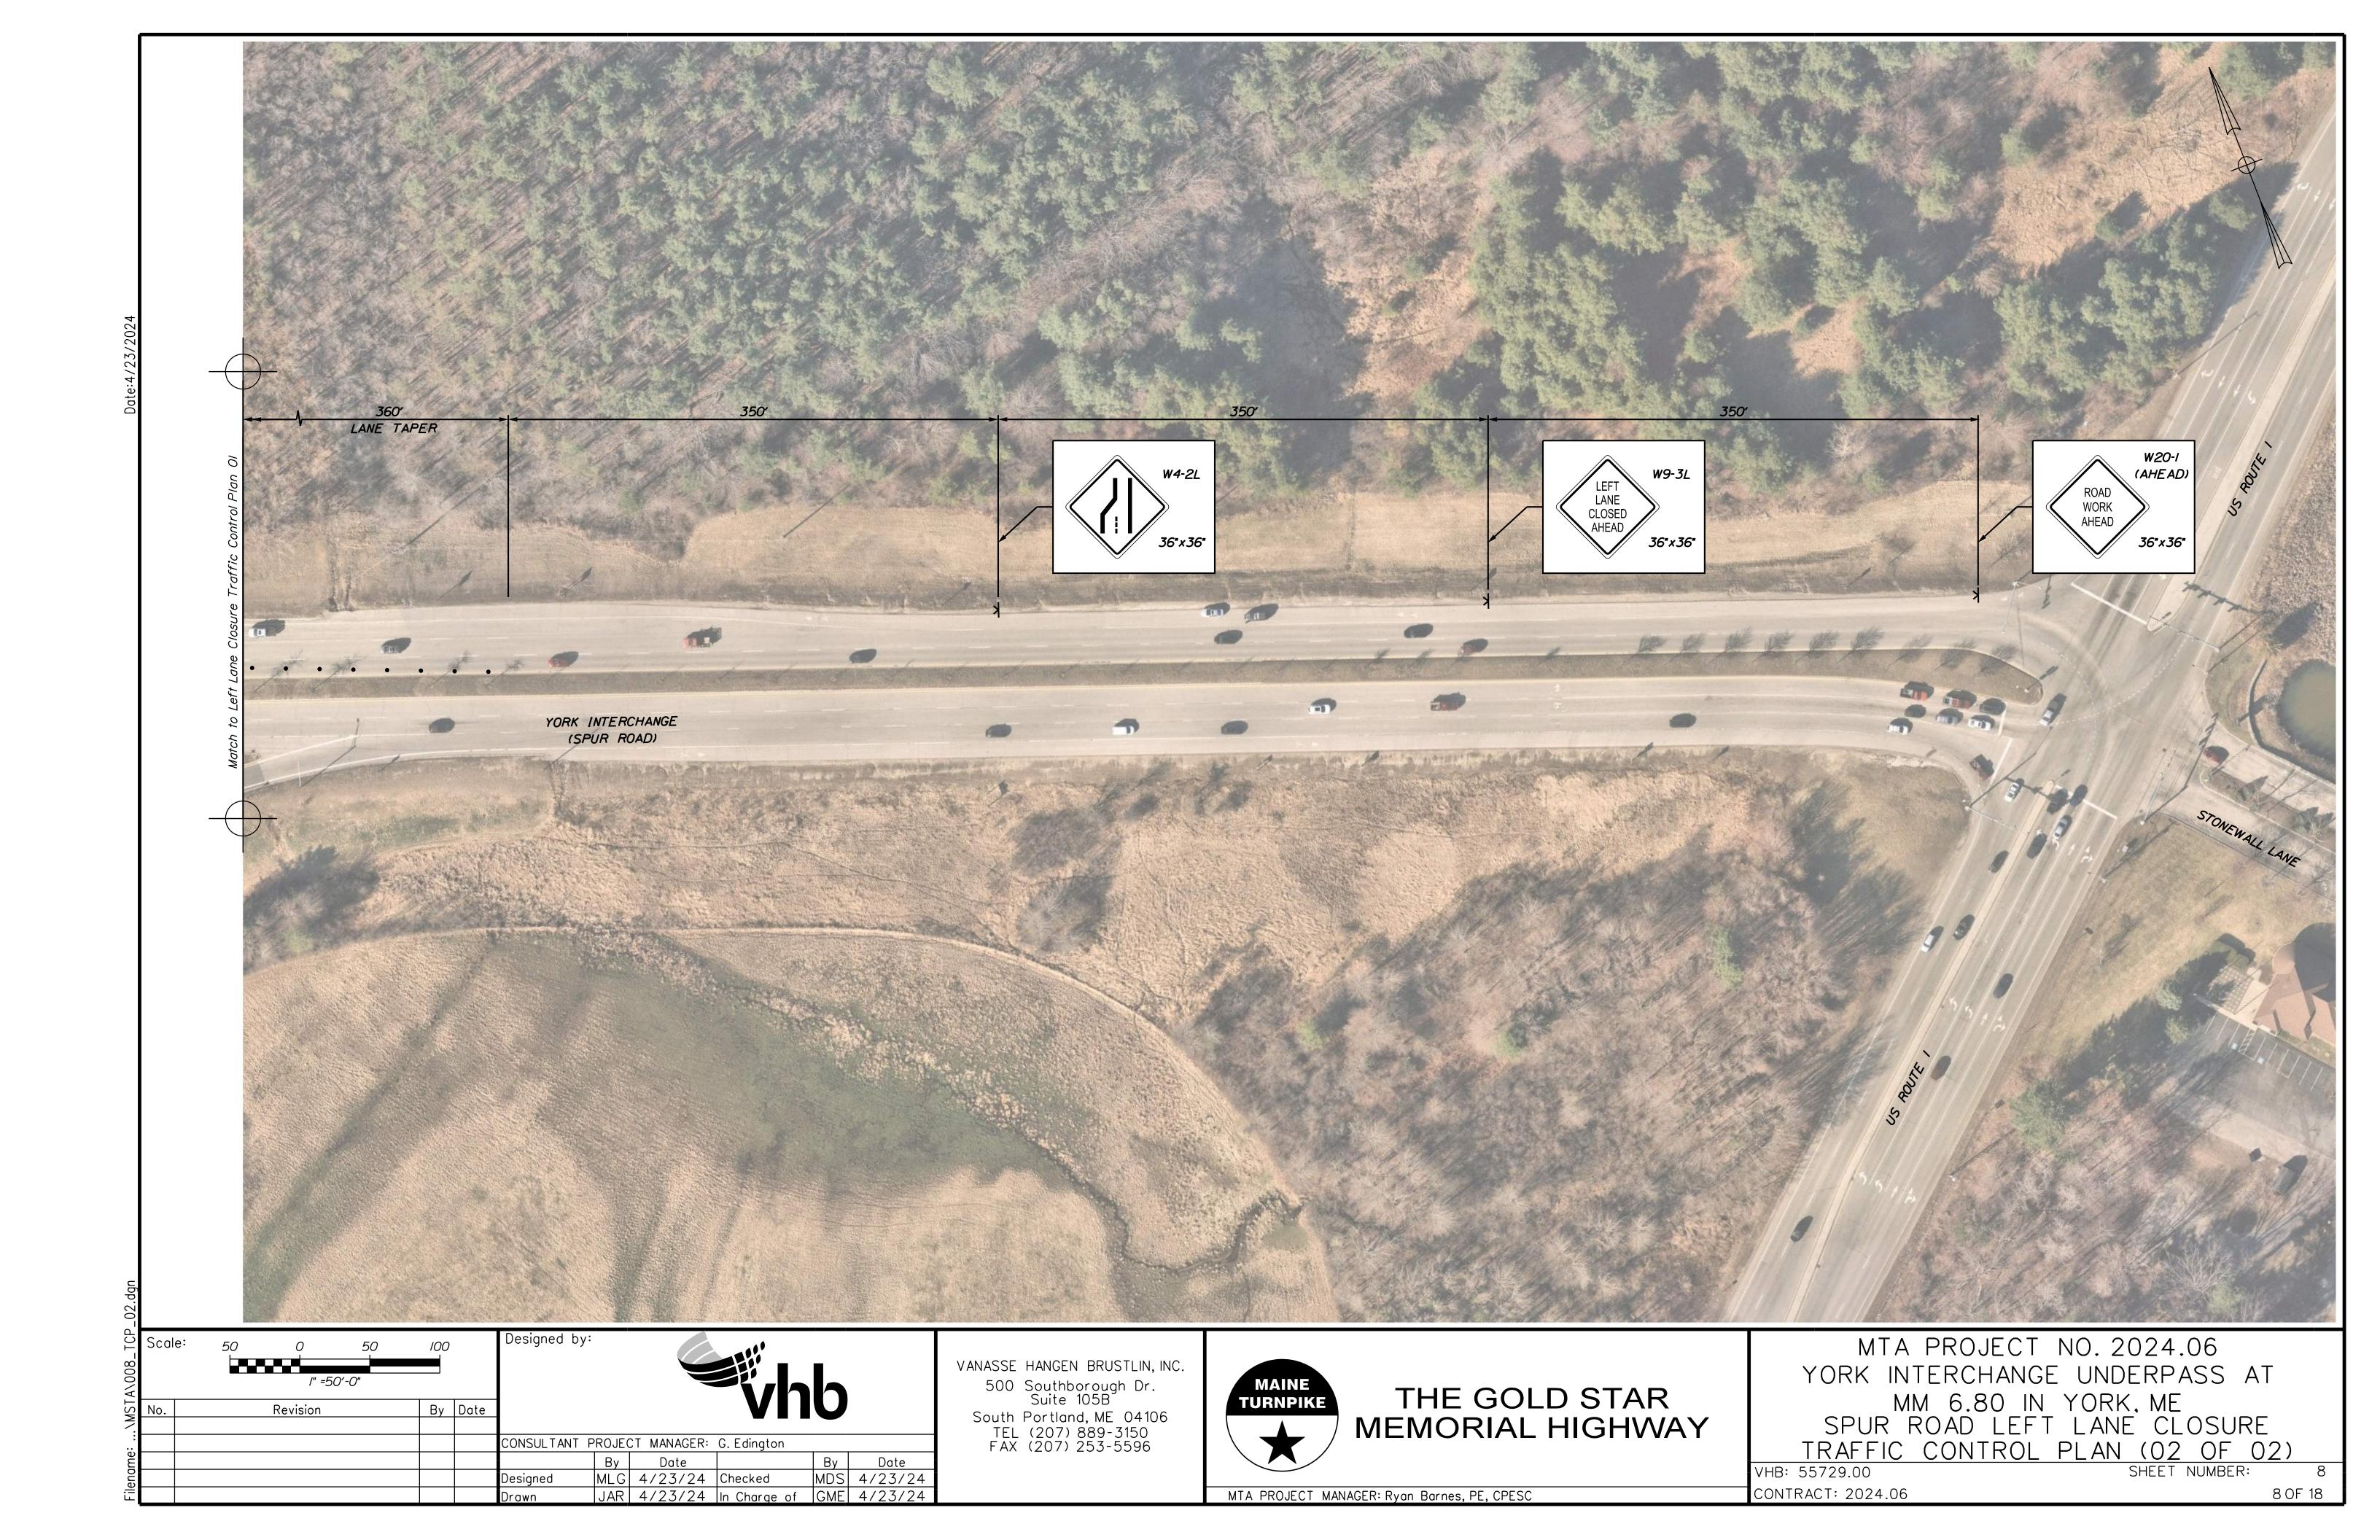


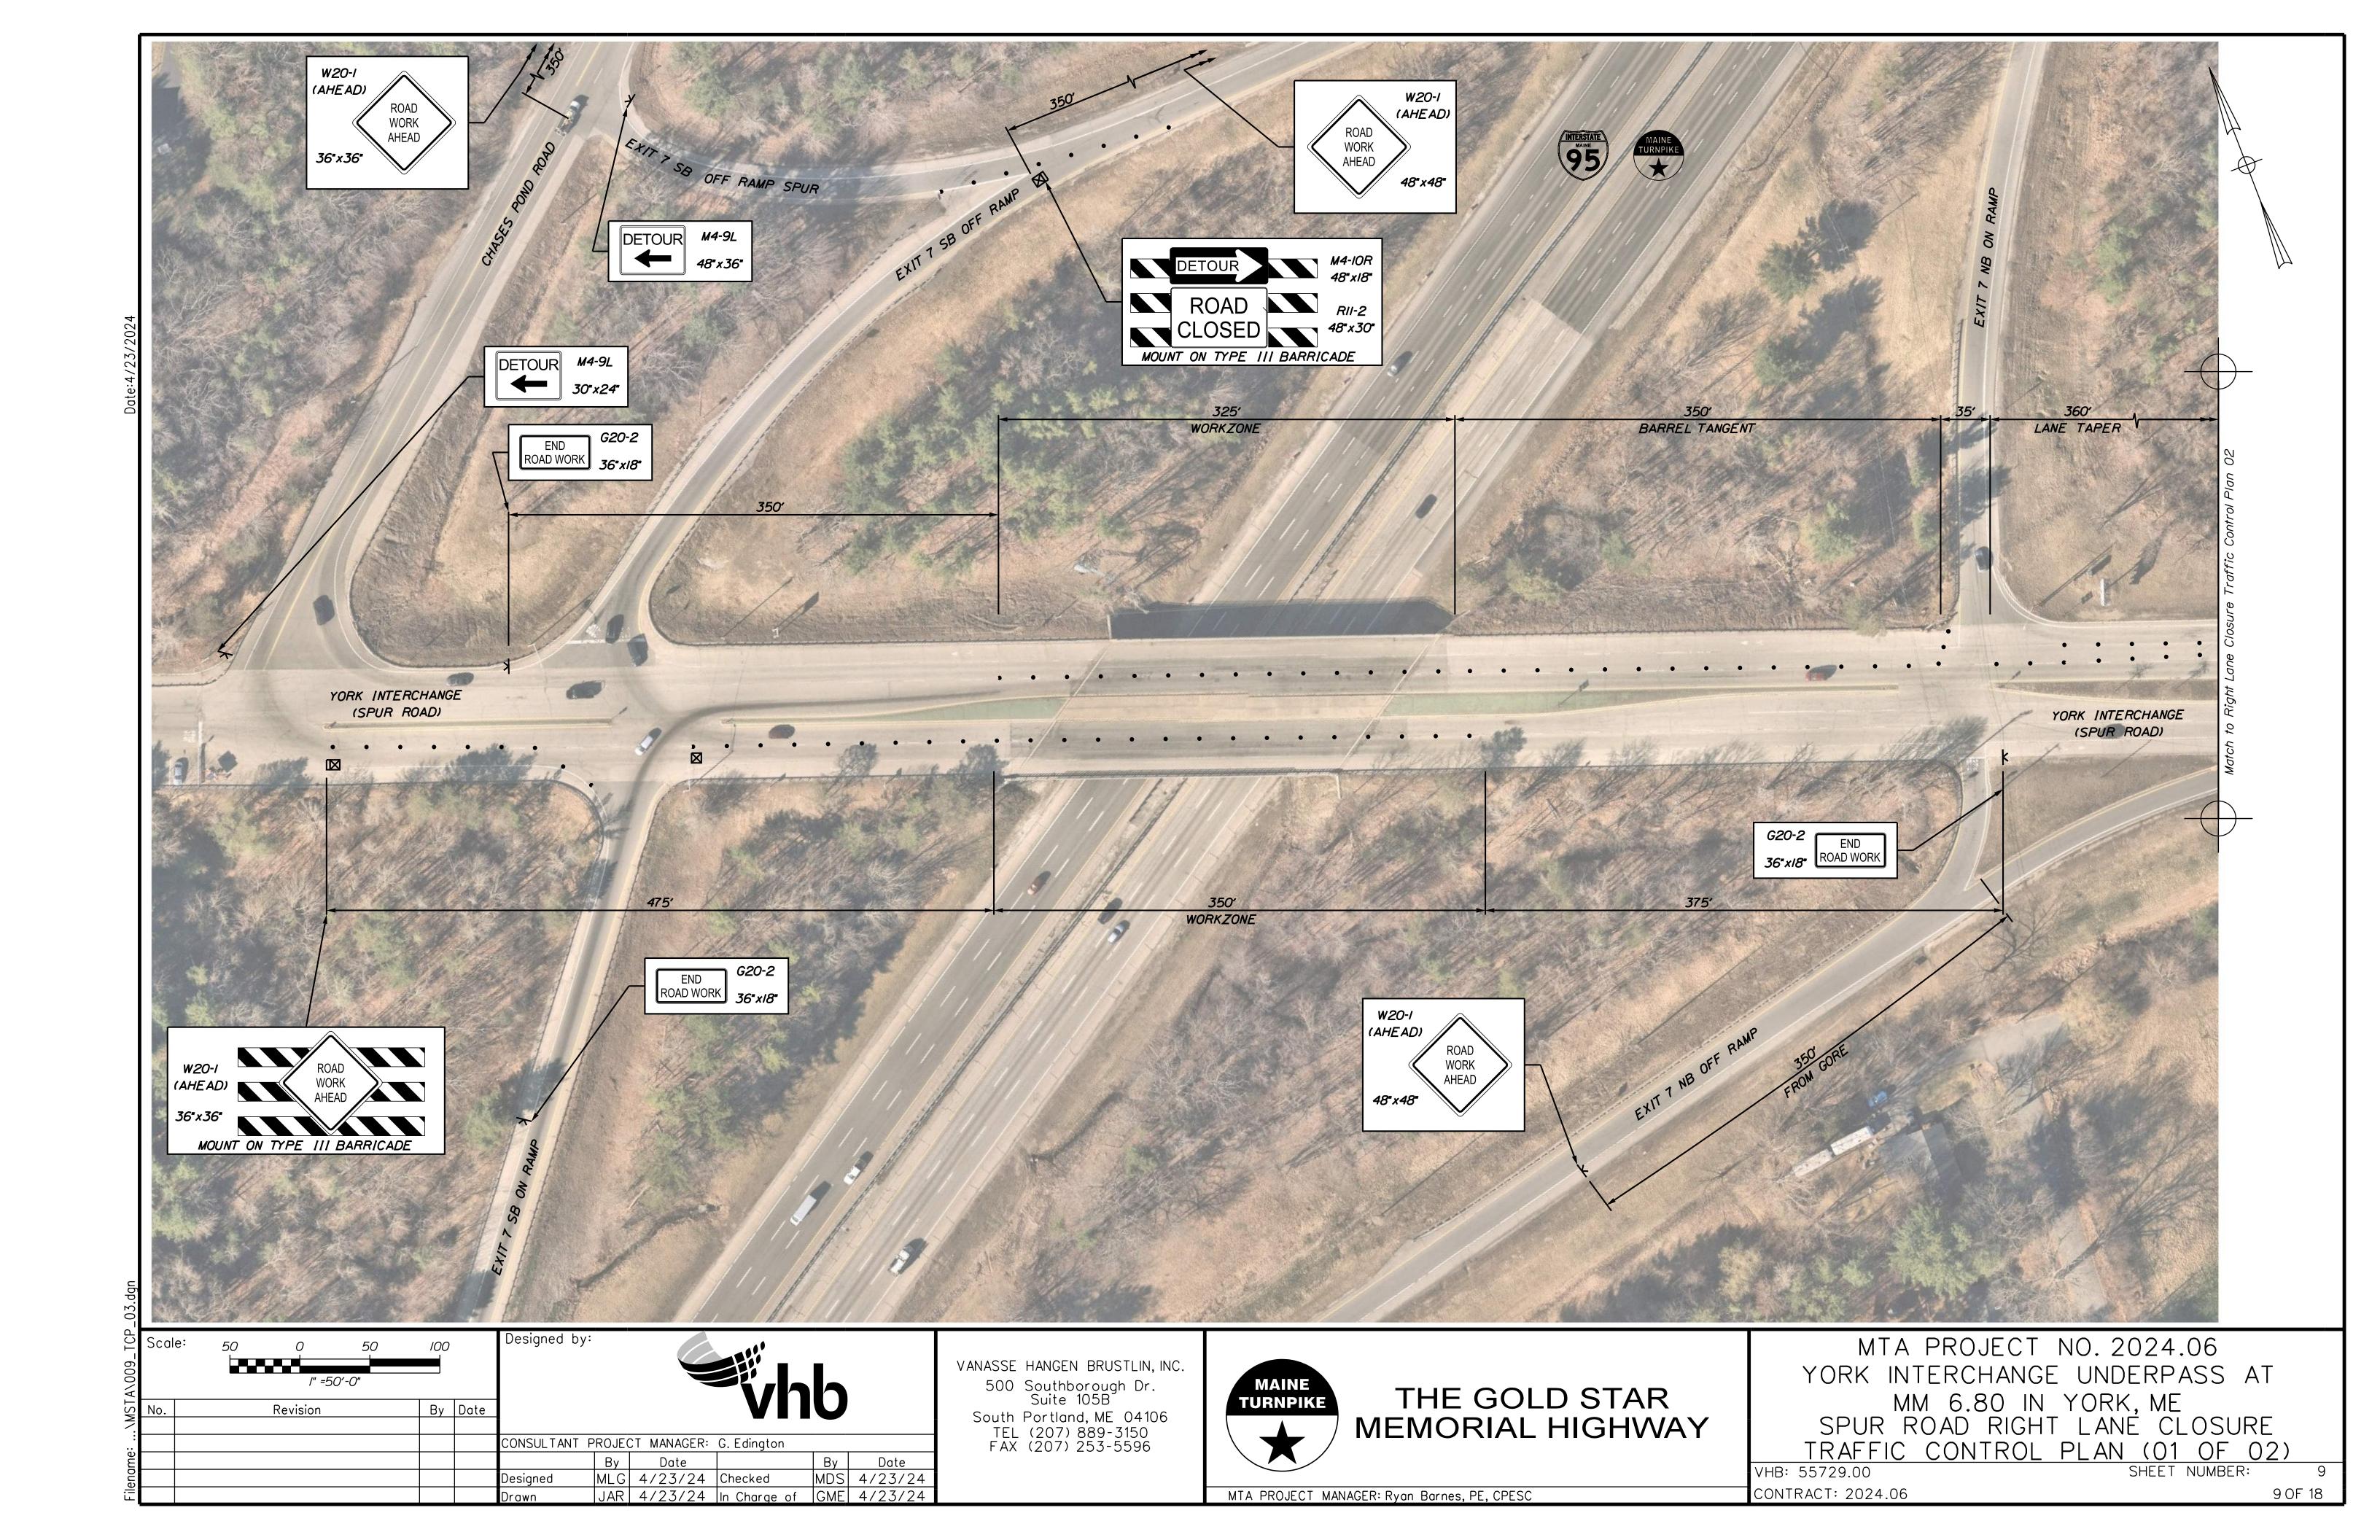


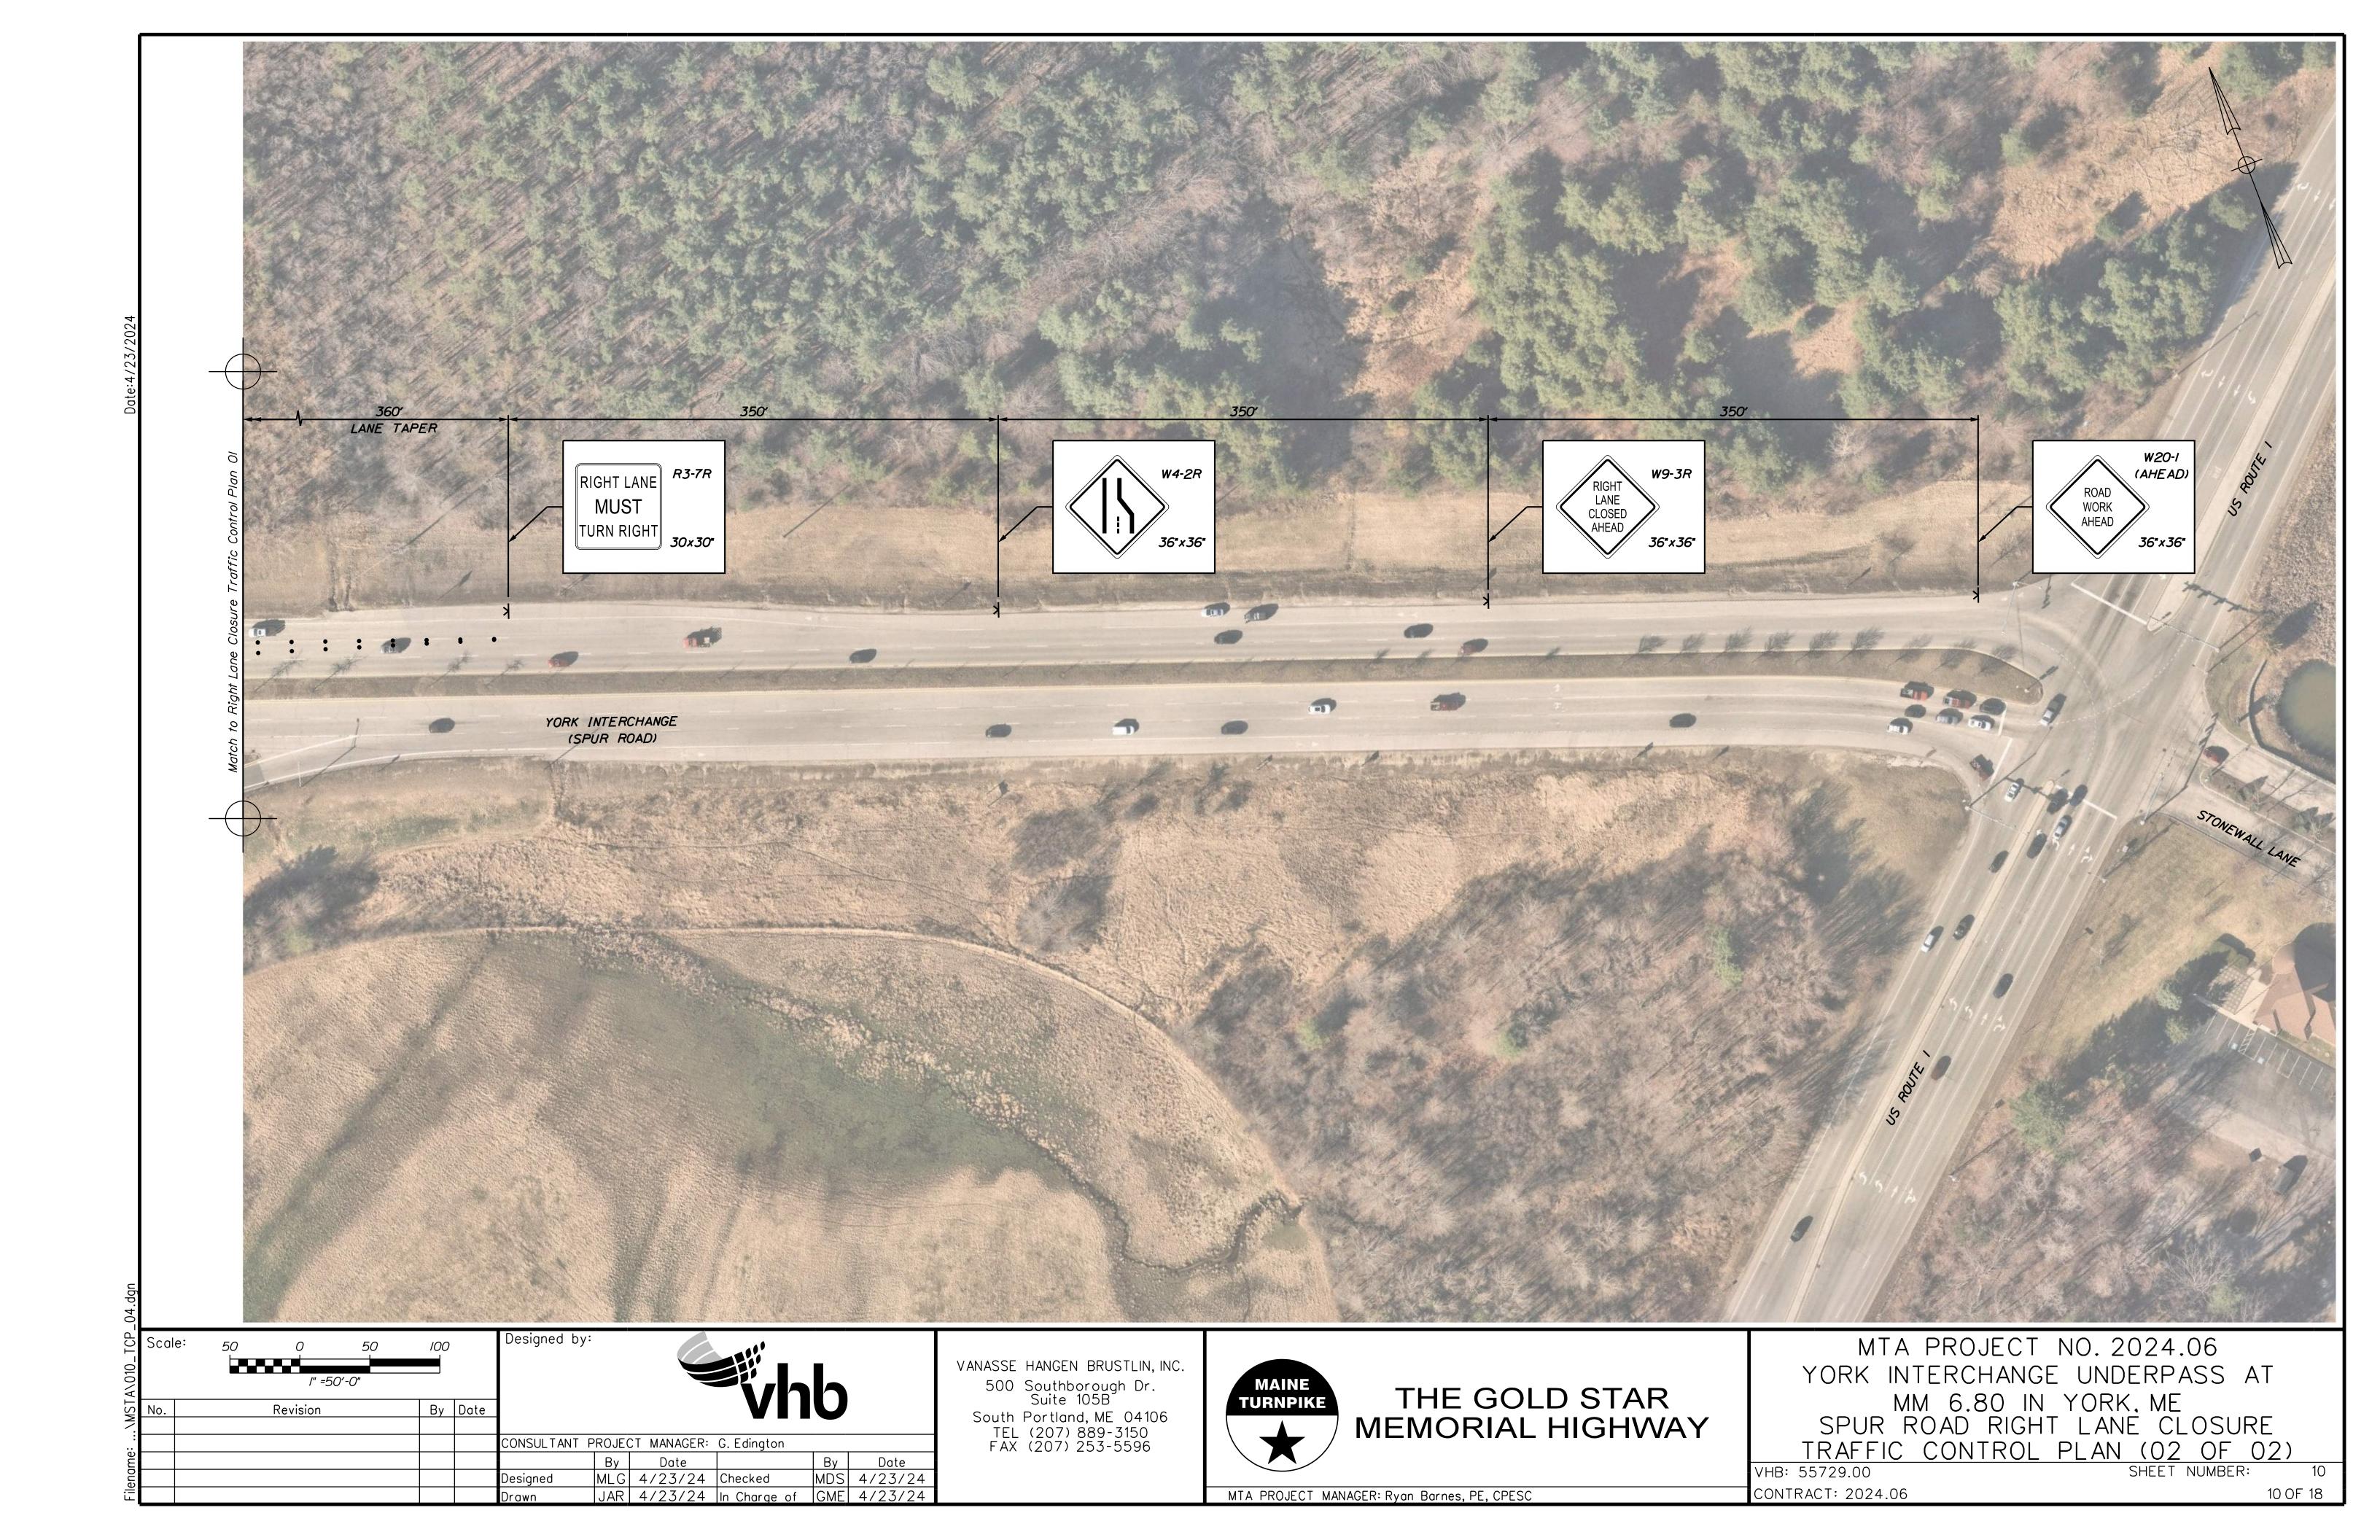

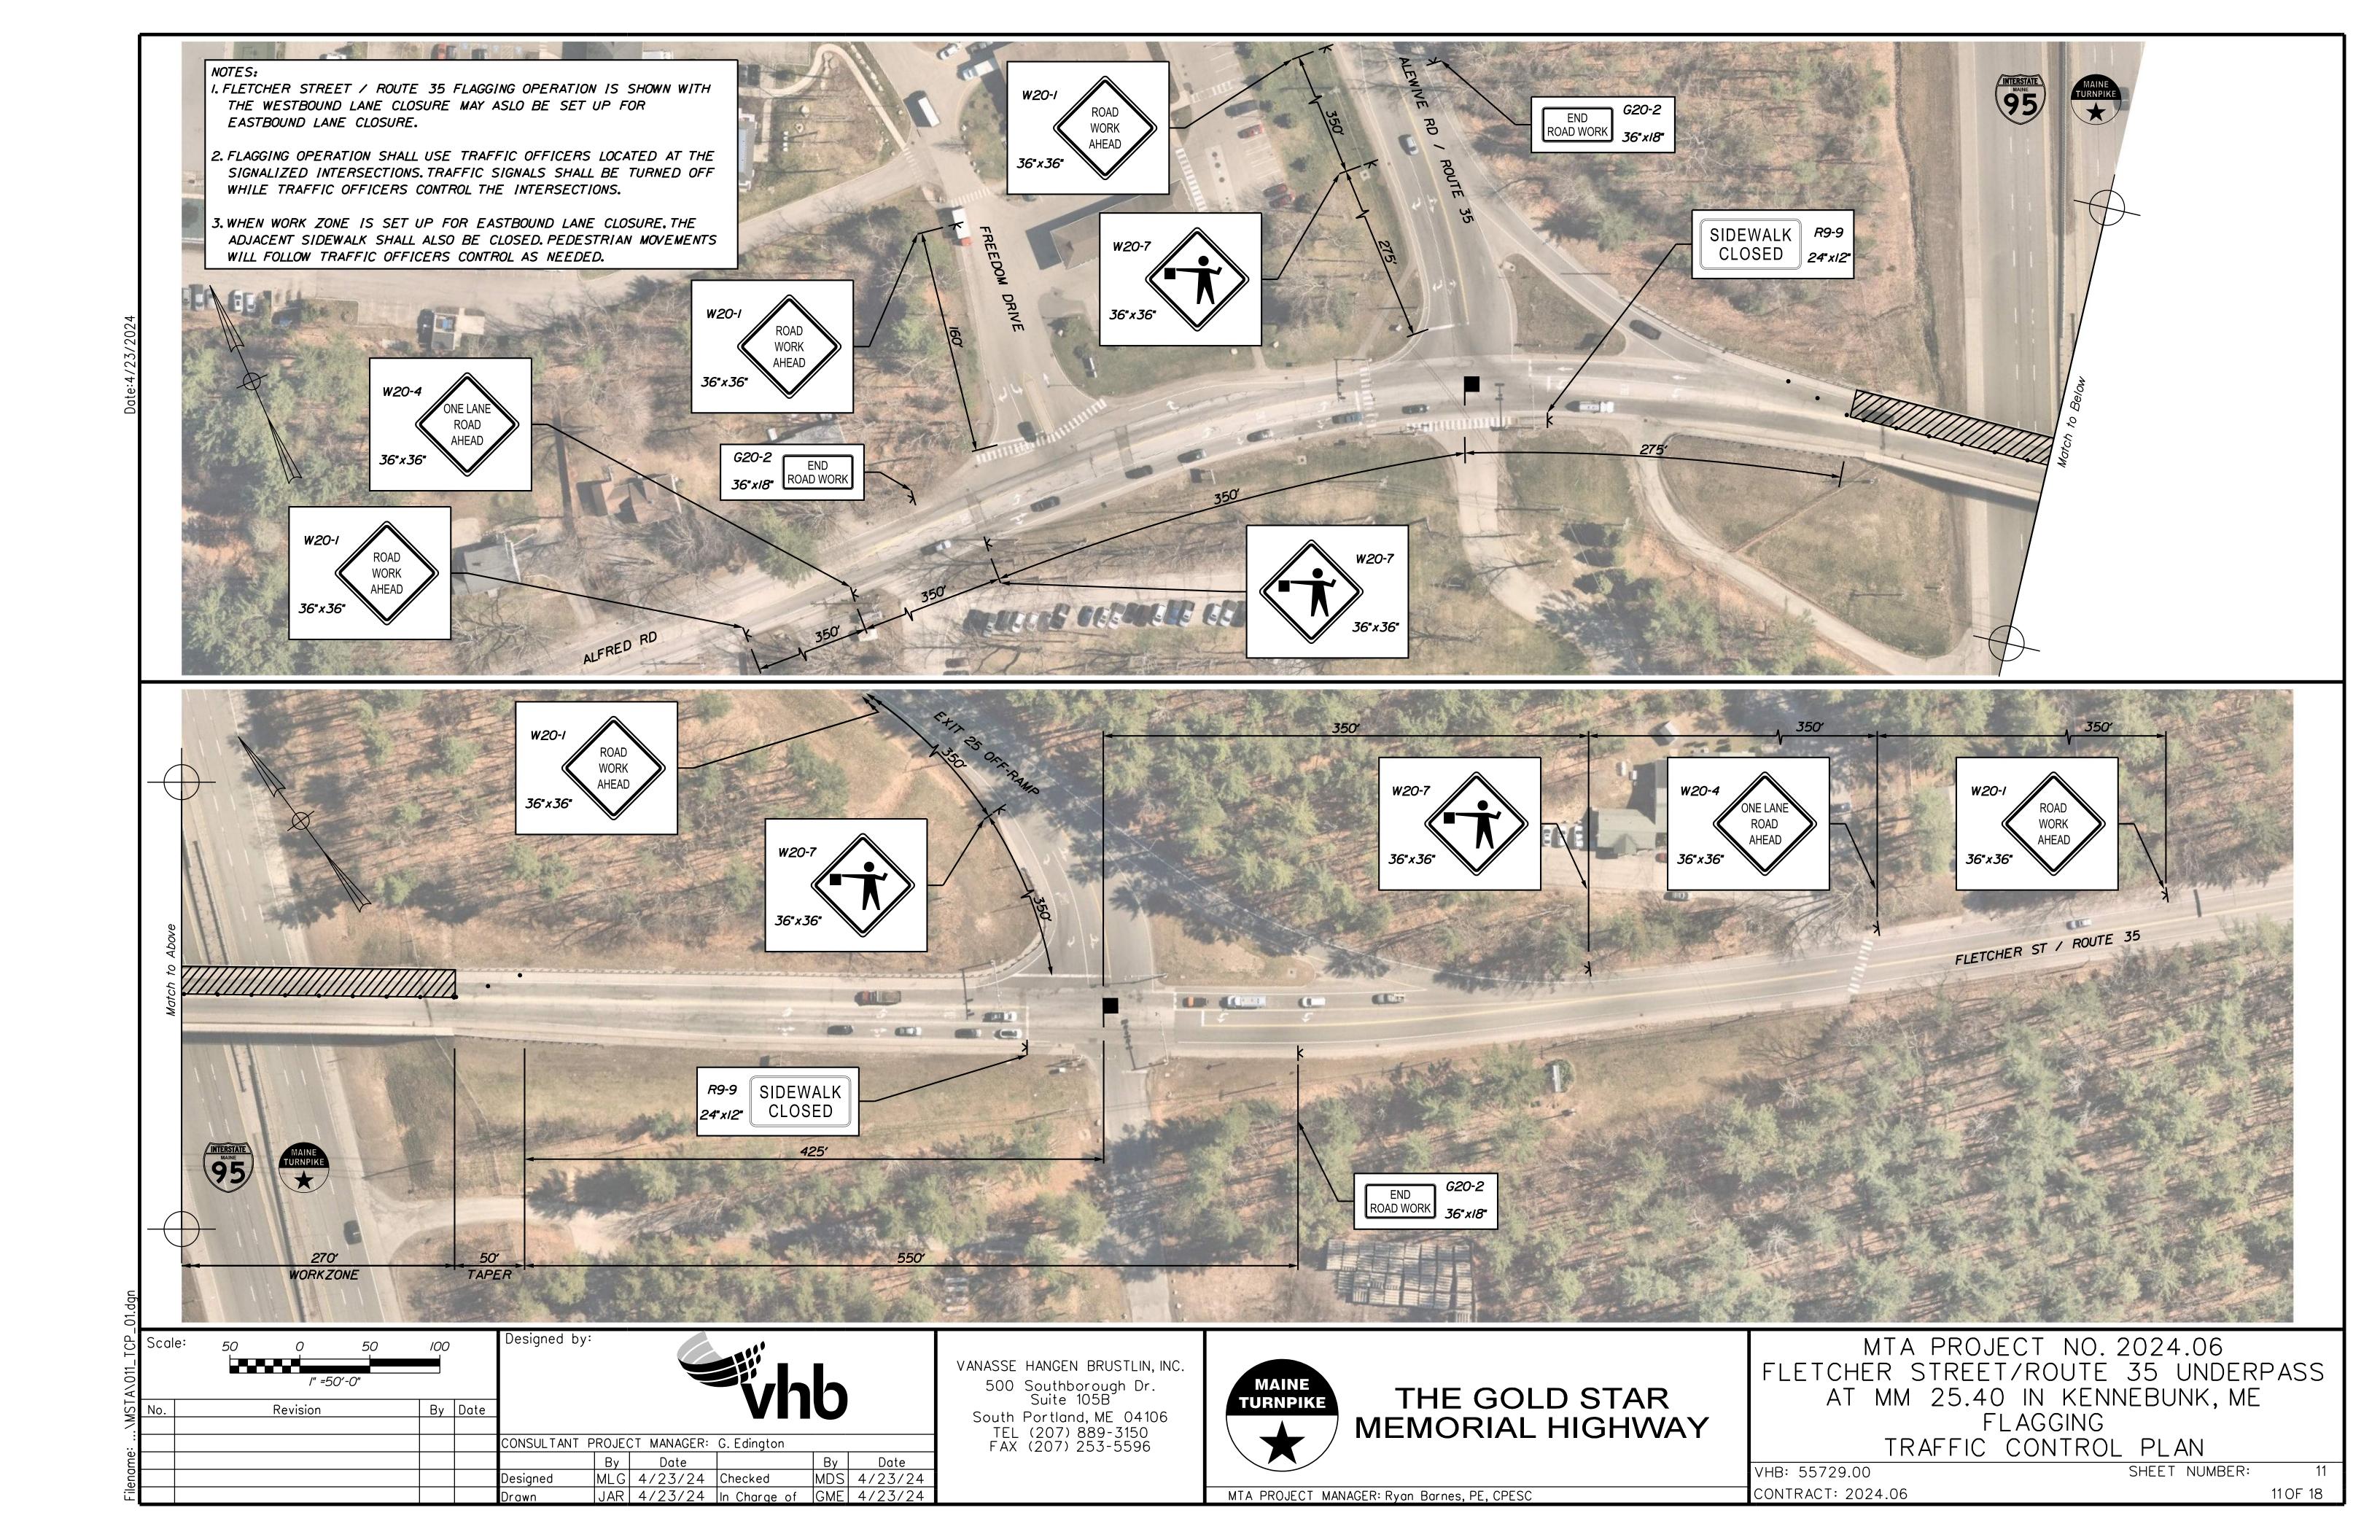


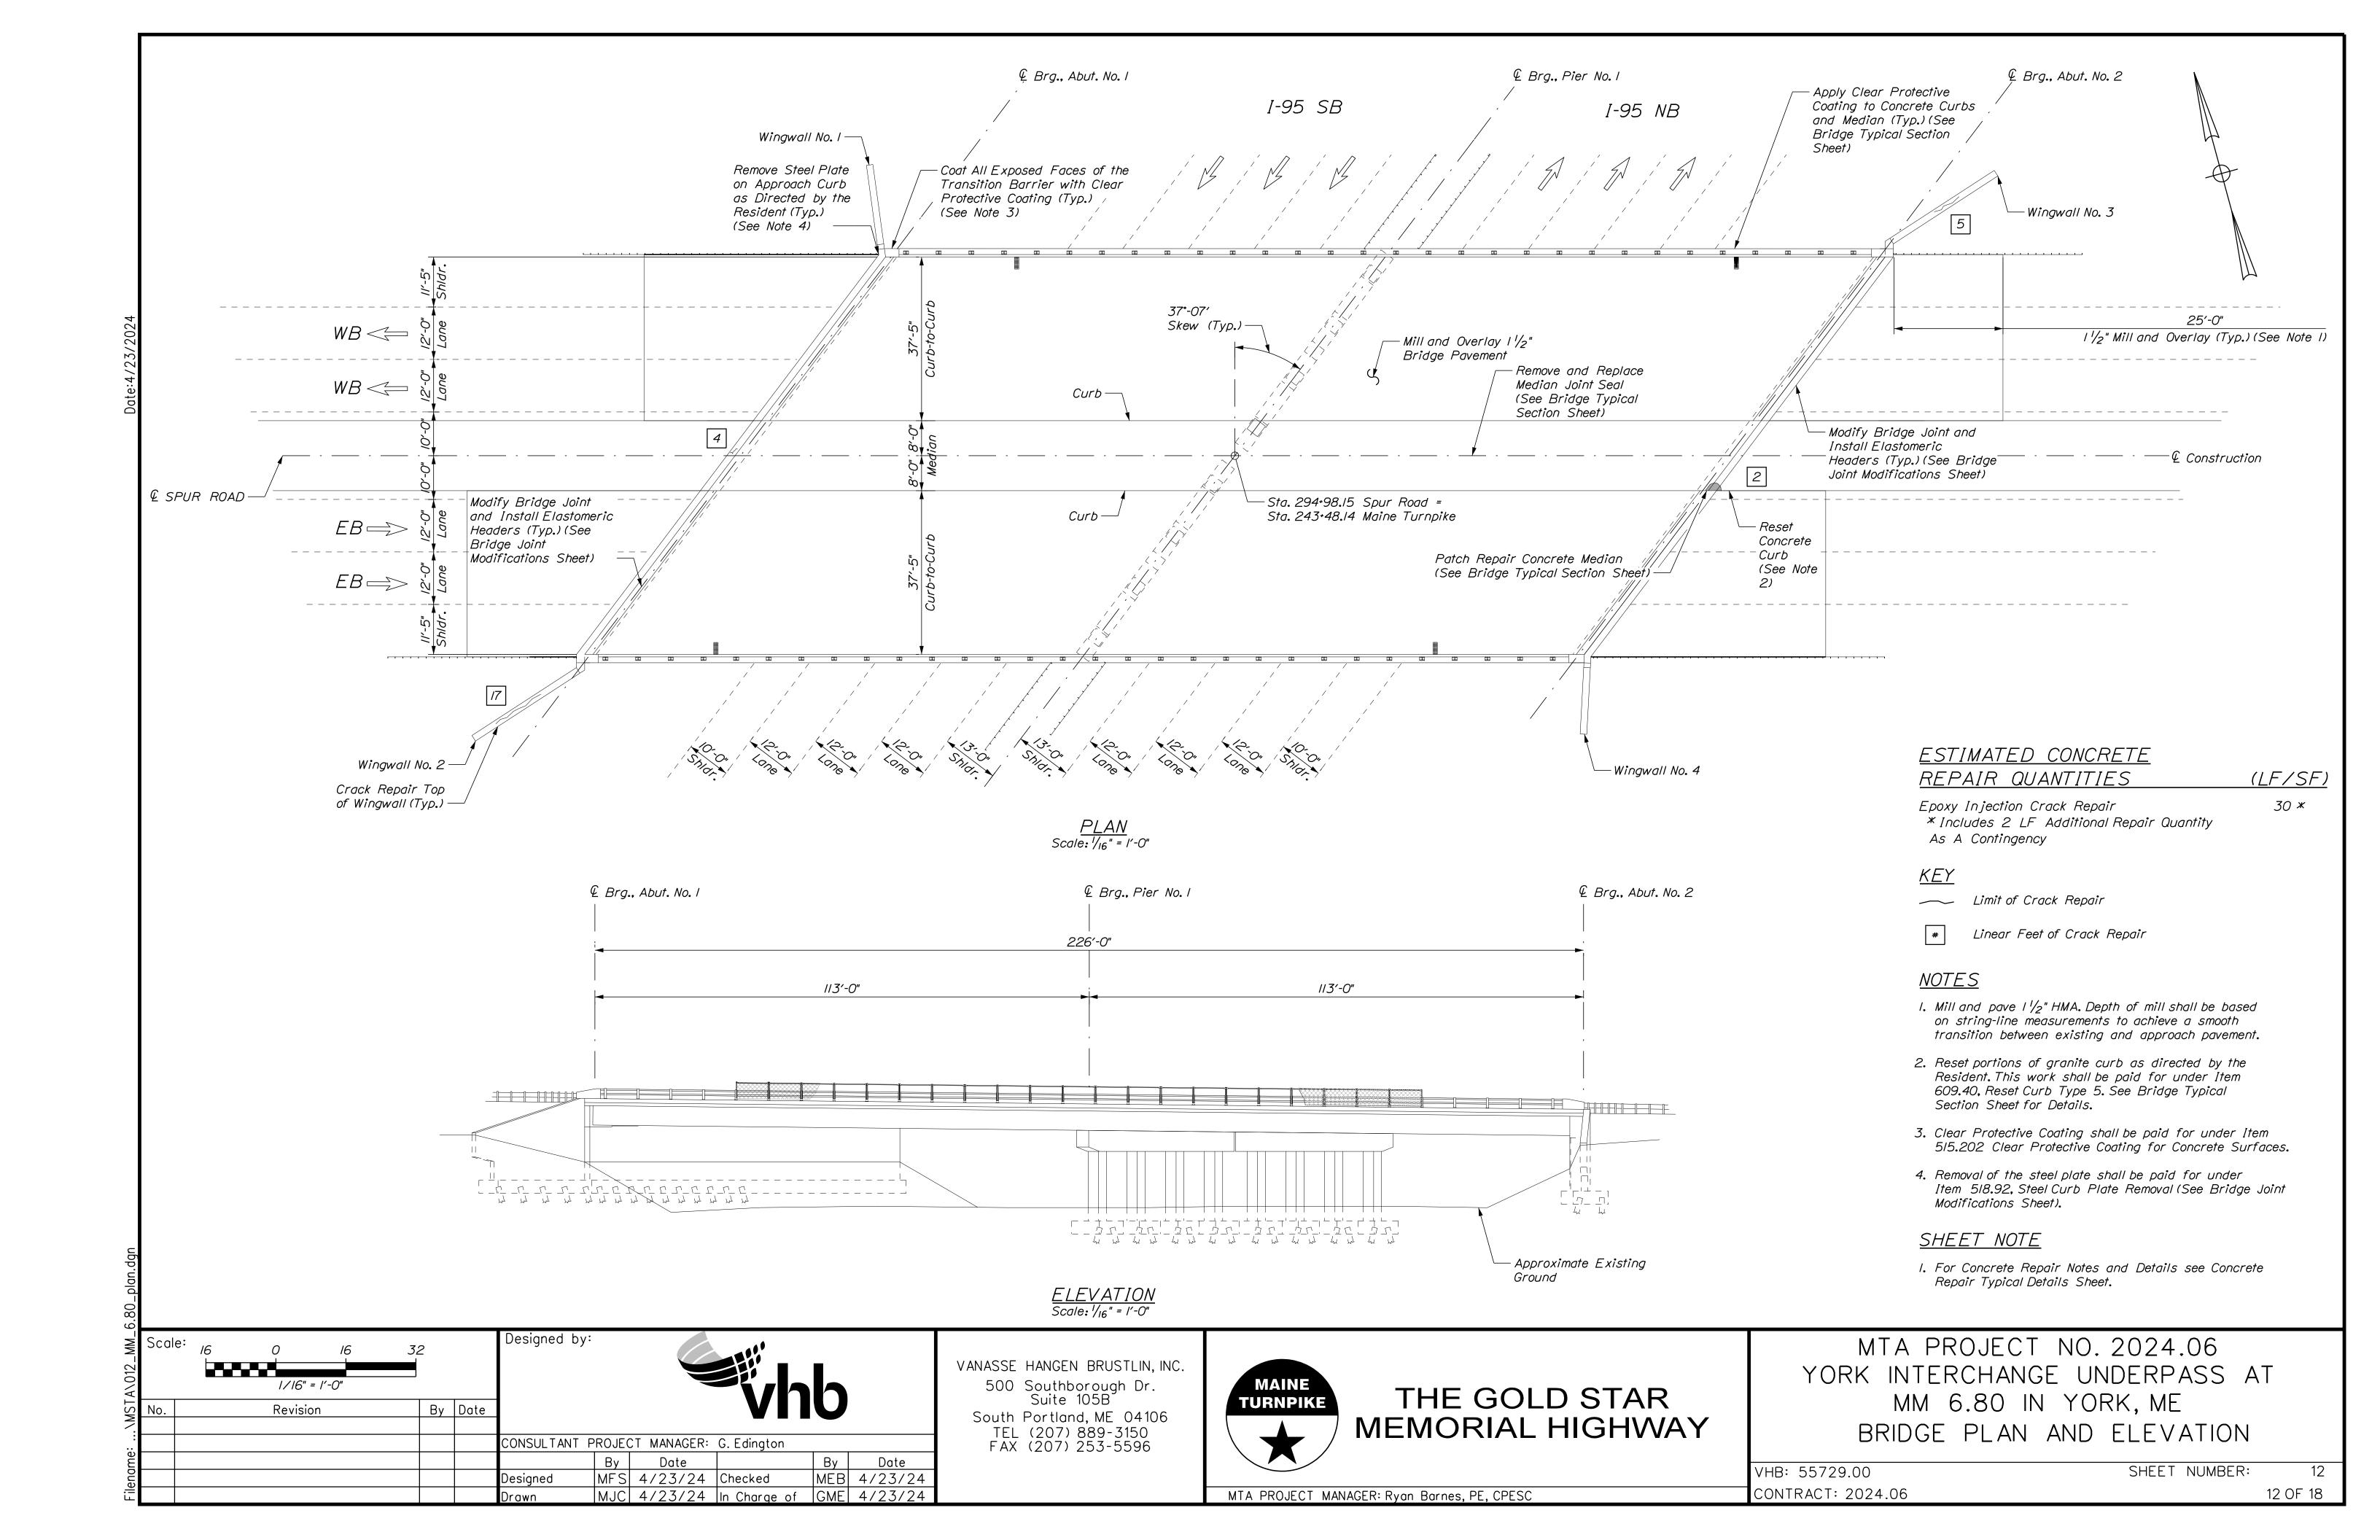

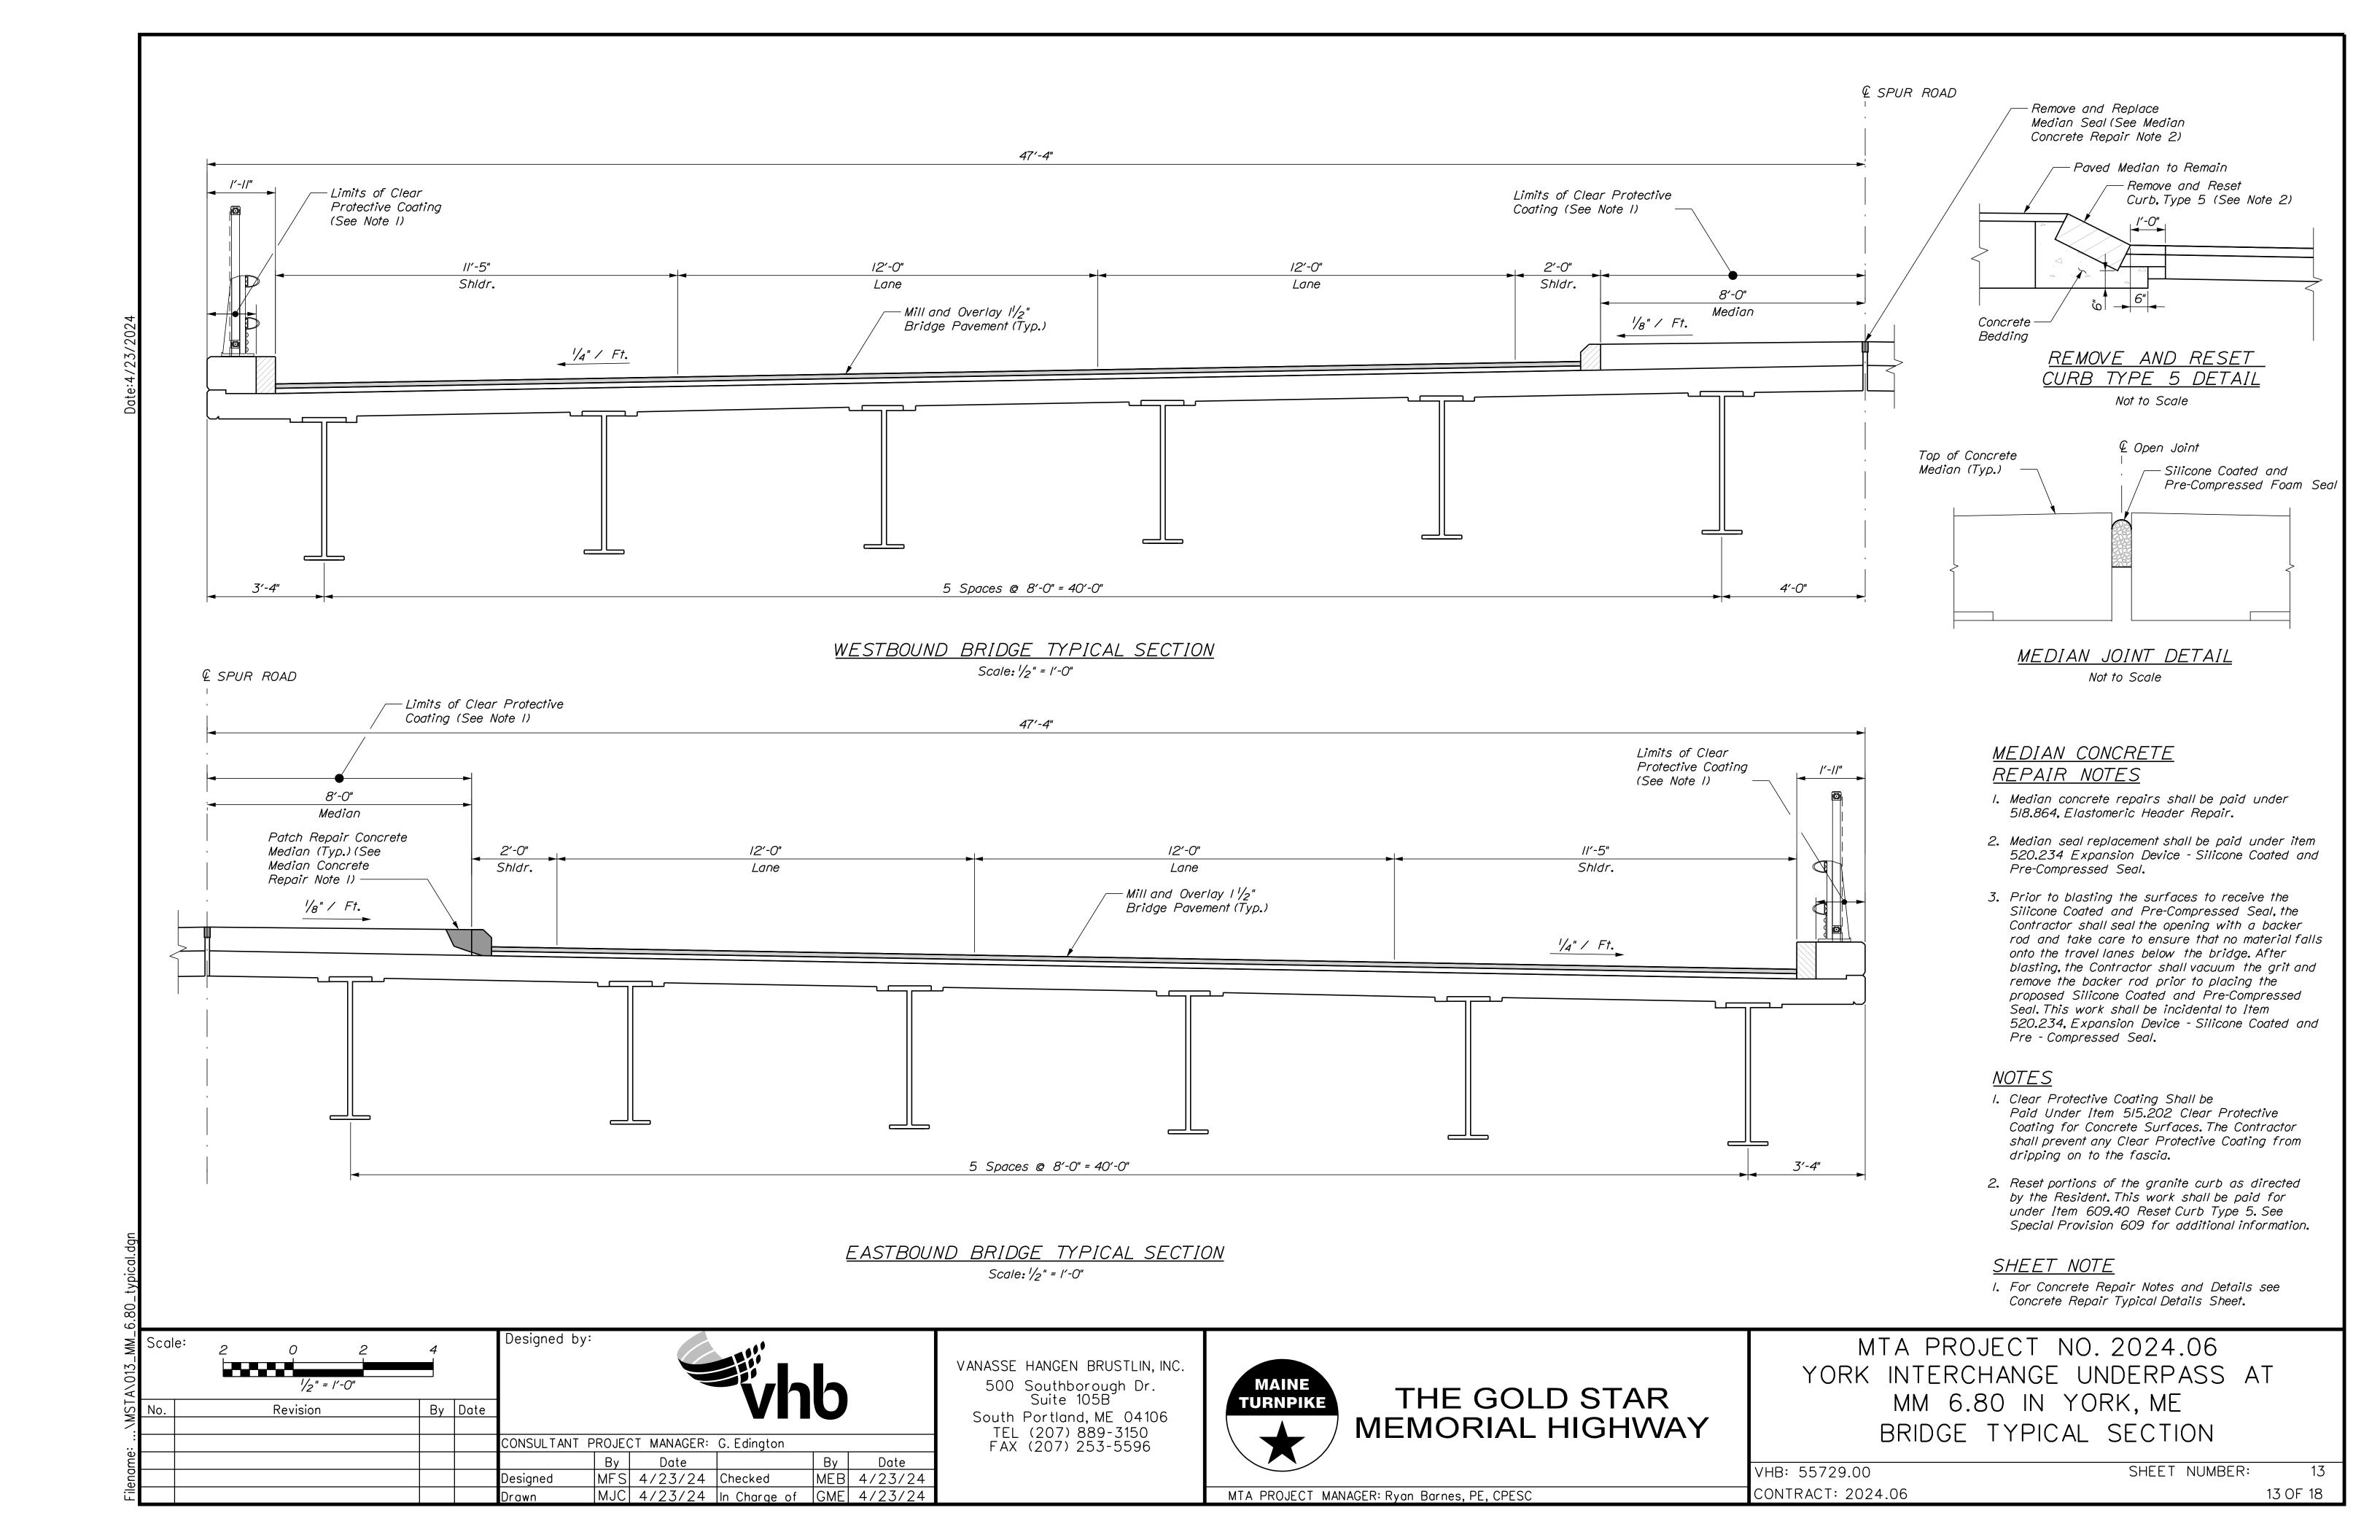

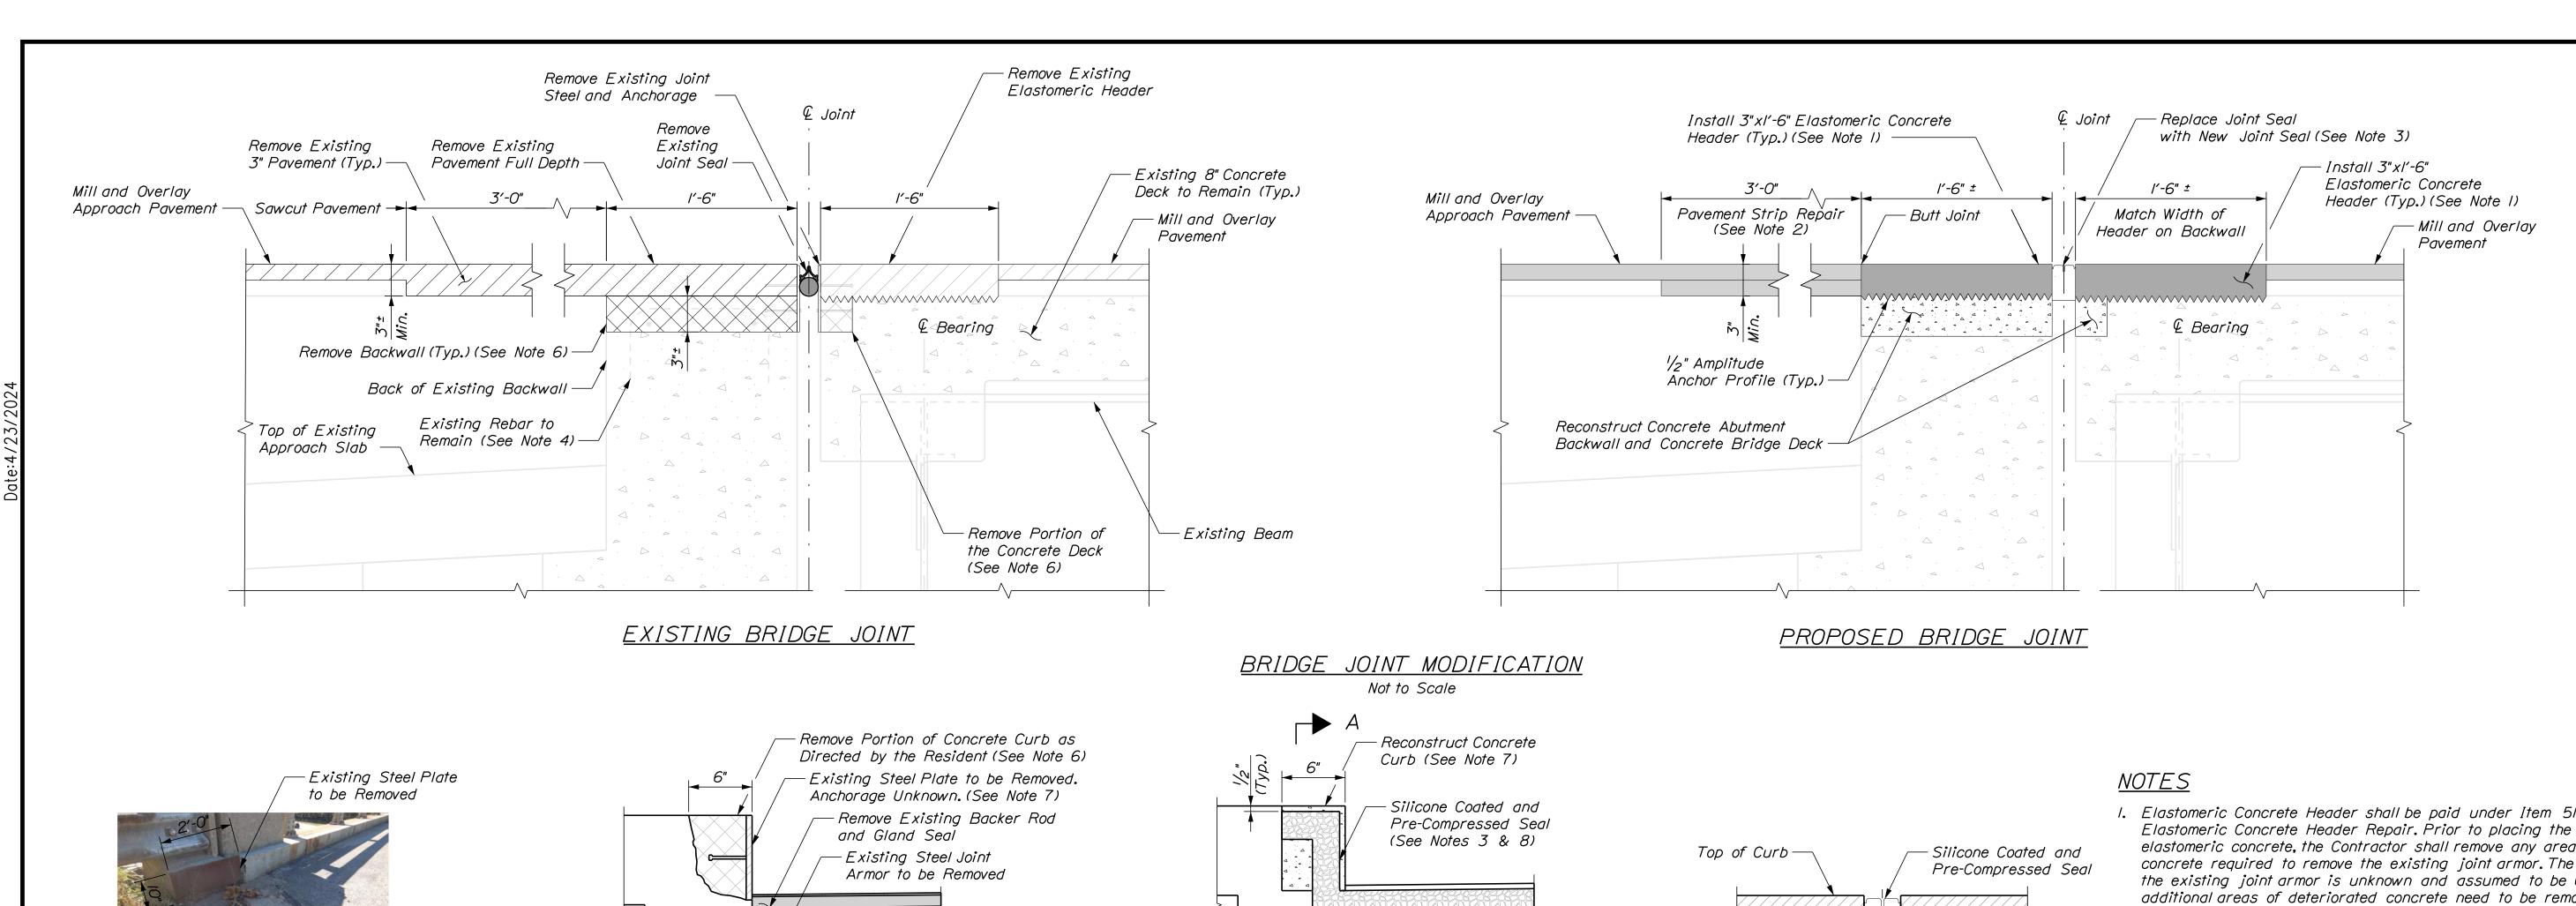

FASCIA CURB DETAIL Not to Scale

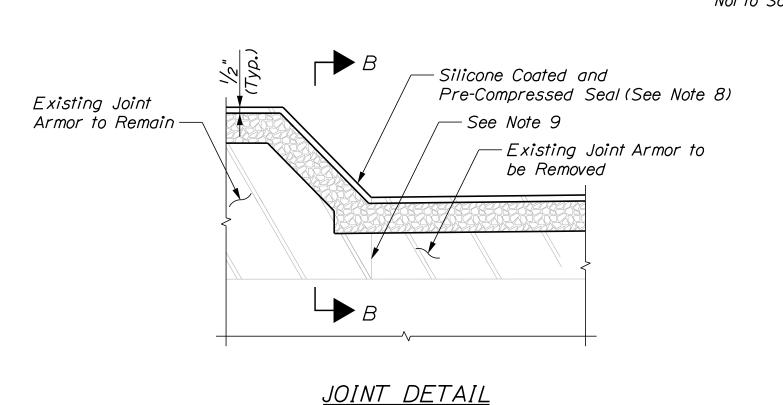

Not to Scale

EXISTING JOINT DETAIL

Remove Existing 3" Pavement (Typ.) -Top of Median -Silicone Coated and Pre-Compressed Seal SECTION B-B Not to Scale


PROPOSED JOINT DETAIL

- I. Elastomeric Concrete Header shall be paid under Item 518.864 Elastomeric Concrete Header Repair. Prior to placing the elastomeric concrete, the Contractor shall remove any areas of concrete required to remove the existing joint armor. The depth of the existing joint armor is unknown and assumed to be 6". If additional areas of deteriorated concrete need to be removed, removal shall be done in accordance with Supplemental Specification Section 518 and as directed by the Resident. If repairs to the top of the backwall are needed, the Contractor shall repair with AAA concrete at the direction of the Resident and paid under Item 518.101, Abutment Repair.
- 2. Pavement Strip Repair shall be paid under Item 403.208 Hot Mix Asphalt 12.5mm Nominal Maximum Size.
- 3. Silicone Coated and Pre-Compressed Seal shall be included in Item 520.922, Bridge Joint Modification (York Interchange
- 4. Existing rebar in abutment backwall shall be cleaned and straightened prior to placing new concrete. Install new reinforcing steel, as required. See Supplemental Specification 518.
- 5. Sawcut I" deep along all limits of removal.

SECTION A-A

Not to Scale

- 6. Chip concrete as specified in Supplemental Specification 518. If the removal limits change during the demolition process, the Contractor shall notify the Resident. The Resident and Contractor shall agree on the revised pay limits prior to the Contractor continuing the removals.
- 7. Contractor shall remove steel plates covering the bridge joint at the curb, as well as any associated anchorage. Steel plate anchorage at the curbs are unknown. Contractor shall remove and replace the concrete curb to the limits of the anchorage or as directed by the Resident. Existing curb reinforcing shall be retained, cleaned and straightened prior to placing new concrete. Concrete curbs shall be repaired using AAA concrete. All work associated with removing the steel plates shall be paid for under Item 518.96, Steel Curb Plate Removal.
- 8. Median curb seal shall extend the full length of the median.
- 9. At the median, cut the existing joint steel armor at the curb when removing the deck end and backwall concrete. The joint armor in the median shall remain.

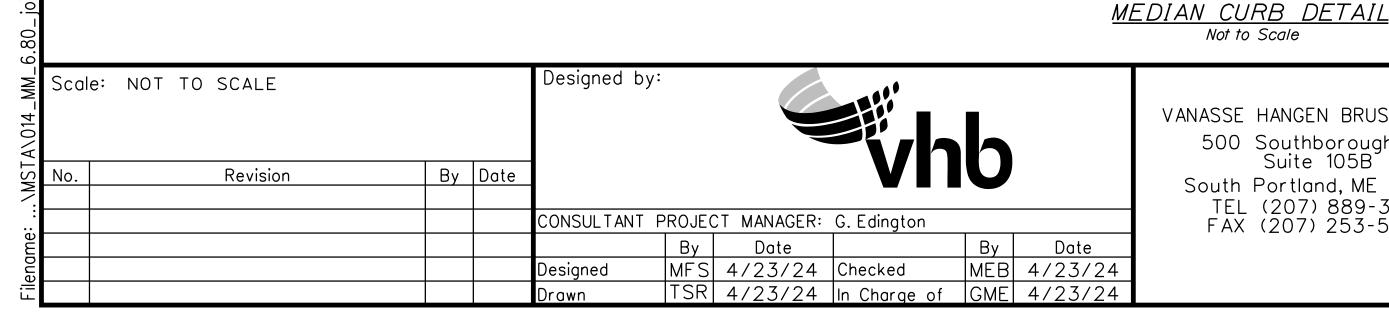

STEEL CURB PLATE ELEVATION

Not to Scale

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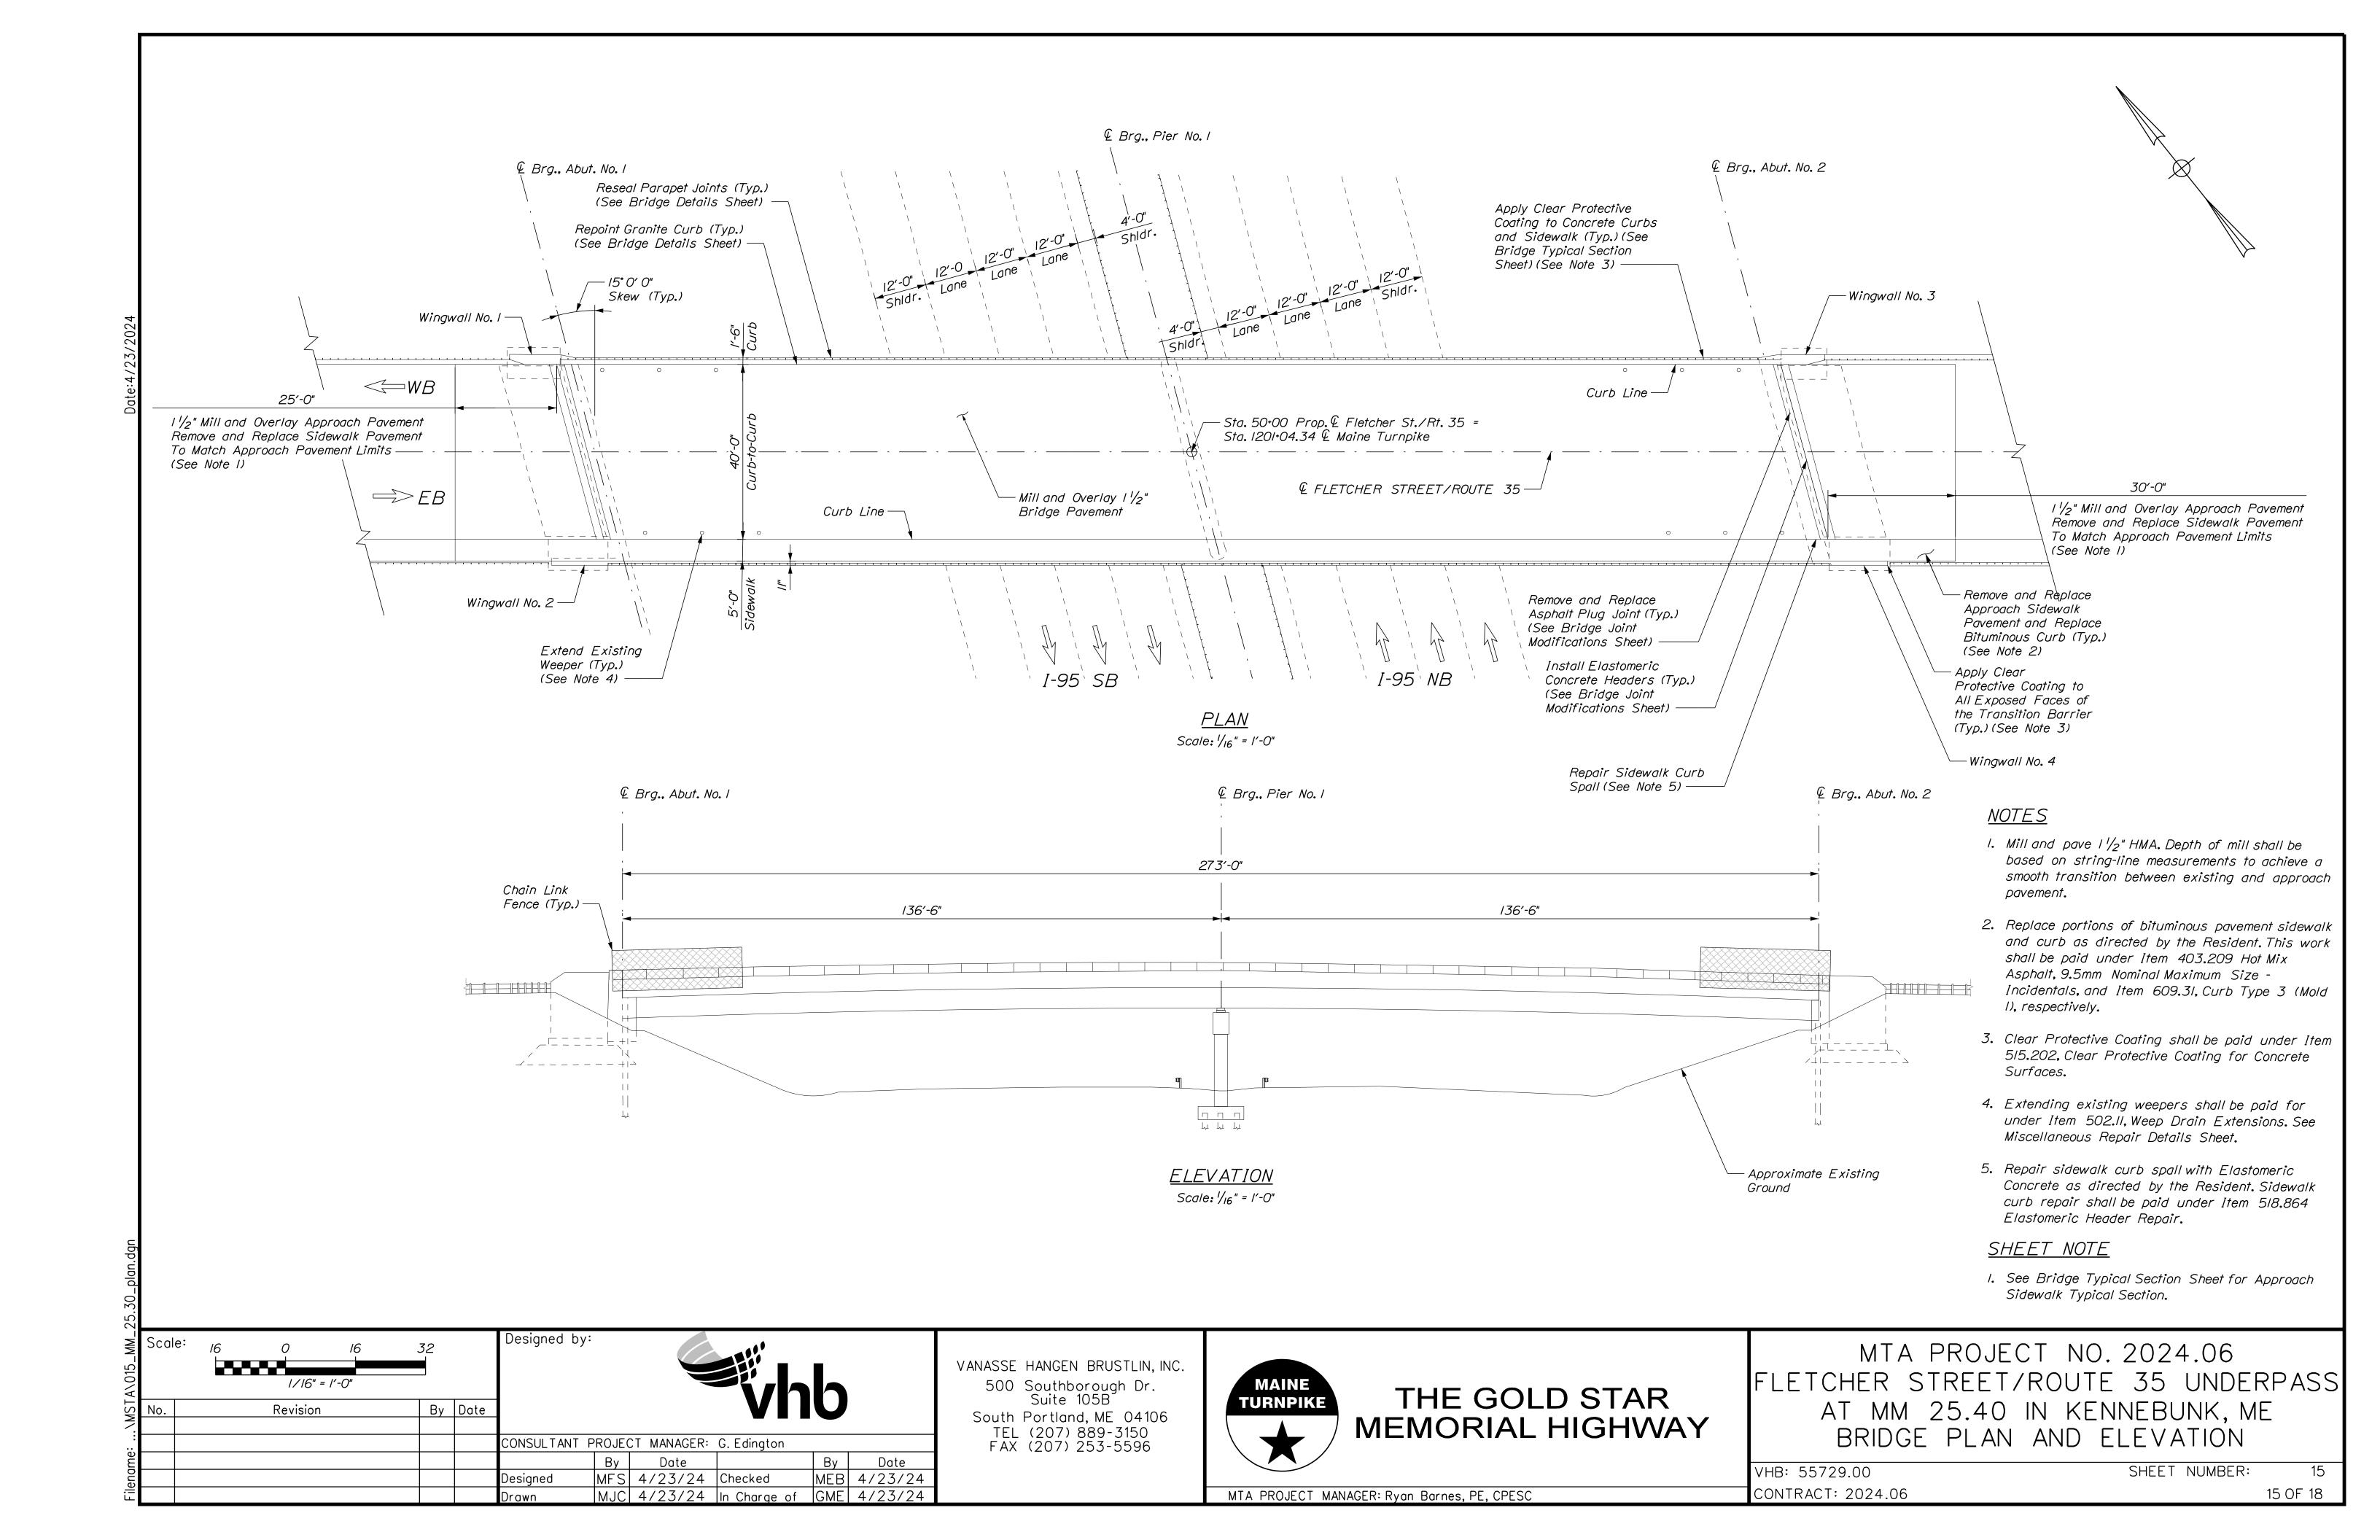
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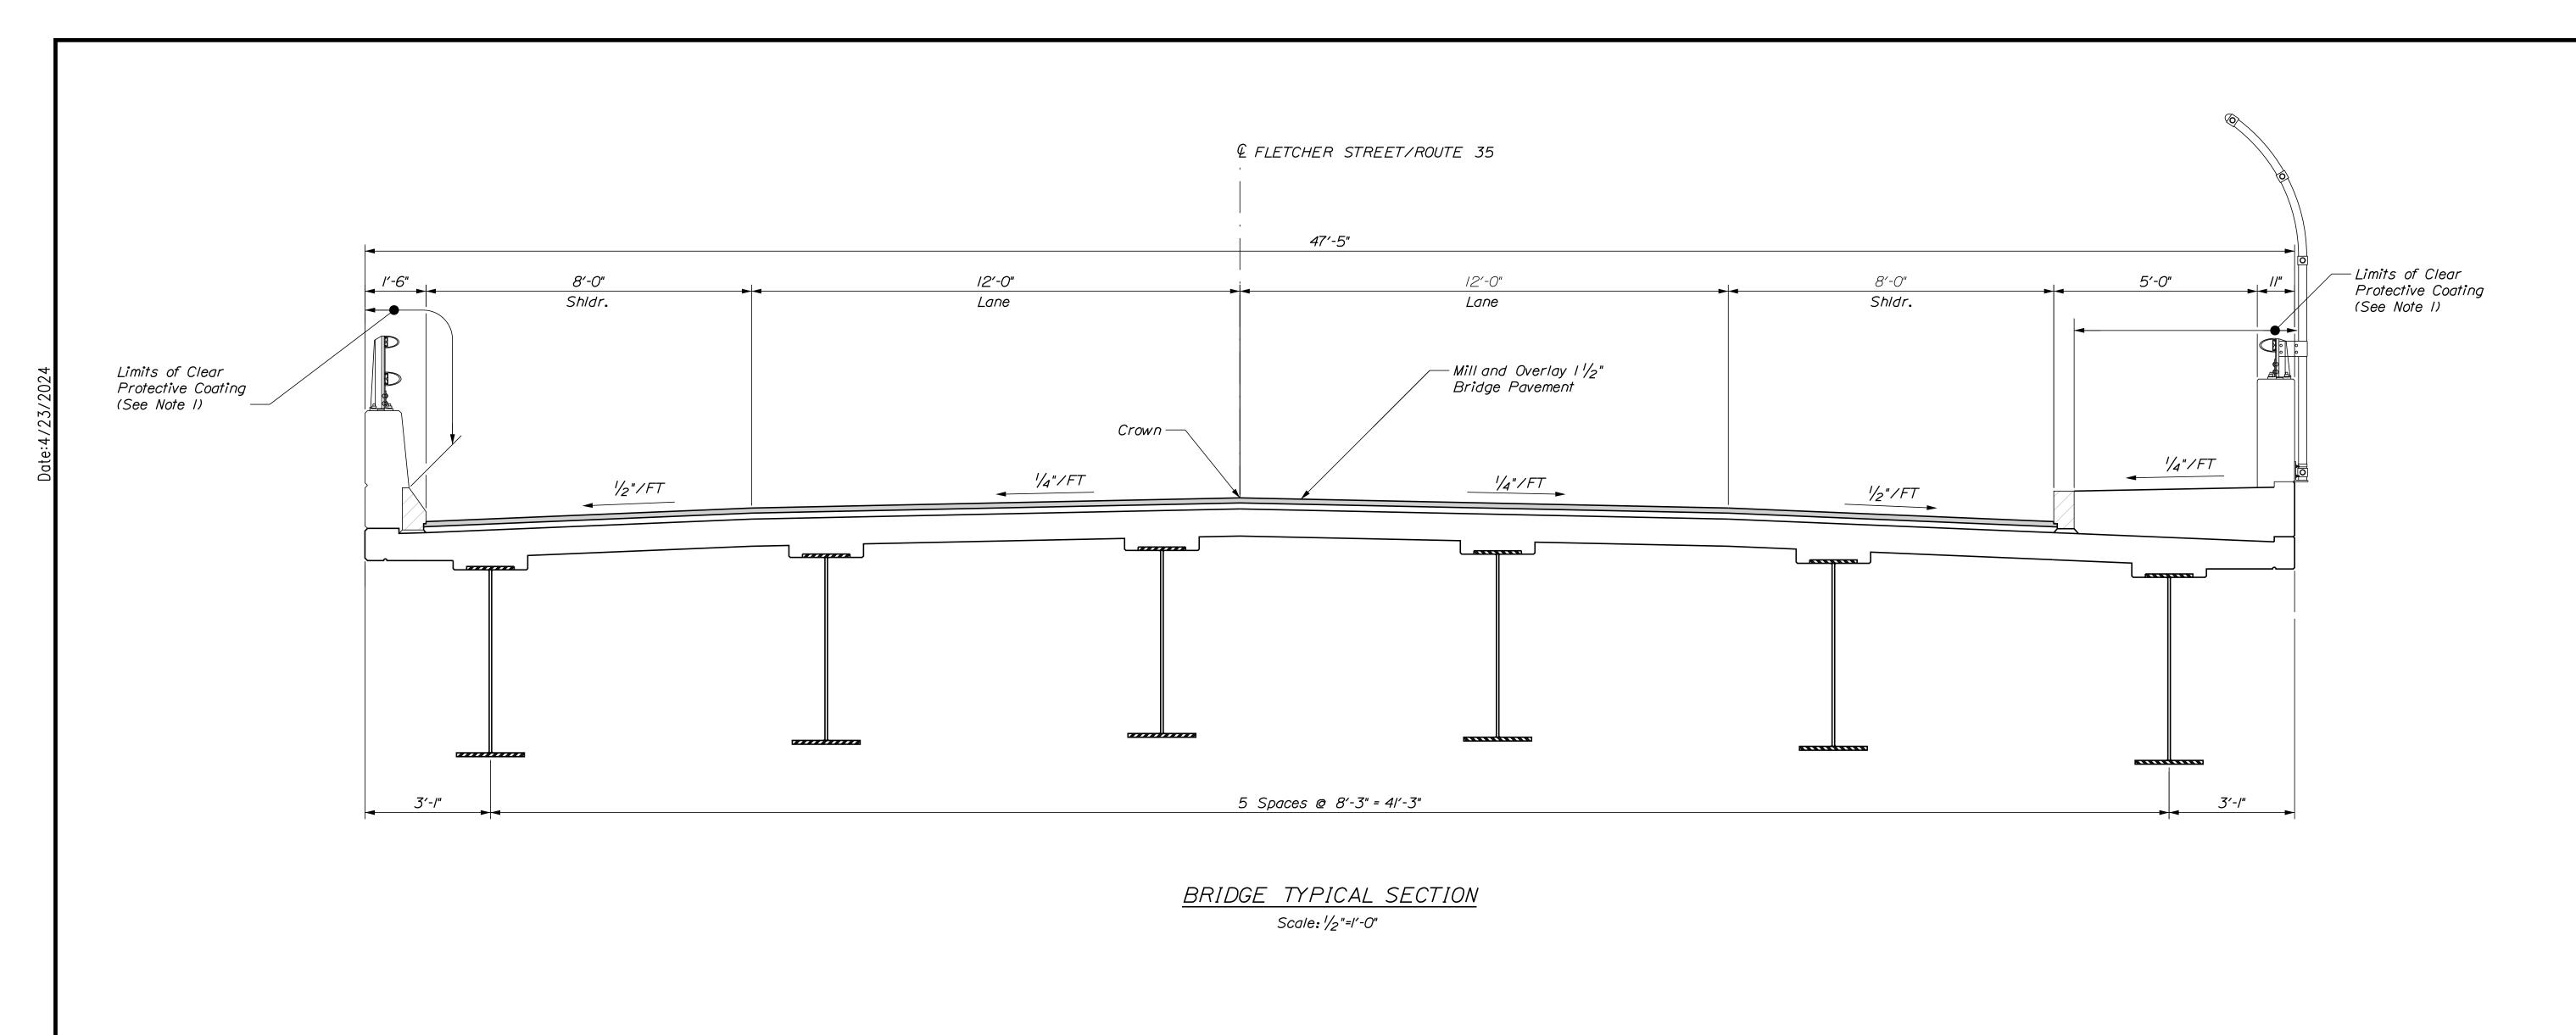
MAINE THE GOLD STAR **TURNPIKE** MEMORIAL HIGHWAY


MTA PROJECT MANAGER: Ryan Barnes, PE, CPESC

MTA PROJECT NO. 2024.06 YORK INTERCHANGE UNDERPASS AT MM 6.80 IN YORK, ME BRIDGE JOINT MODIFICATIONS

VHB: 55729.00 SHEET NUMBER: CONTRACT: 2024.06 14 OF 18






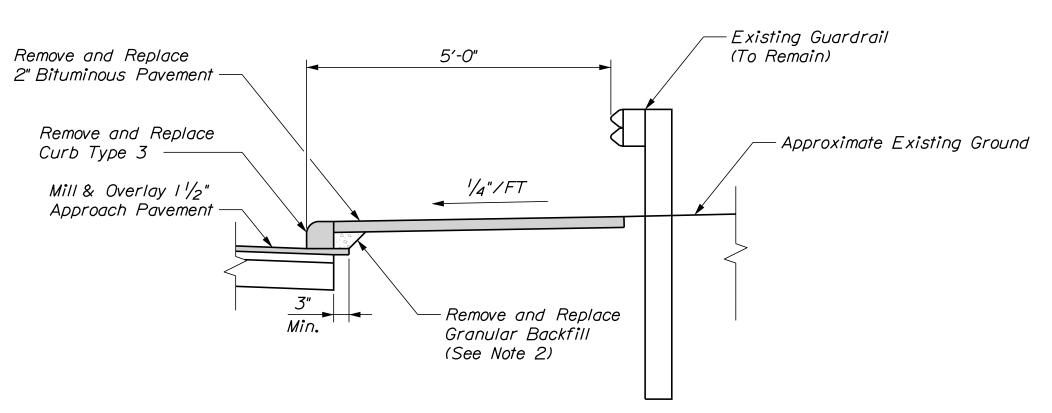

APPROACH SIDEWALK TYPICAL SECTION Scale: 1/2"=1'-0"

NOTES

- I. Clear Protective Coating Shall be Paid
 Under Item 515.202 Clear Protective
 Coating for Concrete Surfaces. The
 Contractor shall prevent any Clear Protective
 Coating from dripping on to the fascia.
- 2. Remove and Replace Granular Backfill as
 Directed by the Resident. All costs
 associated with this work shall be incidental
 to Item 609.31 Curb Type 3 (Mold I)

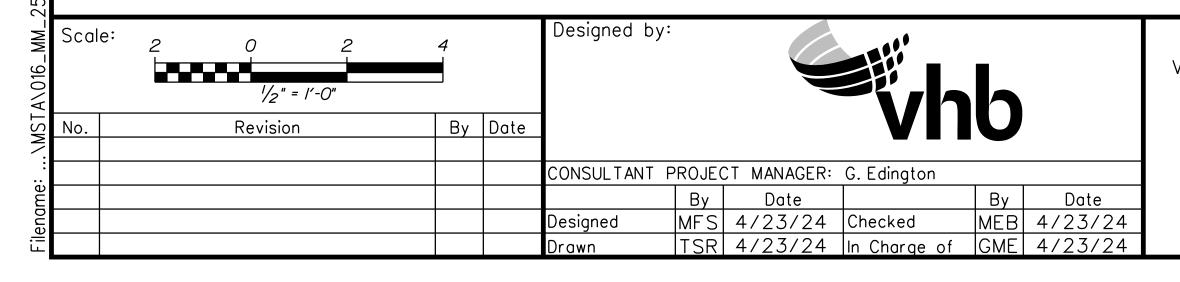

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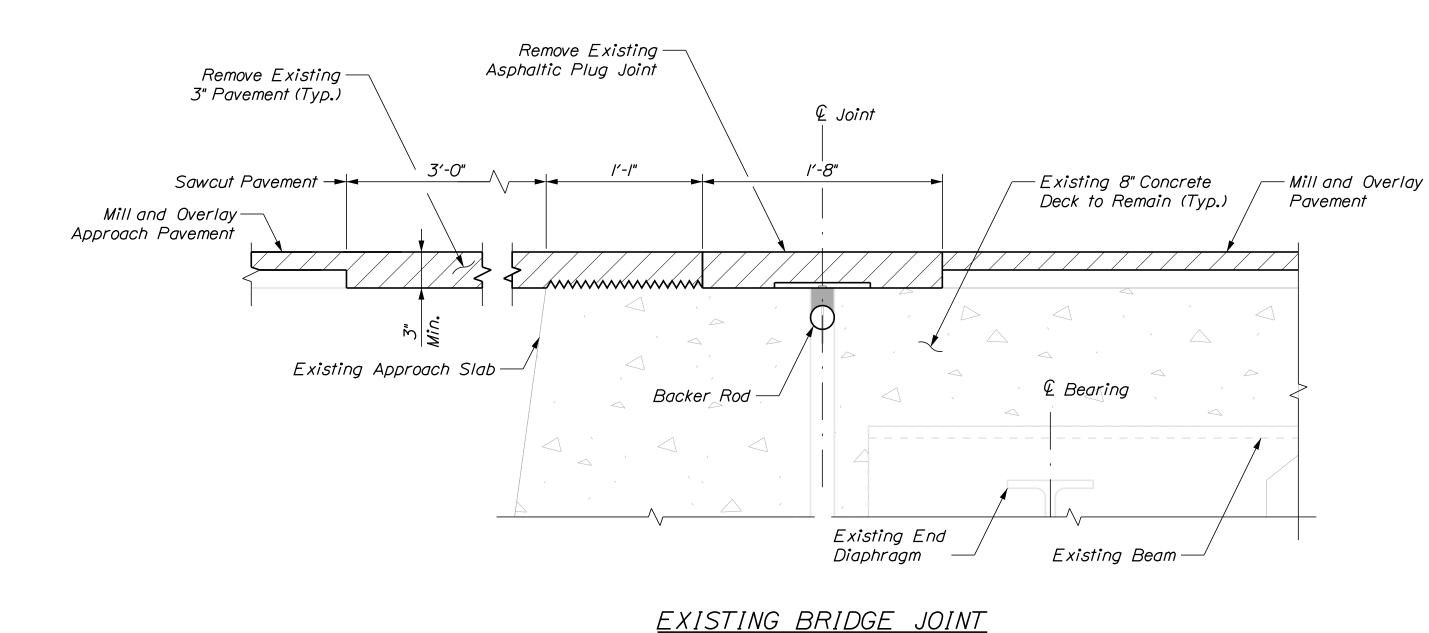
THE MEMO

MTA PROJECT MANAGER: Ryan Barnes, PE, CPESC

THE GOLD STAR MEMORIAL HIGHWAY

MTA PROJECT NO. 2024.06
FLETCHER STREET/ROUTE 35 UNDERPASS
AT MM 25.40 IN KENNEBUNK, ME
BRIDGE TYPICAL SECTION


VHB: 55729.00 SHEET NUMBER: 16 CONTRACT: 2024.06 16 OF 18




Remove and Replace Asphaltic-Binder Material - Aluminum Flashing (See Note 2) Butt Joint Asphaltic Plug Joint 3′-0" Mill and Overlay Pavement Pavement Strip Repair Mill and Overlay— (See Note 3) Approach Pavement Install 3"xl'-l" Elastomeric Concrete Header (See Note I) Backer Rod ¹/₂" Amplitude Anchor Profile (Typ.) -Patch Repair Top of Approach Slab (See Note I) I6D Galvanized Centering Nails

PROPOSED BRIDGE JOINT

BRIDGE JOINT MODIFICATION Not to Scale

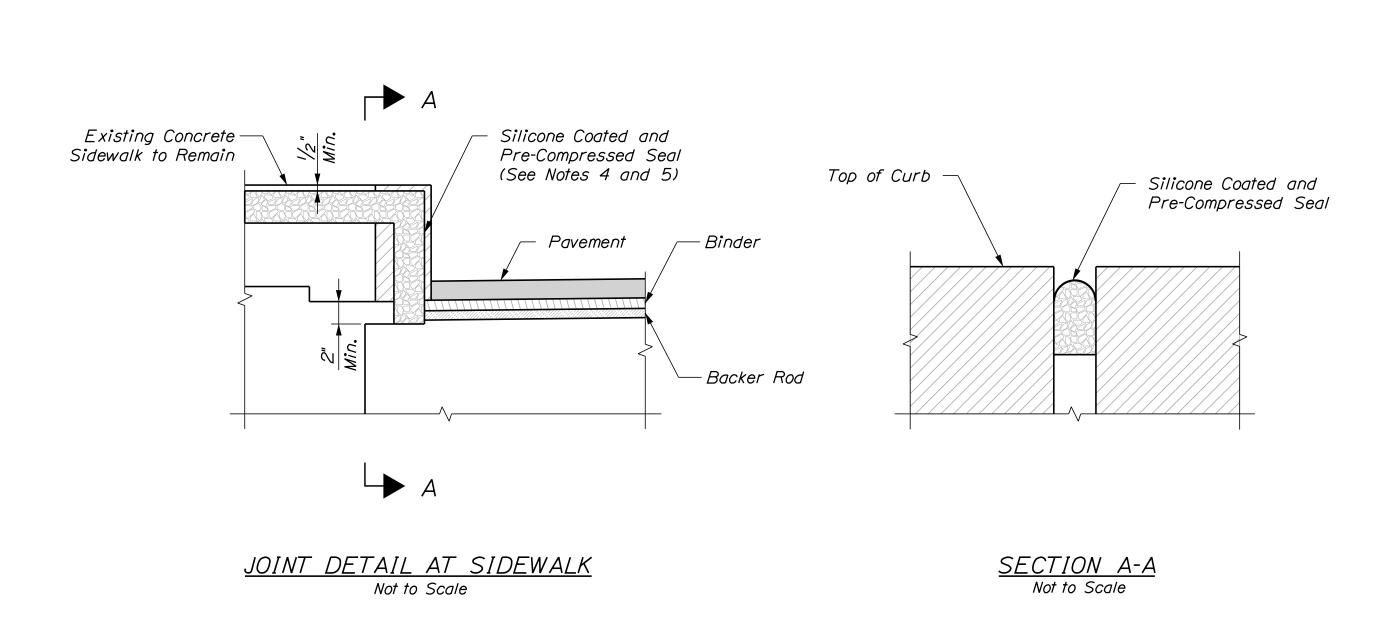

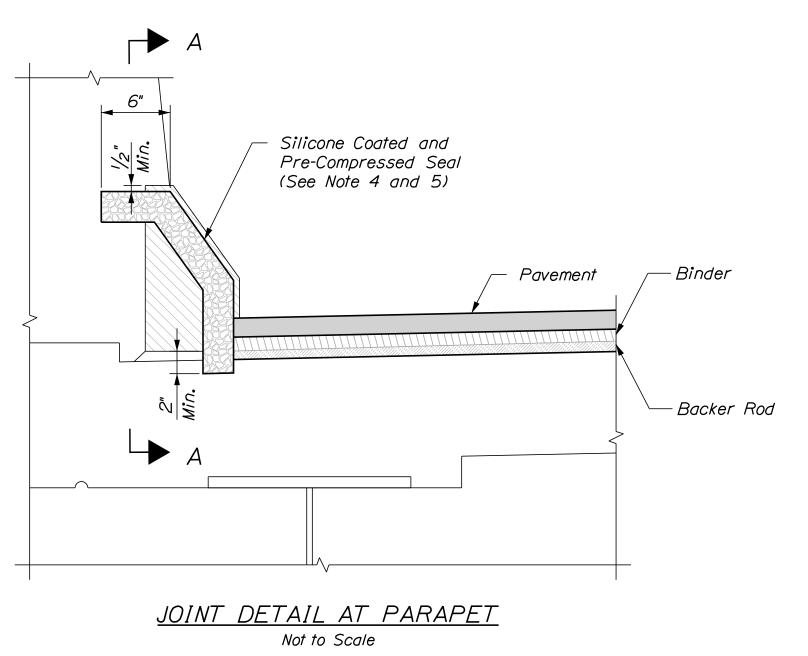

NOTES

- I. Elastomeric Concrete Header shall be paid under Item 518.864 Elastomeric Concrete Header Repair. Prior to placing the elastomeric concrete, the Contractor shall remove any areas of deteriorated concrete in accordance with Supplemental Specification Section 518 and as directed by the Resident. If repairs to the top of the approach slab are needed, the Contractor shall repair with elastomeric concrete and repairs shall be paid under Item 518.864 Elastomeric Concrete Header Repair. If repair depth is greater than 3" below the header, the repairs may be done with AAA concrete at the direction of the Resident and paid under Item 518.101, Abutment Repairs. Abutment Repair quantity is based on an average depth of 3" for additional repairs below the elastomeric header.
- 2. Aluminum Flashing shall be incidental to Item 520.23 Asphaltic Plug
- 3. Pavement Strip Repair shall be paid under Item 403.208 Hot Mix Asphalt 12.5mm Nominal Maximum Size.
- 4. Silicone Coated and Pre-Compressed Seal shall be in accordance with Special Provision 520, Expansion Devices, Non-Modular, Silicone Coated and Pre-compressed Seal. Payment shall be incidental to Item 520.23. Asphaltic Plug Joint.
- 5. After the installation of the asphaltic plug joint system. The bonded Silicone Coated and Pre-Compressed Seal shall be installed in the curbs as shown on the plans and as recommended by the manufacturer. Sidewalk seal shall extend the full width of the sidewalk.
- 6. The Contractor shall place and secure steel plates over the joint after the existing pavement and joint binder material have been removed and before the proposed elastomeric concrete and joint binder material has been placed. See Special Provision 518 for additional requirements.

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No.	Revision	Ву	Date]			VII	U	
				CONSULTANT	PROJE(CT MANAGER:	G. Edington		
					Ву	Date		Ву	Date
				Designed	MFS	4/23/24	Checked	MEB	4/23/2
				Drawn	TSR	4/23/24	In Charge of	GME	4/23/2

VANASSE HANGEN BRUSTLIN, INC. 500 Southborough Dr. Suite 105B South Portland, ME 04106

TURNPI TEL (207) 889-3150 FAX (207) 253-5596

KE	THE GOLD STAR
	MEMORIAL HIGHWAY


MTA PROJECT MANAGER: Ryan Barnes, PE, CPESC

MTA PROJECT NO. 2024.06 FLETCHER STREET/ROUTE 35 UNDERPASS AT MM 25.40 IN KENNEBUNK, ME BRIDGE JOINT MODIFICATIONS

SHEET NUMBER: VHB: 55729.00 CONTRACT: 2024.06 17 OF 18


EXISTING GRANITE CURB DETAIL - SIDEWALK

Not to Scale

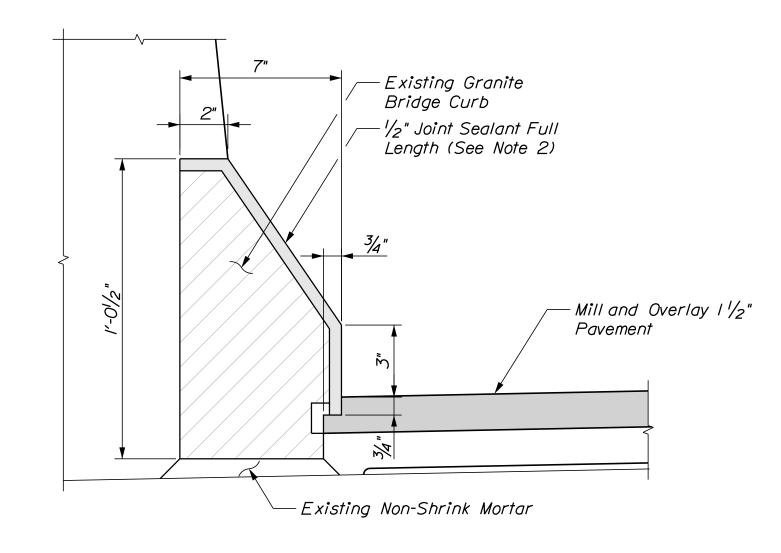

GRANITE CURB DETAIL - PARAPET

Not to Scale

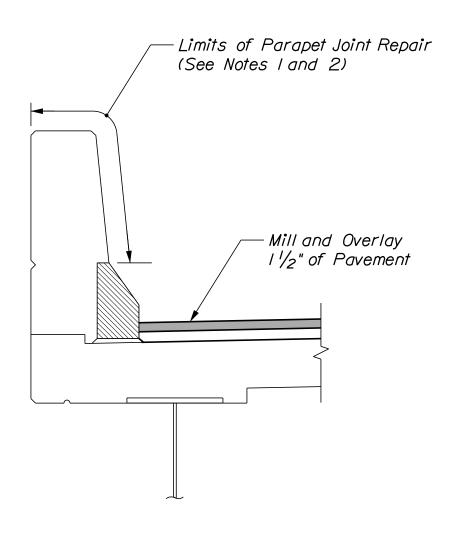

PARAPET DETAIL
(Bridge Rail not Shown for Clarity)
Not to Scale

<u>NOTES</u>

- I. Repair parapet joints as directed by the Resident. Joint sealant shall be from MaineDOT Qualified Product List for Silicone and Polyurethane Joint Sealant. Work shall be paid for under Item 518.48 Reseal Joints.
- 2. Joint Sealant shall be a material from the Maine DOT approved products list as approved by the resident. Joint Sealant shall be incidental to Item 518.391 Repair Granite Curb Joint and Bedding Mortar.

Scale:	Not to Scale			Designed by	:			h	
No.	Revision	Ву	Date	1			VII	U	
				CONSULTANT	PROJE(CT MANAGER:	G. Edington		
					Ву	Date		Ву	Date
				Designed	MFS	4/23/24	Checked	MÉB	4/23/24
				Drawn	MJC	4/23/24	In Charge of	GME	4/23/24

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MTA PROJECT NO. 2024.06
FLETCHER STREET/ROUTE 35 UNDERPASS
AT MM 25.40 IN KENNEBUNK, ME
MISCELLANEOUS DETAILS

VHB: 55729.00 SHEET NUMBER: 18
CONTRACT: 2024.06 18 OF 18