



## MAINE TURNPIKE AUTHORITY

DANIEL E. WATHEN, CHAIR ROBERT D. STONE, VICE CHAIR MICHAEL J. CIANCHETTE, MEMBER JOHN E. DORITY, MEMBER ANN R. ROBINSON, MEMBER THOMAS J. ZUKE, MEMBER KAREN S. DOYLE, MEMBER EX-OFFICIO

S. PETER MILLS, EXECUTIVE DIRECTOR

## **CONTRACT 2019.11** NORTHERN BRIDGE REPAIRS 6 LOCATIONS:

ROUTE 26 UNDERPASS (MILE 64.3) OLD WEBSTER ROAD UNDERPASS (MILÉ 82.7) PLAINS ROAD UNDERPASS (MILE 95.6) PLEASANT RIVER CULVERT (MILE 62.3) COLE BROOK CULVERT (MILE 65.25) FOSTER BROOK CULVERT (MILE 72.9)

EMERGENCY VEHICLE RAMPS BENNETT ROAD UNDERPASS (MILE 68.6)

NEW GLOUCESTER TOLL PLAZA CASH LANE 8 REHABILITATION (MILE 67)

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STRIP SEAL EXPANSION JOINT REINFORCING STEEL SCHEDULE

**OLD WEBSTER ROAD UNDERPASS** 

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**DETOUR PLAN** 

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PLEASANT RIVER CULVERT

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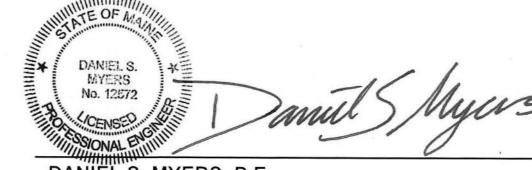
DRAINAGE DETAILS

100-102 MISCELLANEOUS DETAILS **NEW GLOUCESTER TOLL PLAZA** 

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T-Y-LININTERNATIONAL



DANIEL S. MYERS, P.E. T.Y. LIN INTERNATIONAL PROJECT MANAGER, SHEETS 1-102 February 20, 2019

DATE

STEPHEN R. TARTRE, P.E. DIRECTOR OF ENGINEERING AND BUILDING MAINTENANCE

CHIEF OPERATIONS OFFICER

**HNTB DIRECTOR OF OPERATIONS, SHEETS 103-105** 

					Ī	<u>T</u>	Quantities	<del>                                     </del>		* * · · ·	Ī
em No	Item Description	Unit	Mile 62.3	Mile 64.3	Mile 65.25	Mile 68.6	Mile 72.9	Mile 82.7	Mile 95.6	Mile 67.0	77-4-1
	Tem Description	Oiiit	Pleasant River	Route 26	Cole Brook	Bennett Road	Foster Brook	Webster Road	Plains Road	New	Total
			Culvert	Underpass	Culvert	EVR	Culvert	Underpass	Underpass	Gloucester Toll Plaza	Quantity
1.11	CLEARING	AC		0.10		0.60				Ton Piaza	0.70
	REMOVING EXISTING STRUCTURAL CONCRETE	CY		55		0.00					55
	REMOVING EXISTING BITUMINOUS PAVEMENT (2765 SY)			0.47				0.20	0.33		1
	HYDRO-DEMOLITION	SY		4						60	60
	REMOVING EXISTING DRAIN TROUGHS REMOVING PAVEMENT SURFACE	LS SY		1 240		47					287
	PAVEMENT BUTT JOINT	SY		240		77		250	330		580
	COMMON EXCAVATION	CY		350		420					770
	GRANULAR BORROW	CY		102							102
	AGGREGATE SUBBASE COURSE - GRAVEL	CY		390		660					1,050
	AGGREGATE BASE COURSE - TYPE A HOT MIX ASPHALT - 12.5MM NOMINAL MAXIMUM SIZE	CY TON		218		360 310		65	112		360 705
	HOT MIX ASPHALT - 12.5MM NOMINAL MAXIMOM SIZE	TON				310		05	112		15
	HOT MIX ASPHALT, 12.5MM NOMINAL MAXIMUM SIZE (BASE AND INTERMEDIATE COURSE)	TON		378		330		45	77		830
9.15	BITUMINOUS TACK COAT RS-1 OR RS-Ah - APPLIED	GAL		188		120		40	69		417
	SAWING BITUMINOUS PAVEMENT	LF		140		390					530
	BERM DROP OFF CORRECTION - GRINDINGS	TON		50		110					110
	STRUCTURAL CONCRETE, ABUTMENTS AND RETAINING WALLS STRUCTURAL CONCRETE ROADWAY SLAB WEARING SURFACE	CY CY	+	50						5	50 5
	STRUCTURAL CONCRETE, ROADWAY AND SIDEWALK SLAB ON STEEL BRIDGE	CY		13						<del>                                     </del>	13
	BRIDGE DRAIN GRATE MODIFCATIONS	EA		2				2	4		8
03.14	EPOXY-COATED REINFORCING STEEL, FABRICATED AND DELIVERED	LB		17,215							17,215
	EPOXY-COATED REINFORCING STEEL, PLACING	LB		17,215							17,215
	SYNTHETIC FIBER REINFORCEMENT	LB		20						25	25
	ALUMINUM BRIDGE RAILING - RAIL SECTION REPLACE ALUMINUM BRIDGE RAILING - SPLICE MODIFICATION	LF EA		20 32				20	36		20 88
	HIGH PERFORMANCE WATERPROOFING MEMBRANE (2765 SY)			0.47				0.20	0.33		1
	COFFERDAM	EA	2		2			0.20			4
5.201	PIGMENTED PROTECTIVE COATING FOR CONCRETE SURFACES	SY		675				275	405		1,355
	CLEAR PROTECTIVE COATING FOR CONCRETE SURFACES	SY		890				470	755	150	2,265
	EPOXY OVERLAY	SY	105		405			25		12	12
	ABUTMENT REPAIRS PIER REPAIRS	SF SF	125	520 1,155	125			35 220	10 730		815 2,105
	EPOXY INJECTION CRACK REPAIR	LF	125	40	275			220			445
	PARAPET JOINT REPAIRS	 LF	,	580	2.0			325	545		1,450
18.71	REPAIR OF OVERHEAD SURFACES < 8 INCHES	SF						75			75
	FASCIA AND OVERHANG REPAIRS	SF							500		500
	PARTIAL DEPTH CONCRETE DECK REPAIRS	SF		85				75	110		270
	FULL DEPTH CONCRETE DECK REPAIRS  EXPANSION DEVICE - GLAND SEAL	SF EA		2				5	5		15 2
	EXPANSION DEVICE MODIFICATIONS (WEBSTER ROAD)	EA						2			2
	EXPANSION DEVICE MODIFICATIONS (PLAINS ROAD)	EA						_	2		2
23.522	BEARING BOLSTERS & SPACER PLATES, FABRICATED AND DELIVERED	LS		1							1
	BEARING BOLSTERS & SPACER PLATES, INSTALLED	LS		1							1
	JACKING EXISTING SUPERSTRUCTURE	LS	0.10	1 0.31	0.10	0.10	0.10	0.09	0.09		1
	TEMPORARY CONCRETE BARRIER, TYPE 1 - SUPPLIED BY THE AUTHORITY WORK ZONE CRASH CUSHIONS - TL-3	LS UNIT	0.12	0.31	0.12	0.18 2	0.12	0.08	0.08		14
	WORK ZONE CRASH CUSHIONS - TL-3 WORK ZONE CRASH CUSHIONS - TL-2	UNIT		2			۷				2
	15 INCH CULVERT PIPE OPTION III	LF		<del>_</del>		150					150
03.55	CONCRETE PIPE TIES	GP					18				18
	PRESSURE TREATED WOOD DRAIN TROUGH	LF		80							80
	31" W-BEAM GUARDRAIL - MID-WAY SPLICE (STEEL POST, 8" OFFSET BLOCKS, SINGLE FACED)	LF		450		82					532
	31" W-BEAM GUARDRAIL - MID-WAY SPLICE (STEEL POST, 8" OFFSET BLOCKS, 15' RADIUS AND LESS) 31" W-BEAM GUARDRAIL - MID-WAY SPLICE (STEEL POST, 8" OFFSET BLOCKS, OVER 15' RADIUS)	LF LF	+	25		19 46					19 71
	31" W-BEAM GUARDRAIL - MID-WAY SPLICE (STEEL FOST, 6" OF TSET BEOCKS, "OVER 15 NADIOS)  31" W-BEAM GUARDRAIL - MID-WAY SPLICE FLARED TERMINAL (31" HEIGHT)	EA		1		,,					1
	TERMINAL END - ANCHORED END - 31" W-BEAM GUARDRAIL	EA		1		3					4
	BRIDGE TRANSITION - TYPE III	EA		4							4
	REFLECTORIZED FLEXIBLE GUARDRAIL MARKER	EA		6		3					9
	GUARDRAIL - REMOVE AND STACK OR DISPOSE	LF 1 =		590		179					769 130
	WOVEN WIRE FENCE - METAL POSTS  CHAIN LINK FENCE - 6 FOOT	LF LF	+	350		130		285	260		130 895
	CHAIN LINK FENCE GATE	EA	+	2				2	2		6
	AUTOMATIC ENTRY GATE SYSTEM	LS		<del>_</del>		1			<del>_</del>		1
7.32	BRACING ASSEMBLY TYPE I - METAL POSTS	EΑ				8					8
	BRACING ASSEMBLY TYPE II - METAL POSTS	EA				2					2
	BRACING ASSEMBLY CHAIN LINK FENCE	EA		16				16	16		48
	CONCRETE CURB TYPE 2 PLAIN RIPRAP	LF CY	+	60 20		6					60 26
, 0.00	EROSION CONTROL BLANKET	SY		550		840					1,390

ROUTE 26 EARTHWORK SUMMARY							
COMMON EXCAVATION FOR ESTIMATE		-					
COMMON EXCAVATION (FROM CROSS SECTIONS)	)				220		
COMMON EXCAVATION (FROM BRIDGE)	/				93		
GRUBBING IN FILL					21		
PAVEMENT SALVAGE IN FILL					36		
TOTAL COMMON EXCAVATION (for estimate)							37
,							
FILL FOR BORROW CALCULATIONS							
COMMON FILL (FROM CROSS SECTIONS)					74		
GRUBBING IN FILL					21		
PAVEMENT SALVAGE IN FILL					36		
TOTAL FILL							13
AVAILABLE COMMON EXCAVATION FOR BORROW	CALCUL	ΑT	IONS				
(1) TOTAL COMMON EXCAVATION							37
DEDUCTIONS:							
GRUBBING IN CUT					33		
GRUBBING IN FILL					21		
PAVEMENT SALVAGE (CUT & FILL)					151		
(2) TOTAL DEDUCTIONS							20
TOTAL AVAILABLE COMMON EXCAVATION (1) N	MINUS (2)						16
RIPRAP EXCAVATION (1/2 USABLE)							1
TOTAL AVAILABLE NON-ROCK EXCAVATION							17
COMPUTATION OF WASTE STORAGE & WASTE MA	TERIAL						
TOTAL AVAIL. WASTE STORAGE AREA (FROM C	CROSS SE	ΞC	CHONS	S)			
GRUBBING IN CUT					33		
GRUBBING IN FILL					21		
RIPRAP EXCAVATION (1/2 WASTE)					10		
TOTAL WASTE MATERIAL TO BE UTILIZED (LOW		T	AL AV	'AIL	ABLE		
WASTE STORAGE AREA OR TOTAL WASTE MA	TERIAL)						
TOTAL WASTE MATERIAL TO BE WASTED (TOTAL	AL WAST	<u> </u>	MATE	RIAL	_ MINUS		
TOTAL WASTE MATERIAL TO BE UTILIZED)							6
		H					
COMPUTATION OF GRANULAR BORROW FOR ESTI	MATF						
GRANULAR BORROW FOR BRIDGE					108		
GRANULAR BORROW =						x 1.00 =	10
COMPUTATION FOR COMMON BORROW FOR ESTIM	MATE						
(3)TOTAL FILL							13
TOTAL AVAIL. NON-ROCK EXCAV.	174	Х	0.90	=	156		
TOTAL AVAIL. ROCK EXCAV.	0	Х	1.30	=	0		
TOTAL AVAIL. STR. ROCK EXCAV.	0	х	1.30	=	0		
TOTAL WASTE MATERIAL TO BE UTILIZED	0	х	1.10	=	0		
(4)TOTAL AVAILABLE EXCAVATION							15
BORROW NEEDED = TOTAL FILL MINUS TOTAL	L AVAILA	Βl	EEX	C۸۱	/ATION		-2
IF NO BORROW IS NEEDED, SURPLUS MATERIAL = A	VAILABLE	ΞΕ	EXCA'	VAT	ION MINUS		
TOTAL FILL, PLUS TOTAL WASTE MATERIAL TO BE W	VASTED						9

NOT TO SCALE Revision

By Date

Designed

 By
 Date

 DSM
 1/2019

 DSM
 1/2019

T-Y-LININTERNATIONAL CONSULTANT PROJECT MANAGER: DanielS. Myers

By Date
Checked KSD 1/2019
In Charge of DSM 1/2019

T.Y. Lin International 12 Northbrook Drive Building A, Suite One Falmouth, Maine 04105 TEL: (207) 781-4721 FAX: (207) 781-4753



## THE GOLD STAR MEMORIAL HIGHWAY

## NORTHERN BRIDGE REPAIRS & BENNETT ROAD EMERGENCY VEHICLE RAMPS

ESTIMATED QUANTITIES SHEET 1 OF 2

CONTRACT:2019.11

SHEET NUMBER: QT-01

MTA PROJECT MANAGER: Ralph C. Norwood, IV

							Quantities					В
Item No.	Item Description	Unit	Mile 62.3 Pleasant River Culvert	Mile 64.3 Route 26 Underpass	Mile 65.25 Cole Brook Culvert	Mile 68.6 Bennett Road EVR	Mile 72.9 Foster Brook Culvert	Mile 82.7 Webster Road Underpass	Mile 95.6 Plains Road Underpass	Mile 67.0 New Gloucester Toll Plaza	Total Quantity	С
615.07	LOAM	CY		70		330					400	
618.14	SEEDING METHOD NUMBER 2	UNIT		6		27					33	
619.1201	MULCH - PLAN QUANTITY	UNIT		1		27					28	FI
619.1301	BARK MULCH	CY		40				30	35		105	
620.58	EROSION CONTROL GEOTEXTILE	SY		15		19					34	
620.625	CELLULAR CONFINEMENT SYSTEM	SY		350							350	
621.037	EVERGREEN TREE (5'-6') GROUP GP A	EA				10					10	
626.12	QUAZITE JUNCTION BOX	EA				4					4	
626.22	NON-METALLIC CONDUIT	LF				760					760	
626.223	HORIZONTAL DIRECTIONAL DRILLED CONDUIT	LF				330					330	
627.712	WHITE OR YELLOW PAINTED PAVEMENT MARKING LINE	LF		2,150				860	1,500		4,510	
627.752	TEMPORARY WHITE OR YELLOW PAVEMENT AND CURB MARKING	SF		36							36	_
627.77	REMOVING PAVEMENT MARKINGS	SF		720							720	
627.78	TEMPORARY PAVEMENT MARKING LINE, WHITE OR YELLOW	LF		5,850				1,750	2,950		10,550	
629.05	HAND LABOR - STRAIGHT TIME	HR		40		20					60	
631.12	ALL PURPOSE EXCAVATOR (INCLUDING OPERATOR)	HR		20		10					30	
631.172	TRUCK-LARGE (INCLUDING OPERATOR)	HR		40		20					60	_  _
631.32	CULVERT CLEANER (INCLUDING OPERATOR)	HR		5							5	
631.36	FOREMAN	HR		20		10					30	
639.19	FIELD OFFICE, TYPE B	EA	0.03	0.43	0.04	0.18	0.02	0.10	0.18	0.02	1	_
643.72	TEMPORARY TRAFFIC SIGNAL	LS		1							1	
645.106	DEMOUNT REGULATORY, WARNING, CONFIRMATION AND ROUTE MARKER ASSEMBLY SIGN	EA		3		7					10	
645.116	REINSTALL REGULATORY, WARNING, CONFIRMATION AND ROUTE MARKER ASSEMBLY SIGN	EA		3		7					10	
645.271	REGULATORY, WARNING, CONFIRMATION AND ROUTE MARKER ASSEMBLY SIGN, TYPE I	SF		18		27					45	
652.30	FLASHING ARROW BOARD	EA	2	2	2	2	2	2	2		14	
652.312	TYPE III BARRICADE	EA		2				3	4	2	11	
	DRUM	LS	0.14	0.12	0.14	0.12	0.14	0.14	0.14	0.07	1	_
652.34	CONE	EA								15	15	
652.35	CONSTRUCTION SIGNS	SF	1,200	1,850	1,200	1,200	1,200	1,350	1,550	64	9,614	_
652.361	MAINTENANCE OF TRAFFIC CONTROL DEVICES	LS	0.06	0.38	0.06	0.13	0.06	0.13	0.13	0.05	1	╝
652.38	FLAGGERS	HR		430		580					1,010	
652.41	PORTABLE-CHANGEABLE MESSAGE SIGN	EA		2		2		2	2		8	
652.45	TRUCK MOUNTED ATTENUATOR	CD	4	4	4	6	4	14	14		50	
652.451	AUTOMATED TRAILER MOUNTED SPEED LIMIT SIGN	CD	4	4	4	2	4	14	14		46	
652.46	TEMPORARY PORTABLE RUMBLE STRIPS	UNIT	12	12	12	18	12	42	42		150	
655.04	INSTALLATION OF SENSOR LOOPS	LS								1	1	С
	BALED HAY, IN PLACE	EA	10	50	20	100	10	20	30		240	
656.60	TEMPORARY BERMS	LF	10	40	10	80	10	40	40		230	
656.62	TEMPORARY SLOPE DRAINS	LF	10	40	10	80	10	40	40		230	
	30 INCH TEMPORARY SILT FENCE	LF	100	630	160	1,950	150	100	240		3,330	
659.10	MOBILIZATION	LS	0.03	0.43	0.04	0.18	0.02	0.10	0.18	0.02	1	

BENNETT ROAD EARTHWORK SUMMARY						
COMMON EXCAVATION FOR ESTIMATE						
COMMON EXCAVATION (FROM CROSS SECTIONS	3)				413	
EARTH FROM DRIVES, OLD ROAD, ETC.					1	
CULVERT INLET AND OUTLET DITCHES					15	
PAVEMENT SALVAGE IN FILL					61	
TOTAL COMMON EXCAVATION (for estimate)						489
FILL FOR BORROW CALCULATIONS						
COMMON FILL (FROM CROSS SECTIONS)					200	
PAVEMENT SALVAGE IN FILL (OFF ROAD ONLY)					5	
TOTAL FILL						205
TOTALTIEL						200
AVAILABLE COMMON EXCAVATION FOR BORROW	/ CALCIII.	ΔΤ	IONS	1		
AVAILABLE COMMON EXCAVATION FOR BORROW	OALOUL	7		,		
(1) TOTAL COMMON EXCAVATION						489
DEDUCTIONS:						100
GRUBBING IN CUT					87	
GRUBBING IN CUT					0	
					70	
PAVEMENT SALVAGE (CUT & FILL)					70	457
(2) TOTAL DEDUCTIONS						157
TOTAL ANAMARIE COMMONENCANATION (4)	N 41N 11 10 (0)					000
TOTAL AVAILABLE COMMON EXCAVATION (1)	MINUS (2)					332
RIPRAP EXCAVATION (1/2 USABLE)						3
TOTAL AVAILABLE NON-ROCK EXCAVATION	١					334
COMPUTATION OF WASTE STORAGE & WASTE MA	ATERIAL					
	000000					
TOTAL AVAIL. WASTE STORAGE AREA (FROM	CROSS SE	-C	HON	S)		0
GRUBBING IN CUT					87	
GRUBBING IN FILL					0	
RIPRAP EXCAVATION (1/2 WASTE)					3	
TOTAL WASTE MATERIAL TO BE UTILIZED (LOV	<b>NER OF TO</b>	T	4L A\	/AIL	ABLE	
WASTE STORAGE AREA OR TOTAL WASTE MA	ATERIAL)					0
TOTAL WASTE MATERIAL TO BE WASTED (TO	TAL WAST	Ē١	MATE	RIA	L MINUS	
TOTAL WASTE MATERIAL TO BE UTILIZED)						90
COMPUTATION FOR COMMON BORROW FOR EST	IMATE					
COMPUTATION FOR COMMON BORROW FOR EST	IMATE					
	IMATE					205
(3)TOTAL FILL	IMATE					205
(3)TOTAL FILL		X	0.90		301	205
(3)TOTAL FILL  TOTAL AVAIL. NON-ROCK EXCAV.	334	_	0.90		301	205
(3)TOTAL FILL  TOTAL AVAIL. NON-ROCK EXCAV.  TOTAL AVAIL. ROCK EXCAV.	334	х	1.30	=	0	205
(3)TOTAL FILL  TOTAL AVAIL. NON-ROCK EXCAV.  TOTAL AVAIL. ROCK EXCAV.  TOTAL AVAIL. STR. ROCK EXCAV.	334	X X	1.30 1.30	=	0	205
(3)TOTAL FILL  TOTAL AVAIL. NON-ROCK EXCAV.  TOTAL AVAIL. ROCK EXCAV.	334	X X	1.30	=	0	205
(3)TOTAL FILL  TOTAL AVAIL. NON-ROCK EXCAV. TOTAL AVAIL. ROCK EXCAV. TOTAL AVAIL. STR. ROCK EXCAV. TOTAL WASTE MATERIAL TO BE UTILIZED	334	X X	1.30 1.30	=	0	
(3)TOTAL FILL  TOTAL AVAIL. NON-ROCK EXCAV. TOTAL AVAIL. ROCK EXCAV. TOTAL AVAIL. STR. ROCK EXCAV. TOTAL WASTE MATERIAL TO BE UTILIZED  (4)TOTAL AVAILABLE EXCAVATION	334 0 0	X X X	1.30 1.30 1.10	= = =	0 0 0	301
(3)TOTAL FILL  TOTAL AVAIL. NON-ROCK EXCAV. TOTAL AVAIL. ROCK EXCAV. TOTAL AVAIL. STR. ROCK EXCAV. TOTAL WASTE MATERIAL TO BE UTILIZED	334 0 0	X X X	1.30 1.30 1.10	= = =	0 0 0	
(3)TOTAL FILL  TOTAL AVAIL. NON-ROCK EXCAV. TOTAL AVAIL. ROCK EXCAV. TOTAL AVAIL. STR. ROCK EXCAV. TOTAL WASTE MATERIAL TO BE UTILIZED  (4)TOTAL AVAILABLE EXCAVATION BORROW NEEDED = TOTAL FILL MINUS TOTAL	334 0 0 0 AL AVAILA	x x x	1.30 1.30 1.10	= = = (CA)	0 0 0	301
(3)TOTAL FILL  TOTAL AVAIL. NON-ROCK EXCAV. TOTAL AVAIL. ROCK EXCAV. TOTAL AVAIL. STR. ROCK EXCAV. TOTAL WASTE MATERIAL TO BE UTILIZED  (4)TOTAL AVAILABLE EXCAVATION	334 0 0 0 AL AVAILA	x x x	1.30 1.30 1.10	= = = (CA)	0 0 0	301

S	cale:				Designed b	y:				
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N :	0.	Revision	Ву	Date	]					
, 					CONSULTANT	PROJEC	T MANAGER:	Daniel S. Myers		
						Ву	Date		Ву	Date
2					Designed	DSM	1/2019	Checked	KSD	1/2019
					Drawn	DSM	1/2019	In Charge of	DSM	1/2019

T.Y. Lin International
12 Northbrook Drive
Building A, Suite One
Falmouth, Maine 04105
TEL: (207) 781-4721
FAX: (207) 781-4753



# THE GOLD STAR MEMORIAL HIGHWAY

# NORTHERN BRIDGE REPAIRS & BENNETT ROAD EMERGENCY VEHICLE RAMPS

ESTIMATED QUANTITIES SHEET 2 OF 2

CONTRACT:2019.11

SHEET NUMBER: QT-02

MTA PROJECT MANAGER: Ralph C. Norwood, IV

- IN AREAS OF PROPOSED PIPE ENTRY GATES AND NEW FENCE. EXISTING CHAIN LINK OR WIRE FENCE SHALL BE REMOVED. REMOVING AND DISPOSING OF EXISTING FENCE SHALL BE INCIDENTAL TO PIPE ENTRY AND PROPOSED FENCE BID ITEMS. PROPOSED FENCE AND PIPE ENTRY GATE SHALL BE INSTALLED CONTINUOUSLY WITH NO GAPS. TO ACCOMMODATE THE REVISED GRADING OF THE EMERGENCY VEHICLE RAMP, WOVEN WIRE FENCE MAY NEED TO BE CUT OR ADDITIONAL POSTS, BRACING ASSEMBLIES, OR FABRIC MAY NEED TO BE INSTALLED. ALL WORK SHALL BE DONE IN COFNORMANCE WITH MAINEDOT STANDARD SPECIFICATIONS. REVISION 2014, SECTION 607 AND MAINE DOT STANDARD DETAILS. REVISION 2014, SECTION 607.
- CONNECTION FOR PROPOSED FENCE TO EXISTING FENCE SHALL BE INCIDENTAL TO THE CONTRACT INCLUDING ANY REQUIRED ADDITIONAL BRACING FOR THE EXISTING FENCE.
- NO SEPARATE PAYMENT FOR SUPERINTENDENT OR FOREMAN WILL BE MADE FOR THE SUPERVISION OF EQUIPMENT BEING PAID FOR UNDER THE EQUIPMENT RENTAL ITEMS.
- 6. THE CONTRACTOR SHALL NOTE THAT THE ACTUAL EXISTING PAVEMENT THICKNESS MAY VARY FROM THE DEPTHS SHOWN ON THE PLANS, REMOVAL OF EXISTING PAVEMENT SHALL BE PAID AS COMMON EXCAVATION.
- ALL NEW UNDERGROUND ELECTRICAL SERVICE LINES FOR THE NEW BENNETT ROAD NORTHBOUND AND SOUTHBOUND EVR ACCESS GATES WILL CONSIST OF 3-I" CONDUITS. THE HORIZONTAL DIRECTIONAL DRILLING LOCATION NOTED ON THE PLANS UNDER THE MAINE TURNPIKE WILL BE 3 INDIVIDUAL DRILLINGS TO ACCOMMODATE 3 INDIVIDUAL CONDUITS.
- 8. TEN (10) EVERGREEN TREES SHALL BE PLANTED ALONG THE BENNETT ROAD NORTHBOUND EMERGENCY VEHICLE RAMP FOR THE GENERAL PURPOSE OF REPLACING TREES REMOVED IN FRONT OF THE ABUTTING GUAY PROPERTY DURING CONSTRUCTION. THE LOCATION OF THE NEW TREES TO BE PLANTED SHALL BE AT THE DIRECTION OF THE RESIDENT AND WILL BE PAID FOR UNDER ITEM 621.037 - EVERGREEN TREE (5'-6') GP A.

#### **EARTHWORK**

- CLEARING LIMITS SHALL BE 10' BEYOND AND PARALLEL TO THE CONSTRUCTION SLOPE LINES OR AS SHOWN ON THE PLANS UNLESS OTHERWISE AUTHORIZED BY THE RESIDENT. THE ACTUAL CLEARING LINES SHALL BE ESTABLISHED IN THE FIELD BY THE CONTRACTOR AND SHALL BE APPROVED BY THE RESIDENT PRIOR TO AND CLEARING TAKING PLACE. ALL CLEARING SHALL BE CONSIDERED INCIDENTAL TO THE CONTRACT.
- ALL STUMPS WITHIN THE EVR CLEARING LIMITS SHALL BE REMOVED. THE AREA RE-GRADED, LOAMED, AND SEEDED, STUMP REMOVAL SHALL BE INCIDENTAL TO CLEARING. STUMPS ON BENNETT ROAD EMBANKMENT SHALL BE CUT FLUSH WITH THE EMBANKMENT LEAVING THE ROOT STRUCTURE INTACT. GRUBBING FROM EVR CONSTRUCTION SHOULD BE USED ON THE EMBANKMENT TO CREATE A SMOOTH SURFACE. THE EMBANKMENT AREA SHOULD THEN BE SEEDED AND COVERED WITH EROSION CONTROL BLANKET. THE REMAINING GRUBBINGS SHALL BE USED AS LOAM BETWEEN THE EVR AND BENNETT ROAD TOES OF SLOPE.
- 3. MUCK EXCAVATION HAS BEEN ESTIMATED FOR ALL WETLAND AREAS AT A I'DEPTH BELOW NORMAL GRUBBING. THE CONTRACTOR SHALL CONFIRM WITH THE RESIDENT THE ACTUAL LIMITS AND DEPTH BEFORE PLACING ANY AGGREGATE.
- 4. THE GRUBBING DEPTH HAS BEEN ESTIMATED AS 6" (12" IN WOODED AND WETLAND AREAS).
- 5. WASTE MATERIALS SHALL BE DISPOSED OF OFF THE PROJECT SITE. IN ACCORDANCE WITH CHAPTER 404. DEPARTMENT OF ENVIRONMENTAL PROTECTION SOLID WASTE MANAGEMENT RULES.
- EXCAVATIONS ACCOMPLISHED AS PART OF THIS PROJECT SHALL BE CONSTRUCTED IN ACCORDANCE WITH OSHA SUBPART P OF 29 CFR PAR 1926.650-652 (CONSTRUCTION STANDARDS FOR EXCAVATION).
- 7. EXISTING INSLOPES STEEPER THAN 2:1 IN PROPOSED FILL AREAS SHALL BE BENCHED AS DIRECTED BY THE RESIDENT.
- 8. FILL/BORROW SHALL BE COMPACTED TO 90% OF ITS MAXIMUM DRY DENSITY AS DETERMINED BY THE MODIFIED PROCTOR, EXCEPT AS AMENDED BY SPECIAL PROVISION 203. GRANULAR BORROW, AGGREGATE BASE, AND AGGREGATE SUBBASE SHALL BE COMPACTED TO 98% OF THEIR MAXIMUM DRY DENSITY AS DETERMINED BY THE MODIFIED PROCTOR FOR AREAS OF BACKFILL MATERIAL BEHIND ABUTMENTS AND RETAINING WALLS, EXCEPT AS AMENDED BY SPECIAL PROVISION 203. GRANULAR BORROW. AGGREGATE BASE, AND AGGREGATE SUBBASE SHALL BE COMPACTED TO 95% IN ALL OTHER AREAS.

### EROSION CONTROL

- THE ANTICIPATED EROSION CONTROL DEVICES ARE SHOWN ON THE PLANS, THE CONTRACTOR SHALL PROPOSE ACTUAL TYPE AND LOCATION OF DEVICES FOR APPROVAL BY THE RESIDENT. ADDITIONAL MEASURES MAY BE PROPOSED BY THE CONTRACTOR DUE TO SITE OR WEATHER CONDITIONS. THE RESIDENT MAY DIRECT THE CONTRACTOR TO IMPLEMENT ADDITIONAL MEASURES. ANY ADDITIONAL MEASURES APPROVED BY THE RESIDENT WILL BE MEASURED FOR PAYMENT.
- 2. 4" LOAM HAS BEEN ESTIMATED FOR 100% OF THE DISTURBED SLOPE AREA UNLESS OTHERWISE SPECIFIED ON THE PLANS. ACTUAL PLACEMENT OF THE LOAM SHALL BE AS DESIGNATED BY THE RESIDENT. GRUBBINGS FROM THE EVR CONSTRUCTION SHALL BE USED ON THE BENNETT ROAD EMBANKMENT: SEE EARTHWORK
- 3. ALL SLOPES SHALL BE SEEDED WITH SEEDING METHOD NO. 2.
- 4. MULCH SHALL BE APPLIED IN AREAS SEEDED EXCEPT WHERE EROSION CONTROL BLANKET IS SPECIFIED.
- 5. ALL TEMPORARY AND PERMANENT EROSION CONTROL DEVICES SHALL BE INSTALLED IN ACCORDANCE WITH THE MAINE DEPARTMENT OF TRANSPORTATION BEST MANAGEMENT PRACTICES.
- EROSION CONTROL BLANKET SHALL BE INSTALLED IN ALL DITCHES AND 2: SLOPES FROM TOP TO TOE OF SLOPE, LOAM AND SEED SHALL BE PLACED PRIOR TO THE INSTALLATION OF THE EROSION CONTROL BLANKET. LIMITS OF THE EROSION CONTROL BLANKET IN DITCHES SHALL BE 6'WIDE OR AS DESIGNATED BY THE RESIDENT.
- CELLULAR CONFINEMENT SYSTEM SHALL BE USED ON ALL SLOPES STEEPER THAN 2: AND SHALL BE INSTALLED PER THE SPECIAL

### *DRAINAGE*

- I. NO EXISTING DRAINAGE SHALL BE ABANDONED, REMOVED, OR PLUGGED WITHOUT PRIOR APPROVAL OF THE RESIDENT.
- 2. INLETS AND OUTLETS OF ALL CULVERTS SHALL BE RIPRAPPED UNLESS OTHERWISE NOTED ON THE PLANS OR DIRECTED BY THE RESIDENT.
- 3. ALL DITCH ELEVATIONS AND OFFSETS SHOWN ON THE CROSS SECTIONS ARE FOR THE FINISHED DITCH FLOW LINE.
- IF FOUNDATION MATERIAL IS REQUIRED UNDER CULVERTS, IT SHALL MEET THE REQUIREMENTS FOR GRANULAR BORROW - UNDERWATER BACKFILL.

### *LOCAL ROAD*

I. ALL JOINTS BETWEEN EXISTING AND PROPOSED BITUMINOUS PAVEMENT SHALL BE BUTTED. PAYMENT SHALL BE MADE UNDER THE APPROPRIATE CONTRACT PAY ITEMS.

### GUARDRAIL

- GUARDRAIL END TREATMENTS SHALL BE INSTALLED CONCURRENTLY WITH THE PLACEMENT OF EACH SECTION OF BEAM GUARDRAIL. AT THE END OF THE WORK DAY, EVERY DAY, THE CONTRACTOR IS REQUIRED TO HAVE AN APPROVED CRASHWORTHY END TREATMENT ON ALL GUARDRAIL WITHIN ALL WORK AREAS.
- CONNECTIONS FOR PROPOSED GUARDRAIL TO EXISTING GUARDRAIL SHALL BE INCIDENTAL TO THE GUARDRAIL ITEM.
- 3. ALL EXISTING GUARDRAIL TO BE REMOVED SHALL BECOME THE PROPERTY OF THE CONTRACTOR, REMOVAL AND DISPOSAL SHALL BE CONSIDERED INCIDENTAL TO THE GUARDRAIL ITEMS.
- 4. POST HOLES FROM GUARDRAIL REMOVED SHALL BE FILLED AND COMPACTED WITH TYPE D GRAVEL. PAYMENT FOR FILLING HOLES SHALL BE CONSIDERED INCIDENTAL TO THE GUARDRAIL ITEMS.
- 5. TWO REFLECTORIZED FLEXIBLE GUARDRAIL MARKERS (ITEM 606.353) WILL BE INSTALLED AT EACH GUARDRAIL END TREATMENT.
- FOR ALL NEW GUARDRAIL TYPES "31" W-BEAM GUARDRAIL MID-WAY SPLICE" AND THRIE-BEAM SINGLE RAIL. OFFSET BLOCKS SHALL BE NON-WOOD CONFORMING TO NCHRP 350 TEST LEVEL 3.

#### UTILITY

- ALL UTILITY FACILITIES SHALL BE ADJUSTED BY THE RESPECTIVE UTILITIES UNLESS OTHERWISE NOTED.
- 2. EXISTING UTILITIES ON THESE PLANS WERE COMPILED FROM FIELD SURVEY AND VARIOUS OTHER SOURCES. LOCATIONS ARE NOT GUARANTEED TO BE ACCURATE NOR IS IT GUARANTEED THAT ALL UTILITIES ARE SHOWN, NO SEPARATE OR ADDITIONAL COMPENSATION WILL BE ALLOWED TO THE CONTRACTOR DUE TO ANY VARIANCE BETWEEN THE DATA SHOWN ON THE PLANS AND THE ACTUAL FIELD CONDITIONS ENCOUNTERED, NO WORK SHALL BE STARTED UNTIL THE OWNERS OF THE VARIOUS UTILITIES ARE NOTIFIED BY THE CONTRACTOR OF THE PROPOSED CONSTRUCTION. THE CONTRACTOR IS ALSO REQUIRED TO CALL DIG SAFE AT I-888-344-7233 AT LEAST 72 HOURS PRIOR TO THE START OF THE WORK.
- 3. THE CONTRACTOR SHALL NOTIFY THE RESIDENT 10 DAYS PRIOR TO CONSTRUCTION SO THE RESIDENT CAN ARRANGE FOR MAINE TURNPIKE UNDERGROUND UTILITY LOCATION. ALL PROPOSED SIGN LOCATIONS AND EXCAVATION LOCATIONS SHALL BE MARKED AT THE NOTIFICATION TIME. EXCAVATING WILL NOT BE PERMITTED UNTIL THE AUTHORITY HAS LOCATED AND MARKED ITS UNDERGROUND UTILITIES.OR NOTIFIED THE RESIDENT THAT THERE ARE NO UNDERGROUND UTILITIES IN THE MARKED AREAS.
- THE AUTHORITY HAS PROGRAMMED TWO FIELD VISITS FOR MAINE TURNPIKE UTILITY COORDINATION ON THIS PROJECT, SHOULD THE CONTRACTOR NEED ADDITIONAL SIGN LOCATIONS AND/OR ADDITIONAL EXCAVATION LOCATIONS MARKED, OR SHOULD THE CONTRACTOR FAIL TO MAINTAIN THE AUTHORITY'S PREVIOUSLY ESTABLISHED DIG SAFE MARKS, THE AUTHORITY SHALL DEDUCT THE ADDED MARKING COSTS FROM THE CONTRACTOR'S PAYMENTS.

Scale: Designed by: NOT TO SCALE T-Y-LININTERNATIONAL Revision By Date CONSULTANT PROJECT MANAGER: DanielS. Myers Ву Date Date BLT 6/2018 TSK 1/2019 Checked Designed In Charge of DSM 6/2018

T.Y. Lin International 12 Northbrook Drive Building A, Suite One Falmouth, Maine 04105 TEL: (207) 781-4721 FAX: (207) 781-4753



THE GOLD STAR MEMORIAL HIGHWAY

NORTHERN BRIDGE REPAIRS & BENNETT ROAD EMERGENCY VEHICLE RAMPS

GENERAL NOTES

CONTRACT: 2019.11

SHEET NUMBER: GN-01

MTA PROJECT MANAGER: Ralph C. Norwood, IV

### <u>DESIGN</u>

**SPECIFICATIONS:** 

AASHTO LRFD BRIDGE DESIGN SPECIFICATIONS 8TH EDITION WITH INTERIMS THROUGH 2018.

#### <u>CONSTRUCTION</u>

STATE OF MAINE, DEPARTMENT OF TRANSPORTATION STANDARD SPECIFICATIONS NOVEMBER, 2014

STATE OF MAINE DEPARTMENT OF TRANSPORTATION STANDARD DETAILS, NOVEMBER 2014, WITH LATEST REVISIONS

AASHTO LRFD BRIDGE CONSTRUCTION SPECIFICATIONS, THIRD EDITION WITH 2016 INTERIMS

### DESIGN LOADING:

LIVE LOAD HL-93

### MATERIALS:

### <u>CONCRETE</u>

CONCRETE END POSTS, WINGWALLS AND ABUTMENT BACKWALLS SHALL BE CLASS AAA.

ALL OTHER PATCHING AND REPAIR AREAS SHALL BE CLASS AAA-MODIFIED.

#### <u>REINFORCING STEEL</u>

AASHTO M31, GRADE 60 EPOXY-COATED.

### BASIC DESIGN STRESSES:

### <u>CONCRETE</u>

CLASS AAA,  $f'_c$  = 4,500 P.S.I. CLASS AAA - MODIFIED,  $f'_c$  = 4,500 P.S.I.

### REINFORCING STEEL

 $f_{\rm v}$  = 60,000 P.S.I.

### **GENERAL NOTES:**

- I. THE PROPOSED ELEVATIONS ARE BASED ON THE NAVD 88 DATUM. THE AS-BUILT PLANS ARE BASED ON NGVD 29 DATUM.
- 2. FOR ADDITIONAL DETAILS REFERENCED OR NOT SHOWN IN THESE DRAWINGS, SEE THE STATE OF MAINE, DEPARTMENT OF TRANSPORTATION STANDARD DETAILS, HIGHWAYS AND BRIDGES, NOVEMBER 2014 WITH UPDATES.
- 3. COPIES OF THE AS-BUILT PLANS ARE ON FILE AND ARE AVAILABLE ON THE MAINE TURNPIKE AUTHORITY WEBSITE. THE COMPLETENESS AND ACCURACY OF THESE PLANS IS NOT GUARANTEED.
- 4. REINFORCING STEEL SHALL HAVE A CLEAR COVER OF 2" MIN., UNLESS OTHERWISE NOTED.
- 5. CHAMFER ALL EXPOSED CONCRETE EDGES 3/4" UNLESS OTHERWISE
- 6. ALL PROPOSED CONCRETE CURB FACES AND INSIDE AND TOP FACES OF THE ENDPOSTS SHALL RECEIVE A RUBBED FINISH PRIOR TO THE APPLICATION OF THE CLEAR PROTECTIVE COATING FOR CONCRETE SURFACE.
- 7. SHIELDING REQUIRED DURING CONSTRUCTION SHALL NOT PROJECT BELOW THE BOTTOM FLANGES OF GIRDERS.
- 8. ALL PAINT ON EXISTING STEEL, DAMAGED BY CONTRACTOR'S OPERATIONS, SHALL BE REPAIRED TO THE SATISFACTION OF THE RESIDENT AT THE CONTRACTOR'S EXPENSE. THE CONTRACTOR SHALL NOTE THAT THE EXISTING BRIDGE STRUCTURES CONTAIN LEAD BASED PAINT. THE CONTRACTOR SHALL INSTITUTE EVERY PRECAUTION WHEN WORKING WITH MATERIALS COATED WITH LEAD PAINT.
- 9. WHERE DRILLING AND ANCHORING OF REINFORCING STEEL IS SPECIFIED THE CONTRACTOR SHALL USE A MATERIAL LISTED ON THE MAINEDOT PREQUALIFIED LIST OF CHEMICAL ANCHORING MATERIALS. THE DEPTH OF EMBEDMENT SHALL BE SUFFICIENT TO DEVELOP 125% OF THE YIELD STRENGTH OF THE BAR, BUT SHALL BE NO LESS THAN THE MINIMUM DEPTH OF EMBEDMENT WHEN SPECIFIED. WHERE MINIMUM EMBEDMENT DEPTH HAVE NOT BEEN SPECIFIED, BAR LENGTHS HAVE BEEN DEVELOPED BASED ON AN ASSUMED EMBEDMENT DEPTH OF 9" FOR #5 BARS AND II" FOR #6 BARS. THE CONTRACTOR SHALL VERIFY THE REQUIRED DEPTH OF EMBEDMENT AND ADJUST THE REQUIRED BAR LENGTHS AS REQUIRED.
- IO. PAYMENT FOR DRILLING AND ANCHORING OF REINFORCING STEEL IS INCIDENTAL TO ITEM 503.15, EPOXY-COATED REINFORCING STEEL, PLACING.

### CONCRETE REPAIR PROCEDURAL NOTES:

- I. CONCRETE REPAIRS, INCLUDING THE ASSOCIATED REMOVALS, WILL BE PAID UNDER 518 ITEMS.
- 2. ANY REINFORCING STEEL REQUIRED TO REPLACE DETERIORATED EXISTING REINFORCEMENT SHALL BE EPOXY COATED AND WILL BE INCIDENTAL TO 518 ITEMS.

### REMOVAL PROCEDURE:

- I. CONTRACTOR SHALL REMOVE TECTYL COATING WHERE PRESENT PRIOR TO WORK.
  PAYMENT SHALL BE INCIDENTAL TO THE SPECIFIED 518 ITEMS.
- 2. PRIOR TO THE START OF THE CONCRETE REMOVAL, THE RESIDENT AND THE CONTRACTOR SHALL SOUND ALL EXPOSED SURFACES OF CONCRETE AND AGREE ON THE REMOVAL LIMITS. SHOULD THE REMOVAL AREA LIMITS APPEAR TO CHANGE DURING THE DEMOLITION PROCESS, THE CONTRACTOR SHALL NOTIFY THE RESIDENT. THE RESIDENT AND CONTRACTOR SHALL AGREE ON THE REVISED PAY LIMITS PRIOR TO THE CONTRACTOR CONTINUING THE REMOVAL.
- 3. PERFORM I INCH DEEP SAWCUTS ALONG LIMITS OF REMOVAL.
- 4. CHIP CONCRETE TO DEPTH REQUIRED PER SPECIFICATIONS.

### CONCRETE SURFACE PATCH/REPAIR PROCEDURE:

I. PREPARE AND PATCH REPAIR AREAS WITH CLASS AAA - MODIFIED CONCRETE. SEE SPECIFICATIONS FOR MATERIAL, PREPARATION, PLACEMENT, AND CURING REQUIREMENTS.

### GENERAL FINISHING:

I. ALL EXPOSED CONCRETE SURFACES SHALL BE COATED WITH A PROTECTIVE COATING SUITABLE FOR CONCRETE SURFACES AFTER PATCHING IS COMPLETE AND PATCH MATERIALS HAVE CURED. PIGMENTED PROTECTIVE COATING SHALL BE APPLIED TO ALL ABUTMENT FACES, ALL WINGWALL FACES, AND ALL BARRIER OUTSIDE FACES. CLEAR PROTECTIVE COATING SHALL BE APPLIED TO ALL CONCRETE CURB FACES, ALL FASCIAS AND FASCIA OVERHANGS, AND ALL BARRIER INSIDE AND TOP FACES.

#### LIST OF ABBREVIATIONS

ABUT. ABUTMENT ADDL. ADDITIONAL

ASCG. AGGREGATE SUBBASE COURSE GRAVEL

ALT. ALTERNATE
APPROX. APPROXIMATE
BOT. BOTTOM
BRG. BEARING

CL. CLEAR

CONC. CONCRETE

CONSTR. CONSTRUCTION

DEMO. DEMOLITION
DIA. DIAMETER
DIAPH. DIAPHRAGM
FA. FACH

EA. EACH
EB EASTBOUND
E.F. EACH FACE
EL. ELEVATION
EQ. EQUAL
EXIST. EXISTING
EXP. EXPANSION
F.F. FAR FACE

MAX. MAXIMUM MIN. MINIMUM MTA MAINE TURNPIKE AUTHORITY

NB NORTHBOUND

N.F. NEAR FACE

JOINT

N.T.S. NOT TO SCALE

O.H.W. ORDINARY HIGH WATER

PED. PEDESTAL PGL PROFILE GRADE LINE

PLATE
PROP. PROPOSED
RDWY. ROADWAY
SHLD. SHOULDER
SB SOUTHBOUND
SP. SPACES
STA. STATION
T.&B. TOP & BOTTOM

TPKE. TURNPIKE
TYP. TYPICAL
U.O.N. UNLESS OTHERWISE NOTED

VERT. VERTICAL
WB WESTBOUND
W.P. WORKING POINT

NOT TO SCALE

TYLINITERNATIONAL

No. Revision By Date

CONSULTANT PROJECT MANAGER: Daniel S. Myers

By Date By Date

Designed DSM 12/2018 Checked DSM 12/2018

Drawn JJB 12/2018 In Charge of DSM 1/2019

T.Y. Lin International
12 Northbrook Drive
Building A, Suite One
Falmouth, Maine 04105
TEL: (207) 781-4721
FAX: (207) 781-4753



## THE GOLD STAR MEMORIAL HIGHWAY

NORTHERN BRIDGE REPAIRS &
BENNETT ROAD EMERGENCY VEHICLE RAMPS

BRIDGE GENERAL NOTES

SHEET NUMBER: GN-02

CONTRACT:2019.11 5 OF 105

MTA PROJECT MANAGER: Ralph C. Norwood, IV

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### GENERAL MAINTENANCE OF TRAFFIC NOTES:

- I. CONTRACTOR SHALL REFER TO "MANUAL ON UNIFORM TRAFFIC CONTROL DEVICES", LATEST EDITION, FOR TEMPORARY TRAFFIC CONTROL MEASURES AND TYPICAL APPLICATIONS FOR OTHER WORK ZONE ARRANGEMENTS ON TURNPIKE MAINLINE AND OVERPASS ROADWAYS.
- 2. FOR SIGN DETAILS, SEE MAINTENANCE OF TRAFFIC SIGN SUMMARY SHEET.
- 3. ALL CONSTRUCTION SIGNS SHALL BE IN NEW OR LIKE NEW CONDITION.
- 4. ALL WORK TO CONFORM TO THE 2014 MAINE DEPARTMENT OF TRANSPORTATION STANDARD SPECIFICATIONS FOR HIGHWAY AND BRIDGES, REVISION OF 2014, EXCEPT AS MODIFIED BY THE MAINE TURNPIKE AUTHORITY'S GENERAL AND SPECIAL PROVISIONS.
- 5. TEMPORARY PAVEMENT MARKINGS SHALL BE PAINTED, UNLESS OTHERWISE NOTED. PAYMENT FOR MARKINGS SHALL BE UNDER ITEM 627.78 - TEMPORARY PAVEMENT MARKING LINE, WHITE OR YELLOW, TEMPORARY PAVEMENT MARKINGS ON FINAL PAVEMENT SURFACE OR EXISTING PAVEMENT TO REMAIN SHALL BE TEMPORARY PAVEMENT MARKING TAPE TO BE REMOVED PRIOR TO FINAL PAVEMENT MARKING.
- 6. AT NO TIME SHALL SHOULDER CLOSURES ON BOTH SIDES OF THE TRAVEL LANES OCCUR ON THE SAME SIDE OF THE MAINLINE.
- 7. WORK WITHIN SHOULDER CLOSURES SHALL BE CONTINUOUS TO MINIMIZE IMPACTS TO MAINLINE TRAFFIC.
- 8. CONTRACTOR SHALL COORDINATE ALL MAINTENANCE OF TRAFFIC WITH ADJACENT PROJECTS.
- 9. WHEN TRUCK MOUNTED ATTENUATORS ARE INCLUDED IN THE CONTRACT (INCIDENTAL OR PAY ITEM), THEY SHALL BE LOCATED WITHIN THE WORK ZONE, NOT THE BUFFER ZONE.
- 10. LOCATIONS OF TEMPORARY TRAFFIC CONTROL DEVICES, SIGNS, AND PAVEMENT MARKINGS ARE APPROXIMATE. FINAL LOCATIONS WILL BE DETERMINED IN THE FIELD BY THE RESIDENT ENGINEER.
- II. PORTABLE-CHANGEABLE MESSAGE SIGNS SHALL BE LOCATED ON EACH SIDE OF THE BRIDGE ON RT. 26.

### ABBREVIATIONS FOR ALL M.O.T. PLANS

BWLL= BROKEN WHITE LANE LINE SWEL= SOLID WHITE EDGE LINE SYEL= SOLID YELLOW EDGE LINE

TBWLL= TEMPORARY BROKEN WHITE LANE LINE TDYCL= TEMPORARY DOUBLE YELLOW CENTER LINE TSWEL= TEMPORARY SOLID WHITE EDGE LINE TSYEL= TEMPORARY SOLID YELLOW EDGE LINE

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T.Y. Lin International 12 Northbrook Drive Building A, Suite One Falmouth, Maine 04105 TEL: (207) 781-4721 FAX: (207) 781-4753




THE GOLD STAR MEMORIAL HIGHWAY

NORTHERN BRIDGE REPAIRS & BENNETT ROAD EMERGENCY VEHICLE RAMPS

TRAFFIC CONTROL DETAILS - 10F 2

SHEET NUMBER: MT-01 CONTRACT:2019.11 6 OF 105

MTA PROJECT MANAGER: Ralph C. Norwood, IV

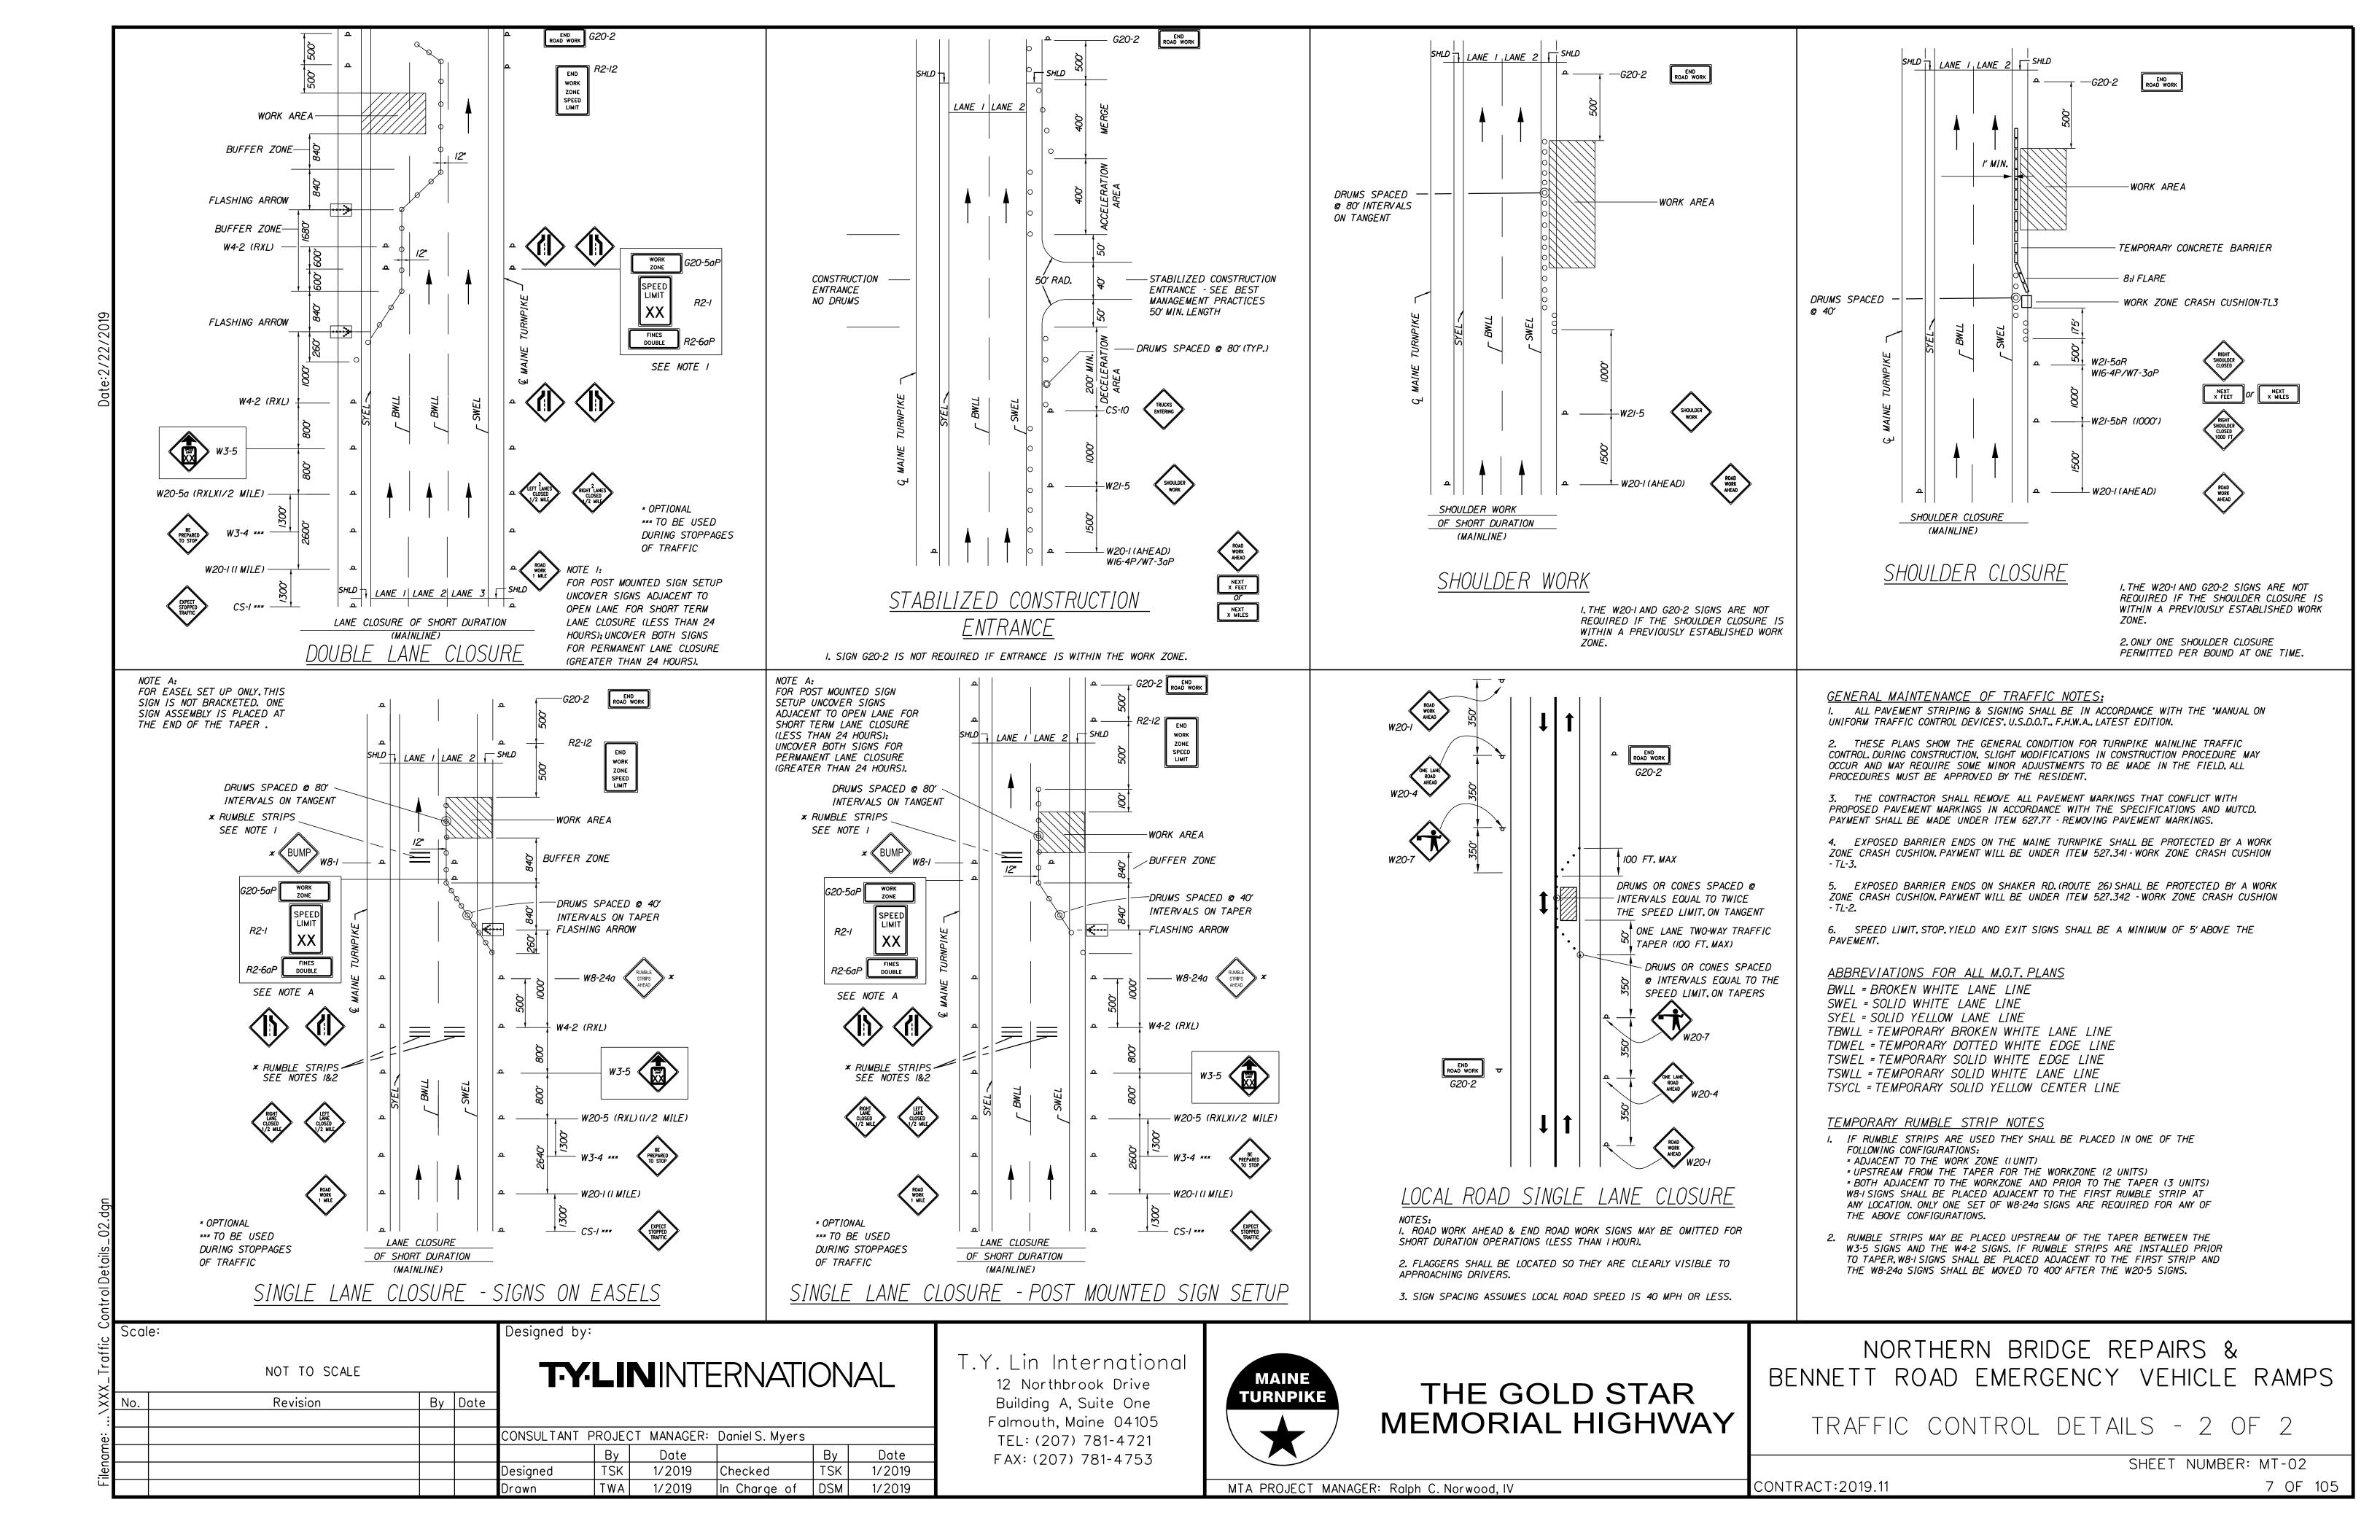

IDENTIFI-	S174	E OF		TEXT DI	MENSIONS	(INCHES)	NUMBER	COL	.OR		ADE A IN	
CATION	SI	'GN	TEXT	LETTER	VERTICAL	ARROW	NUMBER OF SIGNS REQUIRED	BACK-	LEGEND	<i>BORDER</i> <i>RADIUS</i>	AREA IN SQUARE	NOTES
NUMBER	WIDTH	<i>HE IGHT</i>		HEIGHT	SPACING	RTE. MKR.	REQUIRED	GROUND	BORDER	7000	FEET	
CS-I	48"	48"	EXPECT STOPPED TRAFFIC	8C 8C 8C	4" 4"		4	ORANGE	BLACK		16.00 (64)	
CS-10	36" 48"	36" 48"	TRUCKS ENTERING	7C 7C	6"		4 2	ORANGE	BLACK		9.00 (36) 16.00 (32)	
G20-2	36" 48"	18" 24"	END ROAD WORK	CONFOR	DIMENSIONS RM TO "STA AY SIGNS" -	NDARD	4 4	ORANGE	BLACK		4.50 (18) 8.00 (32)	
G20-5aP	36"	24"	WORK ZONE				4	ORANGE	BLACK		6.00 (24)	
R2-I (50)	48"	60"	SPEED LIMIT 50				4	WHITE	BLACK		20.00 (80)	
R2-6aP	36"	24"	FINES DOUBLE				4	WHITE	BLACK		6.00 (24)	
R2-I2	36"	54"	END WORK ZONE SPEED LIMIT				4	WHITE	BLACK		/3.50 (54)	
W3-4	48"	48"	BE PREPARED TO STOP				4	ORANGE	BLACK		16.00 (64)	
W3-5 (50)	48"	48"	SPEED LIMIT 50				4	ORANGE	BLACK		16.00 (64)	
W4-2L (LEFT)	48"	48"		V	V	V	4	ORANGE	BLACK		16.00 (64)	

IDENTIEL	SIZE	. OF		TFX	T DI	MENSIC	DNS	(INCHES)	NUMBER	COL	OR I		4D54 141	
IDENTIFI- CATION NUMBER	SI	GN HEIGHT	TEXT	LETT HE IG	ER	VERTI SPAC	CAL	ARROW RTE.MKR.	NUMBER OF SIGNS REQUIRED	BACK- GROUND	LEGEND BORDER	BORDER RADIUS	AREA IN SQUARE FEET	NOTES
W8-I	48"	48"	BUMP	COI	<i>VFOR</i>	MENS	IONS "STA	S SHALL NDARD	4	ORANGE	BLACK		16.00 (64)	
W8-24a	48"	48"	RUMBLE STRIPS AHEAD						4	ORANGE	BLACK		16.00 (64)	
WI6-4P	<i>36</i> "	30"	NEXT 1000 FEET						2	ORANGE	BLACK		7.50 (15)	
W2O-I (I MILE) (AHEAD) (AHEAD)	48" 36" 48"	48" 36" 48"	ROAD WORK 1 MILE						4 4 4	ORANGE	BLACK		/6.00 (64) 9.00 (36) /6.00 (64)	
W20-4 (AHE AD)	36"	36"	ONE LANE ROAD AHEAD						4	ORANGE	BLACK		9 <b>.</b> 00 (36)	
W20-5R (RIGHT)	<i>48</i> "	48"	RIGHT LANE CLOSED 1/2 MILE						4	ORANGE	BLACK		16.00 (64)	
W20-7a	<i>36</i> "	36"		V	1	▼		∀	4	ORANGE	BLACK		9.00 (36)	

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_					Drawn	TWA	1/2019	In Charge of	DSM	1/2019

T.Y. Lin International
12 Northbrook Drive
Building A, Suite One
Falmouth, Maine 04105
TEL: (207) 781-4721
FAX: (207) 781-4753



# THE GOLD STAR MEMORIAL HIGHWAY

# NORTHERN BRIDGE REPAIRS & BENNETT ROAD EMERGENCY VEHICLE RAMPS

BENNETT ROAD

M.O.T. SIGN SUMMARY 1 OF 2

SHEET NUMBER: EVR-01 8 OF 105

MTA PROJECT MANAGER: Ralph C. Norwood, IV

CONTRACT:2019.11

IDENTIFI- CATION NUMBER	SI	OF GN HEIGHT	TEXT		R VER	TICAL	(INCHES)  ARROW RTE. MKR.	NUMBER OF SIGNS REQUIRED	COL BACK- GROUND	OR LEGEND BORDER	BORDER RADIUS	AREA IN SQUARE FEET	NOTES
W2I-5	48"	48"	SHOULDER	CONF		"STA	S SHALL ANDARD 2009	2	ORANGE	BLACK		16.00 (32)	
W2I-5aR (RIGHT)	48"	48"	RIGHT SHOULDER CLOSED					2	ORANGE	BLACK		16.00 (32)	
W2I-5bR (RIGHT)	48"	<i>48</i> "	RIGHT SHOULDER CLOSED 1000 FT	Ů V		∇	V	2	ORANGE	BLACK		16.00 (32)	

Designed by: T-Y-LININTERNATIONAL NOT TO SCALE By Date Revision CONSULTANT PROJECT MANAGER: DanielS. Myers By Date
Checked JJB 1/2019
In Charge of DSM 1/2019 
 By
 Date

 TWA
 1/2019

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 1/2019
 Designed

T.Y. Lin International 12 Northbrook Drive Building A, Suite One Falmouth, Maine 04105 TEL: (207) 781-4721 FAX: (207) 781-4753



## THE GOLD STAR MEMORIAL HIGHWAY

## NORTHERN BRIDGE REPAIRS & BENNETT ROAD EMERGENCY VEHICLE RAMPS

BENNETT ROAD


CONTRACT:2019.11

M.O.T. SIGN SUMMARY 2 OF 2

SHEET NUMBER: EVR-02 9 OF 105


MTA PROJECT MANAGER: Ralph C. Norwood, IV

AT TURNPIKE (NORTHBOUND) LOOKING NORTH (NTS)

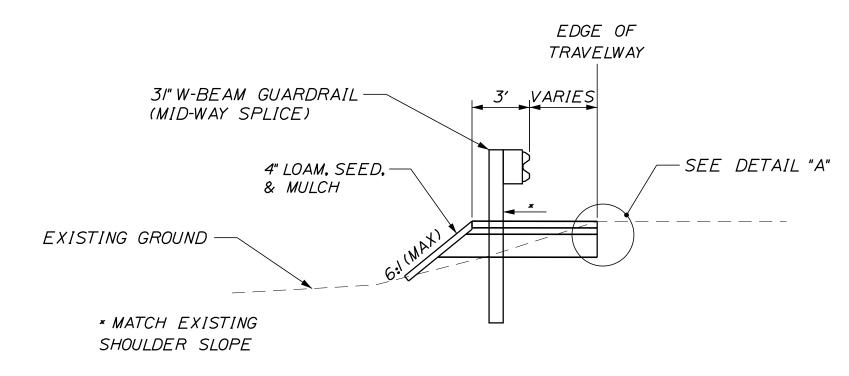

NORTHBOUND EVR GUARDRAIL SECTION


AT BENNETT ROAD LOOKING WEST (NTS)

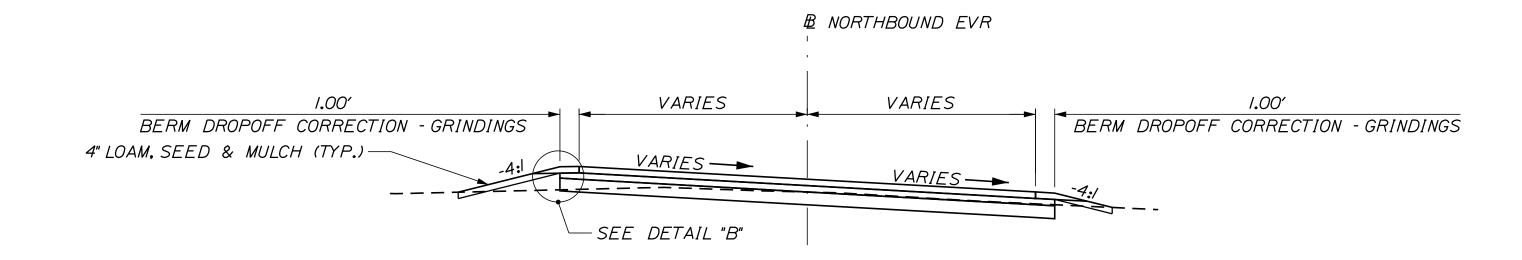

NORTHBOUND EVR TYPICAL SECTION

STA. 14+10 TO STA. 15+12

(NTS)

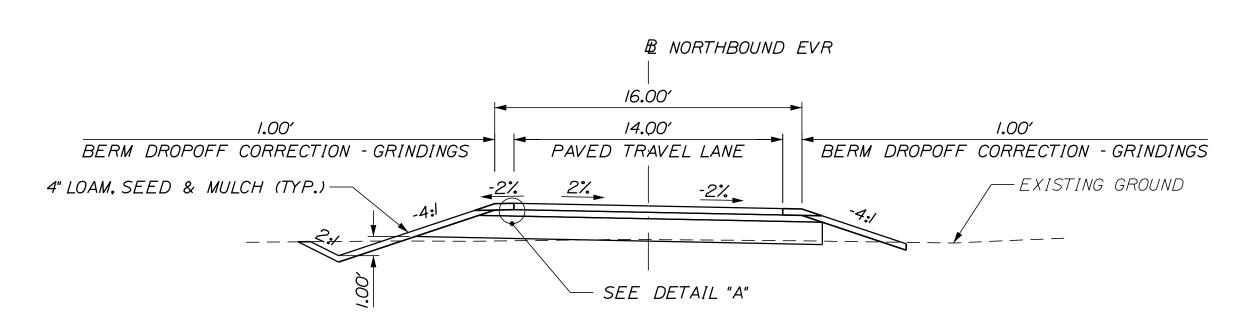

NORTHBOUND EVR TYPICAL SECTION

STA. 10+07 TO STA. 14+10

(NTS)

### NOTES:

- I. THE PAVEMENT, BASE, AND SUBBASE DEPTHS AS SHOWN ON THE PLANS ARE INTENDED TO BE NOMINAL.
- 2. ALL NECESSARY PAVEMENT CUTTING SHALL BE SAWCUT AND DONE IN SUCH A MANNER TO LEAVE A CLEAN, VERTICAL FACE.
- 3. BITUMINOUS TACK COAT IS REQUIRED BETWEEN ALL LIFTS OF PAVEMENT, OR AS DIRECTED BY RESIDENT. BITUMINOUS TACK COAT IS REQUIRED ON ALL EXISTING PAVED OR MILLED SURFACES PRIOR TO PLACING PROPOSED PAVEMENT.
- 4. A COATING OF HOT RUBBERIZED ASPHALT SHALL BE APPLIED TO SURFACE LAYER OF ALL SAW CUT AND PAVEMENT JOINTS PRIOR TO PAVING.
- 6. SEE BENNETT ROAD EVR (MILE 68.6) TYPICAL SECTIONS SHEET 2 OF 2 FOR "DETAIL A" AND "DETAIL B".

Sca	le:			Designed by	<b>/</b> :				
	AS NOTE	ED		T.Y	LII	<b>V</b> INT	ERNATI	ON	ДΙ
No.	Revision	Bv	Date	l					· · ·
10.	TVE VISIOIT	- J by	Dute						
10.	TVE VISIOIT		Dute	CONSULTANT	PROJEC	T MANAGER	: Daniel S. Myers		
NO.	TVE VISIOIT		Date	CONSULTANT	PROJEC By	T MANAGER Date	: Daniel S. Myers	Ву	Date
	TVE VISIOIT			CONSULTANT Designed			: Daniel S. Myers Checked		Date 1/2019

T.Y. Lin International
12 Northbrook Drive
Building A, Suite One
Falmouth, Maine 04105
TEL: (207) 781-4721
FAX: (207) 781-4753



THE GOLD STAR
MEMORIAL HIGHWAY

NORTHERN BRIDGE REPAIRS &
BENNETT ROAD EMERGENCY VEHICLE RAMPS
BENNETT ROAD EVR (MILE 68.6)


TYPICAL SECTIONS SHEET 1 OF 2

SHEET NUMBER: EVR-03


10 OF 105

MTA PROJECT MANAGER: Ralph C. Norwood, IV CONTRACT:2019.11


## SOUTHBOUND EVR TYPICAL SECTION (NTS)

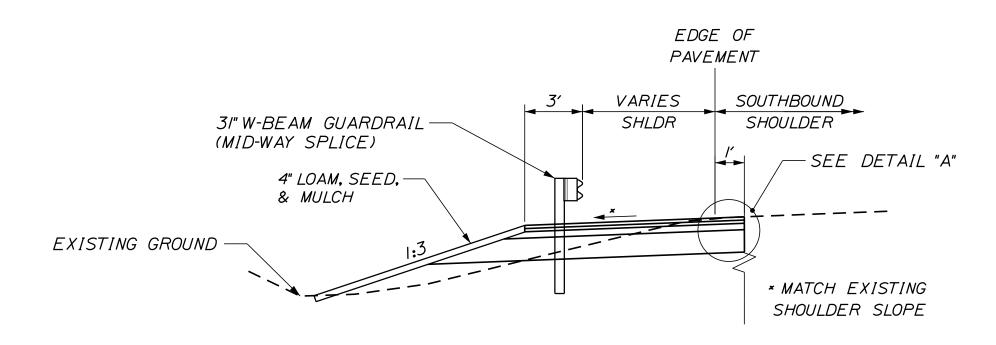

# SOUTHBOUND EVR GUARDRAIL SECTION AT TURNPIKE (SOUTHBOUND) LOOKING NORTH (NTS)

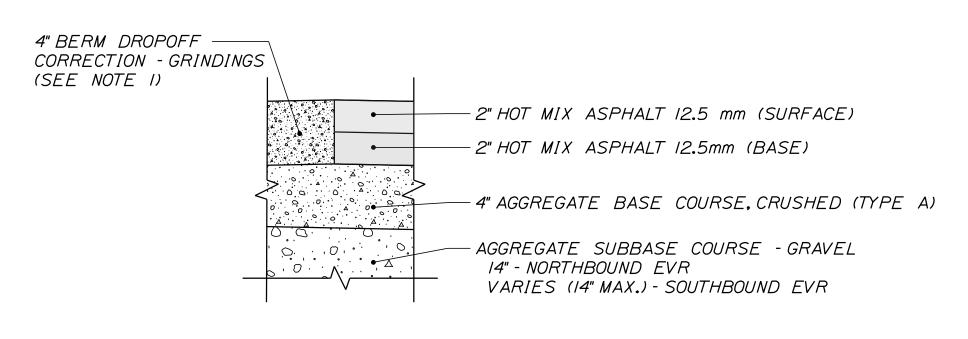

DETAIL "A"

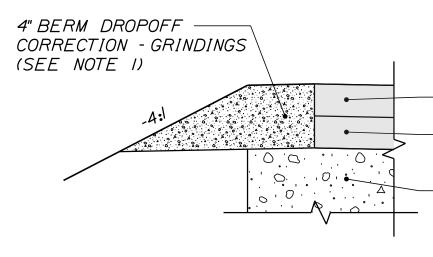

-2" HOT MIX ASPHALT 12.5mm (SURFACE)

-2" HOT MIX ASPHALT 12.5mm (BASE)

-VARIABLE DEPTH (4" MIN.) AGGREGATE BASE COURSE.CRUSHED (TYPE A) (SCARIFY EXISTING GRAVEL BASE IN FILL AREAS)

DETAIL "B"

### NOTES:

- I. WILL BE MEASURED AND PAID FOR UNDER ITEM 470.08 BERM DROP OFF CORRECTION GRINDING.
- 2. SEE BENNETT ROAD EVR (MILE 68.6) TYPICAL SECTIONS SHEET 1 OF 2 FOR NOTES.

Scal	le:			Designed b	y:				
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No.	Revision	Ву	Date						
				CONSULTANT	r PROJEC	T MANAGER:	Daniel S. Myers		
					Ву	Date		Ву	Date
				Designed	TSK	1/2019	Checked	TSK	1/2019
				Drawn	MJD	1/2019	In Charge of	DSM	1/2019

T.Y. Lin International
12 Northbrook Drive
Building A, Suite One
Falmouth, Maine 04105
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THE GOLD STAR
MEMORIAL HIGHWAY


NORTHERN BRIDGE REPAIRS & BENNETT ROAD EMERGENCY VEHICLE RAMPS


BENNETT ROAD EVR (MILE 68.6)


BENNETT ROAD EVR (MILE 68.6) TYPICAL SECTIONS SHEET 2 OF 2

SHEET NUMBER: EVR-04


ood, IV CONTRACT:2019.11

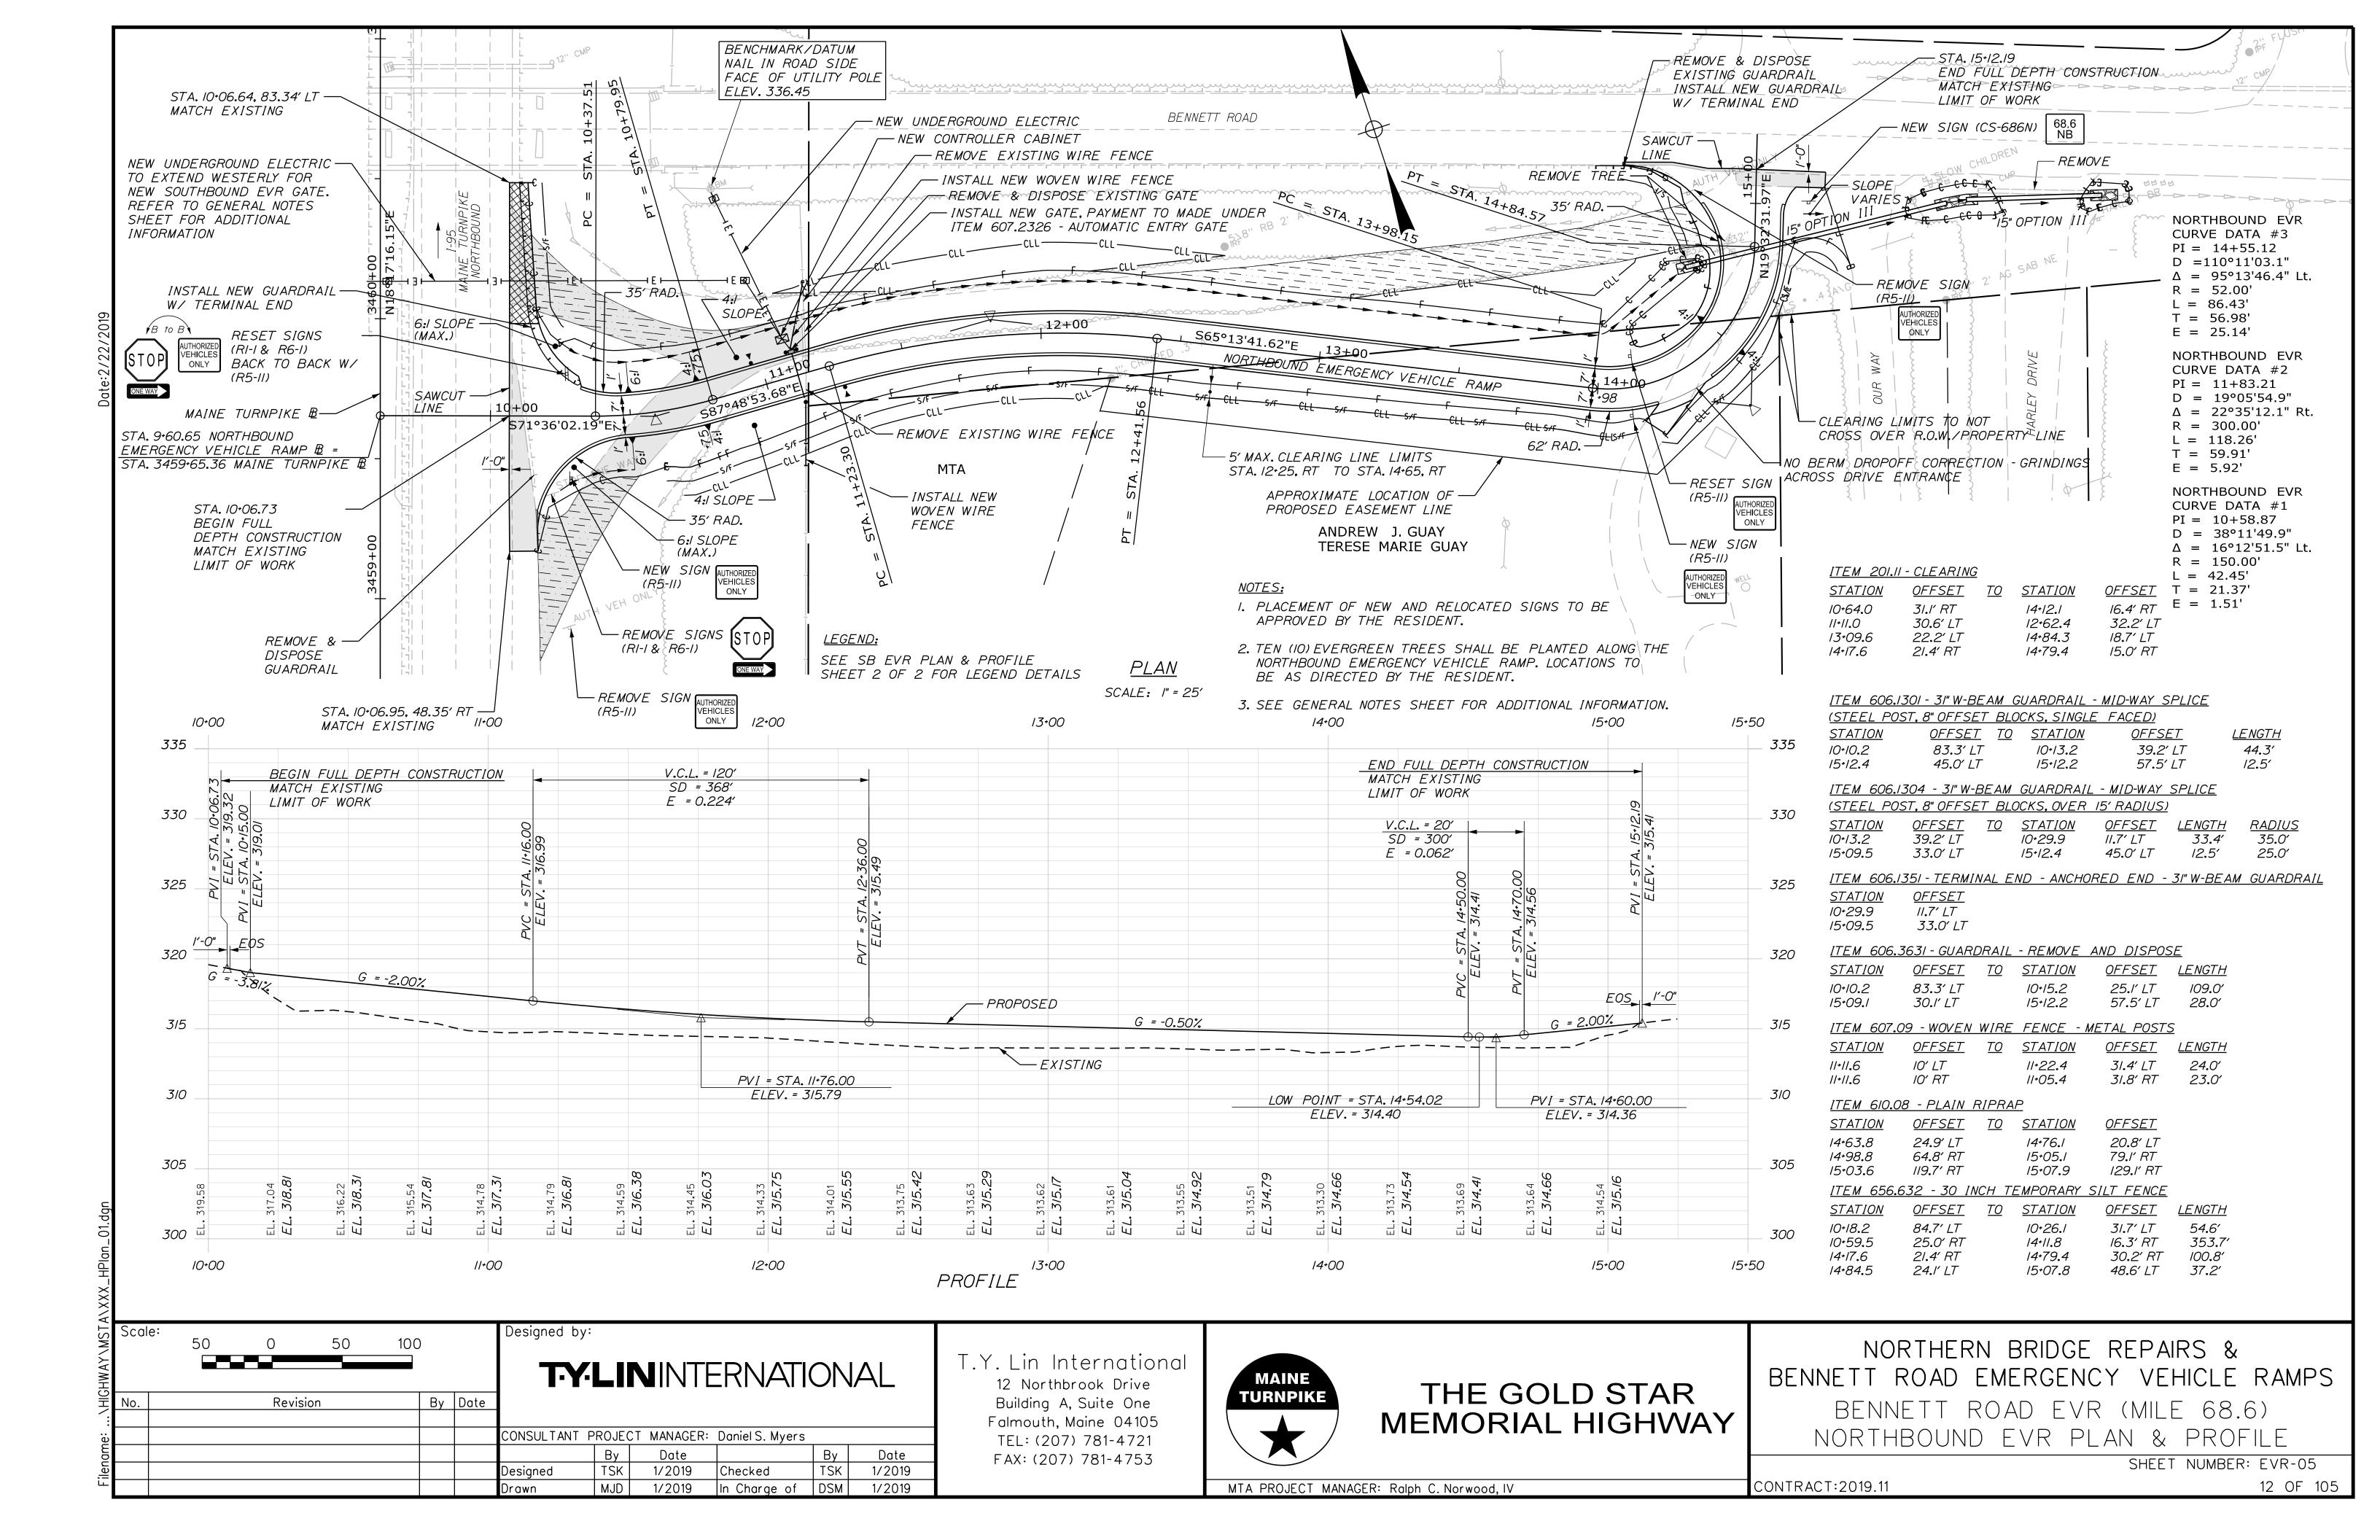

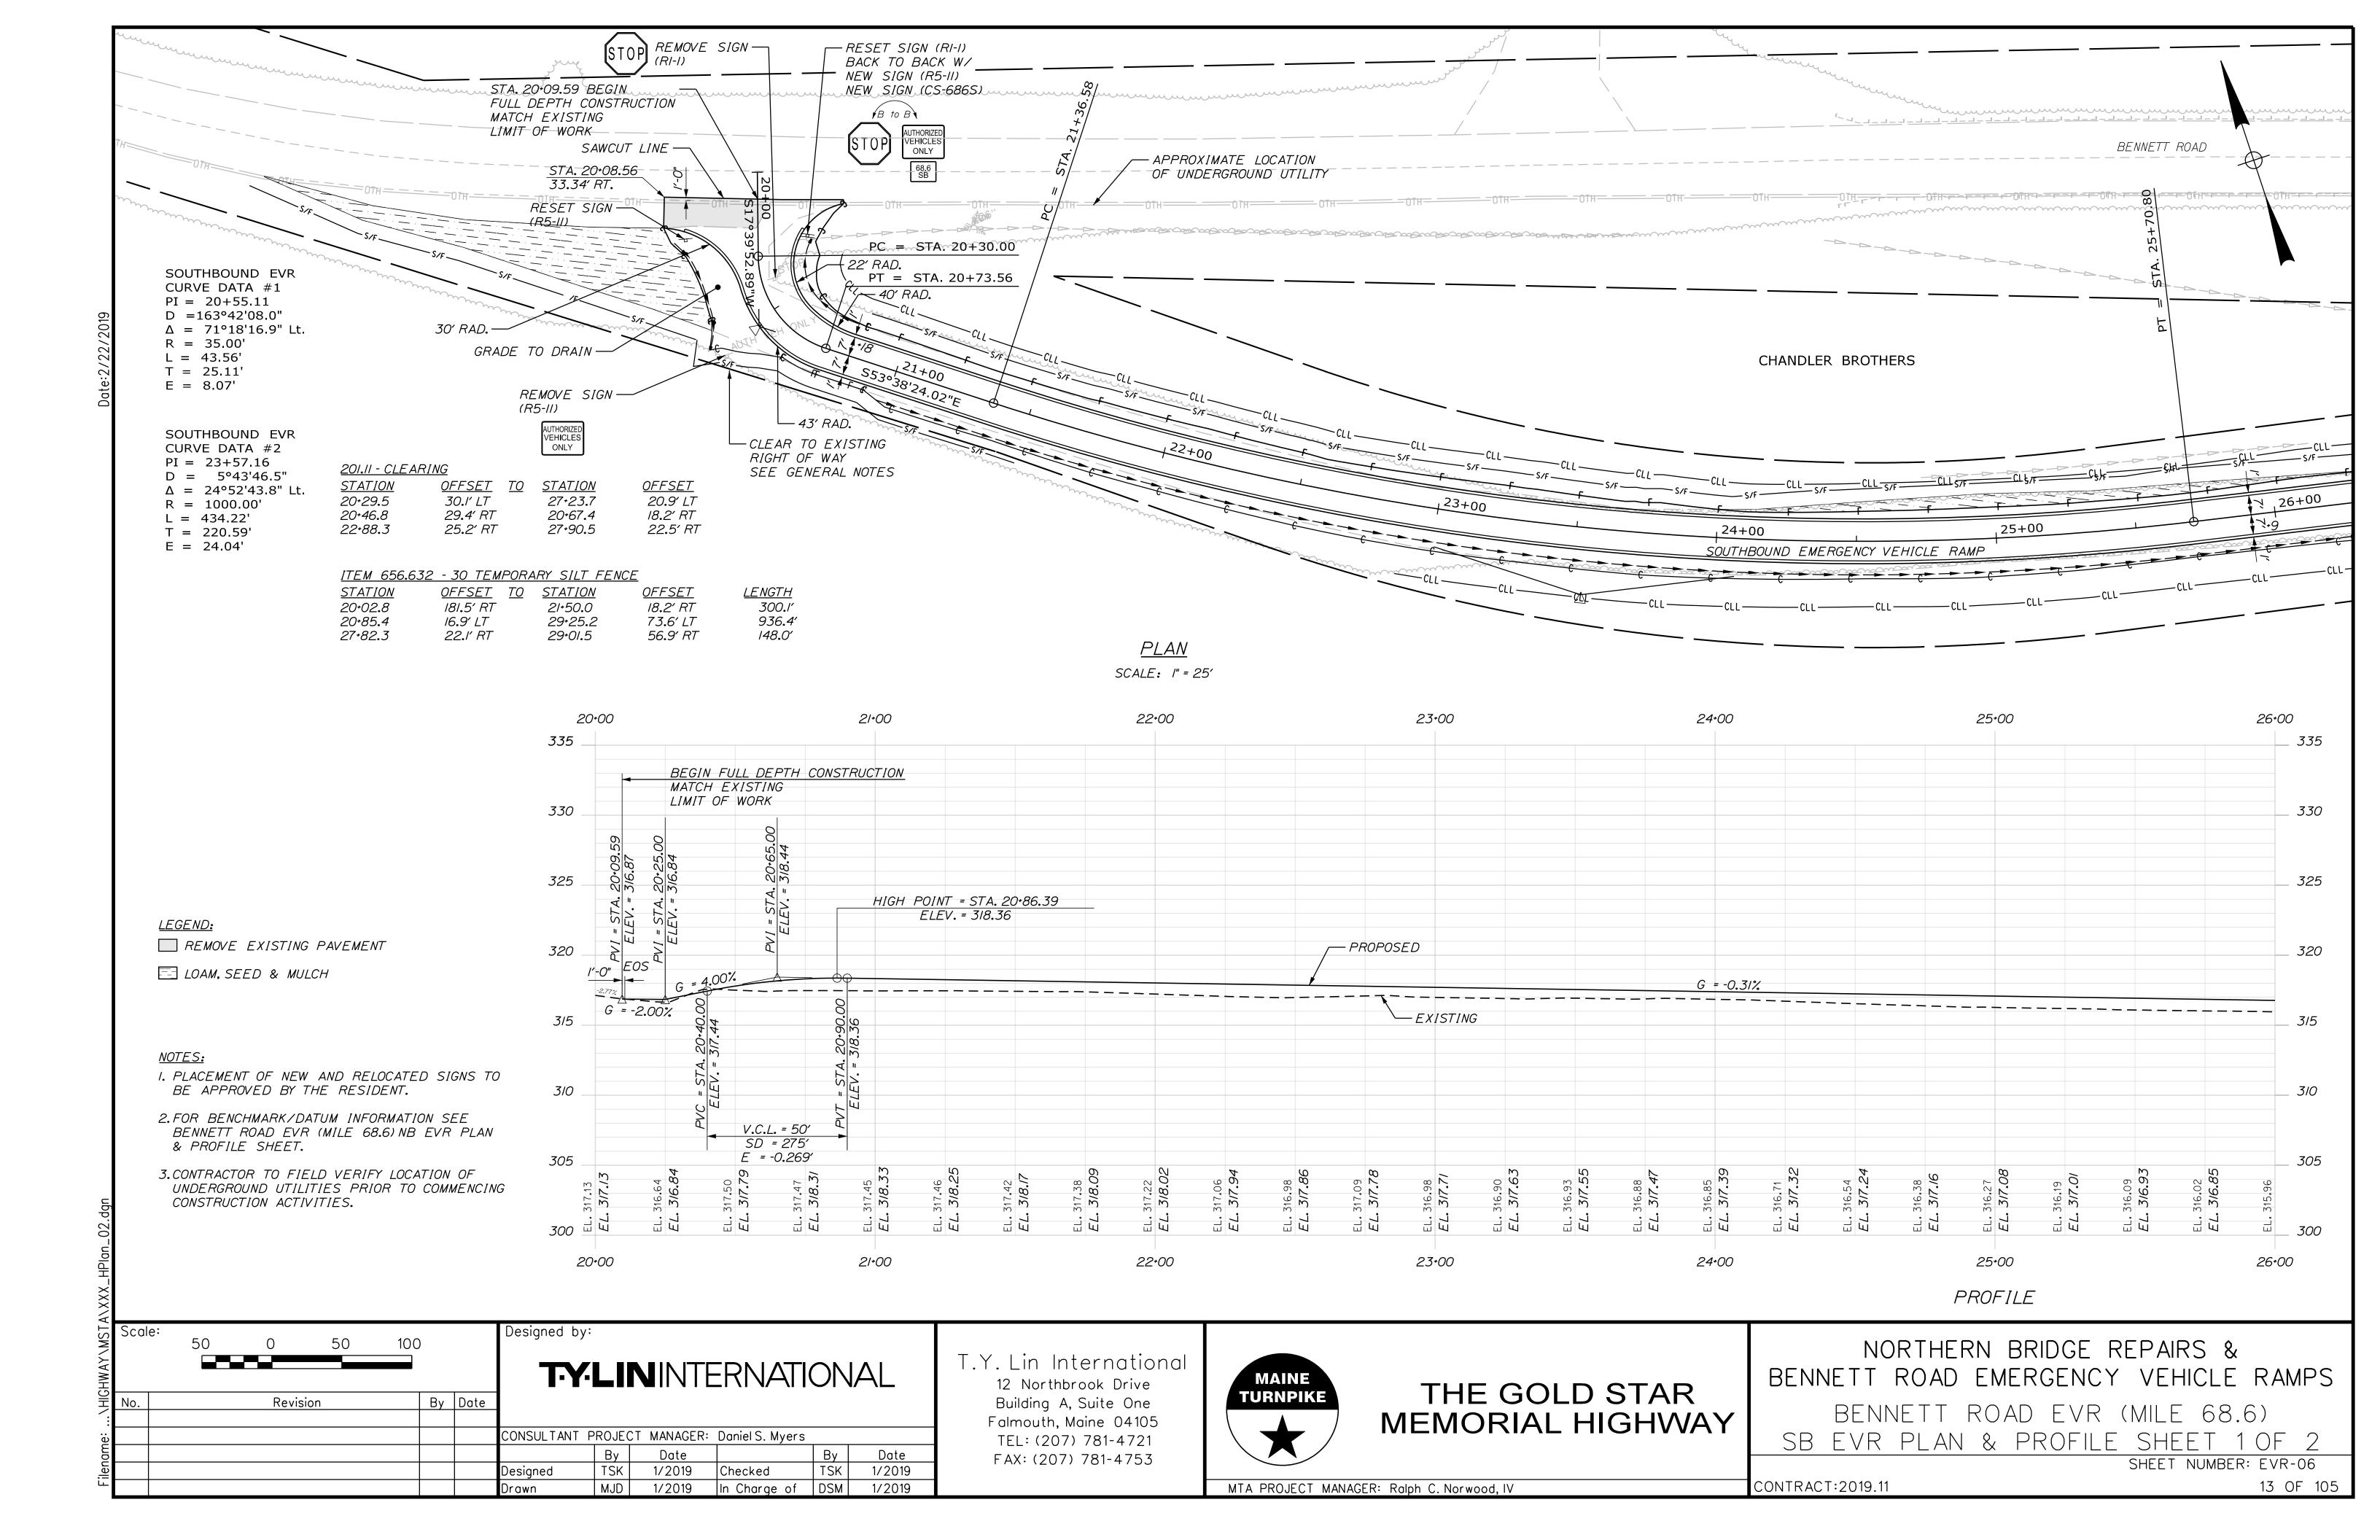


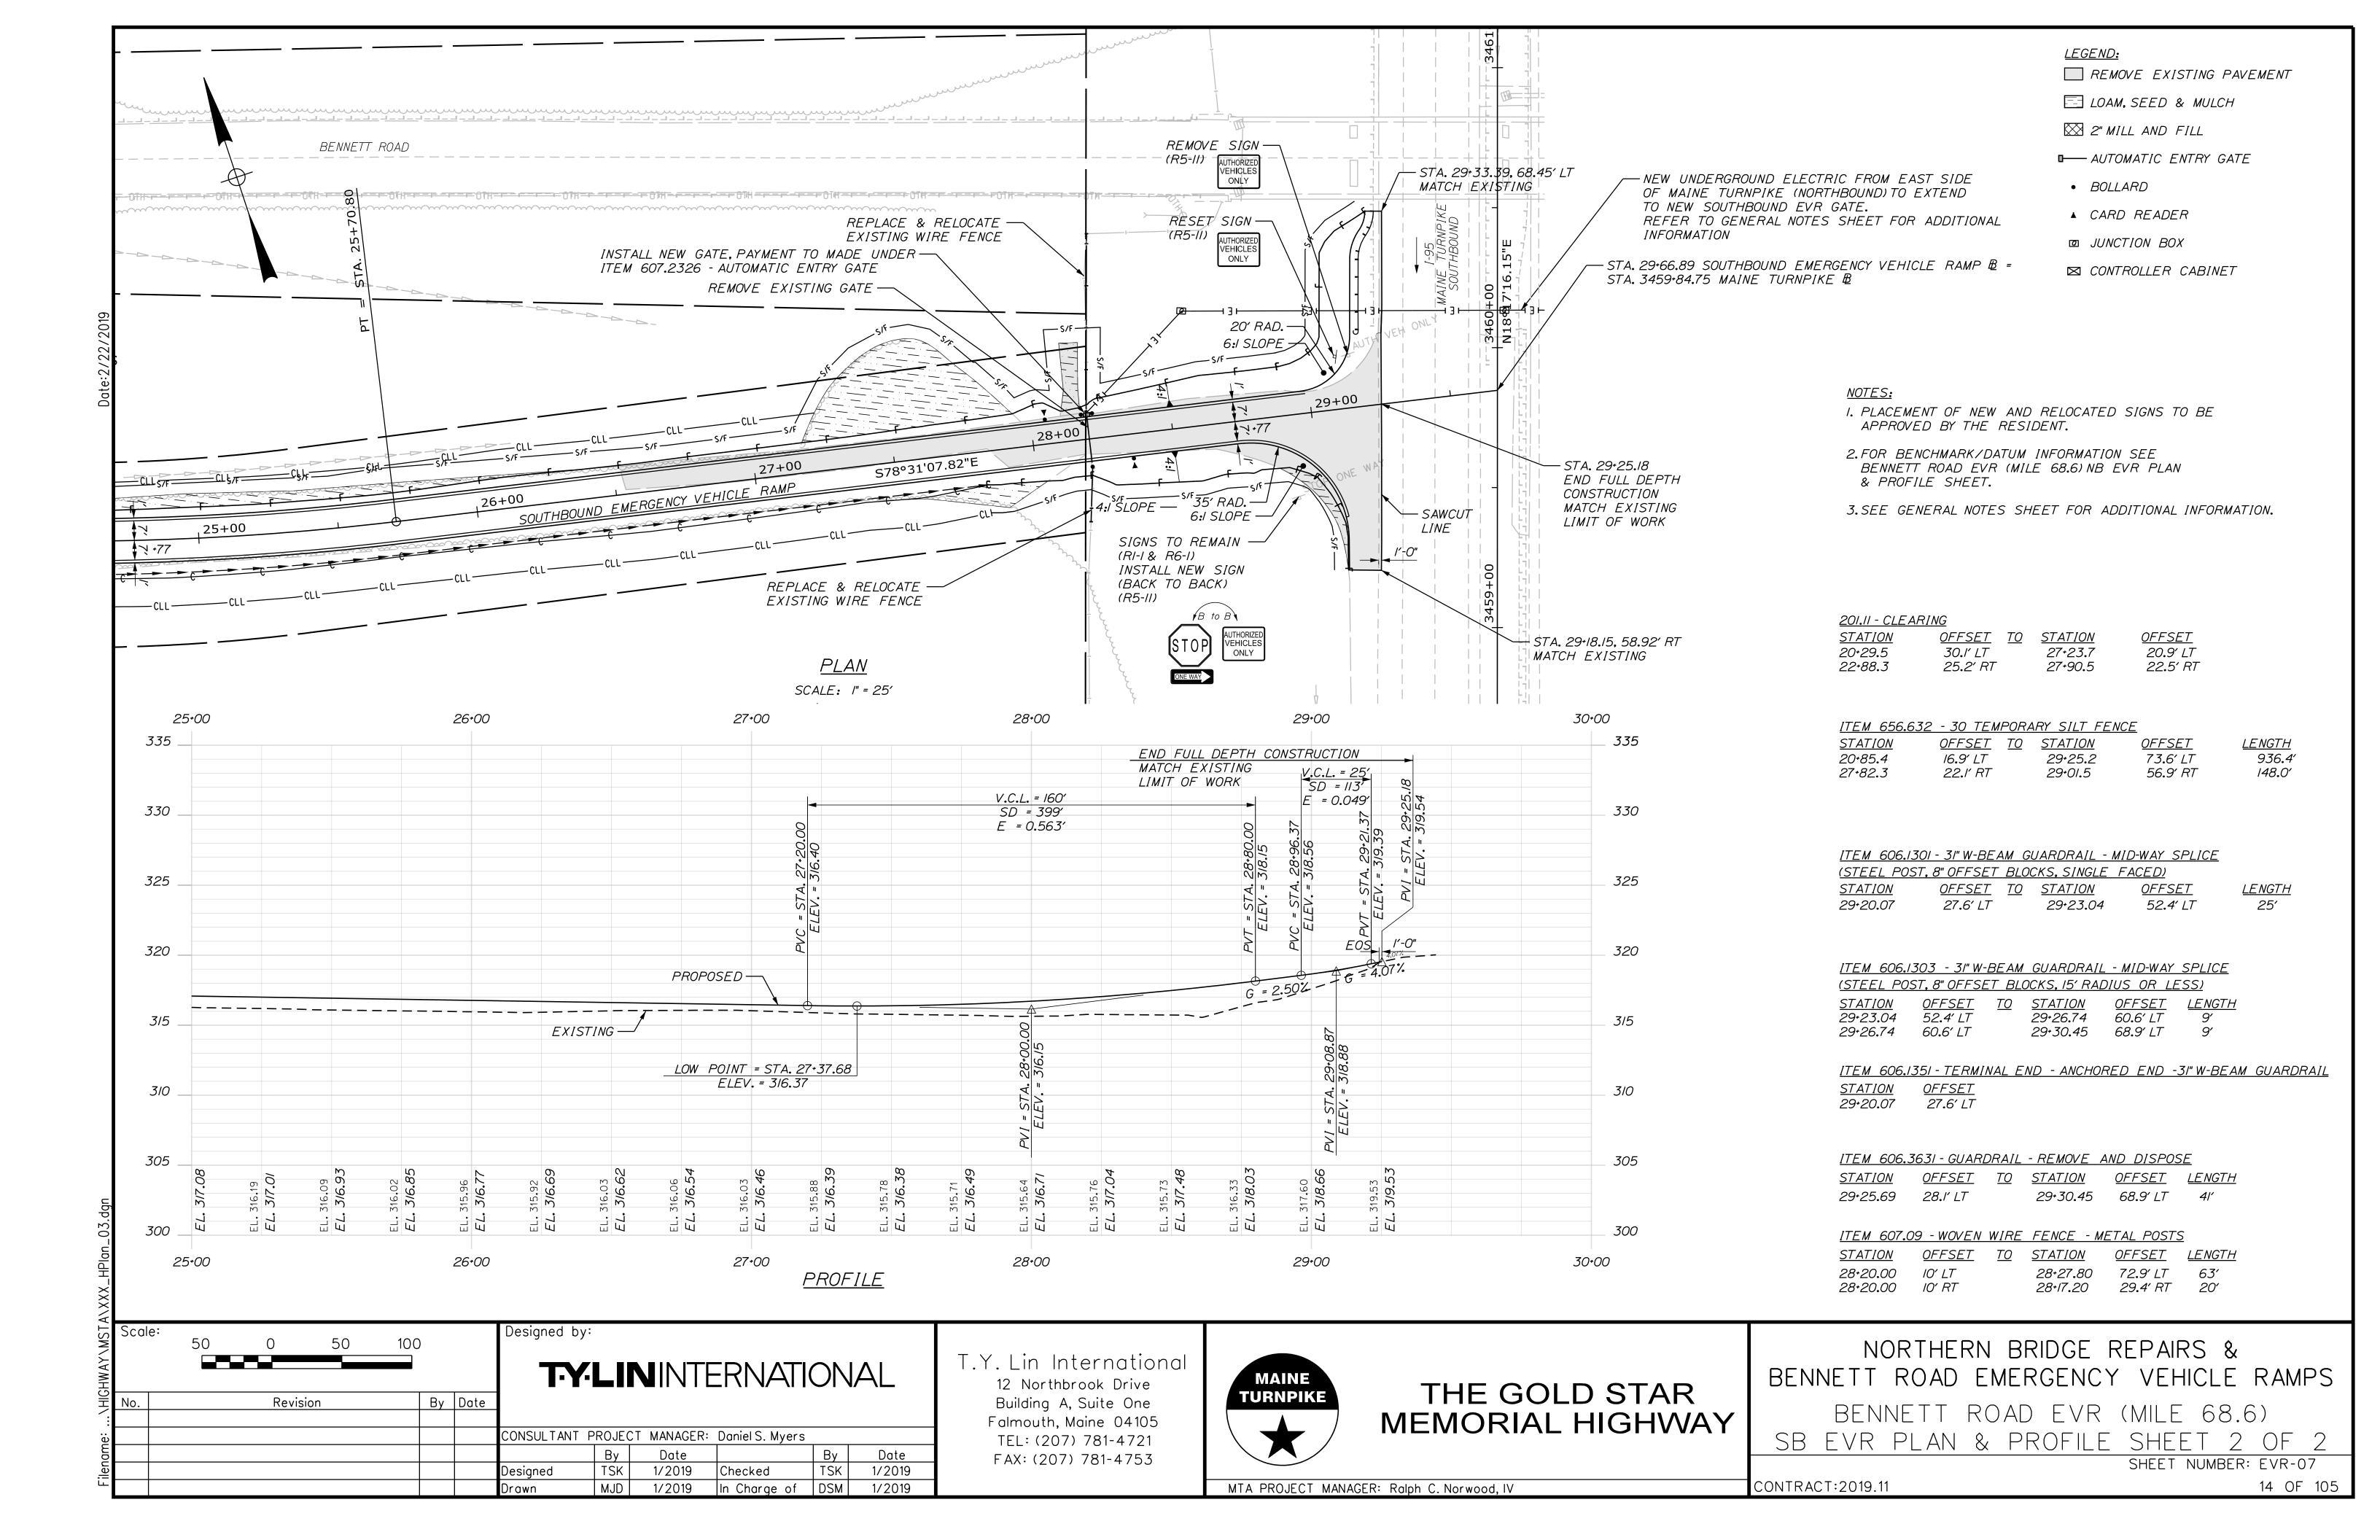

IDENTIFI-					MENSIONS	(INCHES)	NUMBER	COL		BORDER	AREA IN	
CATION NUMBER	SI: WIDTH	GN HE IGHT	TEXT	<i>LETTER</i> HEIGHT	VERTICAL SPACING	(INCHES)  ARROW  RTE. MKR.	SIGNS REQUIRED	BACK- GROUND	<i>LEGEND</i> <i>BORDER</i>	RADIUS	SQUARE FEET	NOTES
CS-686N	18"	12"	68.6 NB	4D 4D	/		/	GREEN	WHITE		1.50 (1.50)	SEE DETAIL THIS SHEET
CS-686S	18"	12"	68.6 SB	4D 4D	/		/	GREEN	WHITE		1.50 (1.50)	SEE DETAIL THIS SHEET
R5-II	36"	24"	AUTHORIZED VEHICLES ONLY	CONFO	DIMENSIONS RM TO "ST. VAY SIGNS"	ANDARD	4	WHITE	BLACK		6.00 (24)	

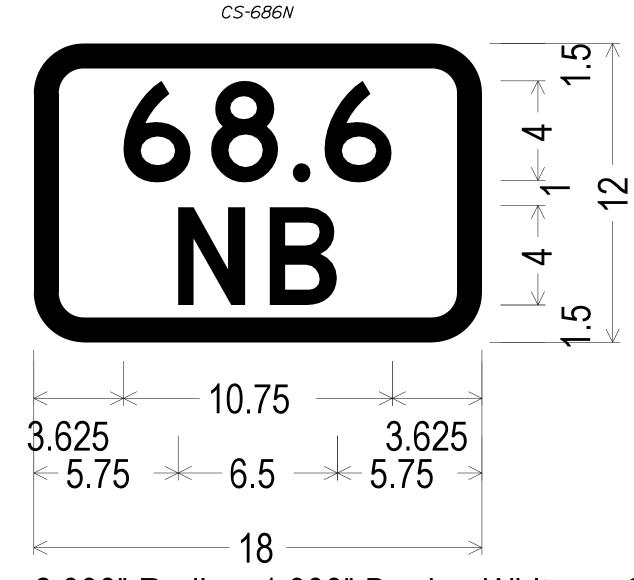

2.000" Radius, 1.000" Border, White on Green; [68.6] D 2K; [NB] D 2K;

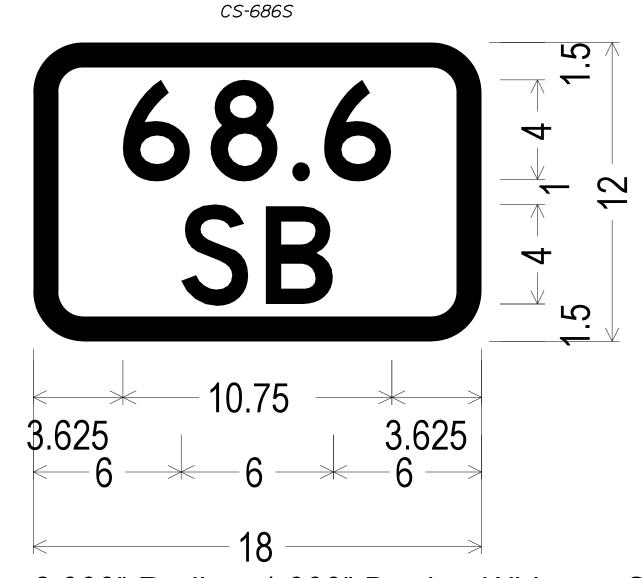


2.000" Radius, 1.000" Border, White on Green; [68.6] D 2K;

[SB] D 2K;

S	Scal	e:			Designed b	y:					
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\MS	No.	Revision	Ву	Date	1						
e:					CONSUL TANT	PROJEC1	MANAGER:	Daniel S. Myers			1
Filename:						Ву	Date		Ву	Date	
ilen					Designed	TWA	1/2019	Checked	JJB	1/2019	
با					Drawn	TWA	1/2019	In Charge of	DSM	1/2019	

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## THE GOLD STAR MEMORIAL HIGHWAY

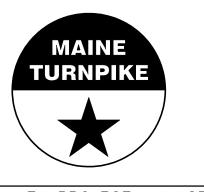
NORTHERN BRIDGE REPAIRS & BENNETT ROAD EMERGENCY VEHICLE RAMPS

> BENNETT ROAD SIGN SUMMARY

CONTRACT:2019.11

SHEET NUMBER: EVR-08

MTA PROJECT MANAGER: Ralph C. Norwood, IV

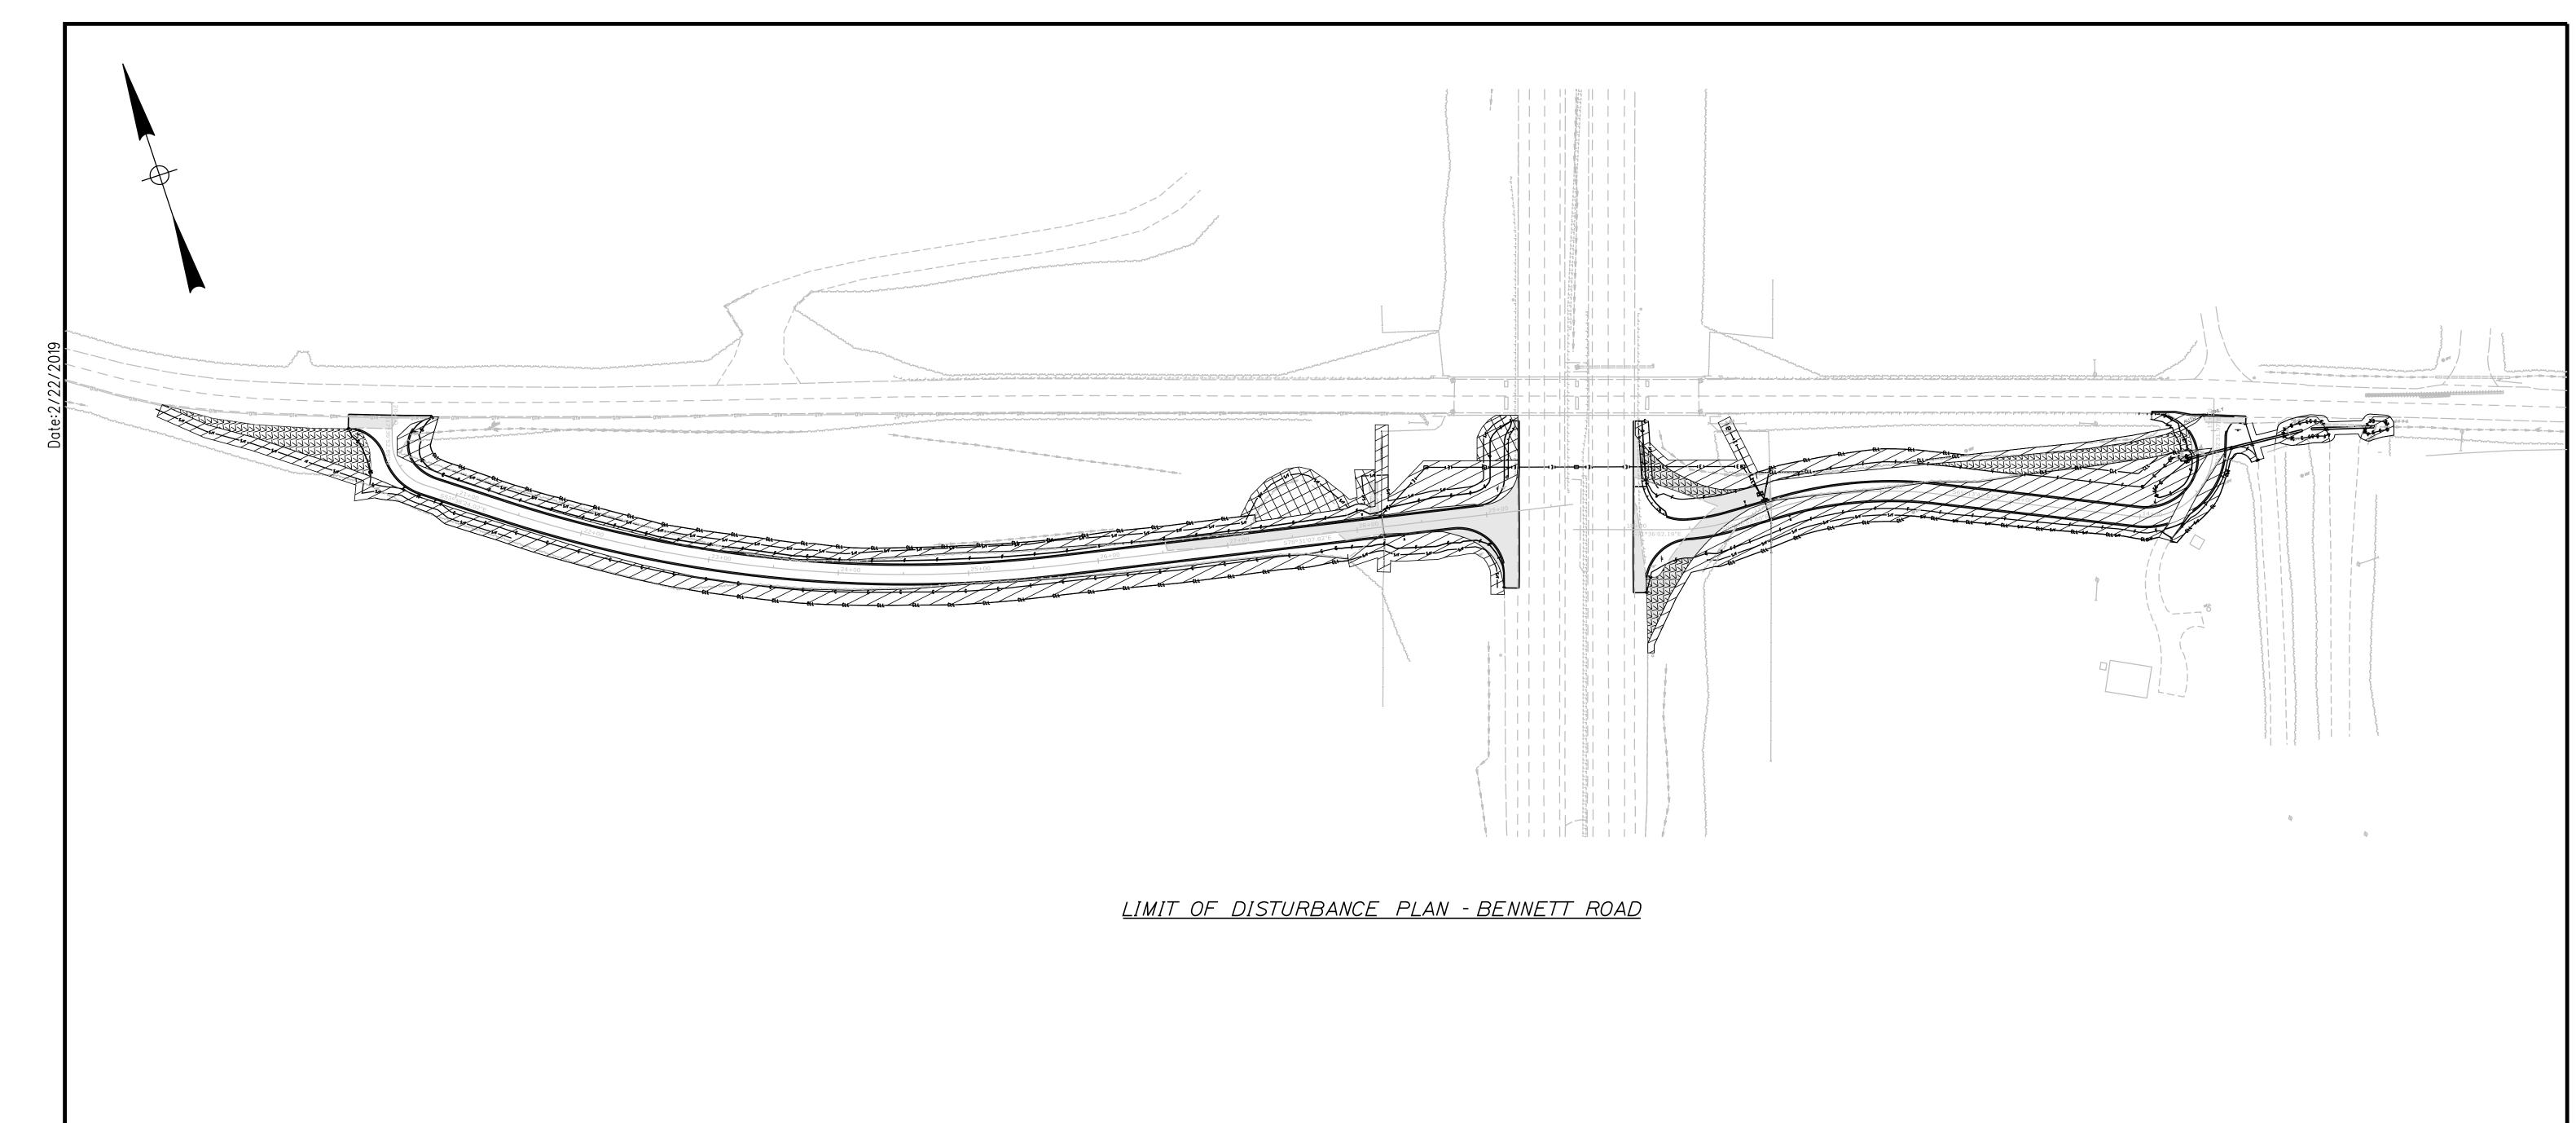

LEGEND:

CONTRACT LIMIT OF DISTURBANCE



CONTRACTOR'S LIMIT OF DISTURBAL
AREA FOR ACCESS AND STORAGE CONTRACTOR'S LIMIT OF DISTURBANCE



Checked

1/2019

1/2019

TSK

In Charge of DSM 1/2019

1/2019

WILL BE VEGETATED IN FINAL CONDITION

### AREAS:

CONTRACT LIMIT OF DISTURBANCE:

BENNETT ROAD = 1.05 ACRES

CONTRACTOR'S LIMIT OF DISTURBANCE AREA FOR ACCESS AND STORAGE:

BENNETT ROAD = 0.08 ACRES

### NOTES:

- I. EROSION AND SEDIMENT CONTROL DEVICES REQUIRED FOR THE CONTRACTOR'S ACCESS LOCATIONS AND STORAGE AREAS WILL NOT BE MEASURED FOR PAYMENT.
- 2. SEE SPECIFICATIONS FOR CONTRACTOR'S SUBMITTAL REQUIREMENTS IF INCREASING THE LIMITS OF DISTURBANCE TO THE PROJECT ESTIMATED QUANTITIES.

### Designed by: Scale: T-Y-LININTERNATIONAL By Date Revision CONSULTANT PROJECT MANAGER: DanielS. Myers By TSK By Date

Designed

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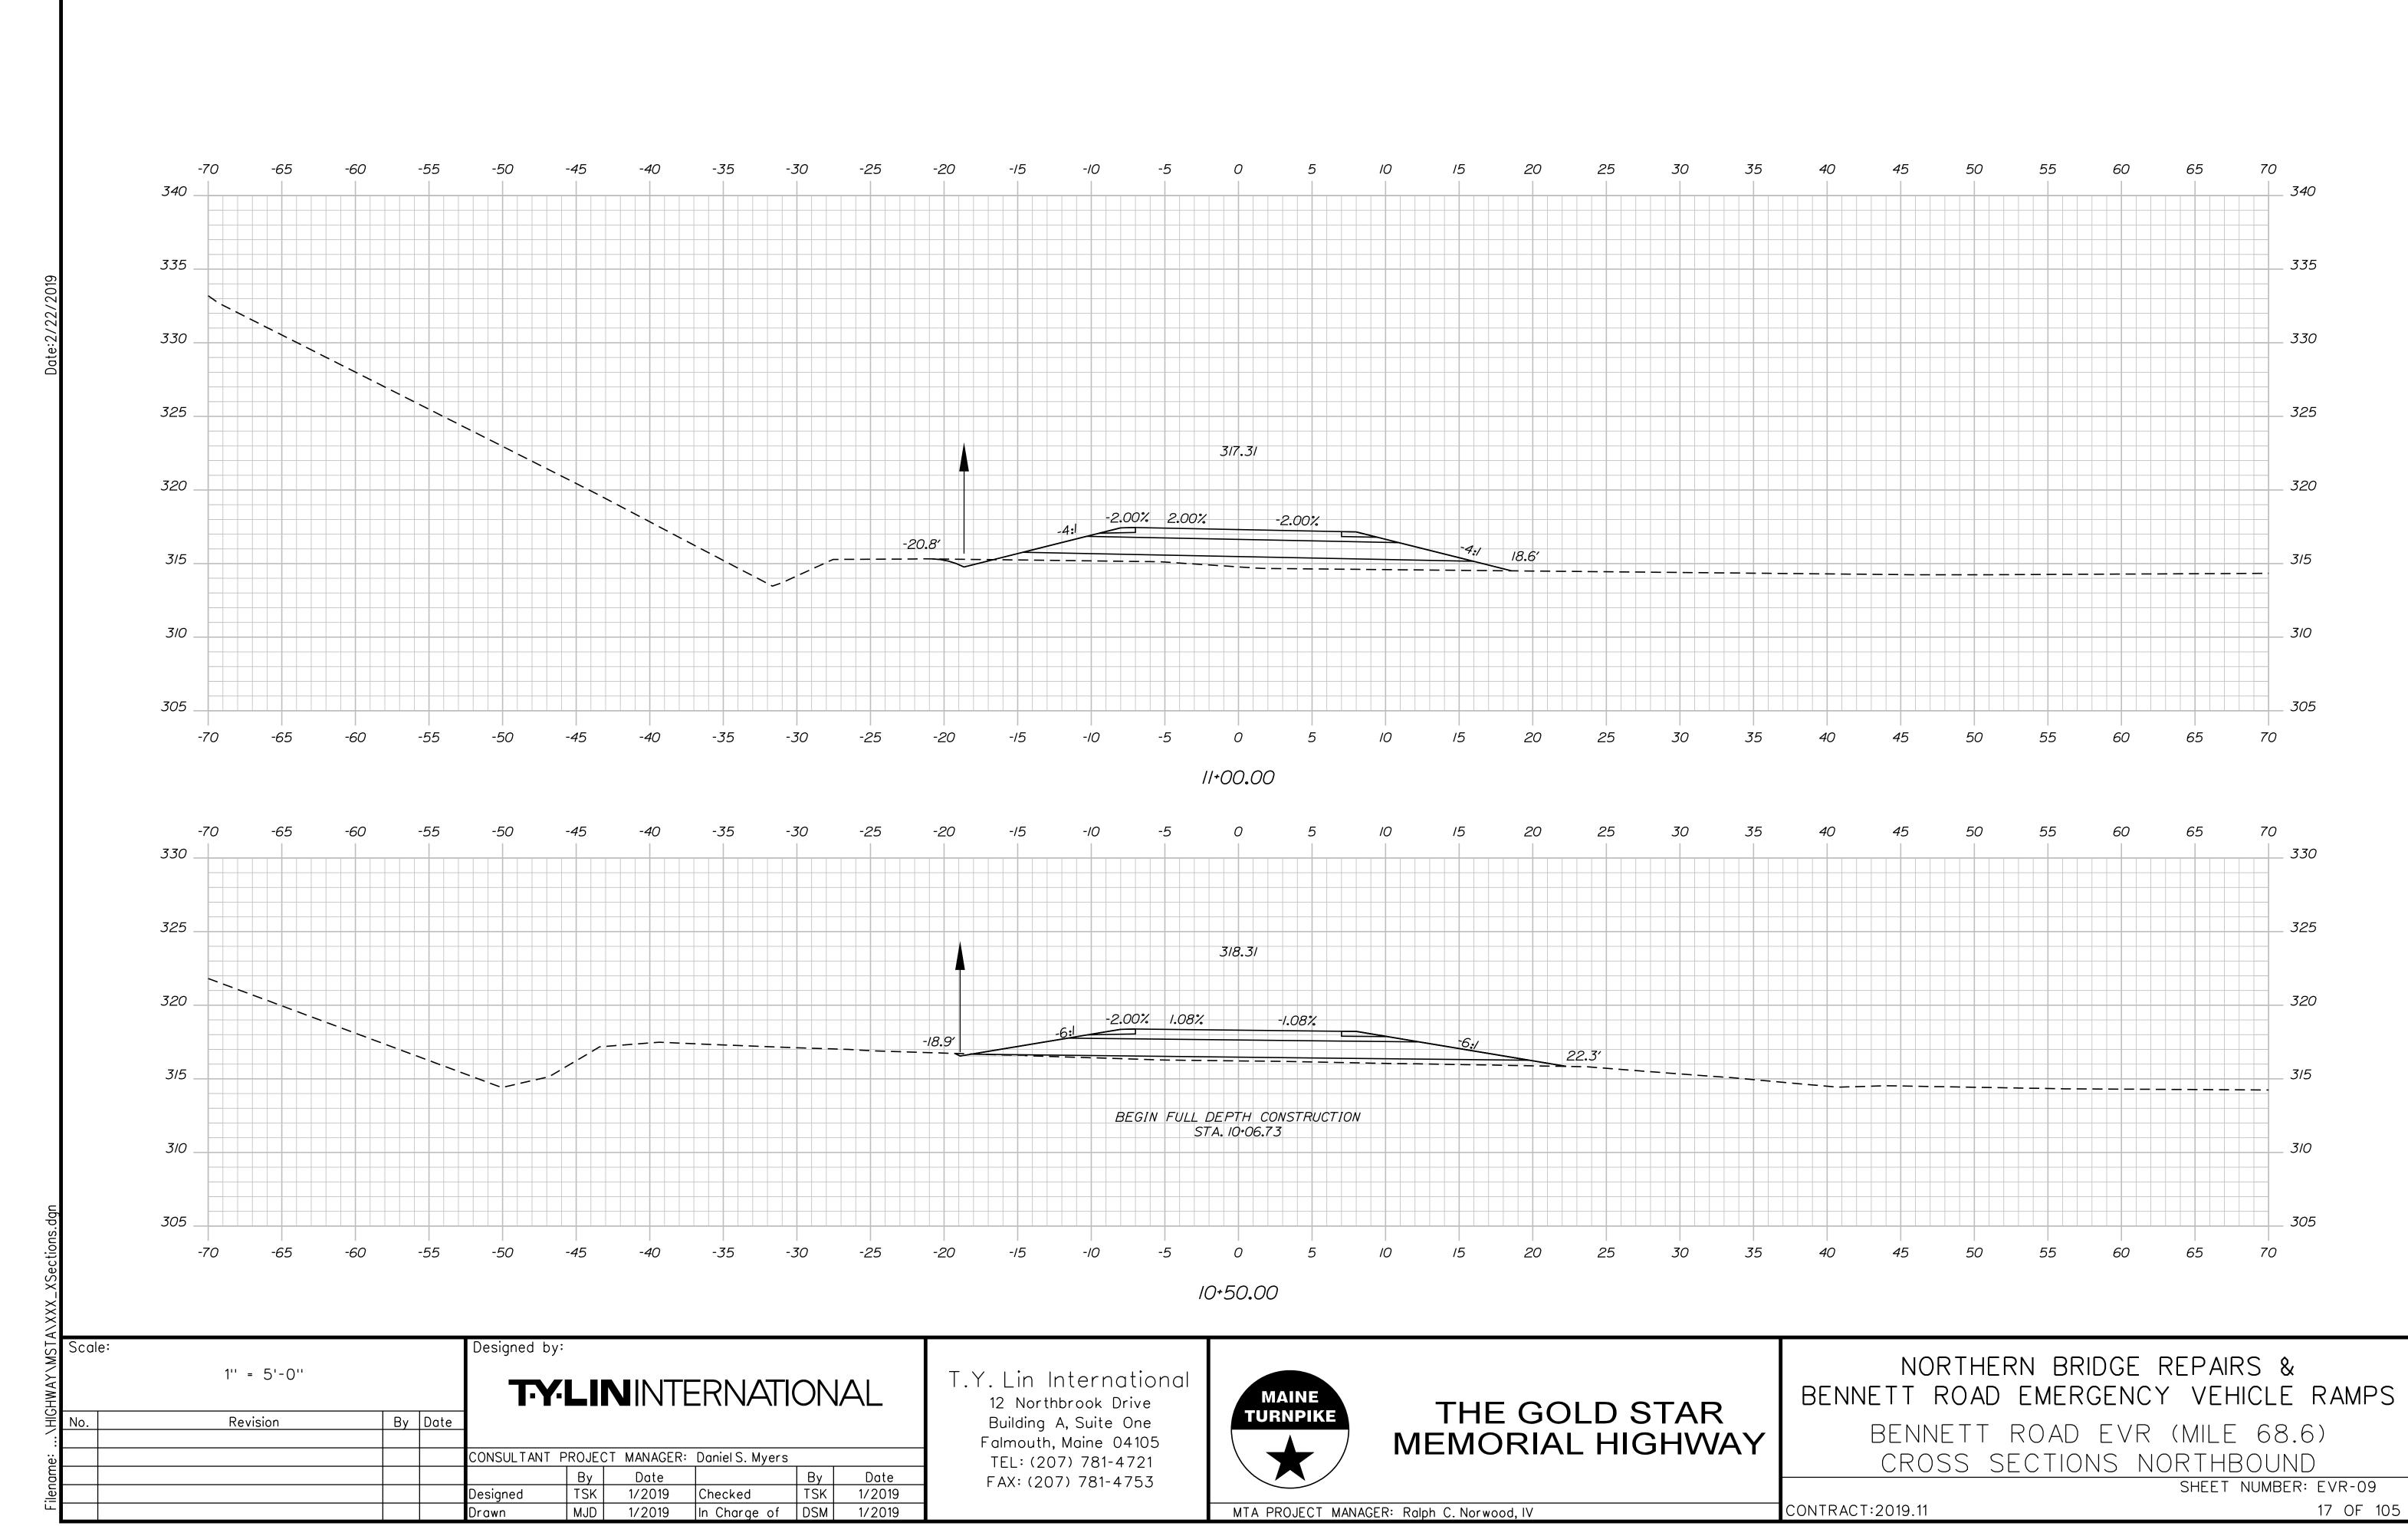
## THE GOLD STAR MEMORIAL HIGHWAY


NORTHERN BRIDGE REPAIRS & BENNETT ROAD EMERGENCY VEHICLE RAMPS


BENNETT ROAD EVR (MILE 68.6) LIMIT OF DISTURBANCE


SHEET NUMBER: EVR-08


CONTRACT:2019.11




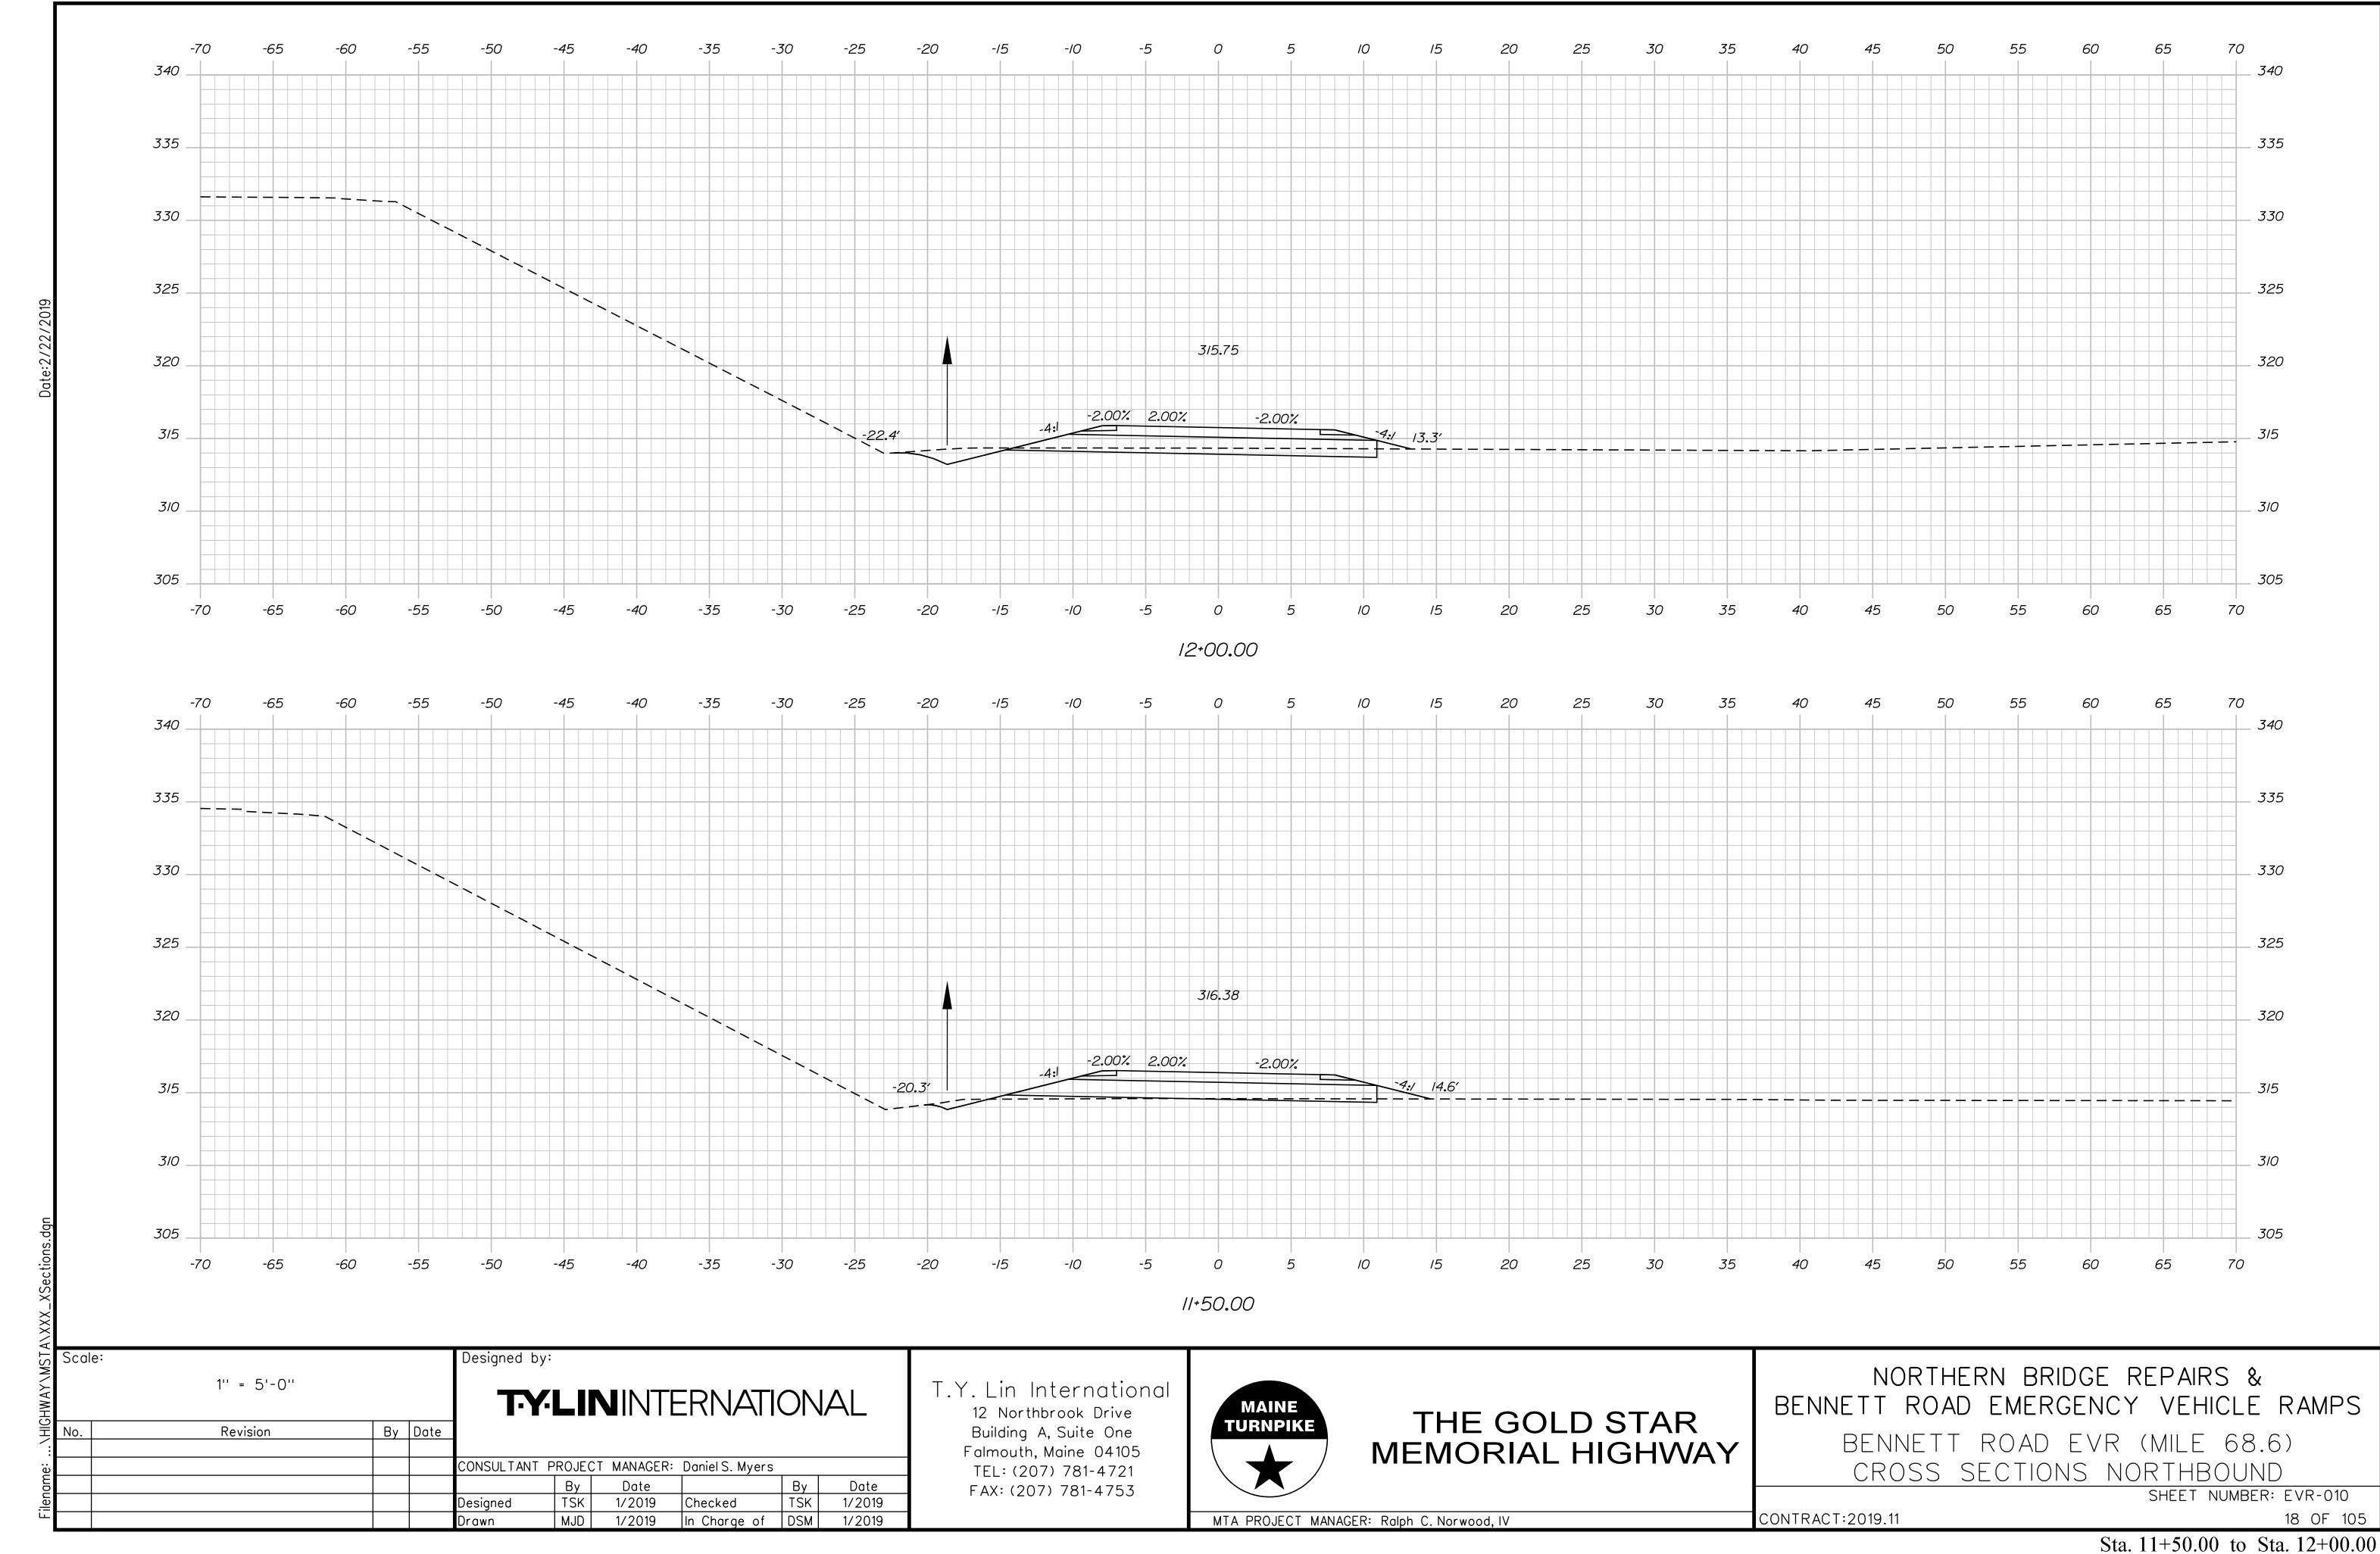


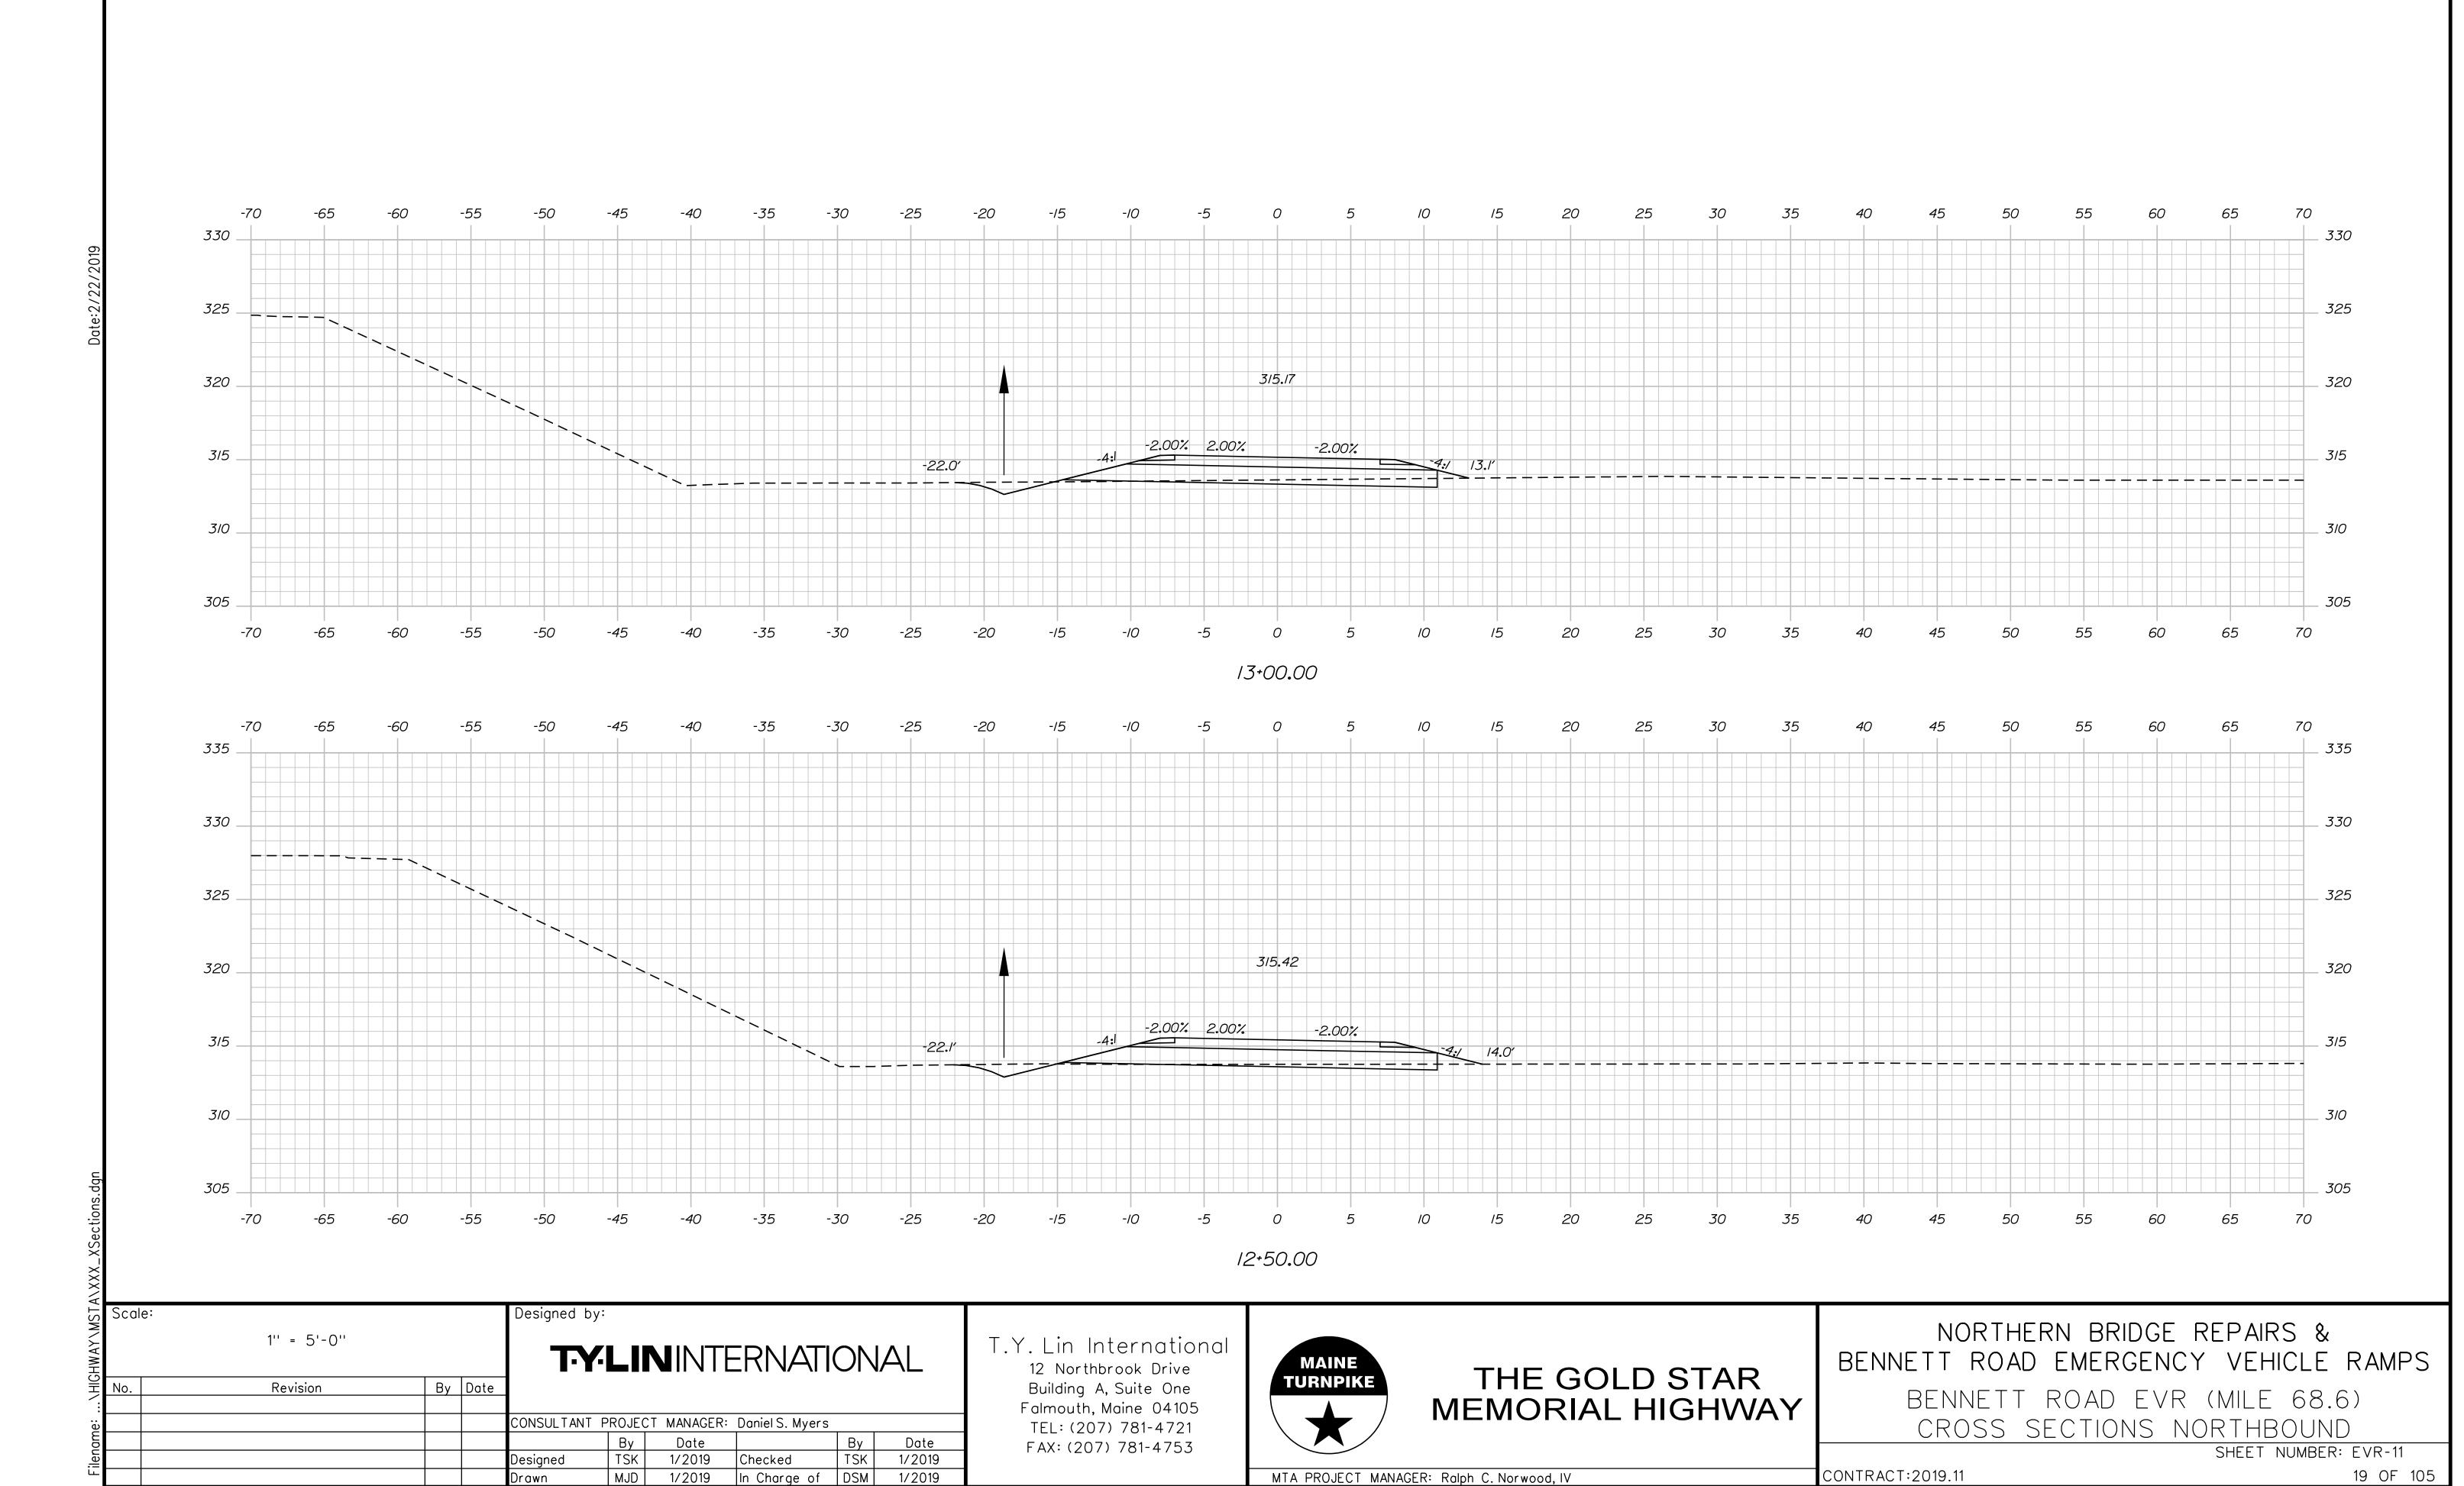


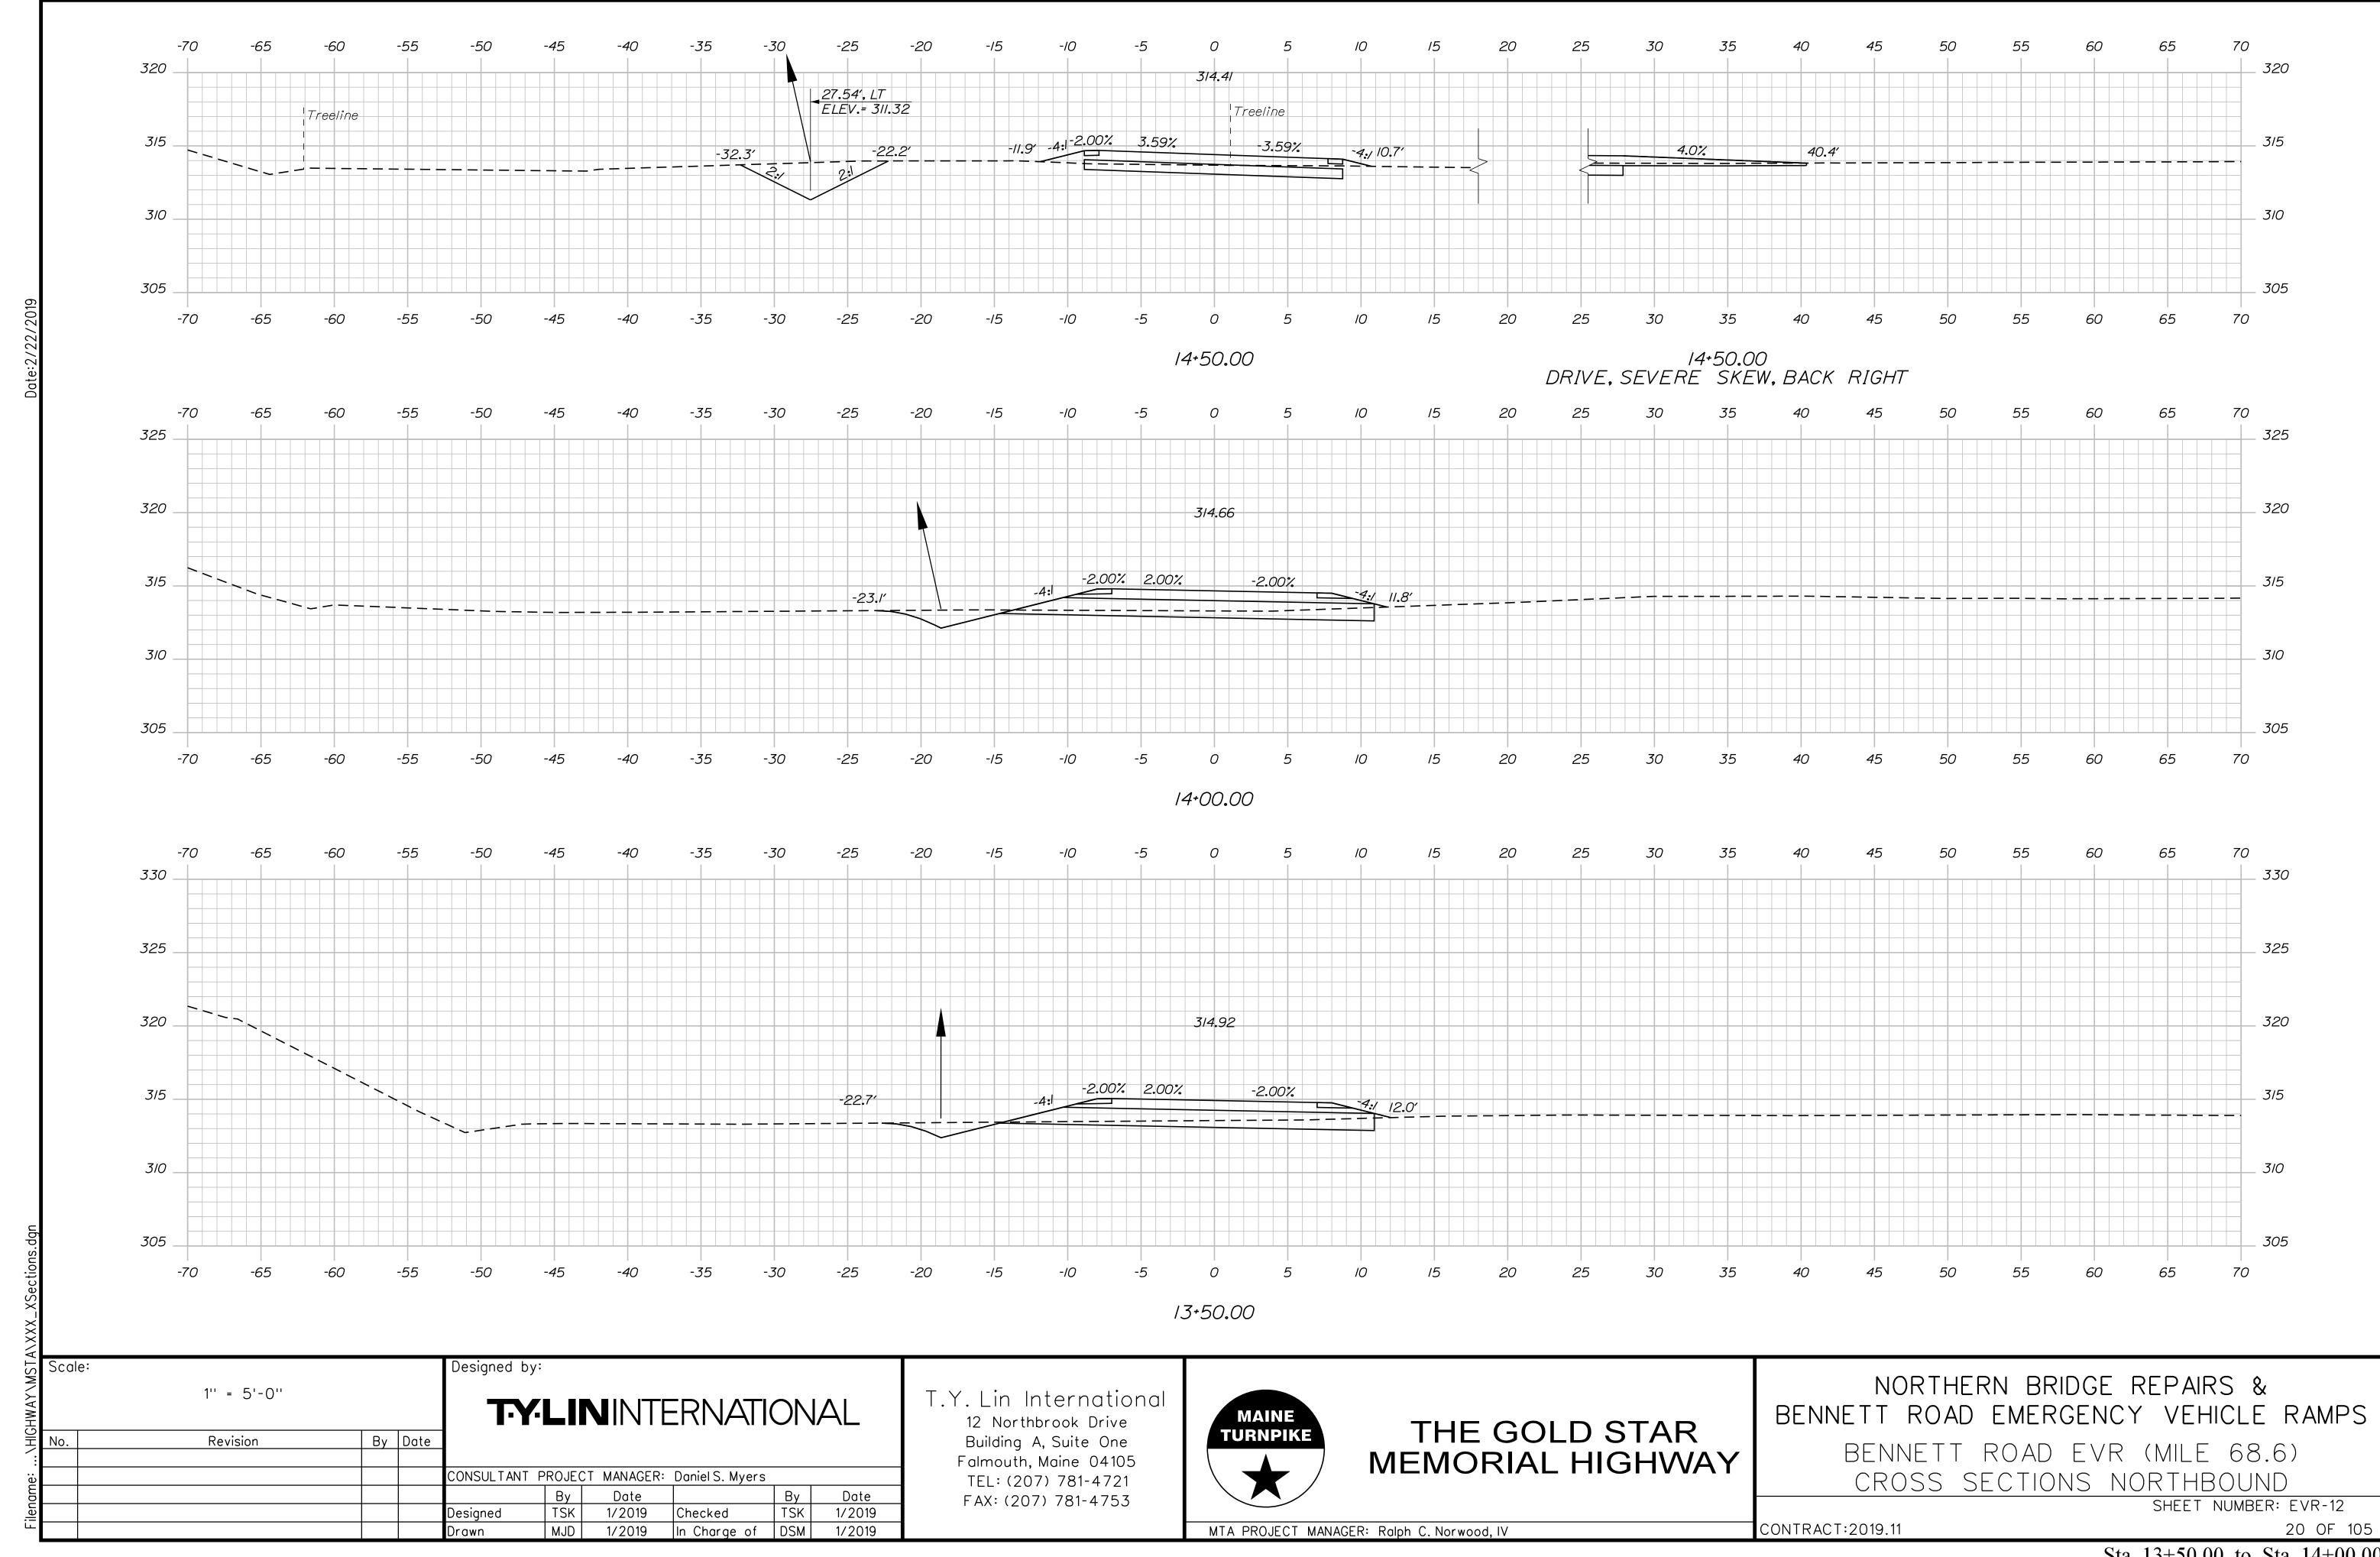


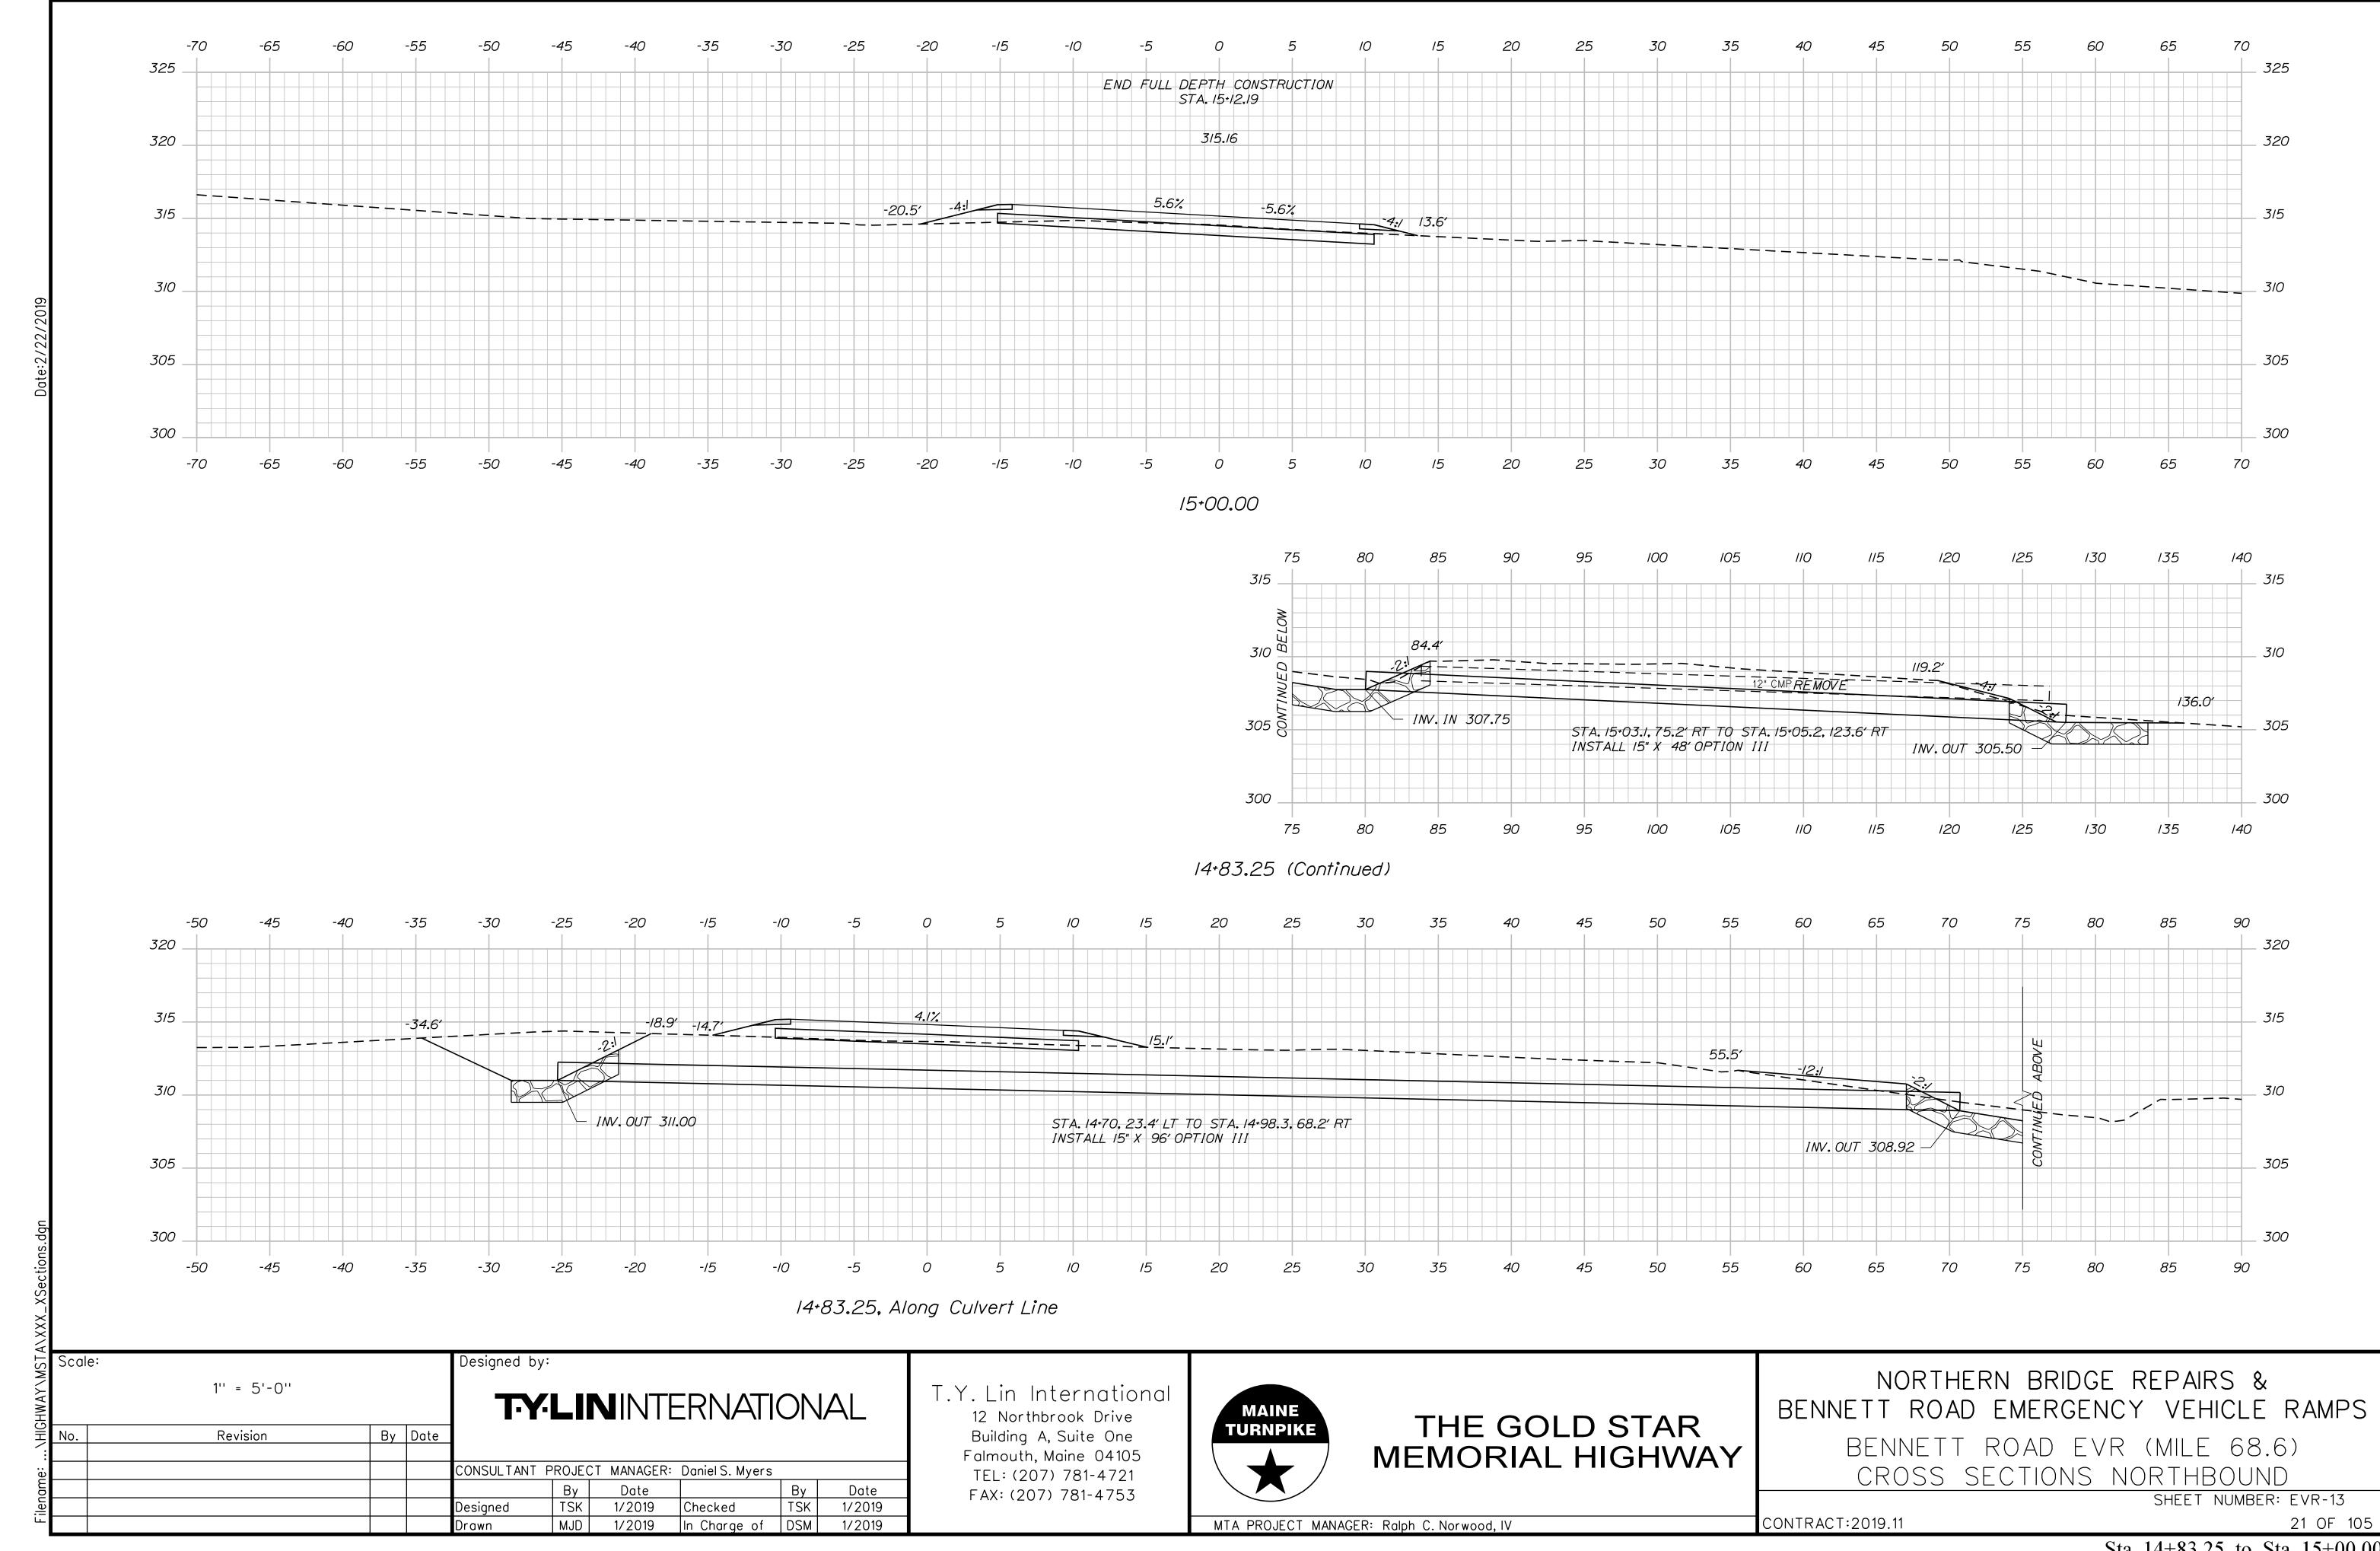


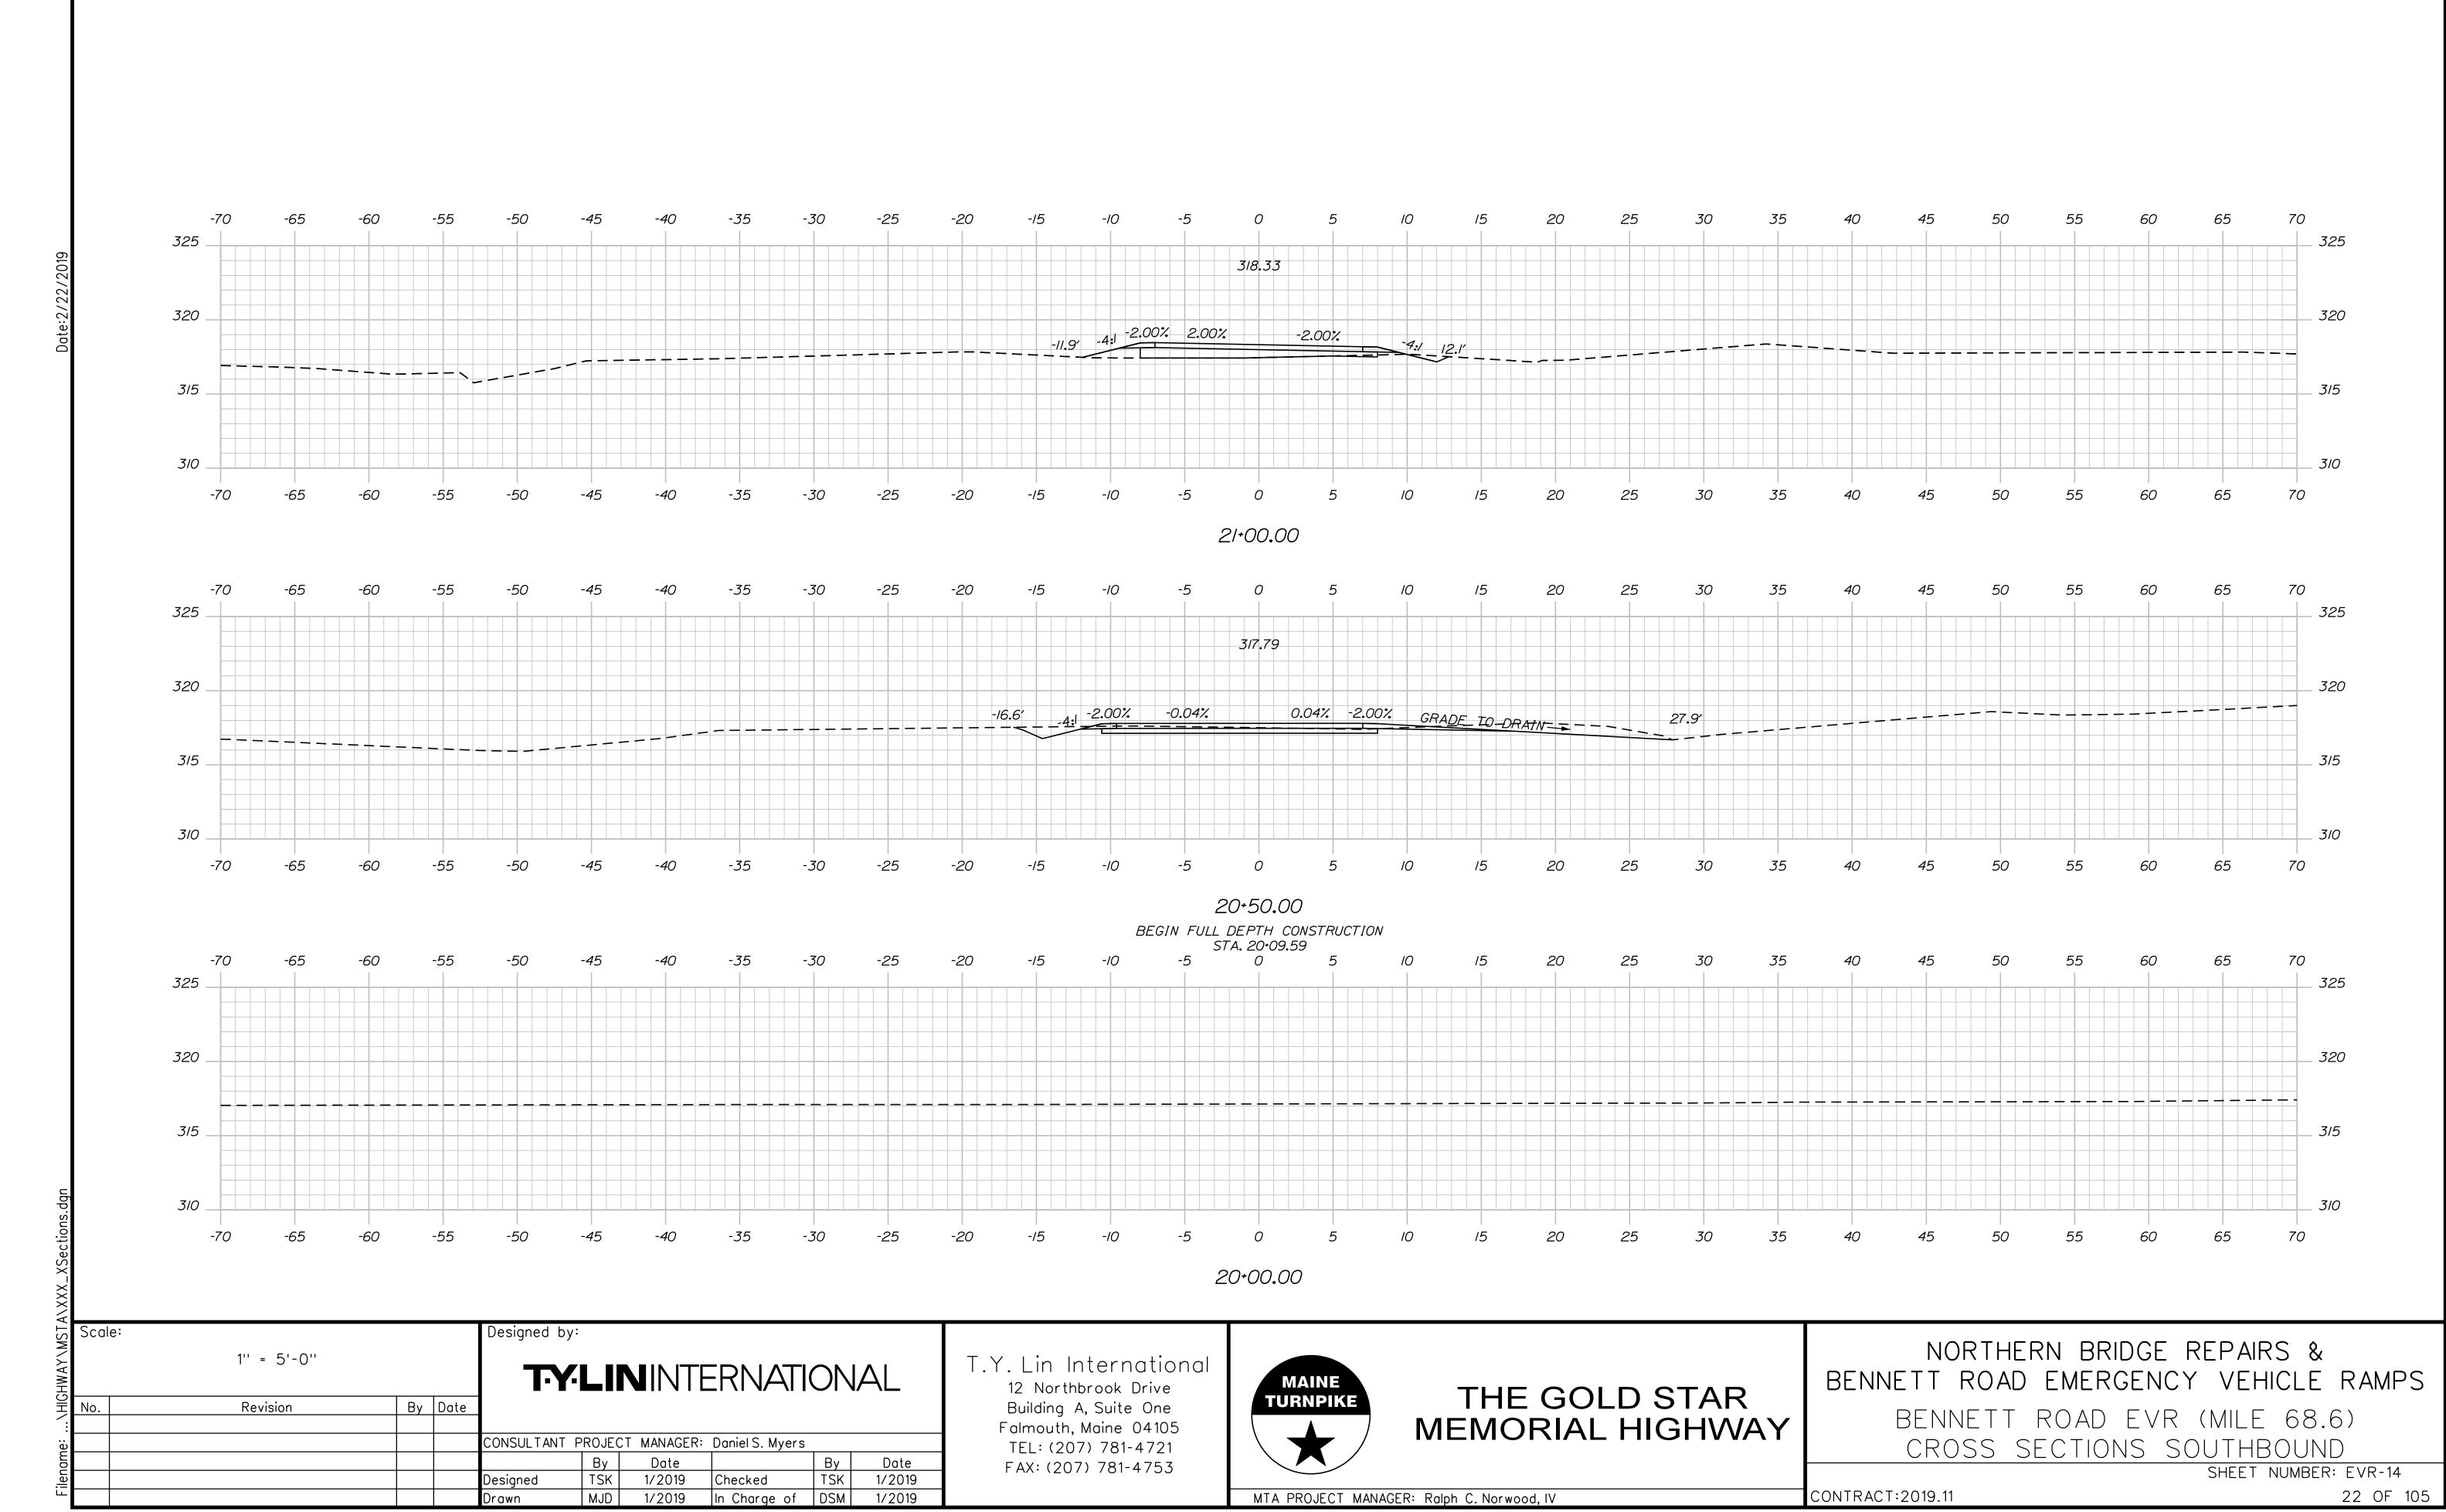


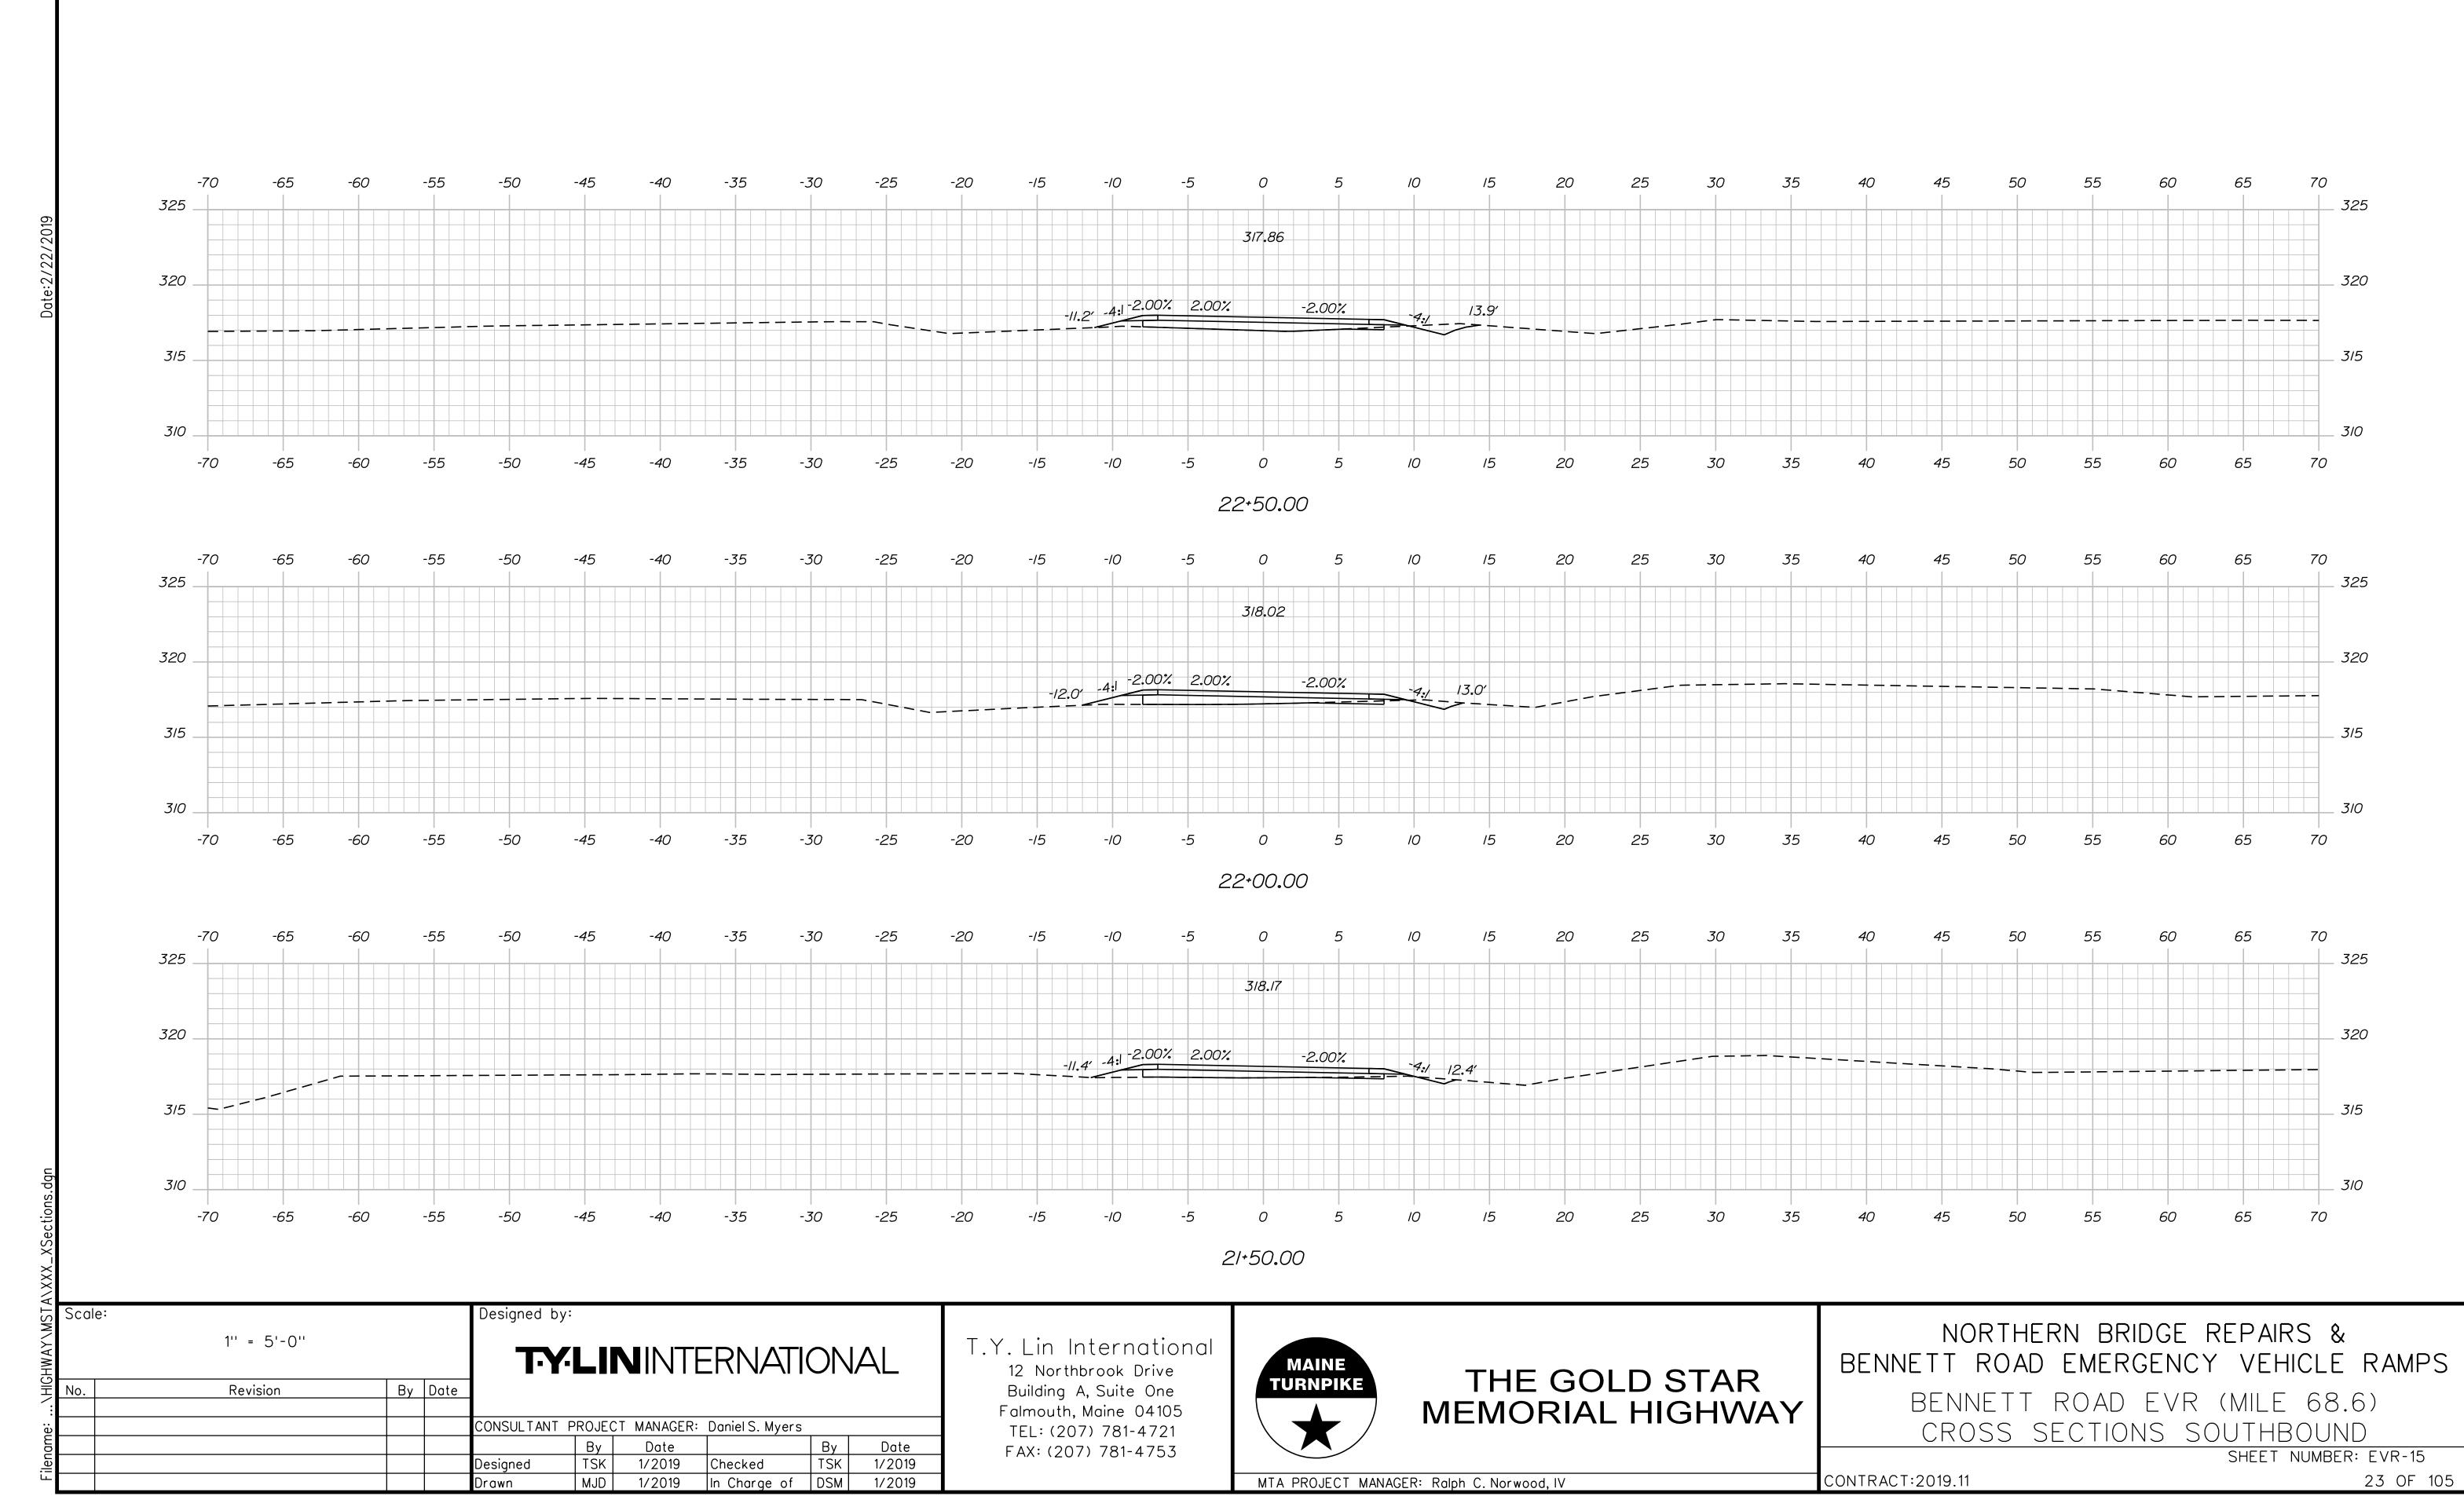


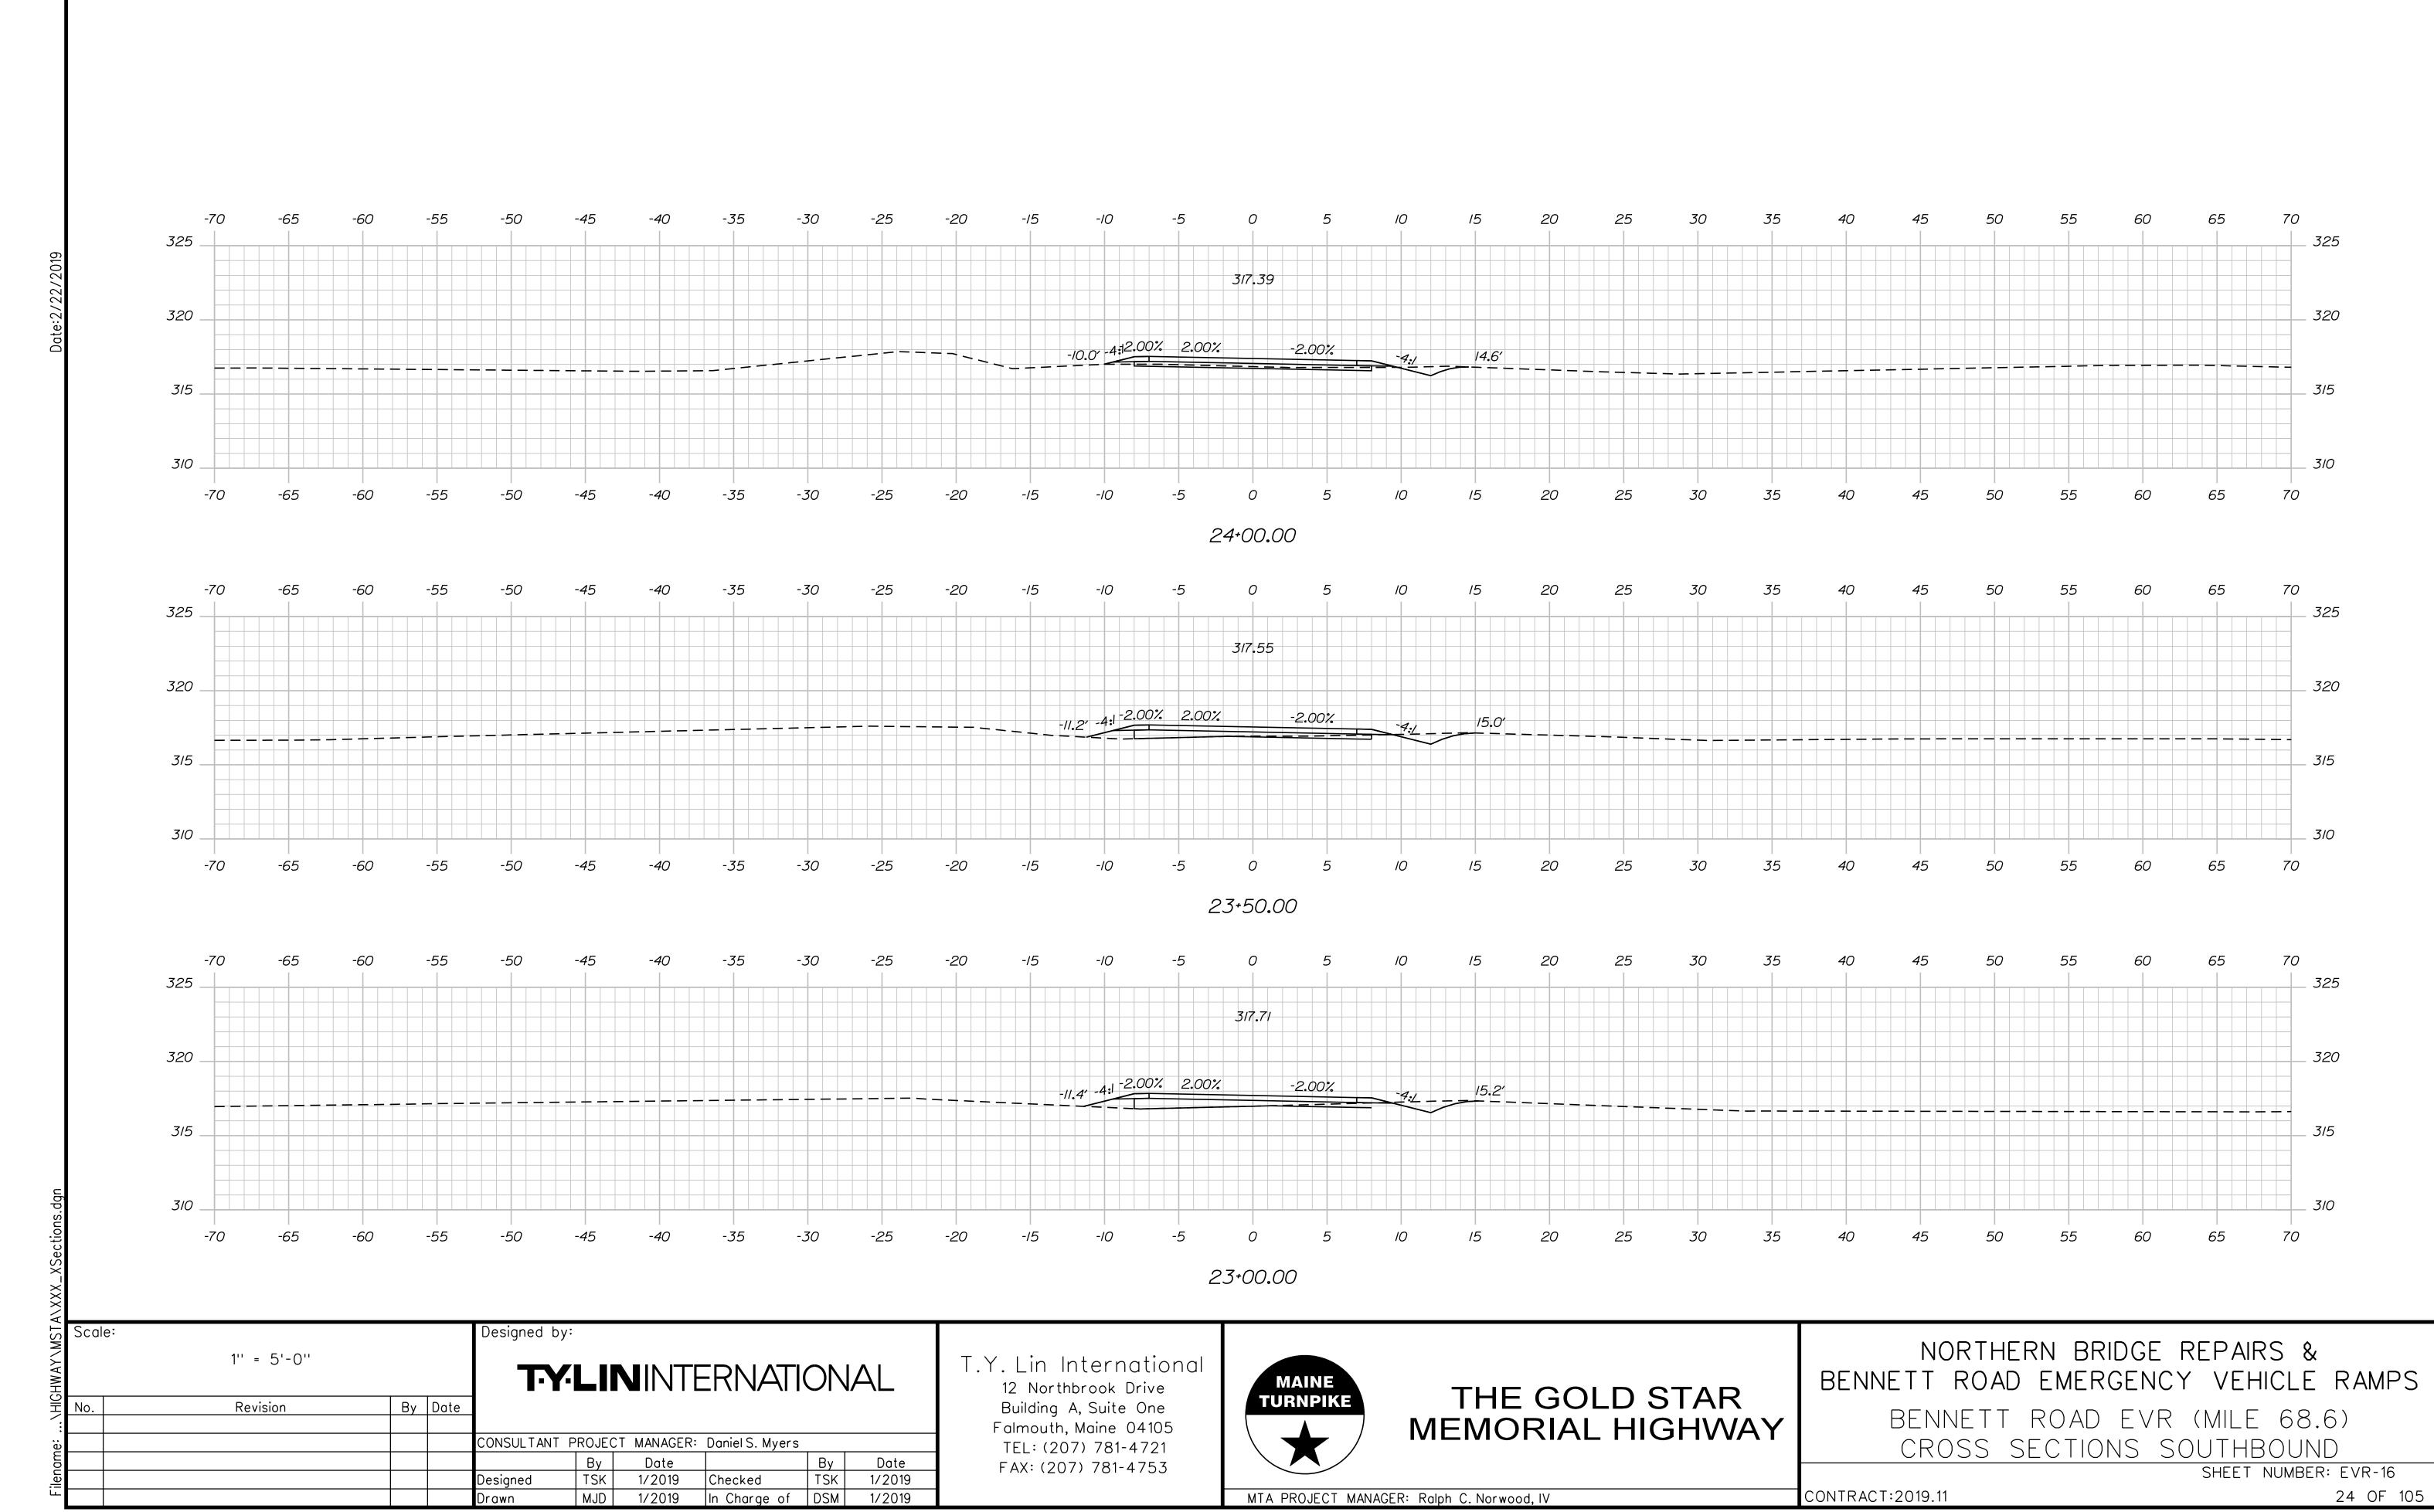


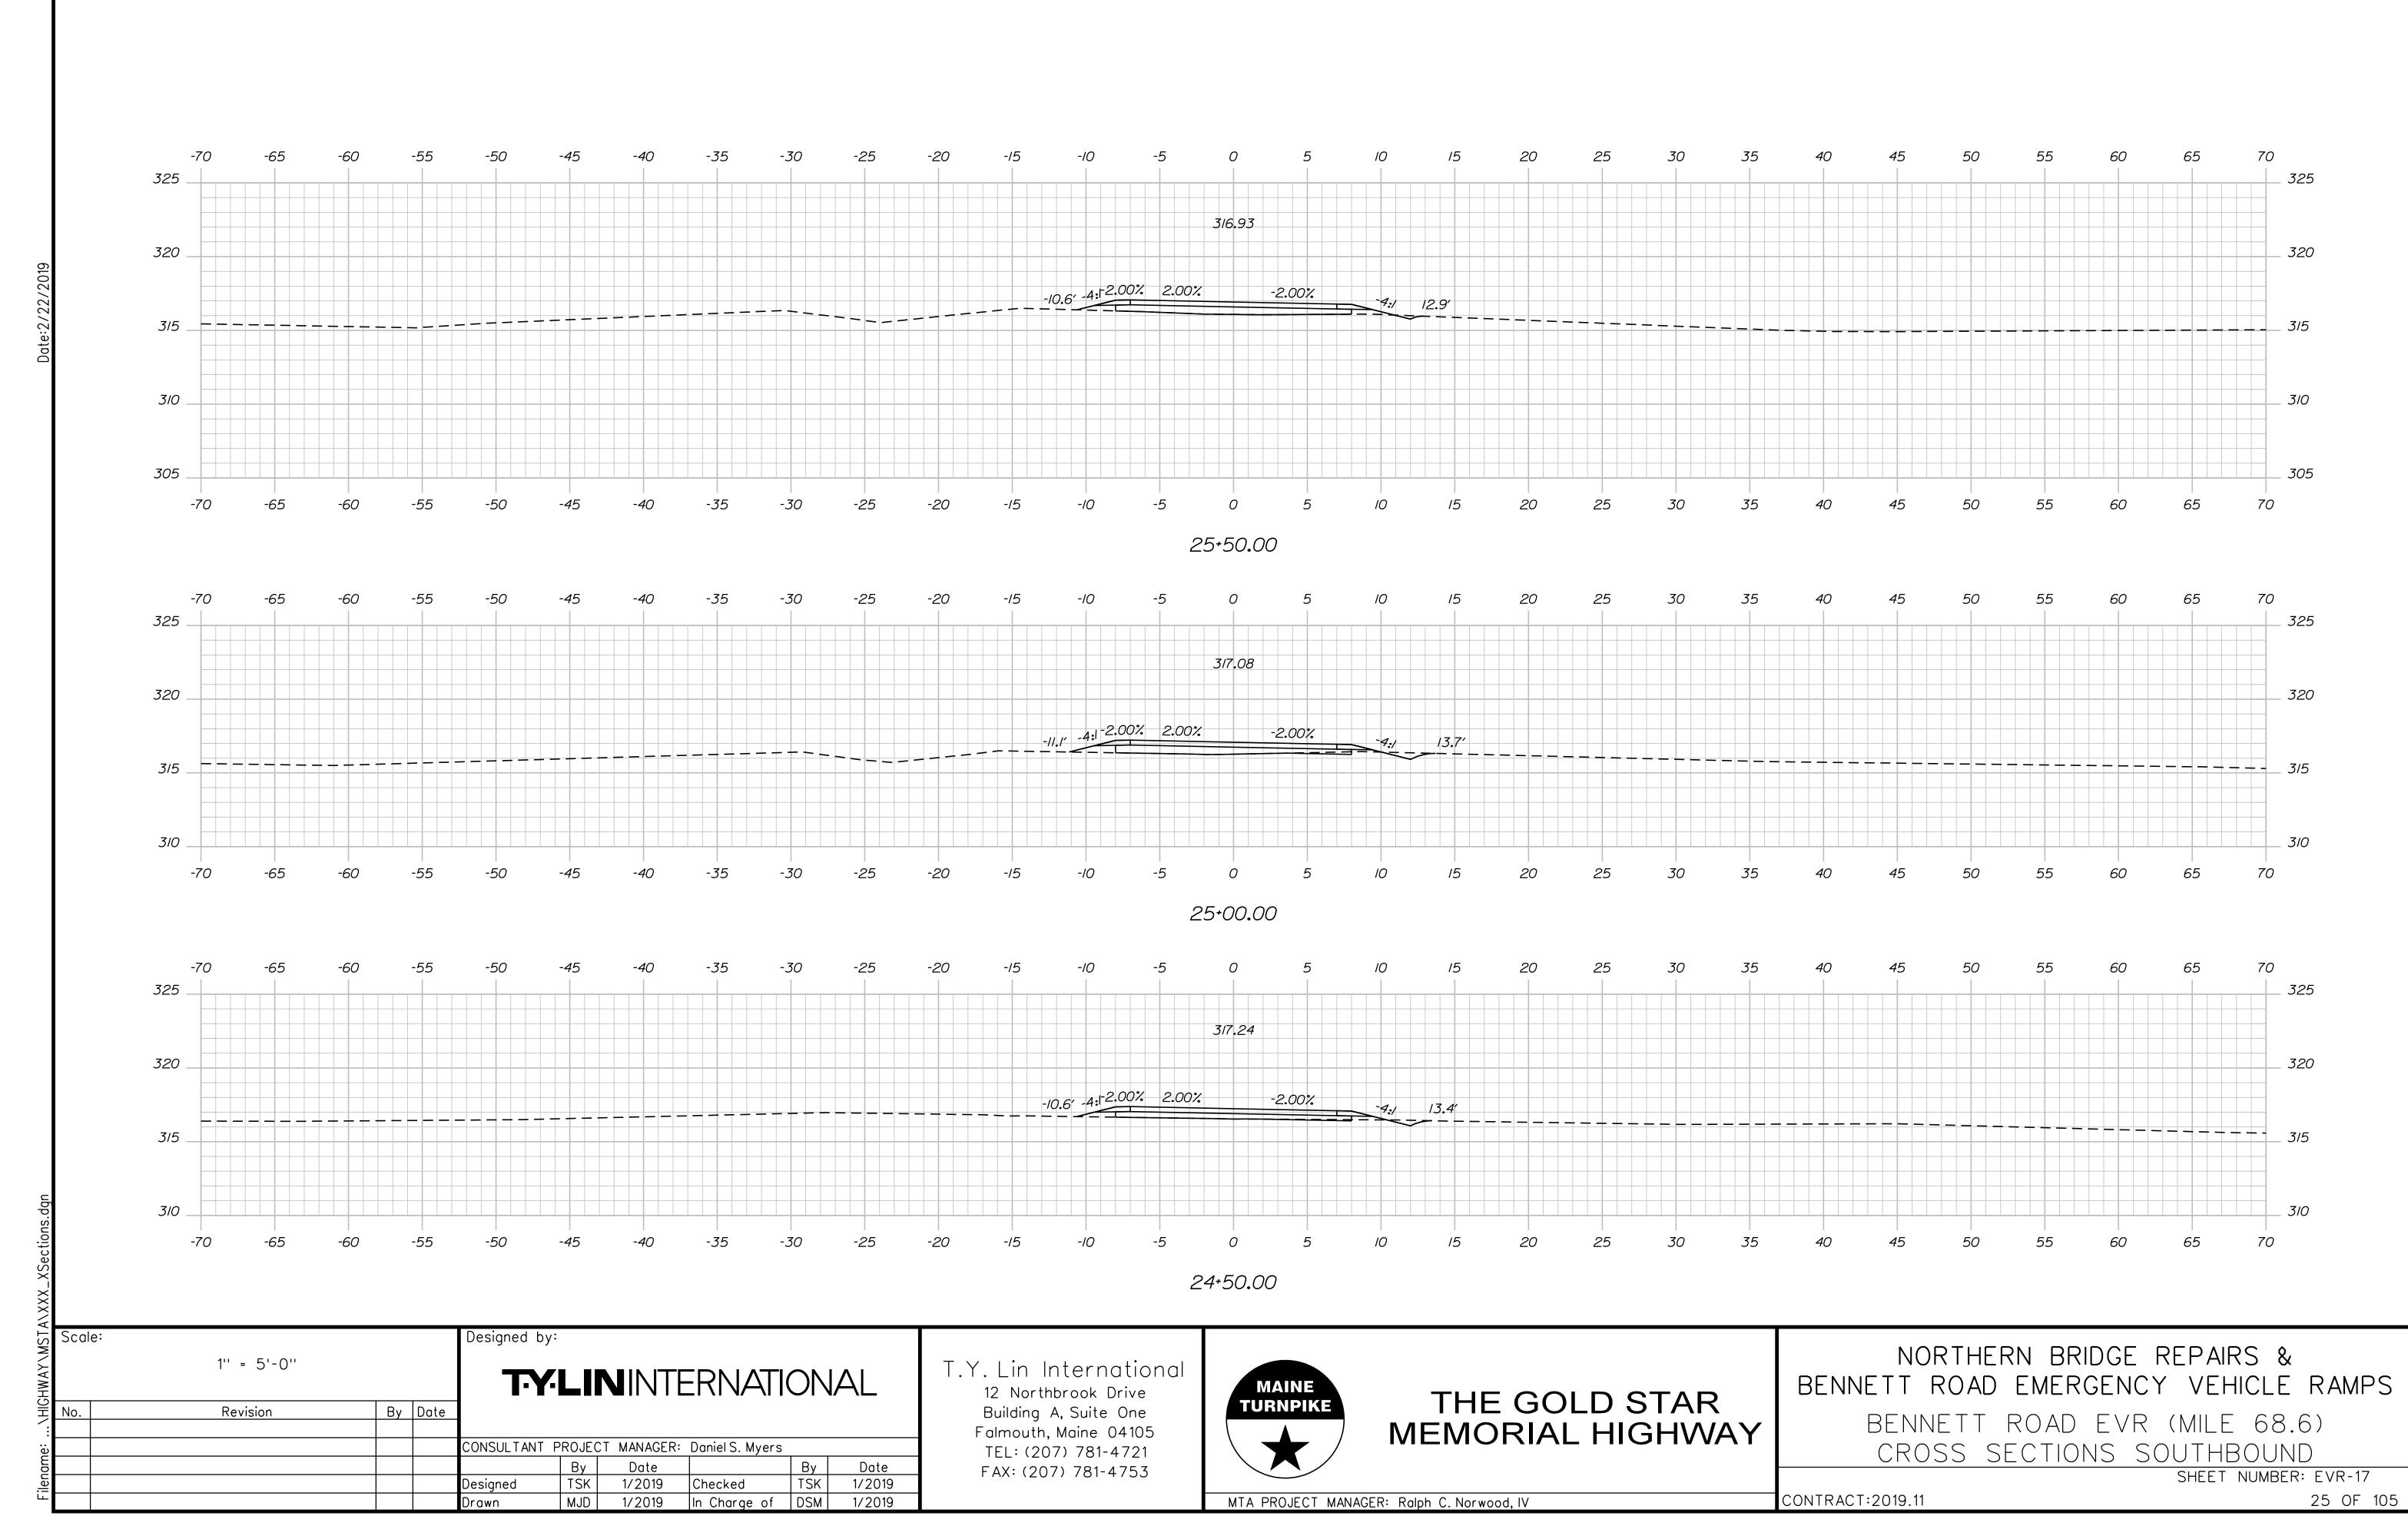


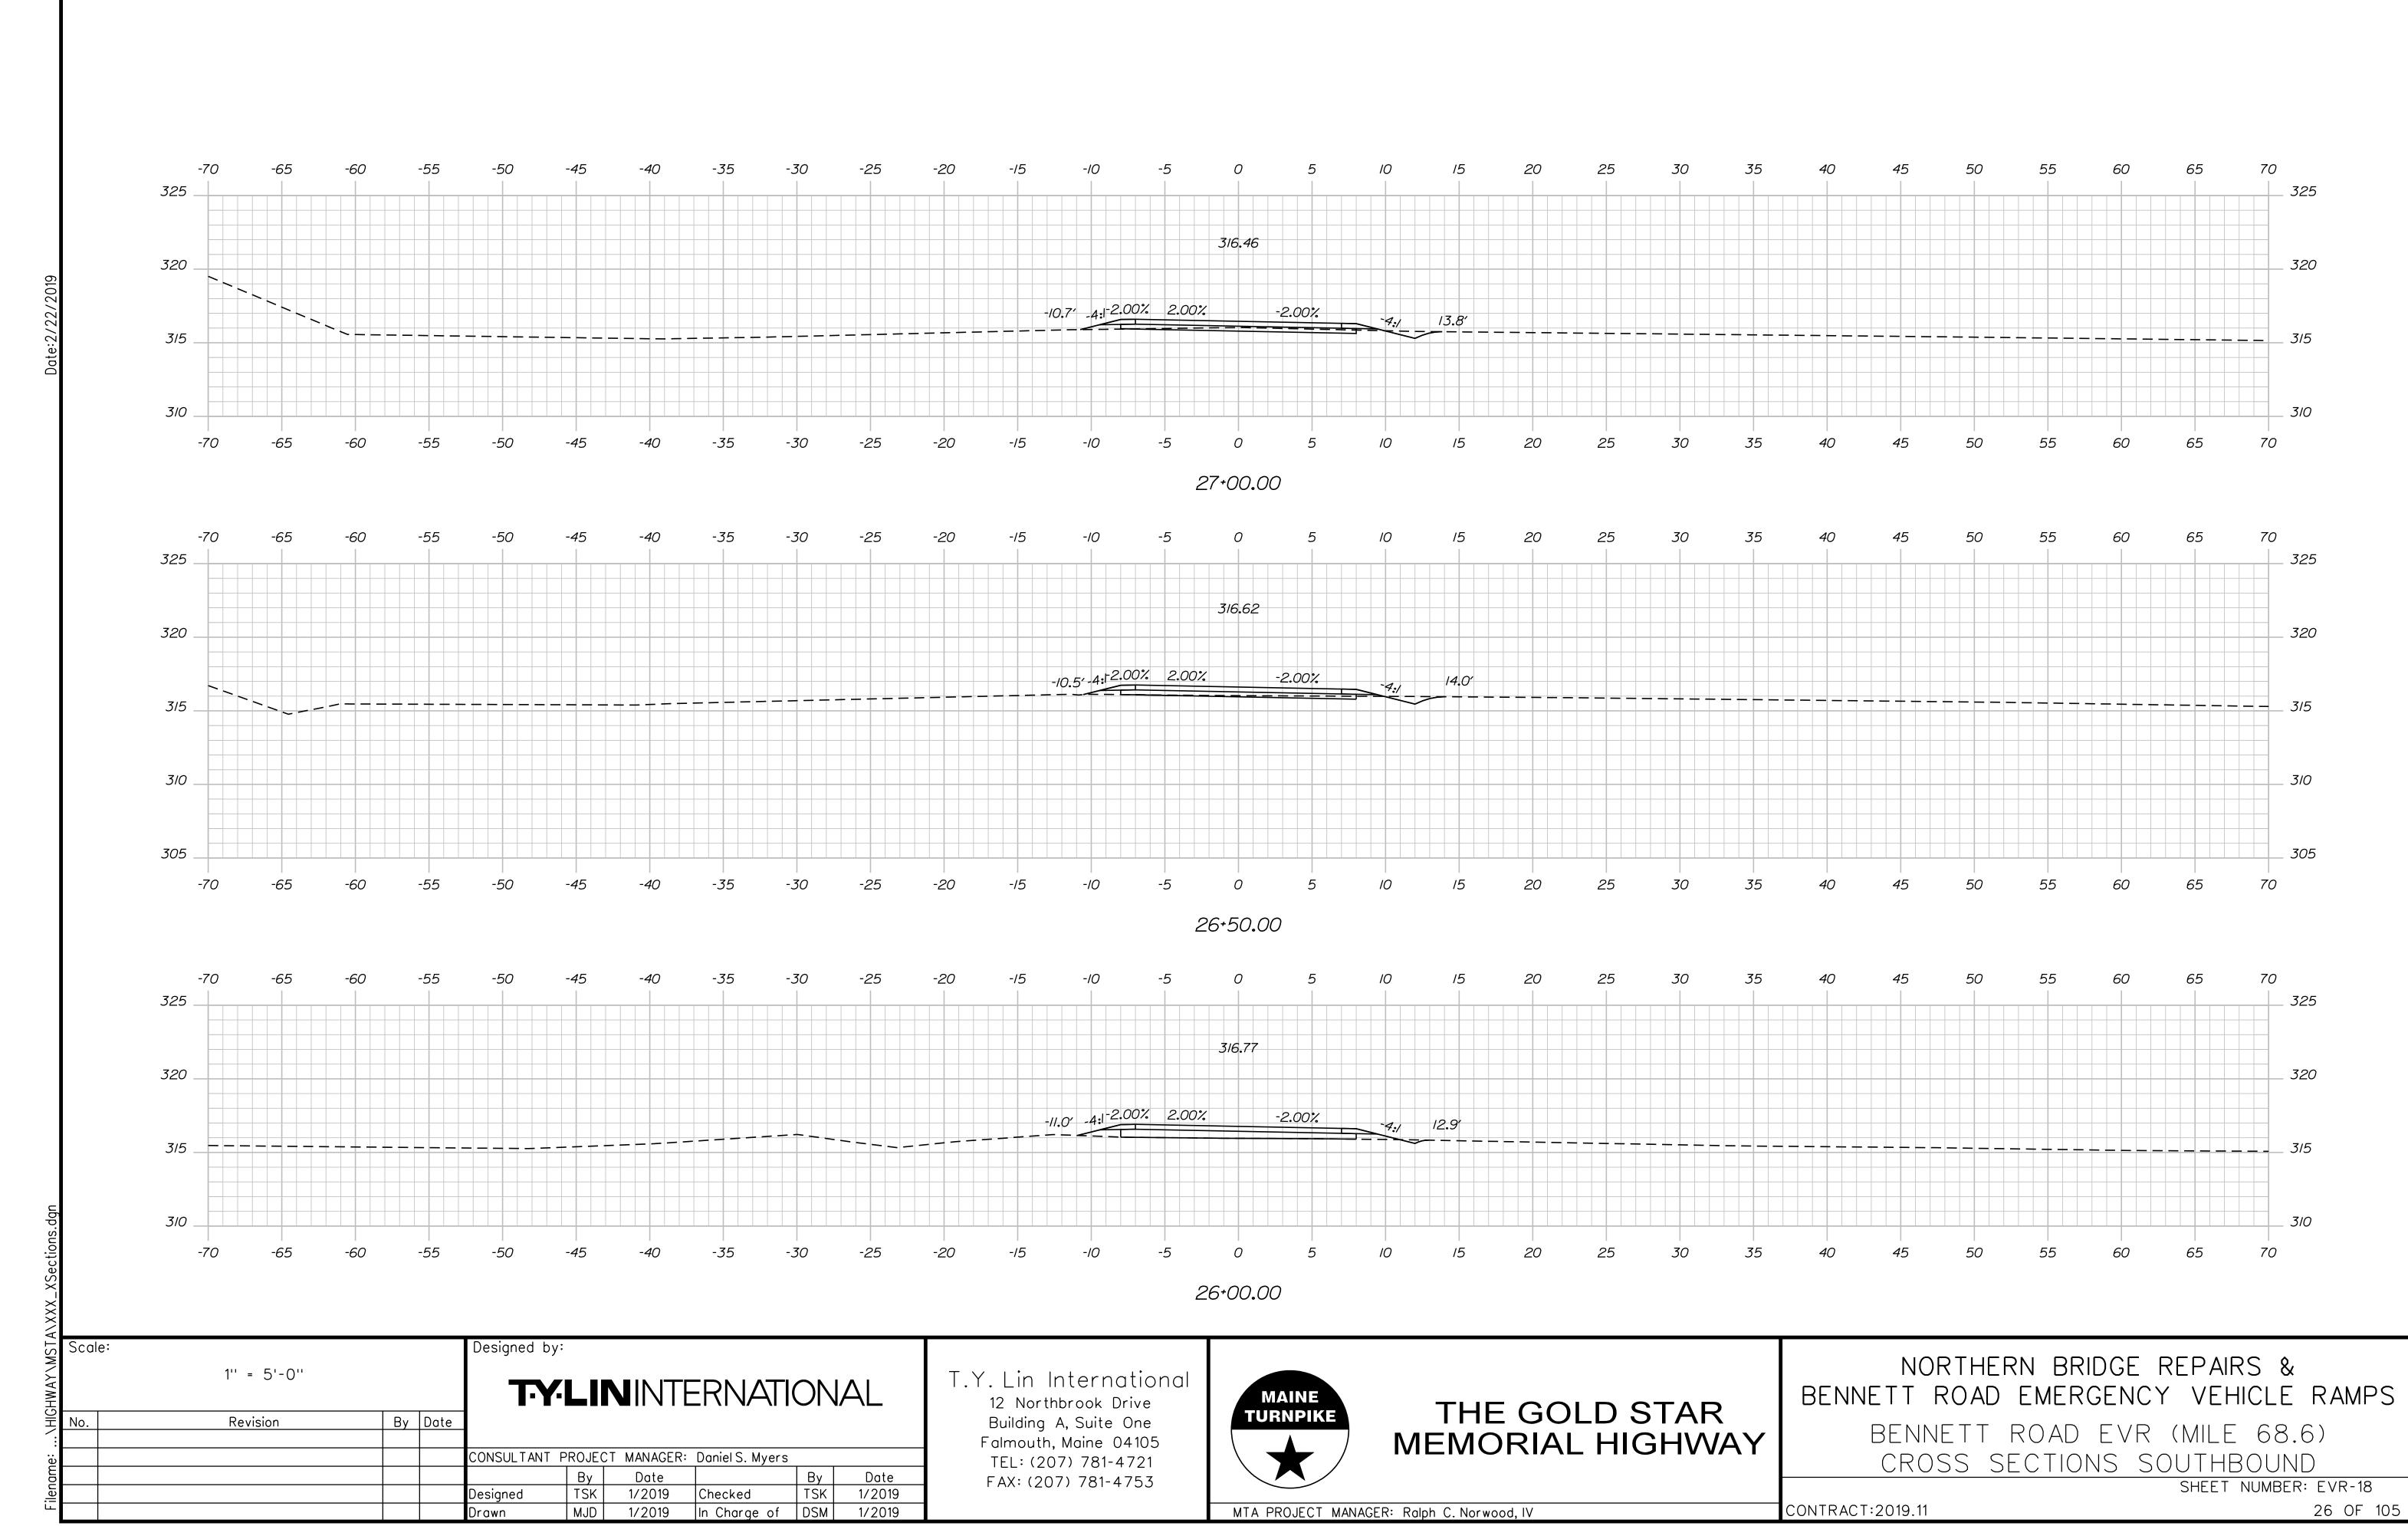


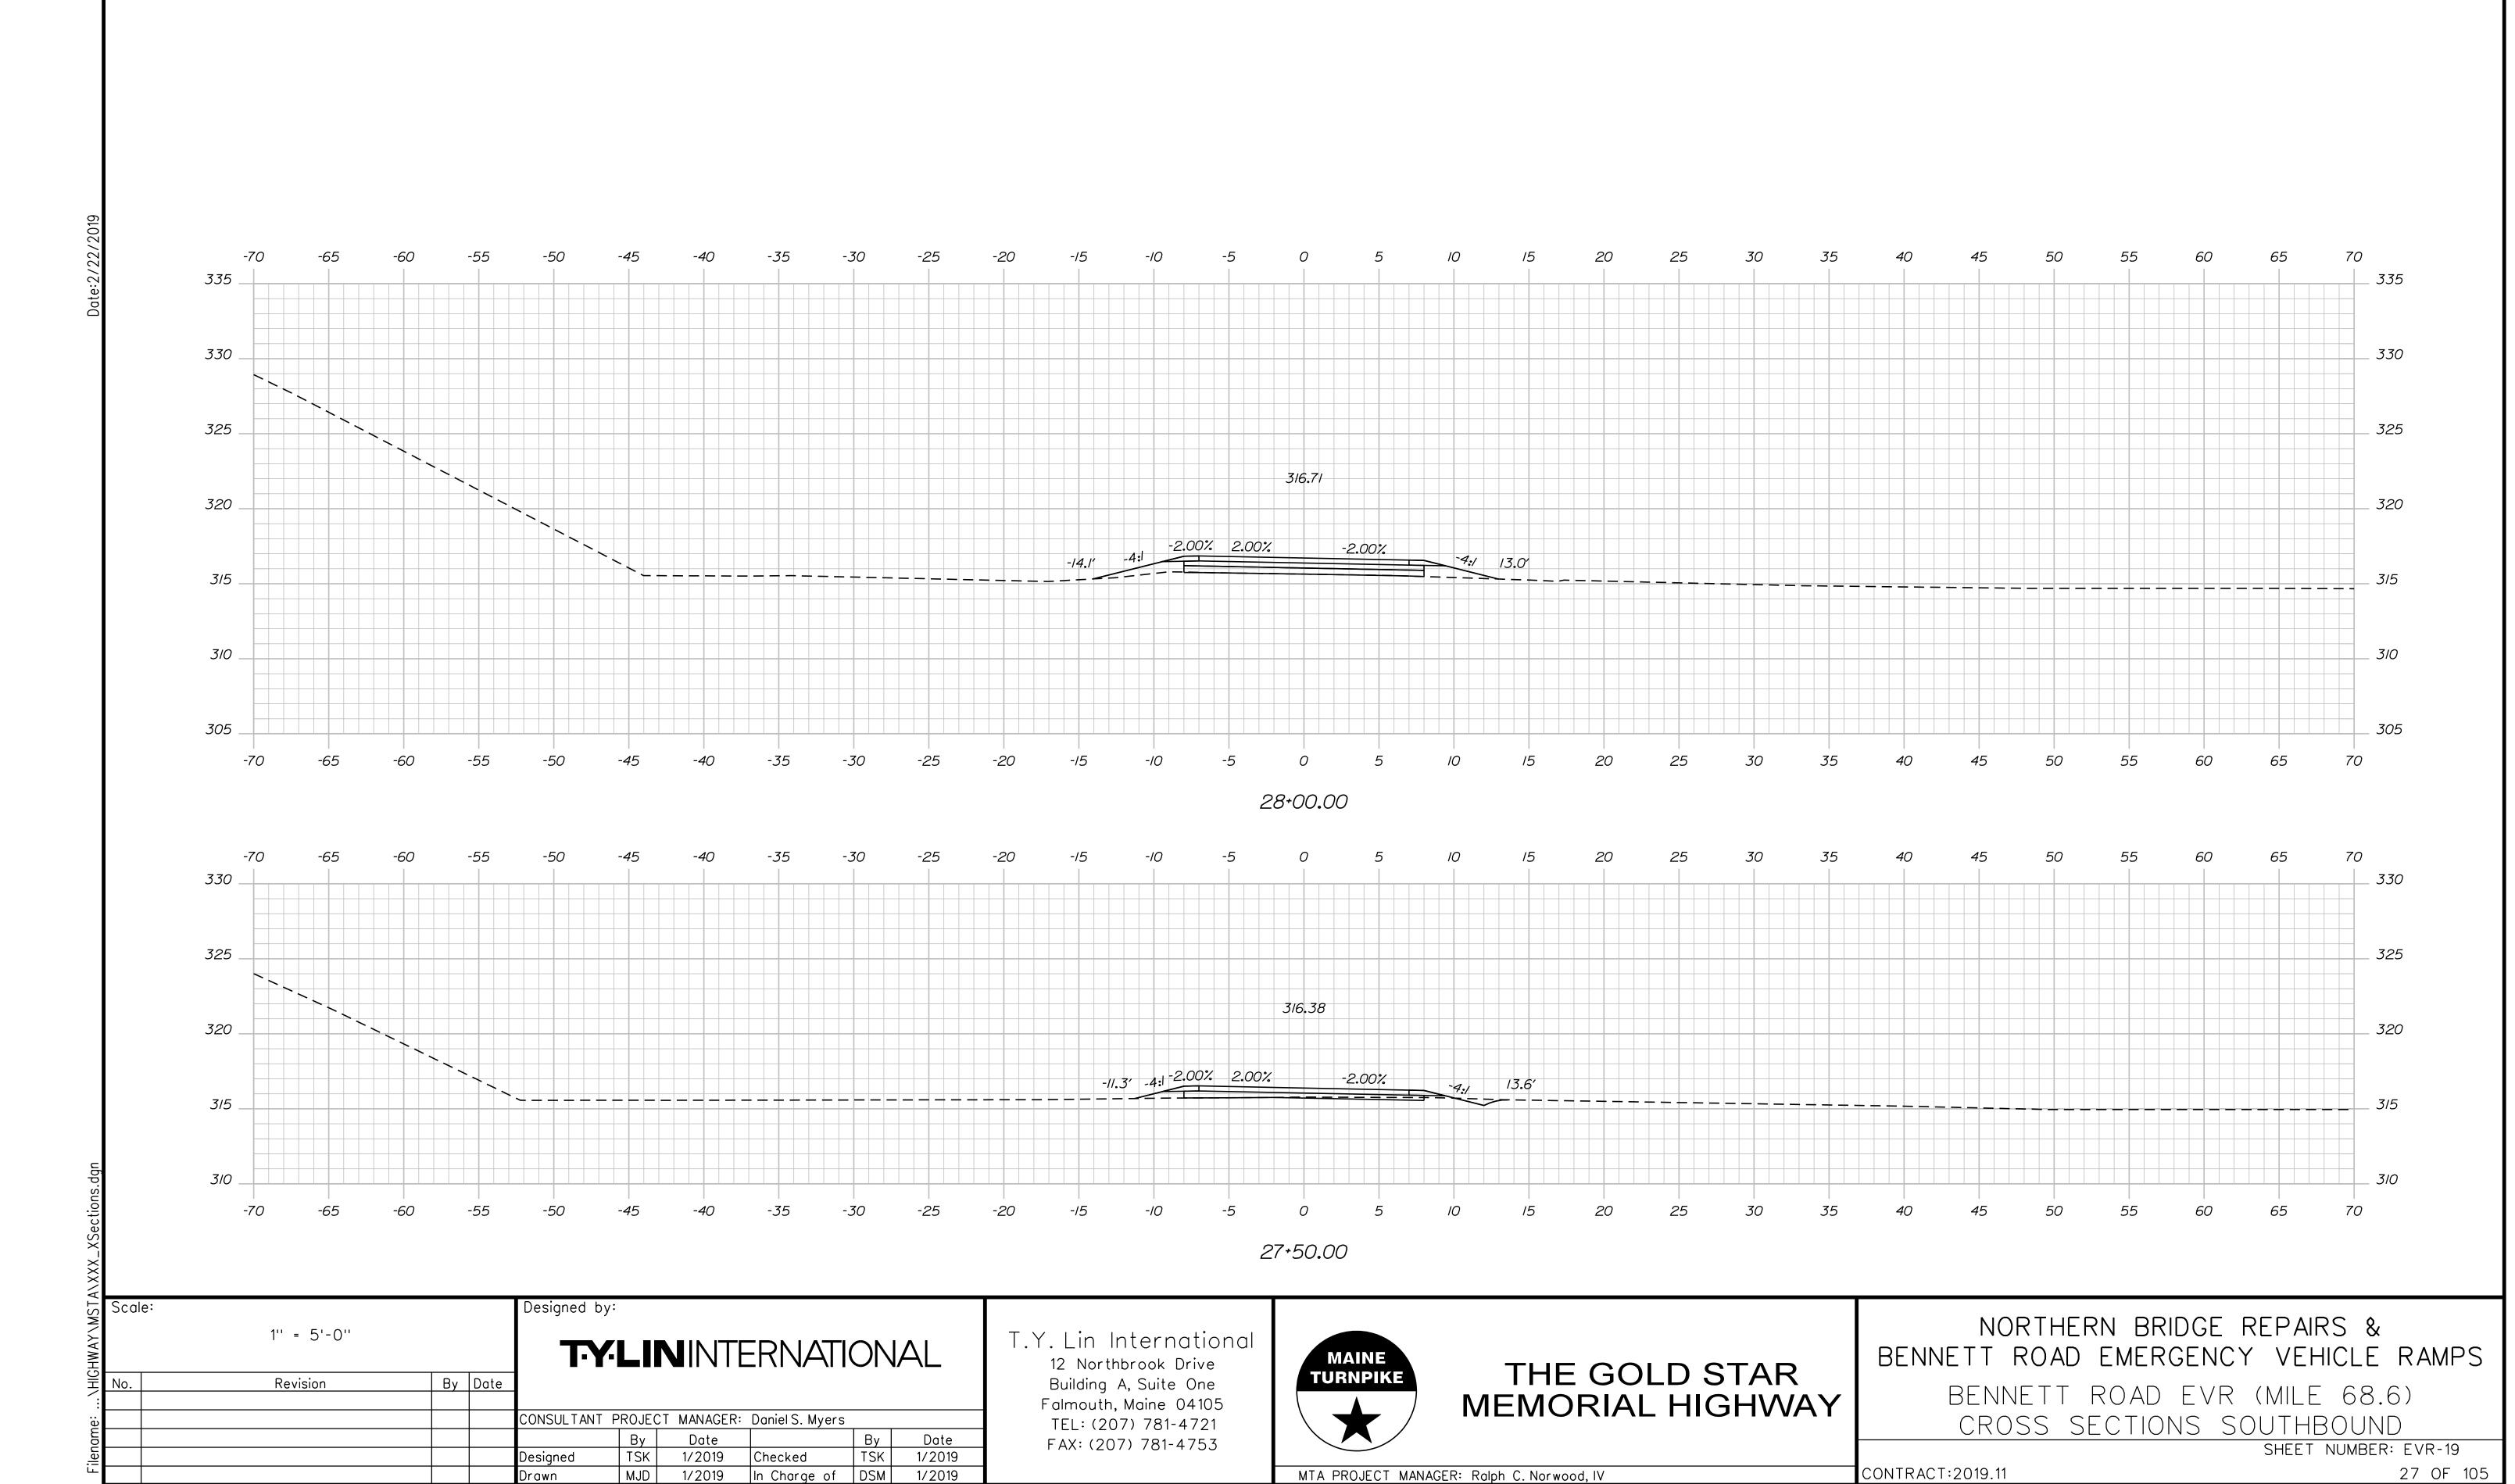


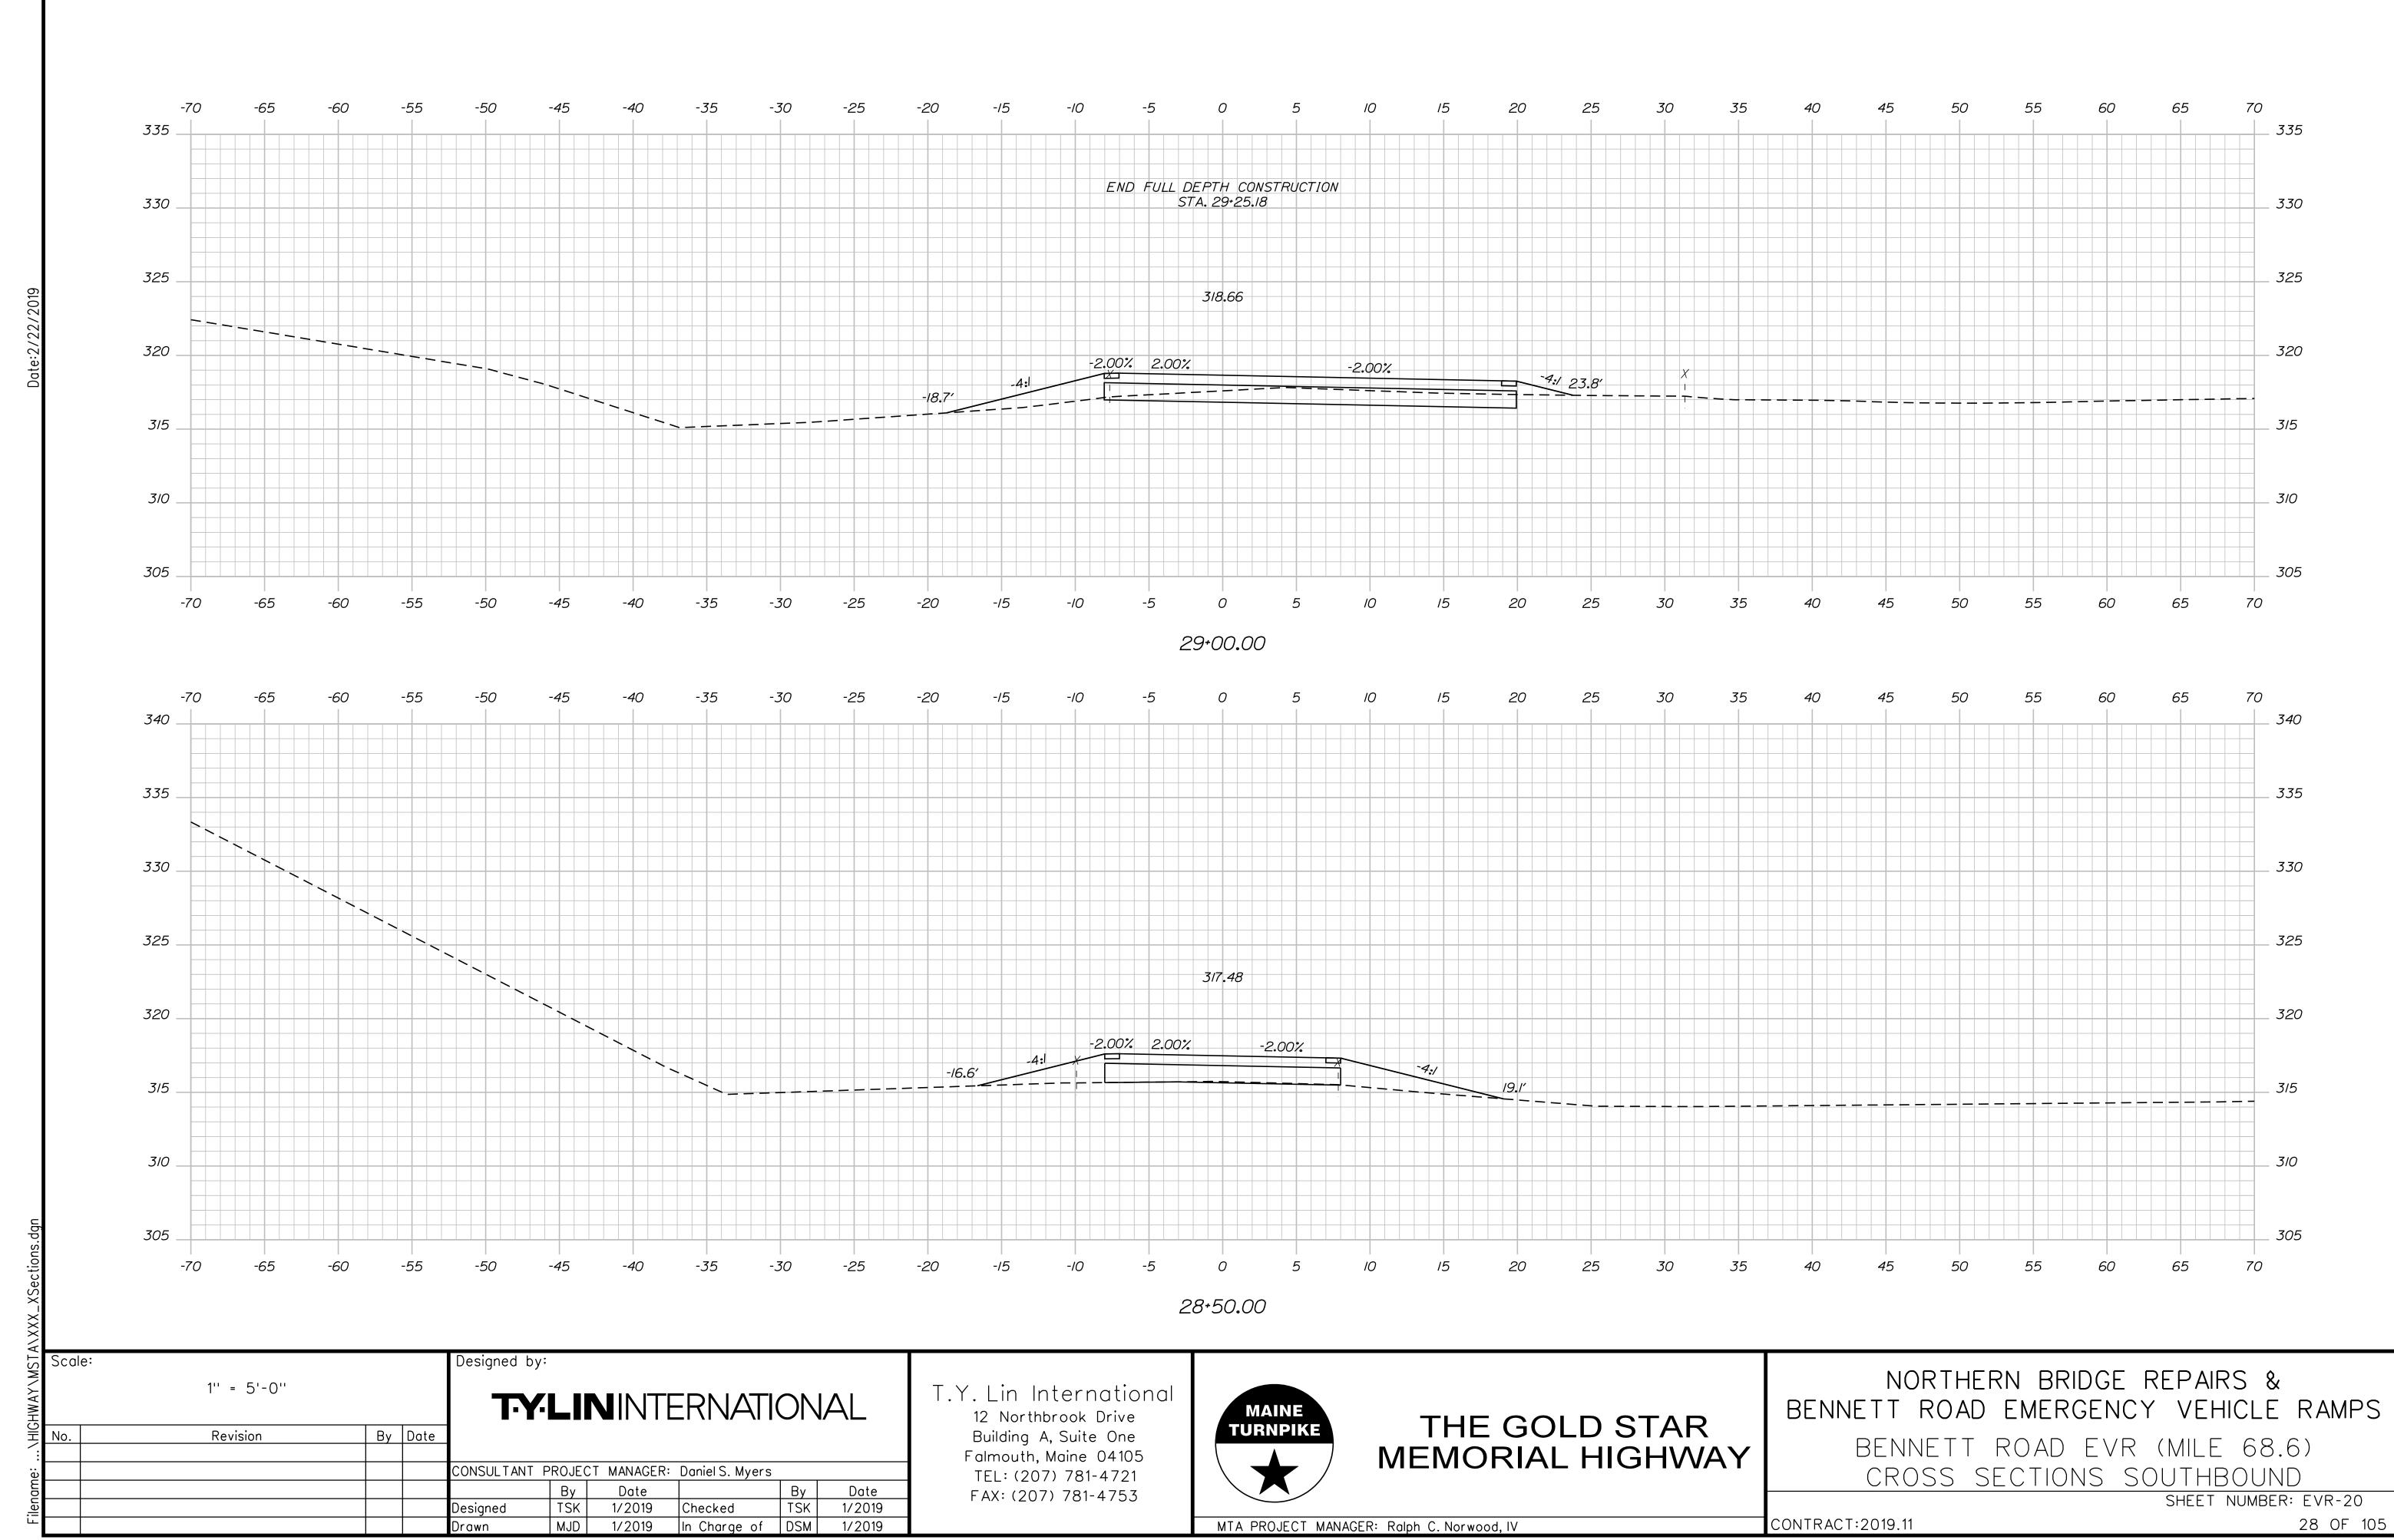

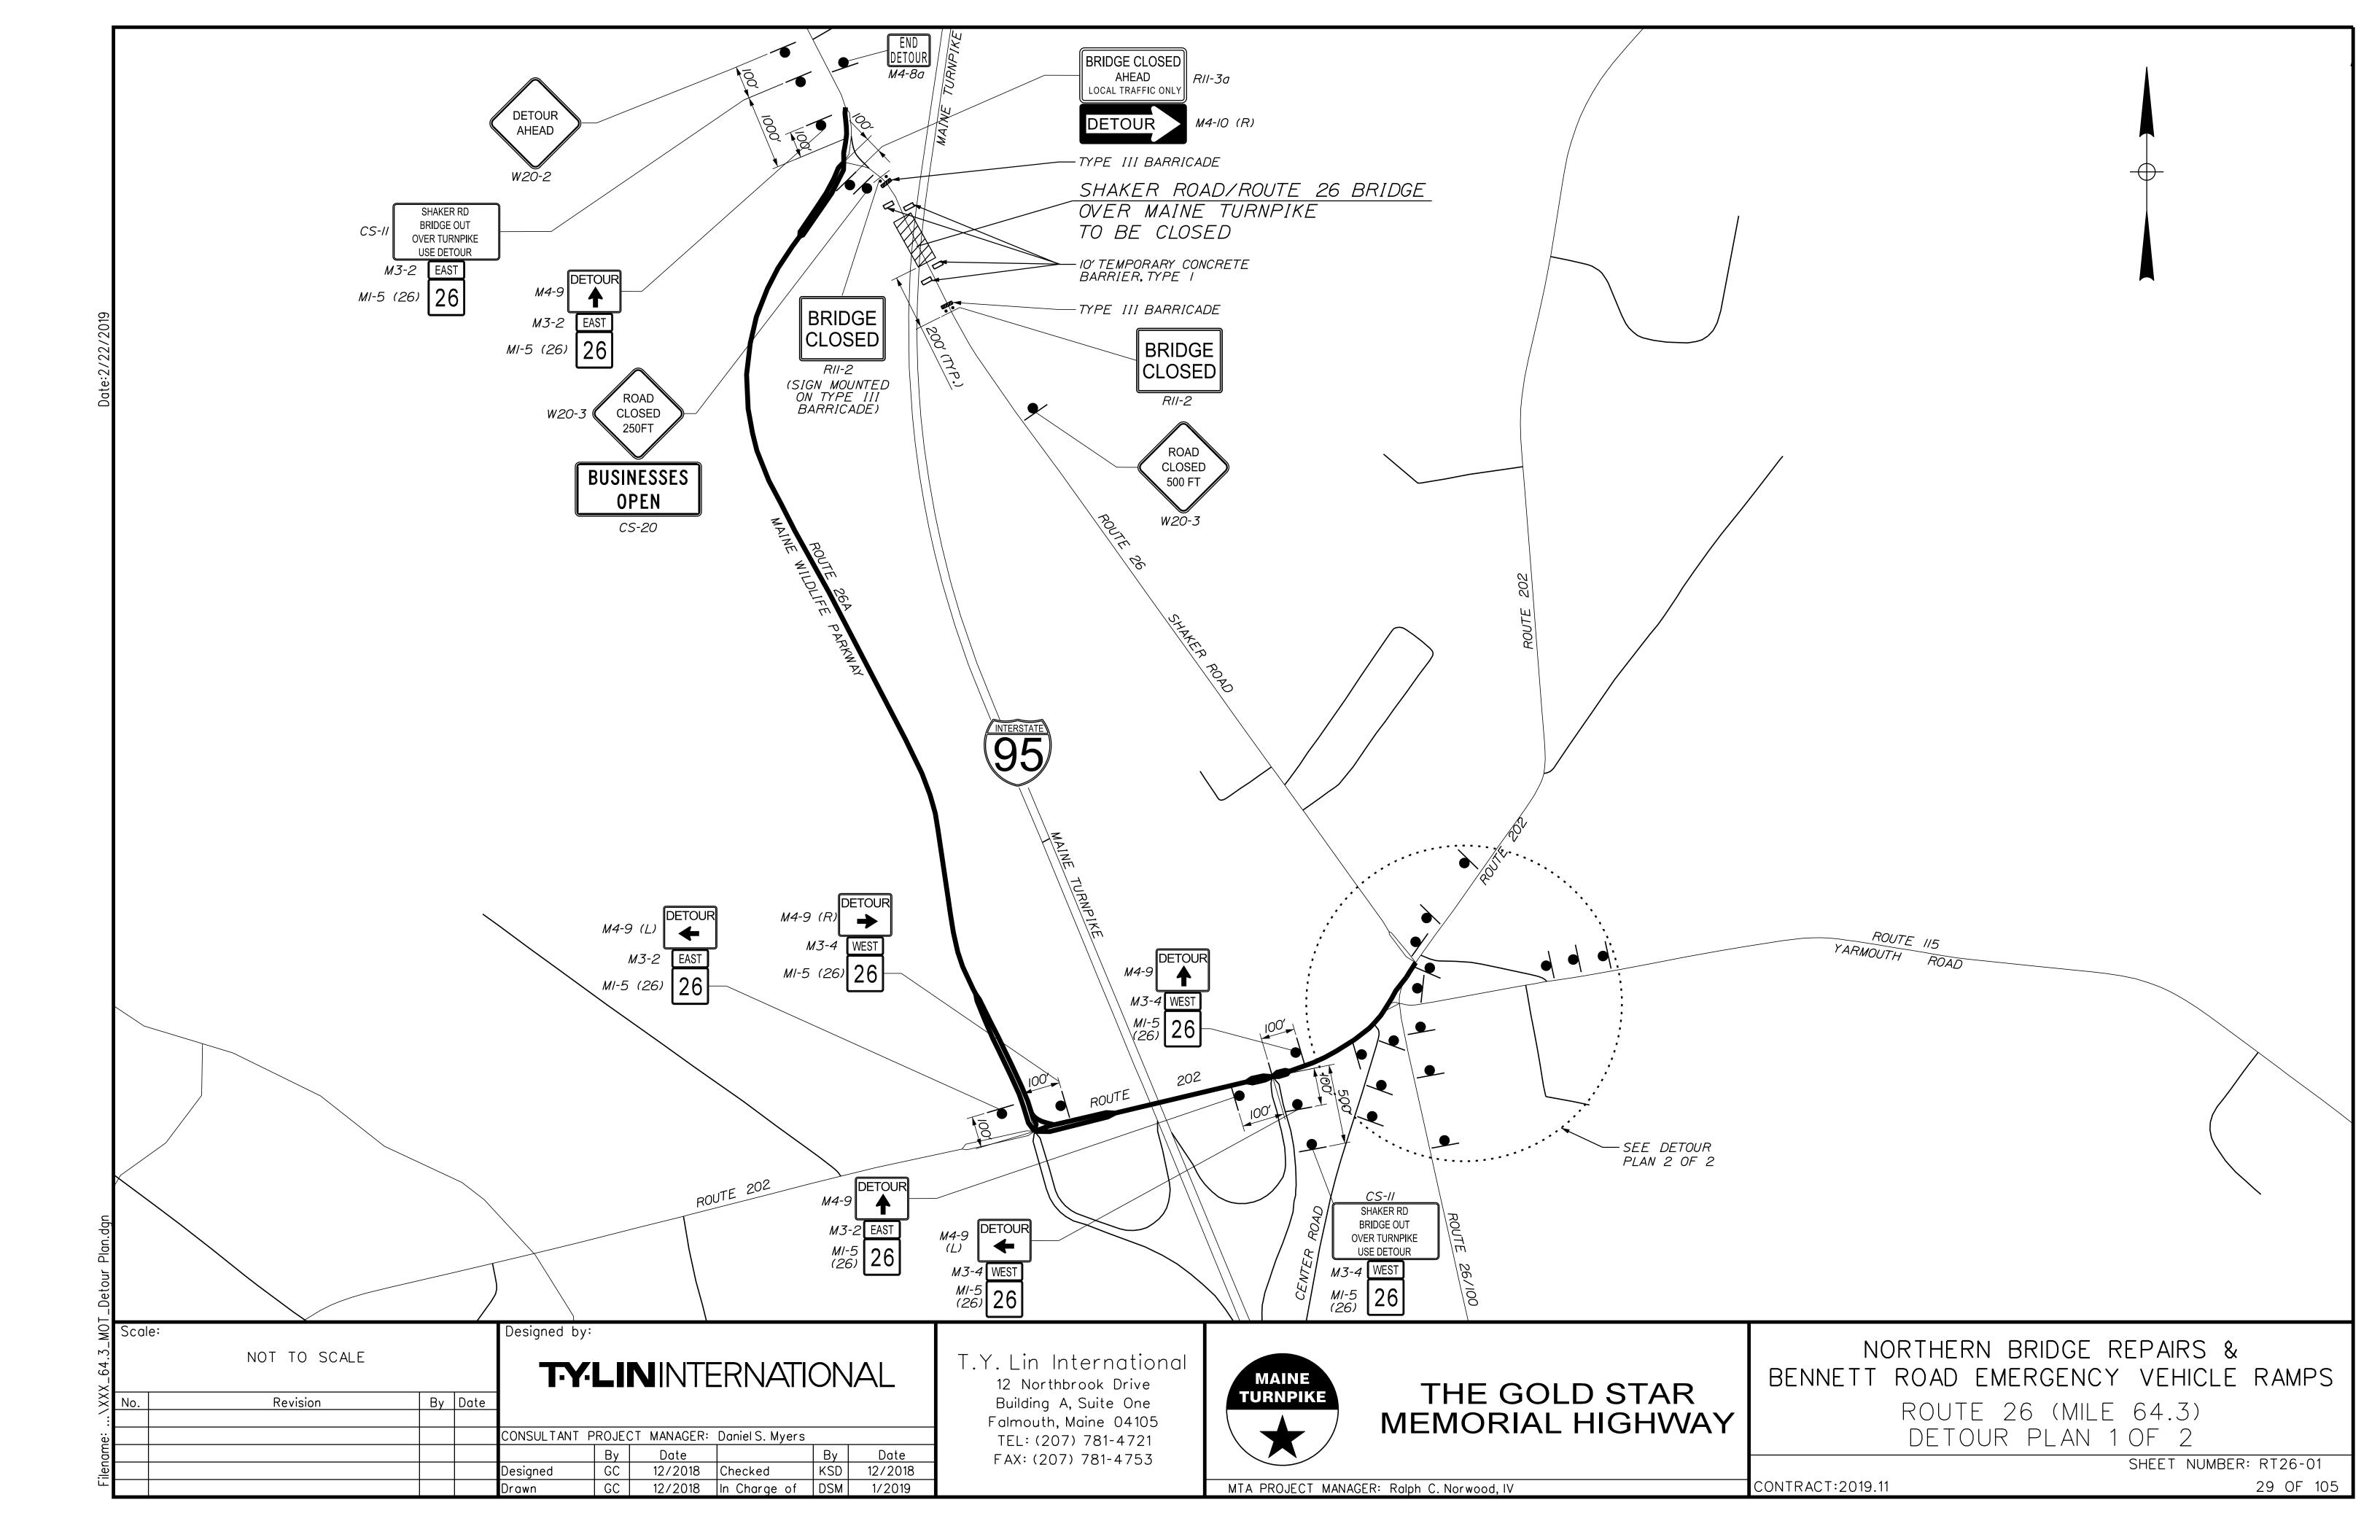

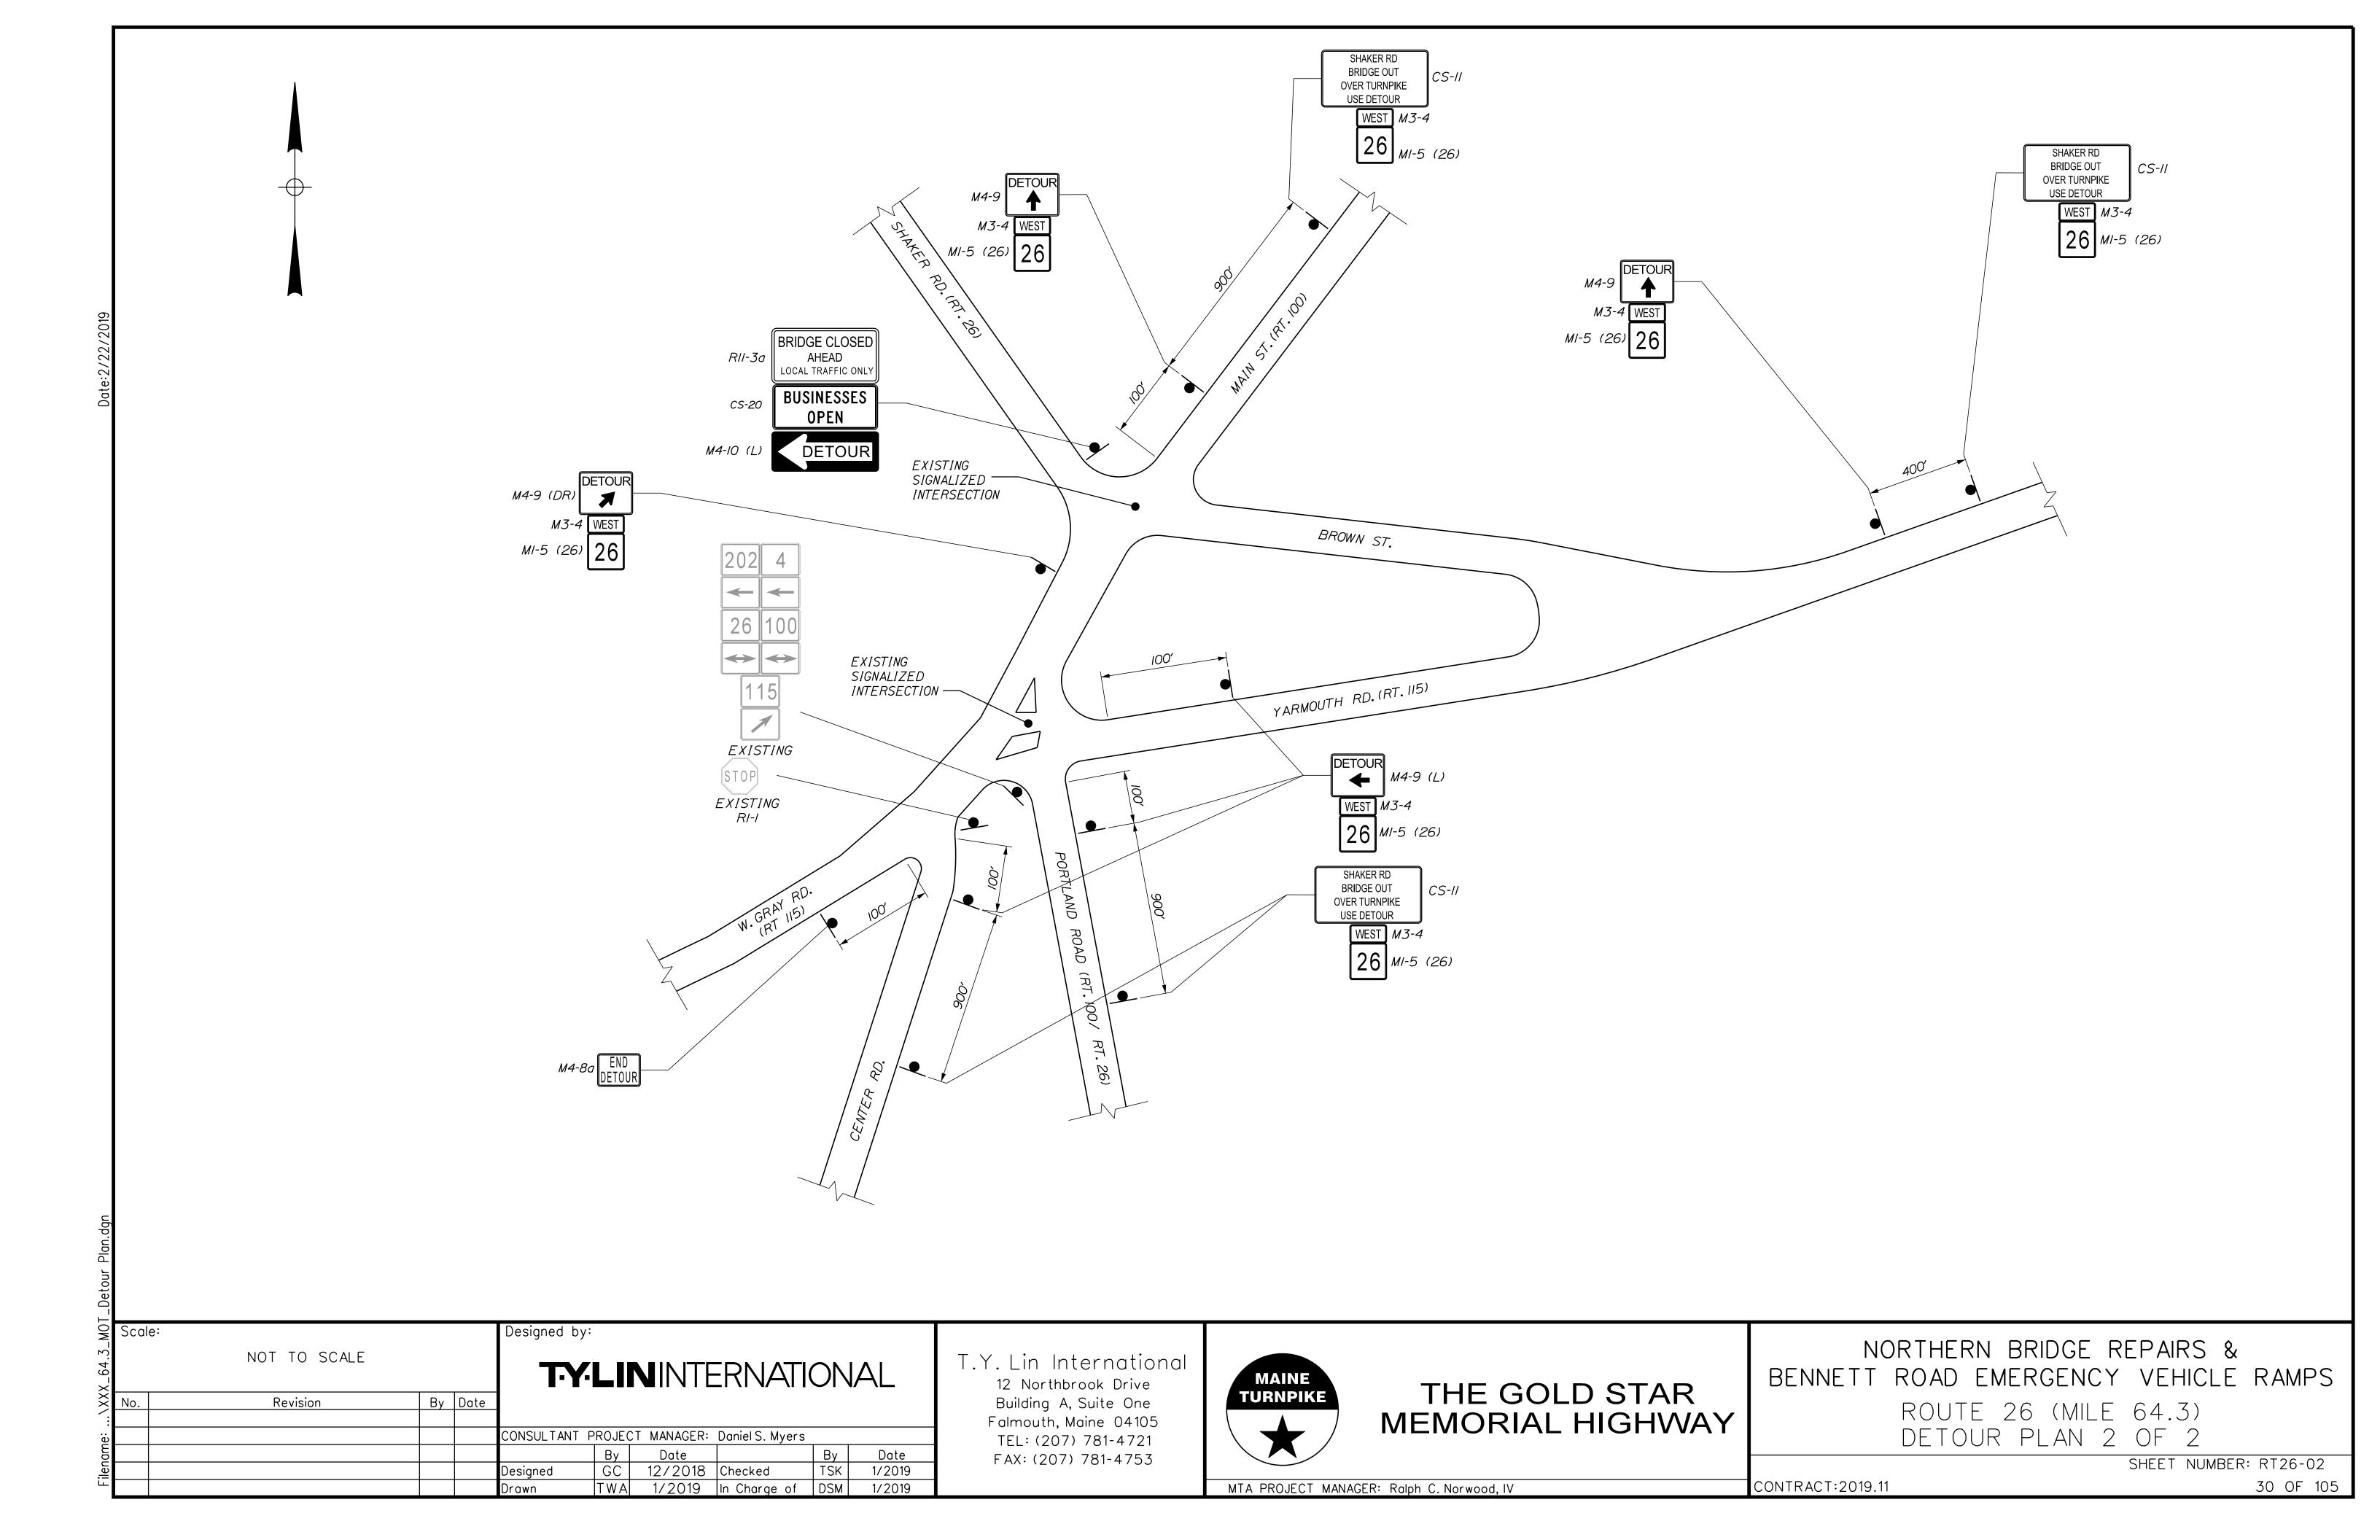

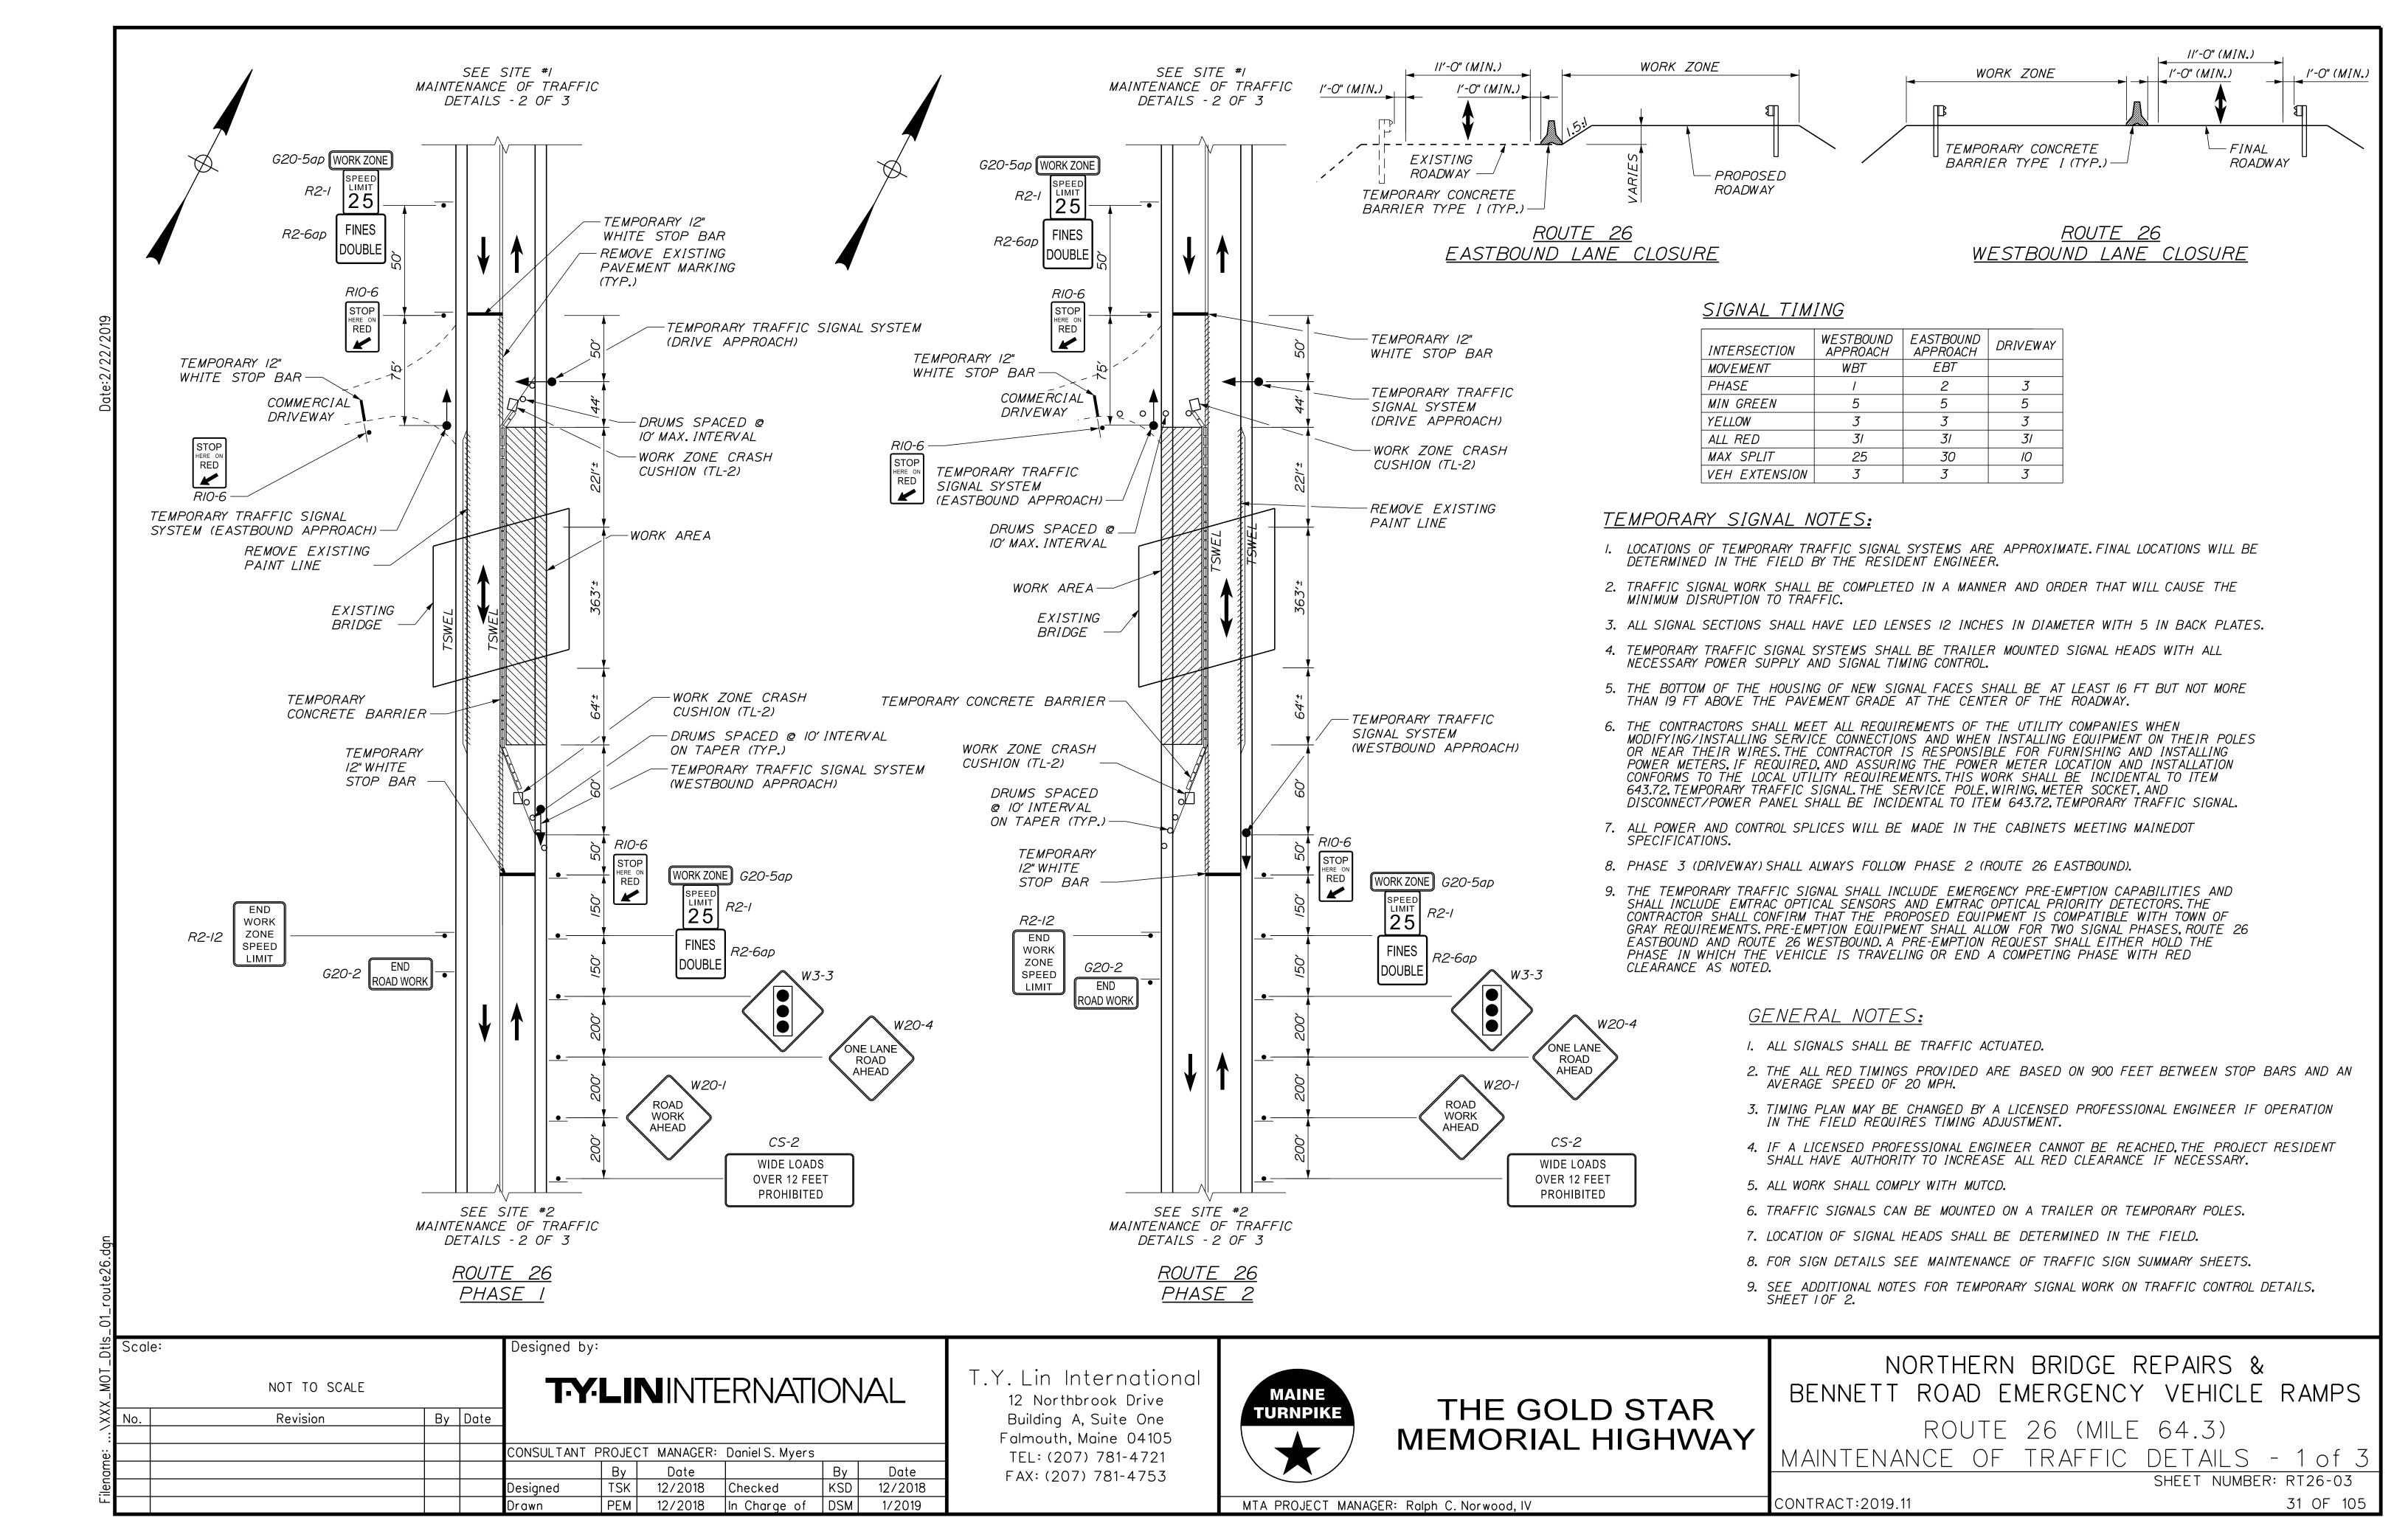

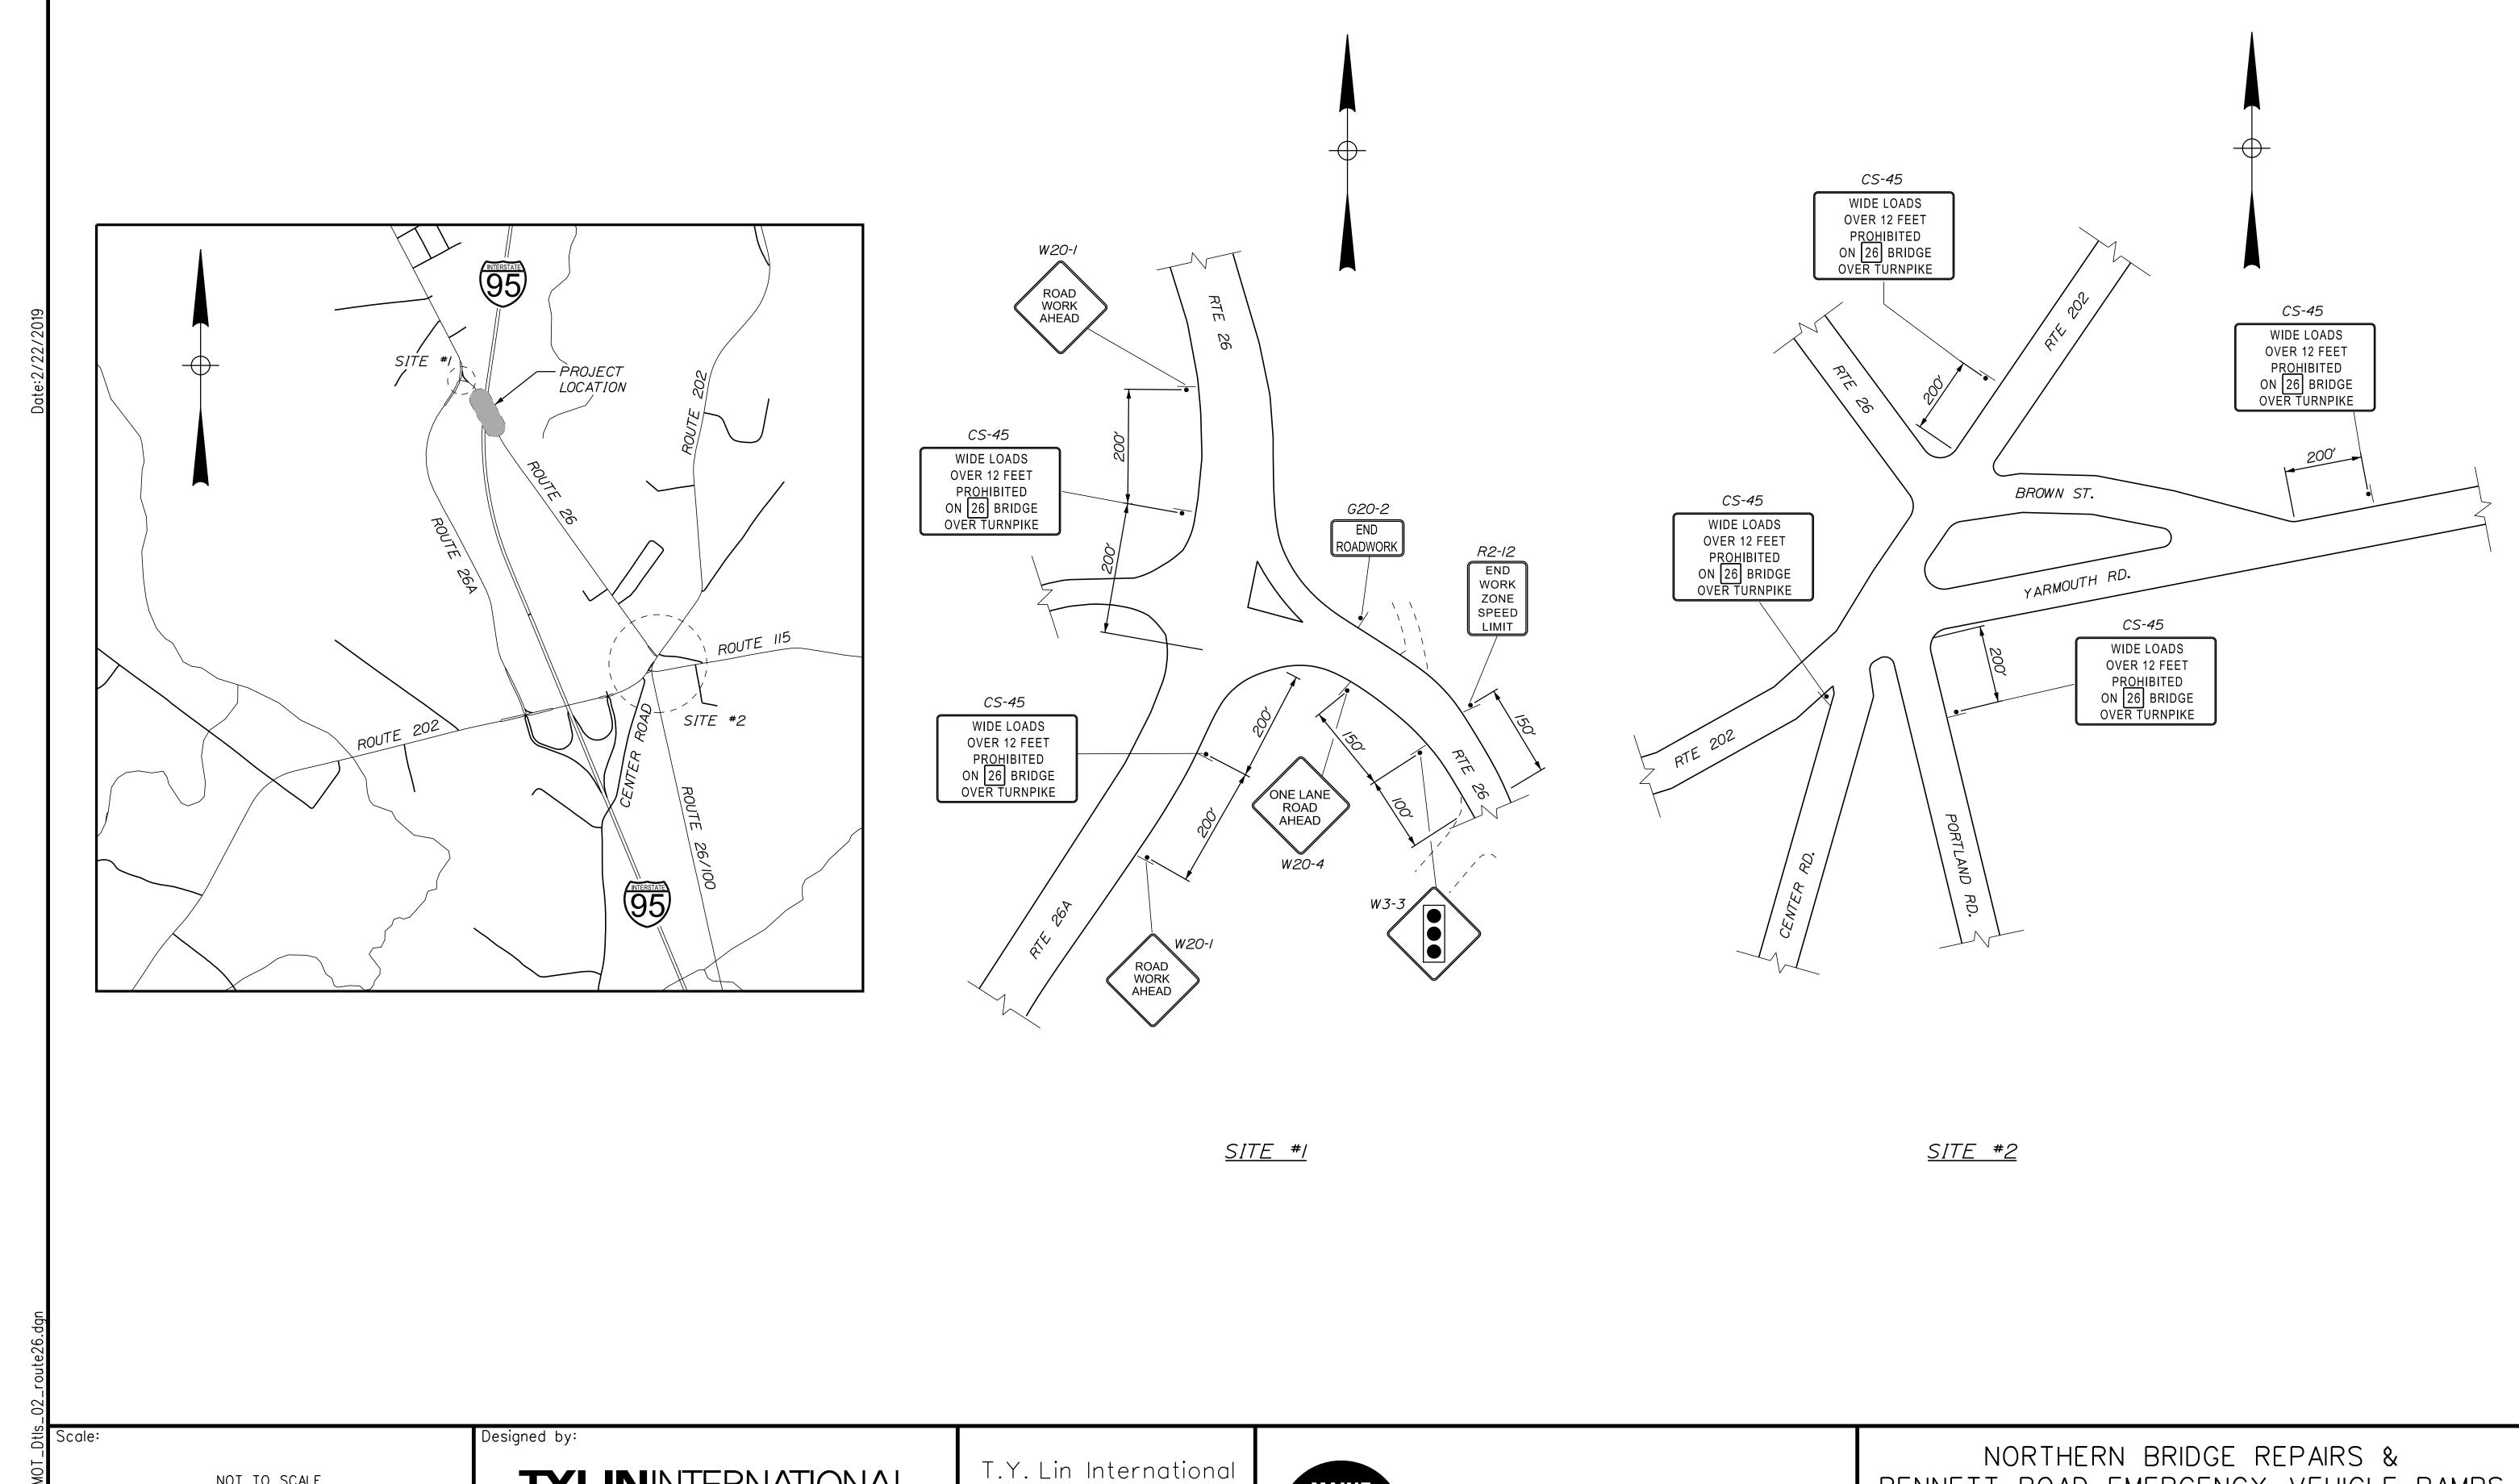

T-Y-LININTERNATIONAL NOT TO SCALE Revision By Date CONSULTANT PROJECT MANAGER: DanielS. Myers 
 By
 Date
 By
 Date

 TSK
 12/2018
 Checked
 KSD
 12/2018

 PEM
 12/2018
 In Charge of
 DSM
 1/2019
 Designed

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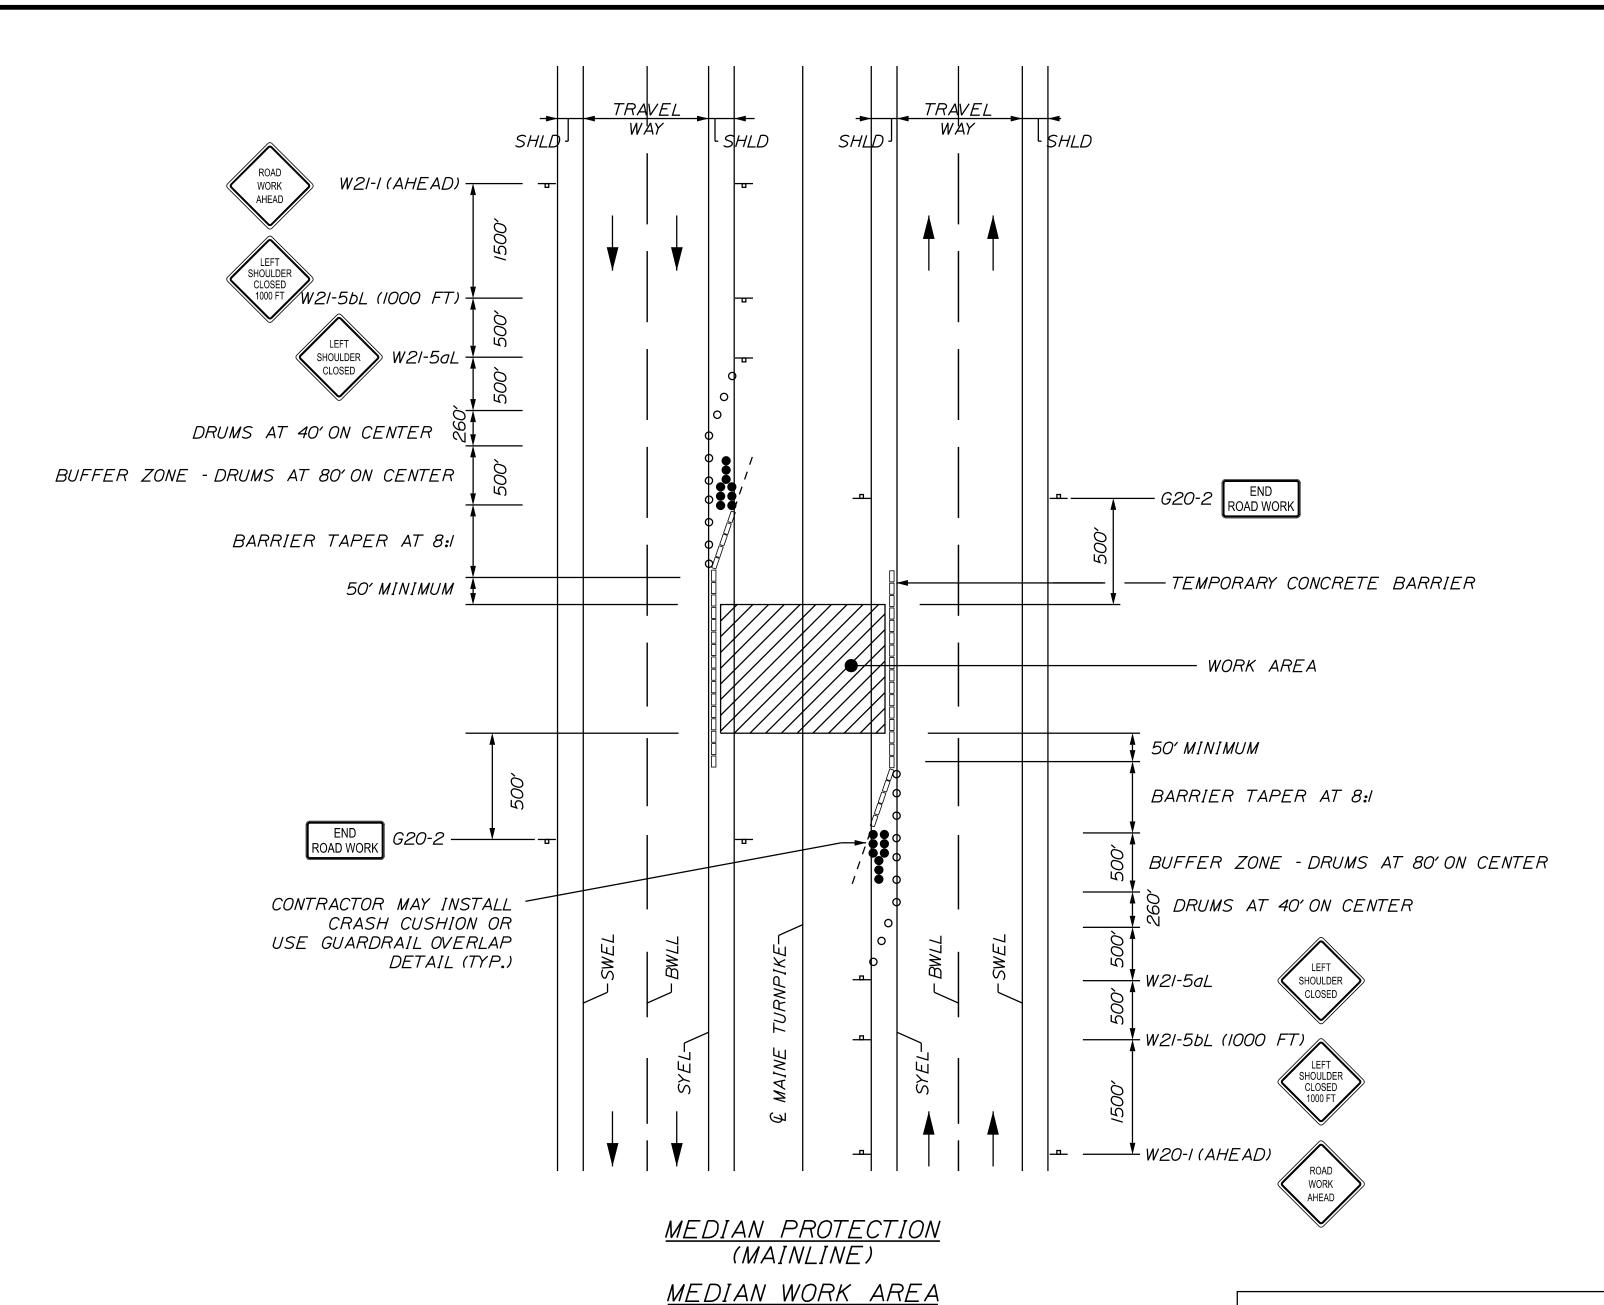
## THE GOLD STAR MEMORIAL HIGHWAY

BENNETT ROAD EMERGENCY VEHICLE RAMPS

ROUTE 26 (MILE 64.3)

MAINTENANCE OF TRAFFIC DETAILS - 2 of 3 SHEET NUMBER: RT26-04 CONTRACT:2019.11

MTA PROJECT MANAGER: Ralph C. Norwood, IV



<u>MEDIAN WORK TYPICAL</u> (NOT TO SCALE) TEMPORARY-50' MIN. OVERLAP CONCRETE BARRIER 2' MINIMUM OFFSET 8:1 TAPER

-BRIDGE PIER

TEMPORARY CONCRETE BARRIER

PROVIDE I' MINIMUM OFFSET FROM

EDGE LINE TO FACE OF BARRIER

### CONCRETE BARRIER/GUARDRAIL OVERLAP DETAIL

### NOTES:

EXIST. GUARDRAIL-

PROVIDE I' MINIMUM OFFSET FROM -

EDGE LINE TO FACE OF BARRIER

I. BARRIER ENDS WITHIN THE HIGHWAY CLEAR ZONE SHALL BE PROTECTED BY A TEMPORARY IMPACT ATTENUATOR OR LAPPED BEHIND GUARDRAIL.


*VARIES* 

2. IF A TEMPORARY WORK ZONE CRASH CUSHION IS USED, THE WORK ZONE CRASH CUSHION SYSTEM MUST BE FOUNDED ON A LEVEL SURFACE. ANY WORK NECESSARY TO PROVIDE A LEVEL SURFACE WILL BE INCIDENTAL TO THE WORK ZONE CRASH CUSHION ITEM.

NOTE: THE W20-I AND G20-2 SIGNS ARE NOT REQUIRED IF THE WORK IS WITHIN A PREVIOUSLY ESTABLISHED WORK ZONE. CONCRETE BARRIER IS REQUIRED WHEN WORKING ON A PIER.

### GENERAL NOTES:

- I. FOR SIGN DETAILS, SEE M.O.T. SIGN SUMMARY.
- 2. WHEN TRUCK MOUNTED ATTENUATORS ARE INCLUDED IN THE CONTRACT (INCIDENTAL OR PAY ITEM), THEY SHALL NOT BE LOCATED IN THE BUFFER ZONE.

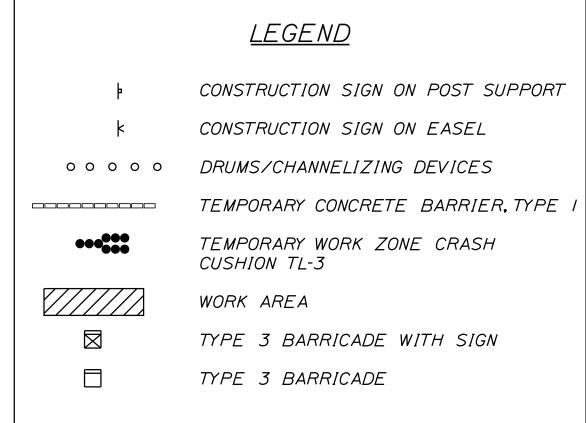

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llen					Designed	TSK	1/2019	Checked	TSK	1/2019	1
-					Drawn	TWA	1/2019	In Charge of	DSM	1/2019	1

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## THE GOLD STAR MEMORIAL HIGHWAY

### NORTHERN BRIDGE REPAIRS & BENNETT ROAD EMERGENCY VEHICLE RAMPS

ROUTE 26 (MILE 64.3)

MAINTENANCE OF TRAFFIC DETAILS - 3 of 3

SHEET NUMBER: RT26-05 CONTRACT:2019.11

MTA PROJECT MANAGER: Ralph C. Norwood, IV

I DENTIE!	CIZI			TEXT DI	MENSIONS	(INCHES)	NUMBER	COL	0R			
IDENTIFI- CATION NUMBER	SI	OF GN HEIGHT	TEXT	LETTER HEIGHT	VERTICAL SPACING	ARROW RTF. MKR.	NUMBER OF SIGNS REQUIRED	BACK- GROUND	LEGEND BORDER	BORDER RADIUS	AREA IN SQUARE FEET	NOTES
CS-I	48"	48"	EXPECT STOPPED TRAFFIC	8C 8C 8C	4" 4"		4	ORANGE	BLACK		16.00 (64)	
CS-2	60"	36"	WIDE LOADS OVER 12 FEET PROHIBITED	6C 6C 6C	5" 4" 4" 5"		1	ORANGE	BLACK		15.00 (15)	
CS-10	48"	48"	TRUCKS ENTERING	7C 7C	6"		2	ORANGE	BLACK		16.00 (32)	
CS-II	54"	36"	SHAKER RD BRIDGE OUT OVER TURNPIKE USE DETOUR	5C 5C 5C 5C	3" 3" 3"		6	ORANGE	BLACK		13 <b>.</b> 50 (81)	
CS-20	42"	18"	BUSINESSES OPEN	5C 5C	2.5" 3" 2.5"		2	ORANGE	BLACK		5 <b>.</b> 25 (10 <b>.</b> 5)	
CS-45	60"	48"	WIDE LOADS OVER 12 FEET PROHIBITED ON 26 BRIDGE OVER TURNPIKE	5C 5C 5C 5C 5C	3" 3" 3" 3"		6	ORANGE	BLACK		20.00 (120)	
G20-2	36" 48"	18" 24"	END ROAD WORK	CONFOR	DIMENSIONS RM TO "STA AY SIGNS" -	NDARD	2 4	ORANGE	BLACK		4.50 (9) 8.00 (32)	
G20-5aP	24" 36"	18" 24"	WORK ZONE				2 4	ORANGE	BLACK		3.00 (6) 6.00 (24)	
MI-5 (26)	24"	24"	26				18	WHITE	BLACK		<b>4.</b> 00 (72)	
м3-2	24"	12"	EAST				4	WHITE	BLACK		2 <b>.</b> 00 (8)	
M3-4	24"	12"	WEST				14	WHITE	BLACK		2 <b>.</b> 00 (28)	
M4-8A	24"	18"	END DETOUR				2	ORANGE	BLACK		3.00 (6)	
M4-9	30"	24"	DETOUR				5	ORANGE	BLACK		5.00 (25)	
M4-9 (DR) (DIAGONAL RIGHT)	<i>30</i> "	24"	DETOUR	V	∇	▼	1	ORANGE	BLACK		5.00 (5)	

IDENTIFI- CATION	SI	E OF GN	TEXT	LET7	T DIMENSIONS TER VERTICA	\Z	ARROW	NUMBER OF SIGNS	COL BACK-	LEGEND	BORDER RADIUS	AREA IN SQUARE	NOTES
NUMBER	WIDTH	HEIGHT		HEIO TE	GHT   SPACING XT DIMENSION			REQUIRED	GROUND	BORDER	NADIOS	FEET	
M4-9L (LEFT) M4-9R (RIGHT)	30" 30"	24" 24"	DETOUR —	l co	NFORM TO "ST GHWAY SIGNS"	$\Gamma A I$	NDARD	5 /	ORANGE ORANGE	BLACK BLACK		5.00 (25) 5.00 (5)	
M4-IOR (RIGHT) M4-IOL (LEFT)	48" 48"	18" 18"	DETOUR					/	ORANGE ORANGE	BLACK BLACK		6.00 (6) 6.00 (6)	
R2-I (25) (50)	24" 48"	30" 60"	SPEED LIMIT X X					2 4	WHITE	BLACK		5.00 (10) 20.00 (80)	
R2-6aP	24" 36"	18" 24"	FINES DOUBLE					2 4	WHITE	BLACK		3.00 (6) 6.00 (24)	
R2-I2	24" 36"	36" 54"	END WORK ZONE SPEED LIMIT					2 4	WHITE	BLACK		6.00 (12) 13.50 (54)	
RIO-6	24"	36"	STOP HERE ON RED					3	WHITE	BLACK		6.00 (18)	
RII-2	48"	30"	BRIDGE CLOSED					2	WH!TE	BLACK		10.00 (20)	
RII-3a	60"	30"	BRIDGE CLOSED AHEAD LOCAL TRAFFIC ONLY					2	WHITE	BLACK		12.50 (25)	
W3-3	<i>36</i> "	36"						2	ORANGE	BLACK		9.00 (18)	
W3-4	48"	48"	BE PREPARED TO STOP					4	ORANGE	BLACK		<i>16.00 (64)</i>	
W3-5	48"	48"	SPEED LIMIT 50	,	V V		▼	4	ORANGE	BLACK		16.00 (64)	

CONTRACT:2019.11

Designed by: T-Y-LININTERNATIONAL NOT TO SCALE By Date Revision CONSULTANT PROJECT MANAGER: DanielS. Myers By Date
Checked PJB 1/2019
In Charge of DSM 1/2019 
 By
 Date

 TWA
 1/2019

 TWA
 1/2019
 Designed

T.Y. Lin International 12 Northbrook Drive Building A, Suite One Falmouth, Maine 04105 TEL: (207) 781-4721 FAX: (207) 781-4753



THE GOLD STAR MEMORIAL HIGHWAY

### NORTHERN BRIDGE REPAIRS & BENNETT ROAD EMERGENCY VEHICLE RAMPS

ROUTE 26 (MILE 64.3) M.O.T. SIGN SUMMARY 1 OF 2

SHEET NUMBER: RT25-06

MTA PROJECT MANAGER: Ralph C. Norwood, IV

IDENTIFI- CATION	SI	E OF 'GN	TEXT	LETTER	IMENSIONS VERTICAL	(INCHES)  ARROW	NUMBER OF SIGNS REQUIRED	BACK-	LEGEND	BORDER RADIUS	AREA IN SQUARE	NOTES
W4-2 (LEFT) (RIGHT)	48"	HE IGHT		CONFO	DIMENSIONS RM TO "STA AY SIGNS" -	S SHALL ANDARD	REQUIREL 4 4	ORANGE	BORDER		I6.00 (64) (64)	
W8-I	48"	48"	BUMP				4	ORANGE	BLACK		16.00 (64)	
W8-24a	48"	48"	RUMBLE STRIPS AHEAD				4	ORANGE	BLACK		16.00 (64)	
WI6-4P	36"	30"	NEXT 1000 FEET				4	ORANGE	BLACK		7.50 (30)	
W2O-I (I MILE) (AHEAD) (AHEAD)	48" 48" 36"	48" 48" 36"	ROAD WORK 1 MILE				4 4 3	ORANGE	BLACK		16.00 (64) 16.00 (64) 9.00 (27)	
W20-2	36"	36"	DETOUR AHEAD				/	ORANGE	BLACK		9.00 (9)	
W20-3 (250) (500)	36"	36"	ROAD CLOSED XXXX FT				//	ORANGE	BLACK		9.00 (9) (9)	
W20-4	36"	36"	ONE LANE ROAD AHEAD	V	V	V	2	ORANGE	BLACK		9.00 (18)	
	NO	T TO SC	: :ALE	Designed b		IINITE		ΓΙΩΝΙ	^ I	T.Y.	Lin Int	ernational

CATION NUMBER WI	SIZE SIG IDTH I		LEFT LANE CLOSED 1/2 MILE	CON	T DIN FORM	VERTICAL SPACING MENSIONS TO "STA SIGNS" -	RTE.MKR SHALL NDARD	NUMBER OF SIGNS REQUIRED	BACK- GROUND	LEGEND BORDER	BORDER RADIUS	AREA IN SQUARE FEET	NOTES
W20-5 4 (LEFT)			LANE CLOSED	TEX CON	T DI FORM	MENSIONS 1 TO "STA	S SHALL NDARD	PILGOTRED	3.100112	BONDEN		, , , , ,	
								4 4	ORANGE	BLACK		16.00 (64) (64)	
W20-7a 3	36"	36"						2	ORANGE	BLACK		9 <b>.</b> 00 (18)	
W2I-5	48"	48"	SHOULDER					2	ORANGE	BLACK		16.00 (32)	
	48" 48"	48" 48"	LEFT SHOULDER CLOSED					4 4	ORANGE	BLACK		16.00 (64) (64)	
	48" 48"	48" 48"	RIGHT SHOULDER CLOSED 1000 FT	V		V	∇	4 4	ORANGE	BLACK		16.00 (64) (64)	

## SHAKER RD BRIDGE OUT OVER TURNPIKE USE DETOUR

WIDE LOADS OVER 12 FEET **PROHIBITED** ON 26 BRIDGE OVER TURNPIKE

— 12.7 — <del>| 1</del>2.65 — <del>| 1</del>5 <del>| 1</del>16.95 — <del>| 1</del>2.7 — -9.775 - 13.55 - 15.55 - 12.2 - 15.75 -6.875 + 6.75 + 10.35 + 5 + 19.15 3.000" Radius, 1.250" Border, 0.750" Indent, Black on Orange;

CONTRACT:2019.11

[WIDE LOADS] Black C 2K; [OVER 12 FEET] Black C 2K;

[BRIDGE] Black C 2K; [OVER TURNPIKE] Black C 2K;

[PROHIBITED] Black C 2K; [ON] Black C 2K; Rectangle Black;

CS-20 BUSINESSES OPEN

1.500" Radius, 0.625" Border, 0.375" Indent, Black on Orange; [BUSINESSES] C 2K; [OPEN] C 2K;

2.250" Radius, 0.875" Border, 0.625" Indent, Black on Orange; [SHAKER RD] Black C 2K; [BRIDGE OUT] Black C 2K; [OVER TURNPIKE] Black C 2K; [USE DETOUR] Black C 2K;

Scale:

NOT TO SCALE

By Date Revision CONSULTANT PROJECT MANAGER: DanielS. Myers Designed

## T-Y-LININIERNAHONAL

By Date

1/2019

PJB

In Charge of DSM

By Date TWA 1/2019 Checked

TWA 1/2019

12 Northbrook Drive Building A, Suite One Falmouth, Maine 04105 TEL: (207) 781-4721 FAX: (207) 781-4753



## THE GOLD STAR MEMORIAL HIGHWAY

NORTHERN BRIDGE REPAIRS & BENNETT ROAD EMERGENCY VEHICLE RAMPS


> ROUTE 26 (MILE 64.3) M.O.T. SIGN SUMMARY 2 OF 2

SHEET NUMBER: RT25-07

MTA PROJECT MANAGER: Ralph C. Norwood, IV

### TYPICAL WESTERN APPROACH SECTION NORMAL

STA. 72+18.84 TO STA. 73+09.14

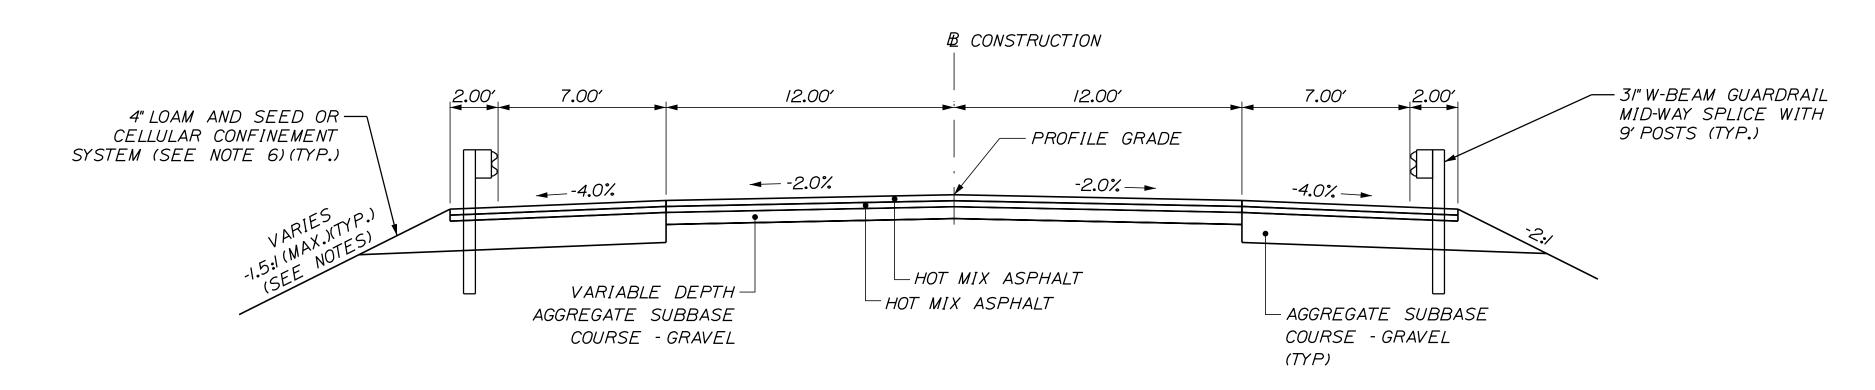

## TYPICAL EASTERN APPROACH SECTION

STA. 76+19.79 TO 78+67.00

### SUPERELEVATION TABLE

	1	ROUTE 2	6	
LT. SHOULDER	LT. TRAVEL LANE	STATION	RT. TRAVEL LANE	RT. SHOULDER
-2.70%	-2.70%	*72+19	-2.20%	-4.50%
<i>-1.51%</i>	-1.51%	<i>72+50</i>	-1.51%	-2.44%
-1.51%	-1.51%	72+64	-1.51%	-1.51%
		to		
-I <b>.</b> 5I%	-1.51%	BRIDGE	-1.51%	-I <b>.</b> 5I%
		to		
-I <b>.</b> 5I%	-l <b>.</b> 5l%	<i>76+65</i>	-1.51%	-I <b>.</b> 5I%
<i>-2.55%</i>	-1.84%	76+9I	-1.51%	-I <b>.</b> 5I%
<i>-3.08%</i>	-2.00%	<i>77+04</i>	-2.00%	-2.06%
-4.00%	-2.00%	77+27	-2.00%	-3.03%
-4.00%	-2.00%	77+50	-2.00%	-4.00%
-4.00%	-2.00%	<i>78+00</i>	-2.00%	-4.00%
-2.28%	-2.00%	<i>78+50</i>	-2.00%	-4.00%
-1.70%	-2.60%	<i>*78+67</i>	-1.50%	-3.30%

\*MATCH EXISTING

### NOTES:

- I. THE PAVEMENT, BASE, AND SUBBASE DEPTHS AS SHOWN ON THE PLANS ARE INTENDED TO BE NOMINAL.
- 2. CROWNS FOR BOTH NORMAL AND SUPERELEVATION SECTIONS FOR ALL COURSES OF SUBBASE AND PAVEMENT SHALL BE STRAIGHT.
- 3. THE GRAVEL QUANTITY CALCULATION IS BASED ON A 4 INCH LOAM DEPTH. THE ACTUAL DEPTH MAY VARY. SEE THE GENERAL NOTES.
- 4. THE ALGEBRAIC DIFFERENCE BETWEEN THE SHOULDER AND THE TRAVEL LANE CROSS SLOPES "ROLLOVER" SHALL NOT EXCEED 8 PERCENT.
- 5. THE STATIONING UNDER EACH TYPICAL IS APPROXIMATE.

CONTRACT:2019.11

6. CELLULAR CONFINEMENT SYSTEM SHALL BE USED ON ALL SLOPES STEEPER THAN 2:1 AND SHALL BE INSTALLED PER THE SPECIAL PROVISIONS.

Scal	le:			Designed b	у:				
Scal	NOT TO SCALE			T-)	/·LII	VINT	ERNATI		AL
No.	Revision	Ву	Date	-					
				CONSULTANT	PROJEC	T MANAGER	: Daniel S. Myers	<u> </u>	
					Ву	Date		Ву	Date
				Designed	TSK	1/2019	Checked	TSK	1/2019
				Drawn	MJD	1/2019	In Charge of	DSM	1/2019

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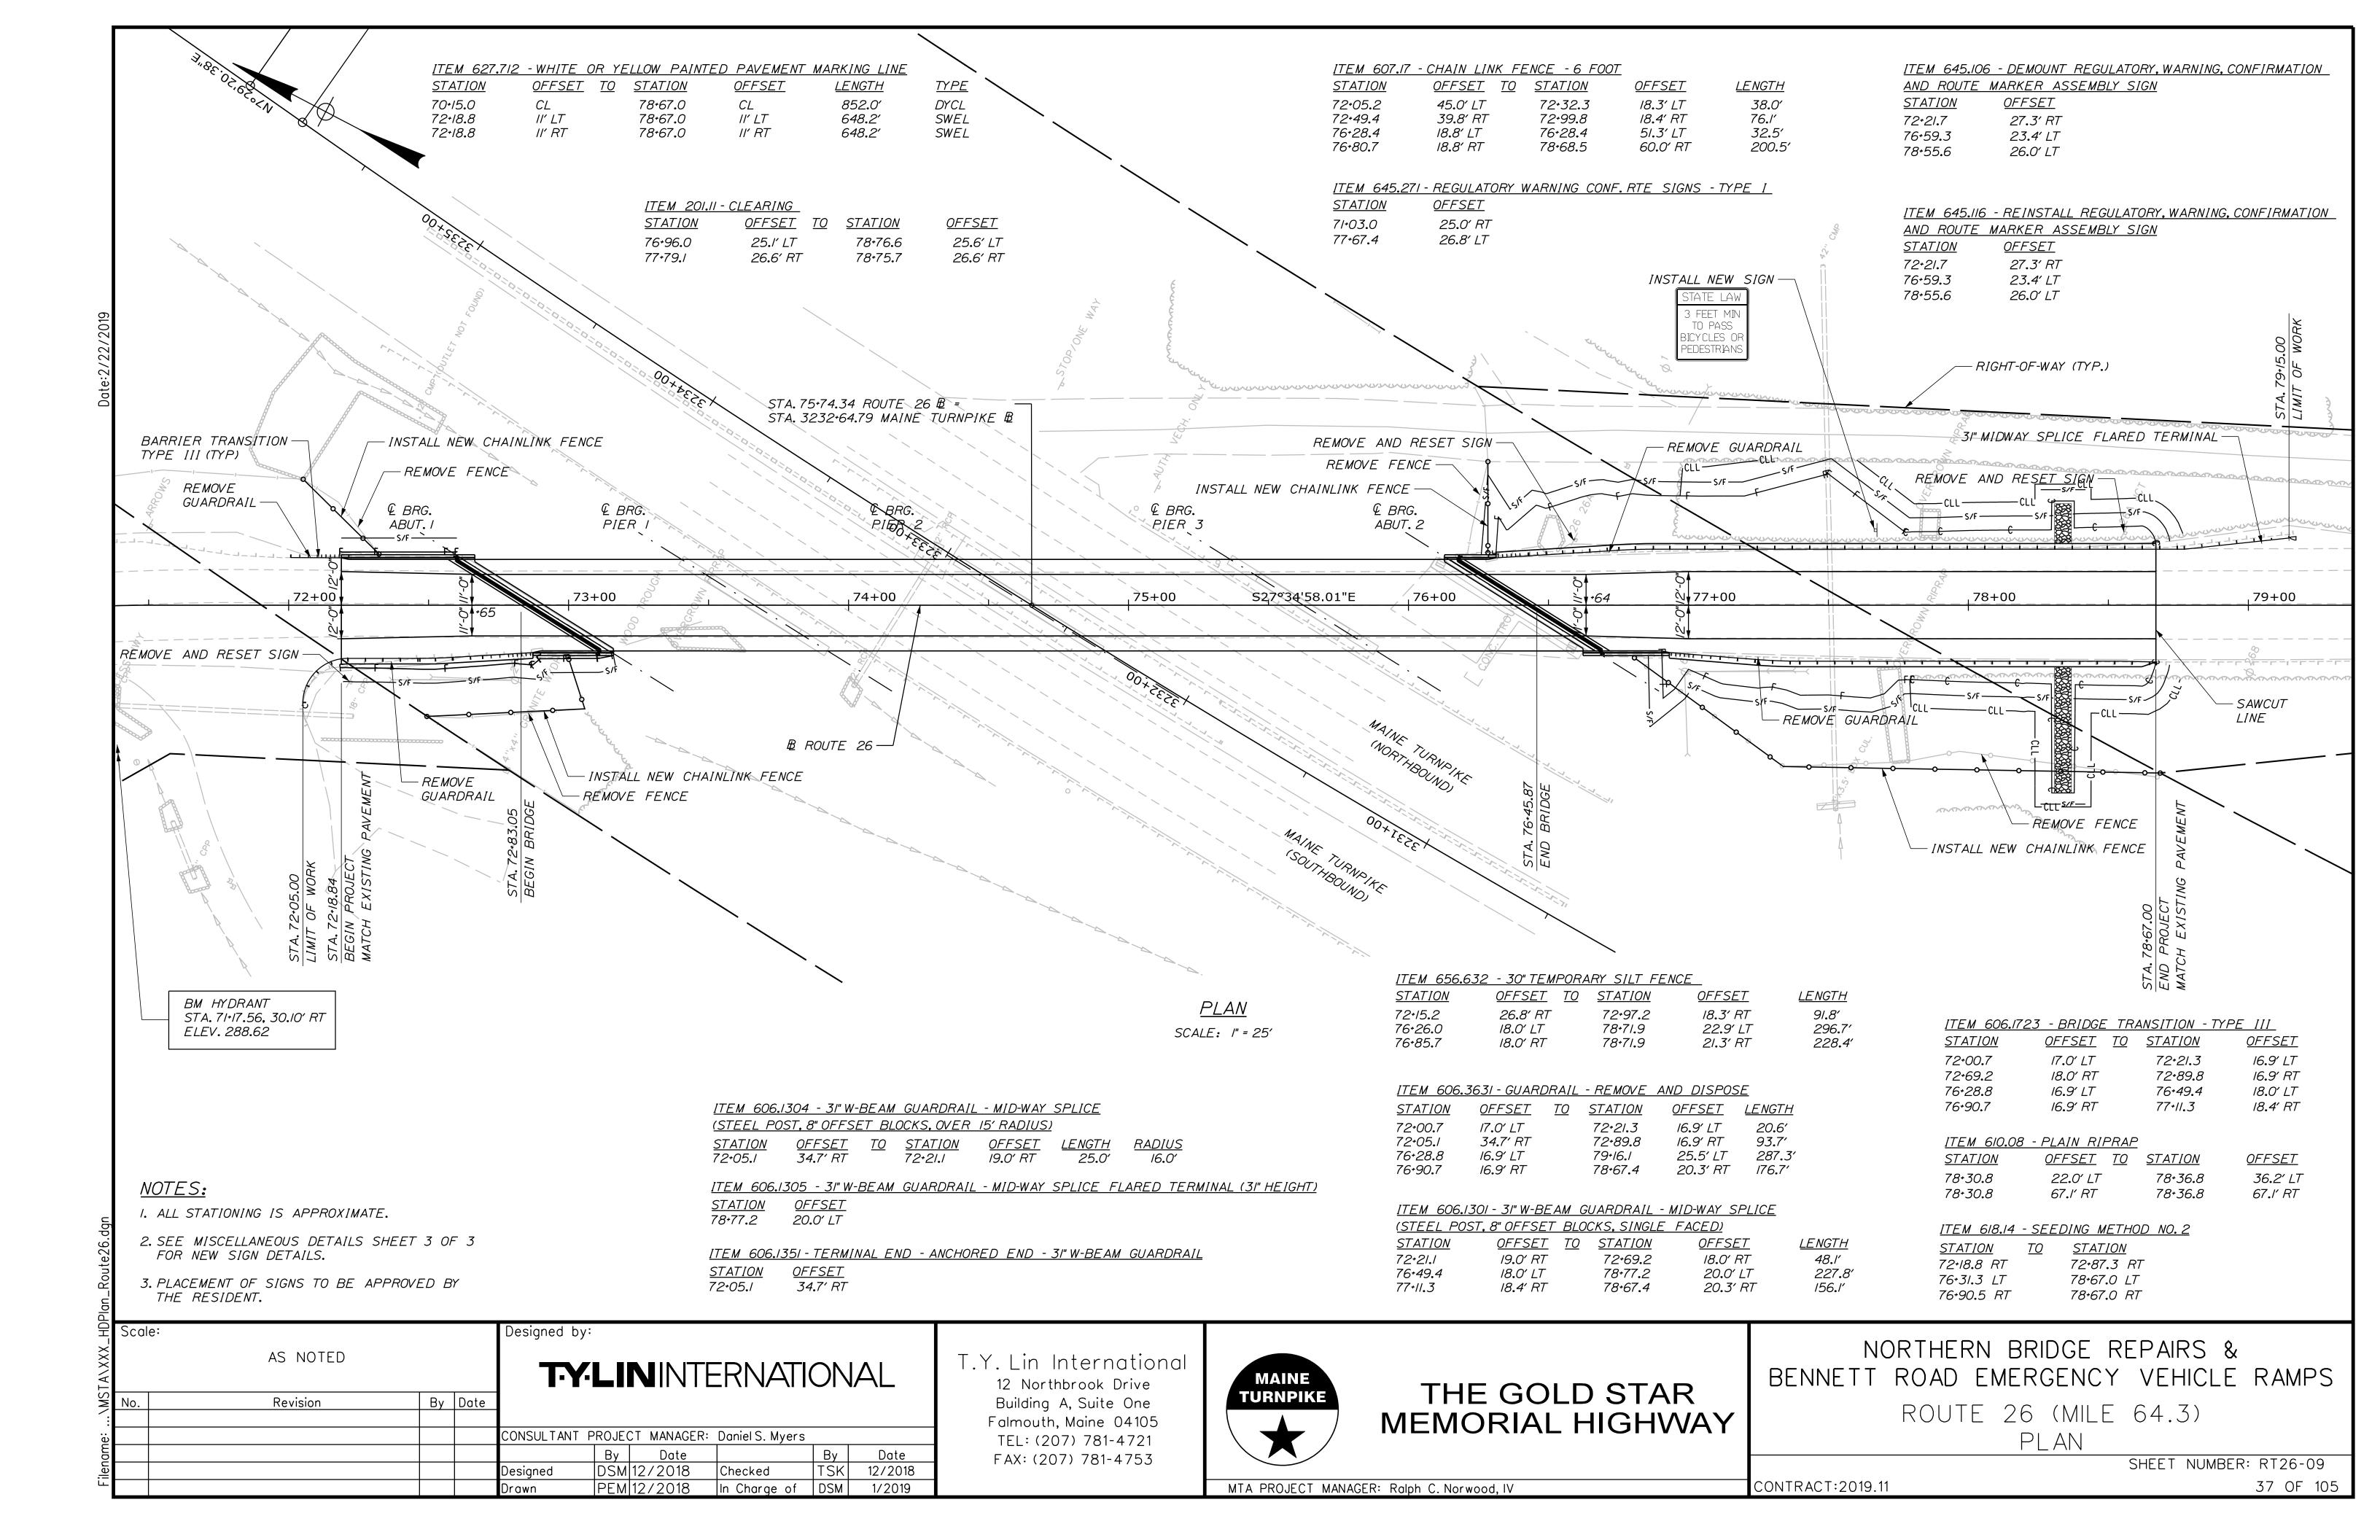
THE GOLD STAR MEMORIAL HIGHWAY


NORTHERN BRIDGE REPAIRS & BENNETT ROAD EMERGENCY VEHICLE RAMPS

> ROUTE 26 (MILE 64.3) TYPICAL APPROACH SECTION

SHEET NUMBER: RT26-08

MTA PROJECT MANAGER: Ralph C. Norwood, IV



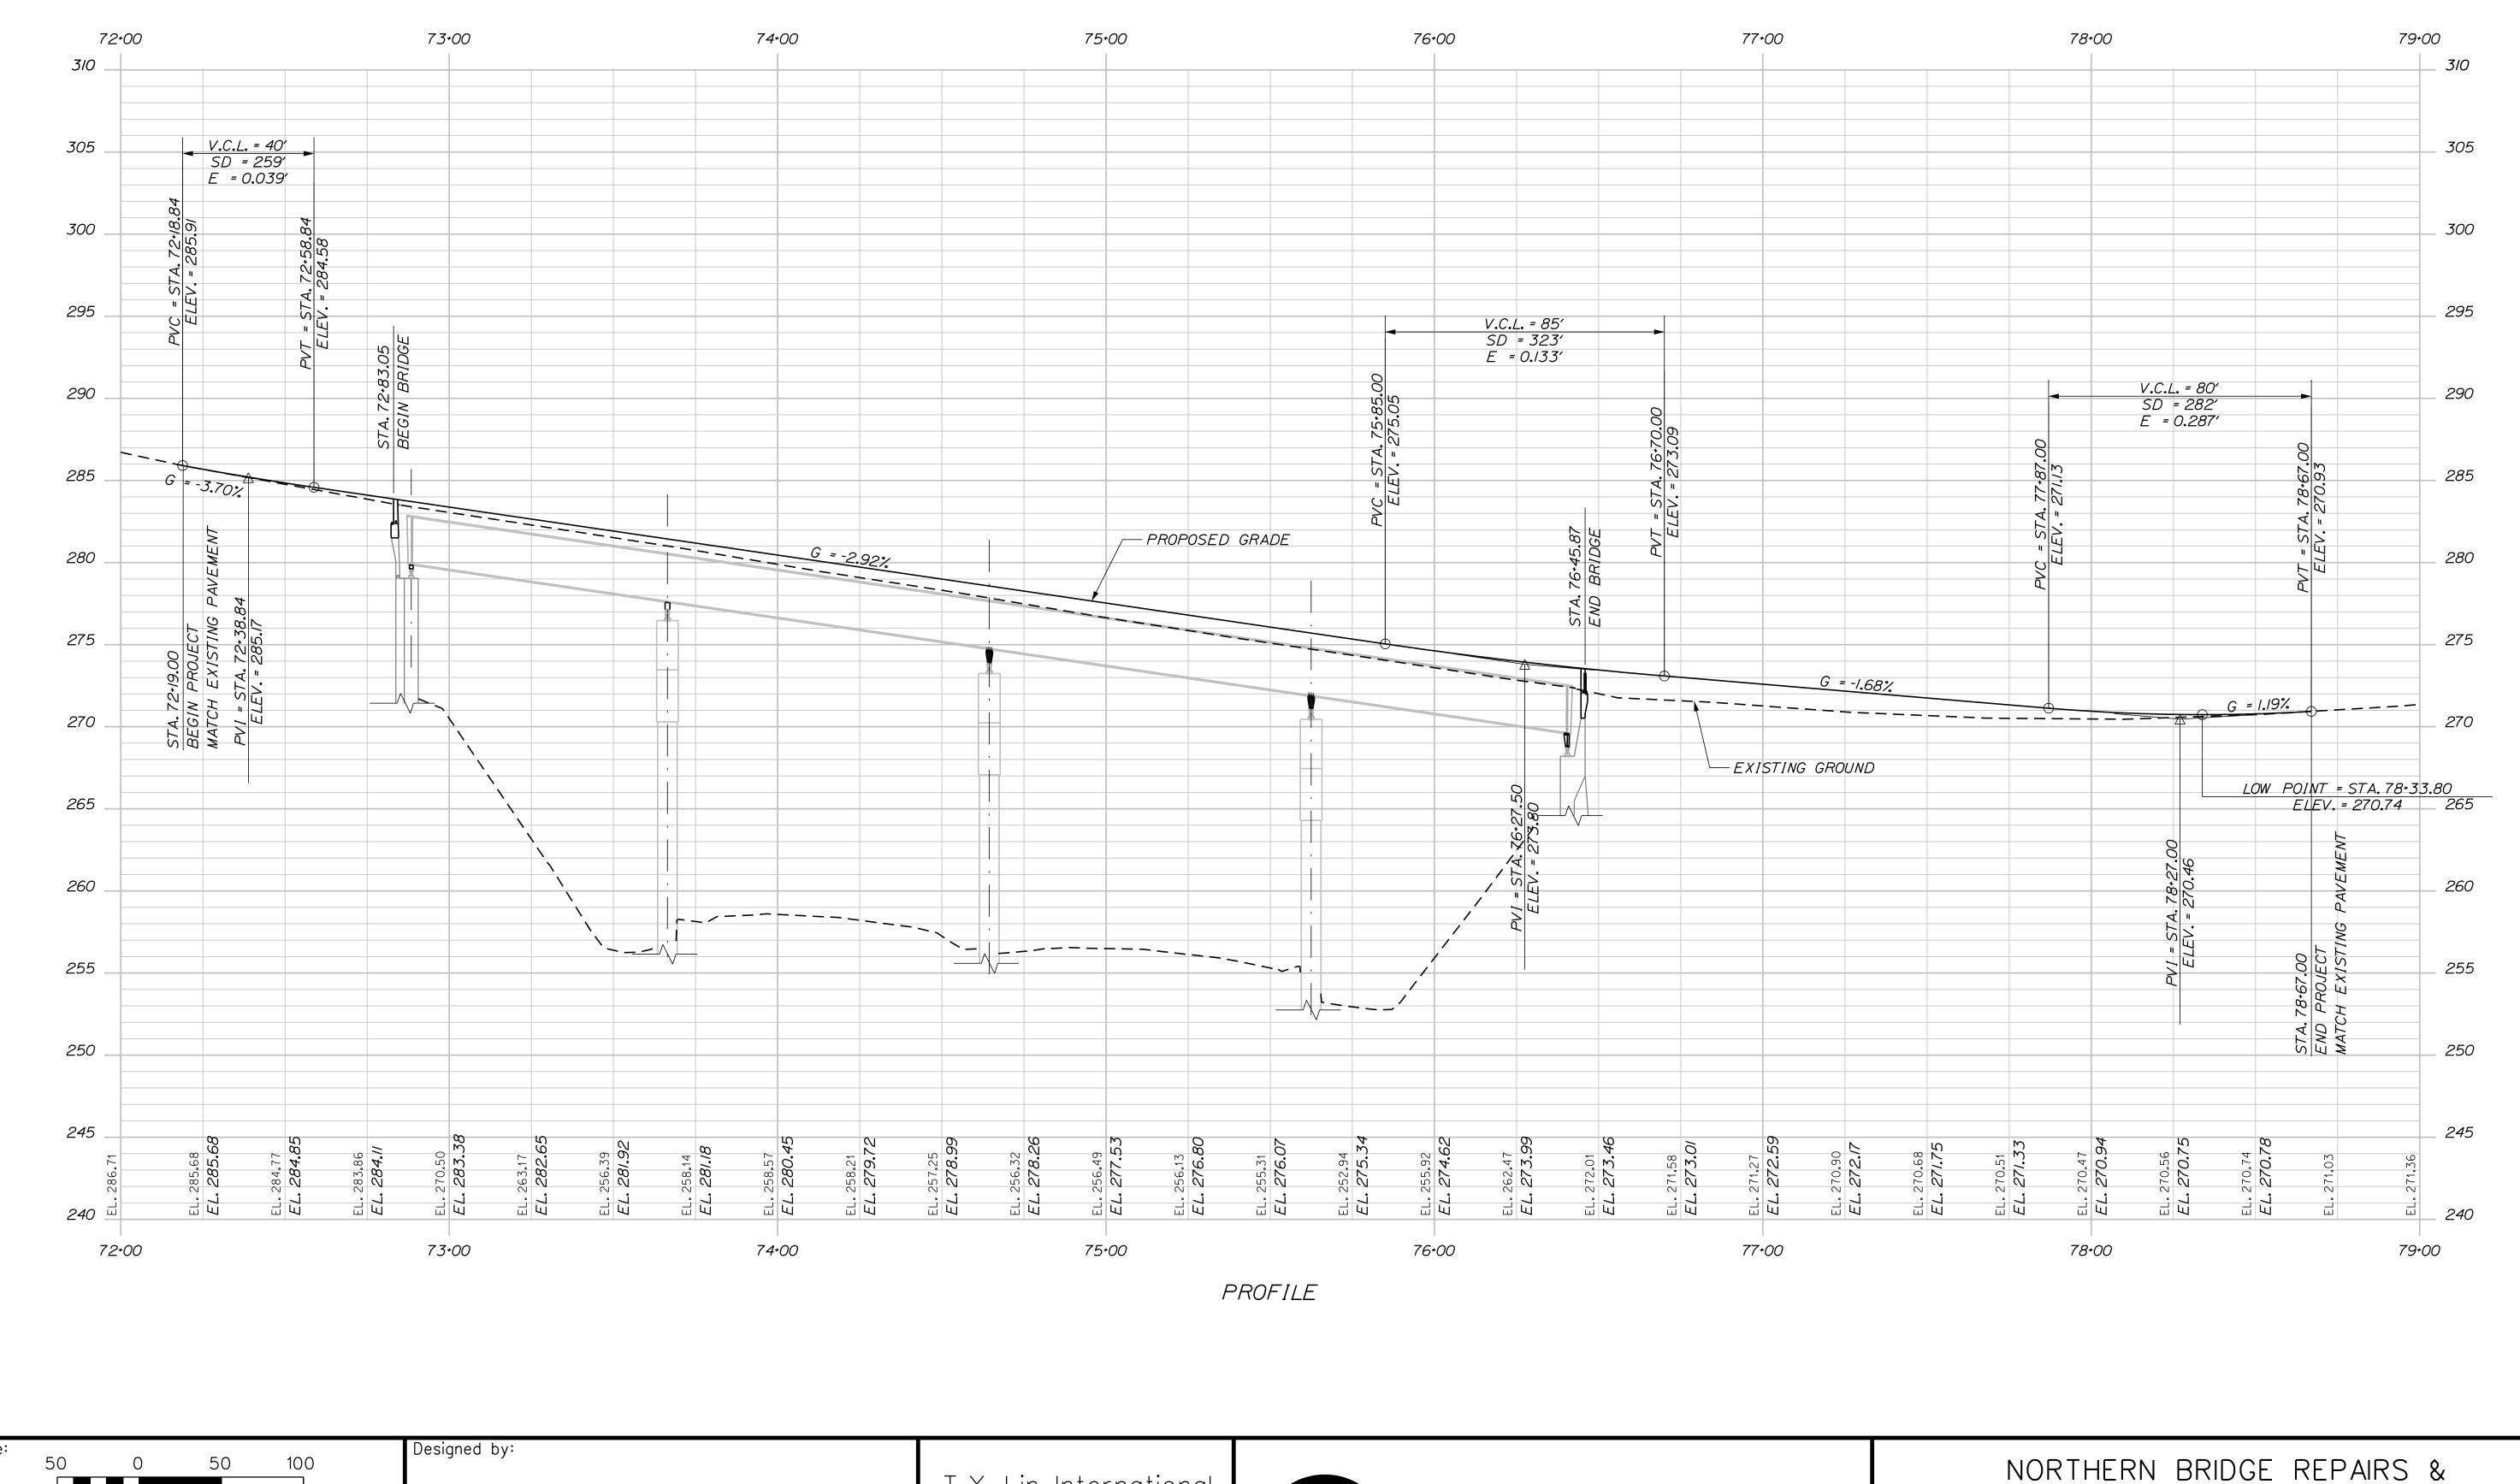

T-Y-LININTERNATIONAL By Date Revision CONSULTANT PROJECT MANAGER: DanielS. Myers By Date TSK 12/2018 By Date TSK 1/2019 Checked In Charge of DSM PEM 12/2018

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## THE GOLD STAR MEMORIAL HIGHWAY

## BENNETT ROAD EMERGENCY VEHICLE RAMPS


ROUTE 26 (MILE 64.3)


PROFILE

SHEET NUMBER: RT26-10 38 OF 105


MTA PROJECT MANAGER: Ralph C. Norwood, IV


CONTRACT:2019.11

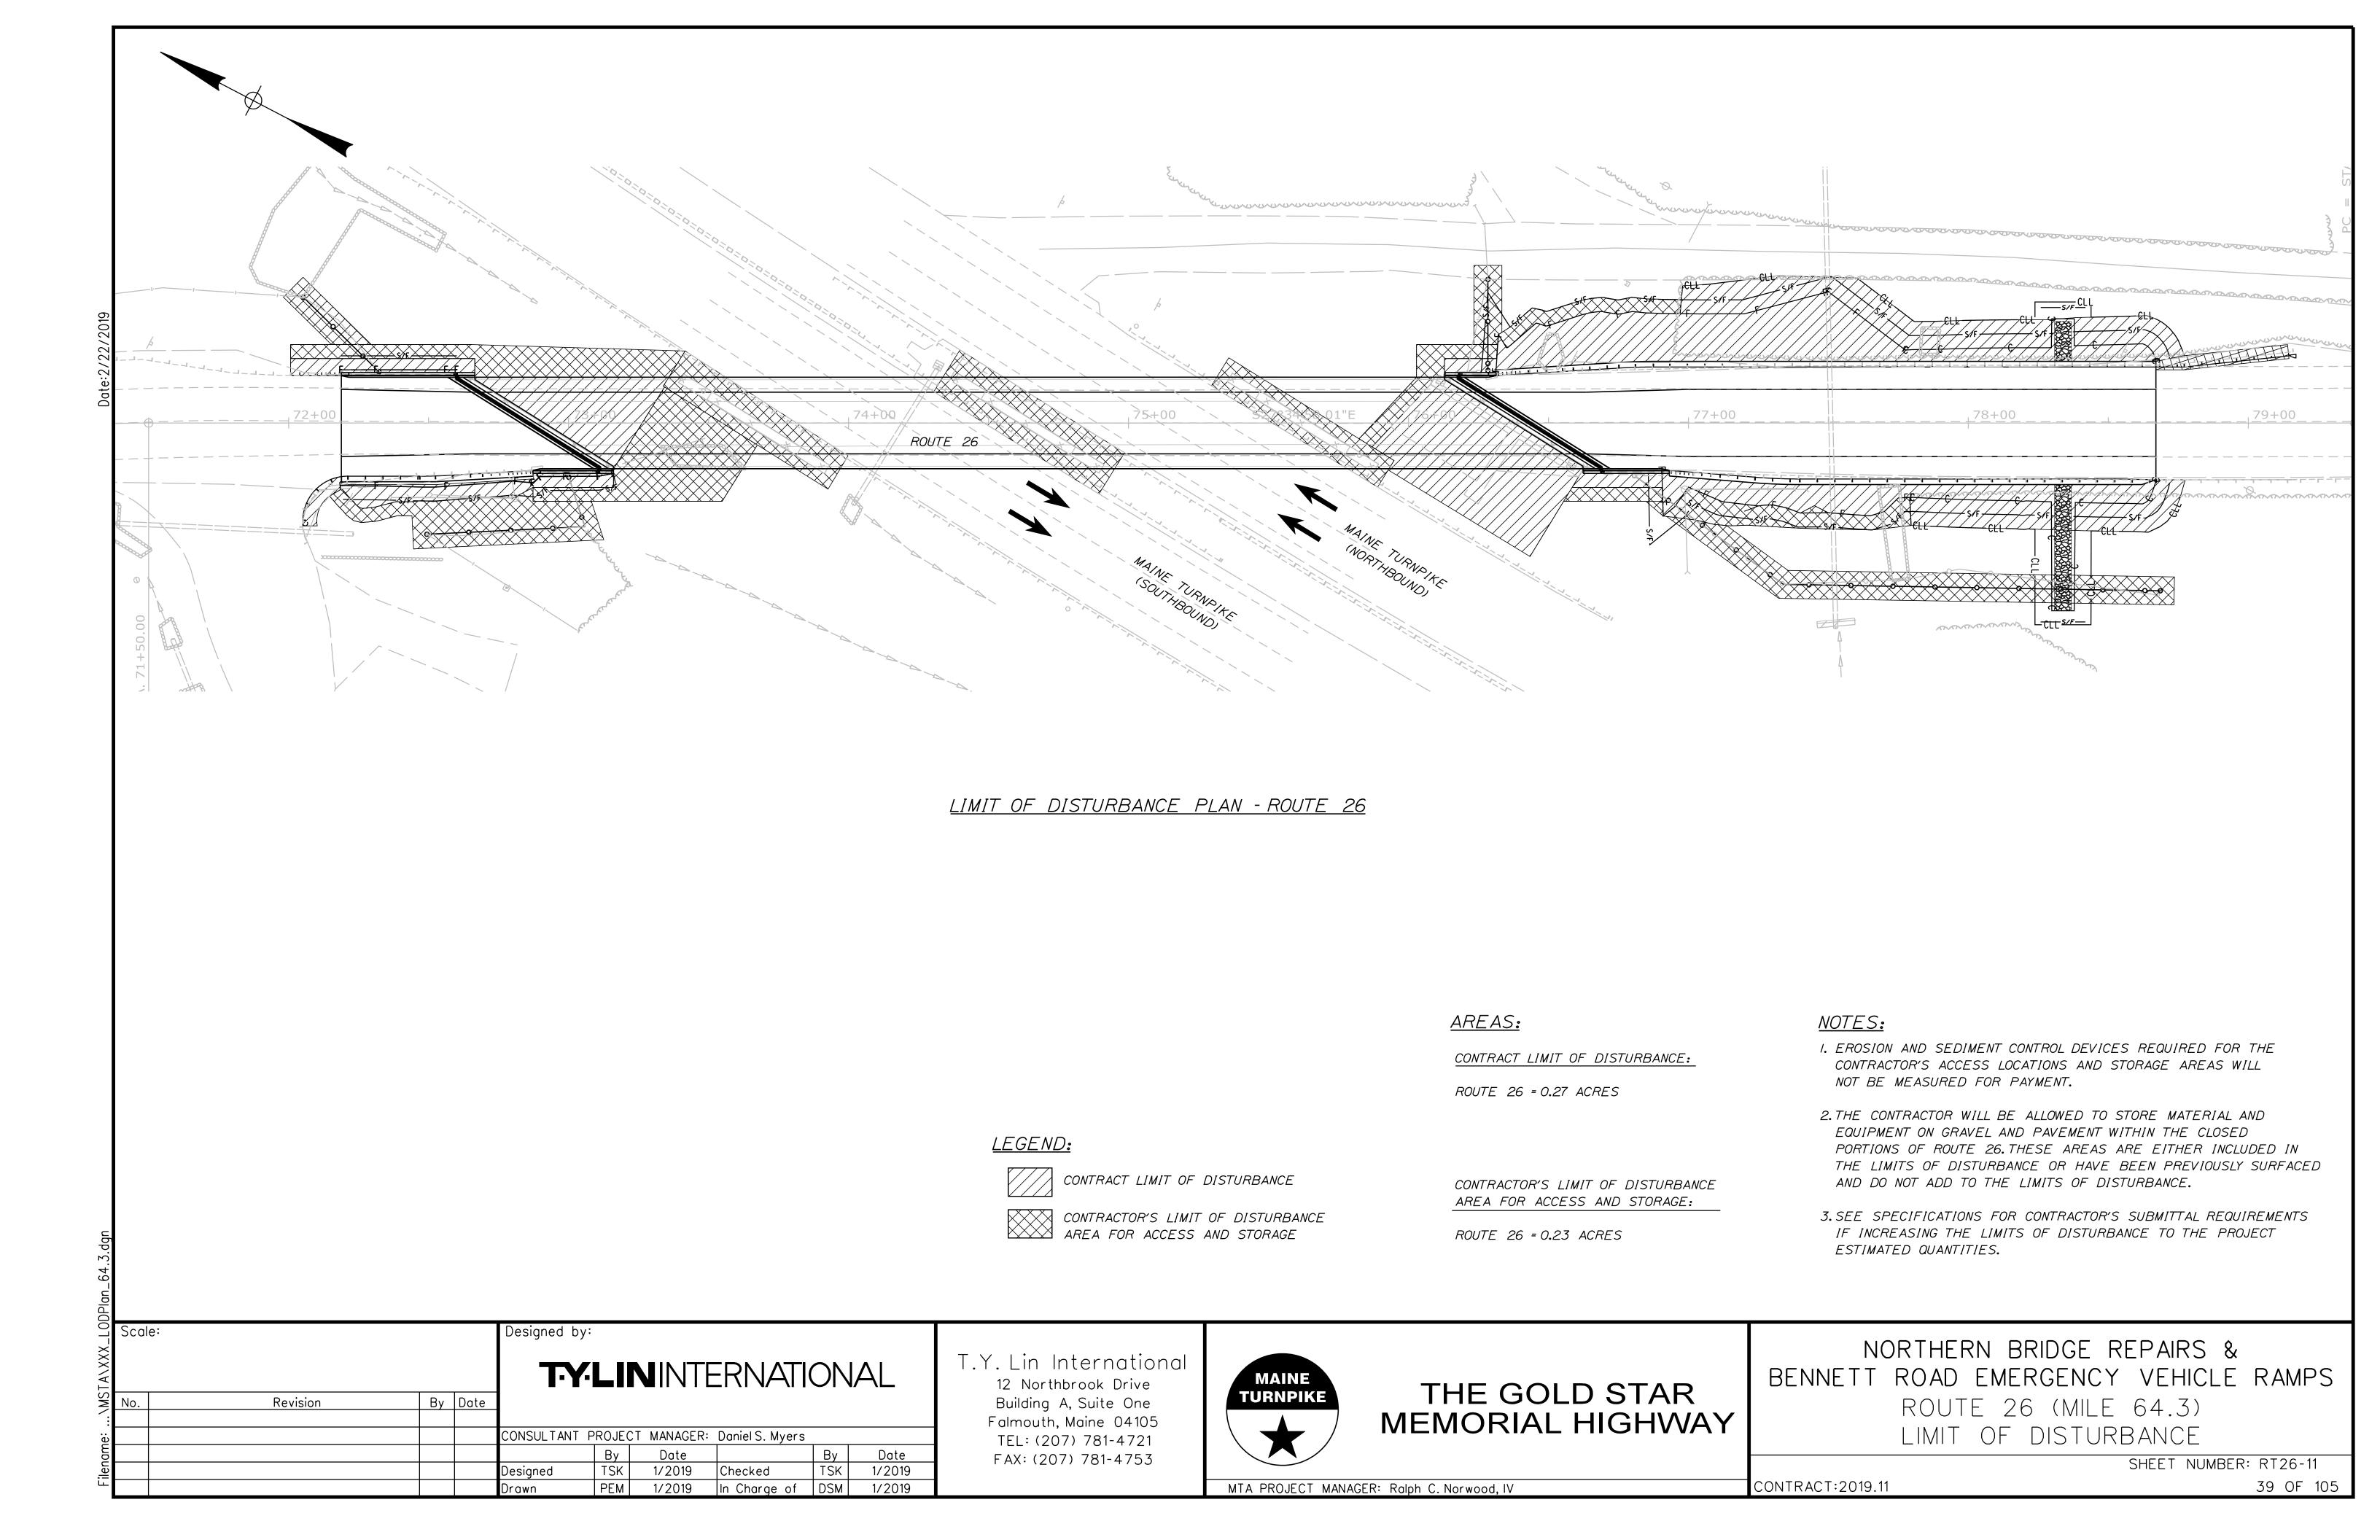

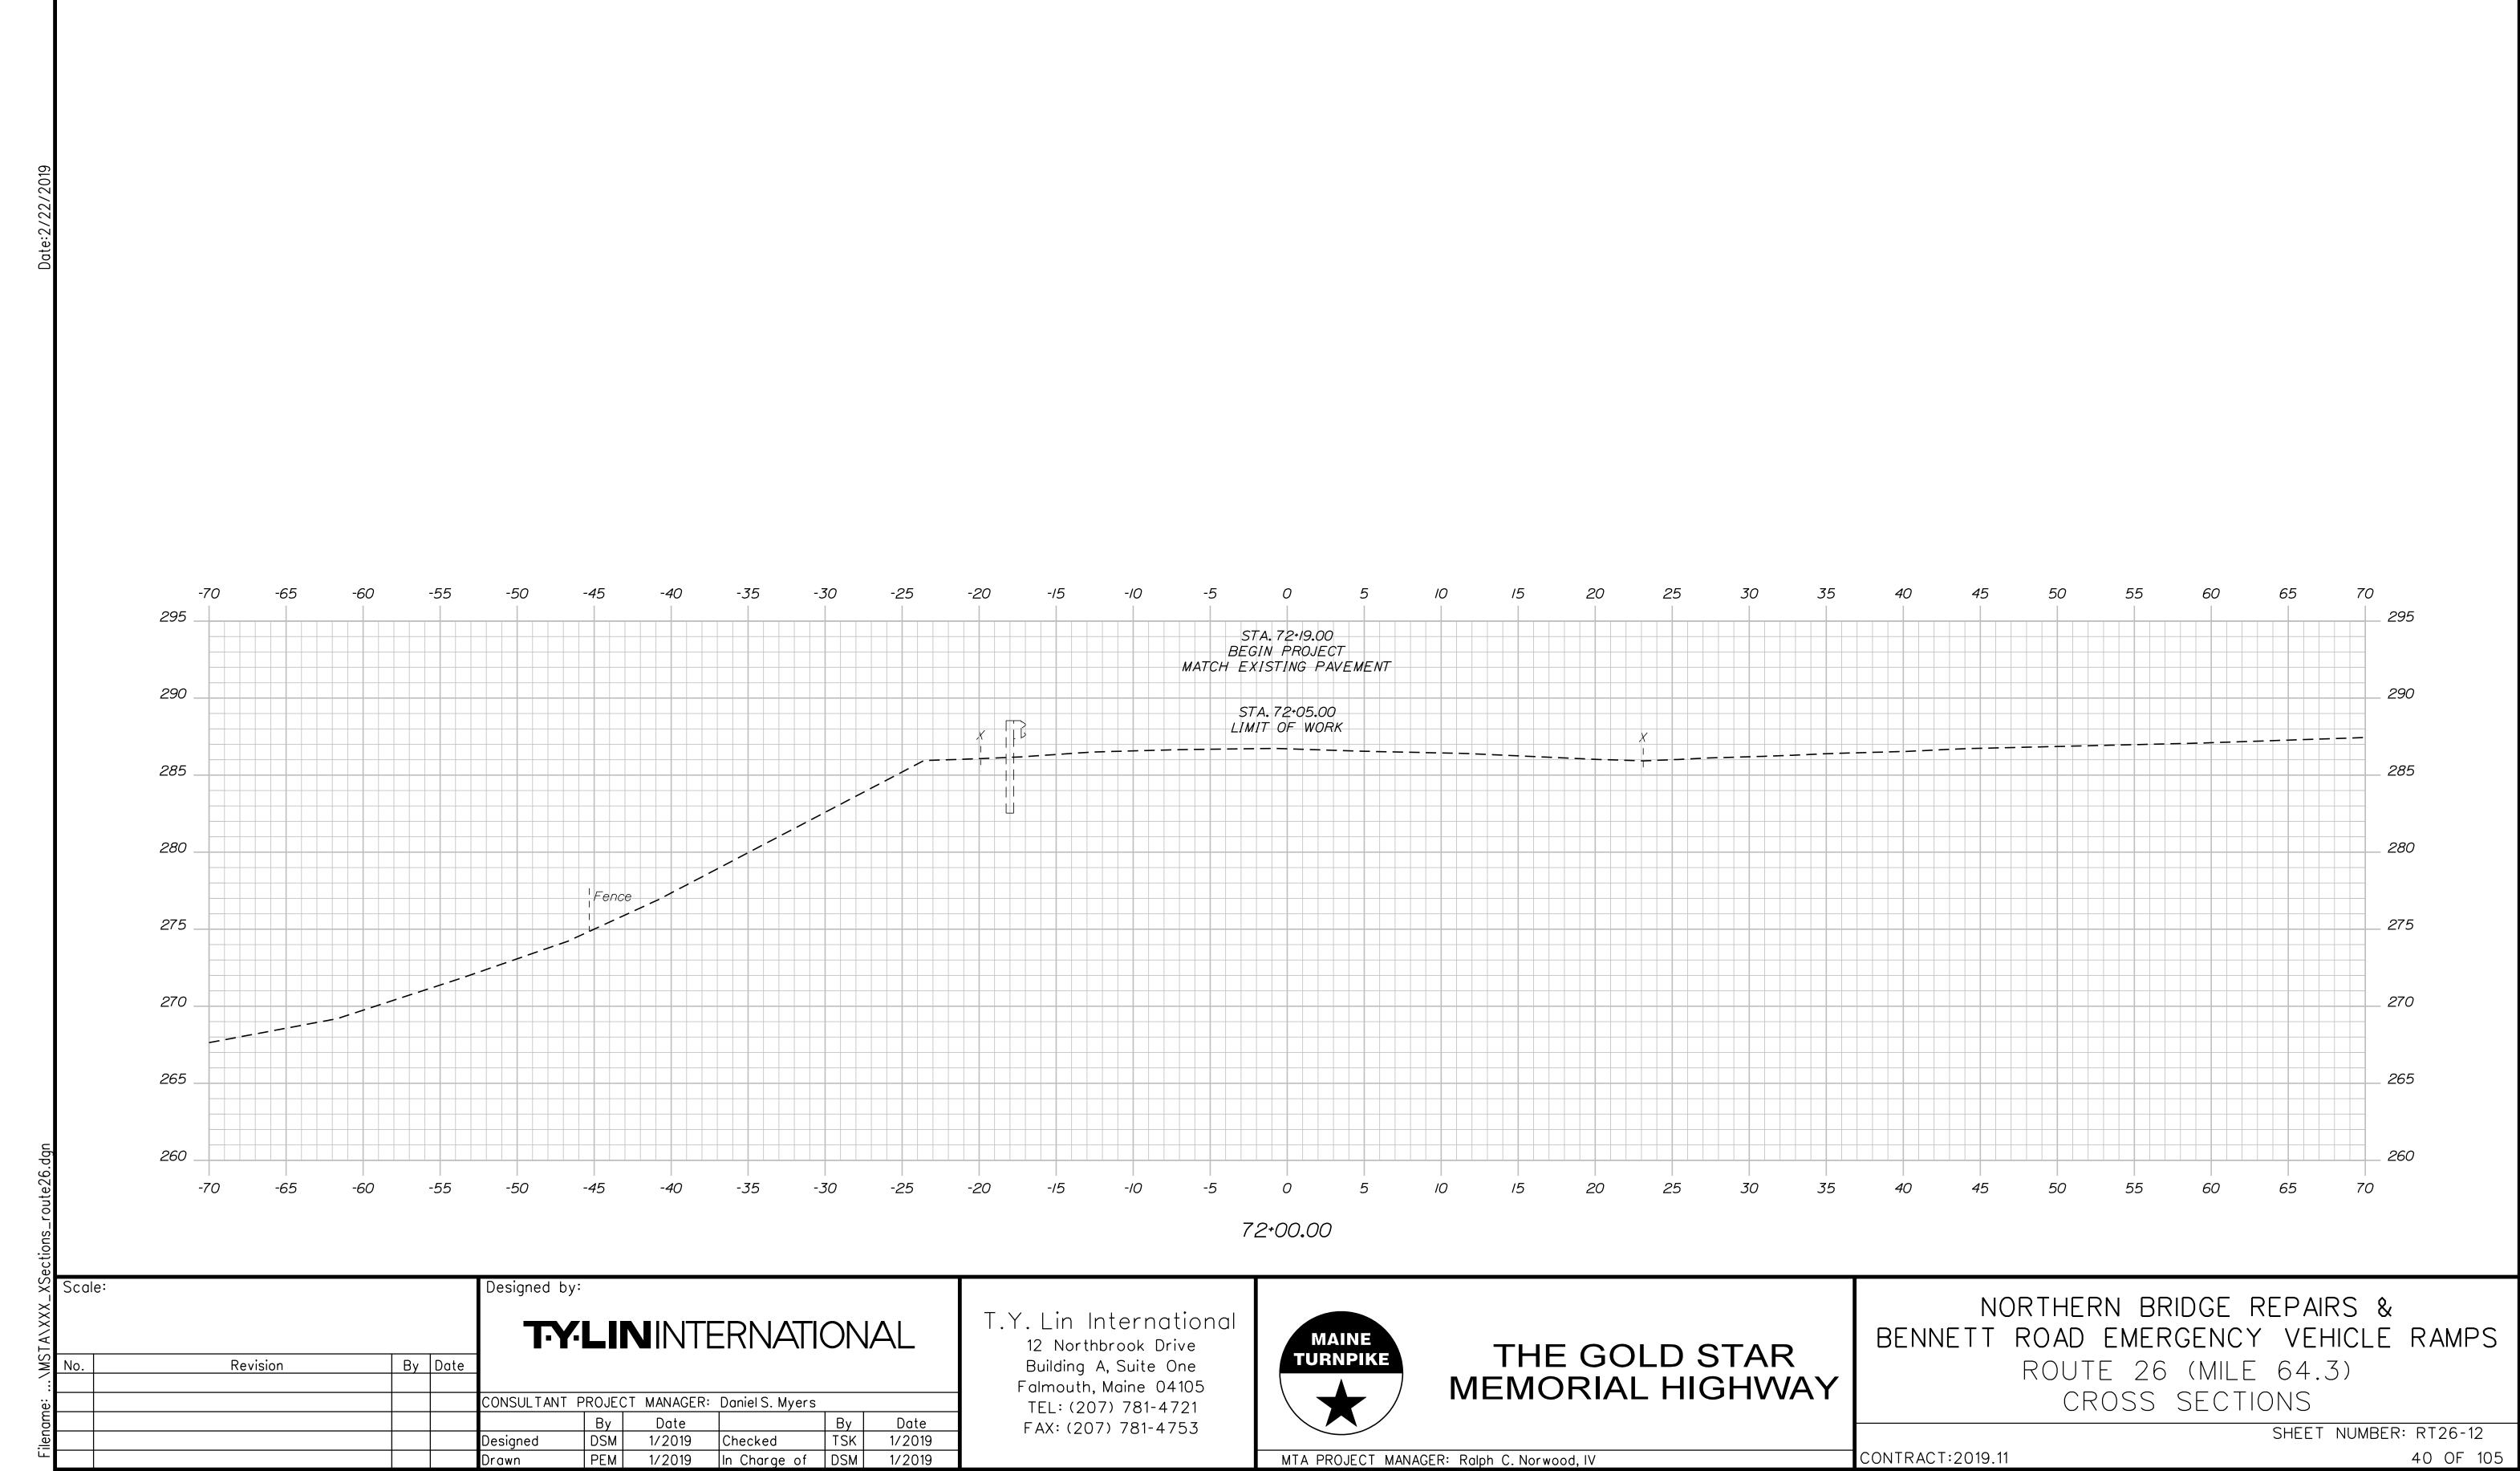



Sta. 72+00.00 to Sta. 72+00.00

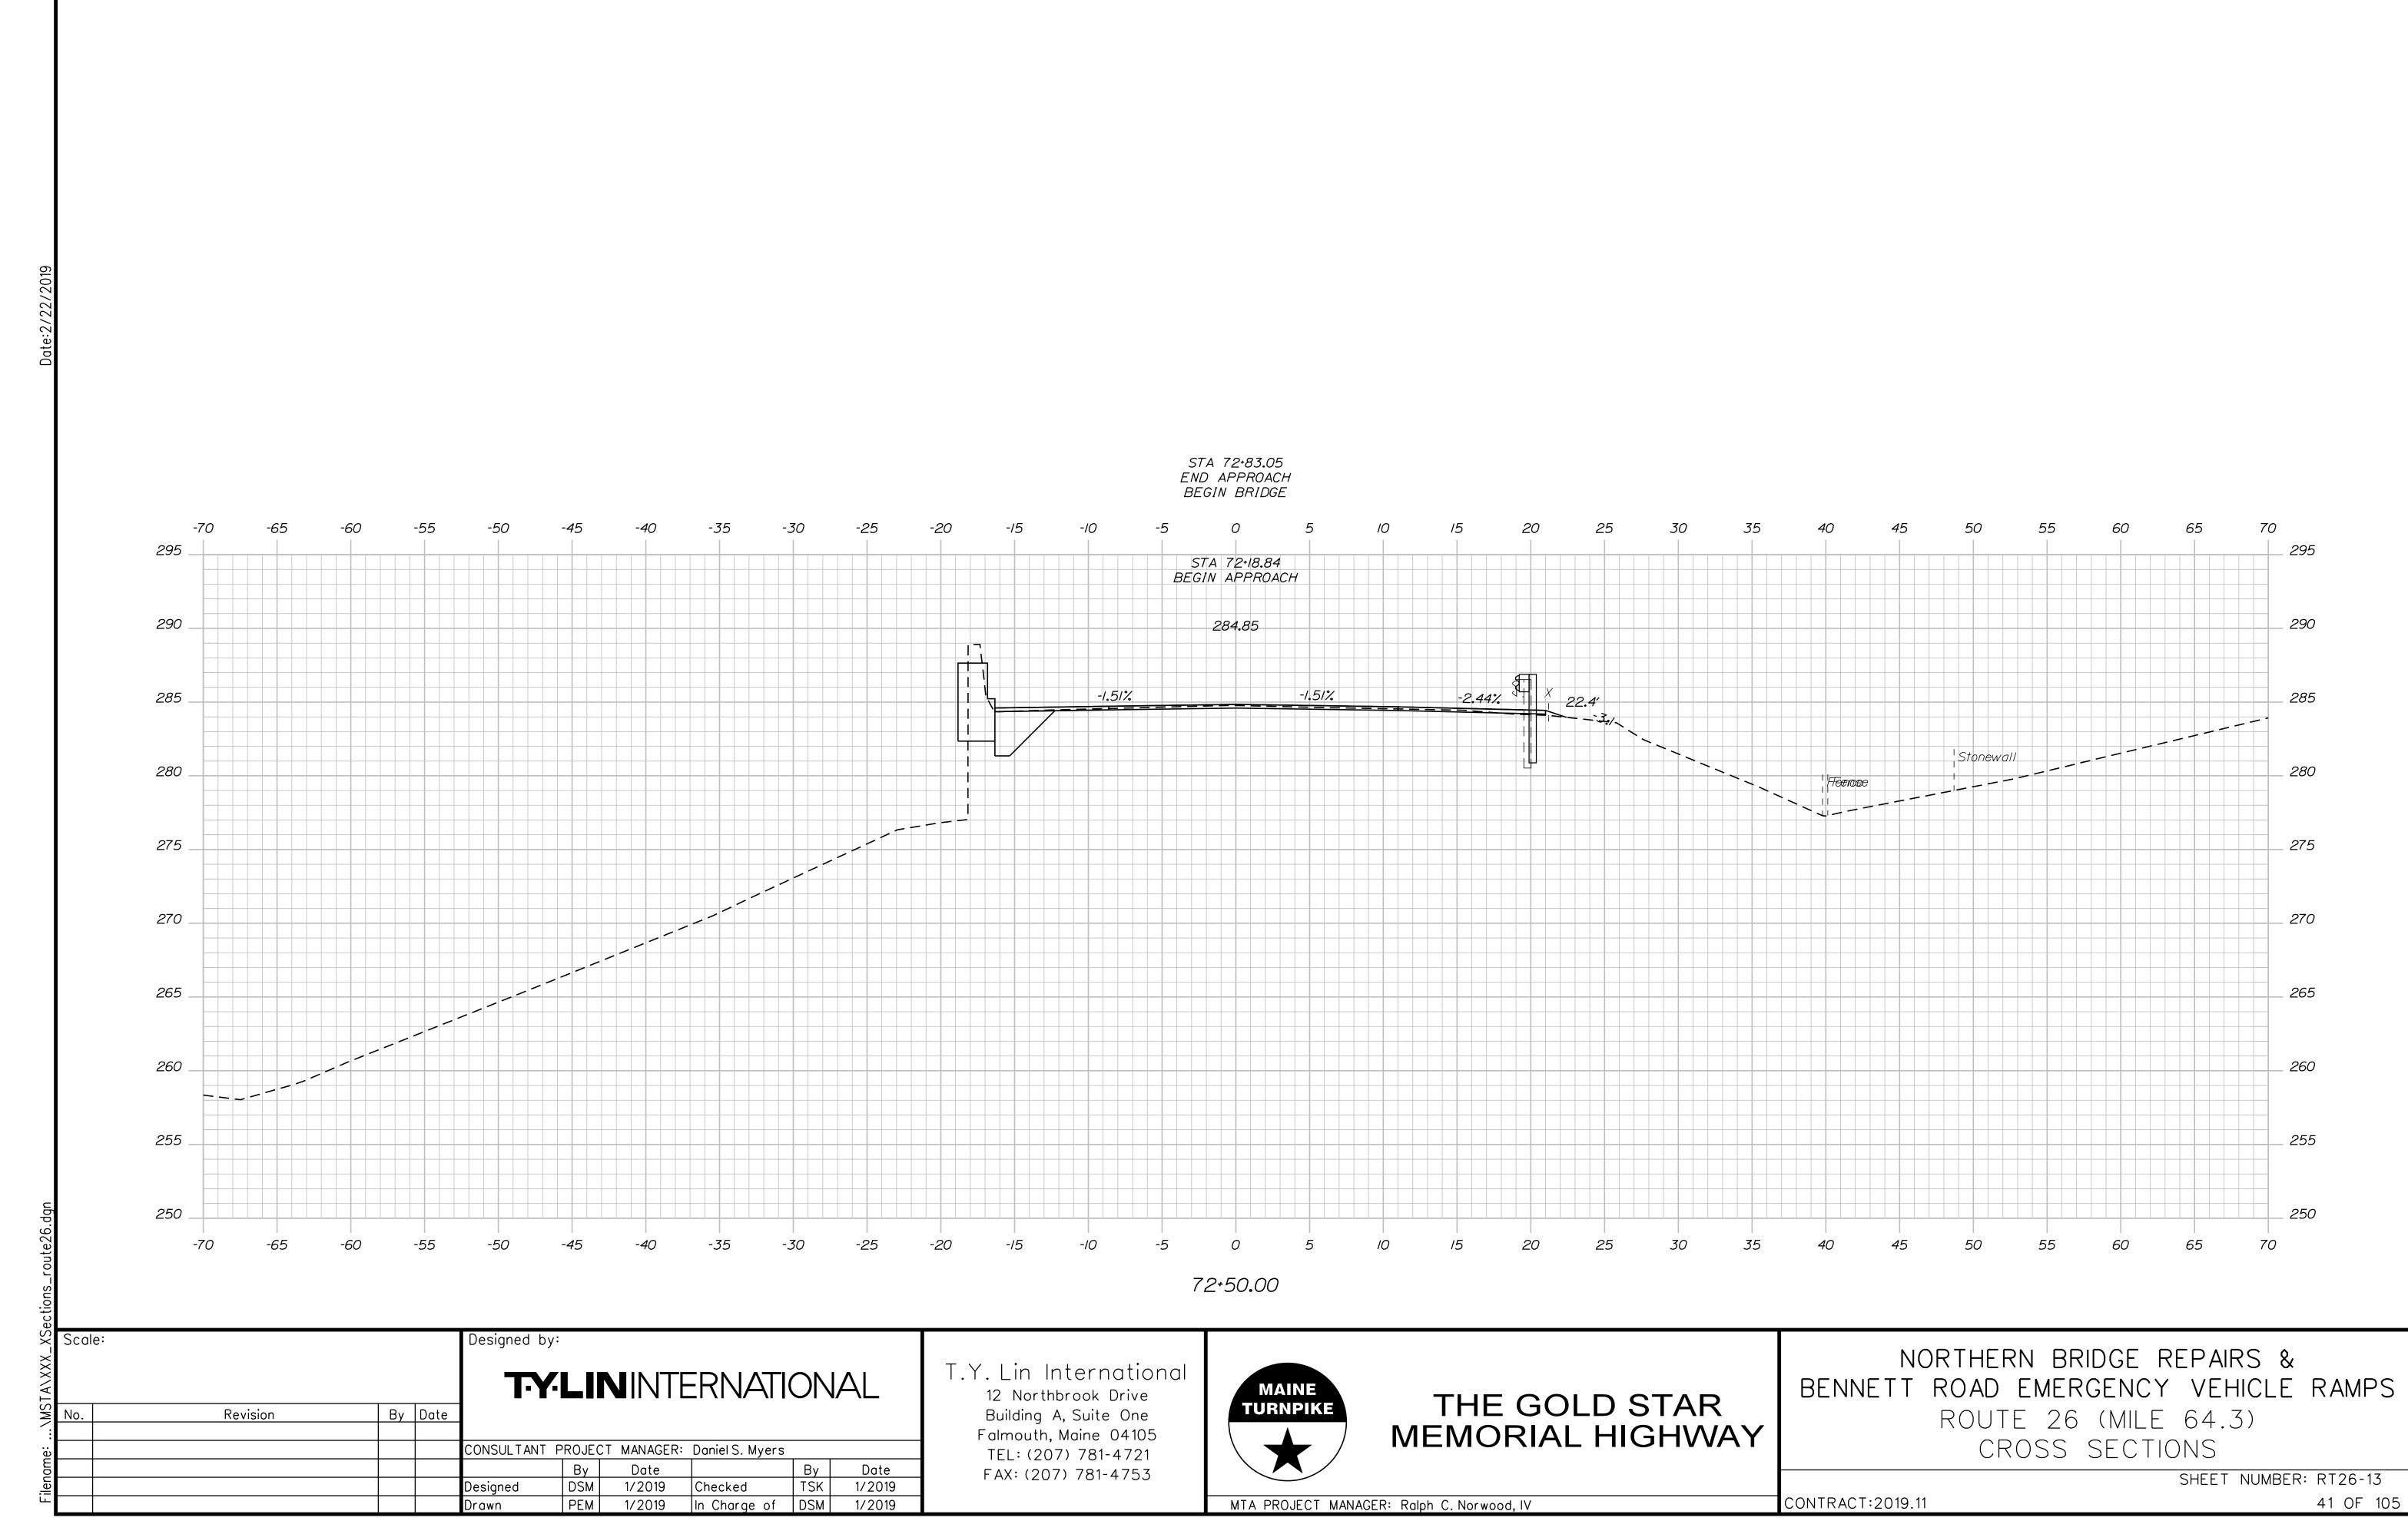

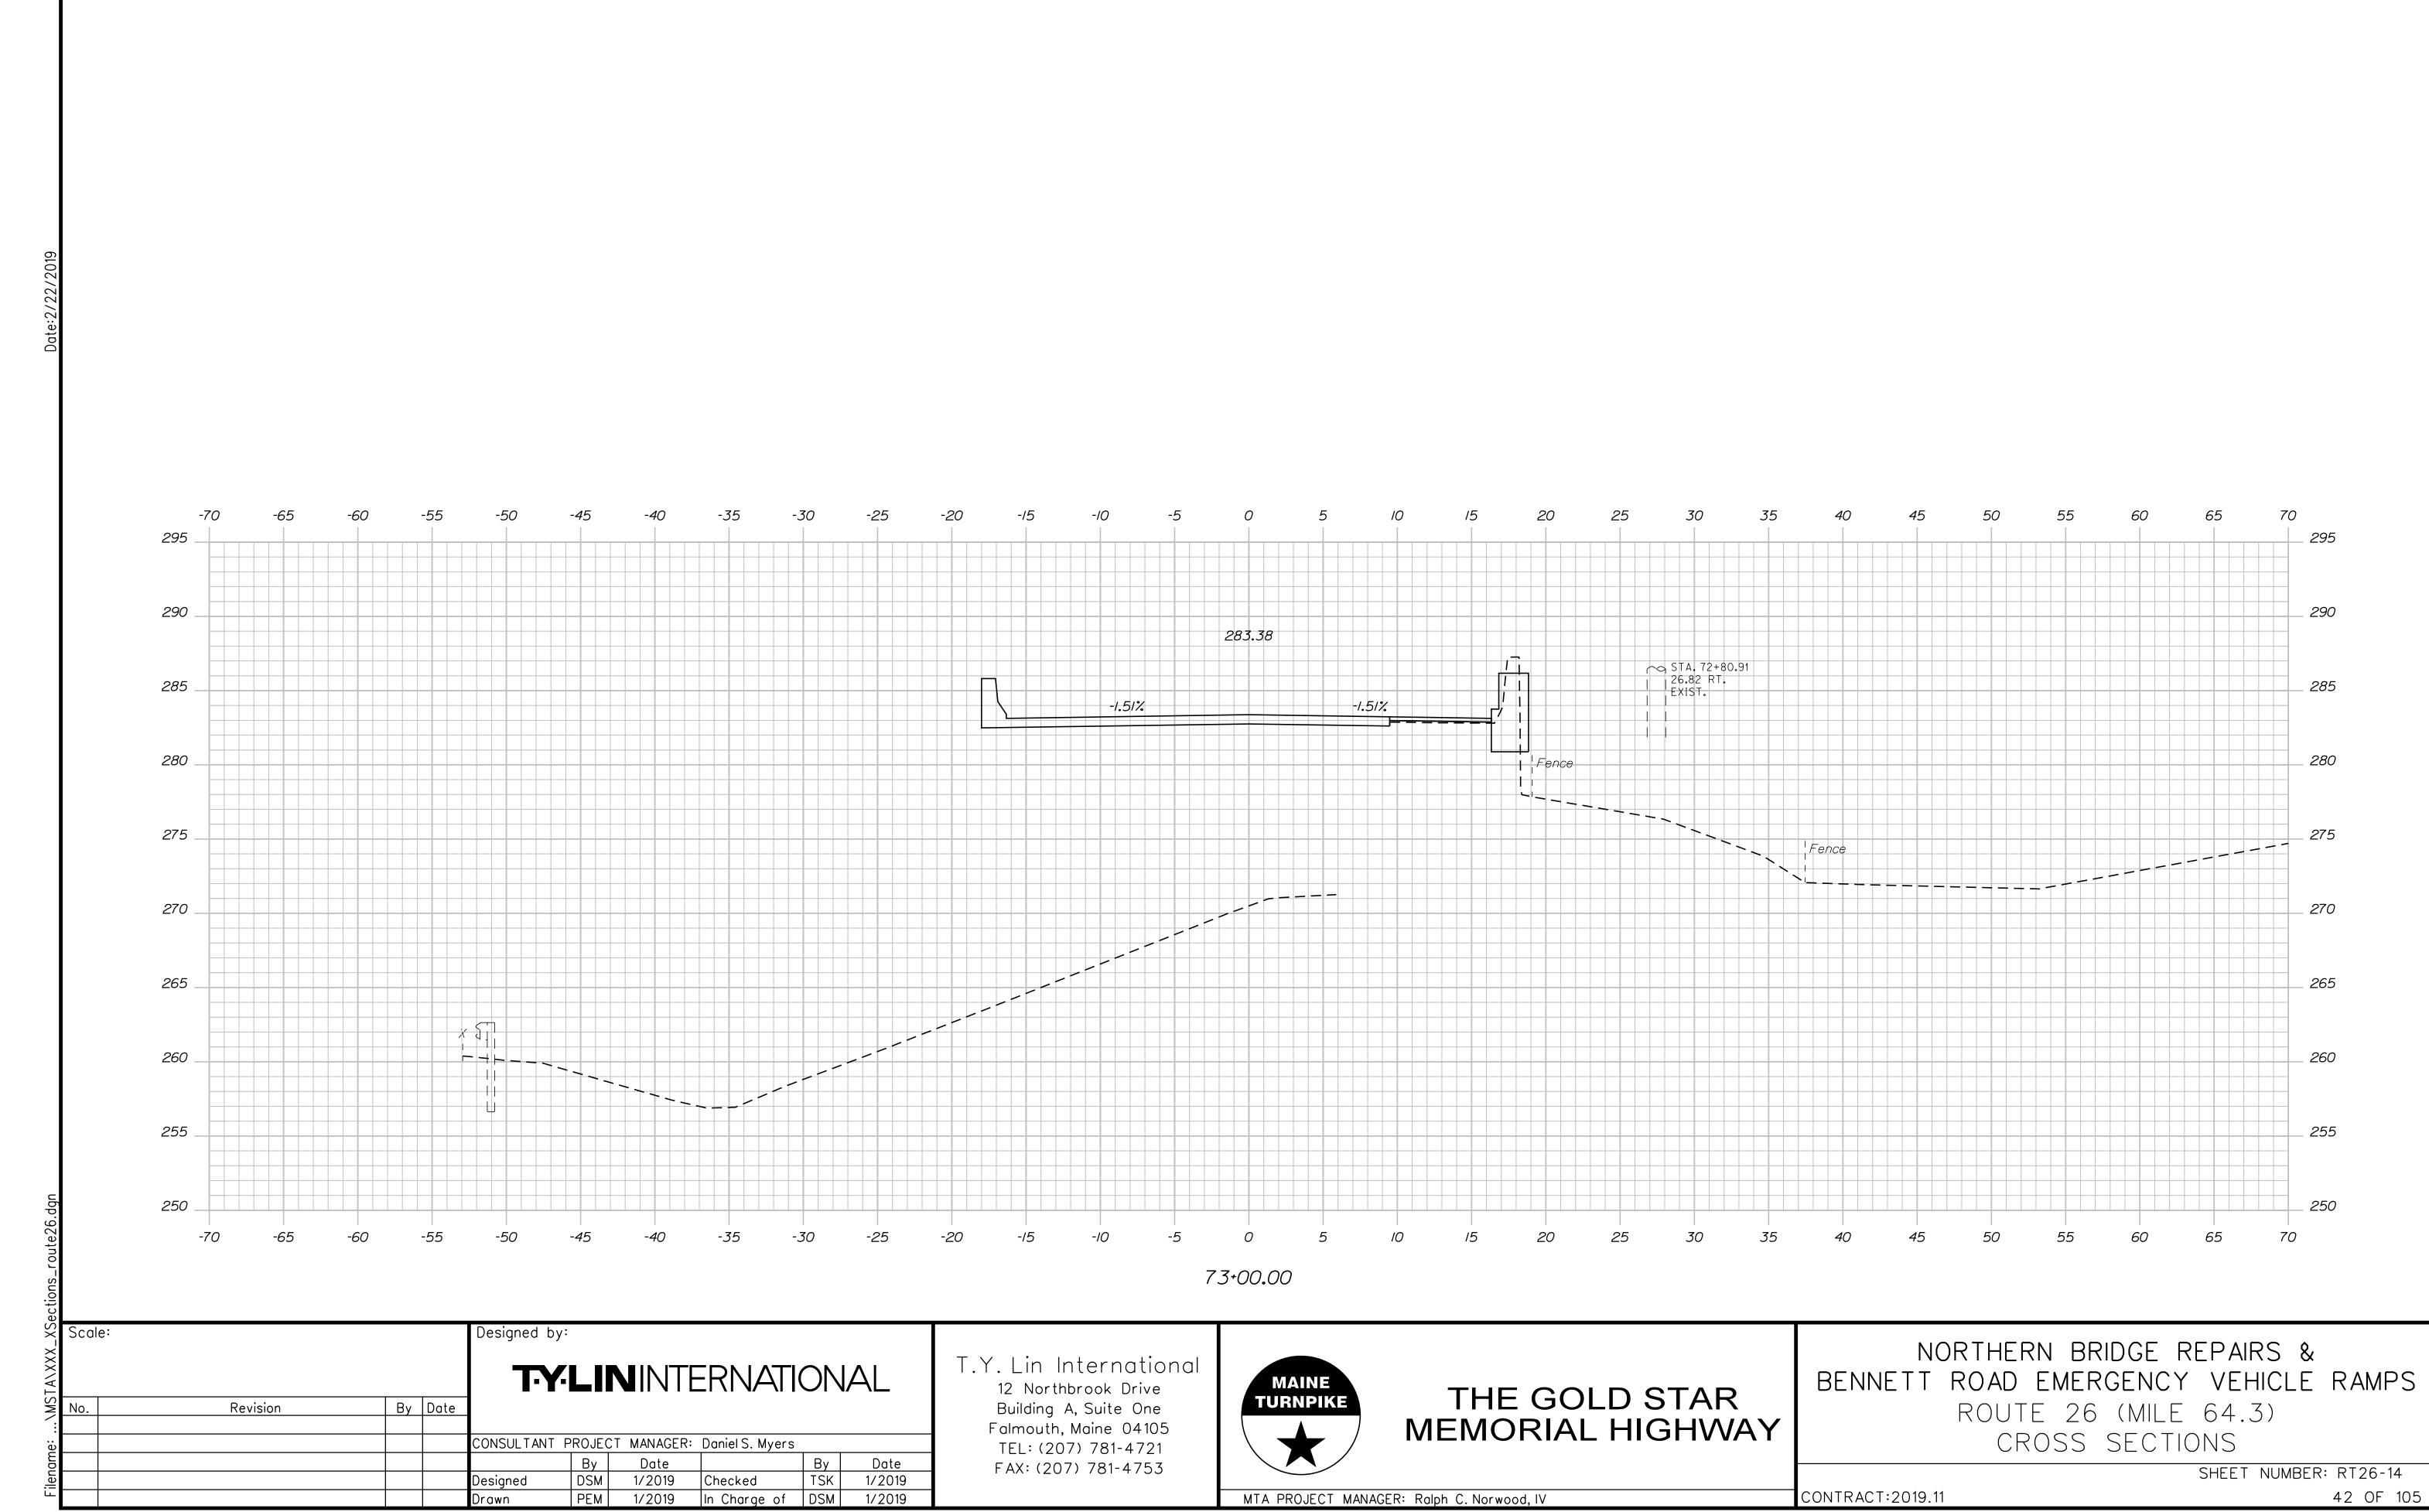

Sta. 73+00.00 to Sta. 73+00.00

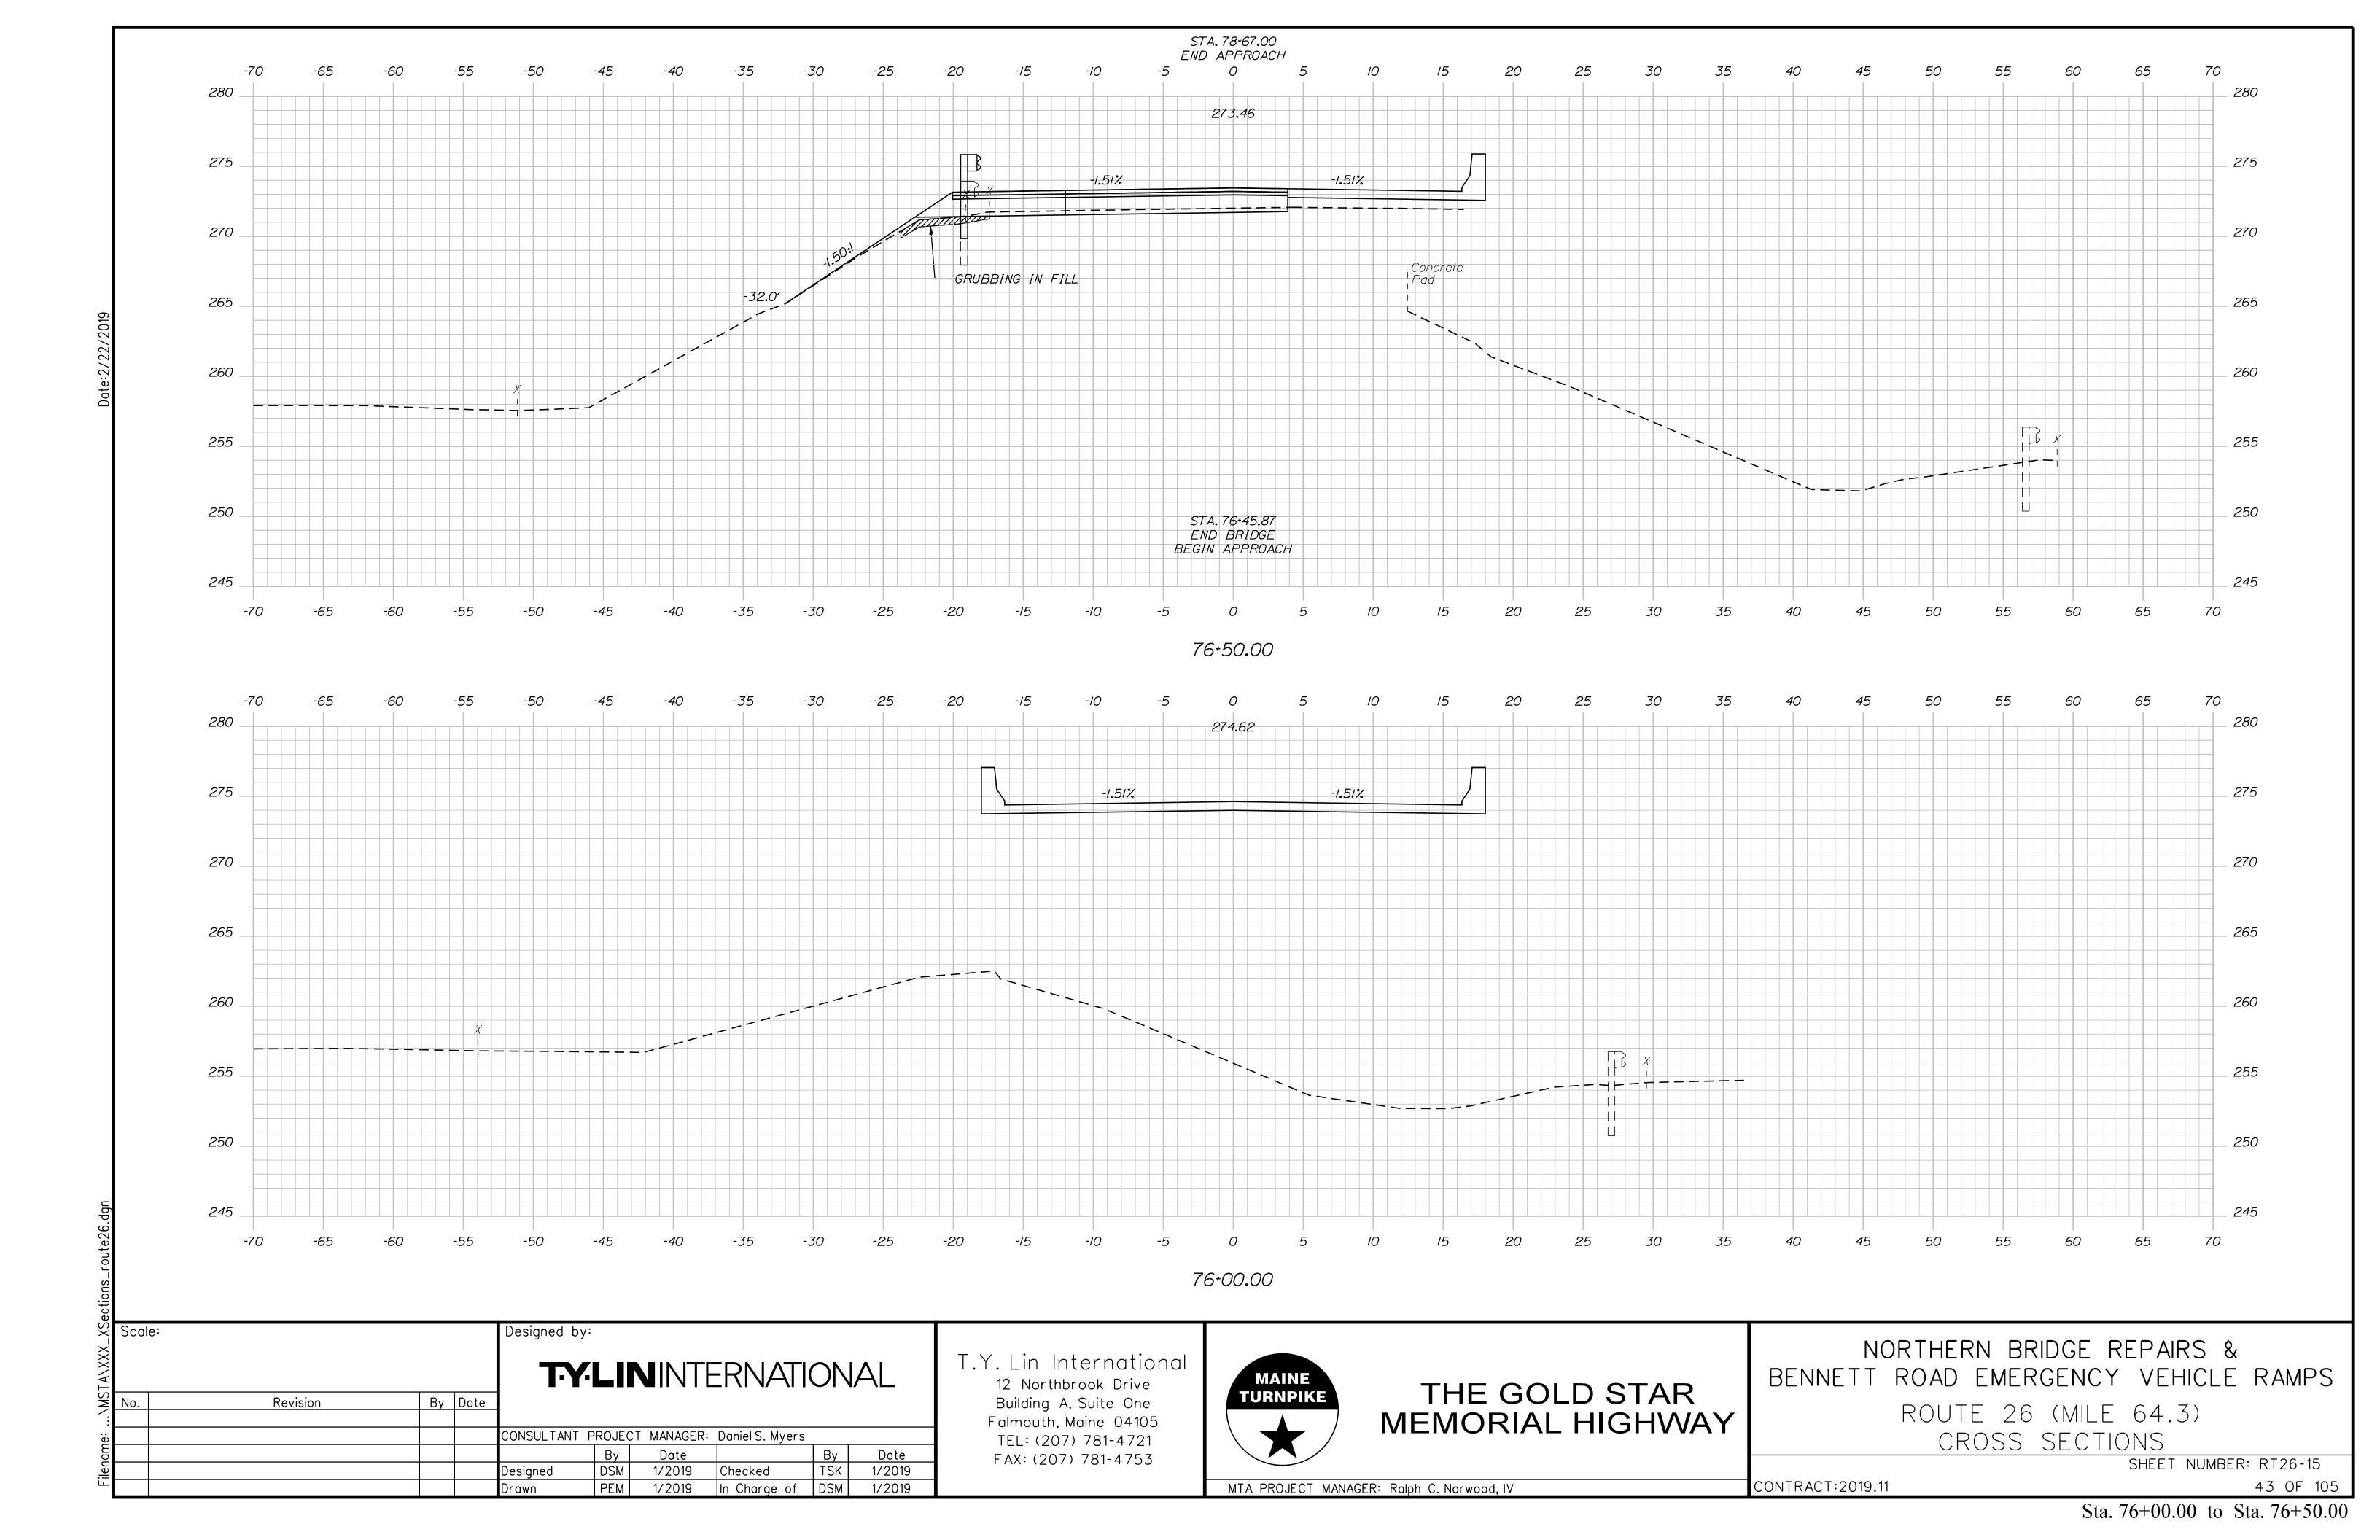

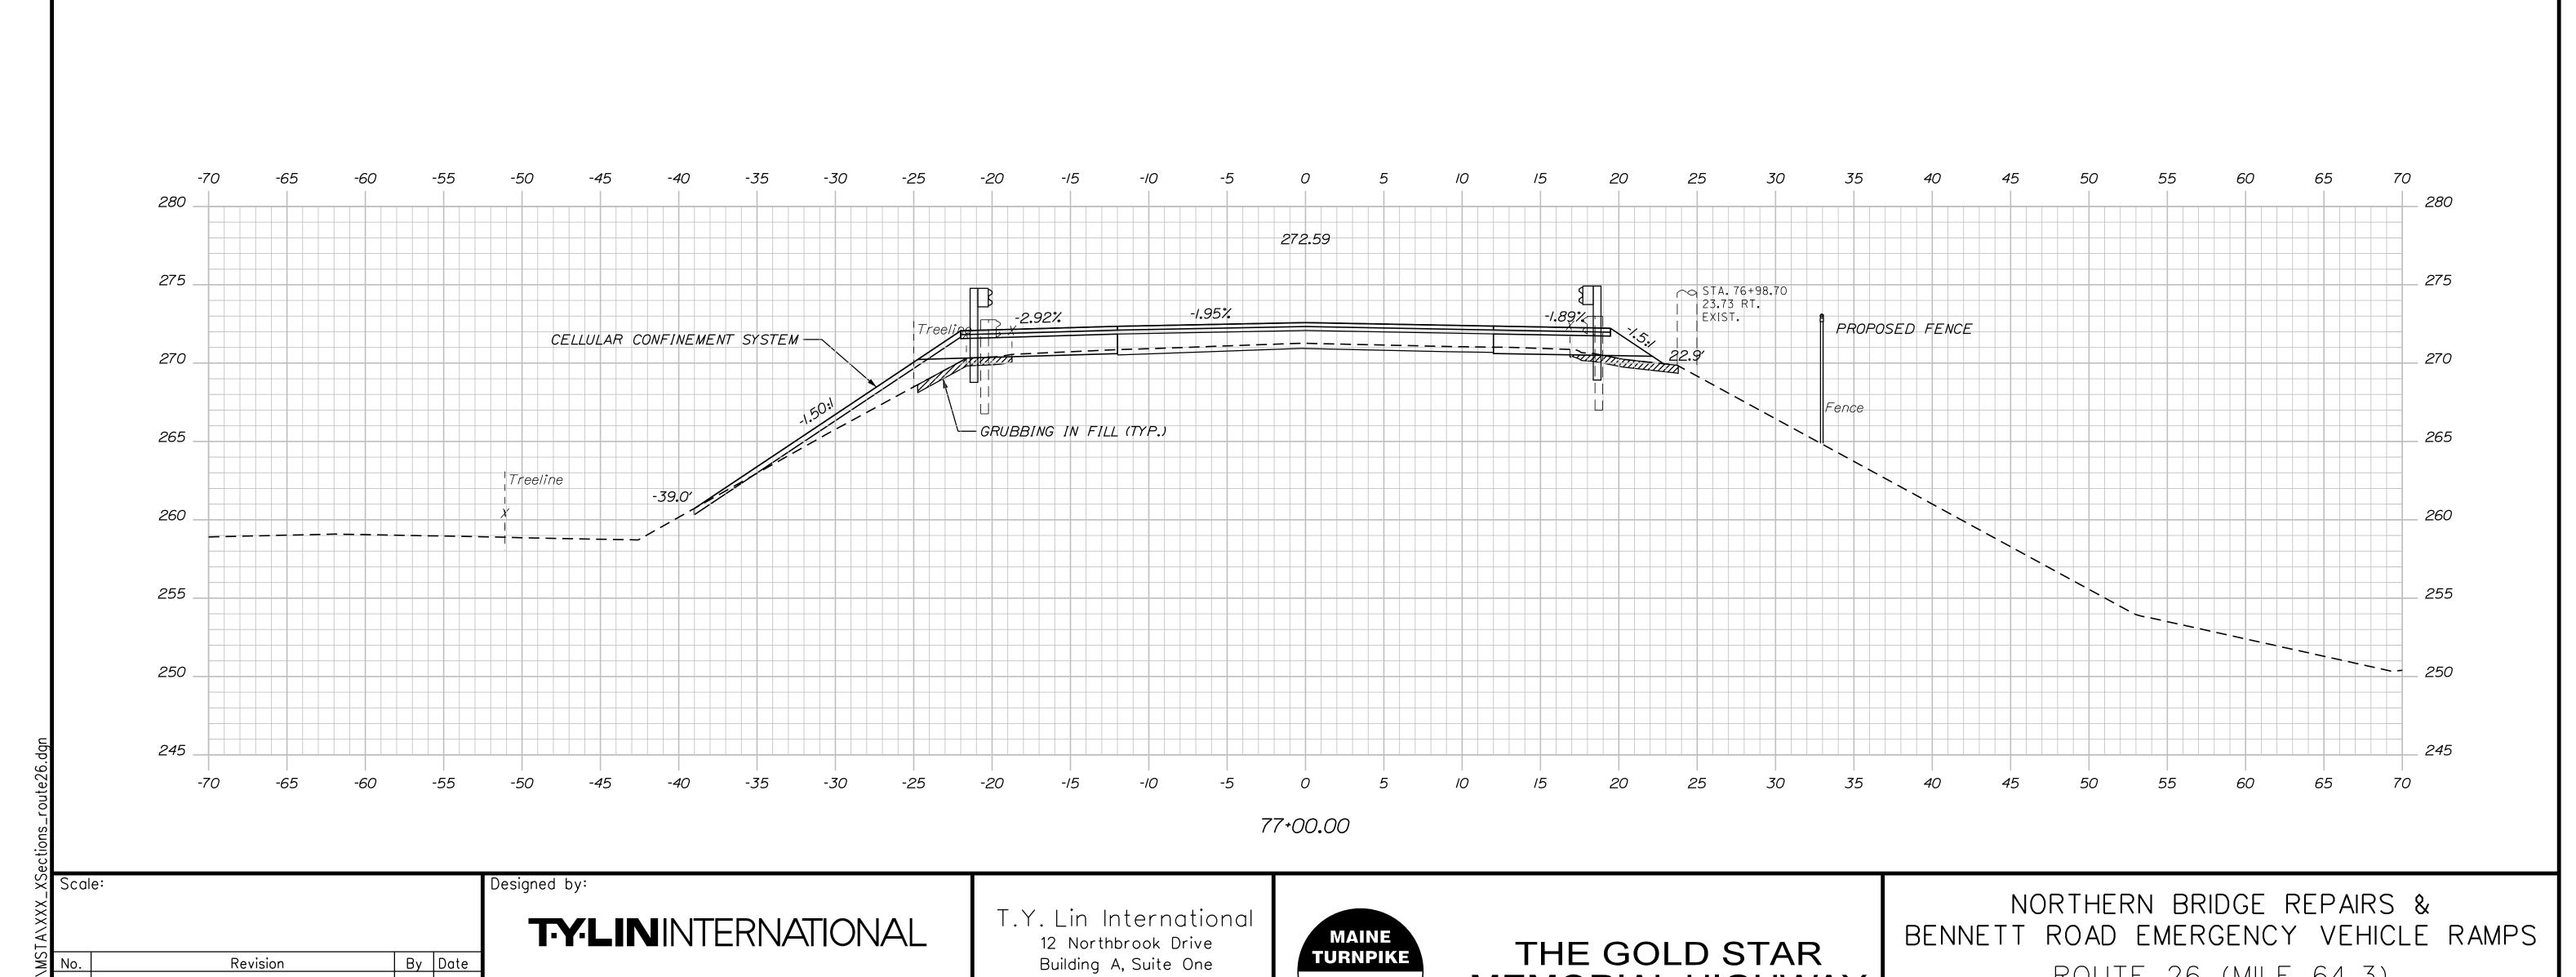

Falmouth, Maine 04105

TEL: (207) 781-4721

FAX: (207) 781-4753

CONSULTANT PROJECT MANAGER: DanielS. Myers

By Date

1/2019

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Checked

In Charge of DSM

By Date
DSM 1/2019
PEM 1/2019

Designed

MEMORIAL HIGHWAY


MTA PROJECT MANAGER: Ralph C. Norwood, IV

ROUTE 26 (MILE 64.3)

CROSS SECTIONS

CONTRACT:2019.11

SHEET NUMBER: RT26-16

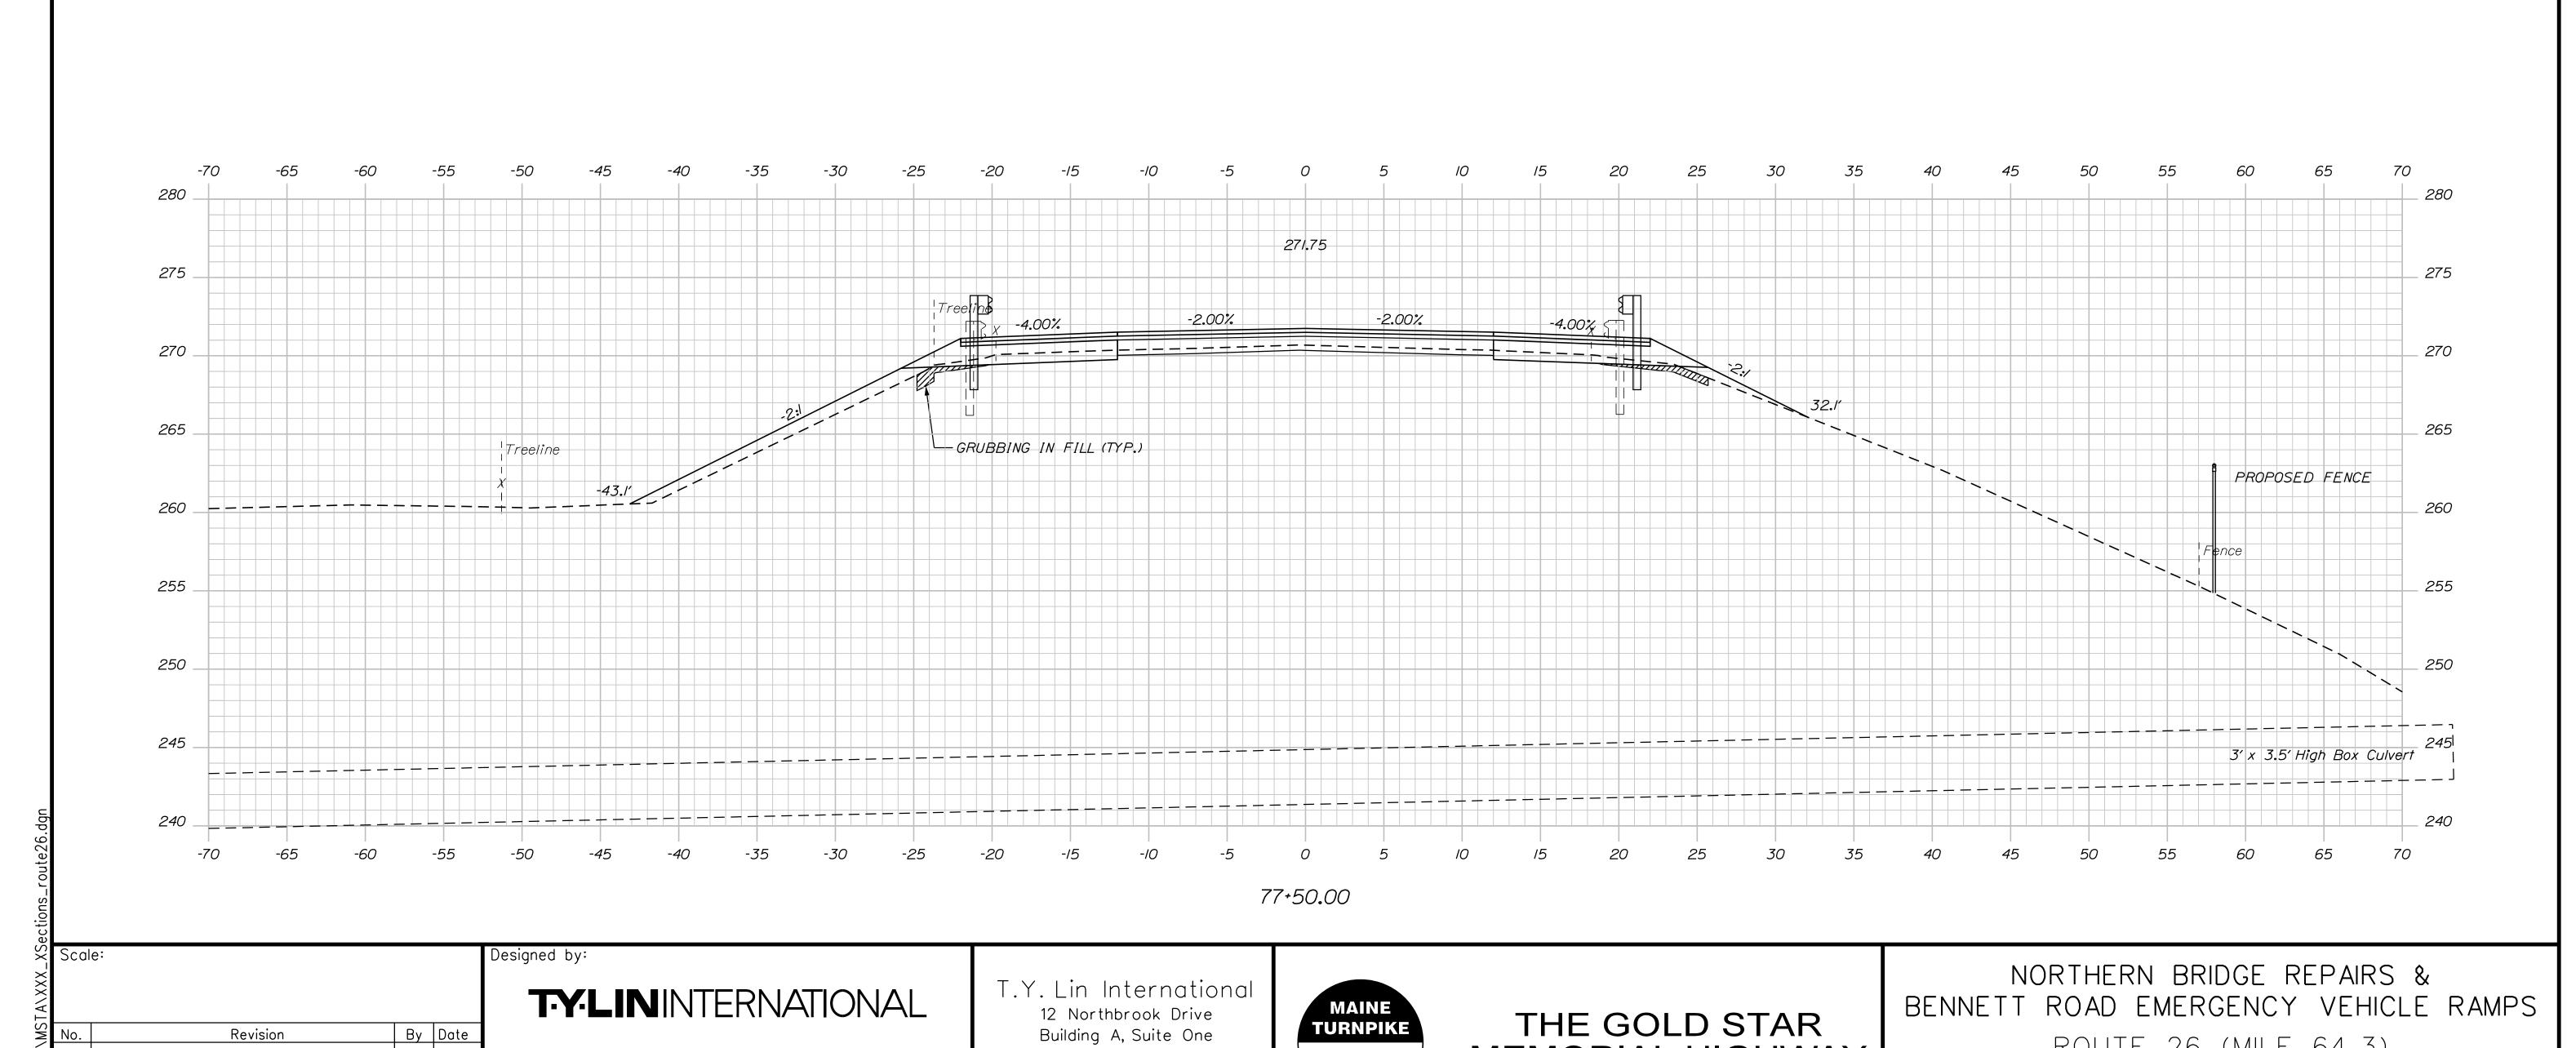

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CONSULTANT PROJECT MANAGER: DanielS. Myers

Checked

In Charge of DSM

By Date

1/2019

 By
 Date

 DSM
 1/2019

MEMORIAL HIGHWAY


MTA PROJECT MANAGER: Ralph C. Norwood, IV

ROUTE 26 (MILE 64.3)

CROSS SECTIONS

CONTRACT:2019.11

SHEET NUMBER: RT26-17

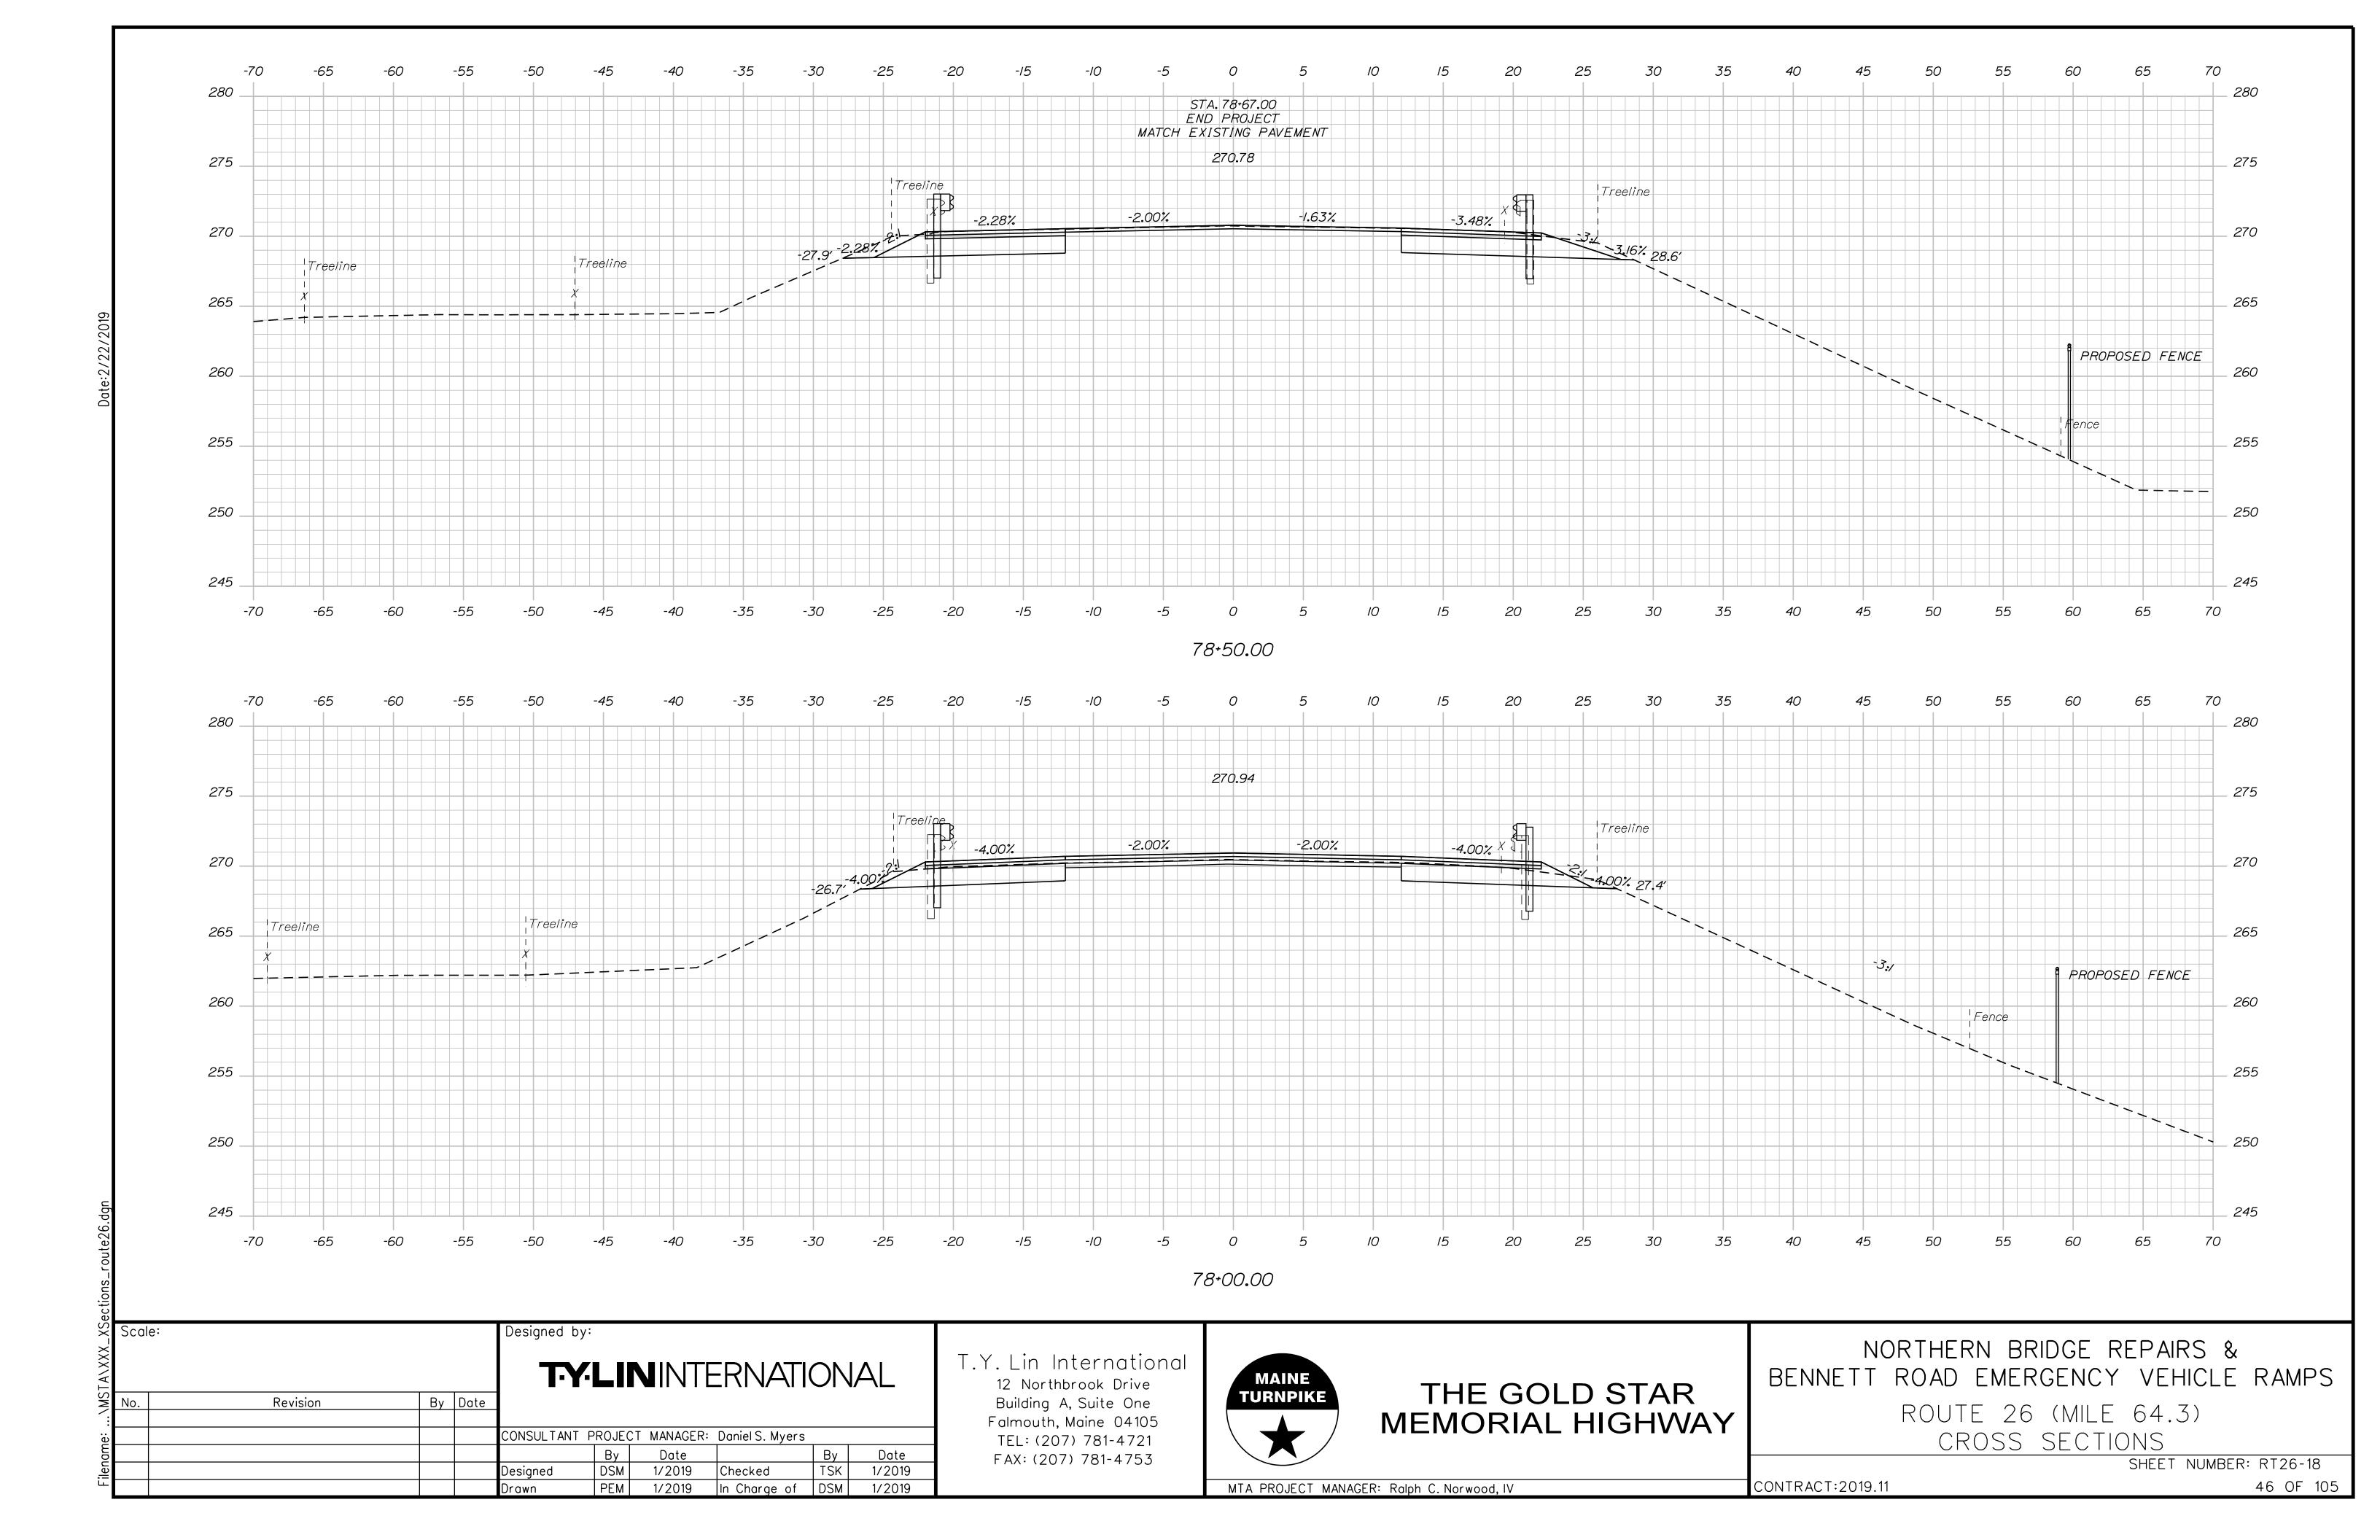


-70 -65 -55 -*4*5 -40 -35 -*30* -25 -20 -15 -5 10 20 25 *30* 35 50 55 60 65 70 -10 15 45 \_ 280 STA. 79+15.00 LIMIT OF WORK Remove — STA. 79+00.51 275 EXI\$*Treeline* |Treeline 270 *2*70 . Treeline 265 265 \_ 260 260 255 255 250 250 70 *79+00.00* Designed by: Scale: NORTHERN BRIDGE REPAIRS & T.Y. Lin International T-Y-LININTERNATIONAL BENNETT ROAD EMERGENCY VEHICLE RAMPS 12 Northbrook Drive THE GOLD STAR **TURNPIKE** Revision By Date Building A, Suite One ROUTE 26 (MILE 64.3) MEMORIAL HIGHWAY Falmouth, Maine 04105 CONSULTANT PROJECT MANAGER: DanielS. Myers CROSS SECTIONS TEL: (207) 781-4721 By Date
DSM 1/2019
PEM 1/2019 By Date FAX: (207) 781-4753 SHEET NUMBER: RT26-19 TSK 1/2019 Checked Designed


MTA PROJECT MANAGER: Ralph C. Norwood, IV

In Charge of DSM


CONTRACT:2019.11 Sta. 79+00.00 to Sta. 79+00.00

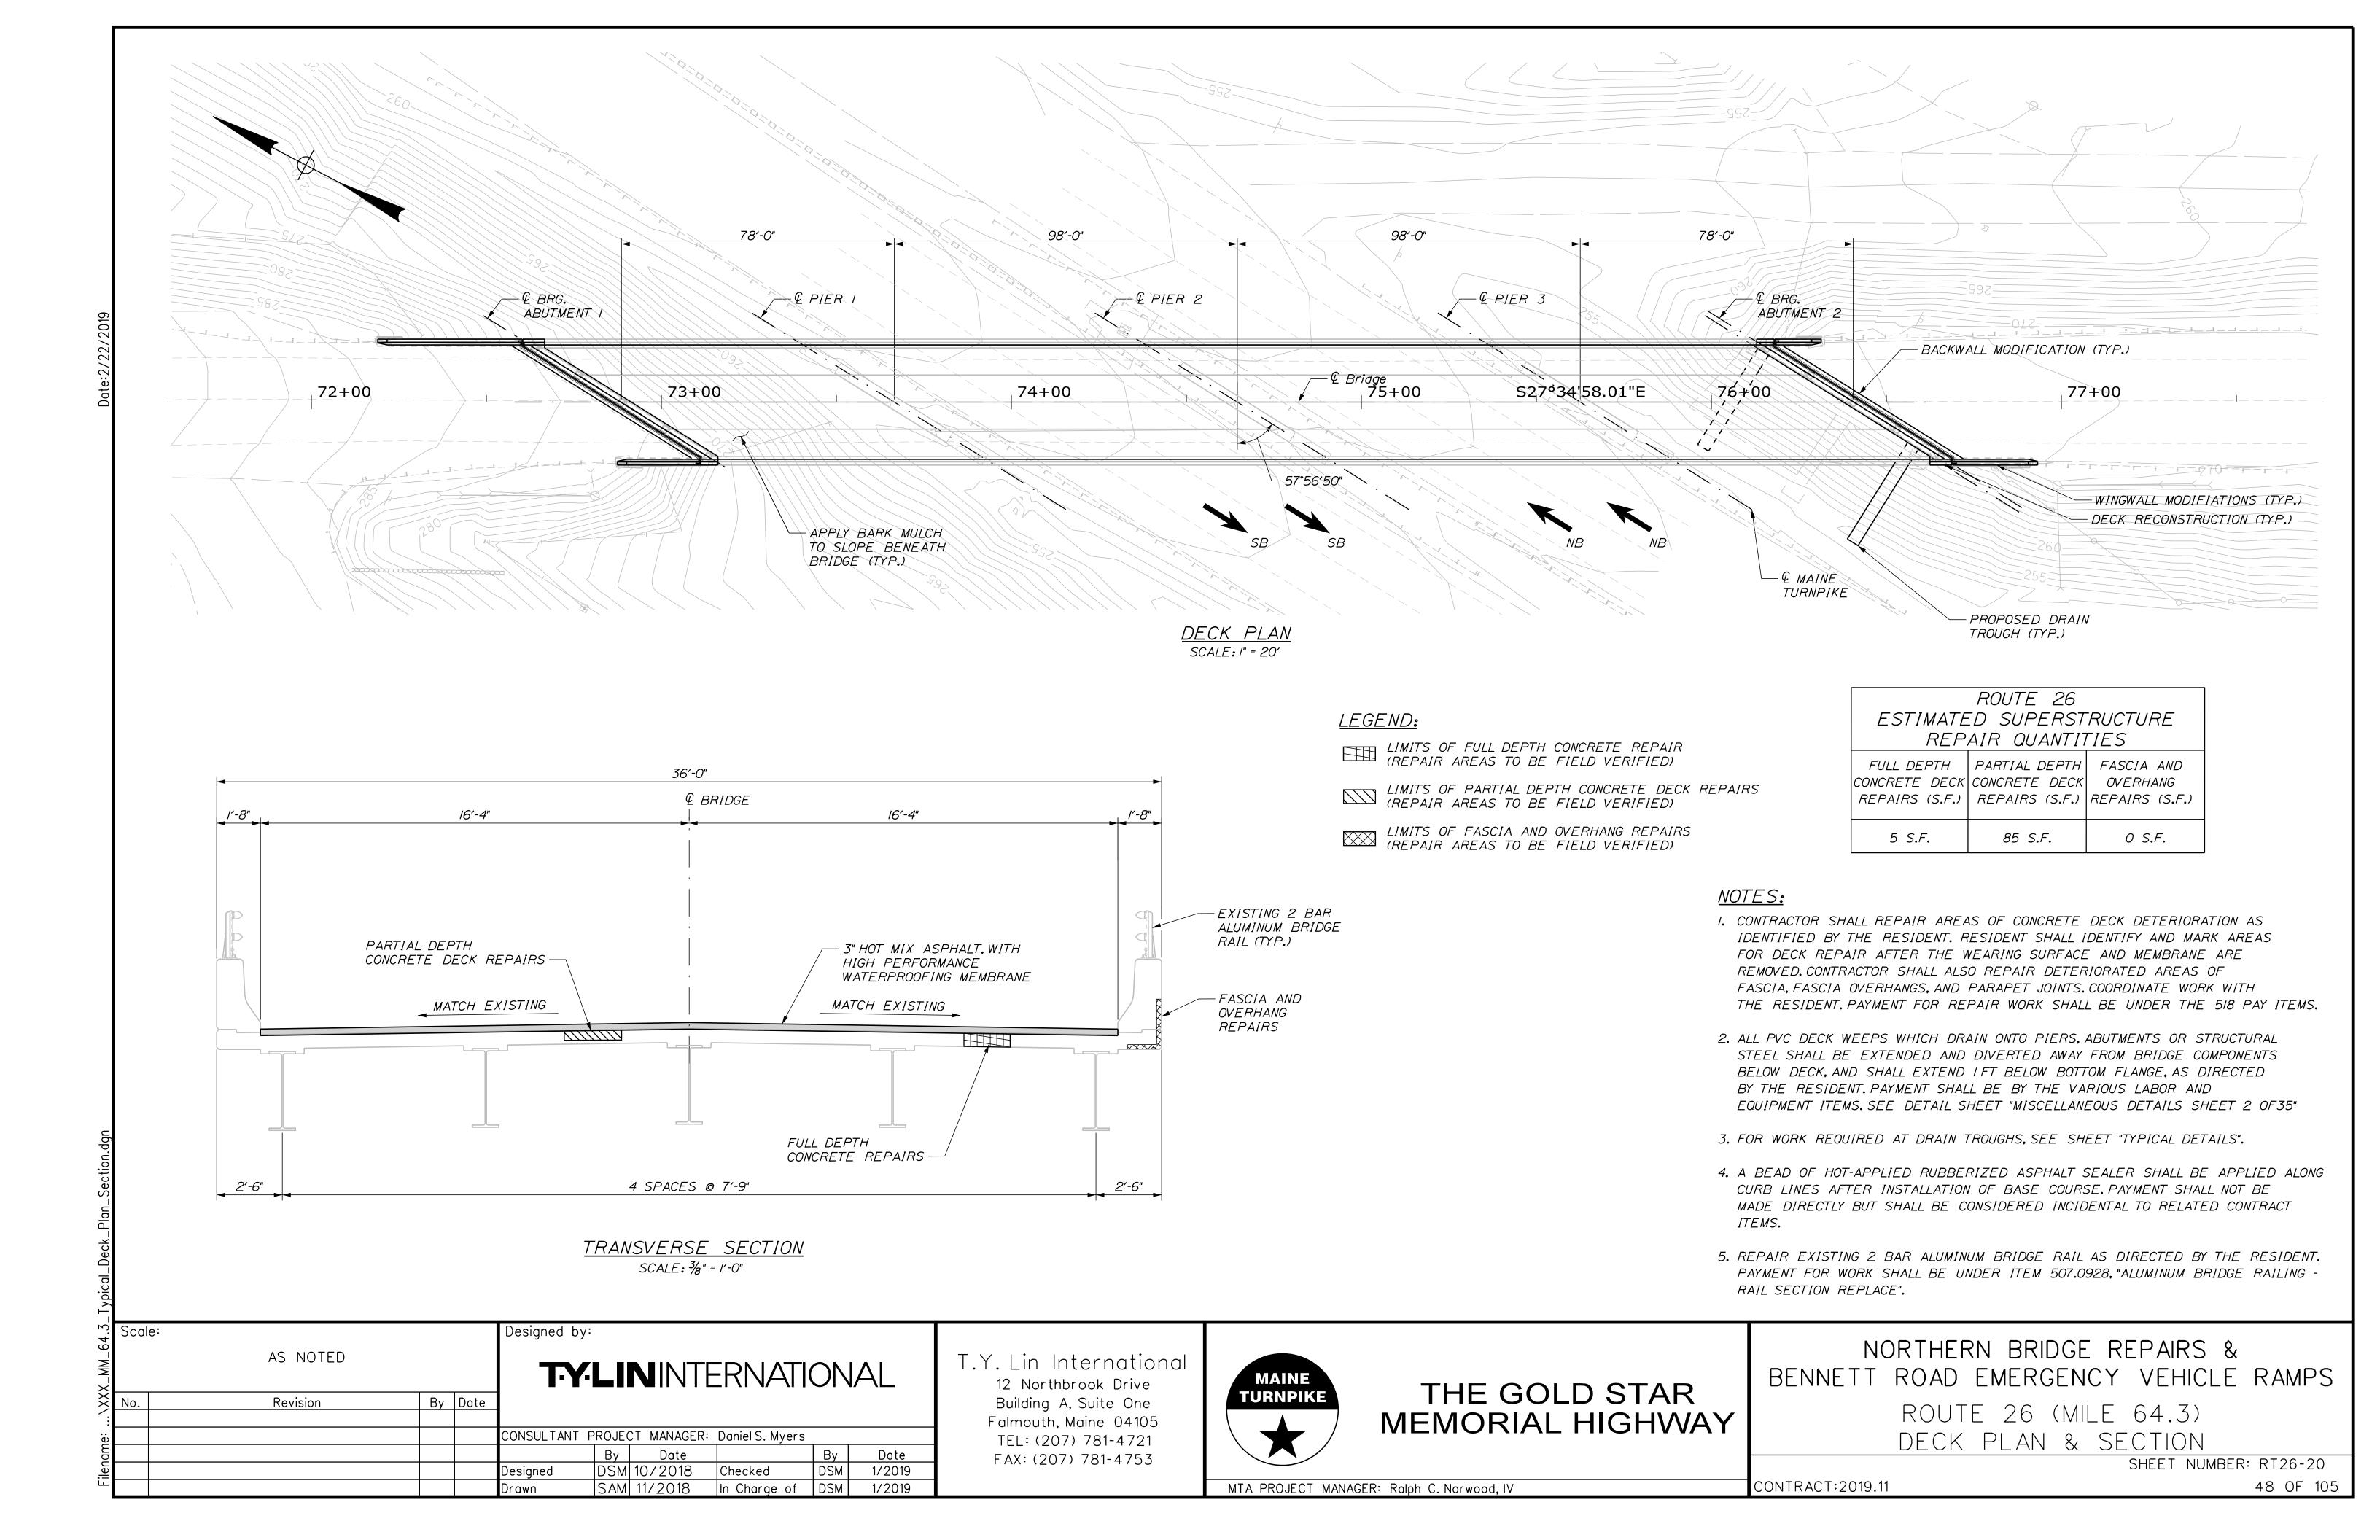

#### EXISTING BRIDGE 3/8" = 1'-0"

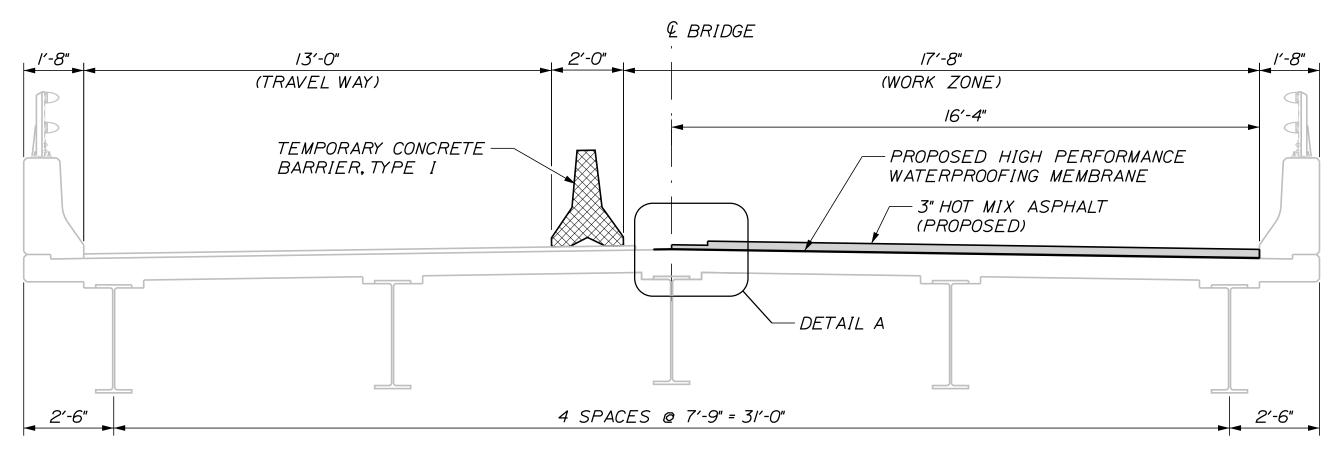

PHASE I 3/8" = 1'-0"

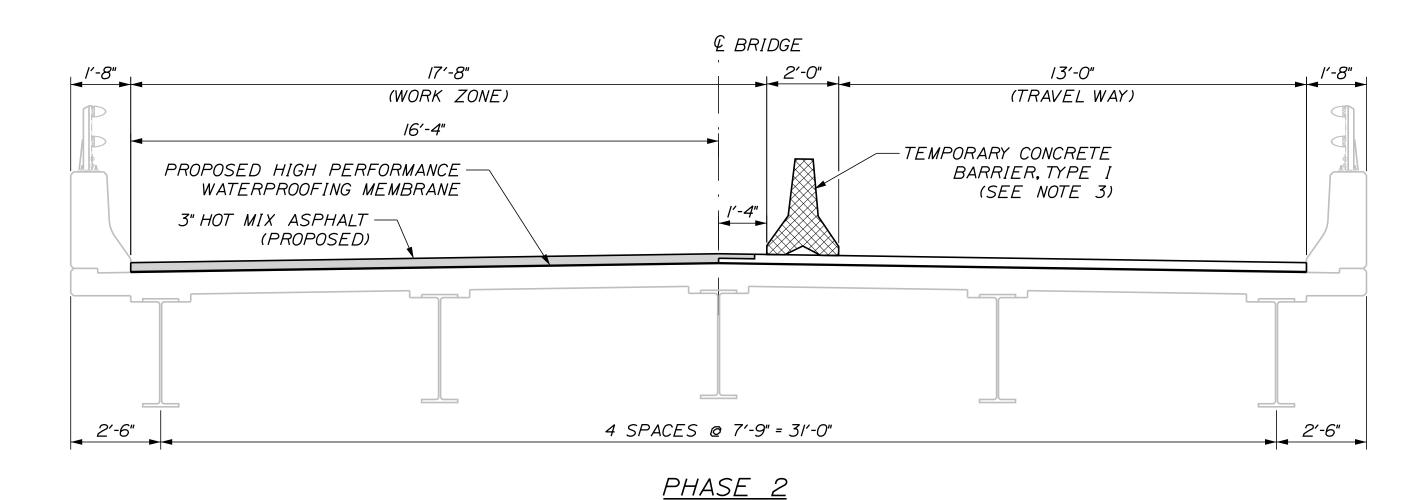

3/8" = 1'-0"

MEMBRANE

### PHASING NOTES:

I. SUGGESTED SEQUENCE OF CONSTRUCTION: PHASE I:

*ℚ BRIDGE* 

BASE

PAVEMENT

/'-O"

<u>DETAIL A</u>

1//2" = 1'-0"

SURFACE PAVEMENT -

SHIFT ALL TRAFFIC TO NORTH SIDE OF BRIDGE, ONE-WAY ALTERNATING. REHAB & CONSTRUCT SOUTH SIDE BRIDGE & APPROACHES (EXCEPT JOINT BLOCKOUT).

FULL CLOSURE:

CLOSE ALL TRAFFIC AND JACK SUPERSTRUCTURE TO FINAL GRADE. COMPLETE SOUTH SIDE JOINT.

RESET TEMPORARY CONCRETE BARRIER.

PHASE 2:

SHIFT ALL TRAFFIC TO SOUTH SIDE OF BRIDGE, ONE-WAY ALTERNATING. REHAB & CONSTRUCT NORTH SIDE BRIDGE & APPROACHES. PLACE BARRIER ONTO SHEETS OF PYLWOOD IF FINAL PAVEMENT COMPLETE. OPEN BRIDGE TO ALL TRAFFIC.

- 2. SEE SHEET "STRIP SEAL EXPANSION JOINT 1 OF 2" FOR EXPANSION JOINT SUGGESTED SEQUENCE OF CONSTRUCTION.
- 3. TEMPORARY CONCRETE BARRIER PLACED ON NEW HOT MIX ASPHALT SHALL BE PLACED ON PLYWOOD AS DIRECTED BY THE RESIDENT TO PREVENT DAMAGE TO THE ASPHALT SURFACE. COSTS FOR PLYWOOD SHALL BE INCIDENTAL TO ITEM 526.306, "TEMPORARY CONCRETE BARRIER, TYPE I - SUPPLIED BY THE AUTHORITY".

Sca	ıle:			Designed b	y:						
No.	AS NOTED	T-Y-LININTERNATIC						ON.	NAL		
No.	Revision	Ву	Date	1							
				CONSULTANT	PROJEC	T MANAGER	Daniel S. Myers				
					Ву	Date		Ву	Date		
				Designed	DSM	1/2019	Checked	KSD	1/2019		
				Drawn	SAM	1/2019	In Charge of	DSM	1/2019		

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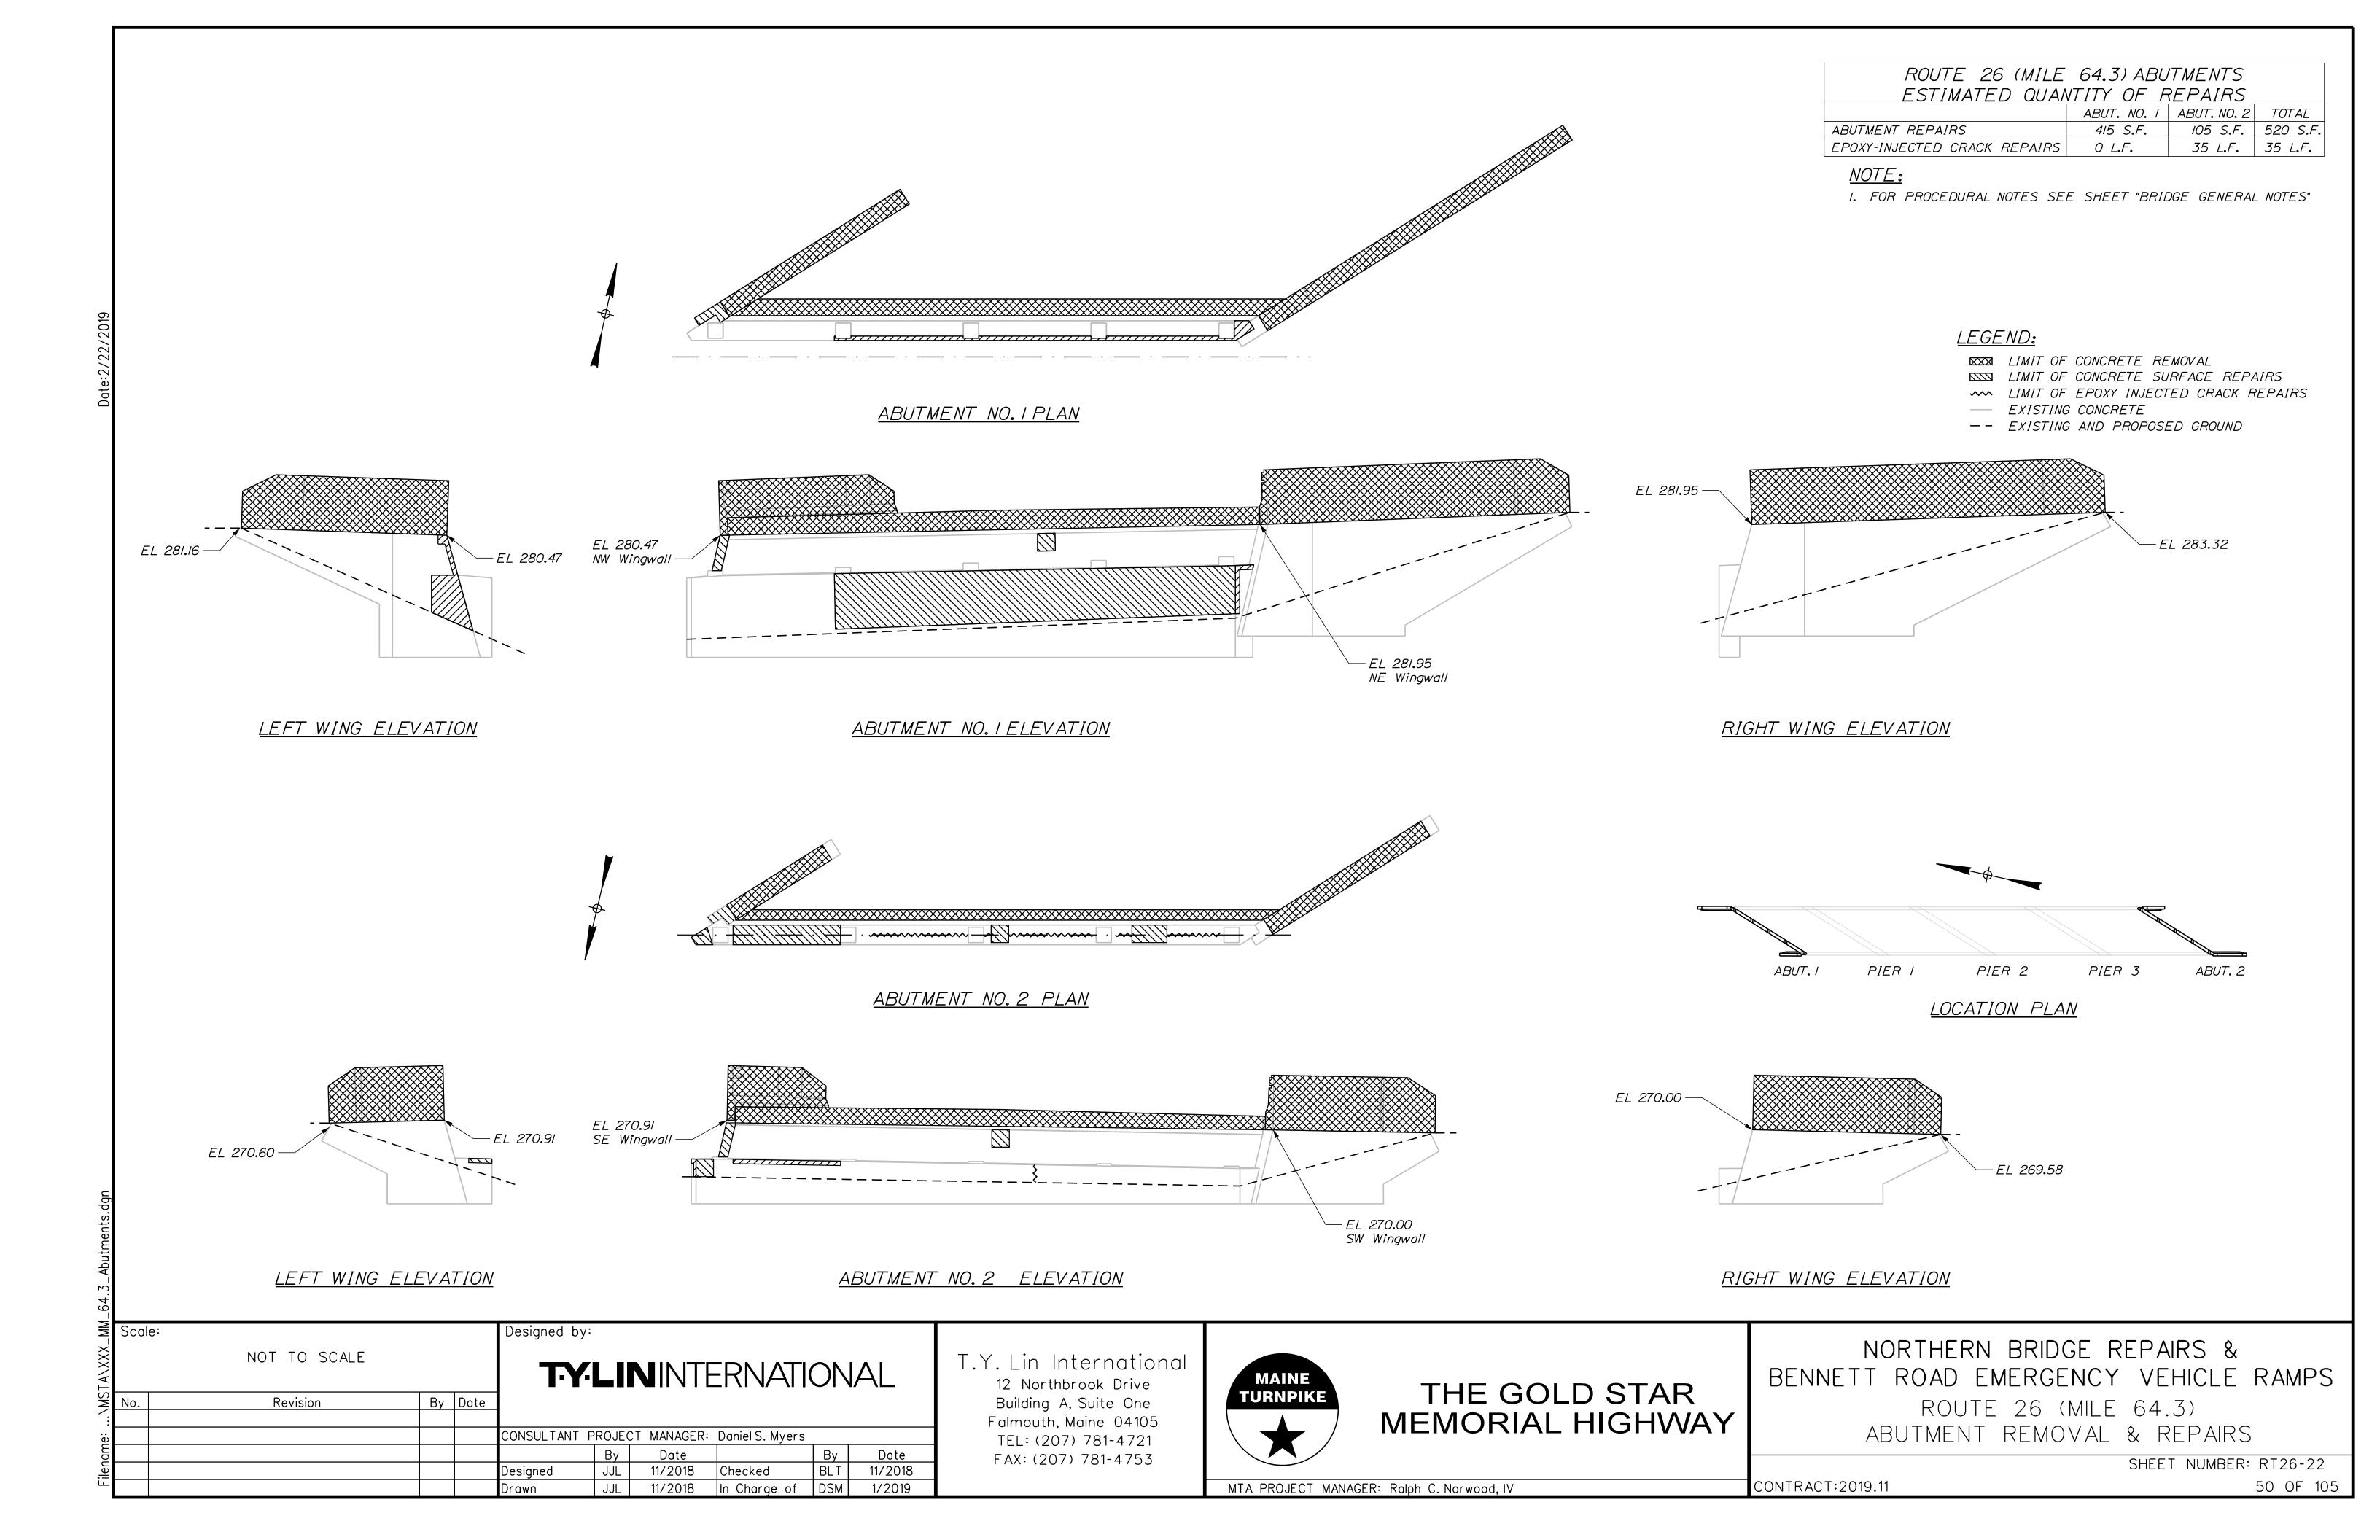
### NORTHERN BRIDGE REPAIRS & BENNETT ROAD EMERGENCY VEHICLE RAMPS


ROUTE 26 (MILE 64.3)


BRIDGE PHASING SHEET NUMBER: RT26-21

CONTRACT:2019.11 49 OF 105

MTA PROJECT MANAGER: Ralph C. Norwood, IV



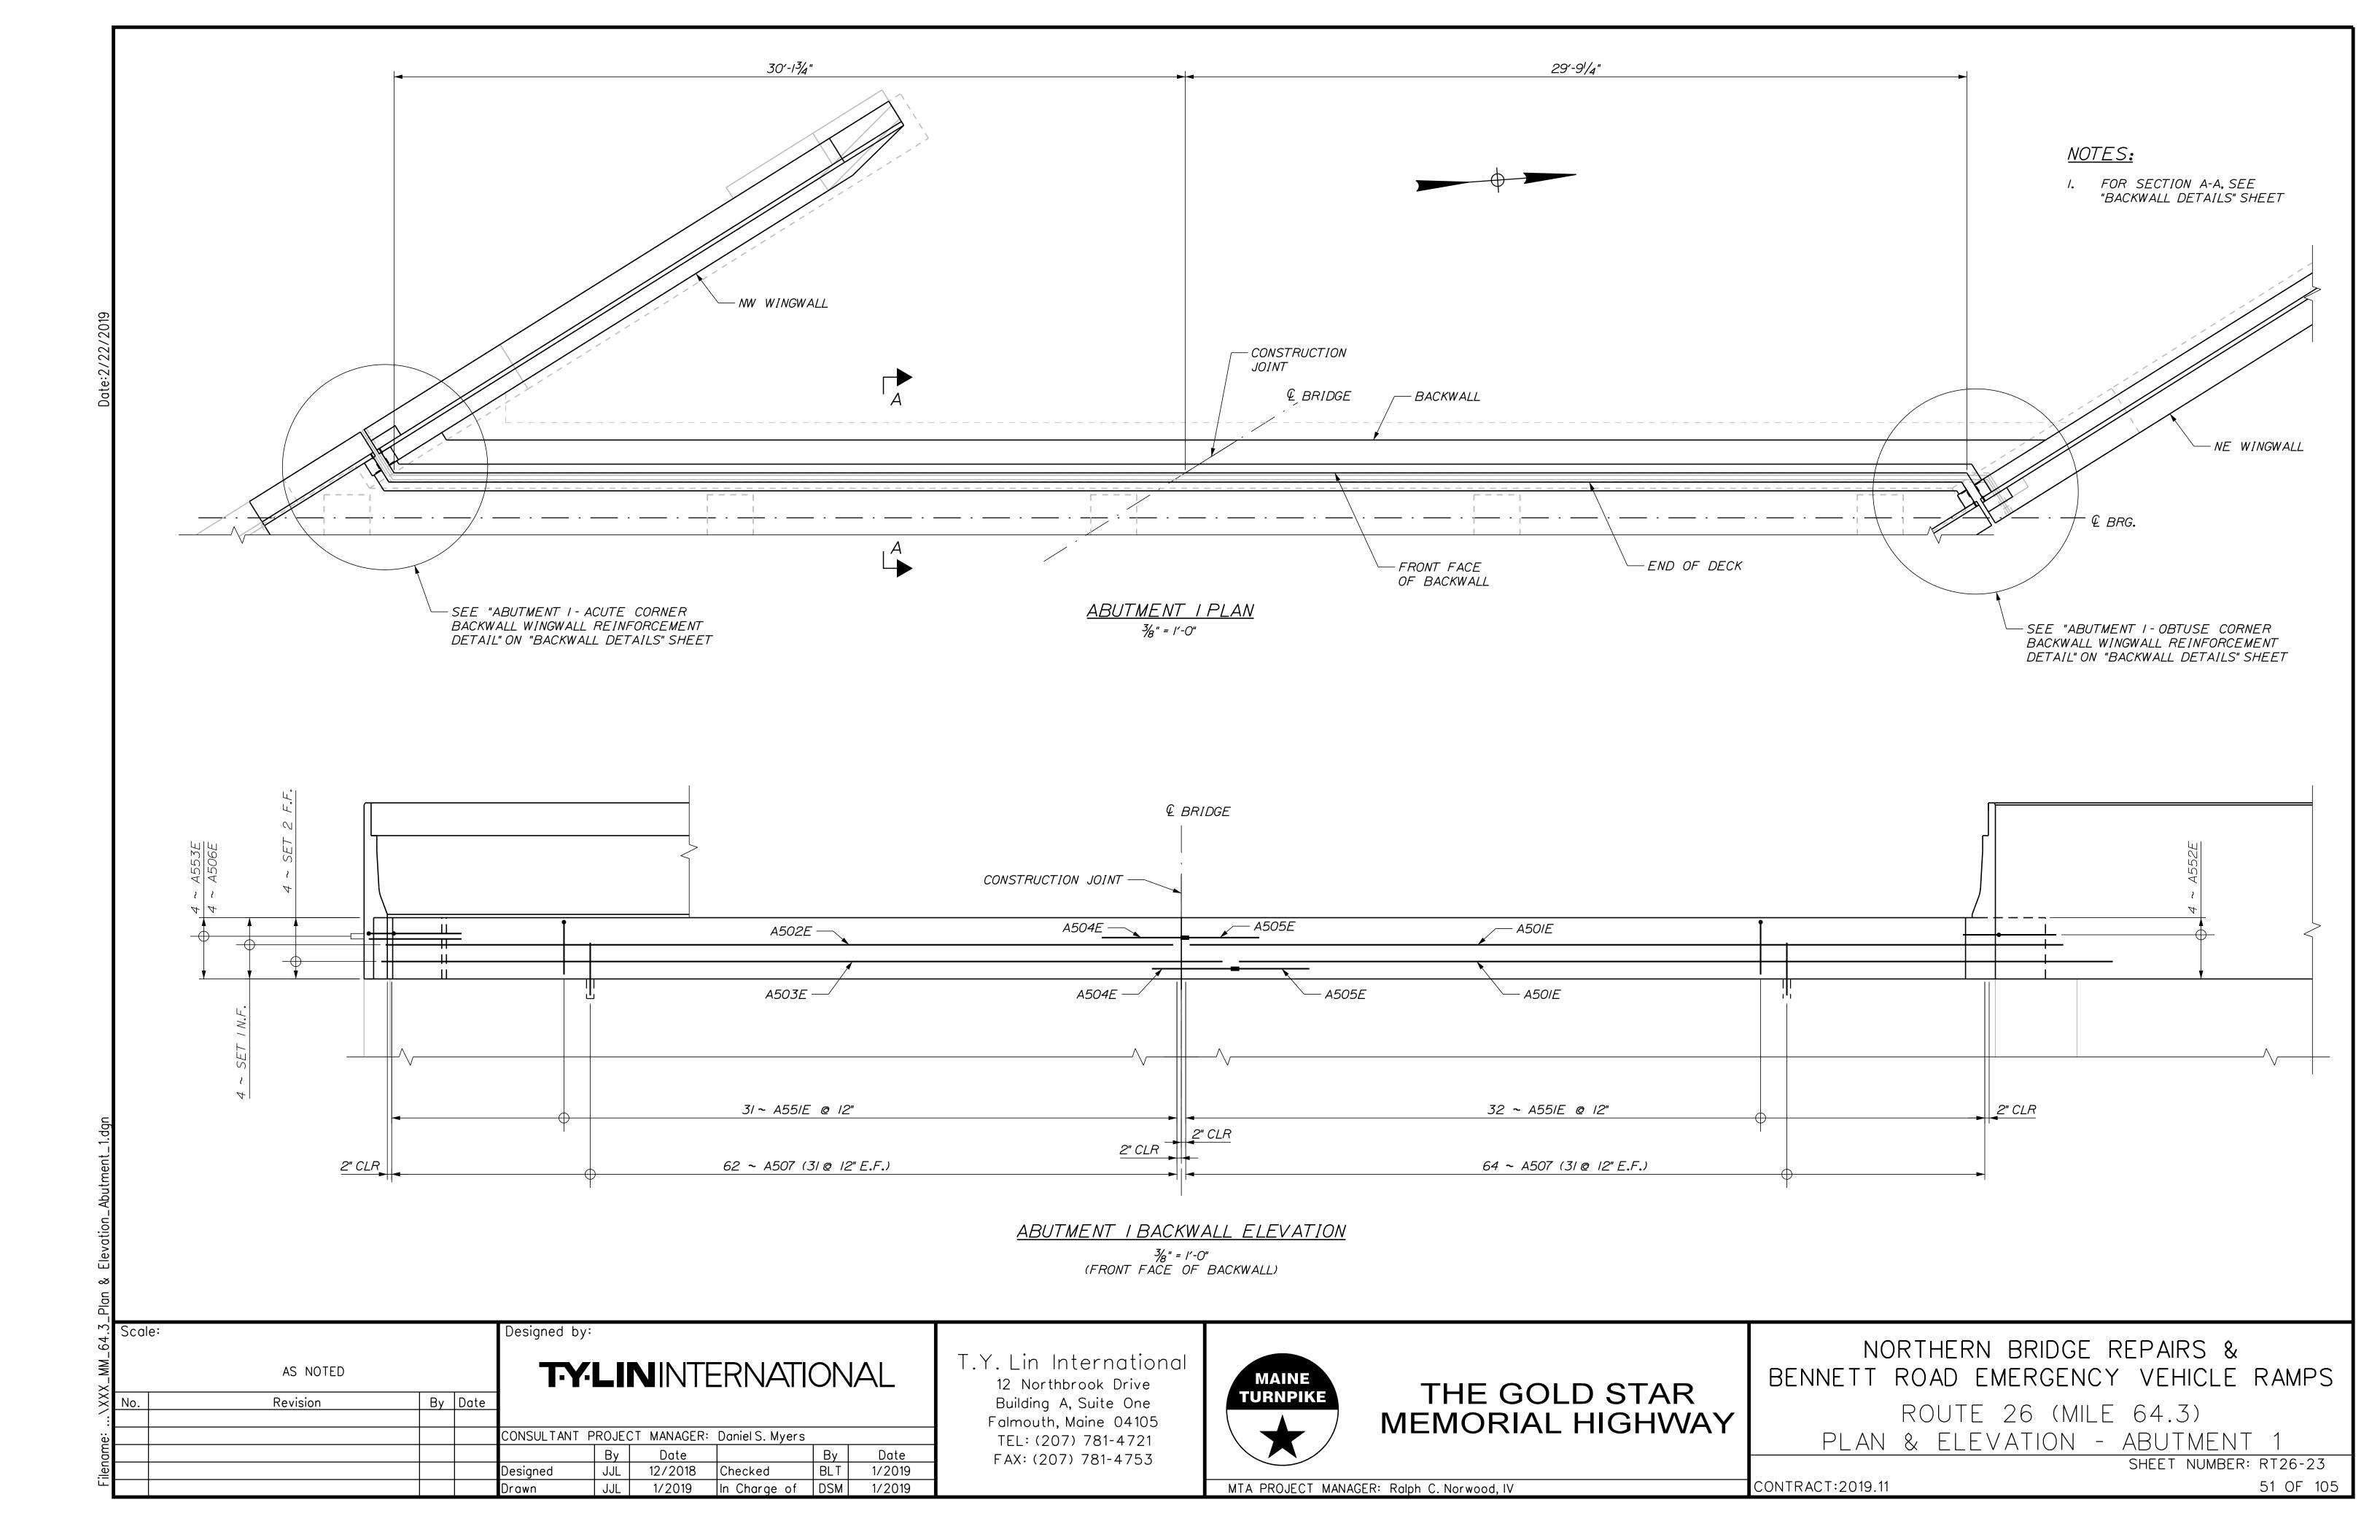

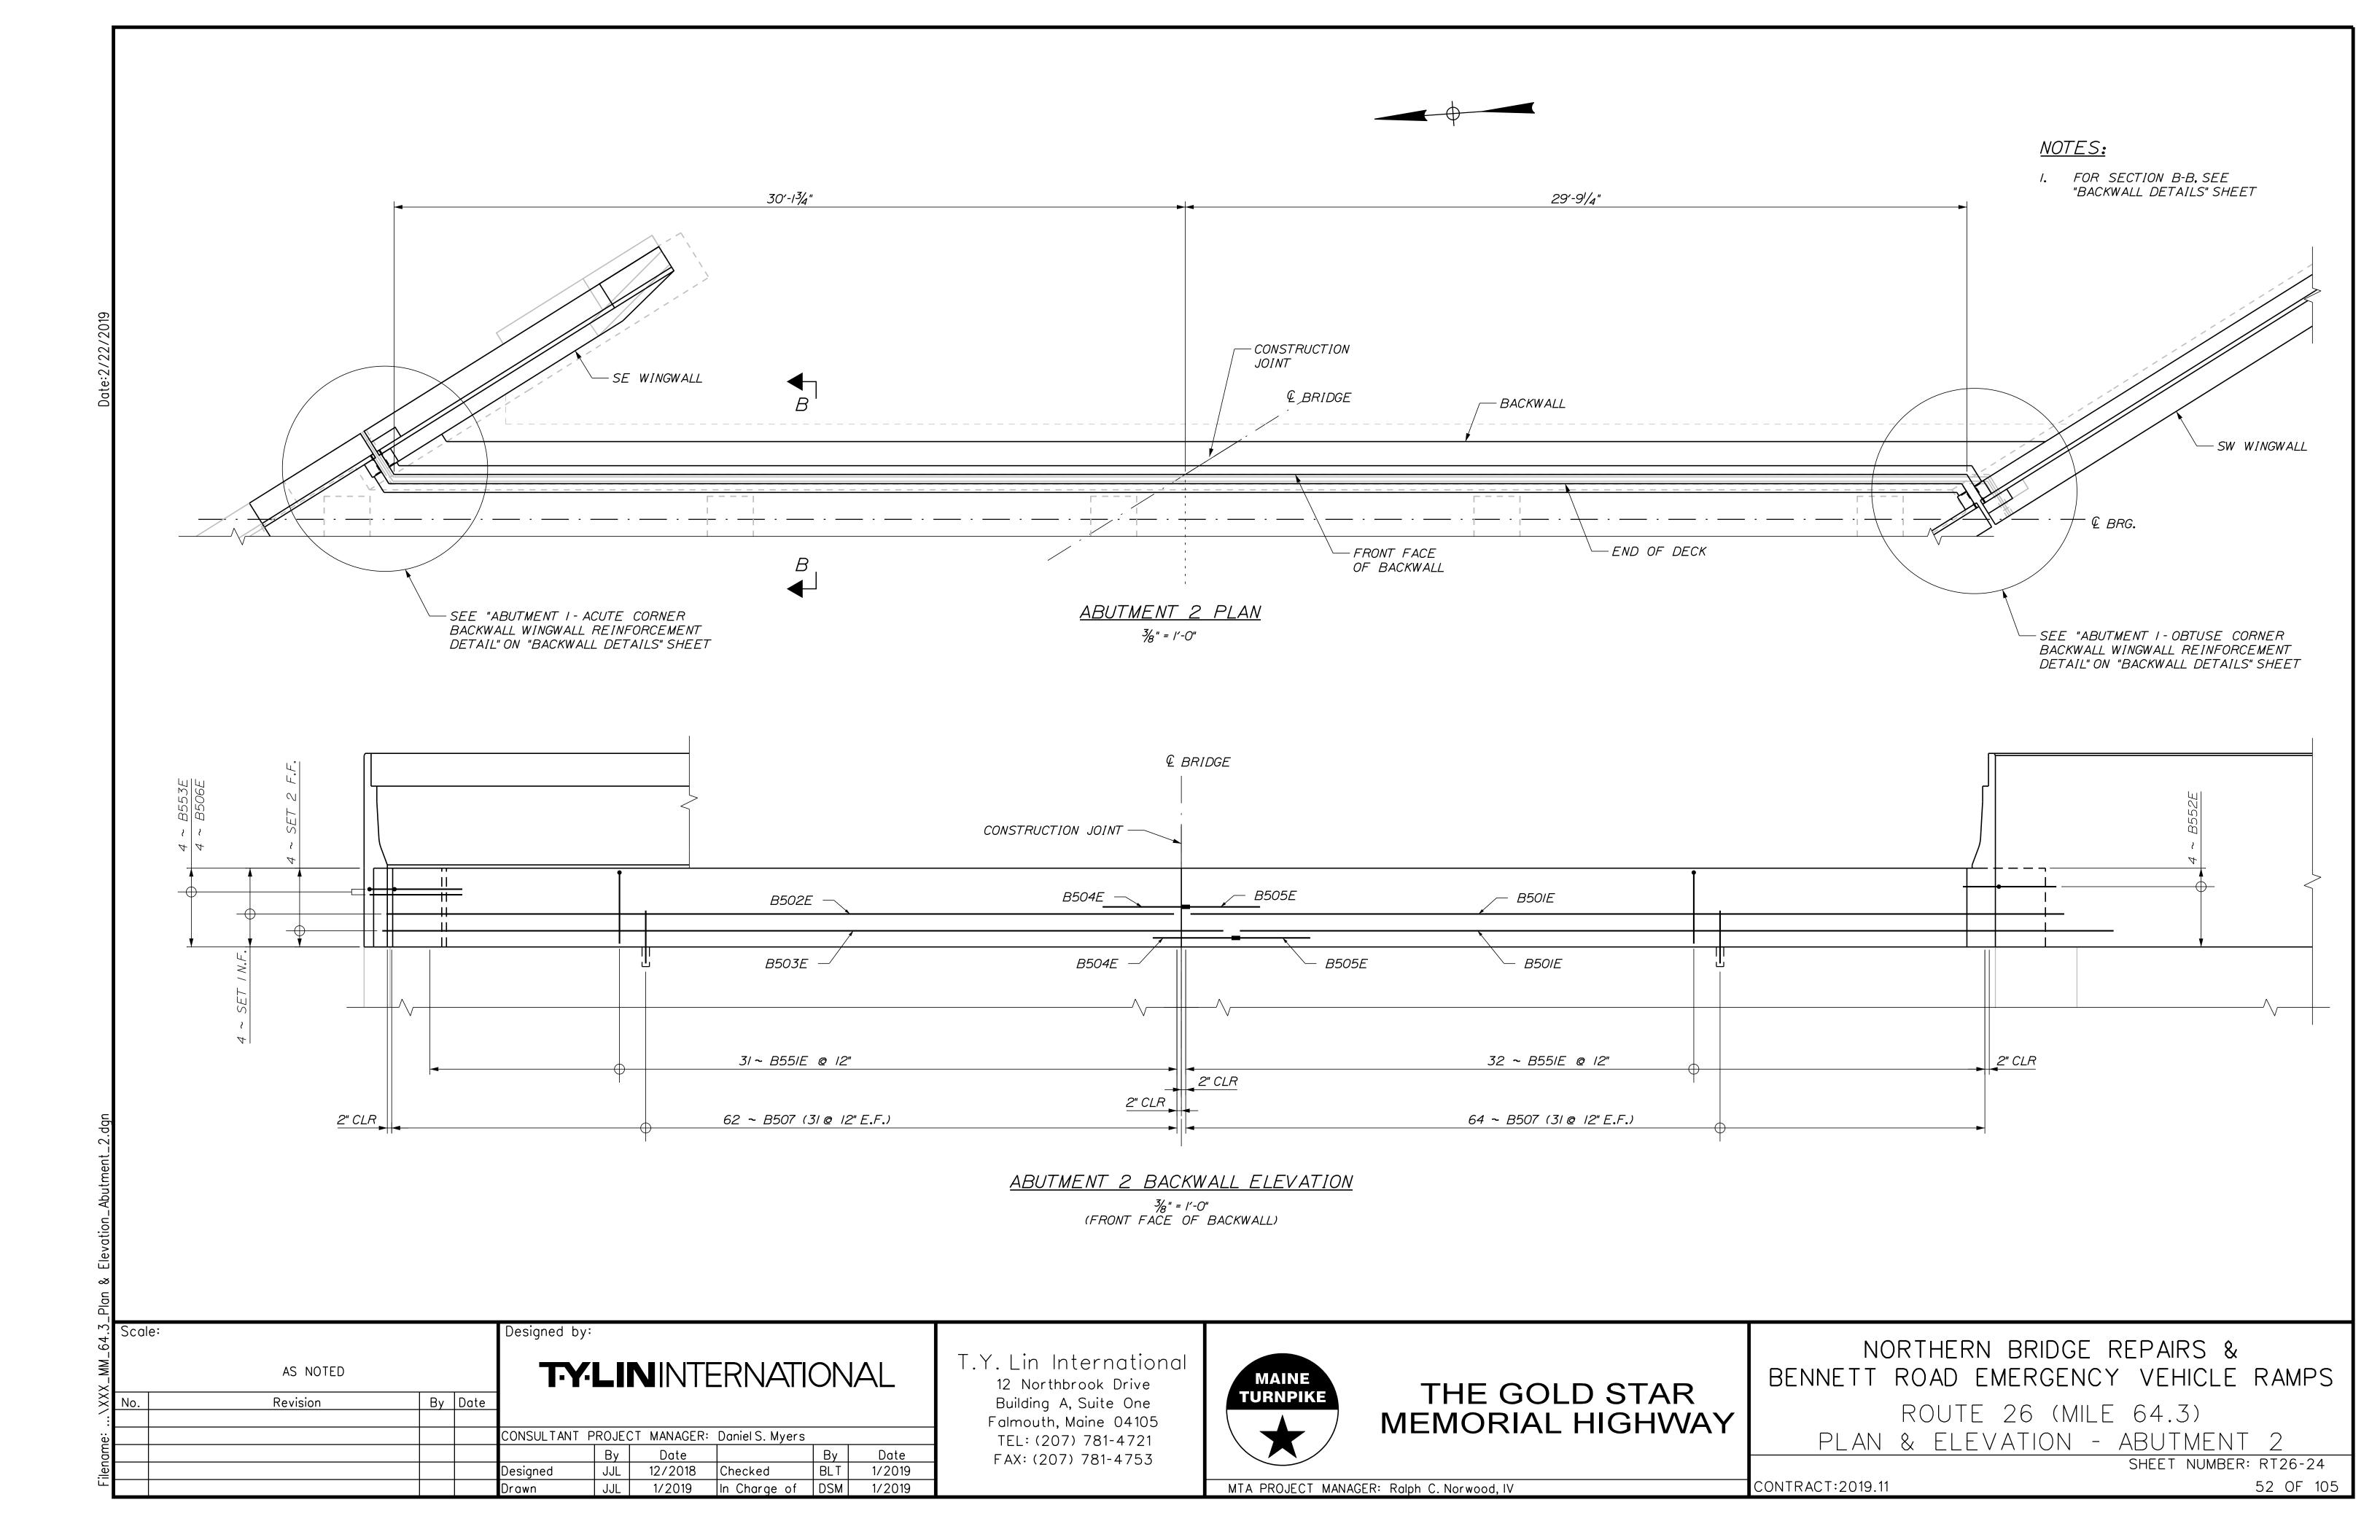

<sup>3</sup>/<sub>4</sub>" = 1'-0"

WINGWALL BARS NOT SHOWN FOR CLARITY

(ABUTMENT 2 SIMILAR)

SET I(TYP.) (A502E SHOWN)— ABUTMENT I - ACUTE CORNER BACKWALL

A507 (TYP.)

A55IE (TYP.)


- *A553E* 

\_\_\_ A506E

3/4" = 1'-0" WINGWALL BARS NOT SHOWN FOR CLARITY (ABUTMENT 2 SIMILAR)

WINGWALL REINFORCEMENT DETAIL

- SET 2 (TYP.) (A503E SHOWN)

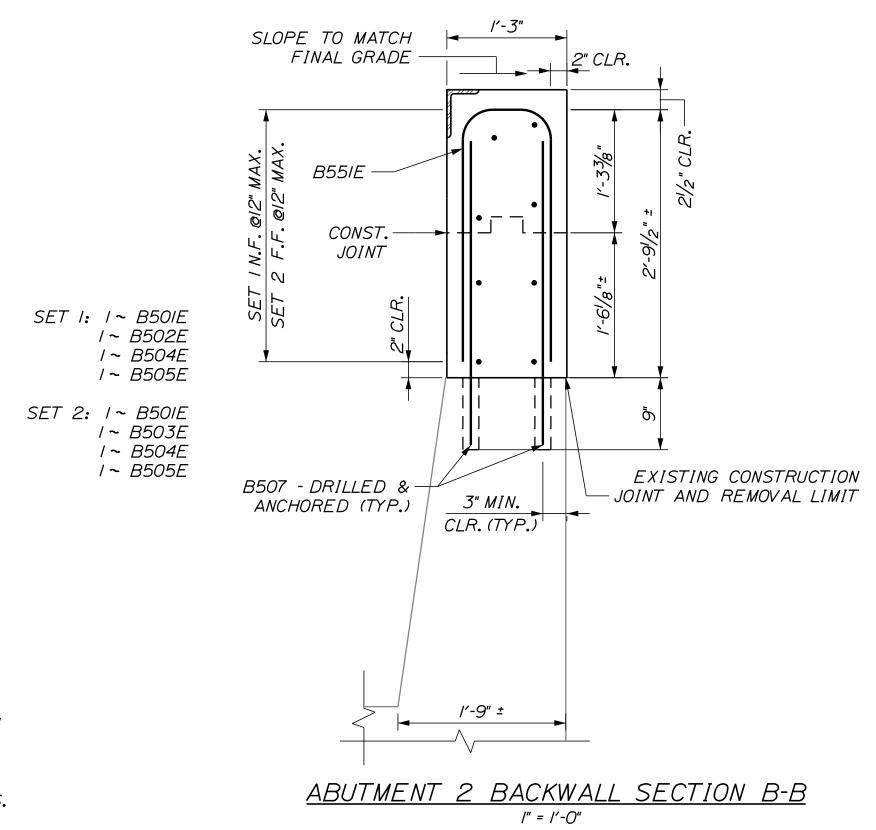

2" CLR. SLOPE TO MATCH FINAL GRADE - CONST. JOINT SET I: I ~ A50IE I ~ A502E 1~ A504E /~ A505E 3" MIN.  $\int CLR. (TYP.)$ SET 2: 1 ~ A501E /~ A503E /~ A504E EXISTING CONSTRUCTION /~ A505E JOINT AND REMOVAL LIMIT ---A507 - DRILLED & ANCHORED (TYP.)

> ABUTMENT I BACKWALL SECTION A-A /" = /'-O"

### NOTES:

FOR SECTION LOCATION A-A, SEE "PLAN & ELEVATION - ABUTMENT I" SHEET

₽ BRG.

- 2. FOR SECTION LOCATION B-B, SEE "PLAN & ELEVATION - ABUTMENT 2" SHEET
- 3. FOR JOINT SUPPORT HARDWARE, SEE "STRIP SEAL EXPANSION JOINT" SHEETS.

#### Scale: Designed by: **TY-LIN**INTERNATIONAL AS NOTED By Date Revision CONSULTANT PROJECT MANAGER: DanielS. Myers Ву Date CPT 2/2019 1/2019 JJL Checked Designed In Charge of DSM 1/2019 1/2019

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THE GOLD STAR MEMORIAL HIGHWAY


### NORTHERN BRIDGE REPAIRS & BENNETT ROAD EMERGENCY VEHICLE RAMPS


ROUTE 26 (MILE 64.3) BACKWALL DETAILS


SHEET NUMBER: RT26-25


MTA PROJECT MANAGER: Ralph C. Norwood, IV

CONTRACT:2019.11 53 OF 105

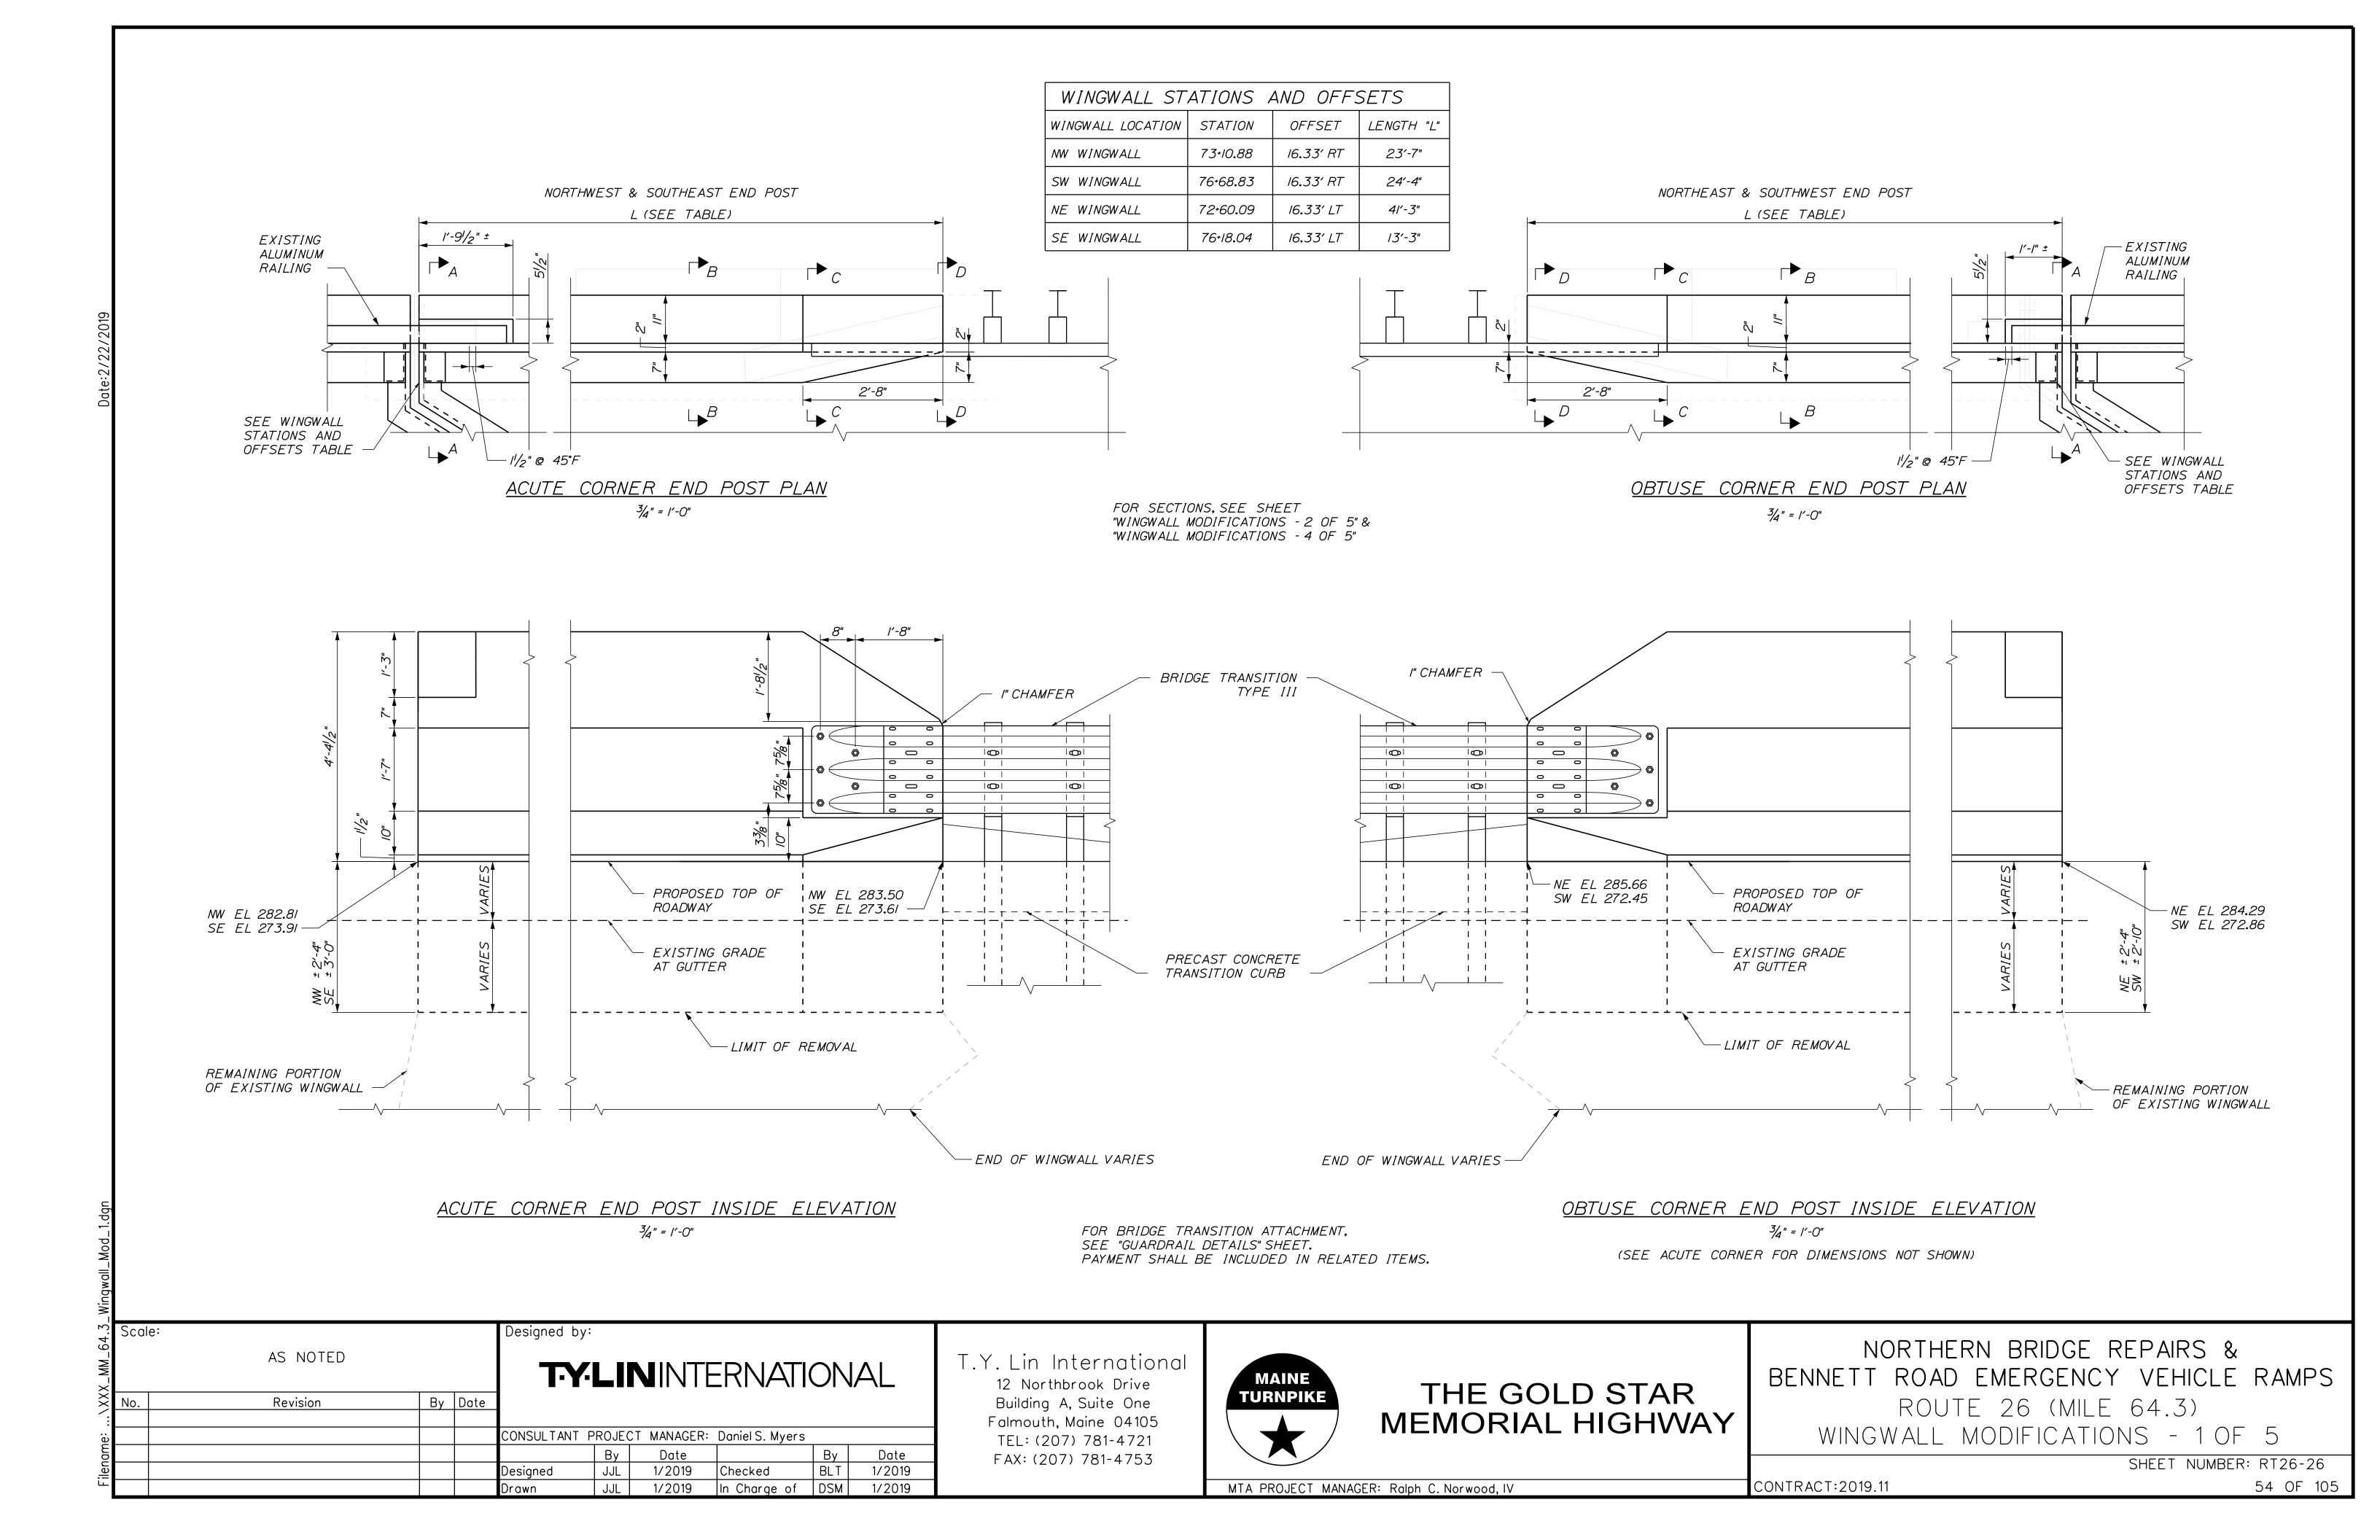

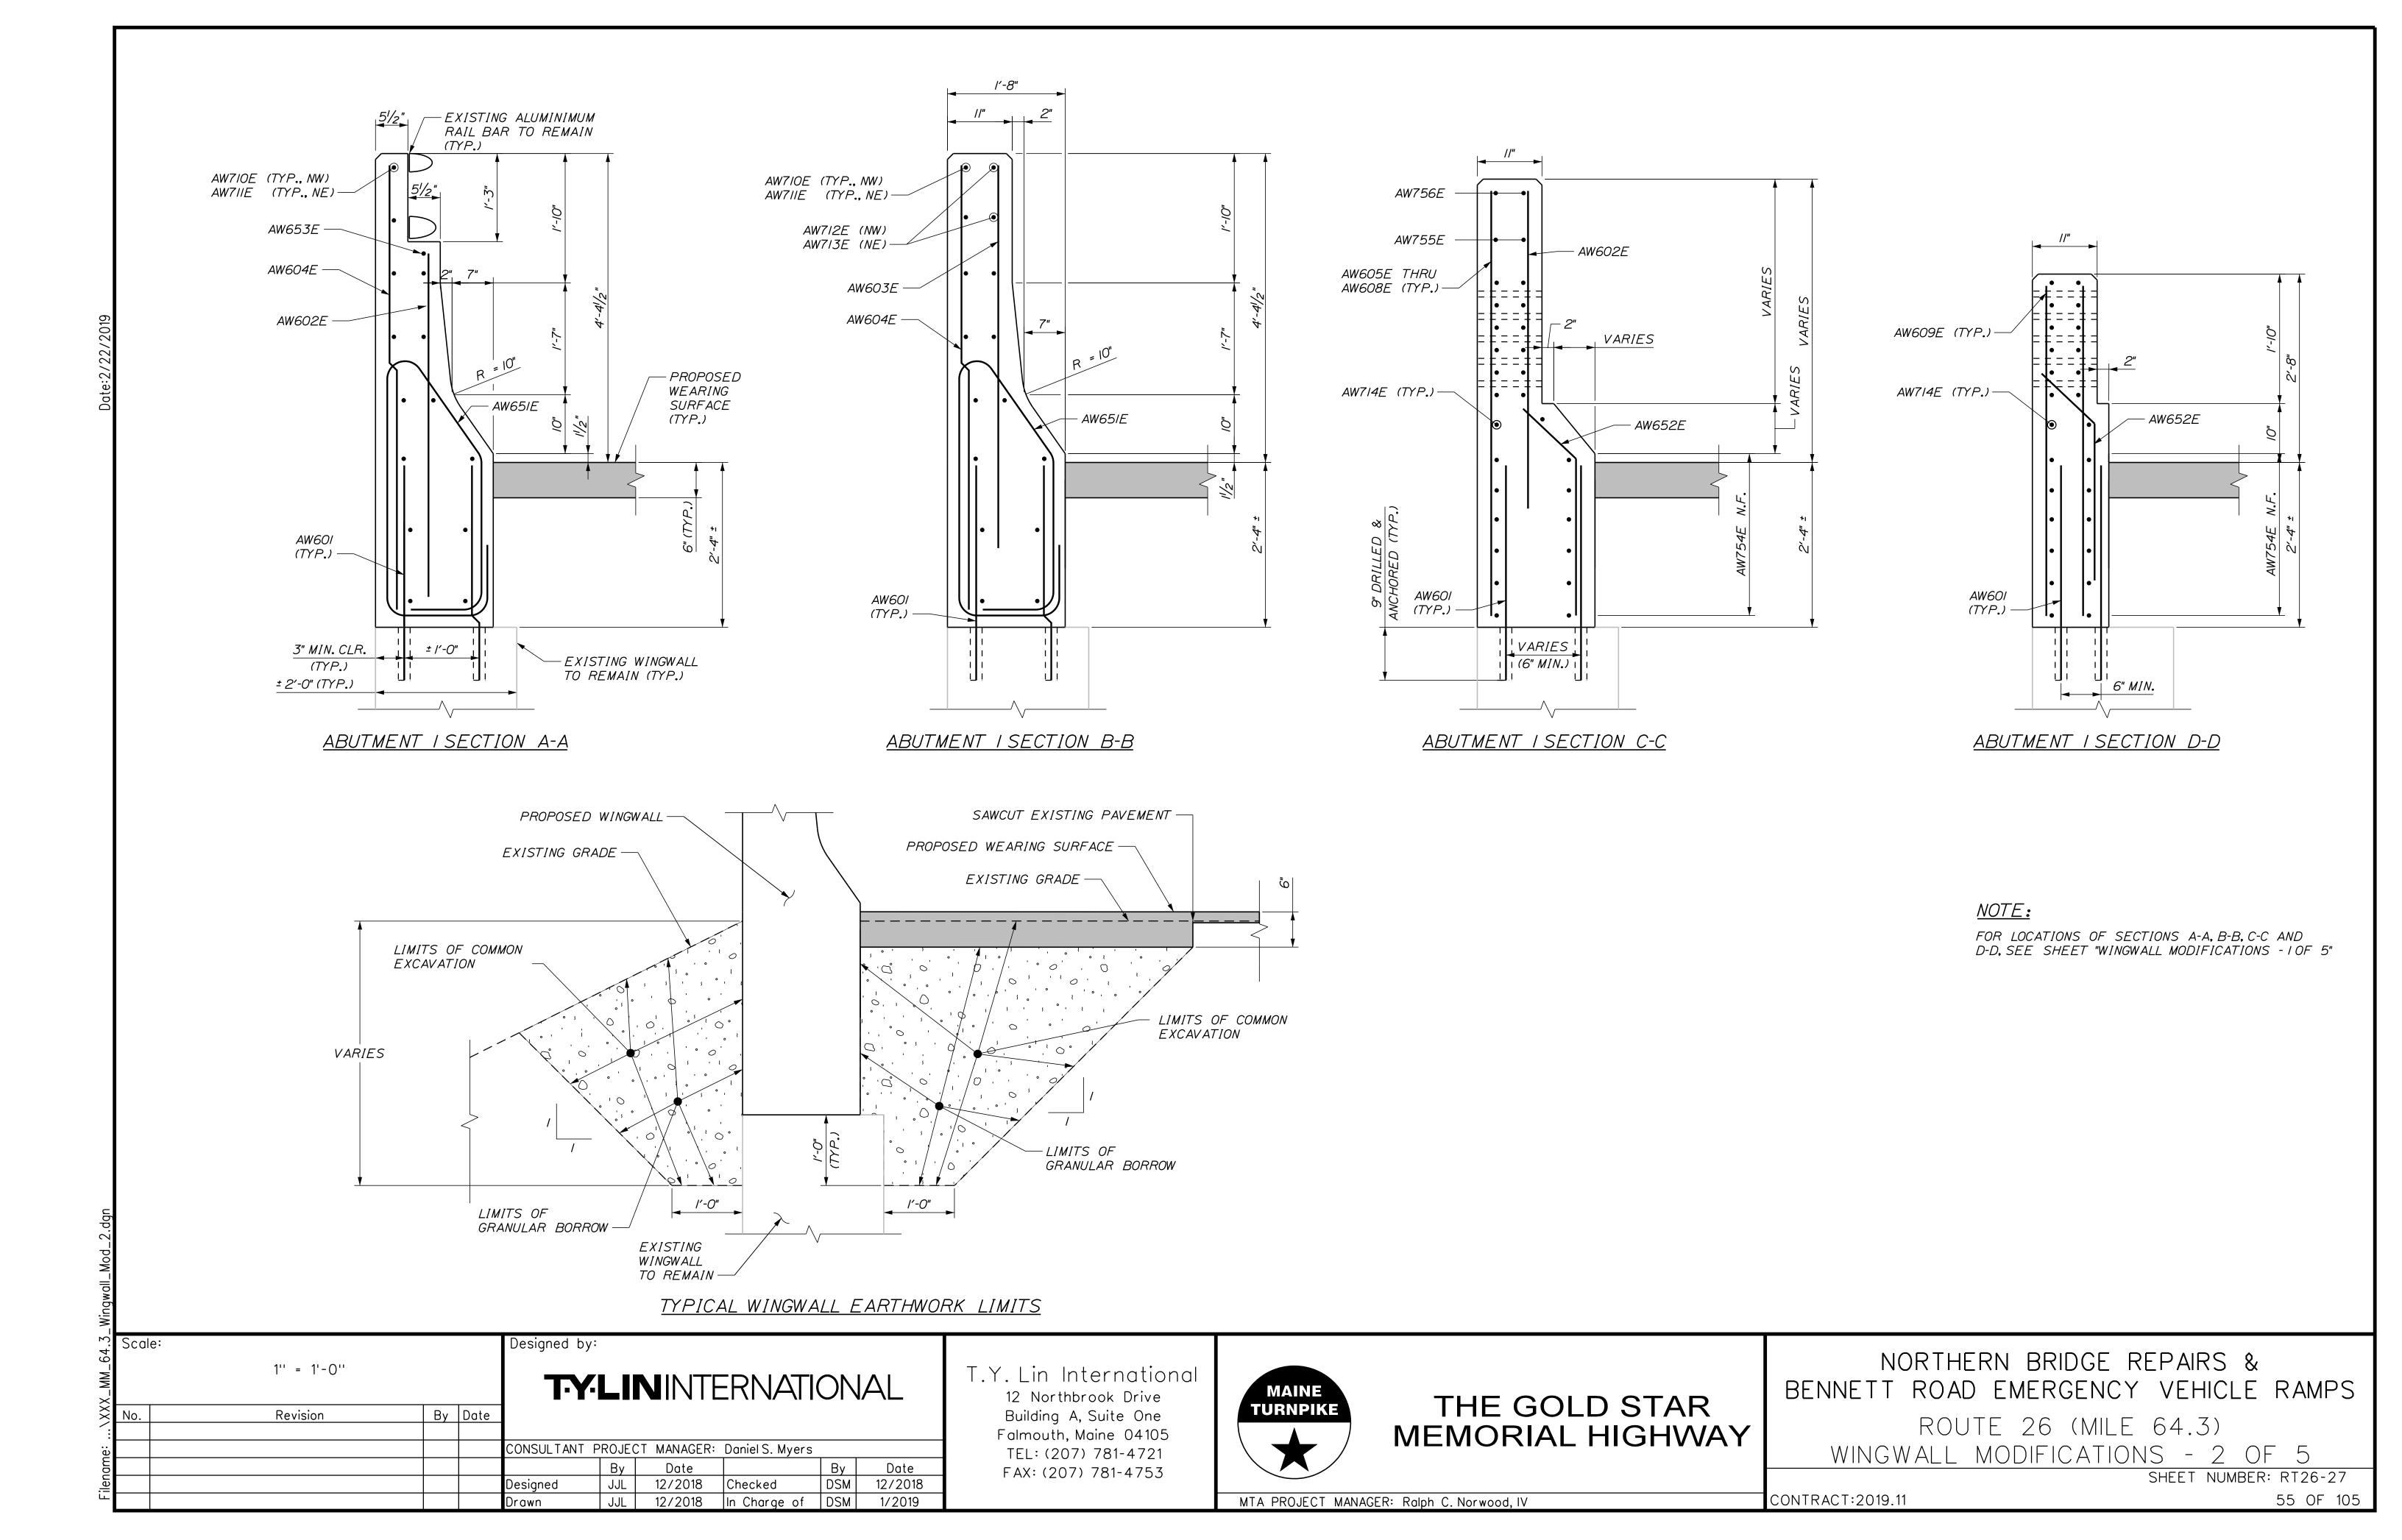

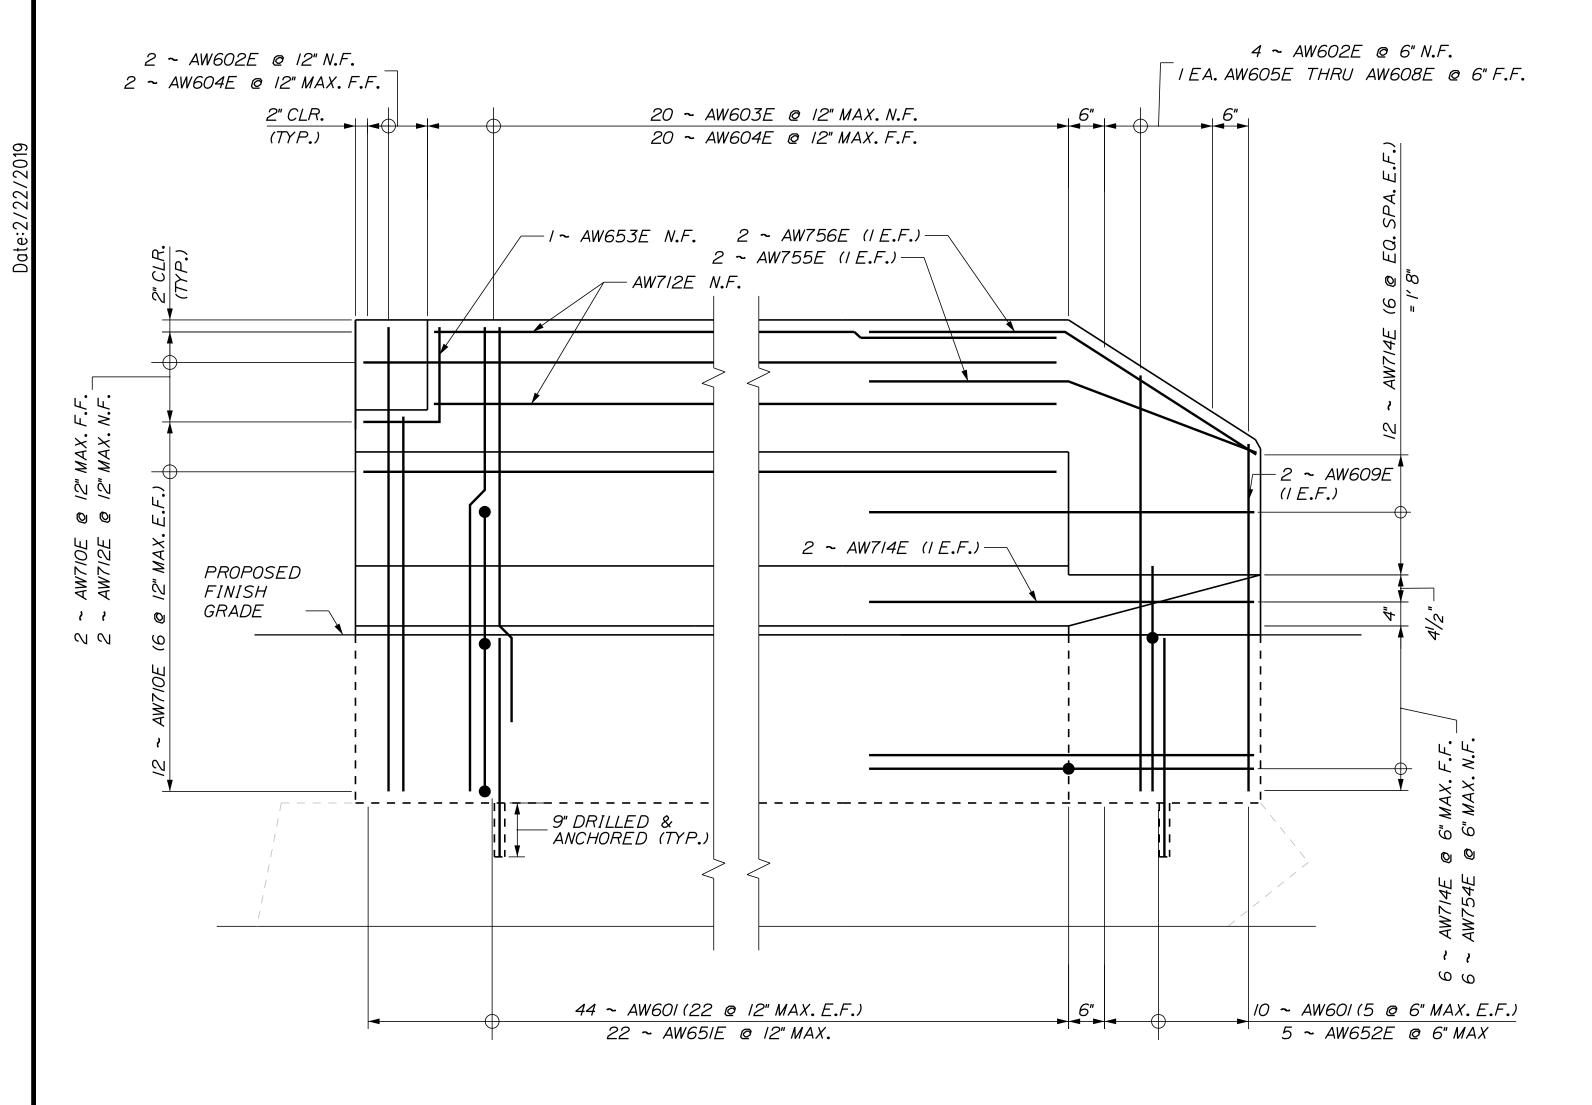

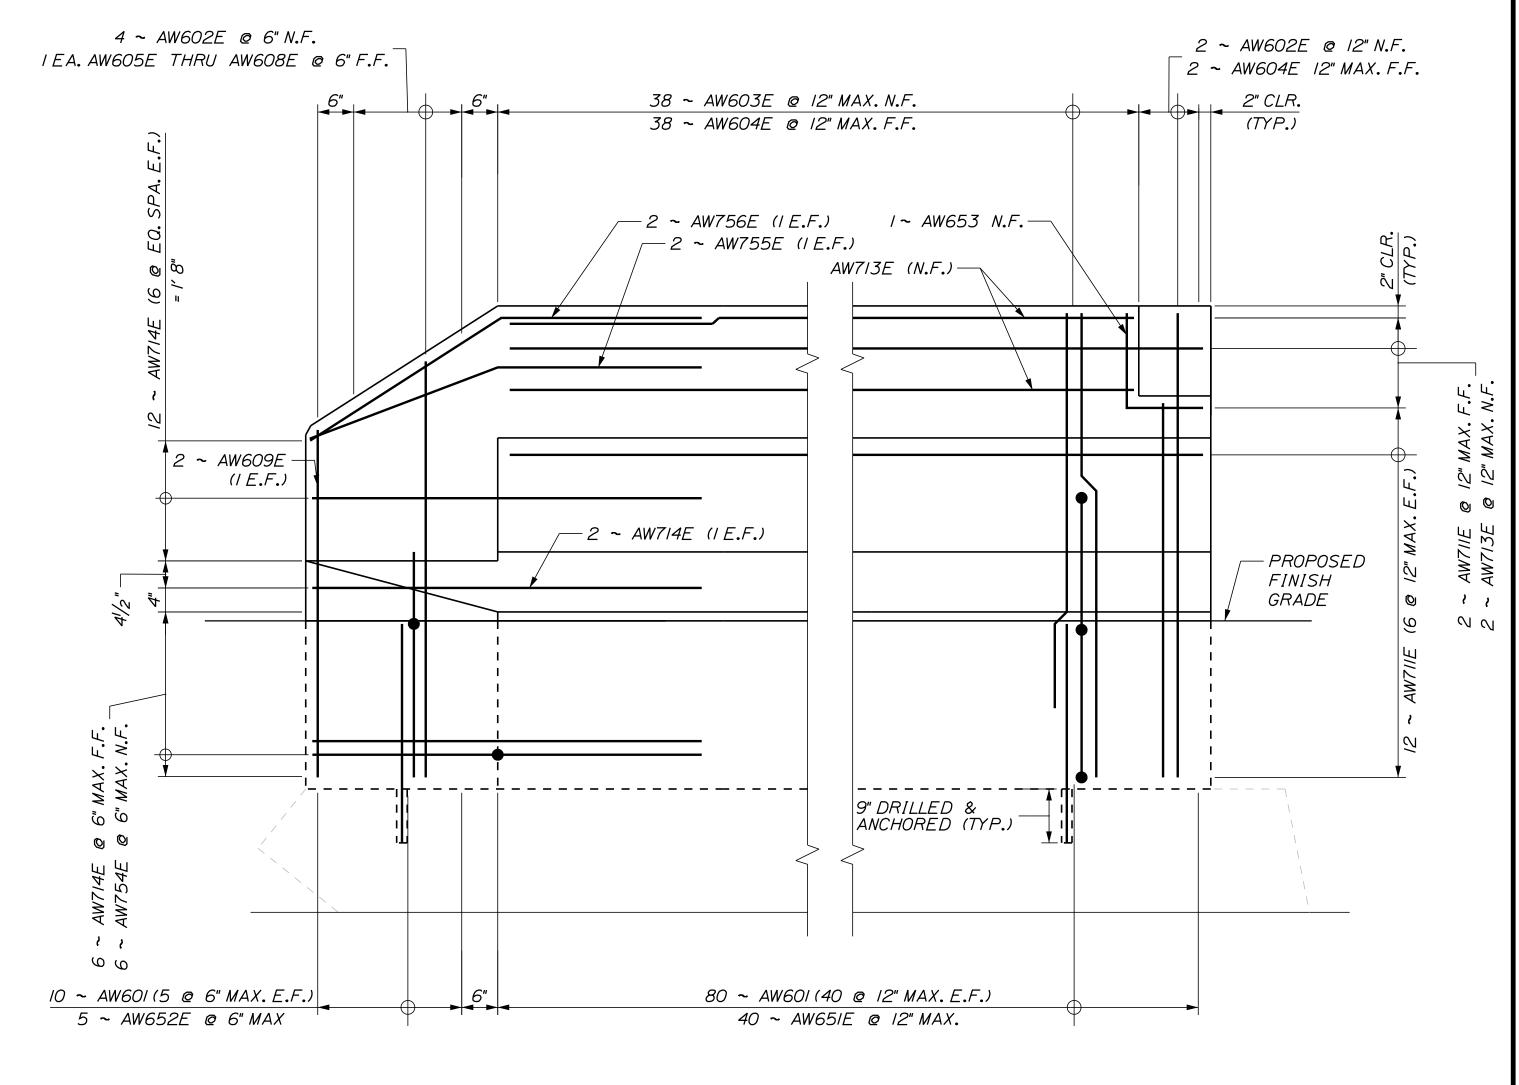

NORTHWEST WINGWALL REINFORCEMENT ELEVATION

NORTHEAST WINGWALL REINFORCEMENT ELEVATION

#### <u>LEGEND:</u>

N.F. = NEAR FACE F.F. = FAR FACE E.F. = EACH FACE

MIN. LAPS

#7 *= 2'-*7"

Scale:				T-Y-LININTERNATIONAL							
No.	3/ <sub>4</sub> '' = 1'-0''										
No.	Revision	Ву	Date	1							
				CONSUL TANT	PROJEC	T MANAGER	: Daniel S. Myers				
					Ву	Date		Ву	Date		
				Designed	JJL	1/2019	Checked	BLT	1/2019		
				Drawn	JJL	1/2019	In Charge of	DSM	1/2019		

T.Y. Lin International
12 Northbrook Drive
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THE GOLD STAR
MEMORIAL HIGHWAY

## NORTHERN BRIDGE REPAIRS & BENNETT ROAD EMERGENCY VEHICLE RAMPS


ROUTE 26 (MILE 64.3)


WINGWALL MODIFICATIONS - 3 OF 5


SHEET NUMBER: RT26-28

MTA PROJECT MANAGER: Ralph C. Norwood, IV

CONTRACT: 2019.11 56 OF 105

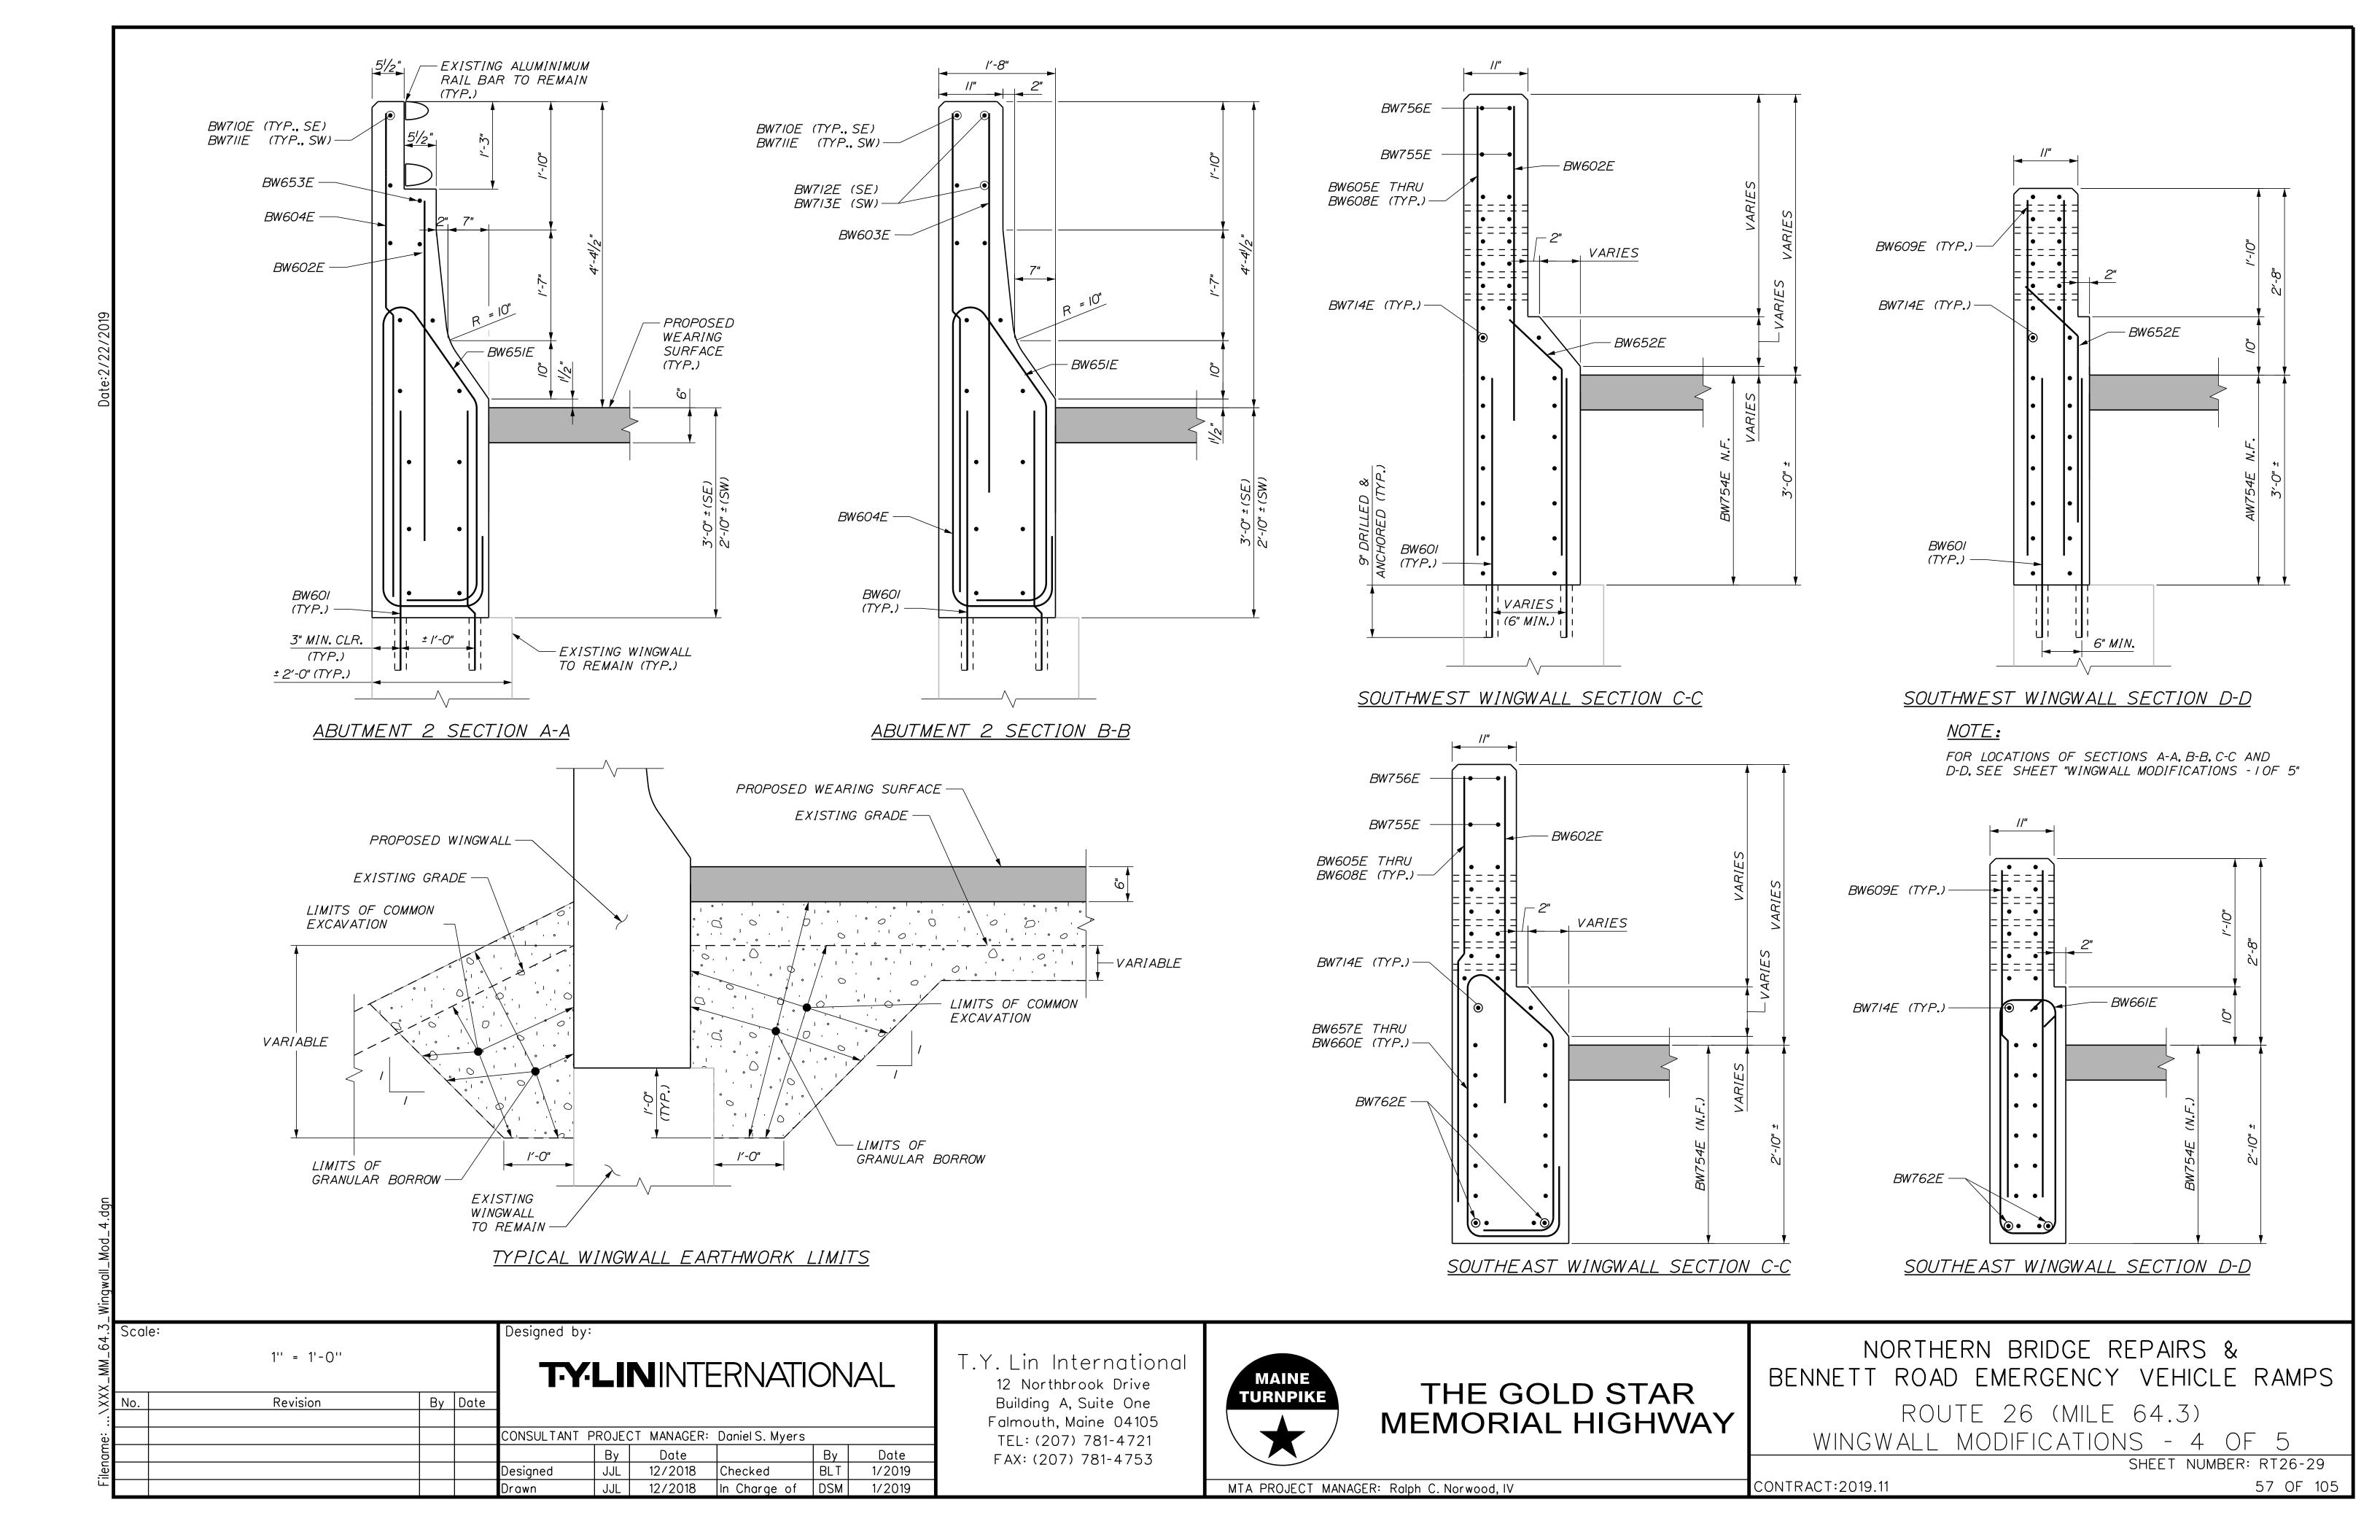

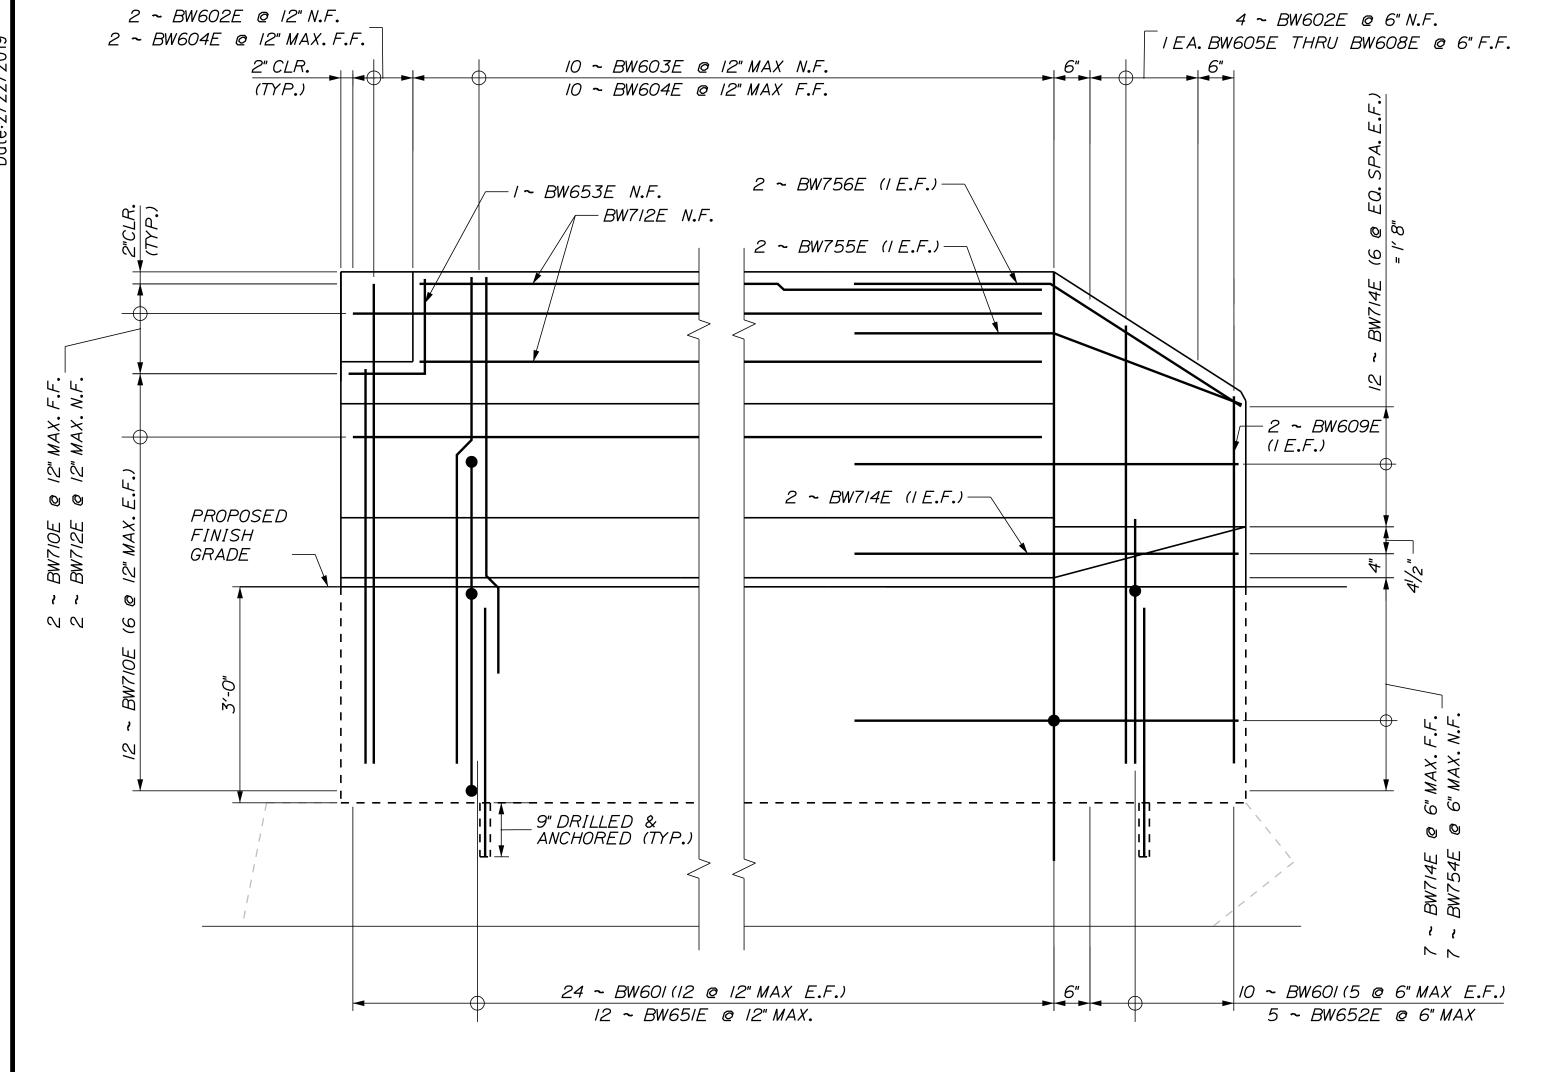

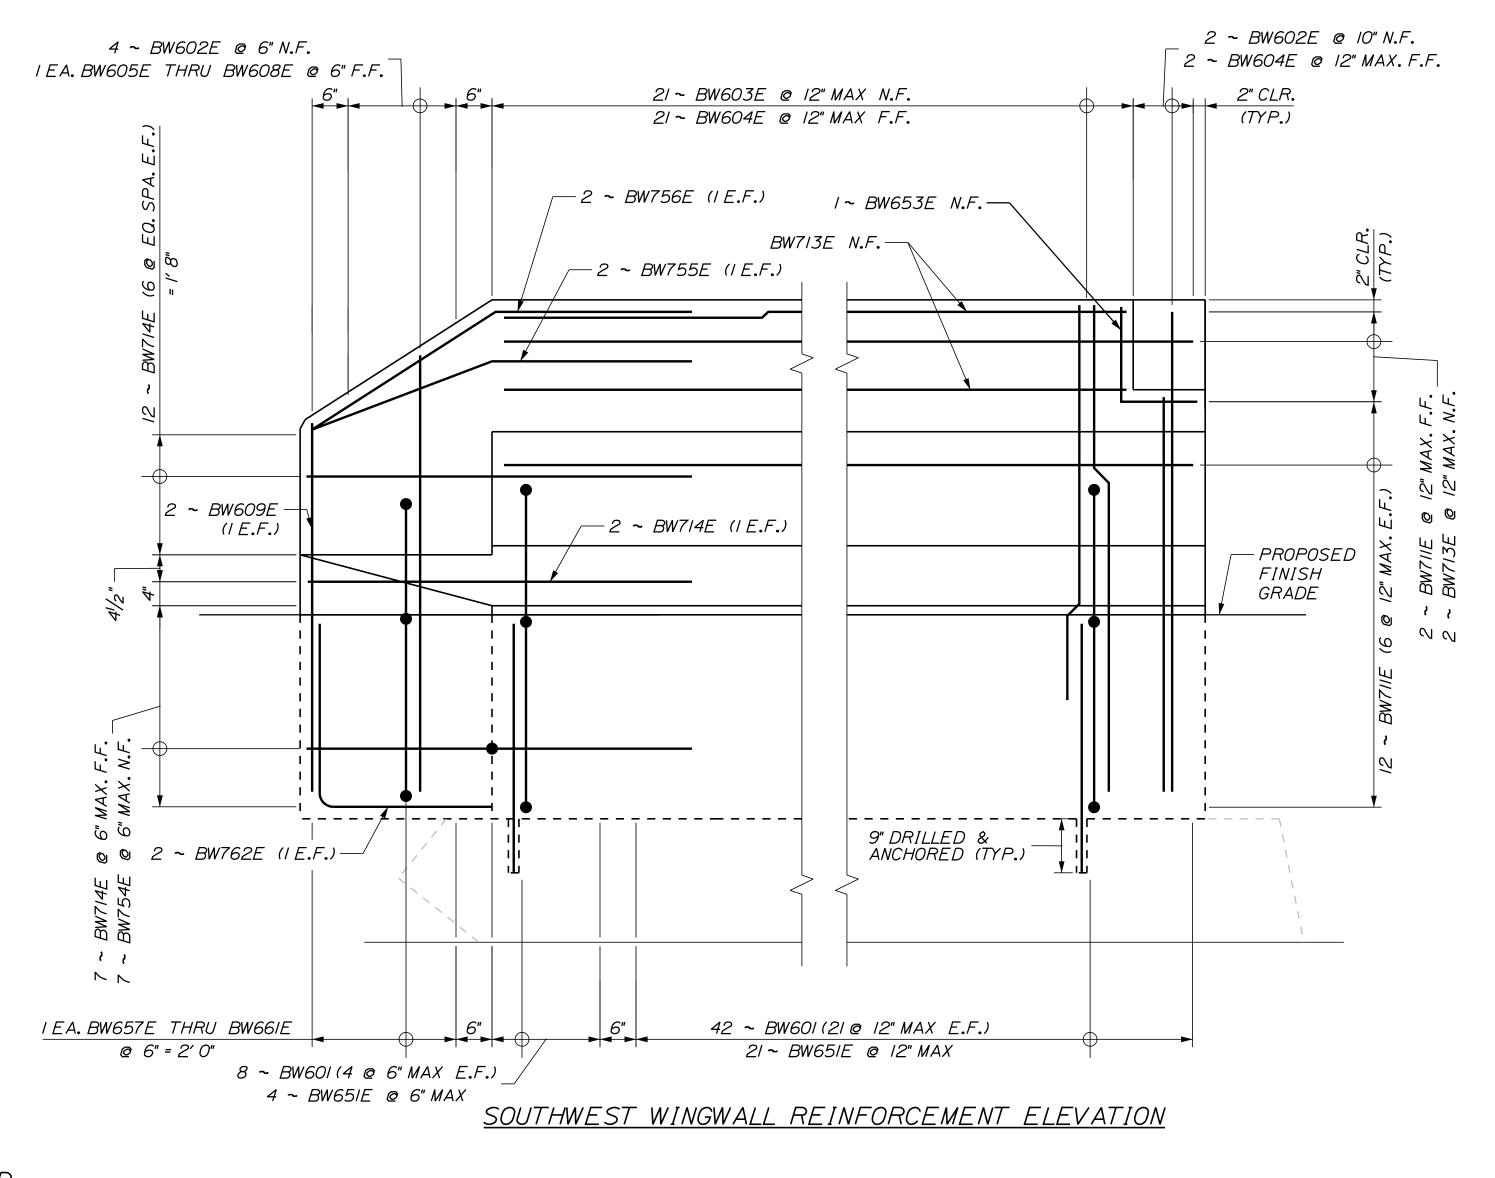

SOUTHEAST WINGWALL REINFORCEMENT ELEVATION

#### <u>LEGEND:</u>

N.F. = NEAR FACE F.F. = FAR FACE E.F. = EACH FACE

MIN. LAPS

#7 *= 2'-*7"

Scale:				Designed b	y:				
No.	3/4'' = 1'-0''		T-Y-LININTERNATIONAL						
No.	Revision	Ву	Date						
				CONSULTANT	PROJEC	T MANAGER:	Daniel S. Myers		
					Ву	Date		Ву	Date
				Designed	JJL	1/2019	Checked	BLT	1/2019
				Drawn	JJL	1/2019	In Charge of	DSM	1/2019

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12 Northbrook Drive
Building A, Suite One
Falmouth, Maine 04105
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FAX: (207) 781-4753



## THE GOLD STAR MEMORIAL HIGHWAY


## NORTHERN BRIDGE REPAIRS & BENNETT ROAD EMERGENCY VEHICLE RAMPS

ROUTE 26 (MILE 64.3)

WINGWALL MODIFICATIONS - 5 OF 5

SHEET NUMBER: RT26-30 CONTRACT:2019.11 58 OF 105

MTA PROJECT MANAGER: Ralph C. Norwood, IV

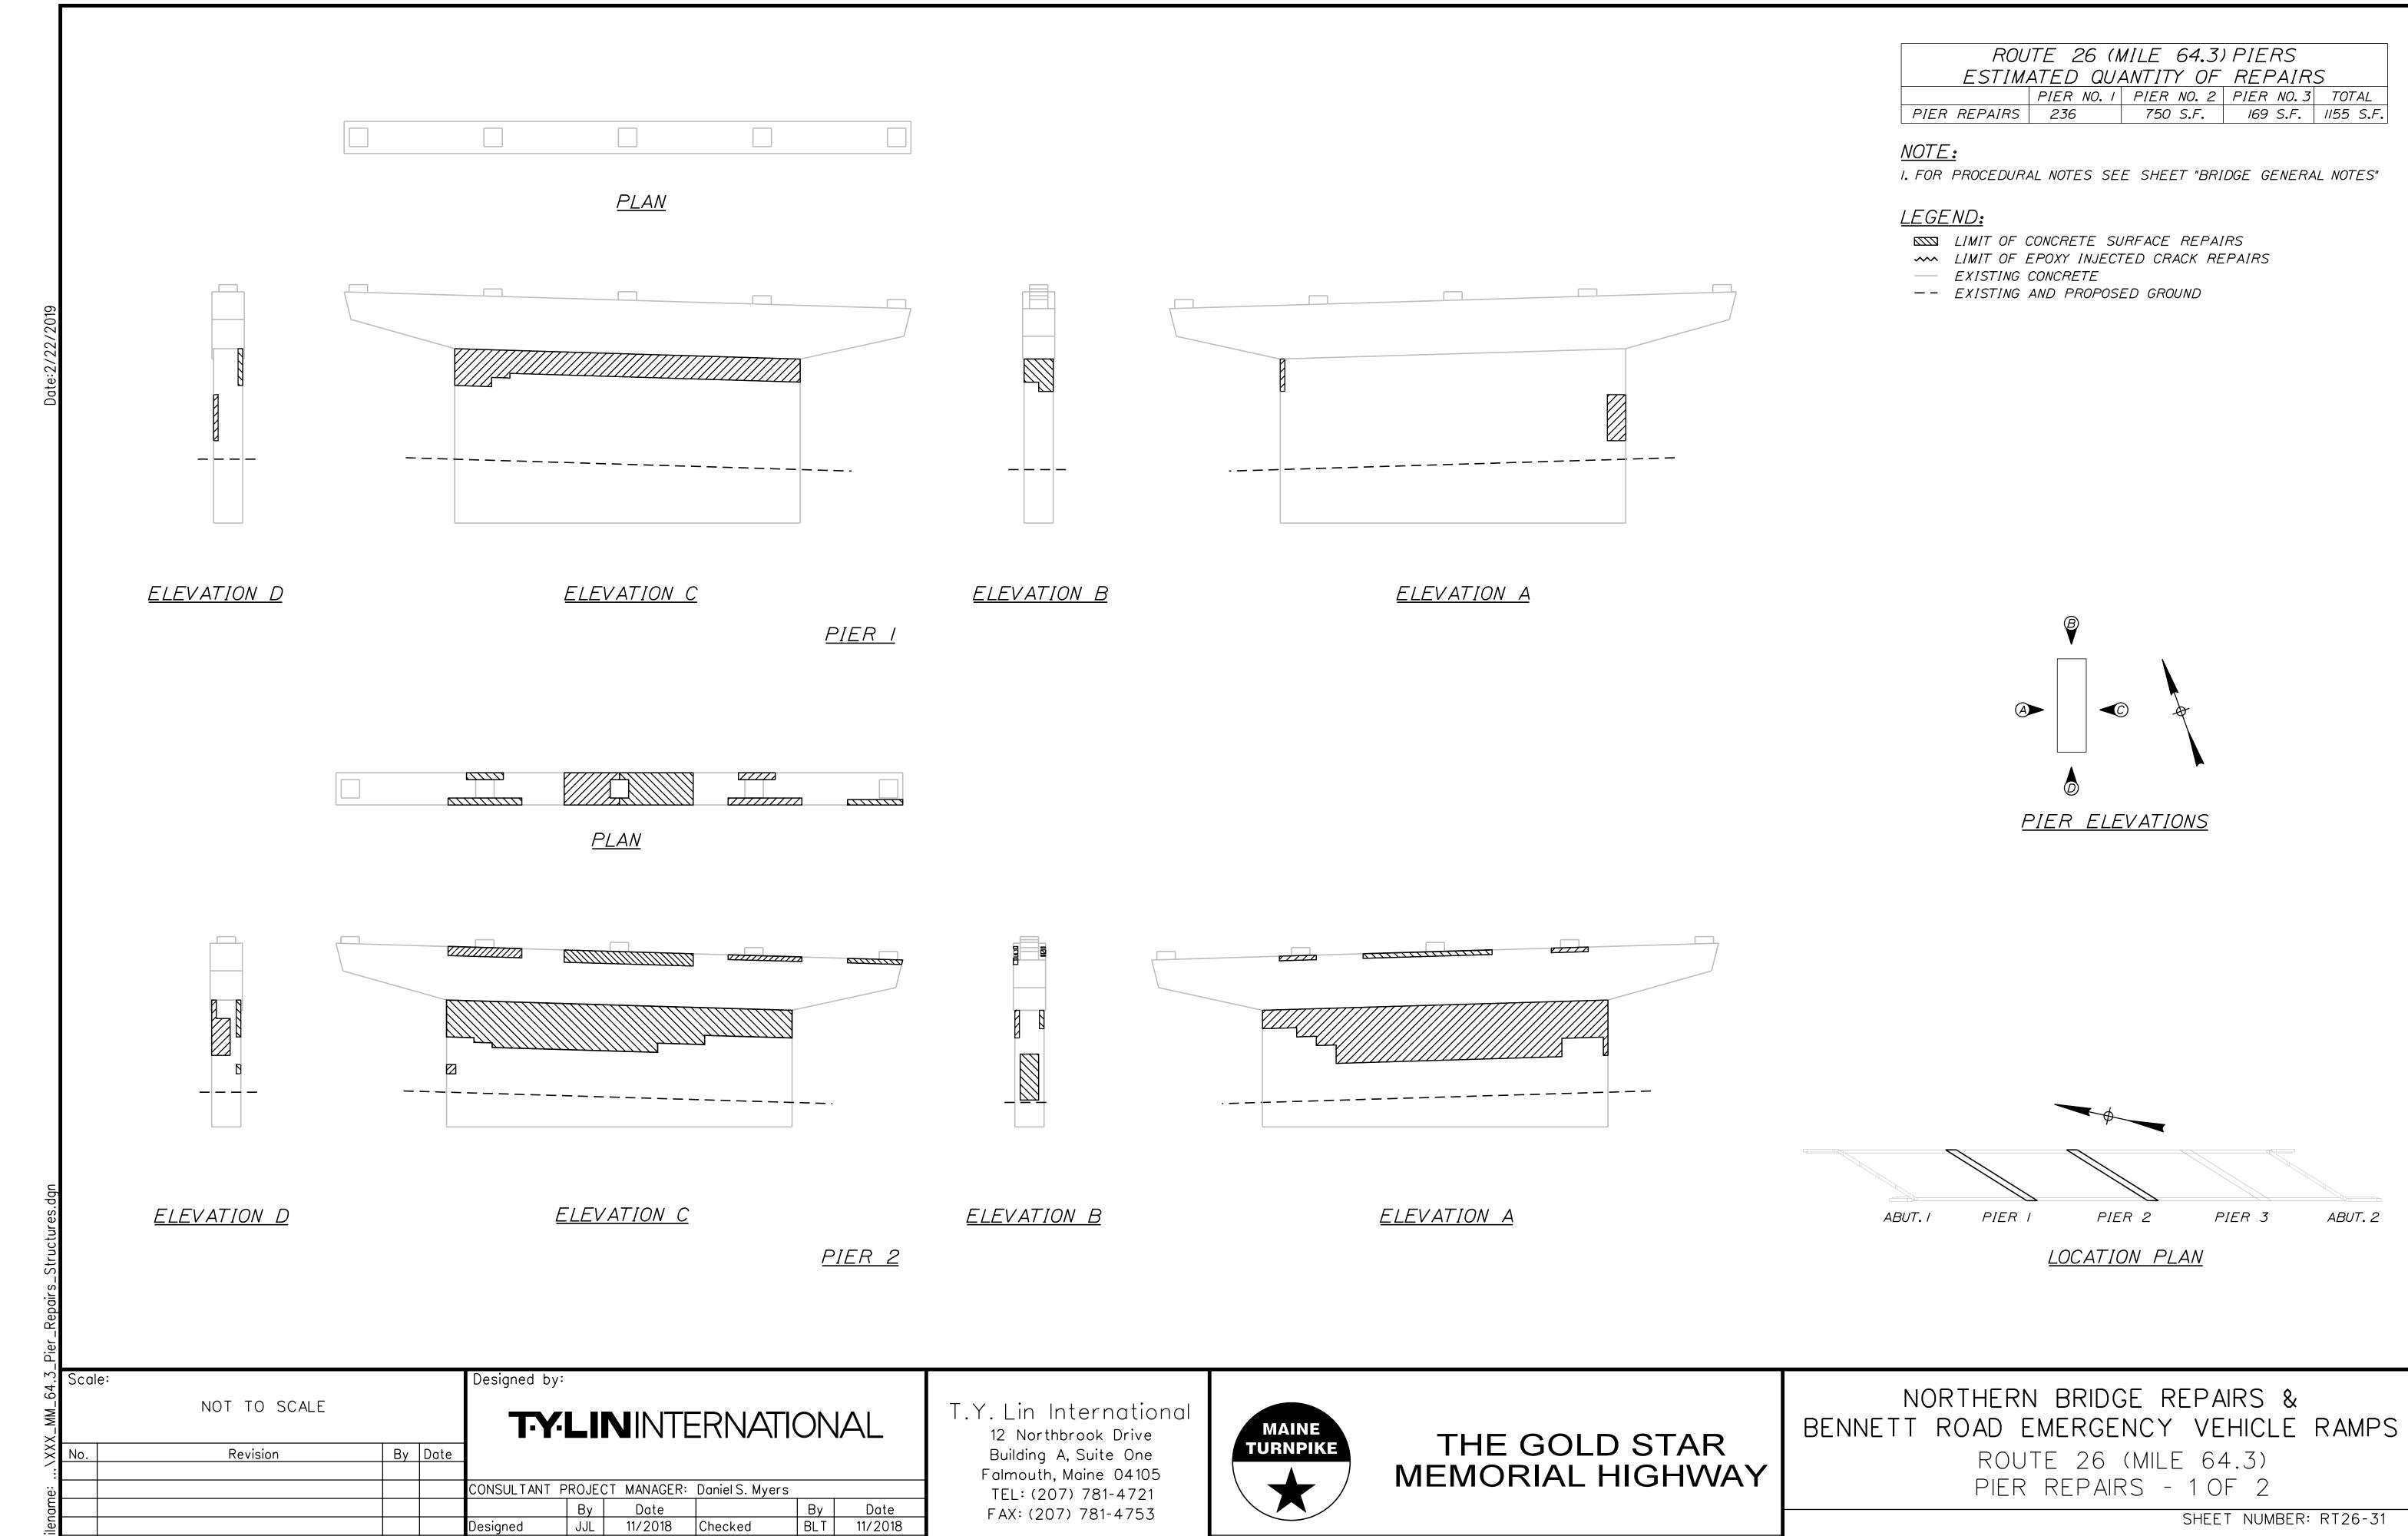

MTA PROJECT MANAGER: Ralph C. Norwood, IV

Designed

In Charge of DSM

11/2018

59 OF 105


CONTRACT:2019.11


I. FOR PROCEDURAL NOTES SEE SHEET "BRIDGE GENERAL NOTES"


2. FOR QUANTITY, SEE "ROUTE 26 (MILE 64.3) PIER REPAIRS - 10F 2"

#### <u>LEGEND:</u>

- LIMIT OF CONCRETE SURFACE REPAIRS
- ~~ LIMIT OF EPOXY INJECTED CRACK REPAIRS
- --- EXISTING CONCRETE
- -- EXISTING AND PROPOSED GROUND

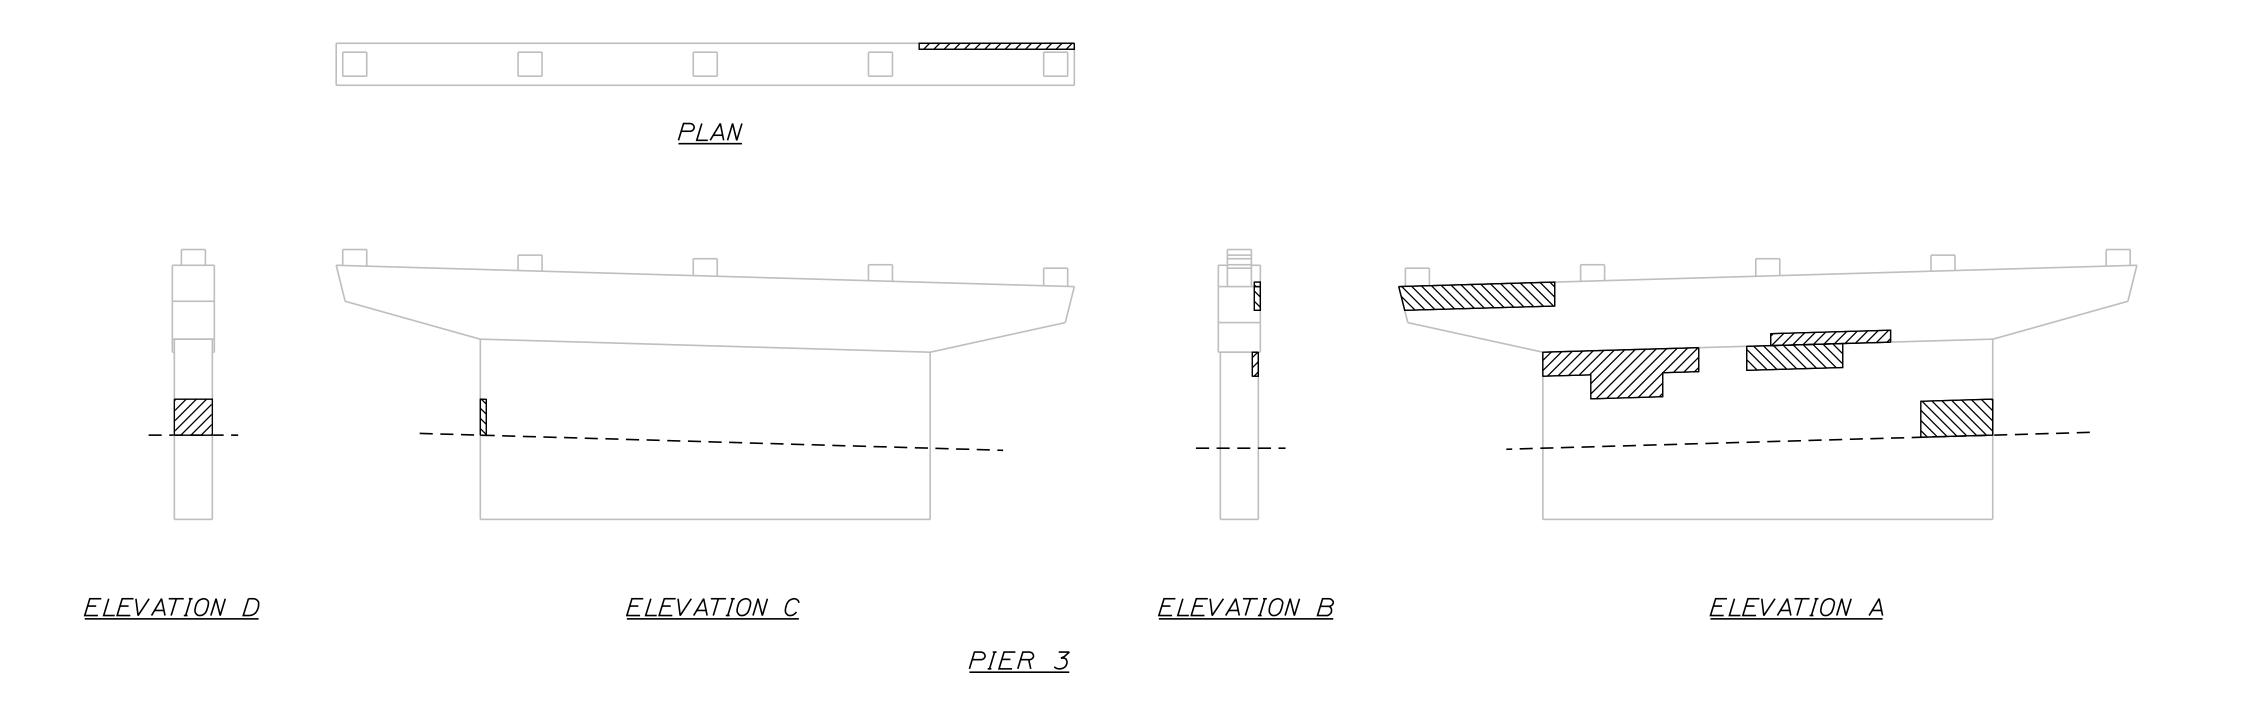

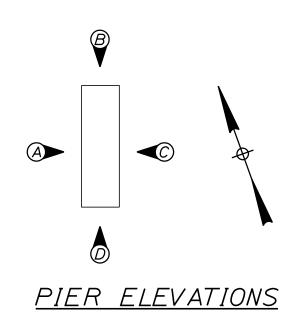

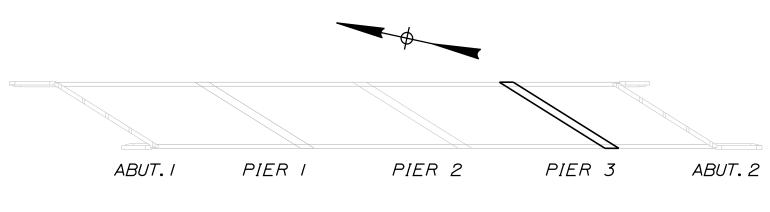

LOCATION PLAN

64.3	Scal				Designed by:						
_MM_		NOT TO SCALE			T:Y:	LI	NINTE	ERNATI	01	IAL	T
XXX\.:	No.	Revision	Ву	Date							
					CONSULTANT F	PROJEC	CT MANAGER:	Daniel S. Myers			1
am						Ву	Date		Ву	Date	
ilen					Designed	JJL	11/2018	Checked	BLT	11/2018	
ᄔ	·				Drawn	JJL	11/2018	In Charge of	DSM	1/2019	

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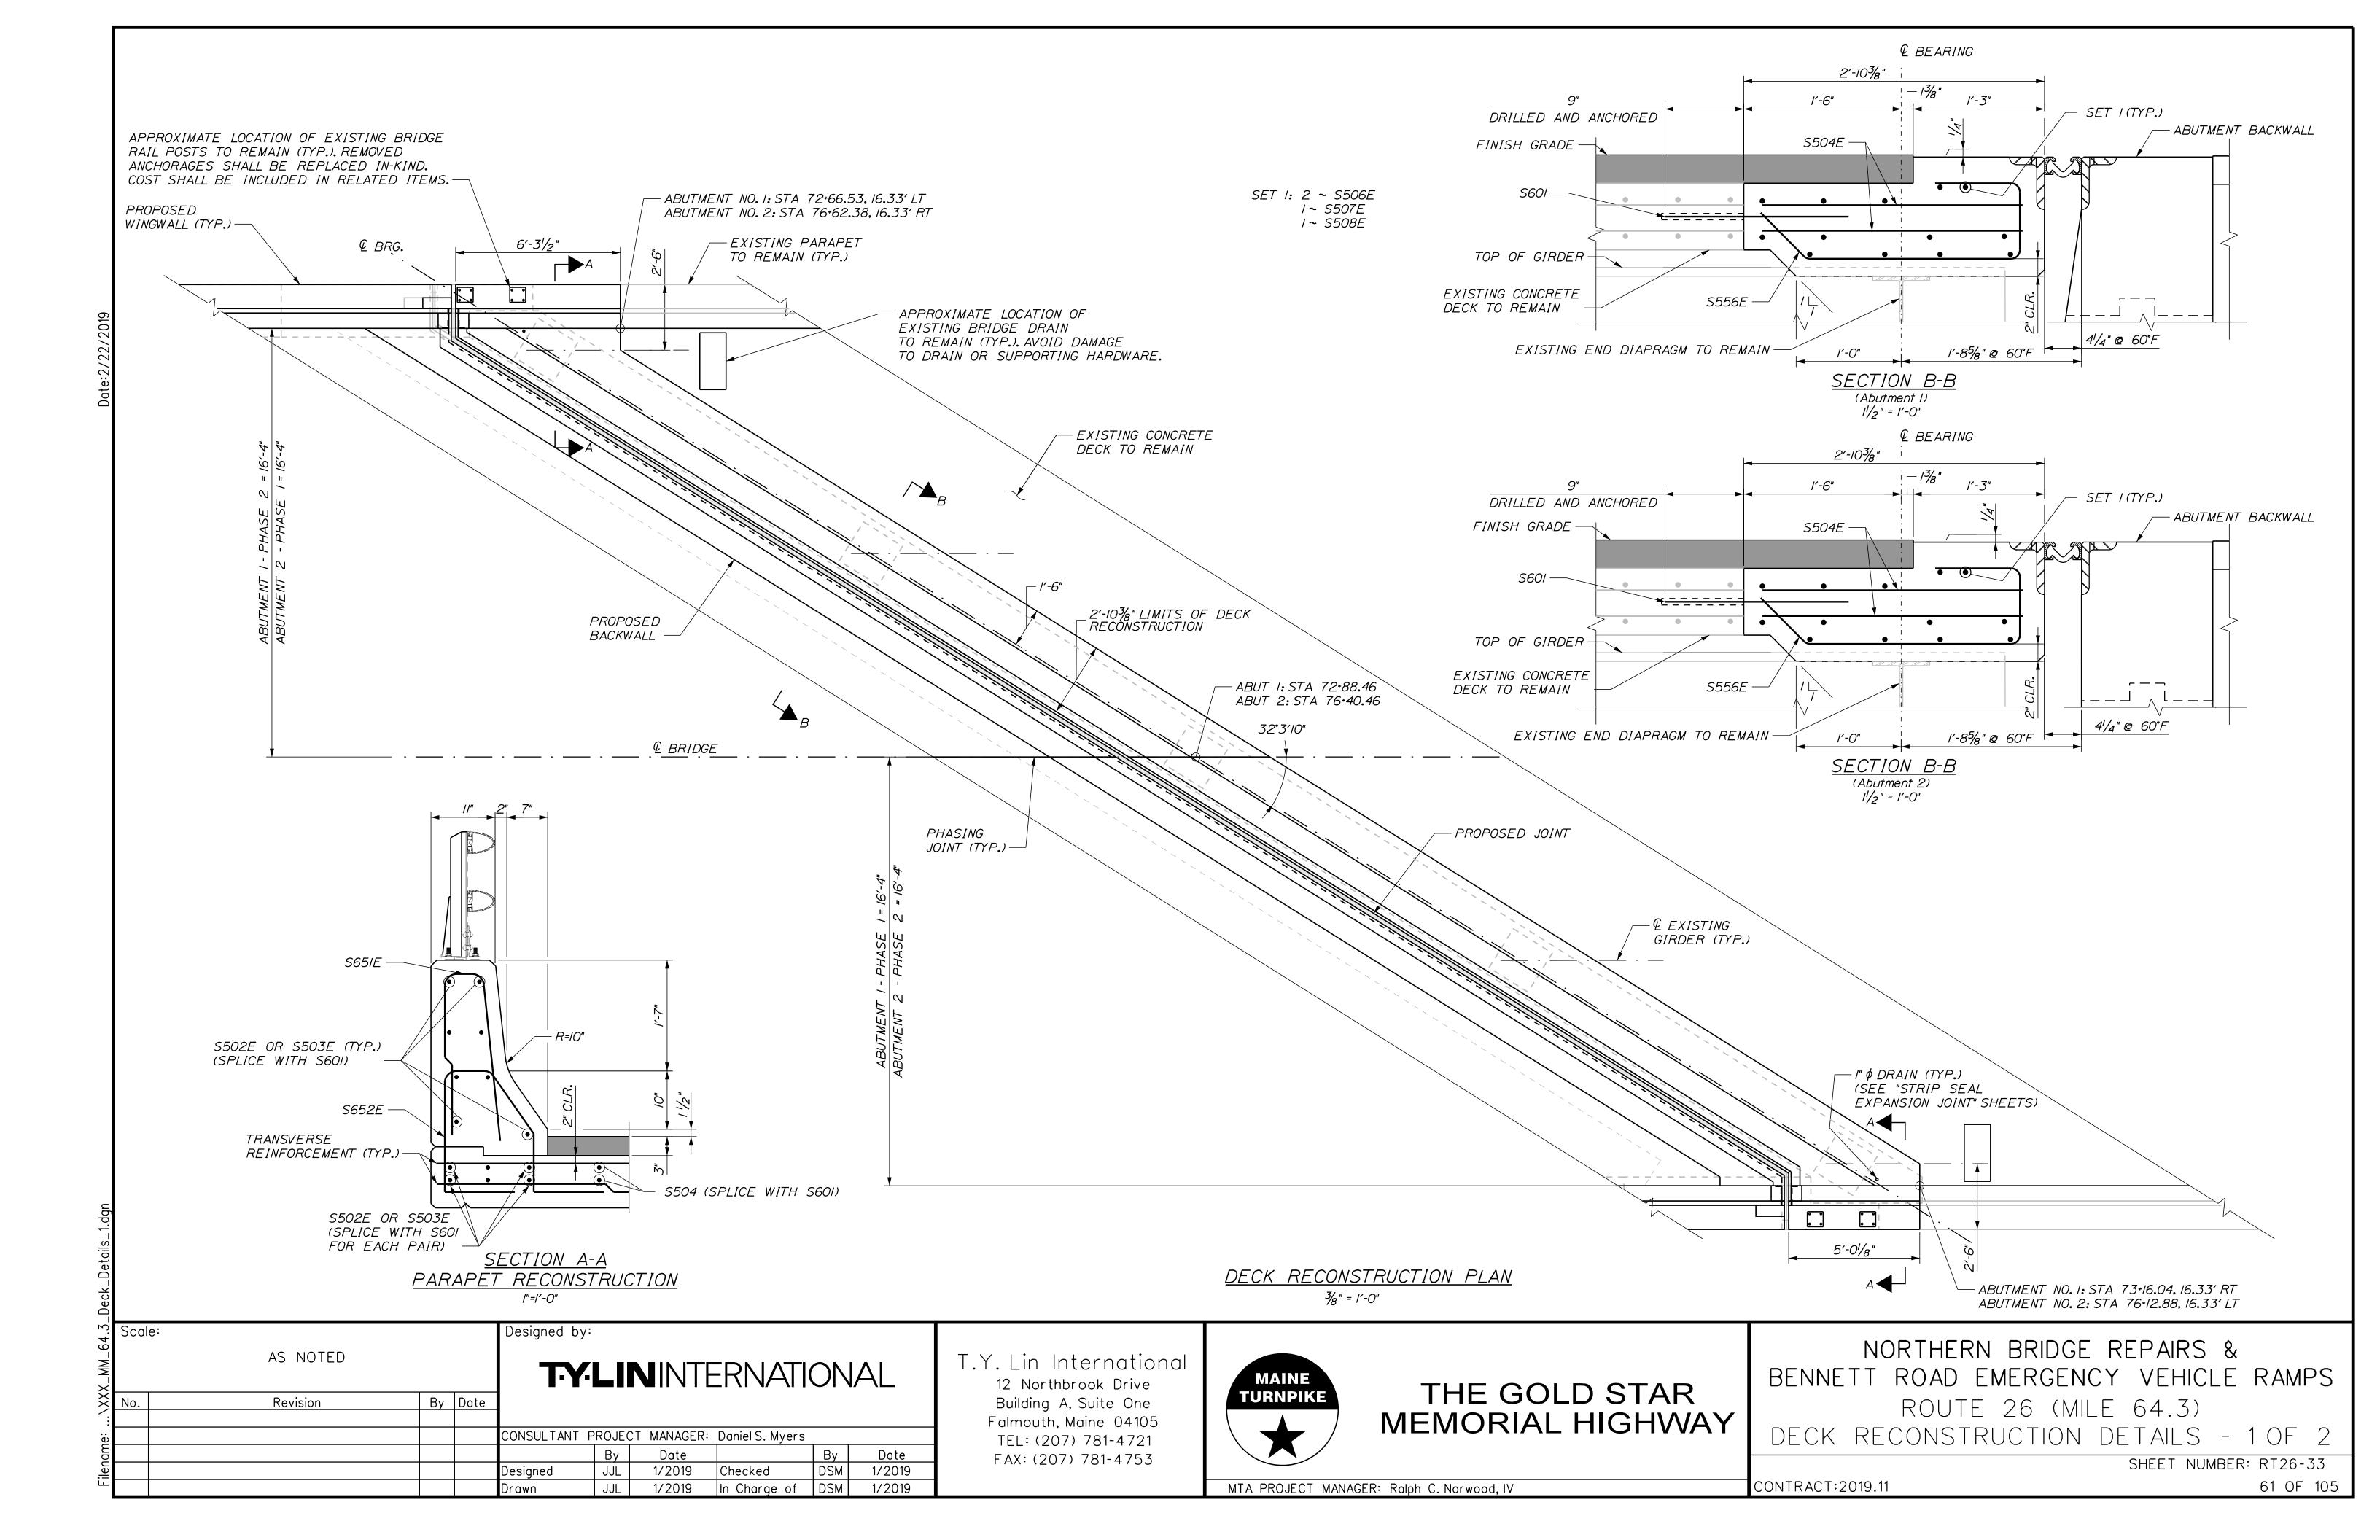
THE GOLD STAR MEMORIAL HIGHWAY


NORTHERN BRIDGE REPAIRS & BENNETT ROAD EMERGENCY VEHICLE RAMPS

ROUTE 26 (MILE 64.3) PIER REPAIRS - 2 OF 2

SHEET NUMBER: RT26-32


CONTRACT:2019.11 60 OF 105



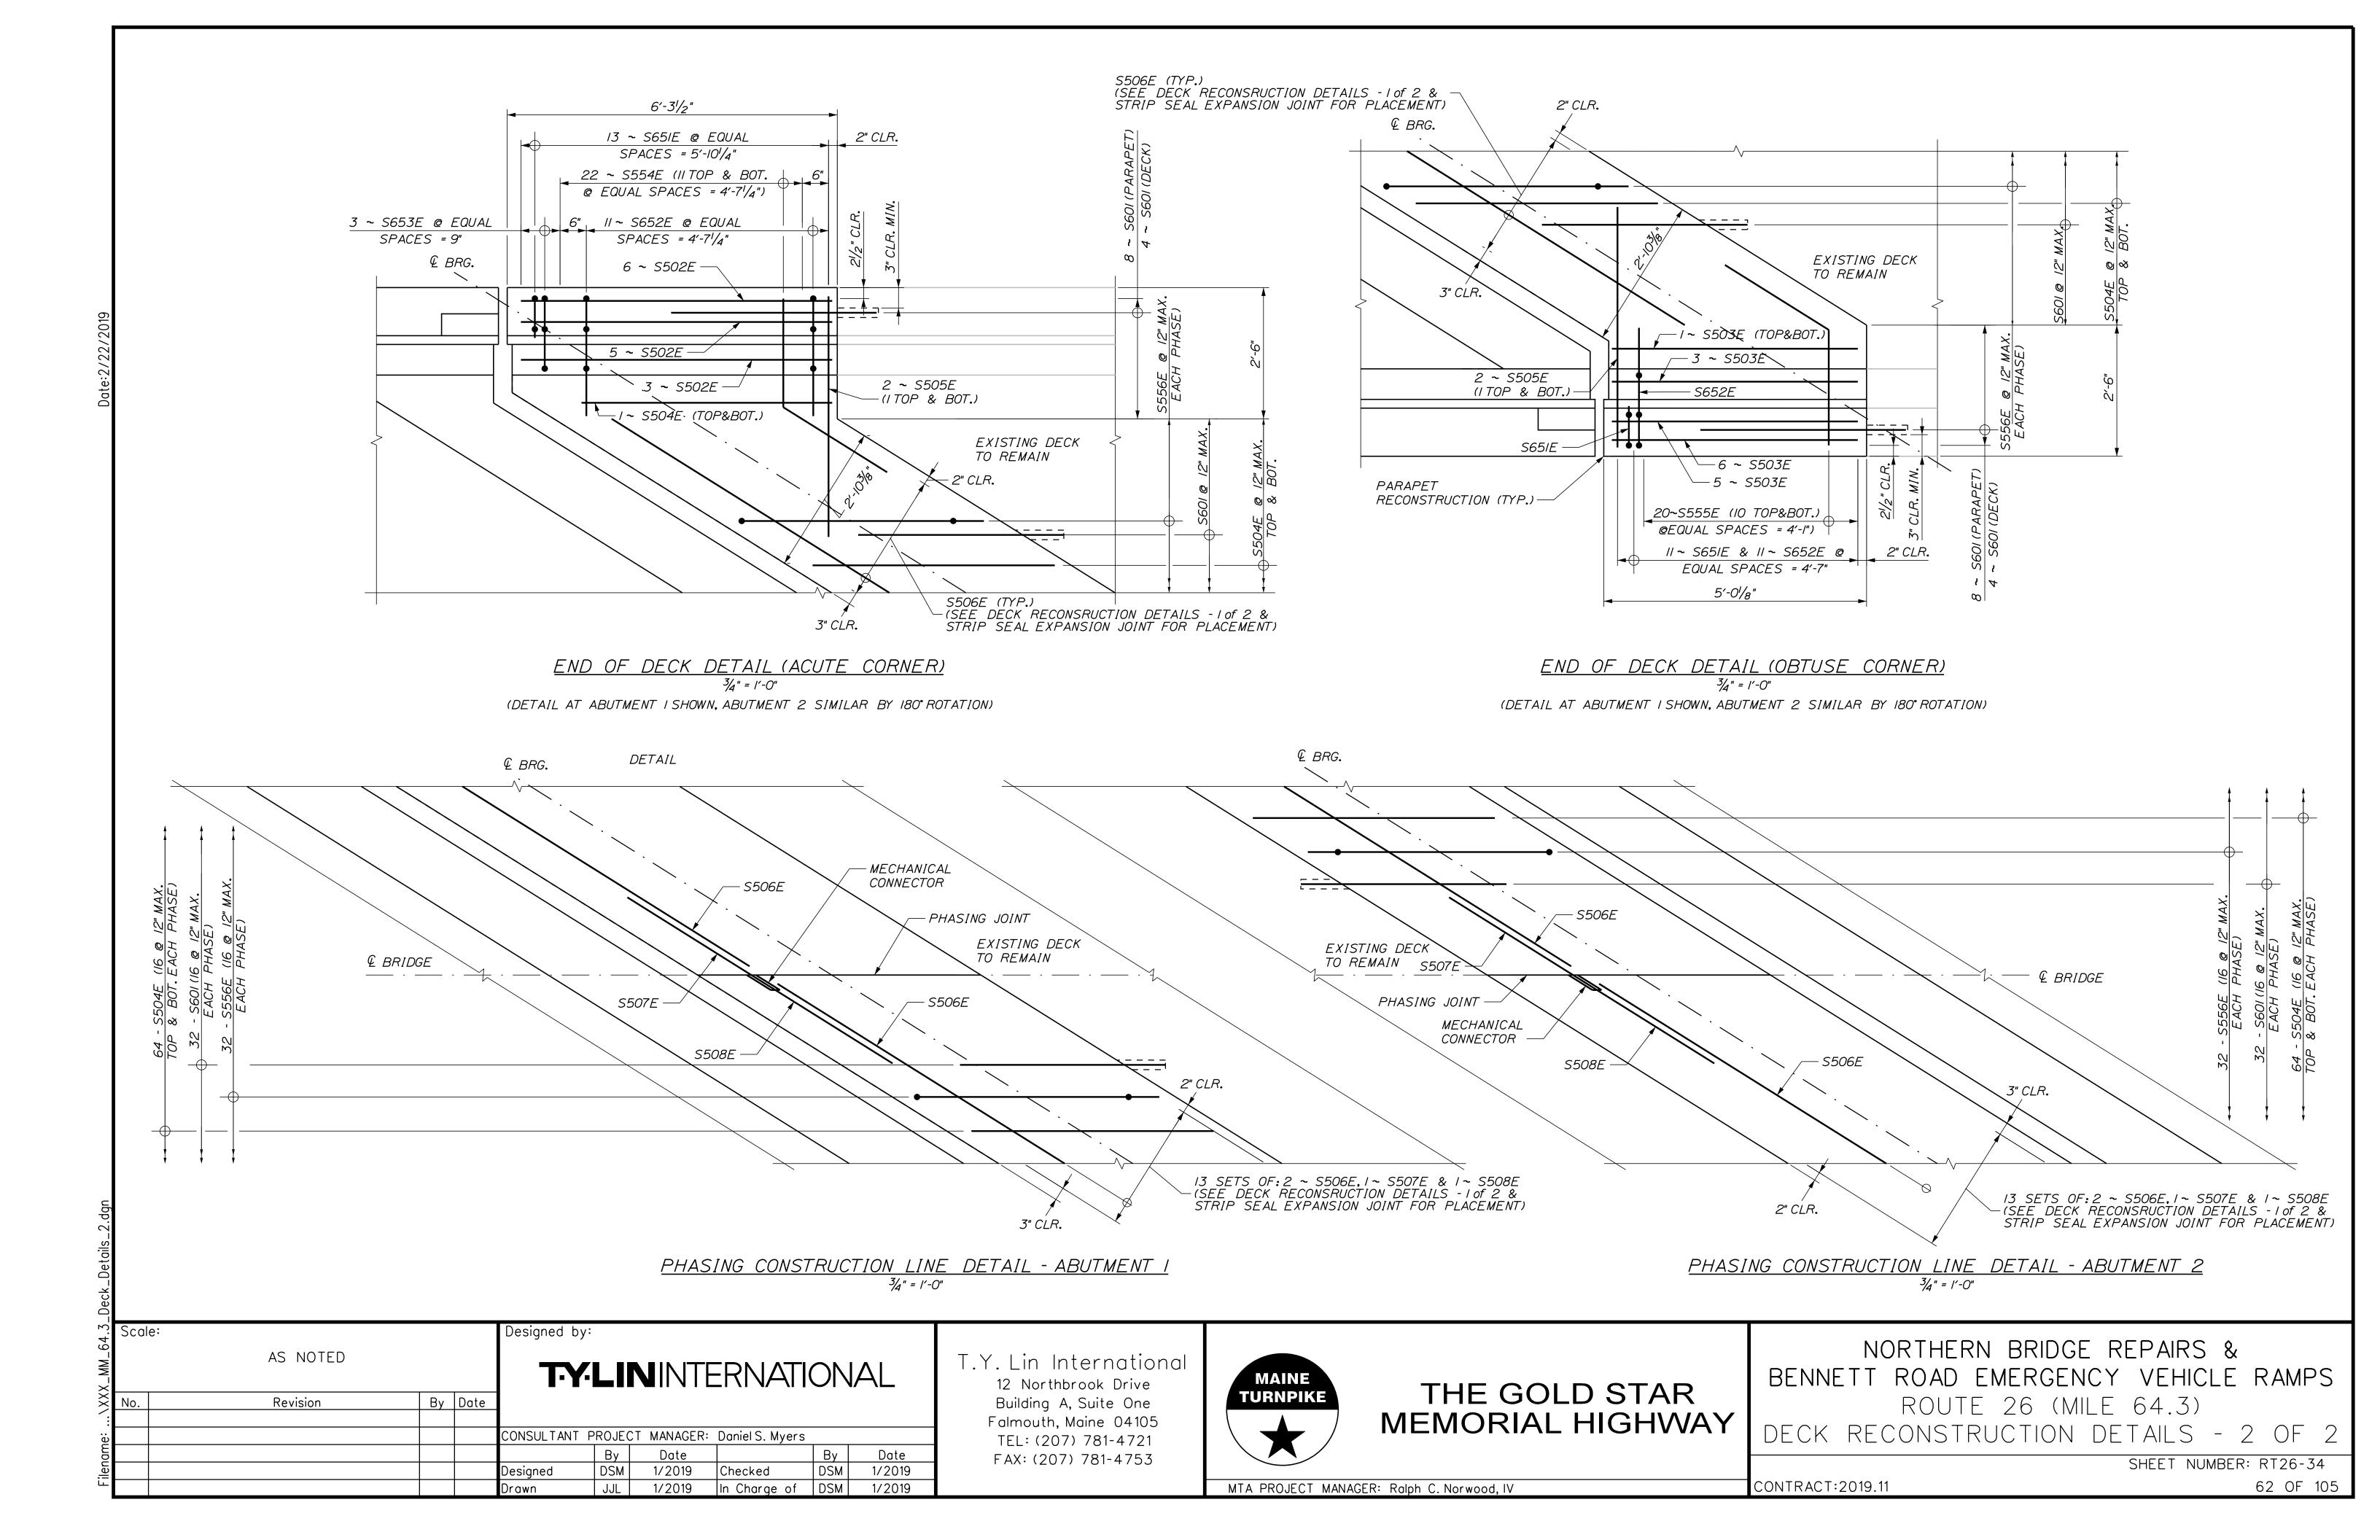


#### **QUANTITIES:**

ABUTMENT BOLSTERS	PIER BOLSTERS	TOTAL NUMBER OF BOLSTERS
5	10	<i>1</i> 5

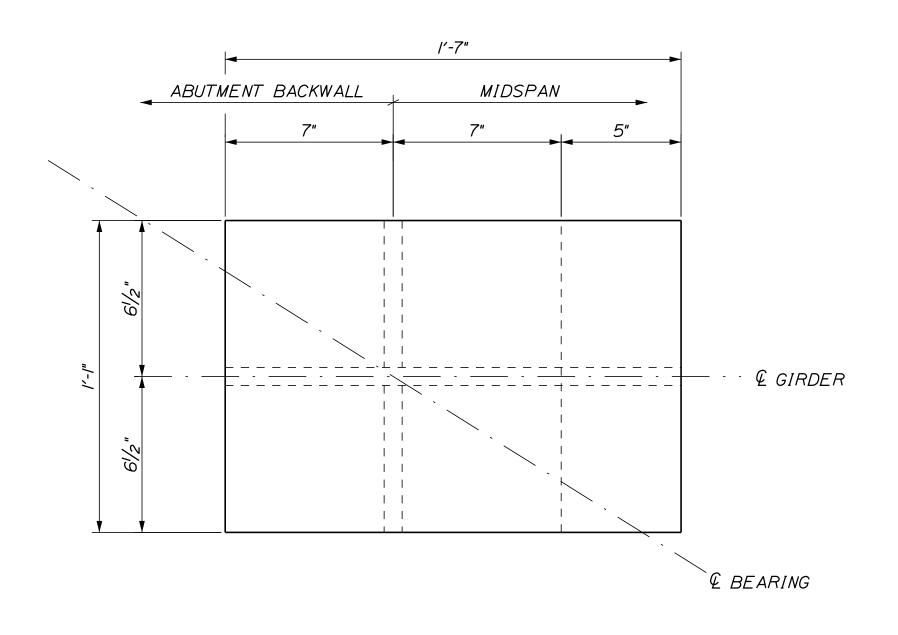



ABUTMENT BOLSTER PLAN

3" = /'-0"

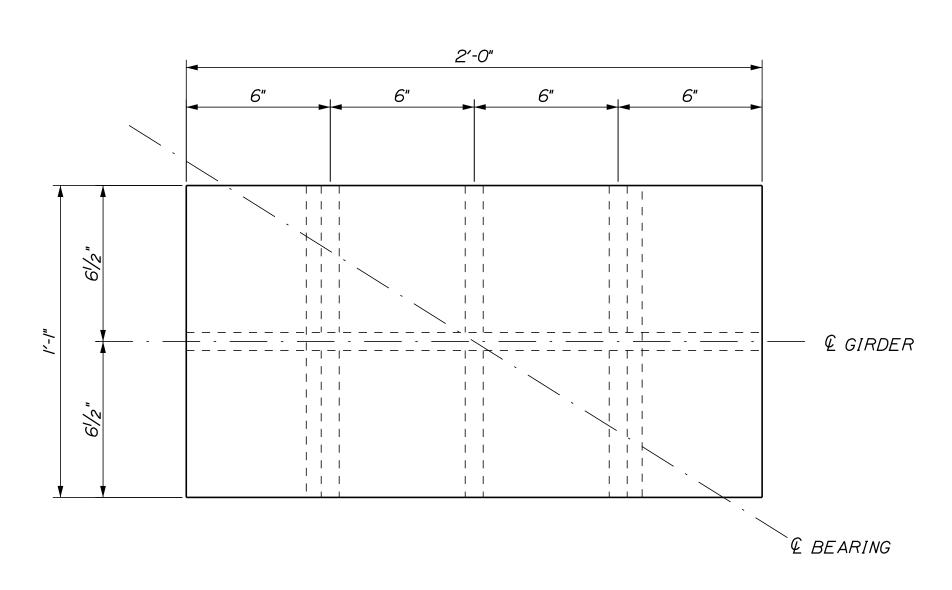

<u>PIER BOLSTER PLAN</u> 3" = /'-0"

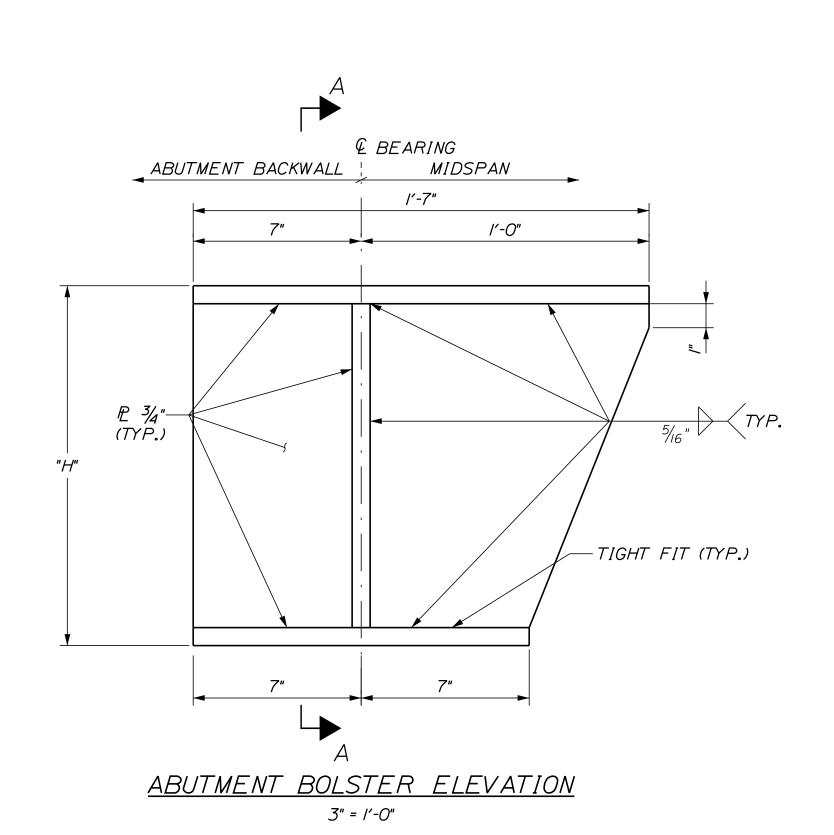


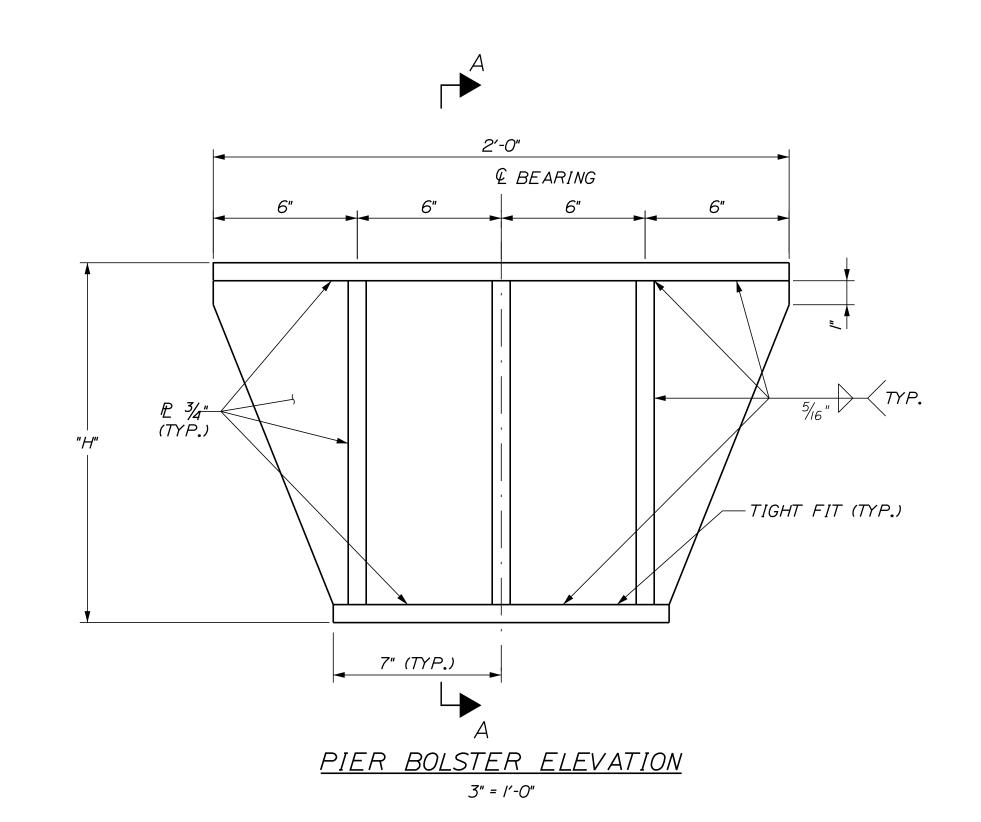

#### NOTES:

- I. ALL STEEL PLATES SHALL CONFORM TO AASHTO M270, GRADE 36 OR 50.
- 2. BEARING BOLSTERS SHALL BE HOT DIP GALVANIZED AFTER FABRICATION IN ACCORDANCE WITH AASHTO AI23.

BOLSTER	R AND SPA	ACER PLATE TABLE
SUBSTRUCTURE LOCATION	GIRDER NUMBER	BOLSTER - SPACER PLATE HEIGHT ("H") - (INCHES)
	GI	1.3125
ABUTMENT I	G2	I <b>.</b> 6875
SPACER PLATE	<i>G3</i>	2.0625
	G4	<b>2.43</b> 75
	G5	2.8125
	G/	3.7500
PIER I	G2	4.1250
SPACER PLATE	G3	4.5000
		4.8750
	G5	5.2500
	G/	<b>6.</b> 7500
PIER 2		7./250
BOLSTER		7.5000
<i></i>		7.8750
	G5	8.2500
		9,7500
PIER 3	 G2	10.1250
BOLSTER	G3	10.5000
DOLOTER	G4	10.8750
	G5	// <b>.</b> 2500
	GI	12.1250
ABUTMENT 2	G2	12.5000
<i>BOLSTER</i>	G3	<i>12.9375</i>
	G4	<i>13.3125</i>
	G5	/3.6875

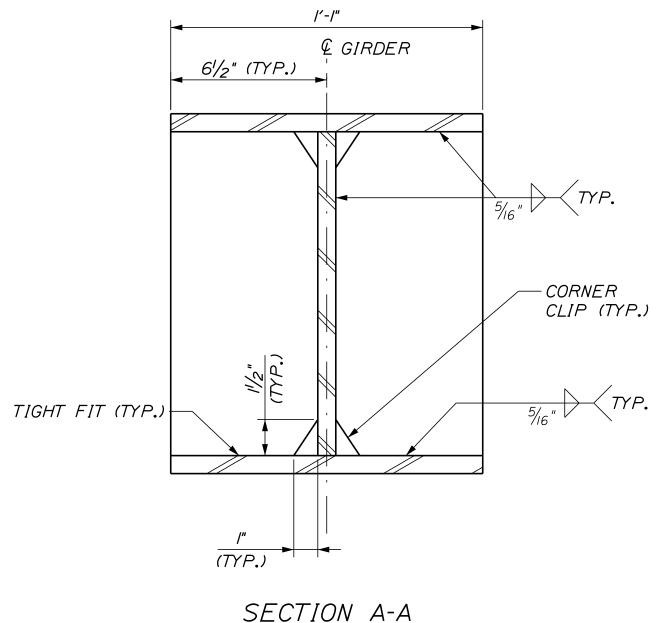

SECTION A-A 3" = /'-0"

CONTRACT:2019.11

Scale:				Designed by	Designed by:					
	AS NOTED			T-Y-LININTERNATIONAL						
No.	Revision	Ву	Date	•						
				CONSULTANT	PROJEC	T MANAGER:	Daniel S. Myers			
					Ву	Date		Ву	Date	
				Designed	JJL	10/2018	Checked	CPT	12/2018	
				Drawn	JJL	10/2018	In Charge of	DSM	1/2019	

T.Y. Lin International 12 Northbrook Drive Building A, Suite One Falmouth, Maine 04105 TEL: (207) 781-4721 FAX: (207) 781-4753



THE GOLD STAR MEMORIAL HIGHWAY

NORTHERN BRIDGE REPAIRS & BENNETT ROAD EMERGENCY VEHICLE RAMPS


ROUTE 26 (MILE 64.3) BOLSTER DETAILS

SHEET NUMBER: RT26-35


MTA PROJECT MANAGER: Ralph C. Norwood, IV


#### NOTES:


- I. BOLSTERS IDENTIFIED IN THE TABLES SHALL BE INSTALLED BY THE CONTRACTOR AT THE LOCATIONS SHOWN, INSTALLATION SHALL BE IN ACCORDANCE WITH SPECIAL PROVISION 523.524, BEARING BOLSTER AND SPACER PLATES, FURNISHED AND INSTALLED.
- 2. ALL BOLSTERS WILL BE FIELD WELDED TO THE COVER PLATES AND/OR GIRDERS.
- 3. ALL EXISTING POT BEARINGS & SOLE PLATES WILL BE REUSED AND ALL WILL BE WELDED TO THE BOTTOM OF THE NEW BOLSTERS.
- 4. ALL AREAS OF GALVANIZING AND/OR PAINTING DAMAGED IN THE FIELD BY WELDING, GRINDING, OR INCIDENTAL WORK SHALL BE FIELD REPAIRED IN ACCORDANCE WITH ASTM A780 OR SECTION 506, AS APPLICABLE.
- 5. EXISTING BOLT HOLES OVER BOLSTERS THAT ARE NOT USED SHALL BE FILLED WITH A MATERIAL APPROVED BY THE RESIDENT.
- 6. EXISTING POT BEARINGS ARE SENSITIVE TO DIRT AND SHALL BE HANDLED WITH CARE, THE BEARINGS SHALL BE MARKED PRIOR TO REMOVAL FOR ORIENTATION TO BRIDGE, LOCATION AND WITH ITSELF.

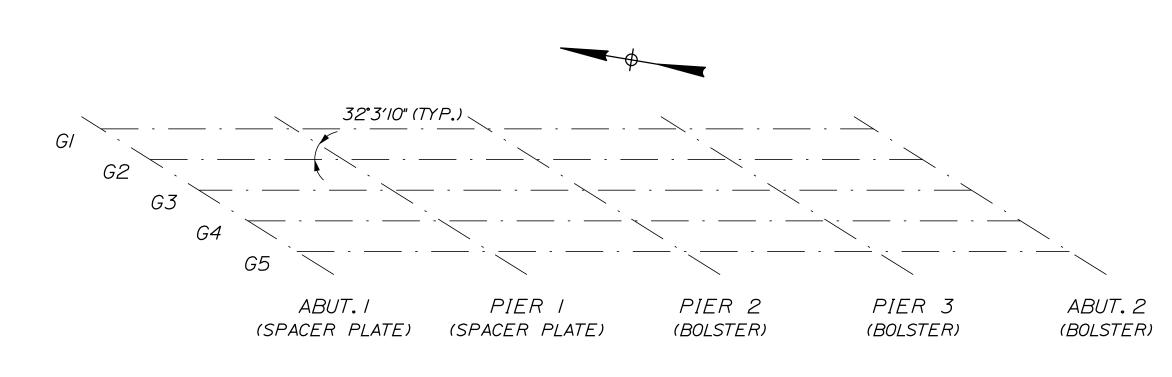



#### LOCATION PLAN

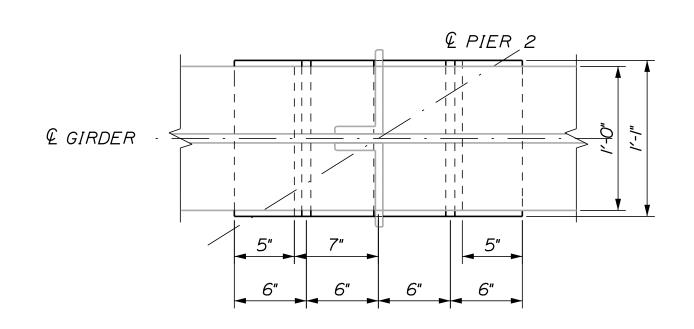


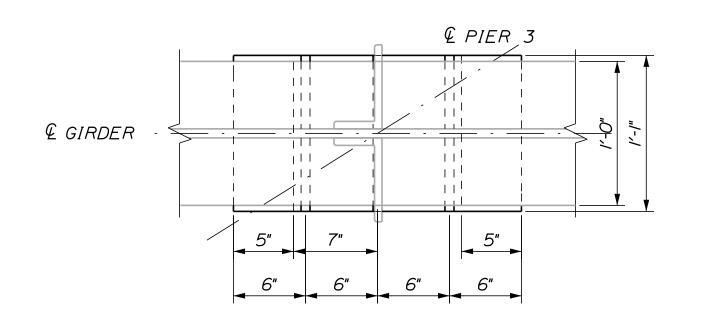


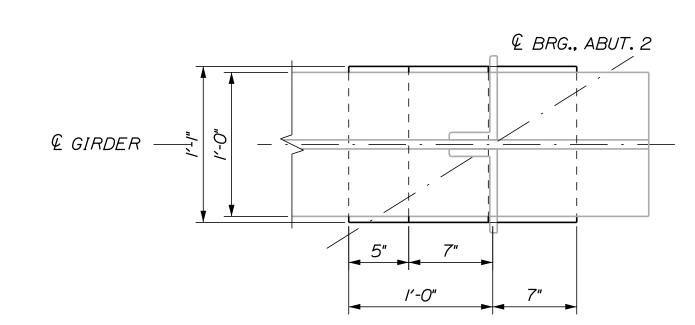

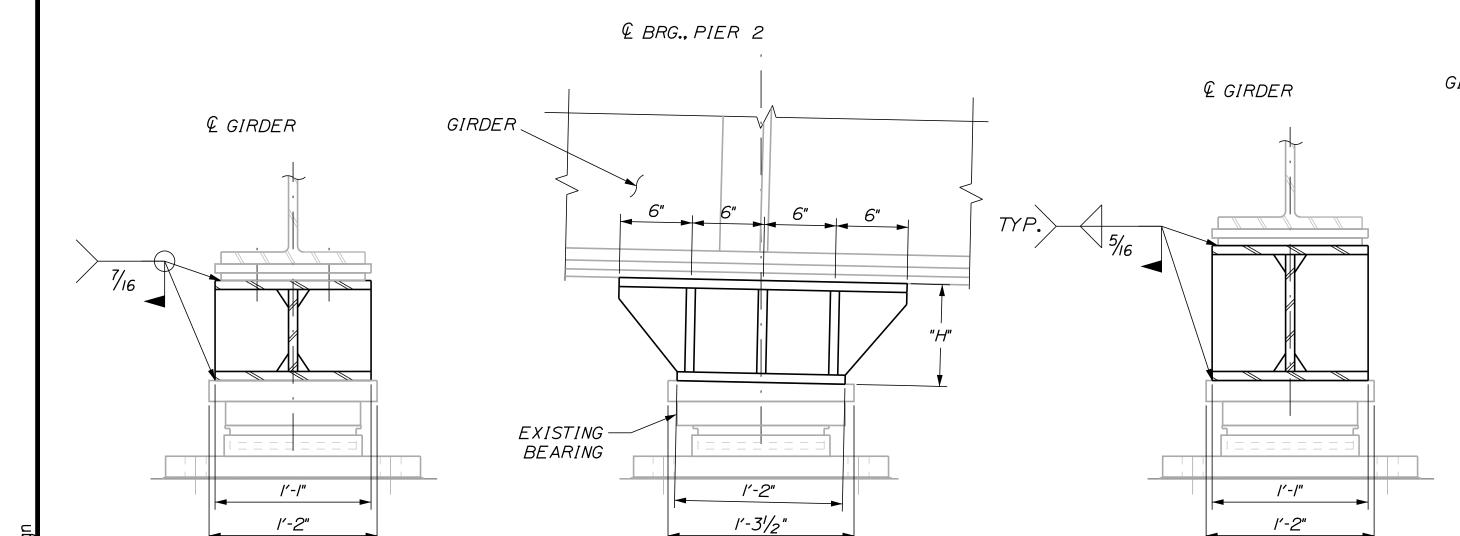

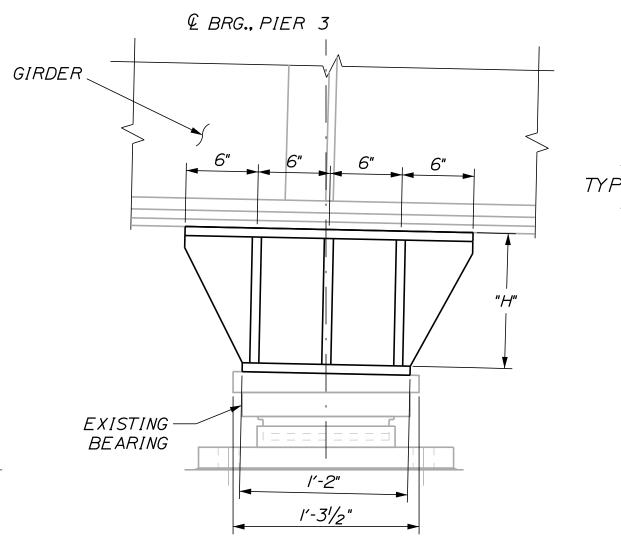

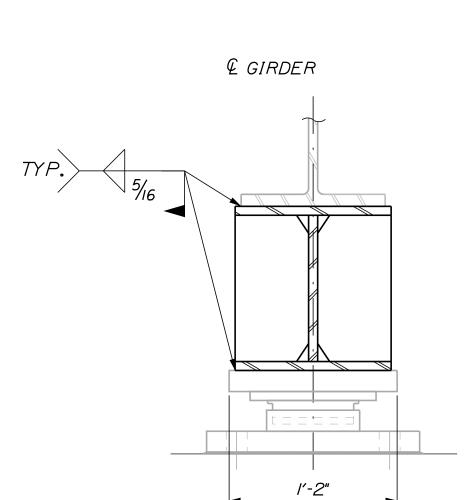

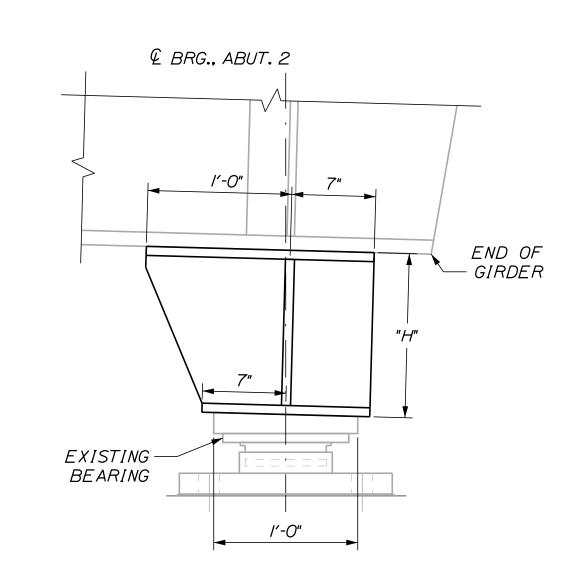

<u> PIER 2</u> PIER 2 GIRDER I - 5 HEIGHT "H" VARIABLE

PIER 3 PIER 3 GIRDER I - 5 HEIGHT "H" VARIABLE

<u>ABUTMENT 2</u> ABUTMENT 2 GIRDER 1-5 HEIGHT "H" VARIABLE

CONTRACT:2019.11

04.3	Scal	e:			Designed by:							
  M   -		11/2" = 1'-0"		T-Y-LININTERNATIONAL								
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:  -					CONSULTANT	PROJEC	T MANAGER:	Daniel S. Myers				
						Ву	Date		Ву	Date		
					Designed	JJL	10/2018	Checked	CPT	12/2018		
ľ					Drawn	JJL	10/2018	In Charge of	DSM	1/2019		

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## THE GOLD STAR MEMORIAL HIGHWAY


NORTHERN BRIDGE REPAIRS & BENNETT ROAD EMERGENCY VEHICLE RAMPS ROUTE 26 (MILE 64.3) BOLSTER INSTALLATION DETAILS

SHEET NUMBER: RT26-36


MTA PROJECT MANAGER: Ralph C. Norwood, IV

#### **QUANTITIES:**


	ABUTMENT SPACER PLATES	PIER SPACER PLATES	TOTAL NUMBER OF SPACER PLATES
f	5	5	10

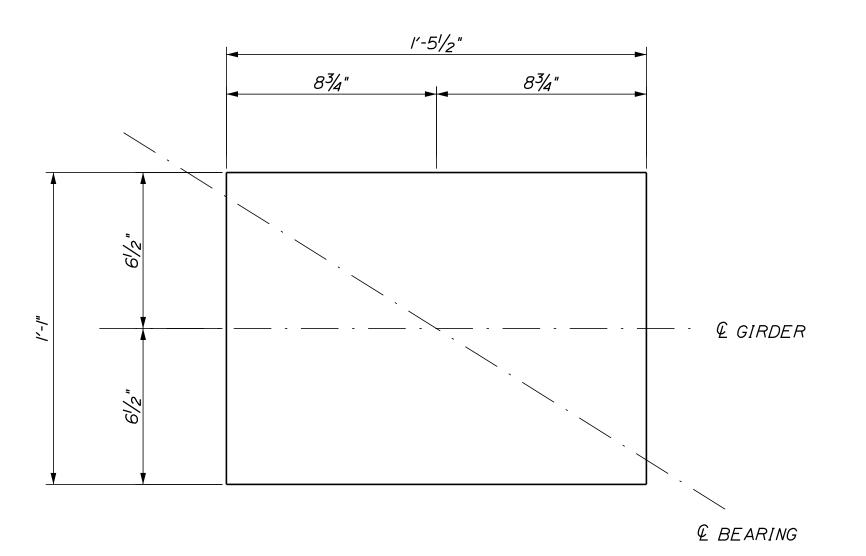


<u>PIER SPACER PLATE PLAN</u> 3" = /'-0"

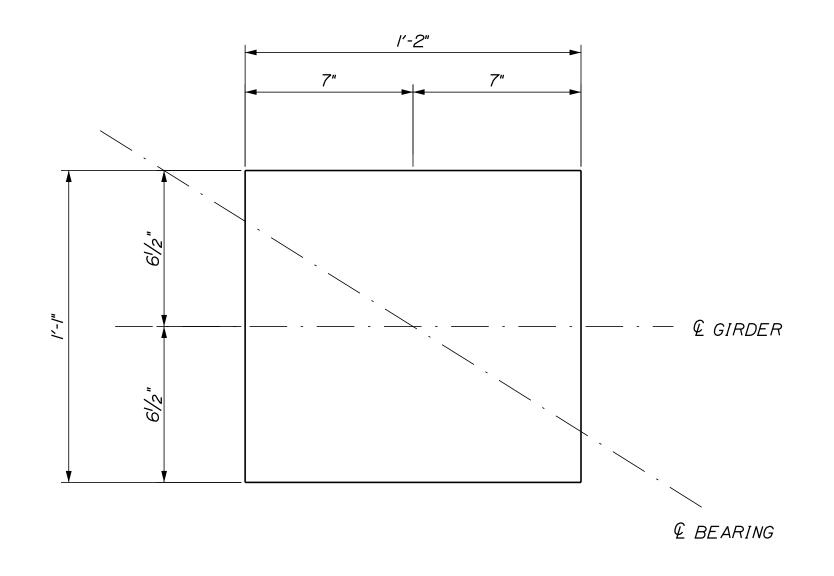

ABUTMENT SPACER PLATE PLAN 3" = /'-0"

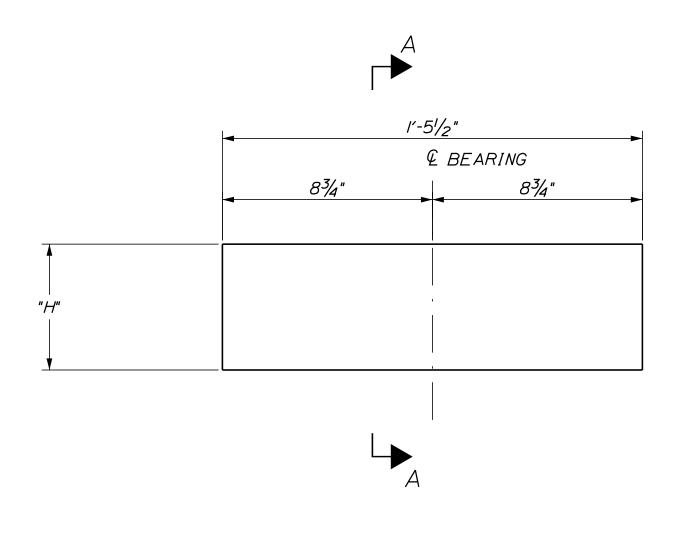


PIER SPACER PLATE ELEVATION 3" = /'-0"

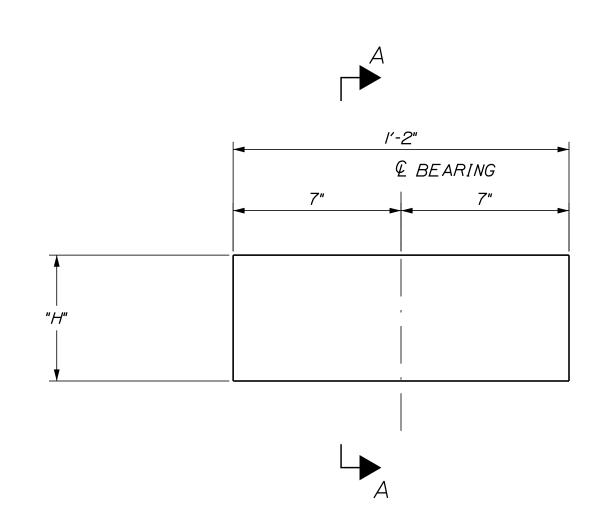

ABUTMENT SPACER PLATE ELEVATION 3" = /'-0"

#### NOTES:


- I. ALL STEEL PLATES SHALL CONFORM TO AASHTO M270, GRADE 36 OR 50.
- 2. BEARING SPACER PLATES SHALL BE HOT DIP GALVANIZED AFTER FABRICATION IN ACCORDANCE WITH AASHTO A123.
- 3. SEE "BOLSTER AND SPACER PLATE TABLE" ON "BOLSTER DETAILS" SHEET FOR LOCATION & HEIGHT "H".

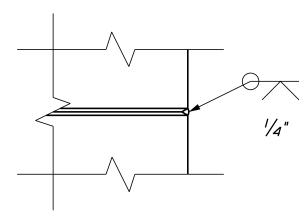

### OPTIONAL PLATE BUILD-UP DETAIL

3" = /'-0"

NOTE: MINIMUM THICKNESS OF I" BETWEEN PLATE WELDS

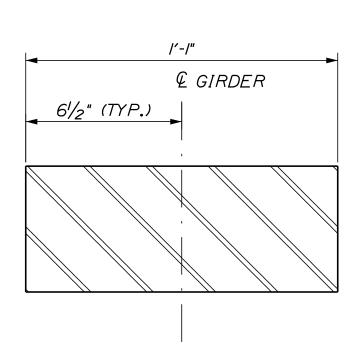

SECTION A-A 3" = /'-0"

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NORTHERN BRIDGE REPAIRS & BENNETT ROAD EMERGENCY VEHICLE RAMPS


ROUTE 26 (MILE 64.3) SPACER PLATE DETAILS


SHEET NUMBER: RT26-37


CONTRACT:2019.11 65 OF 105

#### NOTES:


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- 5. EXISTING BOLT HOLES OVER SPACER PLATES THAT ARE NOT USED SHALL BE FILLED WITH A MAERIAL APPROVED BY THE RESIDENT.

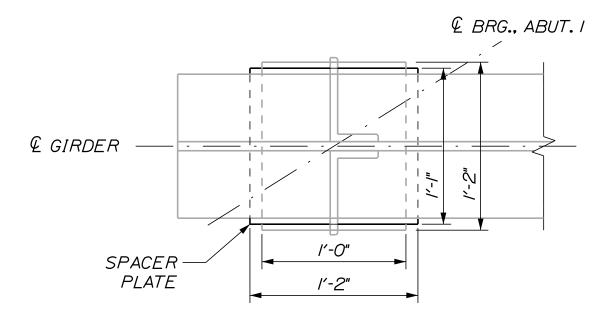

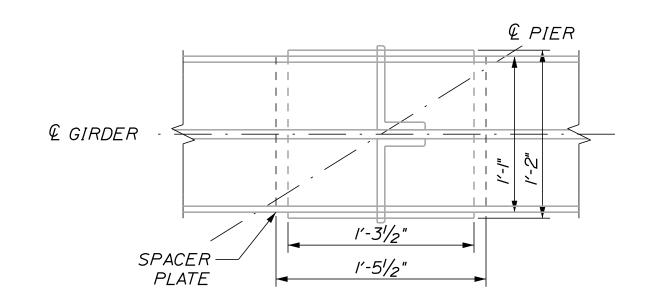

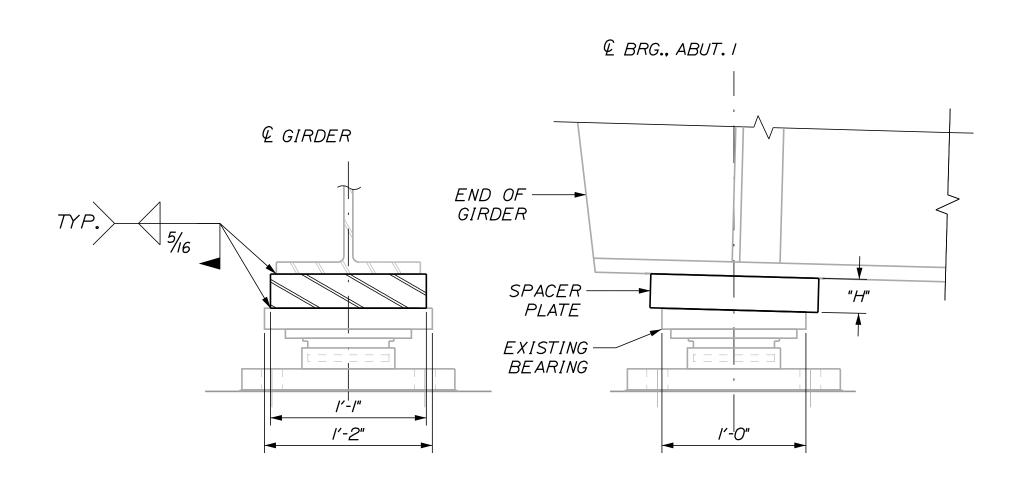



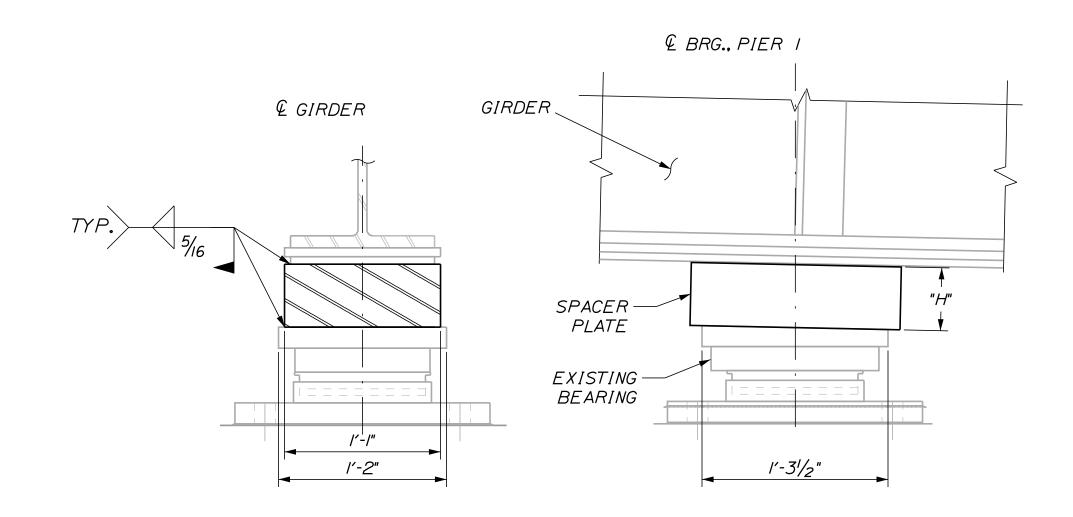

<u>PIER I</u> PIER IGIRDER 5 SHOWN,OTHERS SIMILAR

CONTRACT:2019.11

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# THE GOLD STAR MEMORIAL HIGHWAY


NORTHERN BRIDGE REPAIRS &
BENNETT ROAD EMERGENCY VEHICLE RAMPS


ROUTE 26 (MILE 64.3)

SPACER PLATE INSTALLATION DETAILS


SHEET NUMBER: RT26-38

MTA PROJECT MANAGER: Ralph C. Norwood, IV

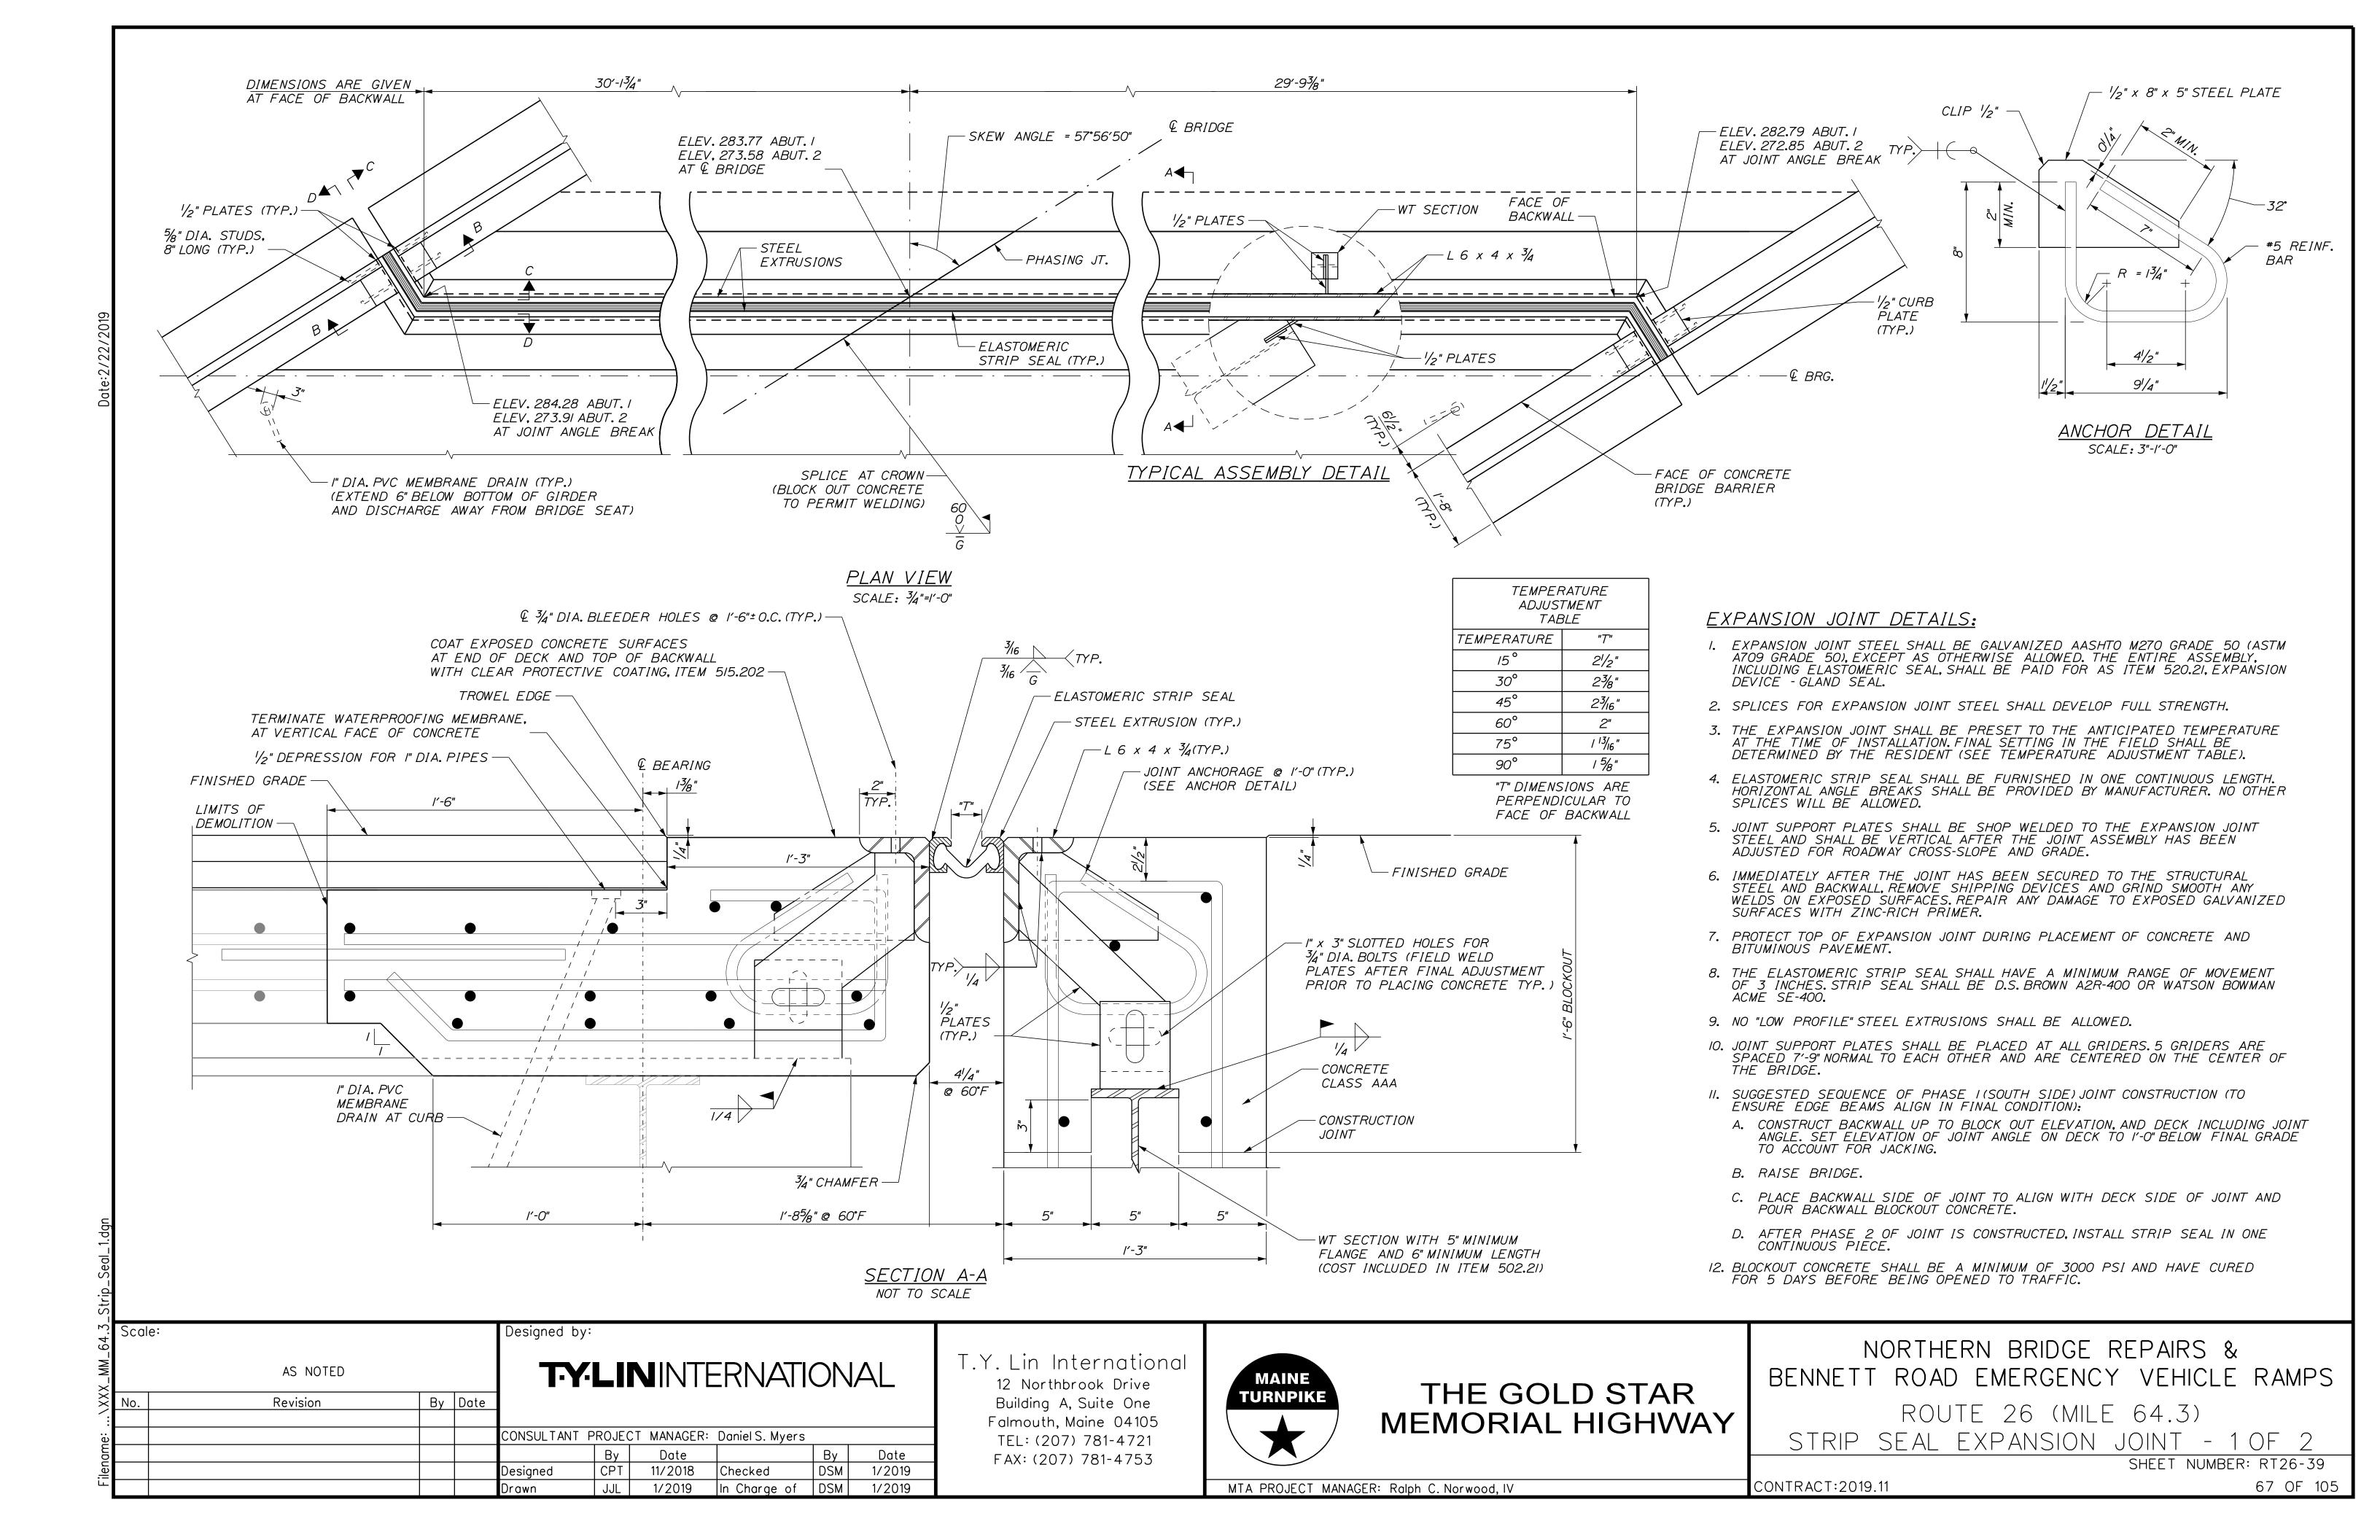

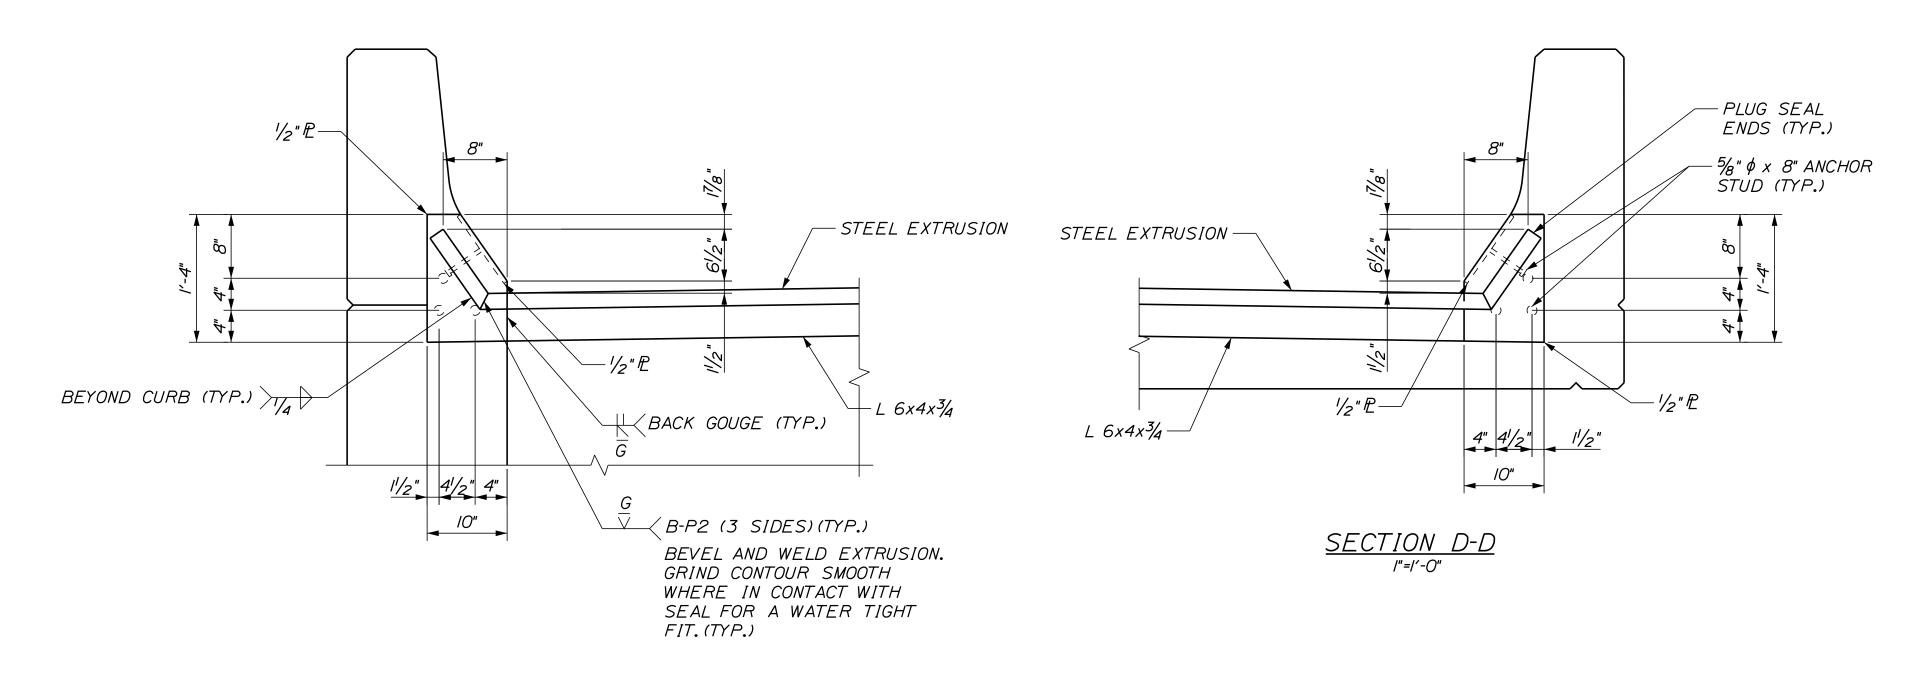

SECTION C-C

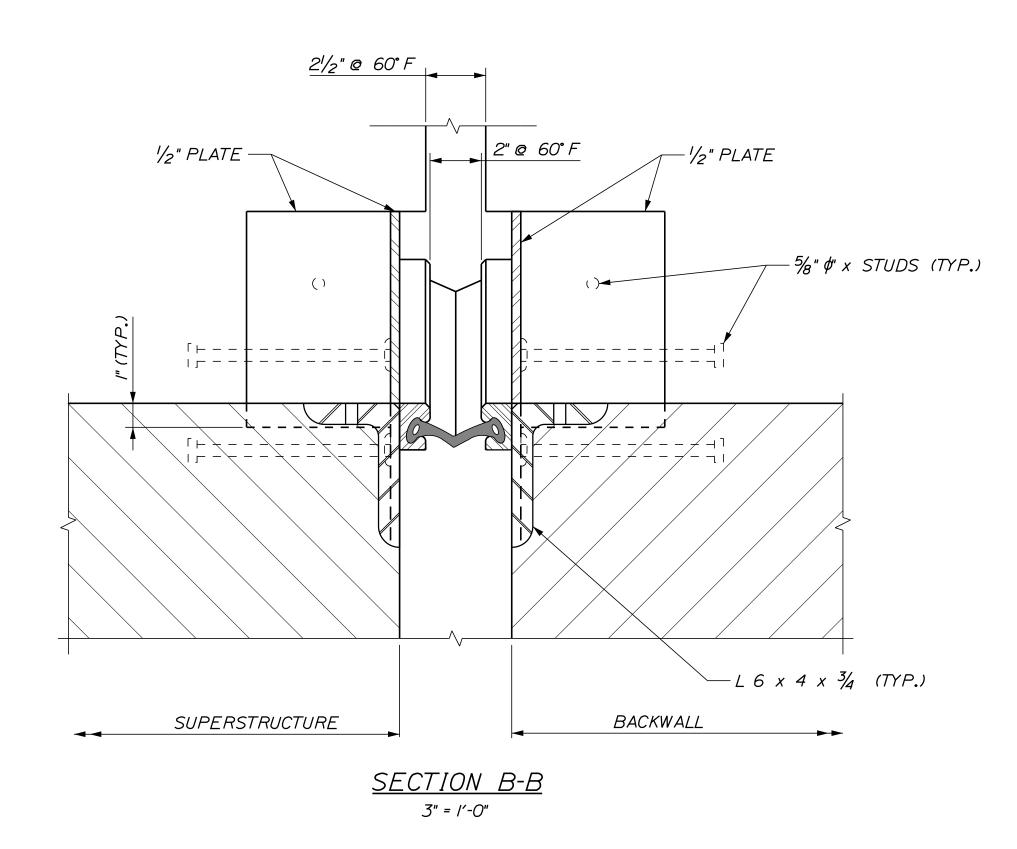

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# THE GOLD STAR MEMORIAL HIGHWAY

NORTHERN BRIDGE REPAIRS &
BENNETT ROAD EMERGENCY VEHICLE RAMPS

ROUTE 26 (MILE 64.3)

STRIP SEAL EXPANSION JOINT - 2 OF 2

SHEET NUMBER: RT26-40


CONTRACT:2019.11 68 OF 105


MTA PROJECT MANAGER: Ralph C. Norwood, IV


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MARK QTY		IGHT BARS  LOCATION	MADK	OTV	LENGTH	Ттург	Λ	В		l D	F	BENT	BARS G	Ги	т	l v	D		LOCATION
MARK   QII		NT NO. /	WAKK	QII.	LENGIN	ПІІСЕ	A	D	ABUTME	NT NO. /		<u>г</u>	<u> </u>	_ п	J	I K	IX	1 0	LOCATION
50IE 8	33′ -3"	TRANS. STEMWALL	A55IE	63	4′ -9"	16	<i>O</i> "	/′ -//"	//"	/′ -//"	O"	O"	O"	/′ -//"	<i>3.</i> 5"	l' -2 <b>.</b> 5"	<i>O</i> "	<i>1' -2.5</i> "	STEMWALL - STIRRUPS
502E 4	30′ -0"	TRANS. STEMWALL	A552E	4	5′ -10"	17	<i>O</i> "	2' -11"	2' -11"	0"	О"	0"	O"	0"	0"	O"	0"	0"	STEMWALL - WINGWALL TIES
503E 4	32′ -0"	TRANS. STEMWALL	A553E	4	7′ -10"	16	<i>O</i> "	2' -11"	l' -9"	3' -2"	<i>O</i> "	<i>O</i> "	<i>O</i> "	2′ -8"	l' -8"	3′ -5"	0"	3′ -5"	STEMWALL - WINGWALL TIES
504E 8 505E 8	3′ -6" 3′ -6"	TRANS. STEMWALL TRANS. STEMWALL	AW65/E	62	10' -10"	77	/′ -O"	l' -4"	3′ -7"	l' -9"	2' -2"	<i>O</i> "	/′ -O"	l' -4"	l' -4"	<i>O</i> "	<i>O</i> "	<i>O</i> "	WINGWALL STIRRUPS
505E 8 506E 4	3' -0"	TRANS. STEMWALL	AW652E	10	3' -2"	16	0"	0"	2' -2"	1' -O"	0"	0"	0"	9"	8"	2' -11"	<i>O</i> "	2' -11"	WINGWALL STITITIONS WINGWALL VERTICAL
A507 126		VERT. STEMWALL - DOWEL	AW653E	2	2' -3"	17	<i>O</i> "	/′ -3"	/′ -O"	0"	<i>O</i> "	0"	0"	0"	<i>O</i> "	0"	<i>O</i> "	0"	WINGWALL
			AW754E	12	5′ -3"	16	0"	<i>O</i> "	2' -9"	2' -6"	0"	0"	O"	6"	2′ -6"	5′ -3"	O"	5′ -3"	WINGWALL LONGITUDINAL
W601 144	2' -//"	VERT. WINGWALL - DOWEL	AW755E	4	5′ -2"	16	<i>O</i> "	<i>O</i> "	2′ -9"	2′ -5"	0"	0"	O"	//"	2′ -4"	5′ -/"	<i>O</i> "	5′ -/"	WINGWALL LONGITUDINAL
'602E   12	5′ -/"	VERT. WINGWALL	AW756E	4	5′ -6"	16	<i>O</i> "	<i>O</i> "	2′ -9"	2' -9"	<i>O</i> "	<i>O</i> "	O"	l' -6"	2' -4"	5′ -/"	<i>O</i> "	5′ -/"	WINGWALL LONGITUDINAL
603E 58	5′ -5″	VERT. WINGWALL																	
604E 62	6' -4"	VERT. WINGWALL	DEELE	CZ	C/ ///	17	O"	0/ 7//	ABUIME Tim	NT NO. 2		T 0"			<u> </u>		0"		CTEMMALL CTIDDUDG
'605E 2 '606E 2	5′ -//" 5′ -7"	VERT. WINGWALL  VERT. WINGWALL	<i>B55IE</i> <i>B552E</i>	63 4	6' -1" 5' -10"	17	0"	2' -7" 2' -11"	2' -11"	2' -7" 0"	<i>O</i> "	<i>O</i> "	<i>O</i> "	O"	O" O"	O"	O" O"	<i>O</i> "	STEMWALL - STIRRUPS STEMWALL - WINGWALL TIES
1608E 2	5' -3"	VERT. WINGWALL	B553E	4	7' -10"	16	<i>O</i> "	2' -11"	1' -9"	3' -2"	0"	0"	0"	2' -8"	1′ -8"	3′ -5"	<i>O</i> "	3' -5"	STEMWALL - WINGWALL TIES
608E 2	4' -//"	VERT. WINGWALL	<u>                                   </u>	,	7 70	1 ,0			, ,	J 2					, 0	3 3			STEMWALL WINGWALL TIES
'609E 4	4' -8"	VERT. WINGWALL	BW65/E	37	//′ -/0"	77	l' -O"	1' -4"	4' -/"	l' -9"	2′ -8"	0"	/' -O"	l' -4"	l' -4"	O"	<i>O</i> "	O"	WINGWALL STIRRUPS
710E 14	20′ -7"	HORIZ. WINGWALL	BW652E	5	3′ -8"	16	O"	O"	2′ -8"	/' -O"	<i>O</i> "	0"	0"	9"	8"	3′ -5"	<i>O</i> "	3′ -5"	WINGWALL VERTICAL
1711E 14	38′ -3"	HORIZ. WINGWALL	BW653E	2	2' -3"	17	<i>O</i> "	l' -3"	l' -O"	0"	0"	0"	O"	0"	<i>O</i> "	O"	<i>O</i> "	0"	WINGWALL
712E 2	19′ -6″	HORIZ. WINGWALL	BW754E		5′ -3"	16	0"	0"	2' -9"	2′ -6"	<i>O</i> "	0"	0"	6"	2′ -6"	5′ -3"	0"	5′ -3"	WINGWALL LONGITUDINAL
1713E 2	37' -2"	HORIZ, WINGWALL	<i>BW755E</i>	4	5′ -2"	16	0"	0"	2' -9"	2' -5"	0"	O"	O"	//"	2' -4"	5′ -/"	0"	5′ -/"	WINGWALL LONGITUDINAL
714E 40	5′ -4"	HORIZ. WINGWALL	BW756E	4	5′ -6"	16   77	0"	0"	2' -9"	2' -9"	0"	0"	0"	l' -6"	2' -4"	5' -/"	<i>O</i> "	5' -/"	WINGWALL LONGITUDINAL
		NT NO. 2	BW657E BW658E	1	//' -/" /O' -//"	77	1' -O" 1' -O"	1' -2" 1' -1"	3' -8" 3' -8"	l' -5"	2' -10" 2' -11"	<i>O</i> "	/' -O" /' -O"	1' -2.5"	10 <b>.</b> 5" 8"	O" O"	O" O"	<i>O</i> "	WINGWALL STIRRUPS WINGWALL STIRRUPS
50IE 8	33' -3"	TRANS. STEMWALL	BW658E BW659E	1	10' -11"	77	/ -O"	/' -/' /' -O"	3' -8"	1'-3	3' -/"	0"	/' -O"	/' -/' /' -O"	6.5"	<i>O</i> "	0"	0"	WINGWALL STIRRUPS WINGWALL STIRRUPS
501L 8	30′ -0"	TRANS. STEMWALL	BW660E	/	// -/"	77	/ -O"	10"	4' -1"	//"	3' -3"	0"	/ -O"	10"	4"	0"	<i>O</i> "	0"	WINGWALL STIRRUPS
503E 4	32′ -0"	TRANS. STEMWALL	BW661E	1	9′ -6"	TI	8"	9"	3' -4"	9"	3' -4"	<i>O</i> "	8"	0"	<i>O</i> "	<i>O</i> "	0"	<i>O</i> "	WINGWALL STIRRUPS
504E 8	3′ -6"	TRANS. STEMWALL	BW762E	2	5′ -0"	<i>S4</i>	0"	2' -6"	2' -6"	0"	<i>O</i> "	O"	O"	0"	0"	0"	0"	O"	WINGWALL
505E 8	3′ -6"	TRANS. STEMWALL																	
506E 4	3′ -0"	TRANS. STEMWALL			<del>-</del>	T			1	RUCTURE	1	<u> </u>	Т .			1 . 1		T .	
<i>507 126</i>	3′ -2"	VERT. STEMWALL - DOWEL	S651E	48	5′ -4"	26	0"	2' -4"	6" 7"	2' -6"	0"	0"	0"	2' -6"	3"	O"	0"	0"	PARAPET TRANSVERSE
N601 84	3′ -5"	VERT. WINGWALL - DOWEL	S652E S653E	44 6	6' -4" 5' -4"	26	1' -0" 1' -0"	l' -9" l' -9"	7"	/' -/" /' -/"	//"	<i>O</i> "	/' -O"	//"	8" 8"	O"	O" O"	<i>O</i> "	PARAPET TRANSVERSE PARAPET TRANSVERSE
N601 84 602E 12	5' -5"	VERT. WINGWALL - DOWEL VERT. WINGWALL	S554E	44	4' -5"	26 16	0"	0"	2' -/"	2' -4"	0"	0"	0"	2' -0"	/ -3"	3' -4"	<i>O</i> "	3' -4"	PARAPET TRANSVERSE
603E 31	5′ -5"	VERT. WINGWALL	S555E	40	4' -6"	16	0"	0"	2' -2"	2' -4"	0"	0"	<i>O</i> "	2' -0"	l' -3"	3' -5"	<i>O</i> "	3′ -5"	PARAPET TRANSVERSE
1604E 35		VERT. WINGWALL	S556E	64	6' -10"	16	l' -6"	8"	3' -9"	//"	<i>O</i> "	0"	0"	5"	10"	4' -7"	<i>O</i> "	4' -7"	DECK LONGITUDINAL STIRRUP
'605E 2	6′ -4"	VERT. WINGWALL																	
'606E 2	6′ -0"	VERT. WINGWALL																	
1607E 2	5′ -8"	VERT. WINGWALL																	
/608E 2	5′ -4"	VERT. WINGWALL																	
1609E 4	5′ -0"	VERT. WINGWALL	_																
V710E 14 V711E 14	10' -3" 21' -4"	HORIZ.WINGWALL HORIZ.WINGWALL																	
N711E 14 N712E 2	9' -2"	HORIZ. WINGWALL																	
V713E 2	20′ -3″	HORIZ. WINGWALL																	
1714E 42		HORIZ. WINGWALL																	
	SUPERS7	RUCTURE																	
601 112		HORIZ. DECK - DOWEL																	
502E 28		HORIZ. LONG.L - PARAPET			1							1							
503E 28	<del>-  </del>	HORIZ, LONG, - PARAPET											-	-					
504E   136 505E   8	4' -7" 4' -6"	HORIZ. LONG DECK HORIZ. TRANS PARAPET																	
506E 52		HORIZ. TRANS PARAPET																	
507E 26	<del>-  </del>	HORIZ. TRANS MECH. CONN.																	
508E 26	+	HORIZ. TRANS MECH. CONN.																	
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REINFORCING STEEL SCHEDULE


STANDARD BAR BEND TYPES




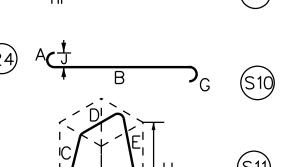

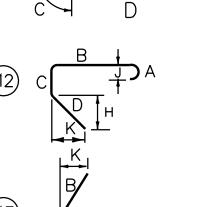

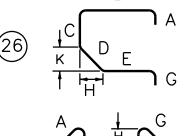STANDEE (ISOMETRIC VIEW)

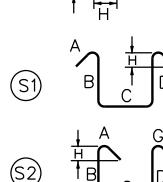

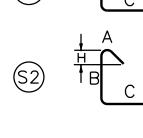

#### REINFORCING GENERAL NOTES:

CONTRACT:2019.11

- I. UNLESS OTHERWISE DESIGNATED, ALL BAR REINFORCEMENT FOR CONCRETE IN SIZES UP TO AND INCLUDING NO. 18 SHALL CONFORM TO THE REQUIREMENTS OF THE "SPECIFICATIONS FOR DEFORMED BILLET-STEEL BARS FOR CONCRETE REINFORCEMENT", AASHTO M31 (ASTM A 615-SI). ALL BARS SHALL BE GRADE 60, UNLESS OTHERWISE DESIGNATED
- 2. FOR TYPICAL BENDING DETAILS, RECOMMENDED PIN DIAMETER "D" OF BENDS AND HOOKS, AND OTHER STANDARD PRACTICE, SEE CURRENT REINFORCING STEEL INSTITUTE "MANUAL OF STANDARD PRACTICE".
- 3. THE FIRST DIGIT FOLLOWING THE LETTER(S) OF THE MARK INDICATES THE SIZE OF THE BAR. ALL BARS WITH MARKS ENDING IN "E" SHALL BE EPOXY COATED.
- 4. ALL DIMENSIONS ARE OUT TO OUT OF BAR EXCEPT "A" AND "G" ON STANDARD 180 DEGREE AND 135 DEGREE HOOKS.

By Date Revision CONSULTANT PROJECT MANAGER: DanielS. Myers By Date 1/2019 DSM 1/2019 JJL Checked Designed In Charge of DSM 1/2019 1/2019

Building A, Suite One Falmouth, Maine 04105 TEL: (207) 781-4721 FAX: (207) 781-4753




THE GOLD STAR MEMORIAL HIGHWAY

NORTHERN BRIDGE REPAIRS & BENNETT ROAD EMERGENCY VEHICLE RAMPS

> ROUTE 26 (MILE 64.3) REINFORCING STEEL SCHEDULE

SHEET NUMBER: RT26-41

MTA PROJECT MANAGER: Ralph C. Norwood, IV

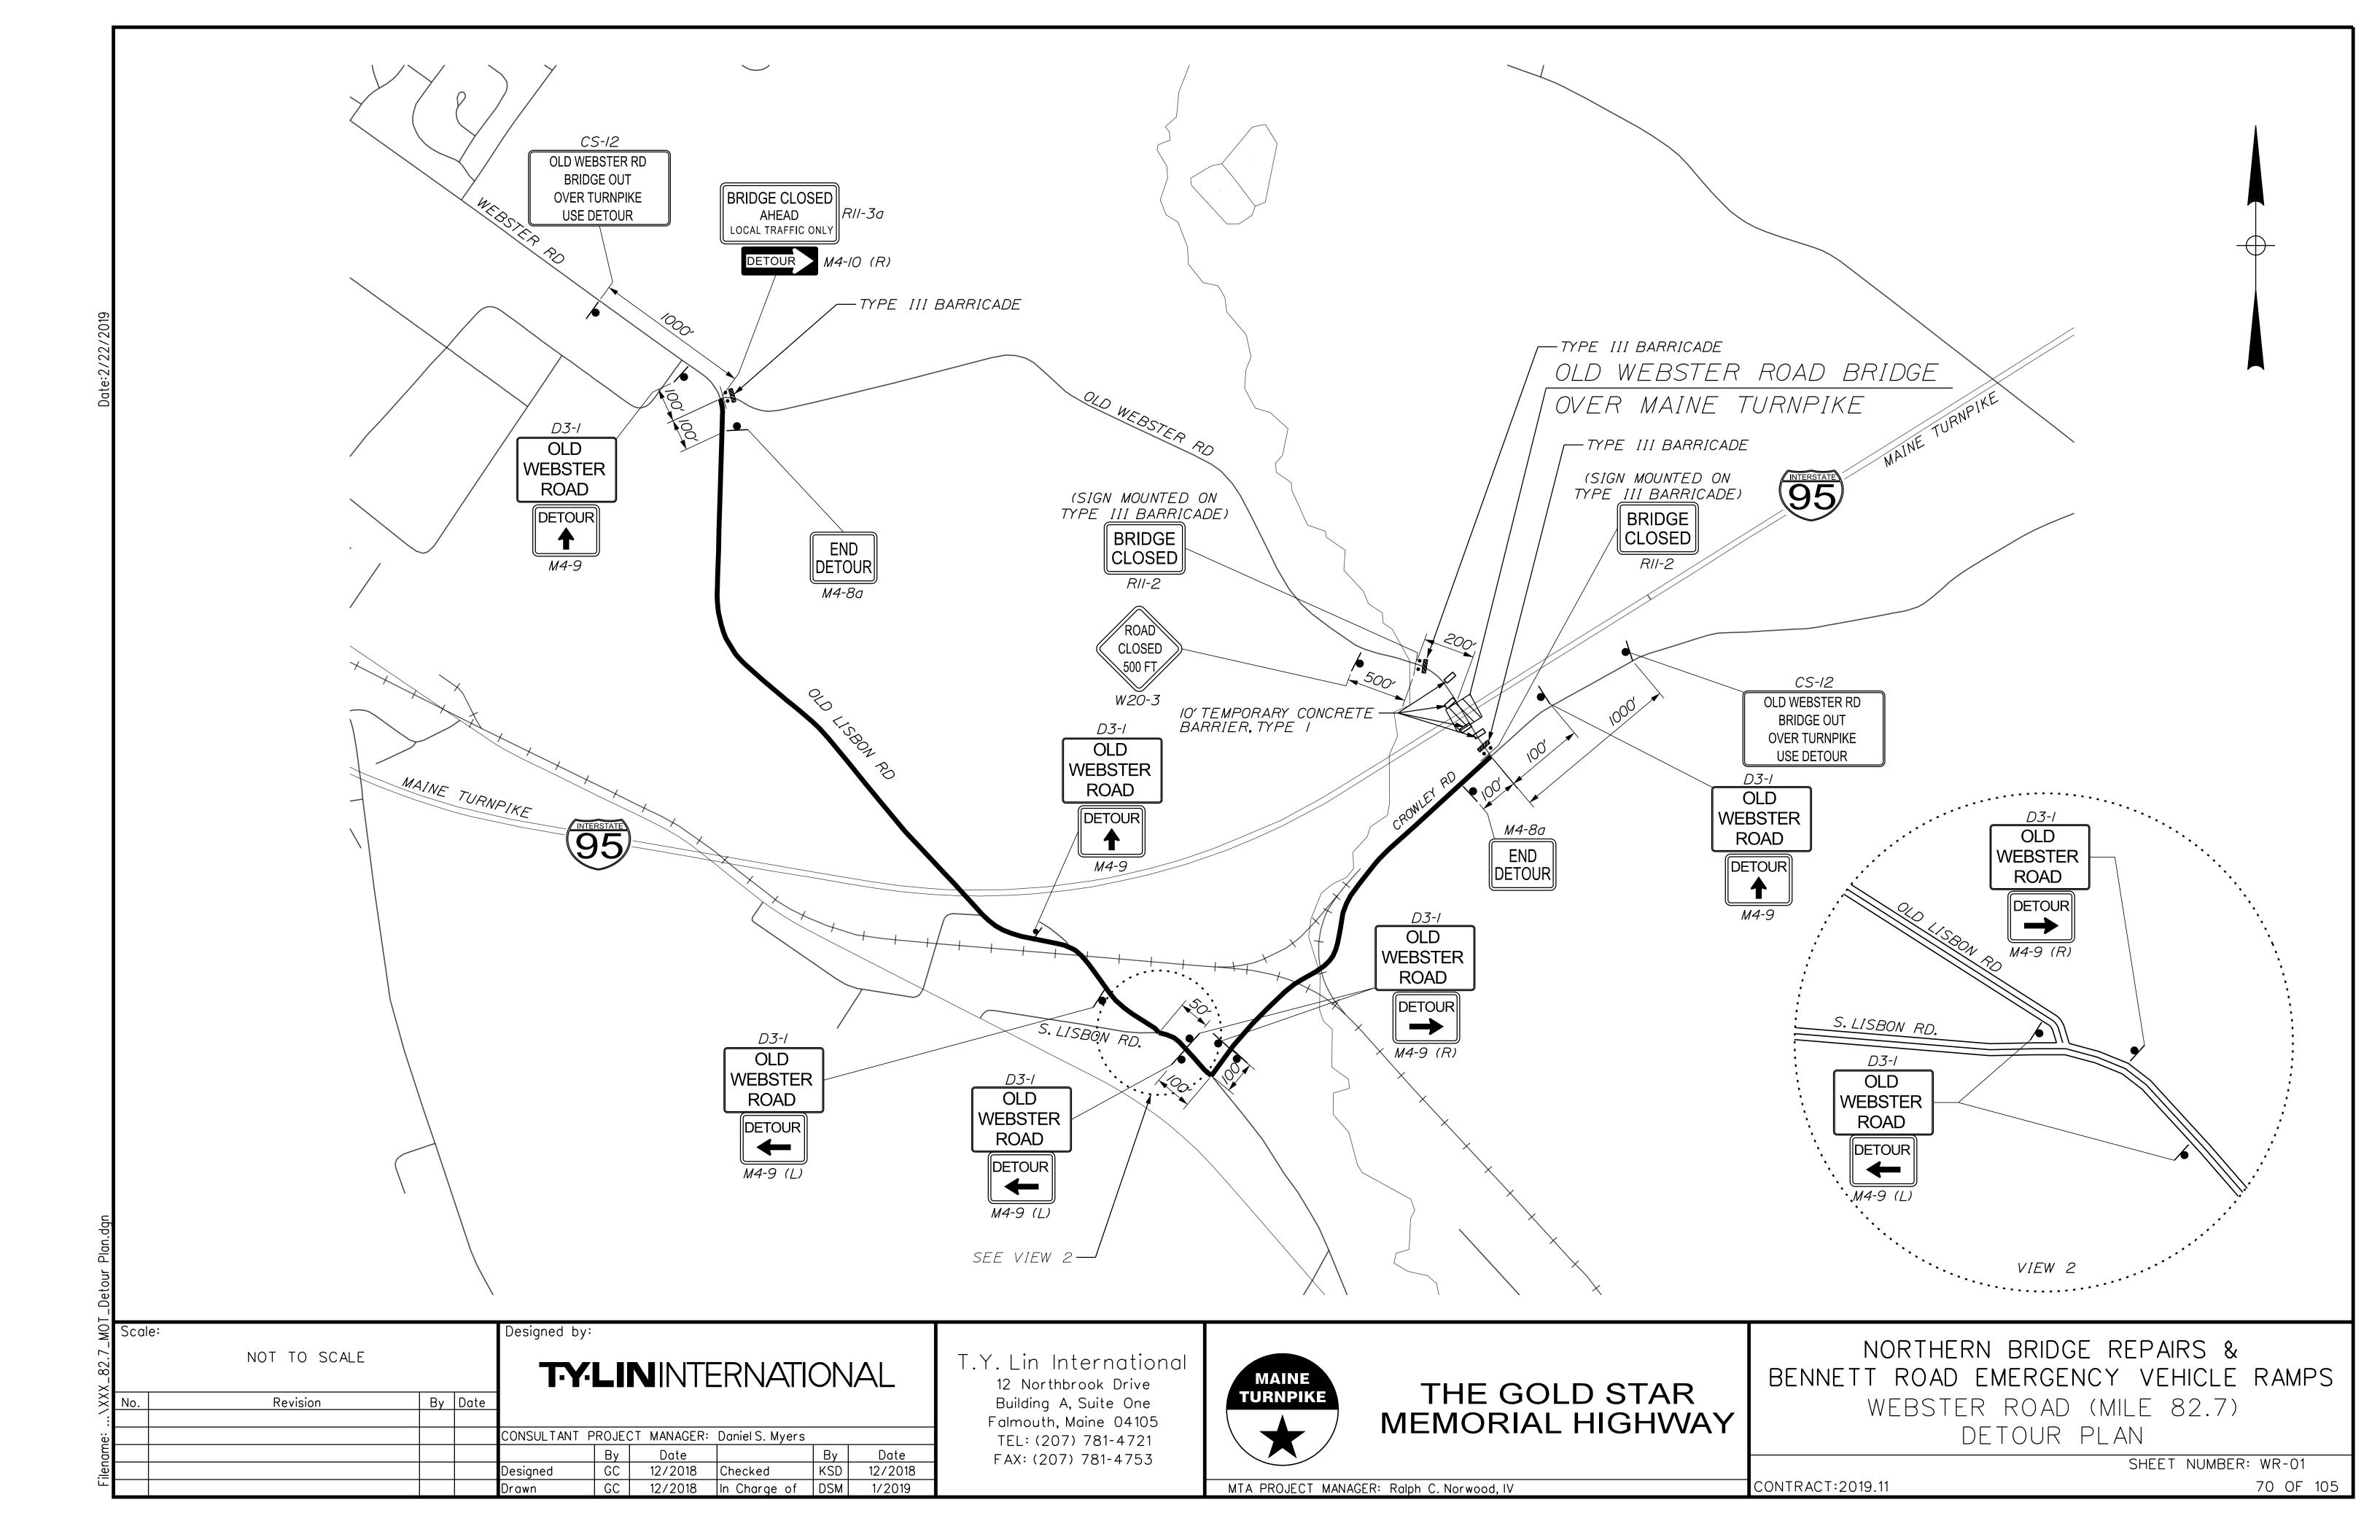

IDENTIEL	SIZE	OF		TFXT DI	MENSIONS	(INCHES)	NUMBER	COL	0R		4054 141	
IDENTIFI- CATION	SI	GN	TEXT	LETTER	VERTICAL		OF SIGNS	BACK-	LEGEND	BORDER RADIUS	AREA IN SQUARE	NOTES
NUMBER	WIDTH	HEIGHT		HEIGHT	SPACING	RTE. MKR.	REQUIRED	GROUND	BORDER		FEET	
CS-I	48"	48"	EXPECT STOPPED TRAFFIC	8C 8C 8C	4" 4"		4	ORANGE	BLACK		16.00 (64)	
CS-10	48"	48"	TRUCKS ENTERING	7C 7C	6"		2	ORANGE	BLACK		16.00 (32)	
CS-12	60"	36"	OLD WEBSTER RD  BRIDGE OUT  OVER TURNPIKE  USE DETOUR	5C 5C 5C 5C	3.5" 3" 3" 3" 3.5"		2	ORANGE	BLACK		/5.00 (30)	
D3-I (MOD)	36"	24"	OLD WEBSTER ROAD	5D 5D 5D	2.5" 2" 2" 2.5"		7	ORANGE	BLACK		6.00 (42)	
G20-2	36"	24"	END ROAD WORK	CONFOR	PIMENSIONS PM TO "STA NY SIGNS" -	NDARD	4	ORANGE	BLACK		6.00 (24)	
G20-5aP	48"	24"	WORK ZONE				4	ORANGE	BLACK		8.00 (32)	
M4-8A	24"	18"	END DETOUR				2	ORANGE	BLACK		3.00 (6)	
M4-9	30"	24"	DETOUR				3	ORANGE	BLACK		5.00 (15)	
M4-9L	<i>30</i> "	24"	DETOUR _				2	ORANGE	BLACK		5.00 (10)	
M4-9R	30"	24"	DETOUR				2	ORANGE	BLACK		5 <b>.</b> 00 (10)	
M4-IOR	48"	18"	DETOUR	▼	V	<b>∀</b>	l	ORANGE	BLACK		6.00 (6)	

IDENTIFI-	SIZE	. OF		TEX	T DI	MENSION	IS	(INCHES)	NUMBER	COL	.OR		AREA IN	
CATION NUMBER	SI	GN	TEXT	LETT HE I C		VERTIC			OF SIGNS	BACK- GROUND	LEGEND BORDER	<i>BORDER</i> <i>RADIUS</i>	SQUARE	NOTES
NOMBLA	WIDIA	HEIGHT							REQUIRED	GNOOND	BUNDLN		FEET	
R2-I	36"	48"	SPEED LIMIT 50	CO	NFOR	IMENSIC M TO "S Y SIGNS	TA		4	WHITE	BLACK		12.00 (48)	
R2-6aP	36"	24"	FINES DOUBLE						4	WHITE	BLACK		6.00 (24)	
R2-I2	36"	<i>54</i> "	END WORK ZONE SPEED LIMIT						4	WHITE	BLACK		13.50 (54)	
RII-2	48"	<i>30</i> "	BRIDGE CLOSED						2	WHITE	BLACK		10.00 (20)	
RII-3a	60"	30"	BRIDGE CLOSED AHEAD LOCAL TRAFFIC ONLY						/	WHITE	BLACK		12.50 (12.5)	
W3-4	48"	48"	BE PREPARED TO STOP						4	ORANGE	BLACK		16.00 (64)	
W3-5	48"	48"	SPEED LIMIT 50						4	ORANGE	BLACK		16 <b>.</b> 00 (64)	
W4-2 (LEFT) (RIGHT)	48" 48"	48" 48"		7	V	∇		V	4 4	ORANGE	BLACK		16.00 (64) (64)	

CONTRACT:2019.11

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:   <u>:</u>					CONSULTANT F	ROJEC	CT MANAGER:	Daniel S. Myers				
аш						Ву	Date		Ву	Date		
r llename:					Designed	TWA	1/2019	Checked	PJB	1/2019		
_					Drawn	TWA	1/2019	In Charge of	DSM	1/2019		

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### THE GOLD STAR MEMORIAL HIGHWAY

NORTHERN BRIDGE REPAIRS & BENNETT ROAD EMERGENCY VEHICLE RAMPS


WEBSTER ROAD (MILE 82.7) M.O.T. SIGN SUMMARY 1 OF 2


SHEET NUMBER: WR-02

MTA PROJECT MANAGER: Ralph C. Norwood, IV


IDENTIFI-		OF	TOUT		MENSIONS	(INCHES)	NUMBER	COL		<i>BORDER</i>	AREA IN	
CATION NUMBER		GN HE IGHT	TEXT	LETTER HEIGHT	VERTICAL SPACING	(INCHES)  ARROW RTE. MKR.	SIGNS REQUIRED	BACK- GROUND	LEGEND BORDER	RADIUS	SQUARE FEET	NOTES
W8-/	48"	48"	BUMP	CONFOR	DIMENSIONS RM TO "STA AY SIGNS" -	ANDARD	4	ORANGE	BLACK		16.00 (64)	
W8-24a	48"	48"	RUMBLE STRIPS AHEAD				4	ORANGE	BLACK		16.00 (64)	
WI6-4P	36"	<i>30</i> "	NEXT 1000 FEET				4	ORANGE	BLACK		7 <b>.</b> 50 (30)	
W20-1 (I MILE) (AHEAD)	48" 48"	48" 48"	ROAD WORK 1 MILE				4 4	ORANGE	BLACK		16.00 (64) (64)	
W20-3 (500)	36"	36"	ROAD CLOSED XXXX FT				/	ORANGE	BLACK		9 <b>.</b> 00 (9)	
W20-5 (LEFT) (RIGHT)	48"	48"	LEFT LANE CLOSED 1/2 MILE				4 4	ORANGE	BLACK		16.00 (64) (64)	
W2I-5	48"	48"	SHOULDER	V	V	V	2	ORANGE	BLACK		16.00 (32)	

IDENTIFI-	SIZE	OF		TEXT DI	MENSIONS	(INCHES)	NUMBER	COL	.OR	000050	AREA IN	
CATION NUMBER	SIO WIDTH	GN HEIGHT	TEXT	LETTER HEIGHT	VERTICAL SPACING		OF SIGNS REQUIRED	BACK- GROUND	LEGEND BORDER	BORDER RADIUS	SQUARE FEET	NOTES
W2I-5aR (LEFT) (RIGHT)	48"	48"	LEFT SHOULDER CLOSED	CONFOR	PIMENSIONS RM TO "STA NY SIGNS" -	NDARD	2 2	ORANGE	BLACK		16.00 (32) (32)	
W2I-5bR (LEFT) (RIGHT)	48"	48"	RIGHT SHOULDER CLOSED 1000 FT	<b>∀</b>	. ↓	V	2 2	ORANGE	BLACK		16.00 (32) (32)	

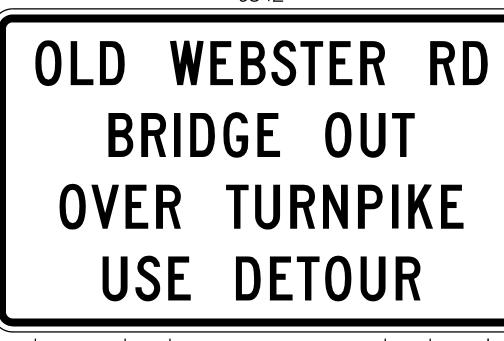

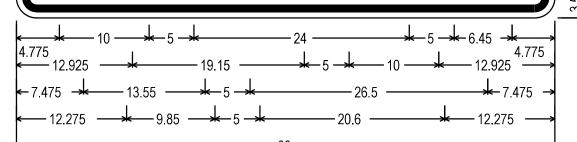

2.250" Radius, 0.875" Border, 0.625" Indent, Black on Orange; [OLD WEBSTER RD] Black C 2K; [BRIDGE OUT] Black C 2K; [OVER TURNPIKE] Black C 2K; [USE DETOUR] Black C 2K;

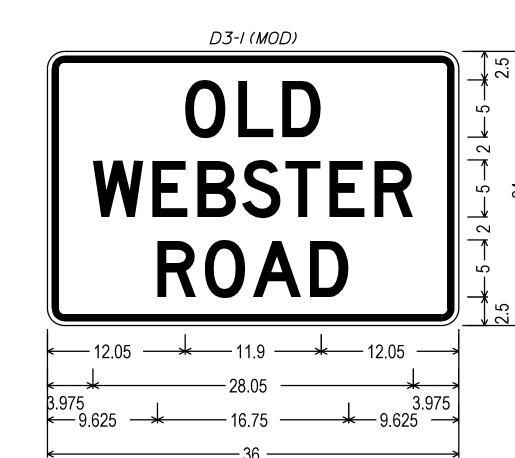

1.500" Radius, 0.625" Border, 0.375" Indent, Black on Orange; [OLD] Black D 2K; [WEBSTER] Black D 2K; [ROAD] Black D 2K;

CONTRACT:2019.11

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					CONSULTANT I	PROJEC	CT MANAGER:	Daniel S. Myers		
						Ву	Date		Ву	Date
					Designed	TWA	1/2019	Checked	PJB	1/2019
					Drawn	TWA	1/2019	In Charge of	DSM	1/2019

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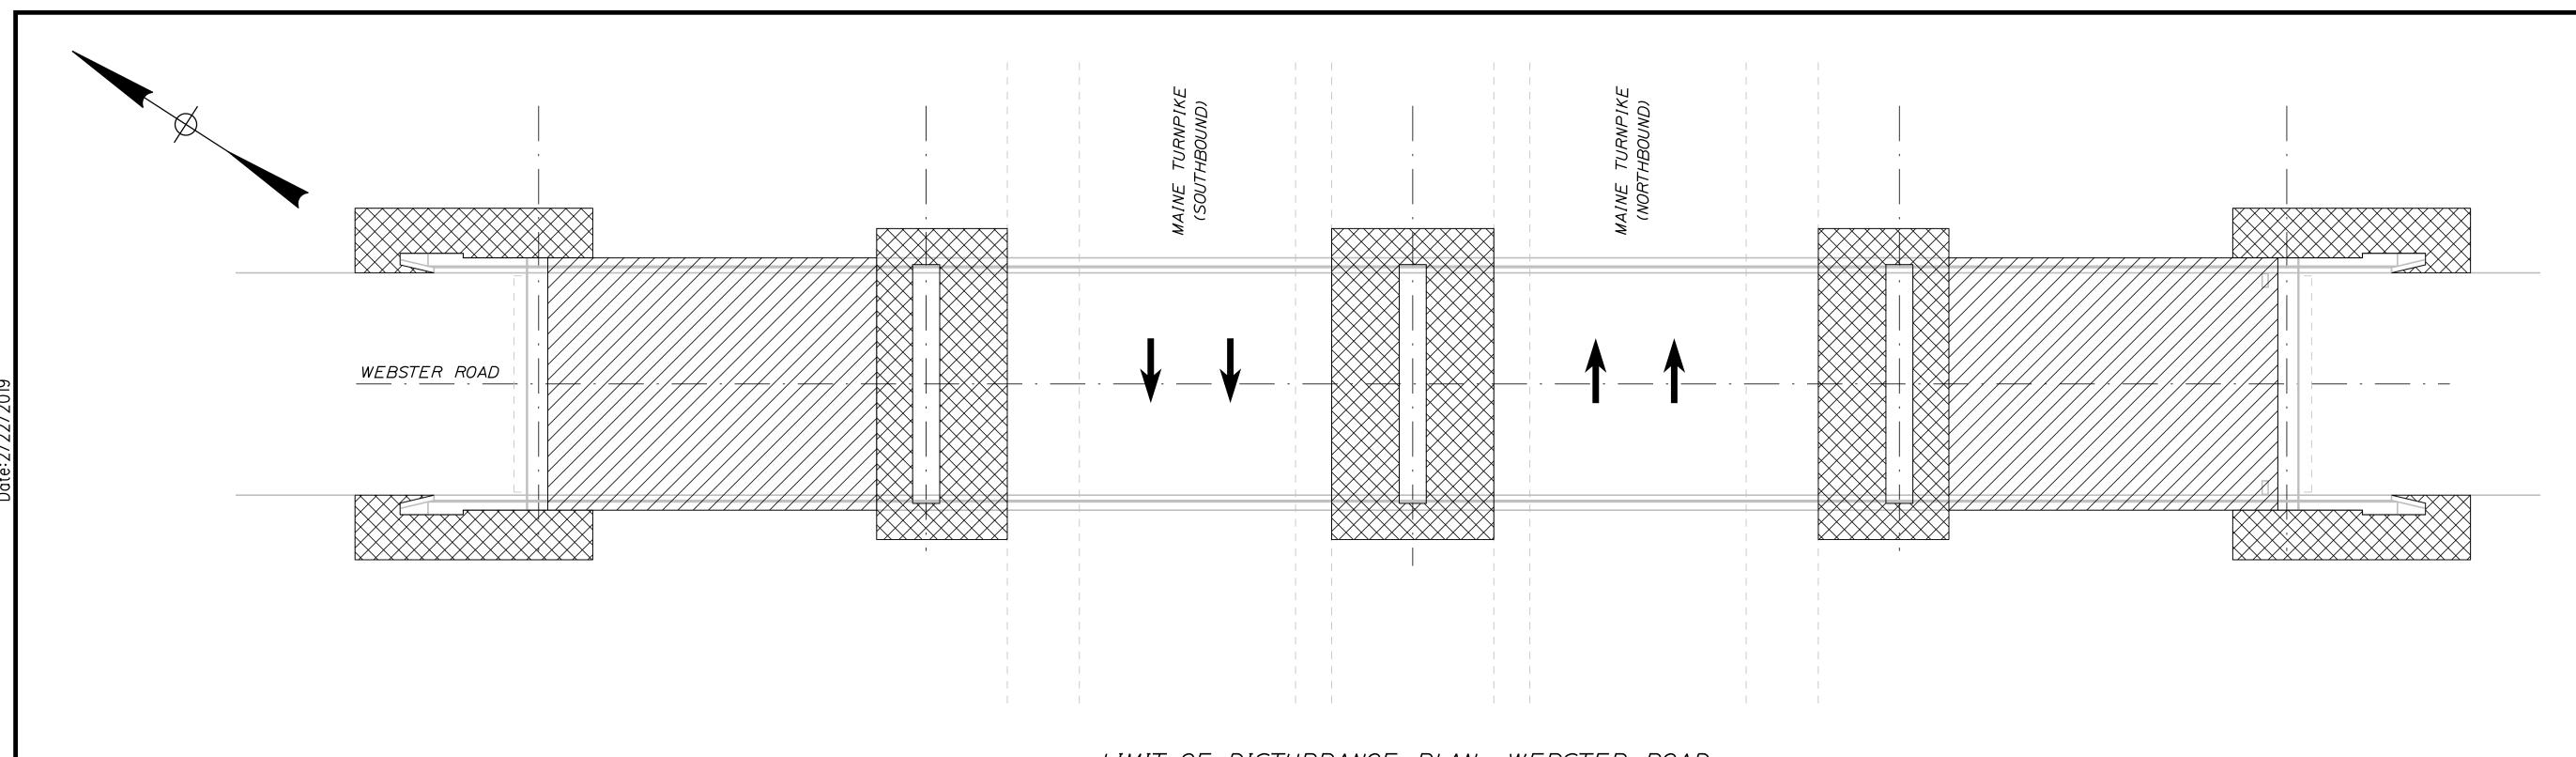
THE GOLD STAR MEMORIAL HIGHWAY

NORTHERN BRIDGE REPAIRS & BENNETT ROAD EMERGENCY VEHICLE RAMPS

> WEBSTER ROAD (MILE 82.7) M.O.T. SIGN SUMMARY 2 OF 2

SHEET NUMBER: WR-03

MTA PROJECT MANAGER: Ralph C. Norwood, IV



LIMIT OF DISTURBANCE PLAN - WEBSTER ROAD

#### LEGEND:

CONTRACT LIMIT OF DISTURBANCE

CONTRACTOR'S LIMIT OF DISTURBANCE
AREA FOR ACCESS AND STORAGE

# AREAS:

CONTRACT LIMIT OF DISTURBANCE:

WEBSTER ROAD = 0.05 ACRES

CONTRACTOR'S LIMIT OF DISTURBANCE AREA FOR ACCESS AND STORAGE:

WEBSTER ROAD = 0.05 ACRES

#### NOTES:

- I. EROSION AND SEDIMENT CONTROL DEVICES REQUIRED FOR THE CONTRACTOR'S ACCESS LOCATIONS AND STORAGE AREAS WILL NOT BE MEASURED FOR PAYMENT.
- 2. THE CONTRACTOR WILL BE ALLOWED TO STORE MATERIAL AND EQUIPMENT ON GRAVEL AND PAVEMENT WITHIN THE CLOSED PORTIONS OF WEBSTER ROAD. THESE AREAS ARE EITHER INCLUDED IN THE LIMITS OF DISTURBANCE OR HAVE BEEN PREVIOUSLY SURFACED AND DO NOT ADD TO THE LIMITS OF DISTURBANCE.
- 3. SEE SPECIFICATIONS FOR CONTRACTOR'S SUBMITTAL REQUIREMENTS IF INCREASING THE LIMITS OF DISTURBANCE TO THE PROJECT ESTIMATED QUANTITIES.

#### Scale: Designed by: T-Y-LININTERNATIONAL By Date Revision CONSULTANT PROJECT MANAGER: DanielS. Myers By TSK By Date Date 1/2019 TSK 1/2019 Checked Designed In Charge of DSM 1/2019 1/2019

T.Y. Lin International
12 Northbrook Drive
Building A, Suite One
Falmouth, Maine 04105
TEL: (207) 781-4721
FAX: (207) 781-4753



THE GOLD STAR MEMORIAL HIGHWAY

NORTHERN BRIDGE REPAIRS & BENNETT ROAD EMERGENCY VEHICLE RAMPS


WEBSTER ROAD (MILE 82.7) LIMIT OF DISTURBANCE


SHEET NUMBER: WR-04

MTA PROJECT MANAGER: Ralph C. Norwood, IV

73 OF 105

CONTRACT:2019.11

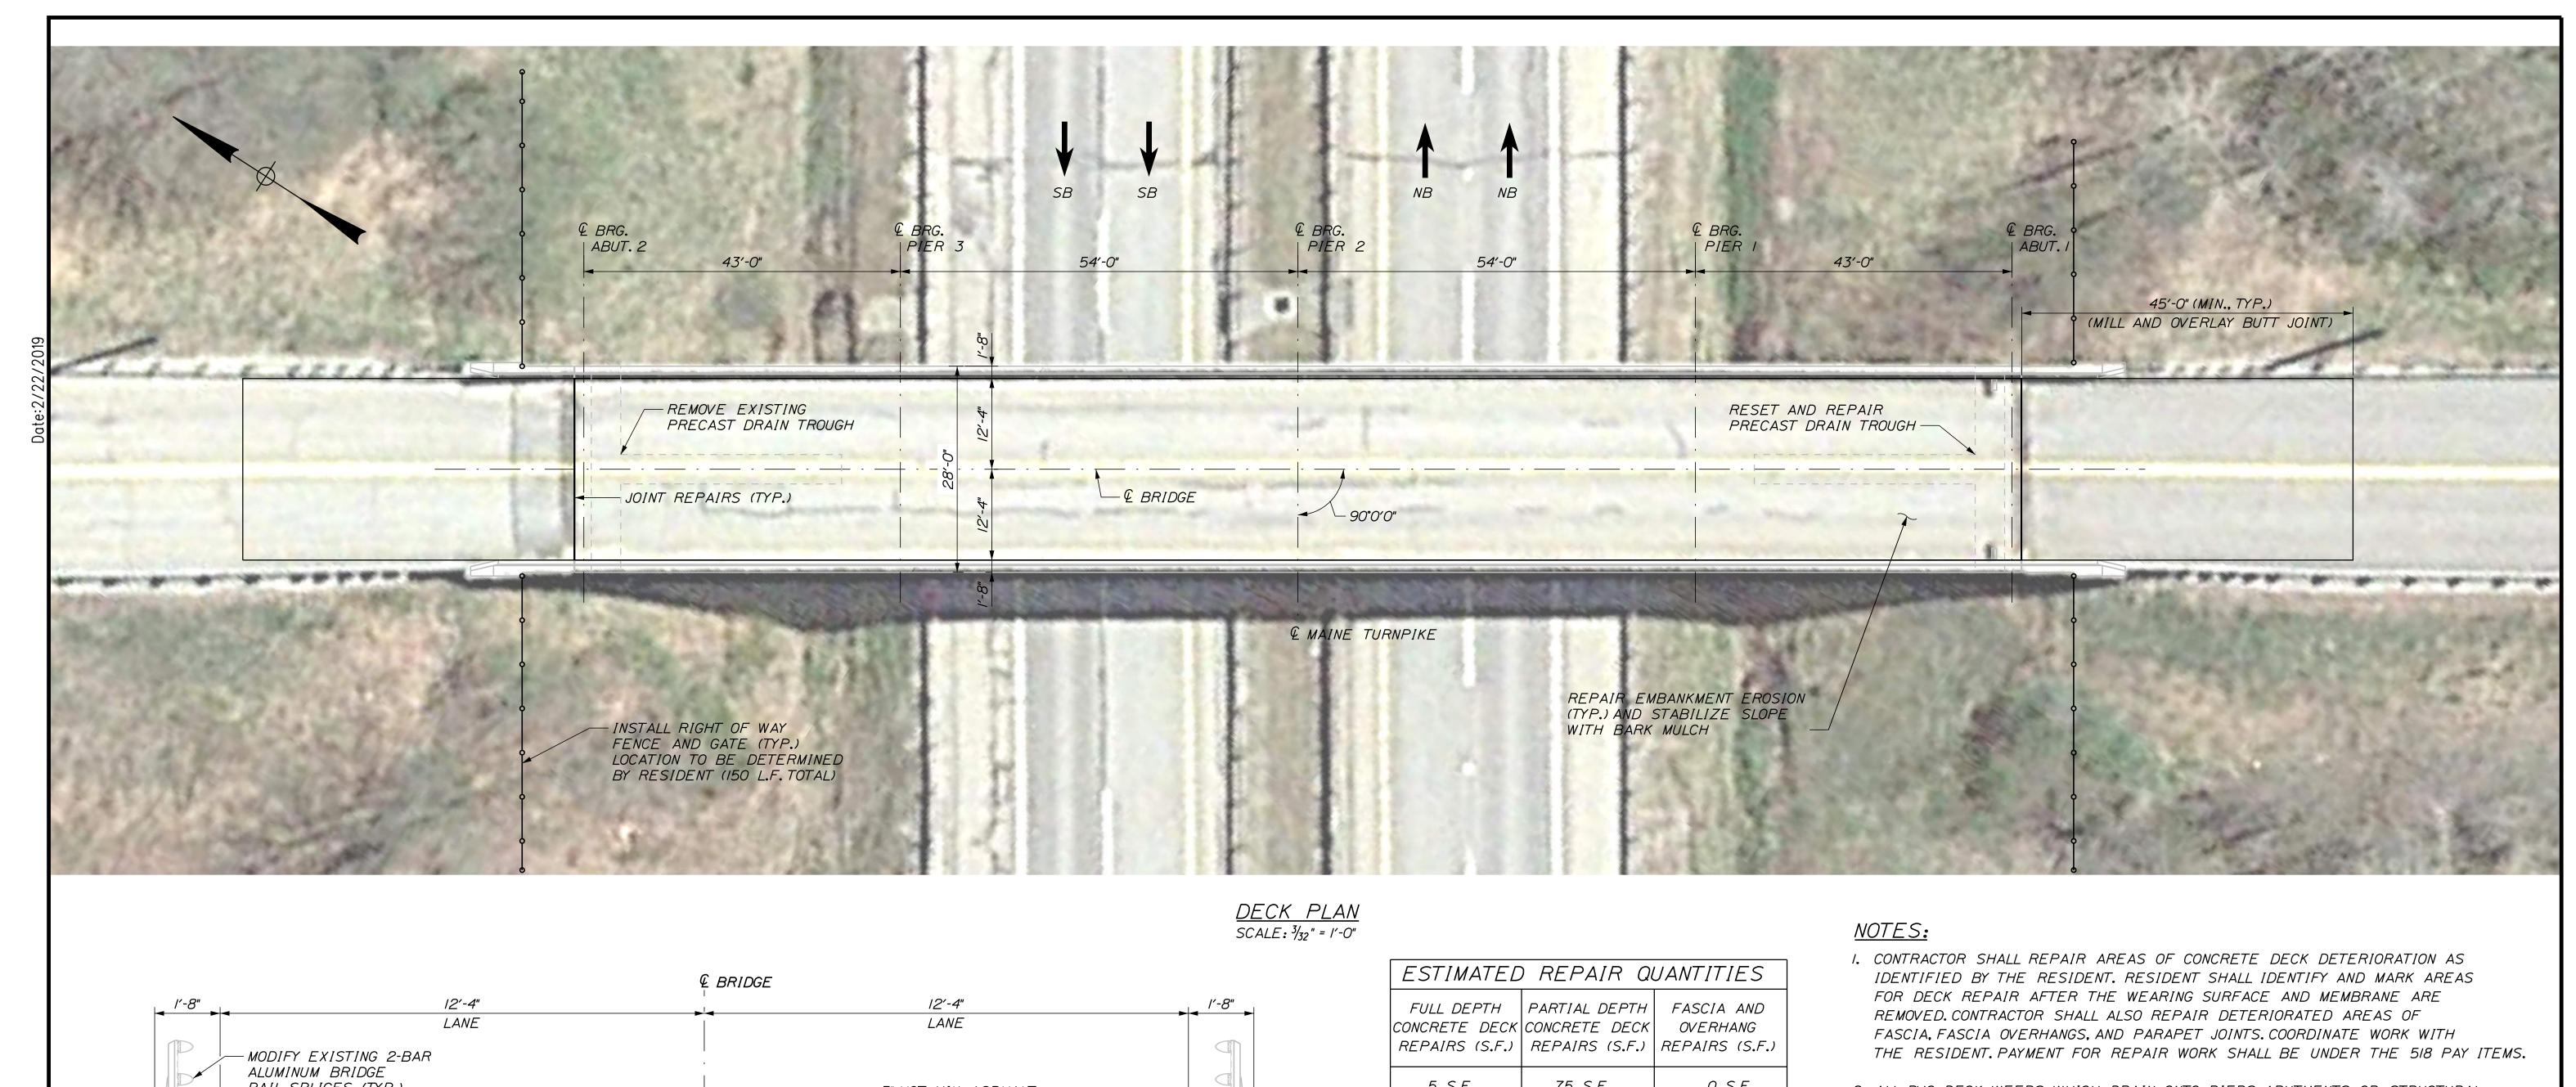

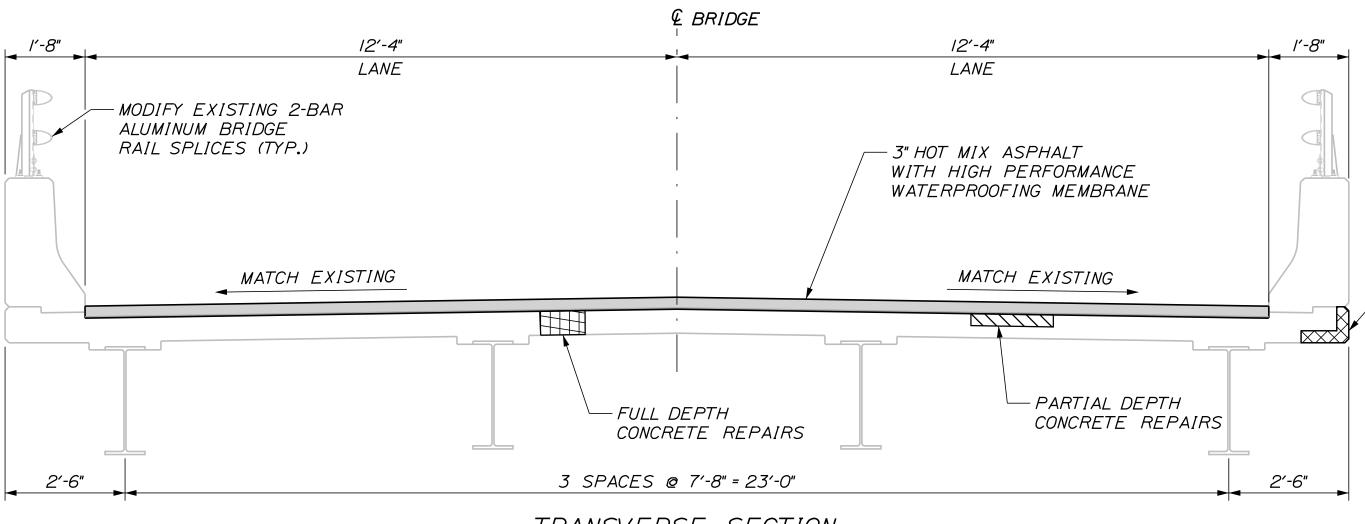

TRANSVERSE SECTION SCALE: 1/2" = 1'-0"

Checked

In Charge of DSM

DSM 12/2018

1/2019

DSM 10/2018

10/2018

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FULL DEPTH	PARTIAL DEPTH	FASCIA AND	
	CONCRETE DECK	l	
REPAIRS (S.F.)	REPAIRS (S.F.)	REPAIRS (S.F.)	
5 S.F.	75 S.F.	0 S.F.	

FASCIA AND OVERHANG REPAIRS

#### LEGEND:

LIMITS OF FULL DEPTH CONCRETE REPAIR (REPAIR AREAS TO BE FIELD VERIFIED)

LIMITS OF PARTIAL DEPTH CONCRETE DECK REPAIRS (REPAIR AREAS TO BE FIELD VERIFIED)


LIMITS OF FASCIA AND OVERHANG REPAIRS (REPAIR AREAS TO BE FIELD VERIFIED)

- 2. ALL PVC DECK WEEPS WHICH DRAIN ONTO PIERS, ABUTMENTS OR STRUCTURAL STEEL SHALL BE EXTENDED AND DIVERTED AWAY FROM BRIDGE COMPONENTS BELOW DECK, AND SHALL EXTEND IFT BELOW BOTTOM FLANGE, AS DIRECTED BY THE RESIDENT. PAYMENT SHALL BE BY THE VARIOUS LABOR AND EQUIPMENT ITEMS. SEE DETAIL SHEET "MISCELLANEOUS DETAILS SHEET I OF 3 & MISCELLANEOUS DETAILS SHEET 2 OF 3.
- 3. FOR WORK REQUIRED AT DRAIN TROUGHS, SEE SHEET "MISCELLANEOUS DETAILS SHEET I OF 3".
- 4. A BEAD OF HOT-APPLIED RUBBERIZED ASPHALT SEALER SHALL BE APPLIED ALONG CURB LINES AFTER INSTALLATION OF BASE COURSE. PAYMENT SHALL NOT BE MADE DIRECTLY BUT SHALL BE CONSIDERED INCIDENTAL TO RELATED CONTRACT ITEMS.

#### Scale: Designed by: T-Y-LININTERNATIONAL By Date Revision CONSULTANT PROJECT MANAGER: DanielS. Myers By Date

Designed

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THE GOLD STAR MEMORIAL HIGHWAY

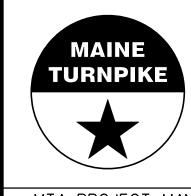
NORTHERN BRIDGE REPAIRS & BENNETT ROAD EMERGENCY VEHICLE RAMPS WEBSTER ROAD (MILE 82.7) DECK PLAN & SECTION


SHEET NUMBER: WR-05

CONTRACT:2019.11

74 OF 105


MTA PROJECT MANAGER: Ralph C. Norwood, IV

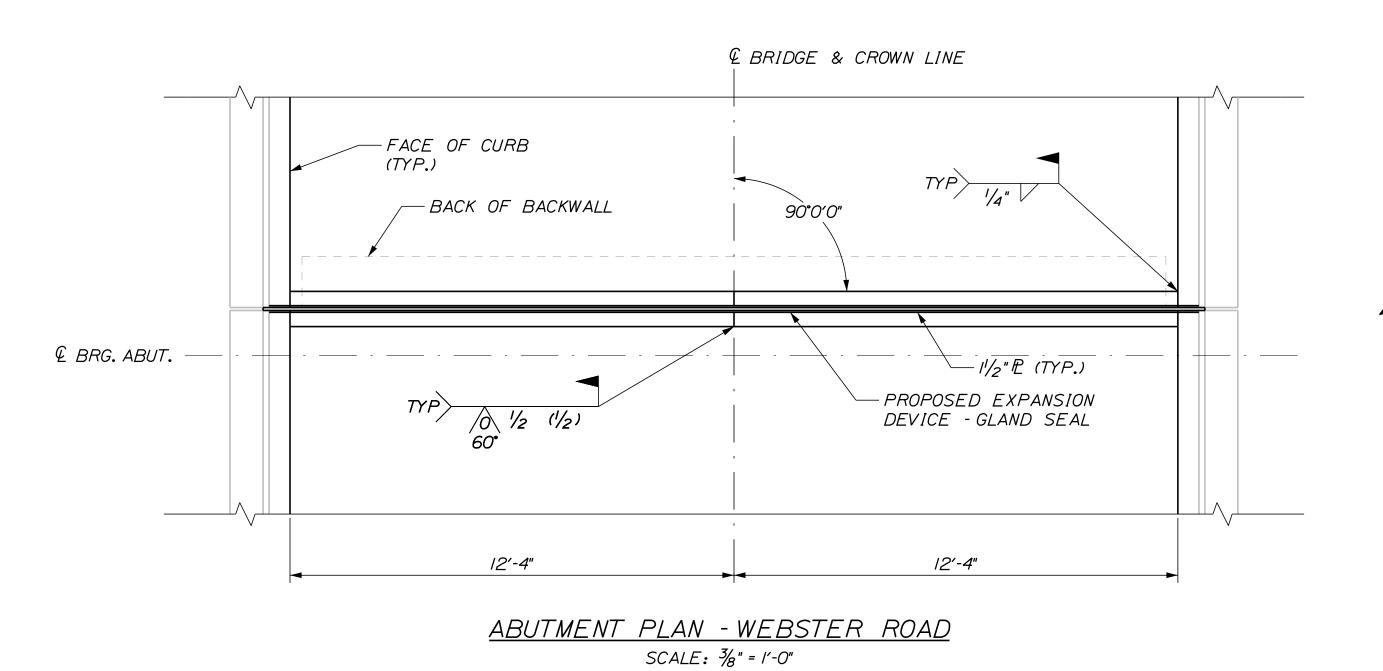

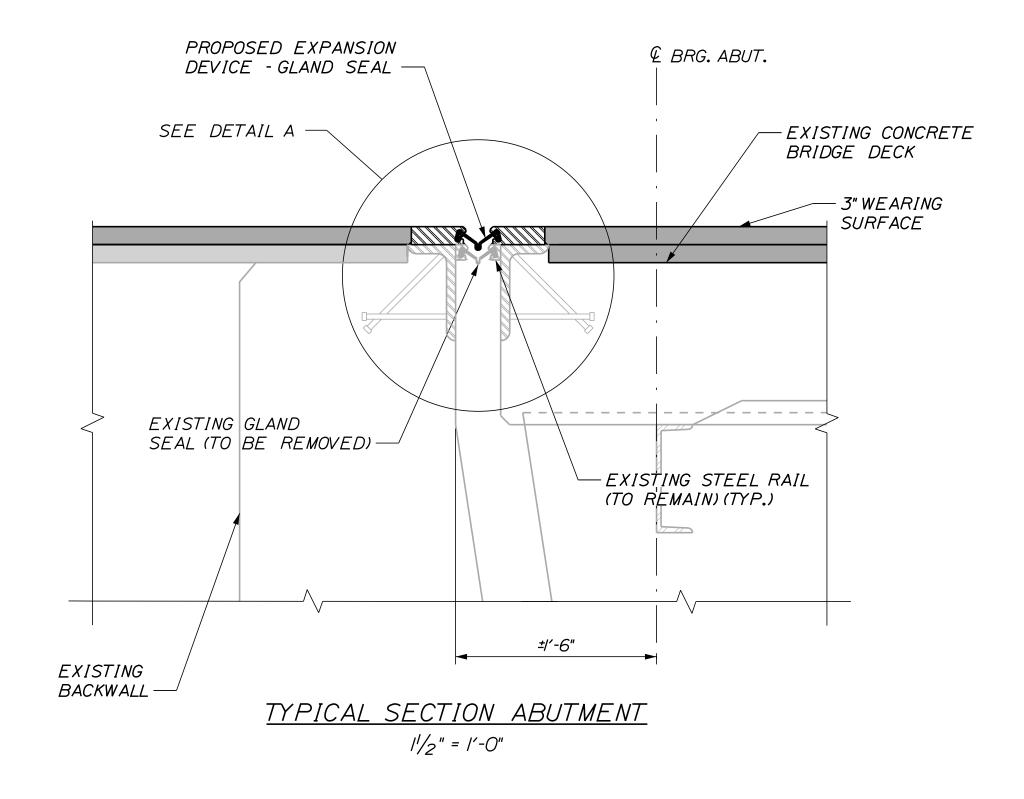

#### EXPANSION JOINT NOTES:

- I. ALL STEEL COMPONENTS SHALL BE AASHTO M270 GRADE 36, UNLESS OTHERWISE NOTED.
- 2. CONTRACTOR SHALL FIELD MEASURE EXISTING CURB PLATE AND JOINT DIMENSIONS PRIOR TO DEVELOPMENT OF SHOP DRAWINGS.
- 3. EXPANSION JOINT MODIFICATIONS AT EACH ABUTMENT SHALL BE PAID UNDER ITEM 520.2211, EXPANSION DEVICE MODIFICATIONS.

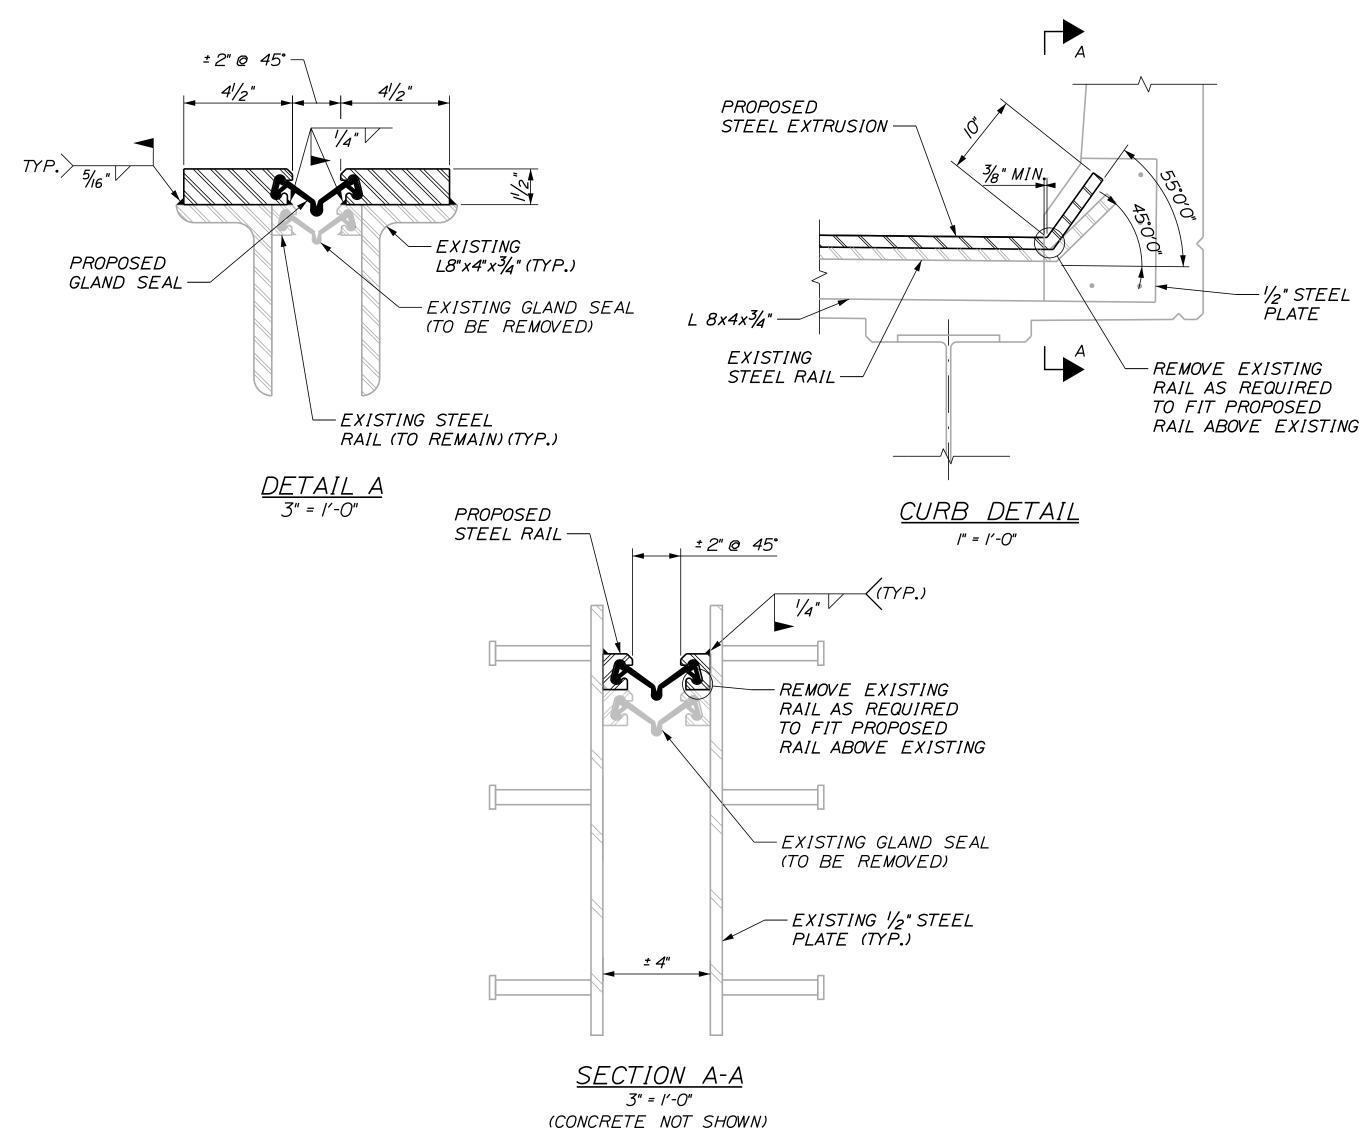

CONTRACT:2019.11

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					CONSULTANT F	PROJEC	T MANAGER:	Daniel S. Myers		
am						Ву	Date		Ву	Date
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ш.					Drawn	PEM	9/2018	In Charge of	DSM	1/2019

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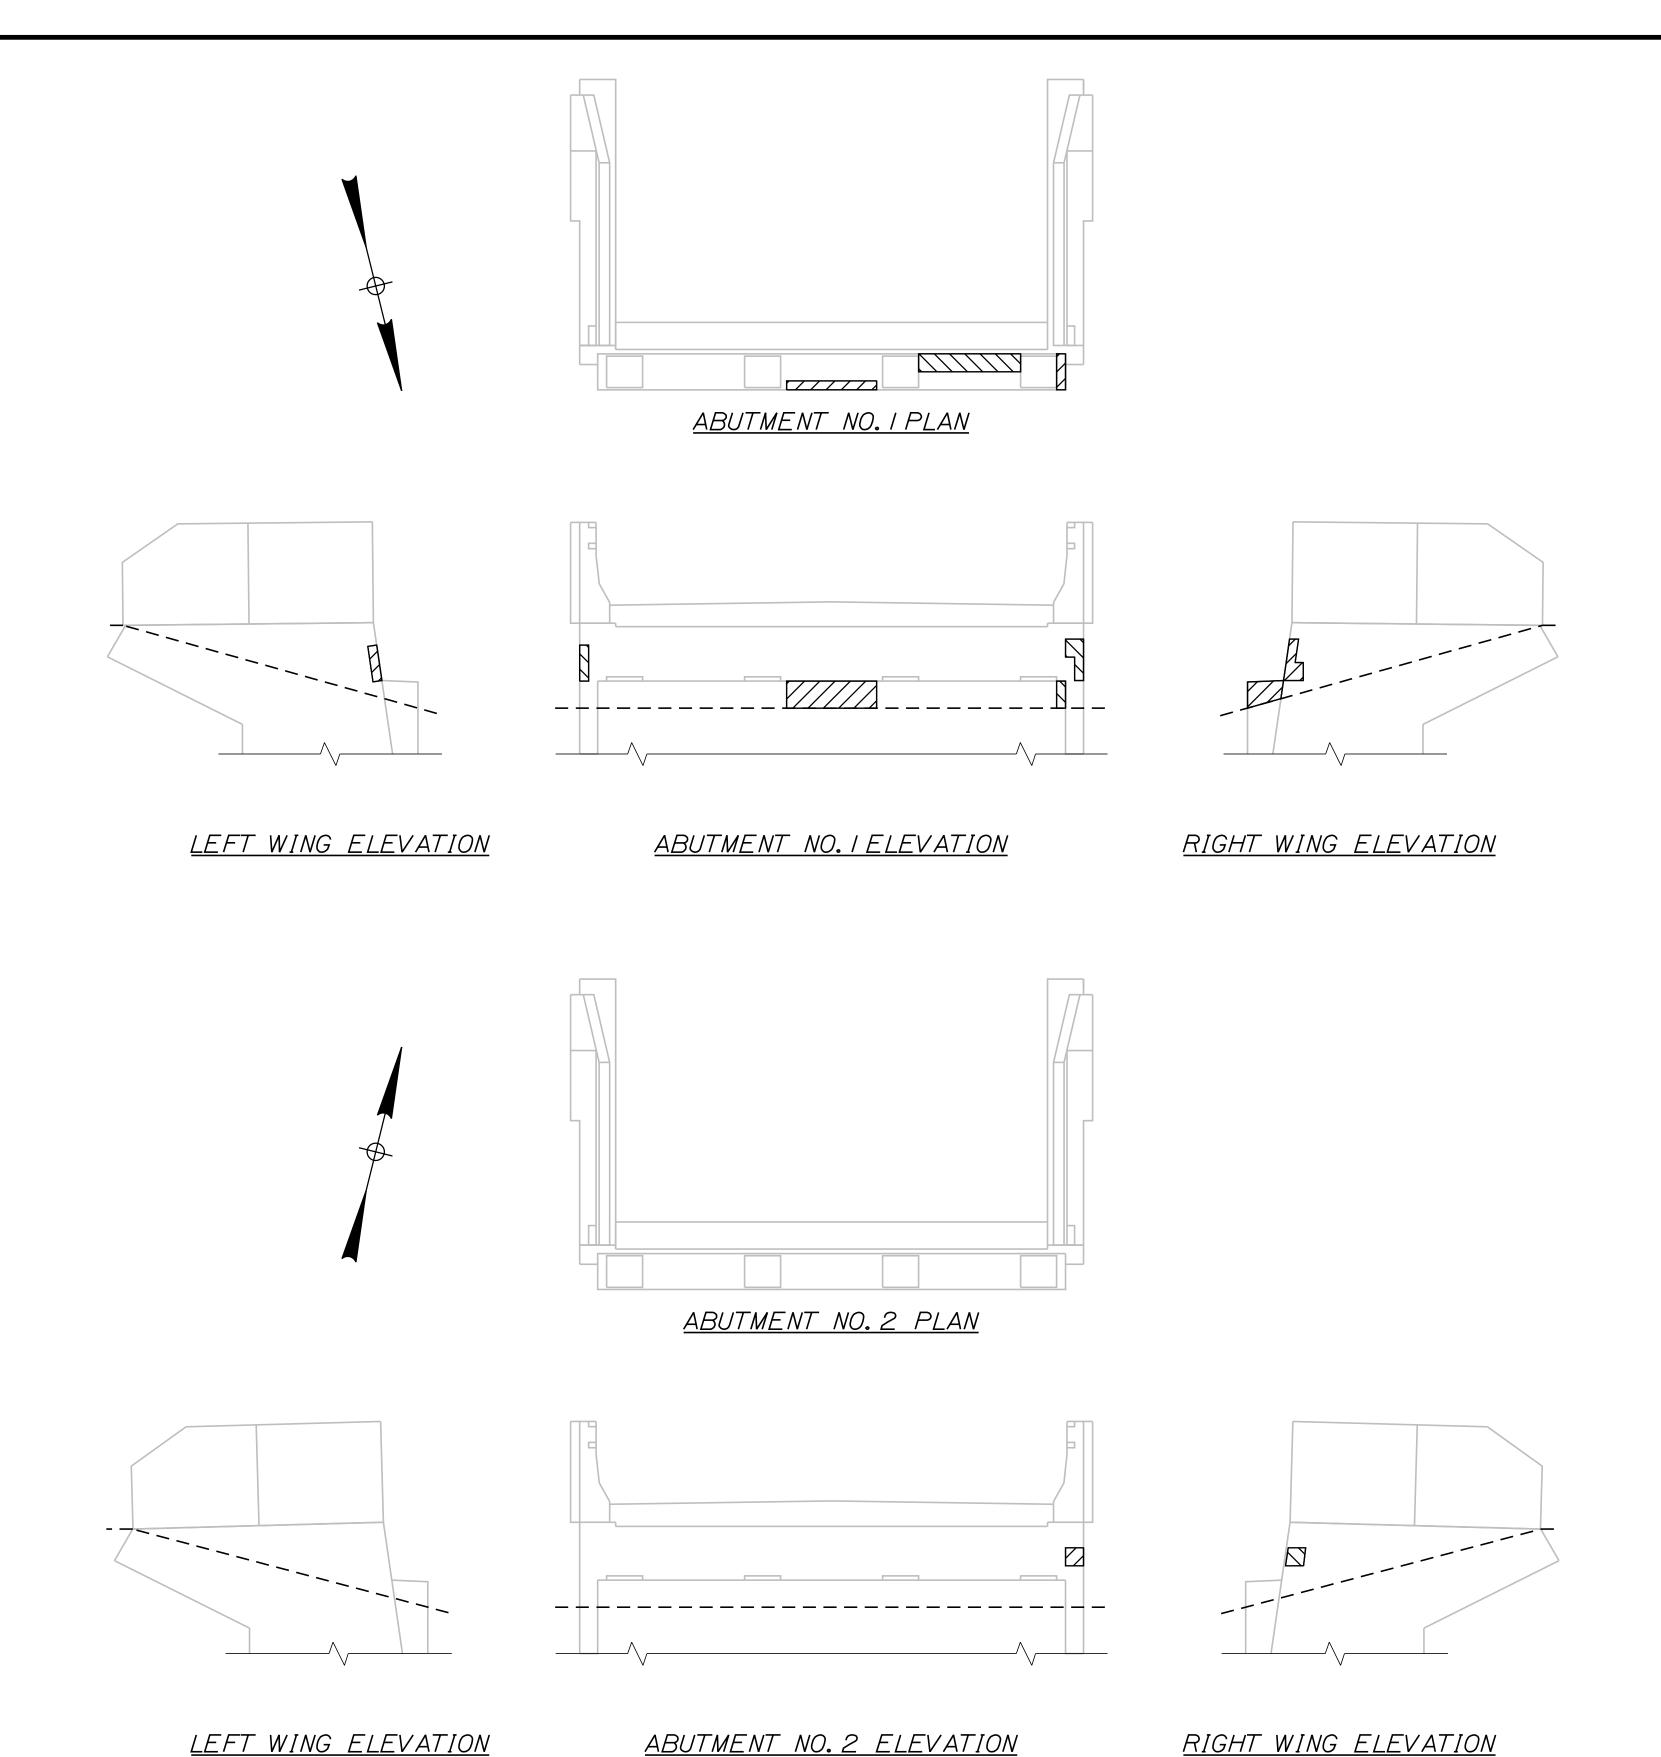
THE GOLD STAR MEMORIAL HIGHWAY

NORTHERN BRIDGE REPAIRS & BENNETT ROAD EMERGENCY VEHICLE RAMPS WEBSTER ROAD (MILE 82.7)

JOINT REPAIRS

SHEET NUMBER: WR-06 75 OF 105

MTA PROJECT MANAGER: Ralph C. Norwood, IV



OLD WEBSTER ROAD (MILE 82.7) ABUTMENTS ESTIMATED QUANTITY OF REPAIRS ABUT. NO. 1 ABUT. NO. 2 TOTAL 26 S.F. 35 S.F. ABUTMENT REPAIRS 9 S.F.

#### NOTES:

I. FOR PROCEDURAL NOTES SEE SHEET "BRIDGE GENERAL NOTES"


#### LEGEND:

LIMIT OF CONCRETE SURFACE REPAIRS

✓✓ LIMIT OF EPOXY INJECTED CRACK REPAIR

—— EXISTING CONCRETE

--- EXISTING AND PROPOSED GROUND

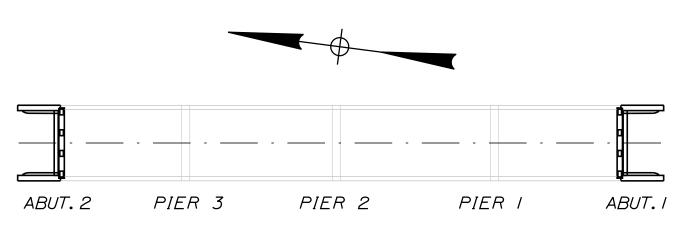

LOCATION PLAN

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5		_				Ву	Date		Ву	Date
٥					Designed	JJL	11/2018	Checked	BLT	11/2018

ACP 6/2018 In Charge of DSM 1/2019

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THE GOLD STAR MEMORIAL HIGHWAY


NORTHERN BRIDGE REPAIRS & BENNETT ROAD EMERGENCY VEHICLE RAMPS

WEBSTER ROAD (MILE 82.7) SUBSTRUCTURE REPAIRS - 1 OF 3

SHEET NUMBER: WR-07

CONTRACT:2019.11

MTA PROJECT MANAGER: Ralph C. Norwood, IV

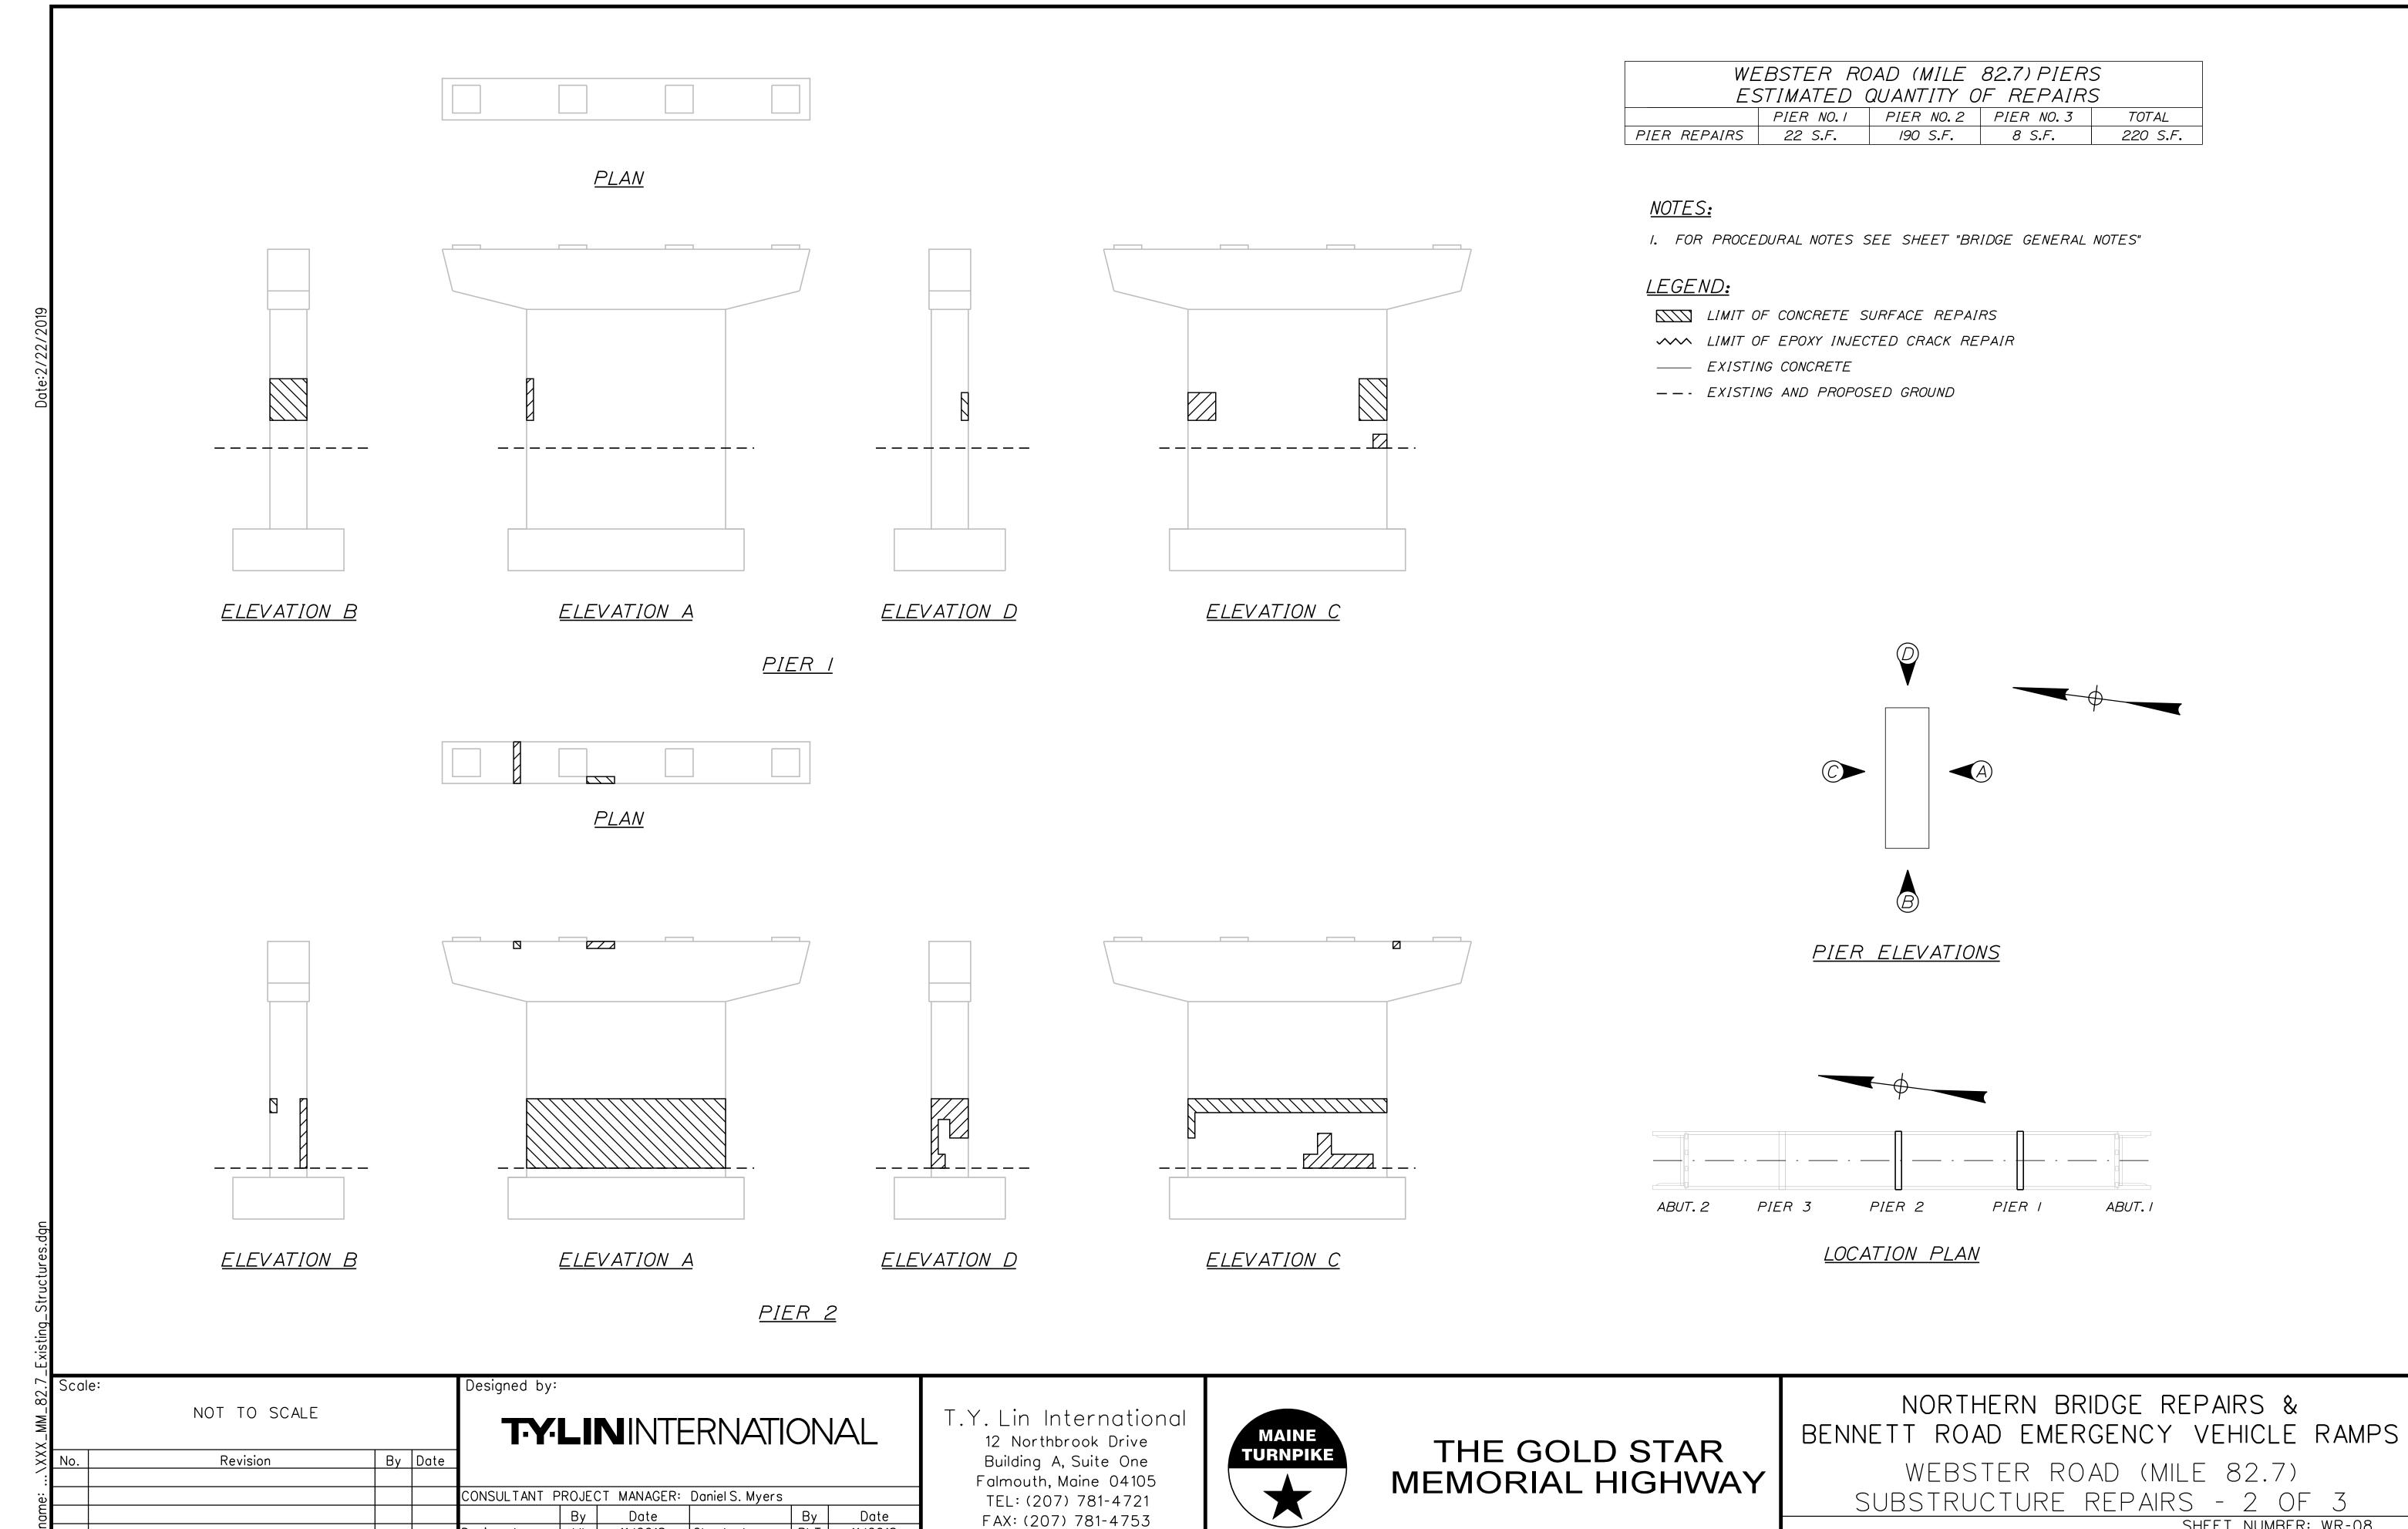

BLT 11/2018

JJL 11/2018

6/2018

Designed

Checked

In Charge of DSM

SHEET NUMBER: WR-08

MTA PROJECT MANAGER: Ralph C. Norwood, IV

CONTRACT:2019.11

2. FOR QUANTITY SEE "(MILE 82.7) SUBSTRUCTURE REPAIRS 2 OF 3"


#### LEGEND:


LIMIT OF CONCRETE SURFACE REPAIRS

VV LIMIT OF EPOXY INJECTED CRACK REPAIR


—— EXISTING CONCRETE

--- EXISTING AND PROPOSED GROUND

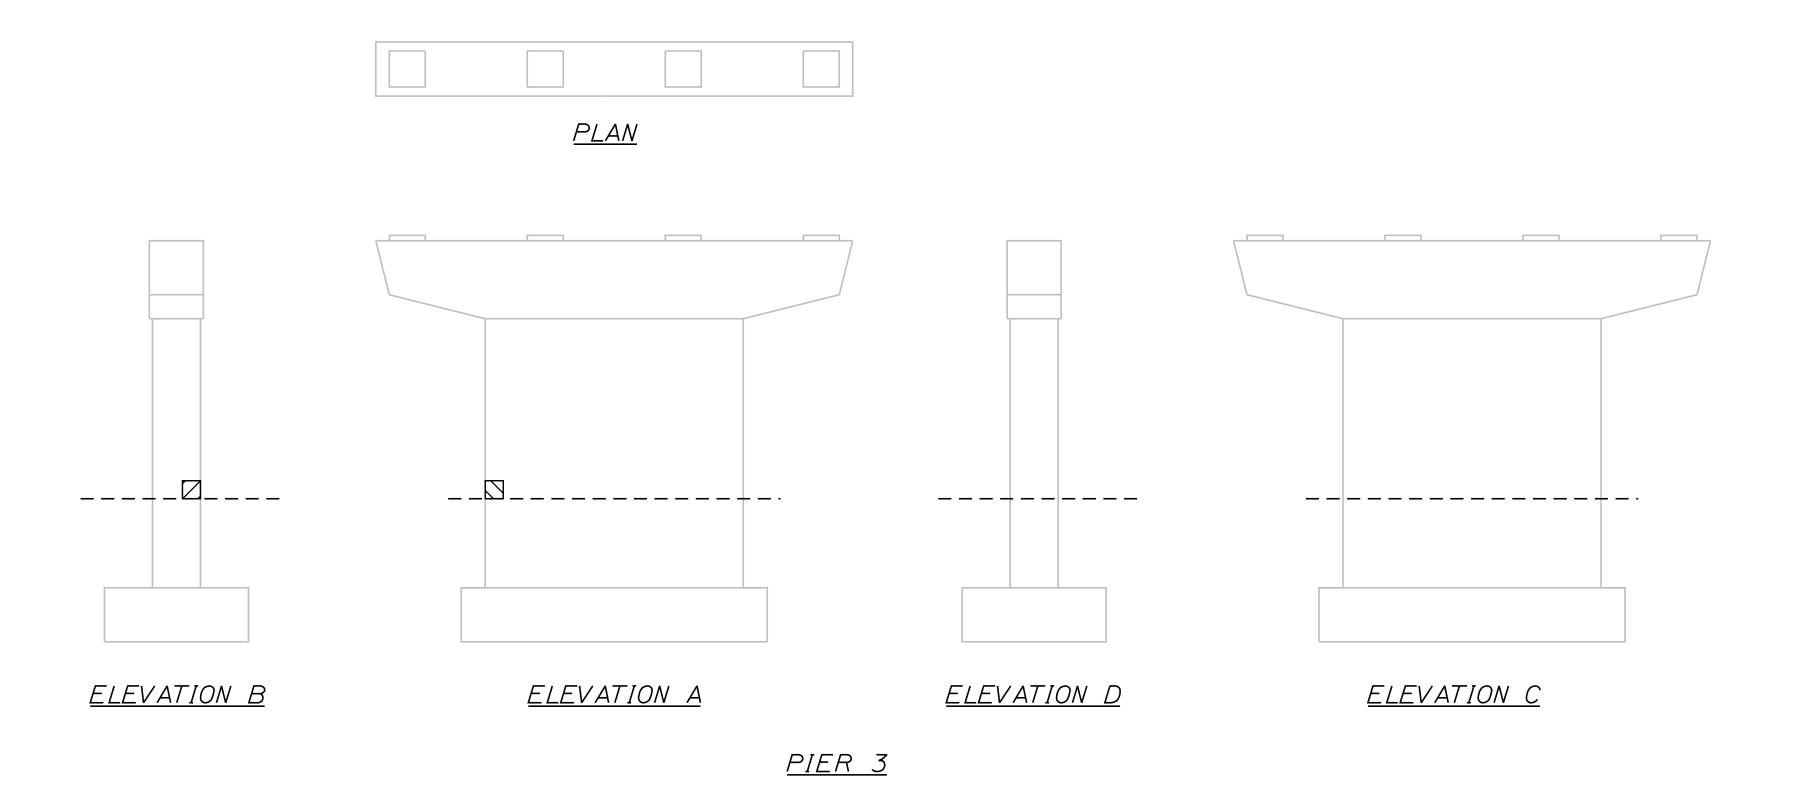

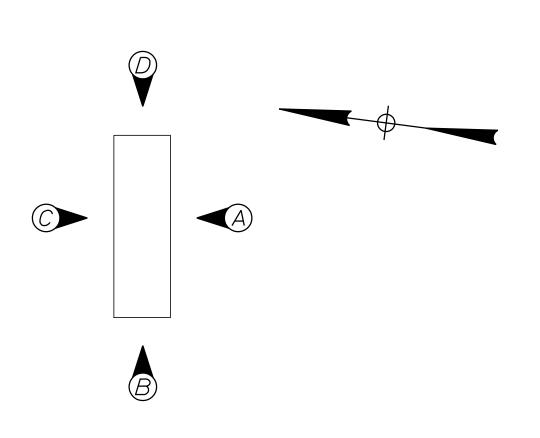



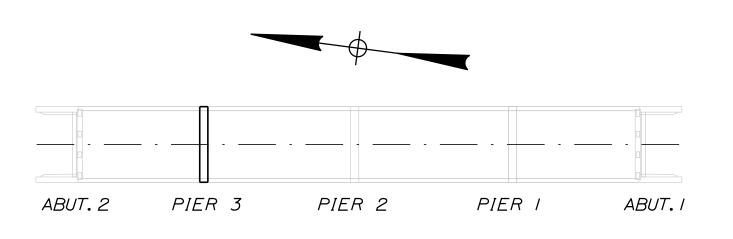

LOCATION PLAN

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				CONSULTANT	PROJEC	T MANAGER	: Daniel S. Myers					
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				Designed	JJL	11/2018	Checked	BLT	11/2018			
				Drawn	ACP	6/2018	In Charge of	DSM	1/2019			

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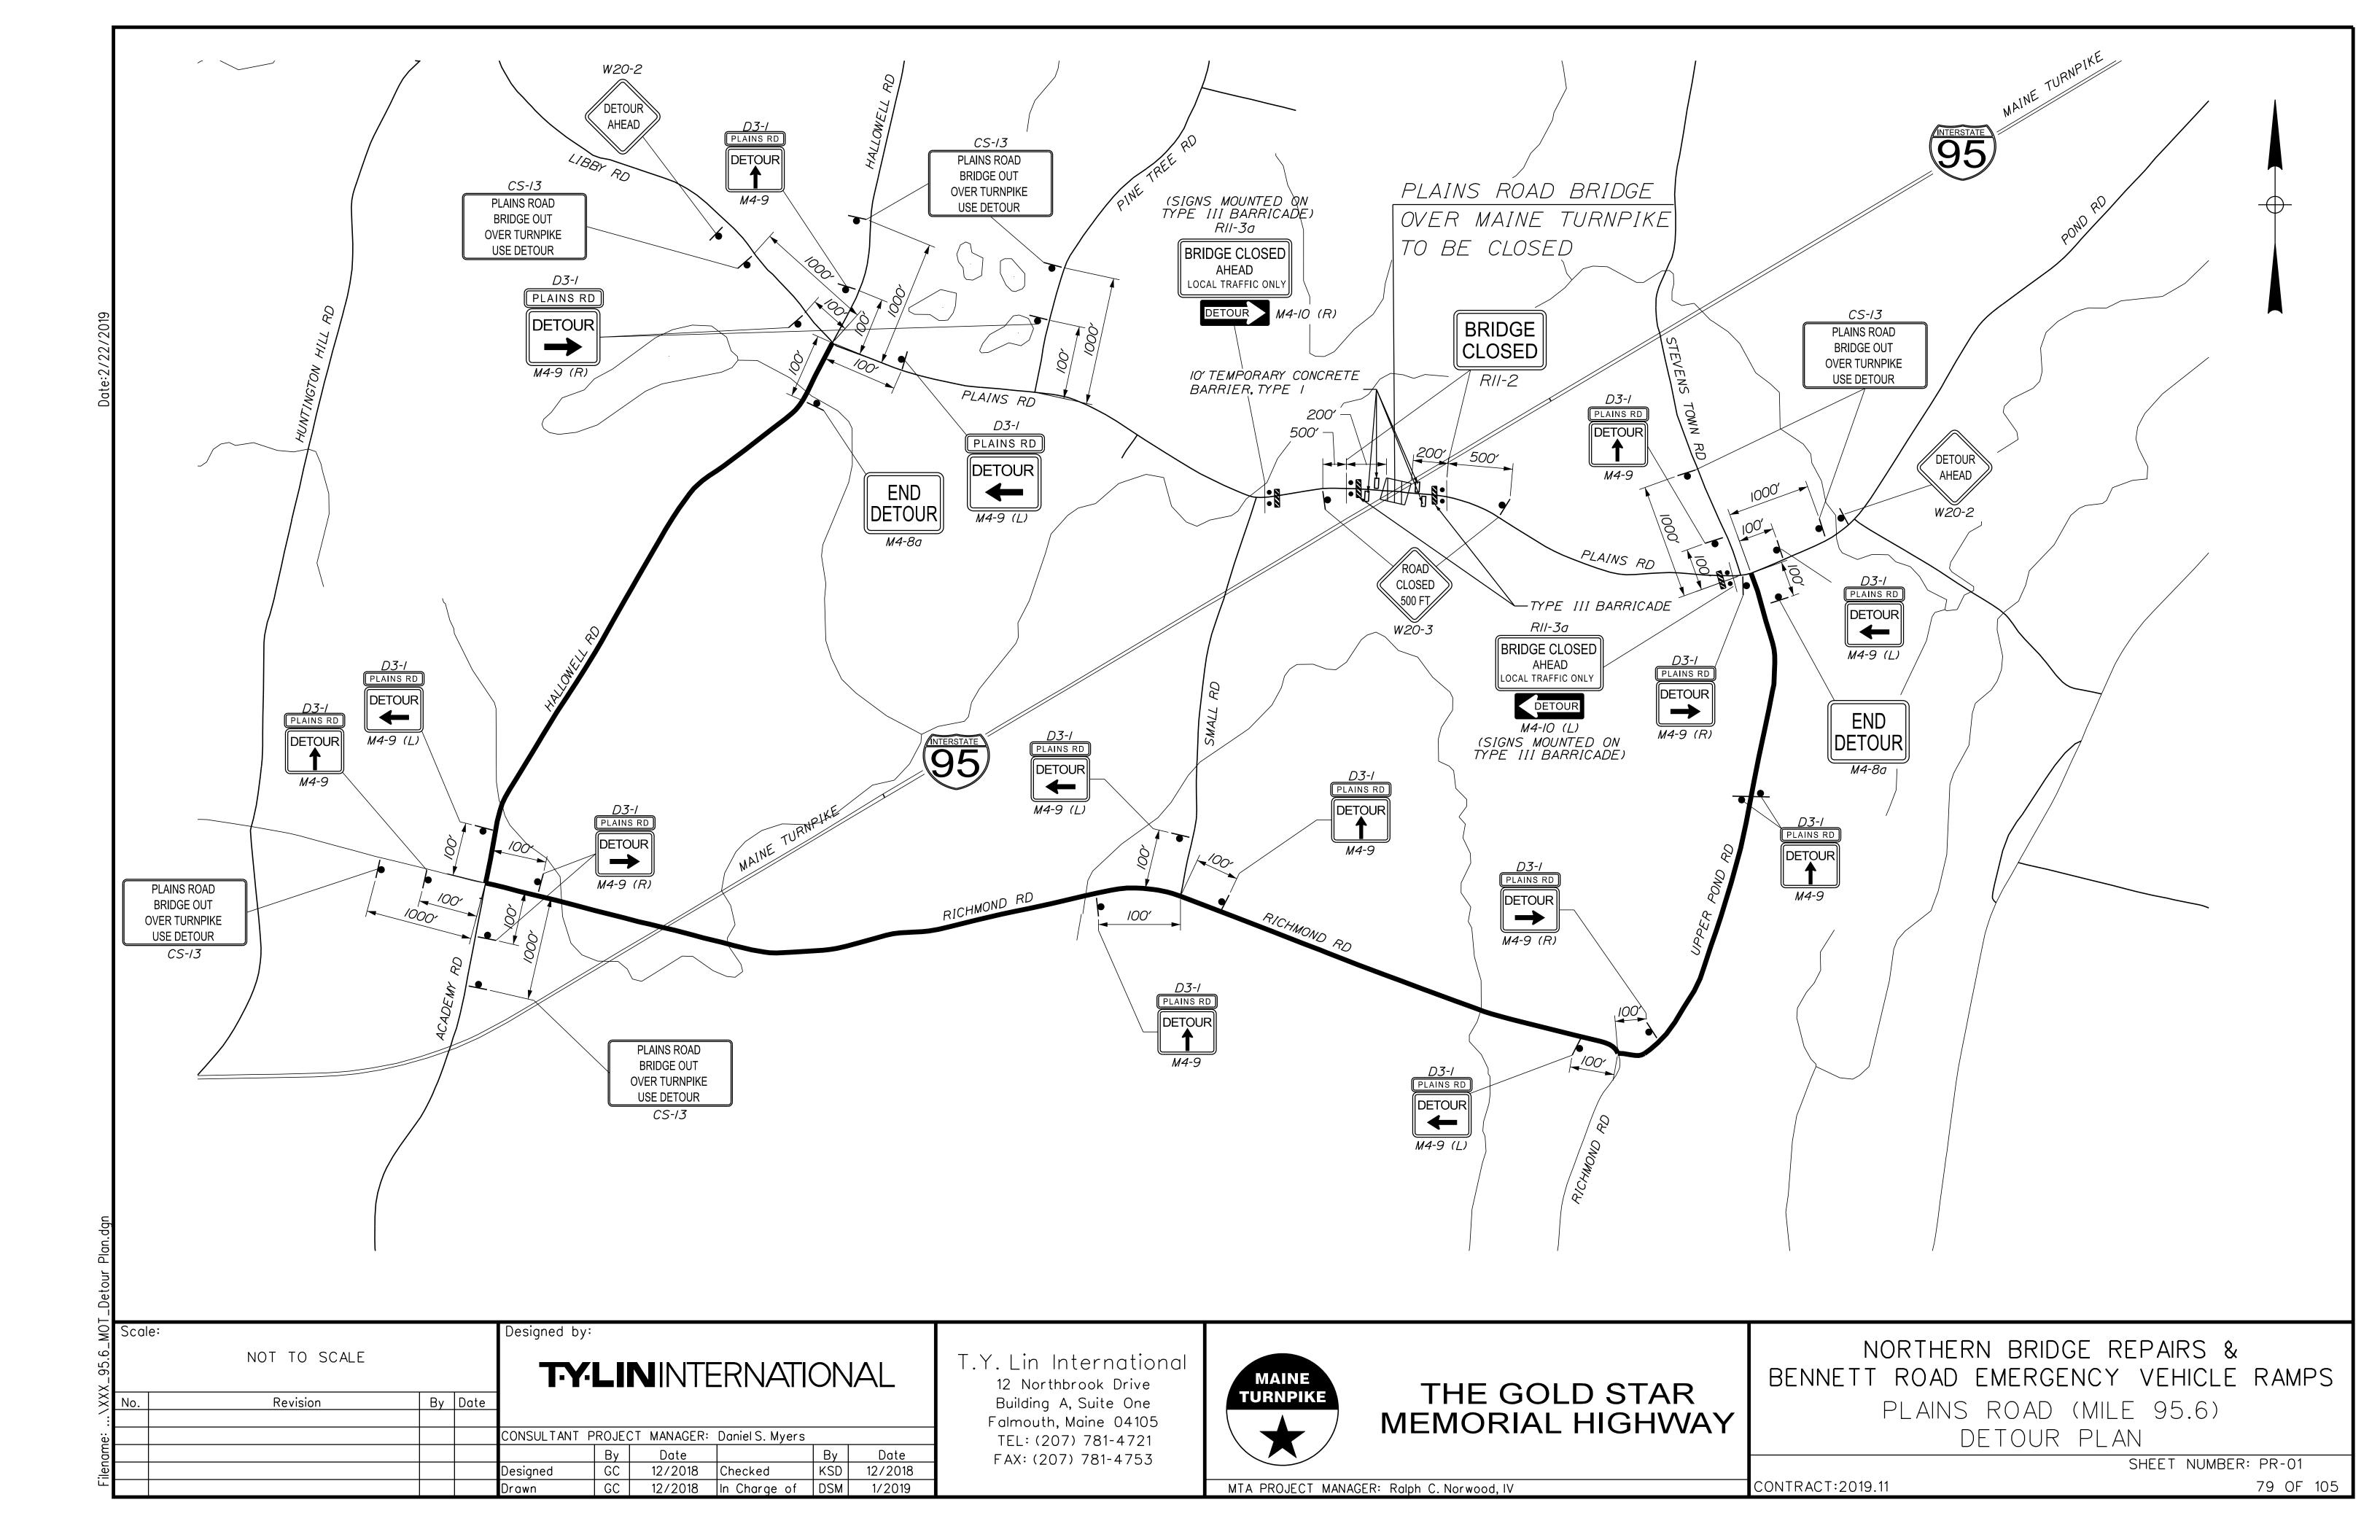
THE GOLD STAR MEMORIAL HIGHWAY

NORTHERN BRIDGE REPAIRS & BENNETT ROAD EMERGENCY VEHICLE RAMPS

WEBSTER ROAD (MILE 82.7) SUBSTRUCTURE REPAIRS - 3 OF 3

SHEET NUMBER: WR-09

78 OF <u>105</u> CONTRACT:2019.11



IDENTIEL-	SIZE	- OF		TFXT	DII	MENSIONS	(INCHES)	NUMBER	COL	OR		ADEA 141	
IDENTIFI- CATION NUMBER	SI	GN HEIGHT	TEXT	LETTE	R	VERTICAL SPACING	1	OF SIGNS RFOUIRFO	BACK- GROUND	LEGEND BORDER	BORDER RADIUS	AREA IN SQUARE FEET	NOTES
CS-I	48"	48"	EXPECT STOPPED TRAFFIC	8C 8C 8C		4" 4"		4	ORANGE	BLACK		16.00 (64)	
CS-10	48"	48"	TRUCKS ENTERING	7C 7C		6"		2	ORANGE	BLACK		16.00 (32)	
CS-13	54"	36"	PLAINS RD BRIDGE OUT OVER TURNPIKE USE DETOUR	5C 5C 5C 5C		3" 3" 3"		7	ORANGE	BLACK		/3.50 (94.5)	
D3-I	42"	12"	PLAINS RD	5D				18	ORANGE	BLACK		3.50 (63)	
G20-2	36"	24"	END ROAD WORK	CONF	FOR	IMENSIONS M TO "STA Y SIGNS" -	NDARD	4	ORANGE	BLACK		6.00 (24)	
G20-5aP	48"	24"	WORK ZONE					4	ORANGE	BLACK		8.00 (32)	
M4-8A	24"	18"	END DETOUR					2	ORANGE	BLACK		3.00 (6)	
M4-9	30"	24"	DETOUR					7	ORANGE	BLACK		5 <b>.</b> 00 (35)	
M4-9L	<i>30</i> "	24"	DETOUR _					5	ORANGE	BLACK		5 <b>.</b> 00 (25)	
M4-9R	30"	24"	DETOUR	∀		∀	∀	6	ORANGE	BLACK		5 <b>.</b> 00 (30)	

IDENTIFI-	SIZE	E OF		TEXT	T DI	MENSIC	DNS	(INCHES)	NUMBER	COL	.OR	20225	AREA IN	
CATION NUMBER	SI	GN	TEXT	LETT HE IG		VERTI	CAL	ARROW	OF SIGNS	BACK- GROUND	LEGEND BORDER	BORDER RADIUS	SQUARE	NOTES
M4-IOR	WIDIH 48"	HE IGHT	DETOUR	TE.	XT D NFOR	IMENS.	IONS "STA	S SHALL NDARD	REQUIRED I	ORANGE	BLACK		6.00 (6)	
M4-IOL	48"	18"	DETOUR						/	ORANGE	BLACK		6.00 (6)	
R2-I	48"	60"	SPEED LIMIT 50						4	WHITE	BLACK		20.00 (80)	
R2-6aP	36"	24"	FINES DOUBLE						4	WHITE	BLACK		6.00 (24)	
R2-I2	36"	54"	END WORK ZONE SPEED LIMIT						4	WHITE	BLACK		13.50 (54)	
RII-2	48"	30"	BRIDGE CLOSED						2	WHITE	BLACK		10.00 (20)	
RII-3a	60"	<i>30</i> "	BRIDGE CLOSED AHEAD LOCAL TRAFFIC ONLY						2	WHITE	BLACK		12 <b>.</b> 50 (25)	
W3-4	48"	48"	BE PREPARED TO STOP						4	ORANGE	BLACK		16.00 (64)	
W3-5	48"	48"	SPEED LIMIT 50	V	7	▼		▼	4	ORANGE	BLACK		16.00 (64)	

- Pig	Scale	:			Designed by:							
-   OM - VVV		NOT TO SCALE			T:Y:	LII	NINTI	ERNATI	ON	AL		
	No.	Revision	Ву	Date	1							
					CONSULTANT	PROJEC	T MANAGER:	Daniel S. Myers				
						Ву	Date		Ву	Date		
					Designed	TWA	1/2019	Checked	PJB	1/2019		
I					Drawn	TWA	1/2019	In Charge of	DSM	1/2019		

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# THE GOLD STAR MEMORIAL HIGHWAY

# NORTHERN BRIDGE REPAIRS & BENNETT ROAD EMERGENCY VEHICLE RAMPS

PLAINS ROAD (MILE 95.6) M.O.T. SIGN SUMMARY 1 OF 2

SHEET NUMBER: PR-02

CONTRACT:2019.11


80 OF 105

MTA PROJECT MANAGER: Ralph C. Norwood, IV

IDENTIFI-	SIZE	. OF		TEXT D	IMENSIONS	(INCHES)	NUMBER	COL	.OR		AREA IN	
CATION NUMBER	SI	GN	TEXT		VERTICAL	1	NUMBER OF SIGNS	BACK- GROUND	LEGEND BORDER	BORDER RADIUS	SQUARE FEET	NOTES
W4-2 (LEFT) (RIGHT)	48" 48" 48"	HE IGHT 48" 48"		TEXT L	DIMENSIONS RM TO "STA AY SIGNS" -	S SHALL ANDARD	A 4 4	ORANGE	BLACK		16.00 (64) (64)	
W8-I	48"	48"	BUMP				4	ORANGE	BLACK		16.00 (64)	
W8-24a	48"	48"	RUMBLE STRIPS AHEAD				4	ORANGE	BLACK		16.00 (64)	
WI6-4P	36"	<i>30</i> "	NEXT 1000 FEET				4	ORANGE	BLACK		7 <b>.</b> 50 (30)	
W2O-I (I MILE) (AHEAD)	48" 48"	48" 48"	ROAD WORK 1 MILE				4 4	ORANGE	BLACK		16.00 (64) (64)	
W20-2	36"	<i>36</i> "	DETOUR AHEAD				2	ORANGE	BLACK		9.00 (18)	
W20-3 (500)	36"	36"	ROAD CLOSED XXXX FT	V	V	V	/	ORANGE	BLACK		9 <b>.</b> 00 (9)	

IDENTIFI-	SIZE	E OF		TEXT	DIME	NSIONS	(INCH	ES)	NUMBER	COL	.OR		AREA IN	
CATION NUMBER	SI	GN HE IGHT	TEXT	LETTE HE IGH	R V.	ERTICAL SPACING	ARF RTE.	ROW MKR.	OF SIGNS REQUIRED	BACK- GROUND	LEGEND BORDER	BORDER RADIUS	SQUARE FEET	NOTES
W20-5 (LEFT) (RIGHT)	48" 48"	48" 48"	LEFT LANE CLOSED 1/2 MILE	CONF	FORM	IENSION. TO "ST. SIGNS" -	ANDAR		4 4	ORANGE	BLACK		16.00 (64) (64)	
W2I-5	48"	48"	SHOULDER WORK						2	ORANGE	BLACK		16.00 (32)	
W2I-5aR (LEFT) (RIGHT)	48" 48"	48" 48"	LEFT SHOULDER CLOSED						2 2	ORANGE	BLACK		16.00 (32) (32)	
W2I-5bR (LEFT) (RIGHT)	48" 48"	48" 48"	RIGHT SHOULDER CLOSED 1000 FT	V		V		V	2 2	ORANGE	BLACK		16.00 (32) (32)	

# BRIDGE OUT OVER TURNPIKE USE DETOUR

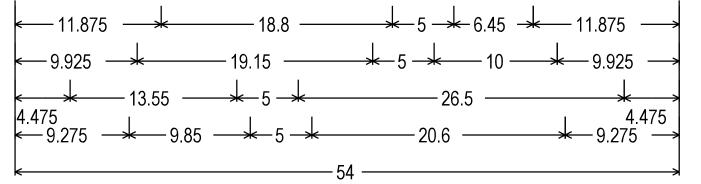

2.250" Radius, 0.875" Border, 0.625" Indent, Black on Orange; [PLAINS RD] Black C 2K; [BRIDGE OUT] Black C 2K; [OVER TURNPIKE] Black C 2K; [USE DETOUR] Black C 2K;

Designed by: T-Y-LININTERNATIONAL NOT TO SCALE By Date Revision CONSULTANT PROJECT MANAGER: DanielS. Myers 
 By
 Date

 PJB
 1/2019
 By Date TWA 1/2019 Checked Designed TWA 1/2019 In Charge of DSM

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# THE GOLD STAR MEMORIAL HIGHWAY


NORTHERN BRIDGE REPAIRS & BENNETT ROAD EMERGENCY VEHICLE RAMPS

> PLAINS ROAD (MILE 95.6) M.O.T. SIGN SUMMARY 2 OF 2

CONTRACT:2019.11

SHEET NUMBER: PR-03

MTA PROJECT MANAGER: Ralph C. Norwood, IV

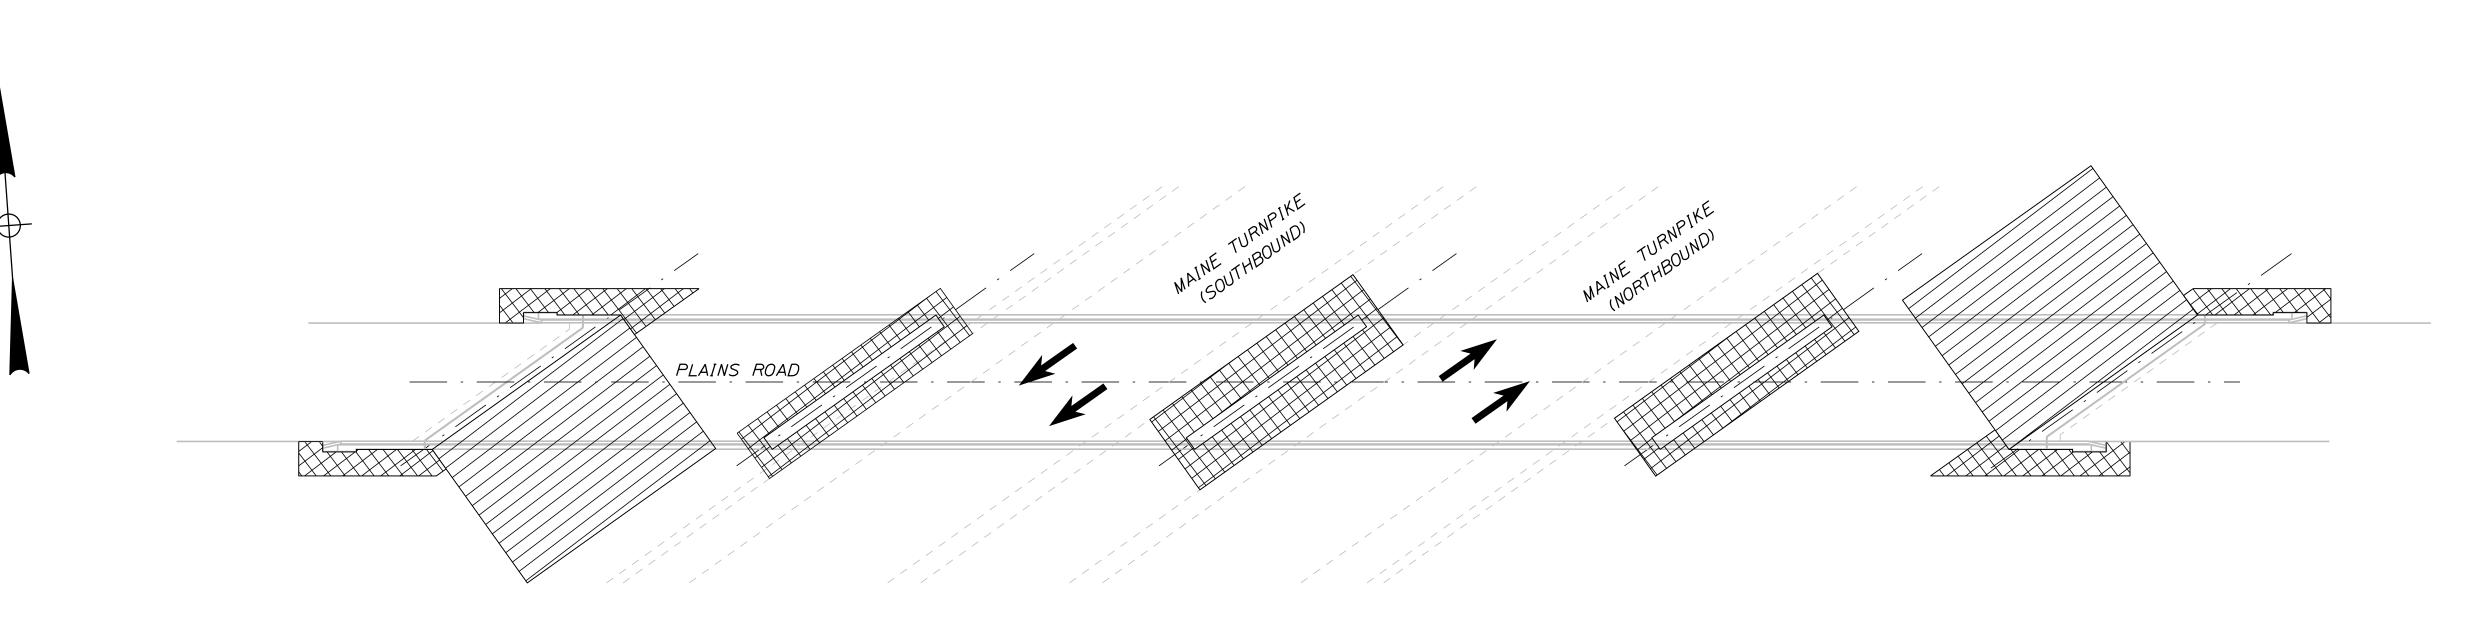

LIMIT OF DISTURBANCE PLAN - PLAINS ROAD

#### AREAS:

CONTRACT LIMIT OF DISTURBANCE:

PLAINS ROAD = 0.08 ACRES

CONTRACTOR'S LIMIT OF DISTURBANCE AREA FOR ACCESS AND STORAGE:

PLAINS ROAD = 0.06 ACRES

#### NOTES:

- I. EROSION AND SEDIMENT CONTROL DEVICES REQUIRED FOR THE CONTRACTOR'S ACCESS LOCATIONS AND STORAGE AREAS WILL NOT BE MEASURED FOR PAYMENT.
- 2. THE CONTRACTOR WILL BE ALLOWED TO STORE MATERIAL AND EQUIPMENT ON GRAVEL AND PAVEMENT WITHIN THE CLOSED PORTIONS OF PLAINS ROAD, THESE AREAS ARE EITHER INCLUDED IN THE LIMITS OF DISTURBANCE OR HAVE BEEN PREVIOUSLY SURFACED AND DO NOT ADD TO THE LIMITS OF DISTURBANCE.
- 3. SEE SPECIFICATIONS FOR CONTRACTOR'S SUBMITTAL REQUIREMENTS IF INCREASING THE LIMITS OF DISTURBANCE TO THE PROJECT ESTIMATED QUANTITIES.

#### LEGEND:

In Charge of DSM 1/2019

1/2019

CONTRACT LIMIT OF DISTURBANCE

CONTRACTOR'S LIMIT OF DISTURBANCE
AREA FOR ACCESS AND STORAGE

#### Scale: Designed by: T-Y-LININTERNATIONAL By Date Revision CONSULTANT PROJECT MANAGER: DanielS. Myers By TSK By Date TSK 1/2019 1/2019 Checked Designed

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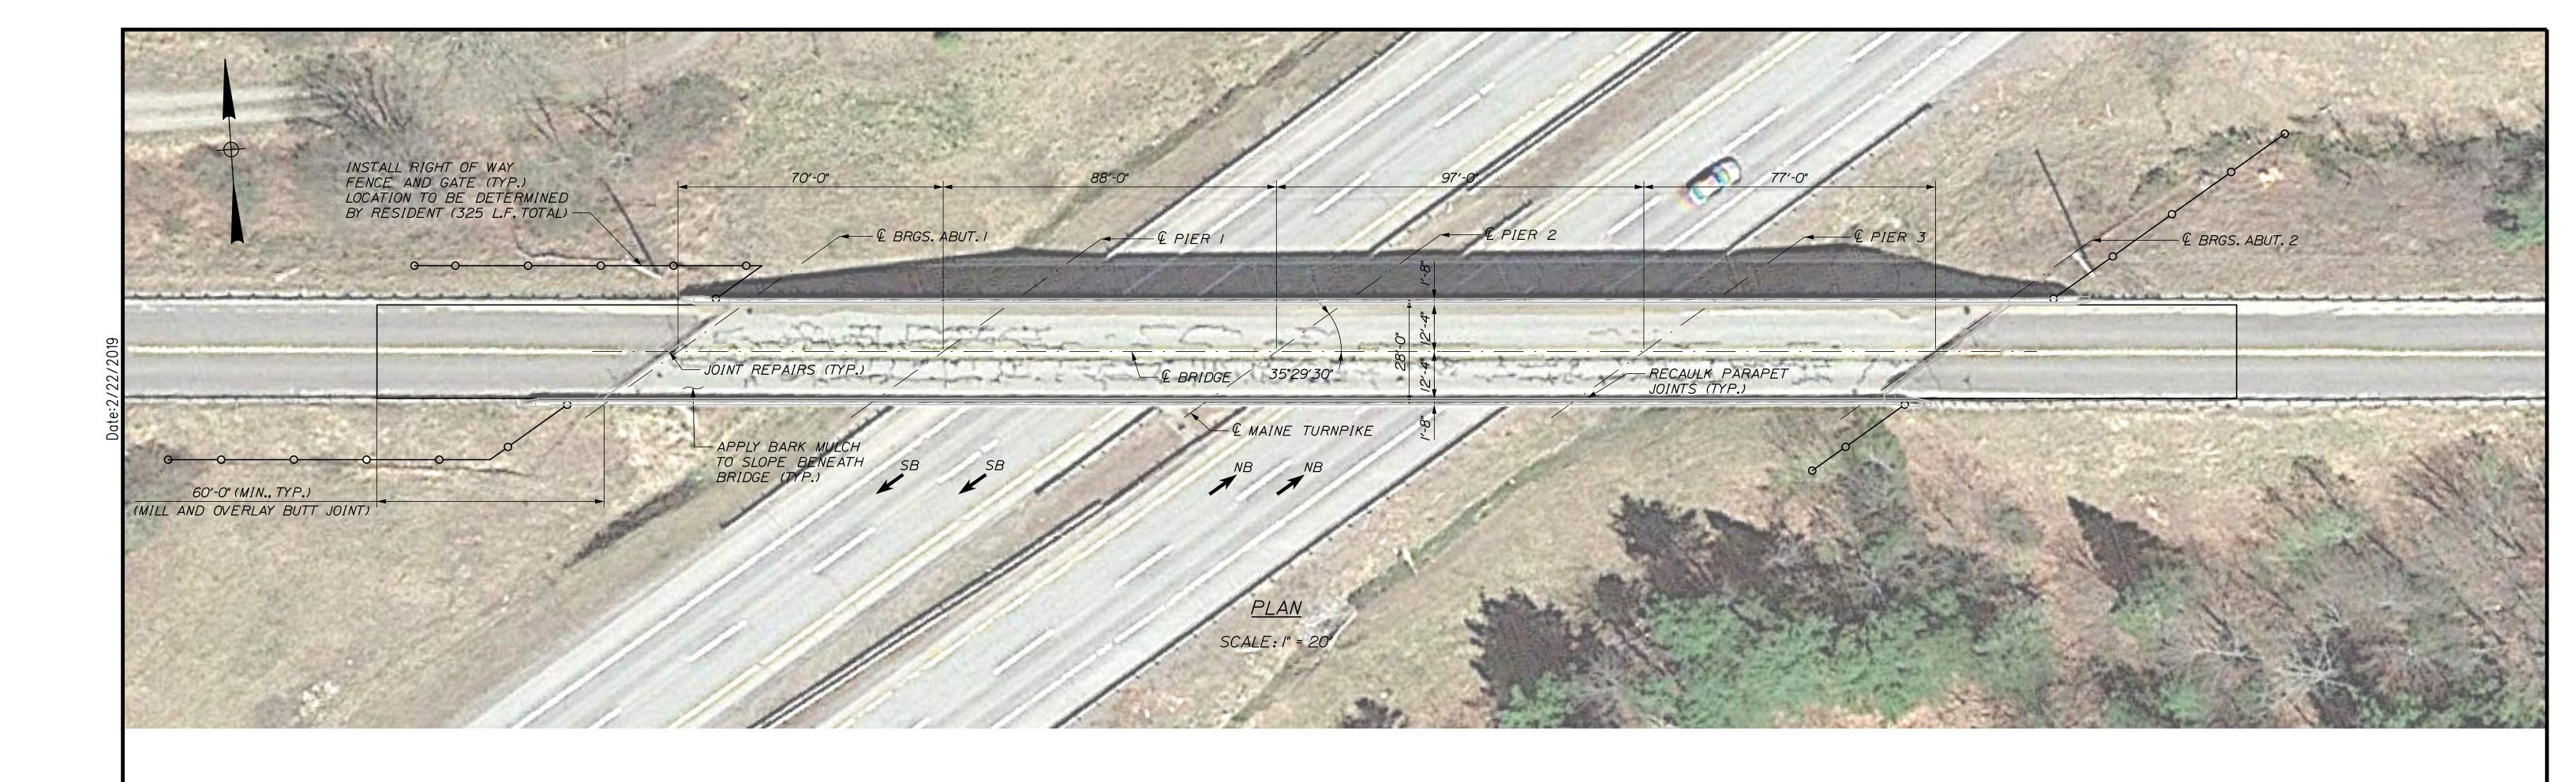
THE GOLD STAR MEMORIAL HIGHWAY


NORTHERN BRIDGE REPAIRS & BENNETT ROAD EMERGENCY VEHICLE RAMPS PLAINS ROAD (MILE 95.6)

LIMIT OF DISTURBANCE

SHEET NUMBER: PR-04

CONTRACT:2019.11 82 OF 105



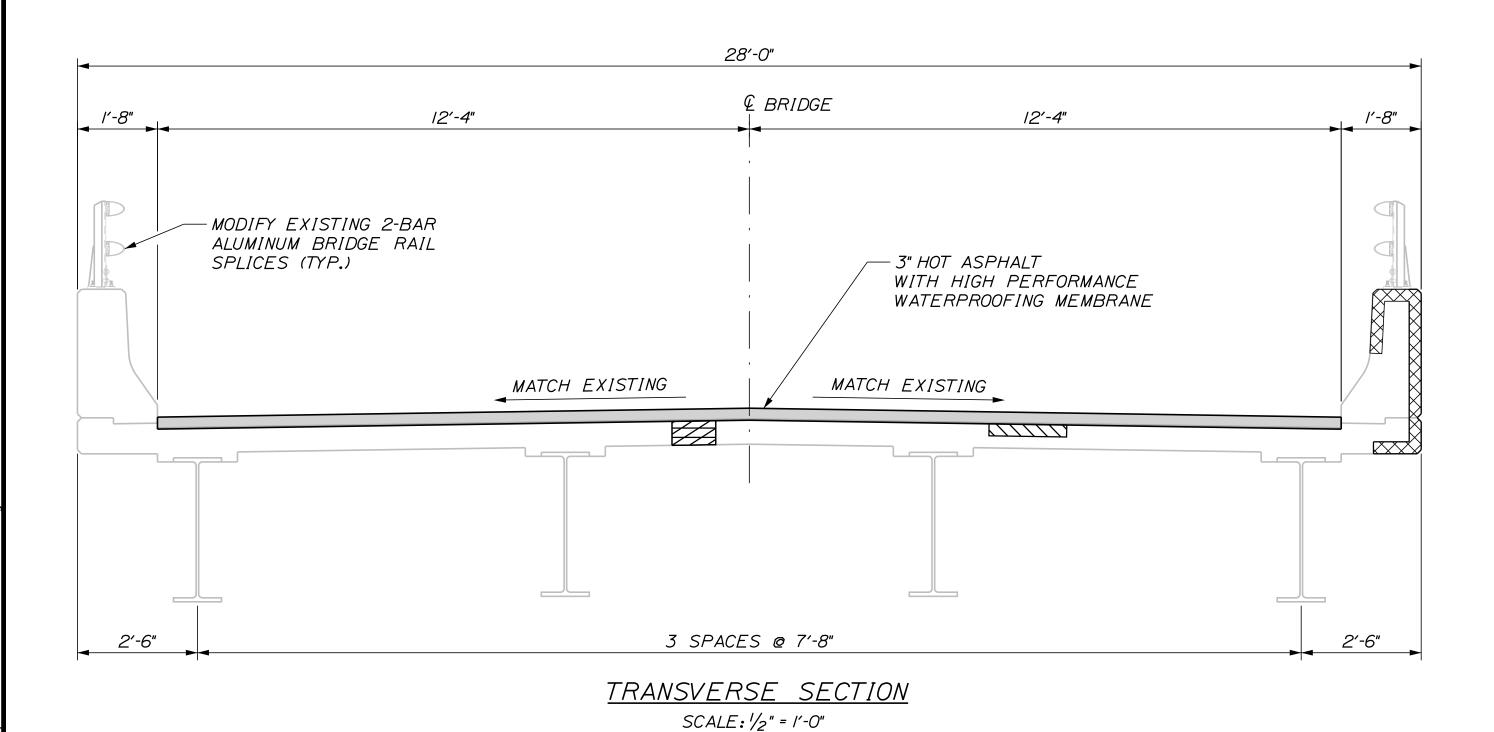

ESTIMATEL	D REPAIR Q	<i>UANTITIES</i>
CONCRETE DECK	PARTIAL DEPTH CONCRETE DECK REPAIRS (S.F.)	OVERHANG
5 S.F.	110 S.F.	500 S.F.

#### LEGEND:

LIMITS OF FULL DEPTH CONCRETE REPAIR (REPAIR AREAS TO BE FIELD VERIFIED)

LIMITS OF PARTIAL DEPTH CONCRETE DECK REPAIRS (REPAIR AREAS TO BE FIELD VERIFIED)

LIMITS OF FASCIA AND OVERHANG REPAIRS (REPAIR AREAS TO BE FIELD VERIFIED)

#### NOTES:

CONTRACT:2019.11

- I. CONTRACTOR SHALL REPAIR AREAS OF CONCRETE DECK DETERIORATION AS IDENTIFIED BY THE RESIDENT. RESIDENT SHALL IDENTIFY AND MARK AREAS FOR DECK REPAIR AFTER THE WEARING SURFACE AND MEMBRANE ARE REMOVED. CONTRACTOR SHALL ALSO REPAIR DETERIORATED AREAS OF FASCIA, FASCIA OVERHANGS, AND PARAPET JOINTS, COORDINATE WORK WITH THE RESIDENT. PAYMENT FOR REPAIR WORK SHALL BE UNDER THE 518 PAY ITEMS.
- 2. ALL PVC DECK WEEPS WHICH DRAIN ONTO PIERS, ABUTMENTS OR STRUCTURAL STEEL SHALL BE EXTENDED AND DIVERTED AWAY FROM BRIDGE COMPONENTS BELOW DECK, AND SHALL EXTEND IFT BELOW BOTTOM FLANGE, AS DIRECTED BY THE RESIDENT. PAYMENT SHALL BE BY THE VARIOUS LABOR AND EQUIPMENT ITEMS. SEE DETAIL SHEET "MISCELLANEOUS DETAILS SHEET 2 OF 3" & "MISCELLANEOUS DETAILS SHEET 3 OF 3".
- 3. FOR WORK REQUIRED AT DRAIN TROUGHS, SEE SHEET "MISCELLANEOUS DETAILS SHEET I OF 3".
- 4. A BEAD OF HOT-APPLIED RUBBERIZED ASPHALT SEALER SHALL BE APPLIED ALONG CURB LINES AFTER INSTALLATION OF BASE COURSE. PAYMENT SHALL NOT BE MADE DIRECTLY BUT SHALL BE CONSIDERED INCIDENTAL TO RELATED CONTRACT ITEMS.

95.6.	Scale:				Designed b	y:					
_ MM	Scale:				T-Y	'LII	VINT	ERNATI	ON	AL	
(XX) :-	No.	Revision	Ву	Date	]						
e:					CONSULTANT	PROJEC	T MANAGER:	Daniel S. Myers			1
am						Ву	Date		Ву	Date	1
r Ilename:					Designed	DSM	10/2018	Checked	DSM	1/2019	1
_					Drawn	ACP	10/2018	In Charge of	DSM	1/2019	1

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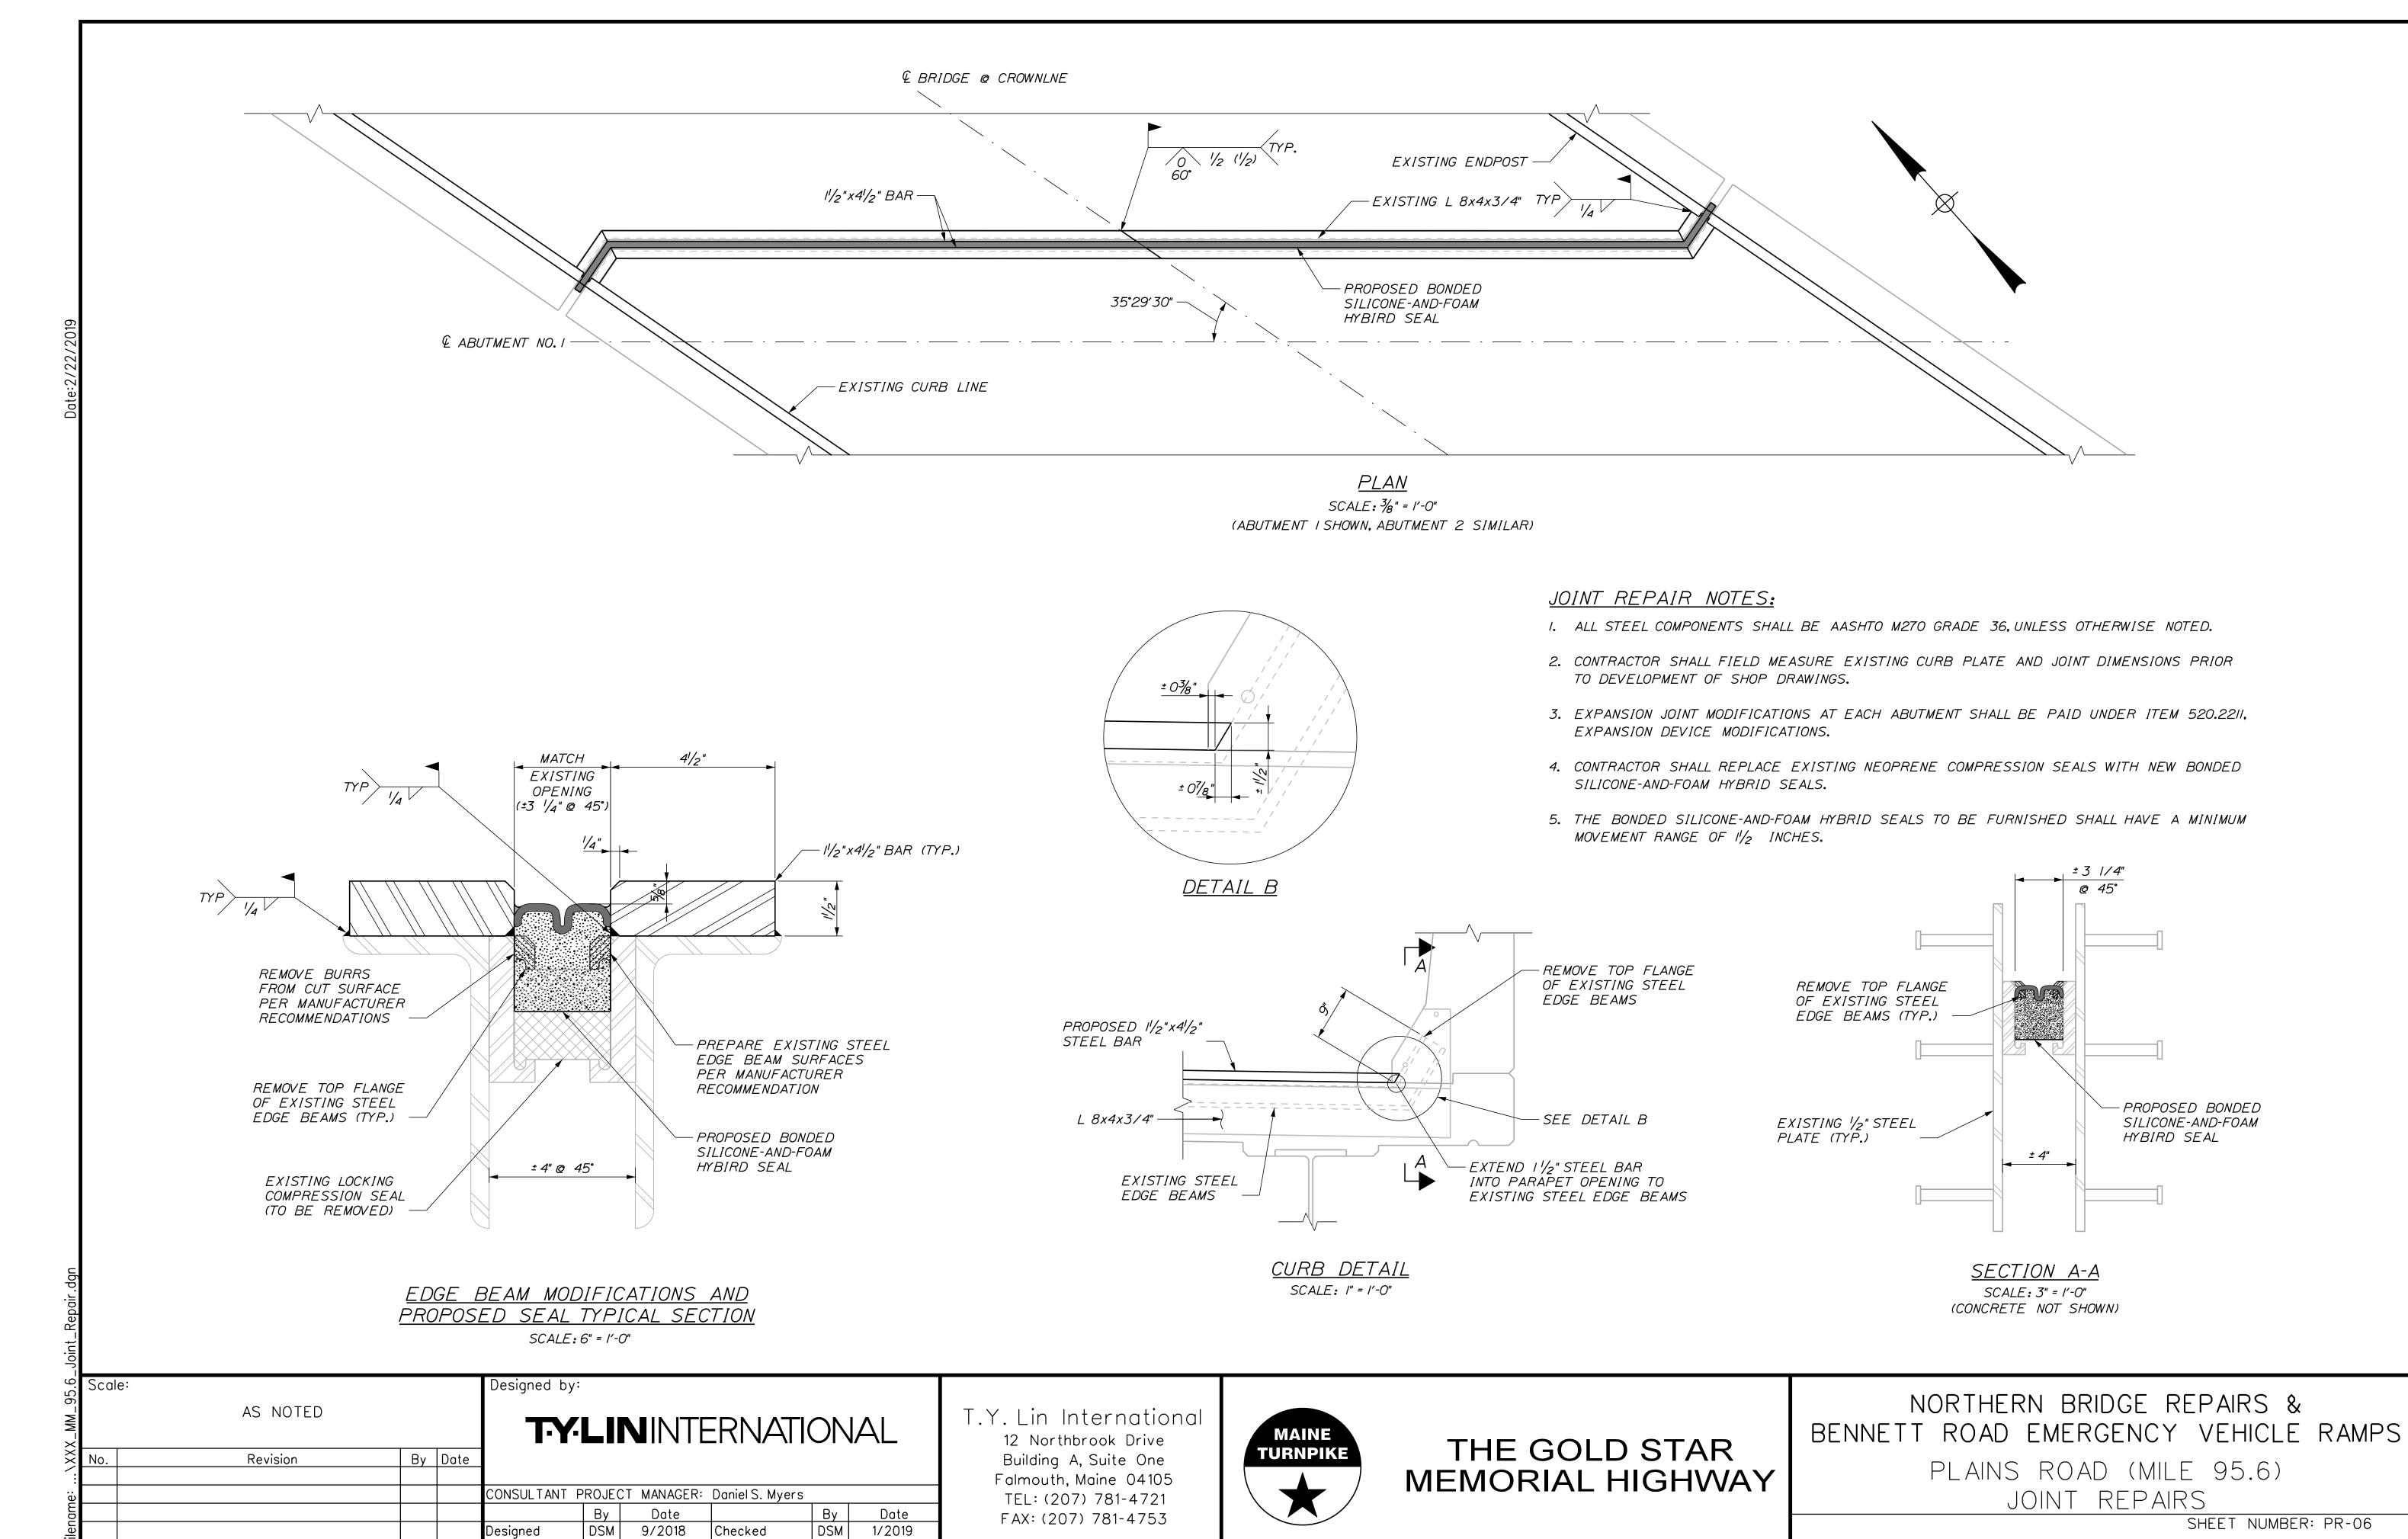


THE GOLD STAR MEMORIAL HIGHWAY

NORTHERN BRIDGE REPAIRS & BENNETT ROAD EMERGENCY VEHICLE RAMPS PLAINS ROAD (MILE 95.6) DECK PLAN & SECTION

SHEET NUMBER: PR-05

MTA PROJECT MANAGER: Ralph C. Norwood, IV



DSM

Checked

In Charge of DSM

Designed


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1/2019

SHEET NUMBER: PR-06 CONTRACT:2019.11 84 OF 105 MTA PROJECT MANAGER: Ralph C. Norwood, IV



PLAINS ROAD (MILE 95.6) ABUTMENTS ESTIMATED QUANTITY OF REPAIRS									
	ABUT. NO. I ABUT. NO. I TOTAL								
ABUTMENT REPAIRS	0 S.F.	10 S.F.	10 S.F.						
EPOXY-INJECTED CRACK REPAIR 5 S.F. 0 S.F. 2 S.F.									

#### NOTES:

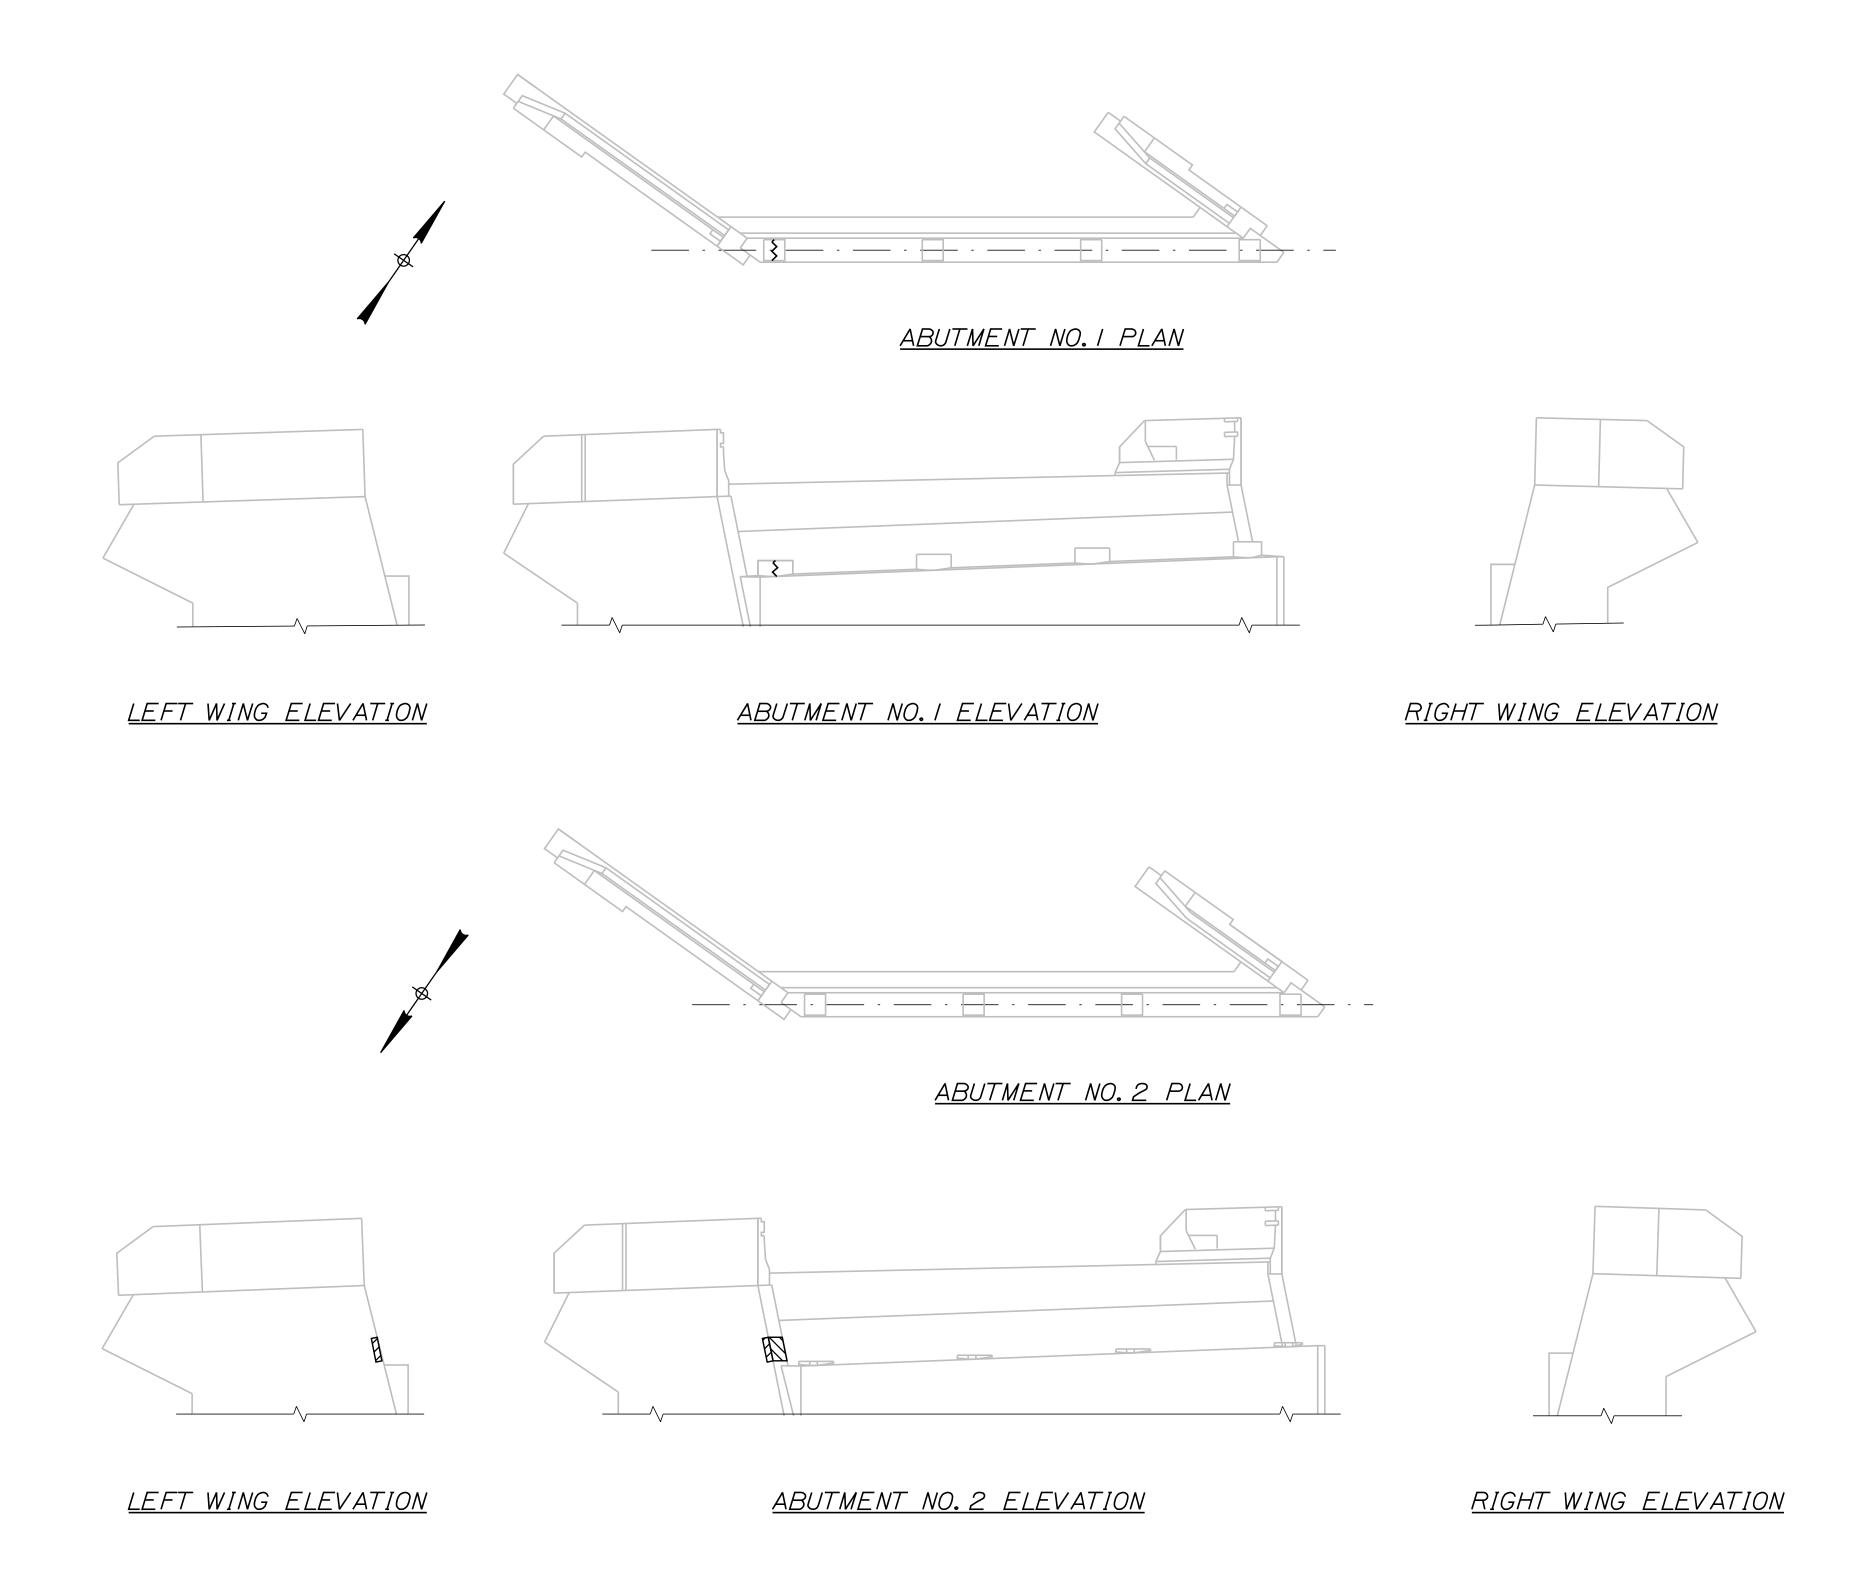I. FOR PROCEDURAL NOTES SEE SHEET "BRIDGE GENERAL NOTES"

#### <u>LEGEND:</u>

LIMIT OF CONCRETE SURFACE REPAIRS

---- LIMIT OF EPOXY INJECTED CRACK REPAIR

---- EXISTING CONCRETE

-- EXISTING AND PROPOSED GROUND



LOCATION PLAN

Designed by: NOT TO SCALE T-Y-LININTERNATIONAL By Date Revision CONSULTANT PROJECT MANAGER: DanielS. Myers By Date JJL 11/2018 BLT 11/2018 Checked Designed In Charge of DSM 1/2019

Scale:

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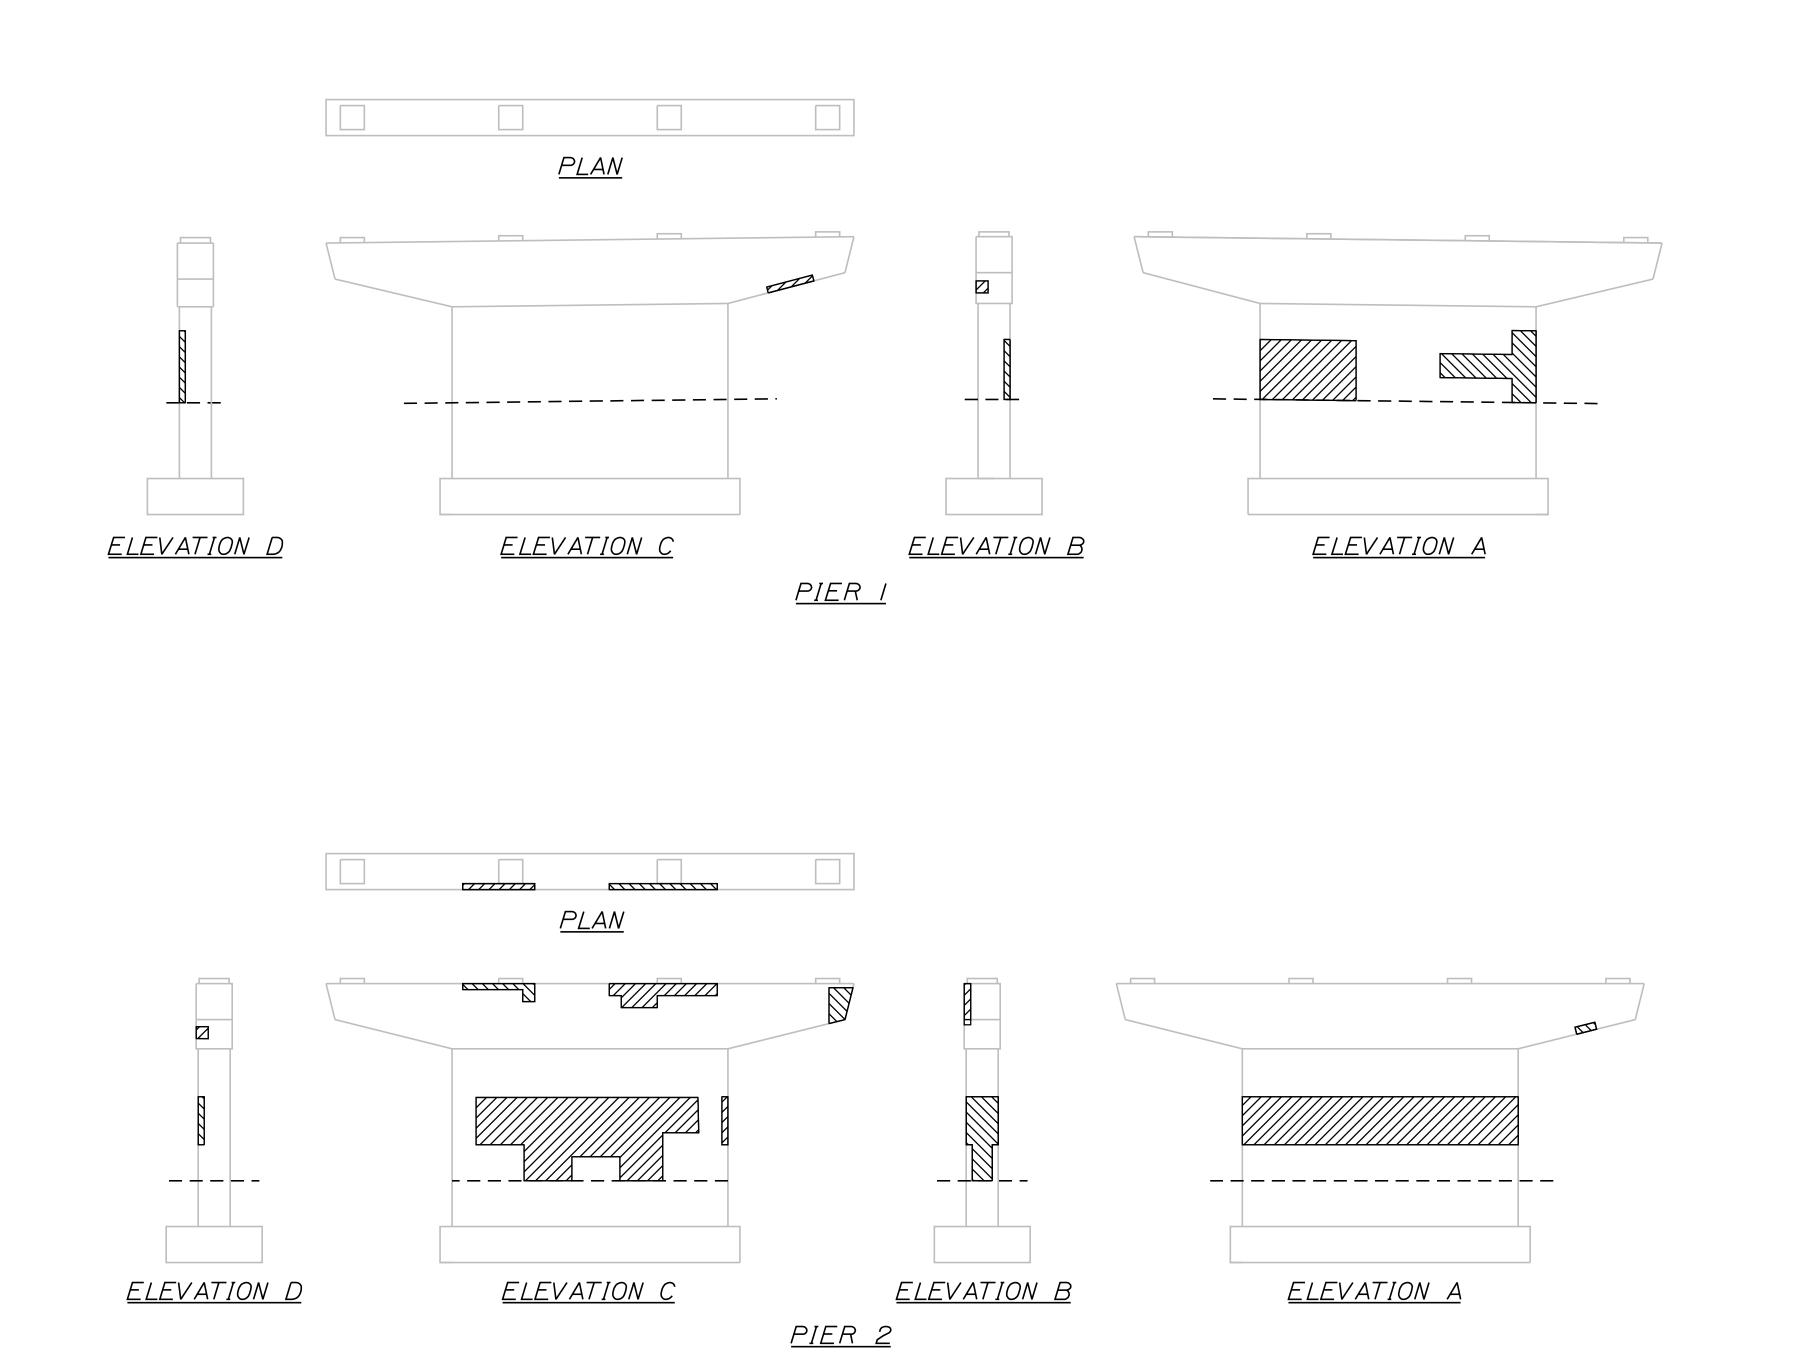
THE GOLD STAR MEMORIAL HIGHWAY

NORTHERN BRIDGE REPAIRS & BENNETT ROAD EMERGENCY VEHICLE RAMPS

PLAINS ROAD (MILE 95.6)

SUBSTRUCTURE REPAIRS - 1 OF 3

SHEET NUMBER: PR-07 CONTRACT:2019.11 85 OF 105



PL	AINS ROAL	D (MILE 9	5.6) PIERS	
EST	TIMATED Q	UANTITY O	F REPAIR.	S
	PIER NO. I	PIER NO. 2	PIER NO. 3	TOTAL
PIER REPAIRS	115 S <b>.</b> F	315 S <b>.</b> F	300 S.F	730 S.F

#### NOTES:

I. FOR PROCEDURAL NOTES SEE SHEET "BRIDGE GENERAL NOTES"


#### <u>LEGEND:</u>

LIMIT OF CONCRETE SURFACE REPAIRS


---- LIMIT OF EPOXY INJECTED CRACK REPAIR


---- EXISTING CONCRETE

-- EXISTING AND PROPOSED GROUND

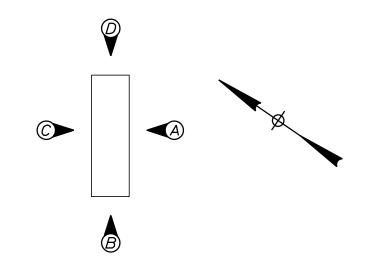

<u>PIER ELEVATIONS</u>

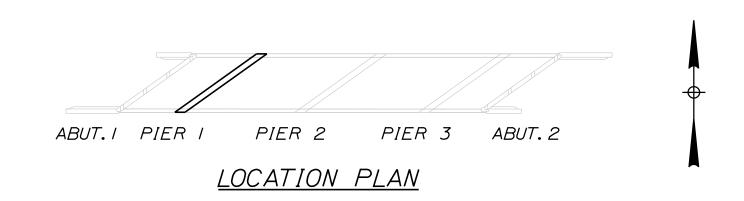

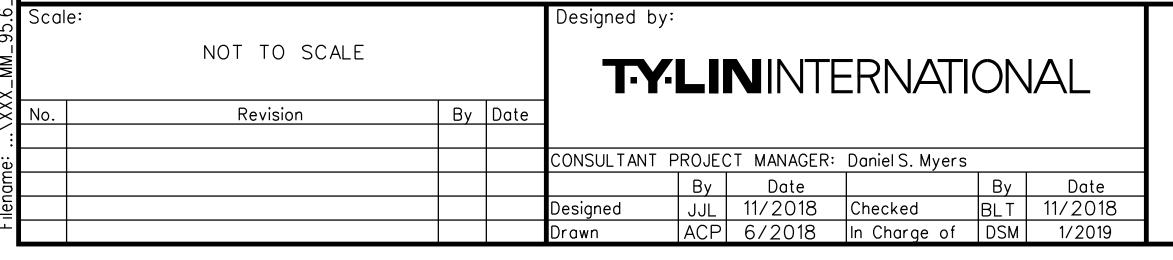

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THE GOLD STAR MEMORIAL HIGHWAY

NORTHERN BRIDGE REPAIRS & BENNETT ROAD EMERGENCY VEHICLE RAMPS PLAINS ROAD (MILE 95.6)

SUBSTRUCTURE REPAIRS - 2 OF 3

SHEET NUMBER: PR-08

MTA PROJECT MANAGER: Ralph C. Norwood, IV

CONTRACT:2019.11 86 OF 105

PIER 3

#### NOTES:

- I. FOR PROCEDURAL NOTES SEE SHEET "GENERAL NOTES"
- 2. FOR QUANTITY, SEE "(MILE 95.6) SUBSTRUCTURE REPAIRS 2 OF 3"


#### <u>LEGEND:</u>


LIMIT OF CONCRETE SURFACE REPAIRS

~~~ LIMIT OF EPOXY INJECTED CRACK REPAIR

---- EXISTING CONCRETE

-- EXISTING AND PROPOSED GROUND

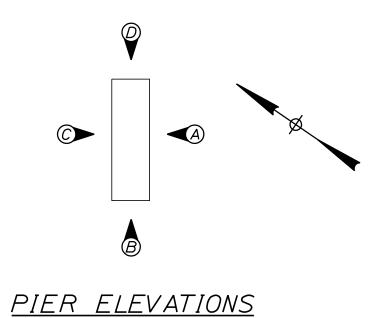

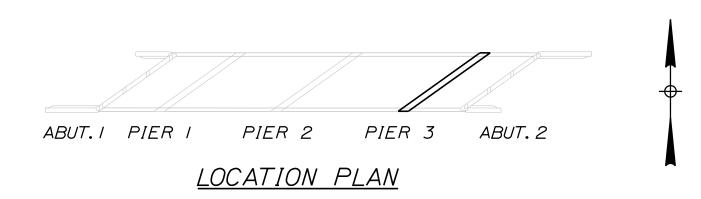

Scale: Designed by: NOT TO SCALE T-Y-LININTERNATIONAL By Date Revision CONSULTANT PROJECT MANAGER: DanielS. Myers 
 By
 Date
 By
 Date

 JJL
 11/2018
 Checked
 BLT
 11/2018

 ACP
 6/2018
 In Charge of DSM
 1/2019
 Designed

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THE GOLD STAR MEMORIAL HIGHWAY

NORTHERN BRIDGE REPAIRS & BENNETT ROAD EMERGENCY VEHICLE RAMPS

PLAINS ROAD (MILE 95.6) SUBSTRUCTURE REPAIRS - 3 OF 3

SHEET NUMBER: PR-09

MTA PROJECT MANAGER: Ralph C. Norwood, IV

CONTRACT:2019.11 87 OF 105

| IDENTIFI                  | CIZE       | : OF           |                                       | TFXT           | DΜ              | MENSIONS                             | (INCHES)  | NUMBER                            | COL    | OR .   |                  | 4054 44               |       |
|---------------------------|------------|----------------|---------------------------------------|----------------|-----------------|--------------------------------------|-----------|-----------------------------------|--------|--------|------------------|-----------------------|-------|
| IDENTIFI-<br>CATION       |            | GN             | TEXT                                  | LETTE          | $\frac{DIR}{R}$ | VERTICAL                             | ARROW     | NUMBER<br>OF<br>SIGNS<br>REQUIRED | BACK-  | LEGEND | BORDER<br>RADIUS | AREA IN<br>SQUARE     | NOTES |
| NUMBER                    | WIDTH      | <i>HE IGHT</i> |                                       | HEIGH          | T               | SPACING                              | RTE. MKR. | REQUIRED                          | GROUND | BORDER | RADIUS           | FEET                  |       |
| CS-I                      | 48"        | 48"            | EXPECT<br>STOPPED<br>TRAFFIC          | 8C<br>8C<br>8C |                 | 4"<br>4"                             |           | 4                                 | ORANGE | BLACK  |                  | 16.00<br>(64)         |       |
| CS-10                     | 48"        | 48"            | TRUCKS ENTERING                       | 7C<br>7C       |                 | 6"                                   |           | 2                                 | ORANGE | BLACK  |                  | 16.00<br>(32)         |       |
| G20-2                     | 48"        | 24"            | END<br>ROAD WORK                      | CONF           | FOR.            | IMENSIONS<br>M TO "STA<br>Y SIGNS" - | NDARD     | 4                                 | ORANGE | BLACK  |                  | 8.00<br>(32)          |       |
| G20-5aP                   | 36"        | 24"            | WORK ZONE                             |                |                 |                                      |           | 4                                 | ORANGE | BLACK  |                  | 6.00<br>(24)          |       |
| R2-I<br>(50)              | 48"        | 60"            | SPEED<br>LIMIT<br>50                  |                |                 |                                      |           | 4                                 | WHITE  | BLACK  |                  | 20.00<br>(80)         |       |
| R2-6aP                    | 36"        | 24"            | FINES<br>DOUBLE                       |                |                 |                                      |           | 4                                 | WHITE  | BLACK  |                  | 6.00<br>(24)          |       |
| R2-I2                     | 36"        | <i>54</i> "    | END<br>WORK<br>ZONE<br>SPEED<br>LIMIT |                |                 |                                      |           | 4                                 | WHITE  | BLACK  |                  | 13.50<br>(54)         |       |
| W3-4                      | 48"        | 48"            | BE<br>PREPARED<br>TO STOP             |                |                 |                                      |           | 4                                 | ORANGE | BLACK  |                  | 16.00<br>(64)         |       |
| W3-5                      | 48"        | 48"            | SPEED LIMIT 50                        |                |                 |                                      |           | 4                                 | ORANGE | BLACK  |                  | 16.00<br>(64)         |       |
| W4-2<br>(LEFT)<br>(RIGHT) | 48"<br>48" | 48"<br>48"     |                                       | V              |                 | V                                    | ∇         | 4<br>4                            | ORANGE | BLACK  |                  | 16.00<br>(64)<br>(64) |       |

| IDENTIFI-                    | SIZE       | E OF          |                                        | TEXT DIMENSION                                   | S (INCHES)             | NUMBER                            | COL             | .OR              | 202252           | AREA IN               |       |
|------------------------------|------------|---------------|----------------------------------------|--------------------------------------------------|------------------------|-----------------------------------|-----------------|------------------|------------------|-----------------------|-------|
| CATION<br>NUMBER             | SI         | GN<br>HE IGHT | TEXT                                   | LETTER VERTICA<br>HEIGHT SPACIN                  | AL ARROW<br>G RTE.MKR. | NUMBER<br>OF<br>SIGNS<br>REQUIRED | BACK-<br>GROUND | LEGEND<br>BORDER | BORDER<br>RADIUS | SQUARE<br>FEET        | NOTES |
| W8-/                         | 48"        | 48"           | BUMP                                   | TEXT DIMENSIO<br>CONFORM TO "S<br>HIGHWAY SIGNS" | TANDARD                | 4                                 | ORANGE          | BLACK            |                  | 16.00<br>(64)         |       |
| W8-24a                       | 48"        | 48"           | RUMBLE<br>STRIPS<br>AHEAD              |                                                  |                        | 4                                 | ORANGE          | BLACK            |                  | 16.00<br>(64)         |       |
| WI6-4P                       | 36"        | 30"           | NEXT<br>1000 FEET                      |                                                  |                        | 4                                 | ORANGE          | BLACK            |                  | 7.50<br>(30)          |       |
| W2O-I<br>(I MILE)<br>(AHEAD) | 48"<br>48" | 48"<br>48"    | ROAD<br>WORK<br>1 MILE                 |                                                  |                        | 4 4                               | ORANGE          | BLACK            |                  | 16.00<br>(64)<br>(64) |       |
| W20-5<br>(RIGHT)<br>(LEFT)   | 48"<br>48" | 48"<br>48"    | RIGHT<br>LANE<br>CLOSED<br>1/2 MILE    |                                                  |                        | 4<br>4                            | ORANGE          | BLACK            |                  | 16.00<br>(64)<br>(64) |       |
| W2I-5                        | 48"        | 48"           | SHOULDER<br>WORK                       |                                                  |                        | 2                                 | ORANGE          | BLACK            |                  | 16.00<br>(32)         |       |
| W2I-5a<br>(RIGHT)<br>(LEFT)  | 48"<br>48" | 48"<br>48"    | LEFT<br>SHOULDER<br>CLOSED             |                                                  |                        | 2<br>2                            | ORANGE          | BLACK            |                  | 16.00<br>(32)<br>(32) |       |
| W2I-5b<br>(RIGHT)<br>(LEFT)  | 48"<br>48" | 48"<br>48"    | RIGHT<br>SHOULDER<br>CLOSED<br>1000 FT | V V                                              | V                      | 2 2                               | ORANGE          | BLACK            |                  | 16.00<br>(32)<br>(32) |       |

CONTRACT:2019.11

| Scal | e:           |    |      | Designed by: |        |            |                 |     |        |
|------|--------------|----|------|--------------|--------|------------|-----------------|-----|--------|
|      | NOT TO SCALE |    |      | T:Y:         | LII    | NINTE      | ERNATI          | ON  | AL     |
| No.  | Revision     | Ву | Date | 1            |        |            |                 |     |        |
|      |              |    |      |              |        |            |                 |     |        |
|      |              |    |      | CONSULTANT F | PROJEC | T MANAGER: | Daniel S. Myers |     |        |
|      |              |    |      |              | Ву     | Date       |                 | Ву  | Date   |
|      |              |    |      | Designed     | TWA    | 1/2019     | Checked         | JJB | 1/2019 |
| ·    |              |    |      | Drawn        | TWA    | 1/2019     | In Charge of    | DSM | 1/2019 |

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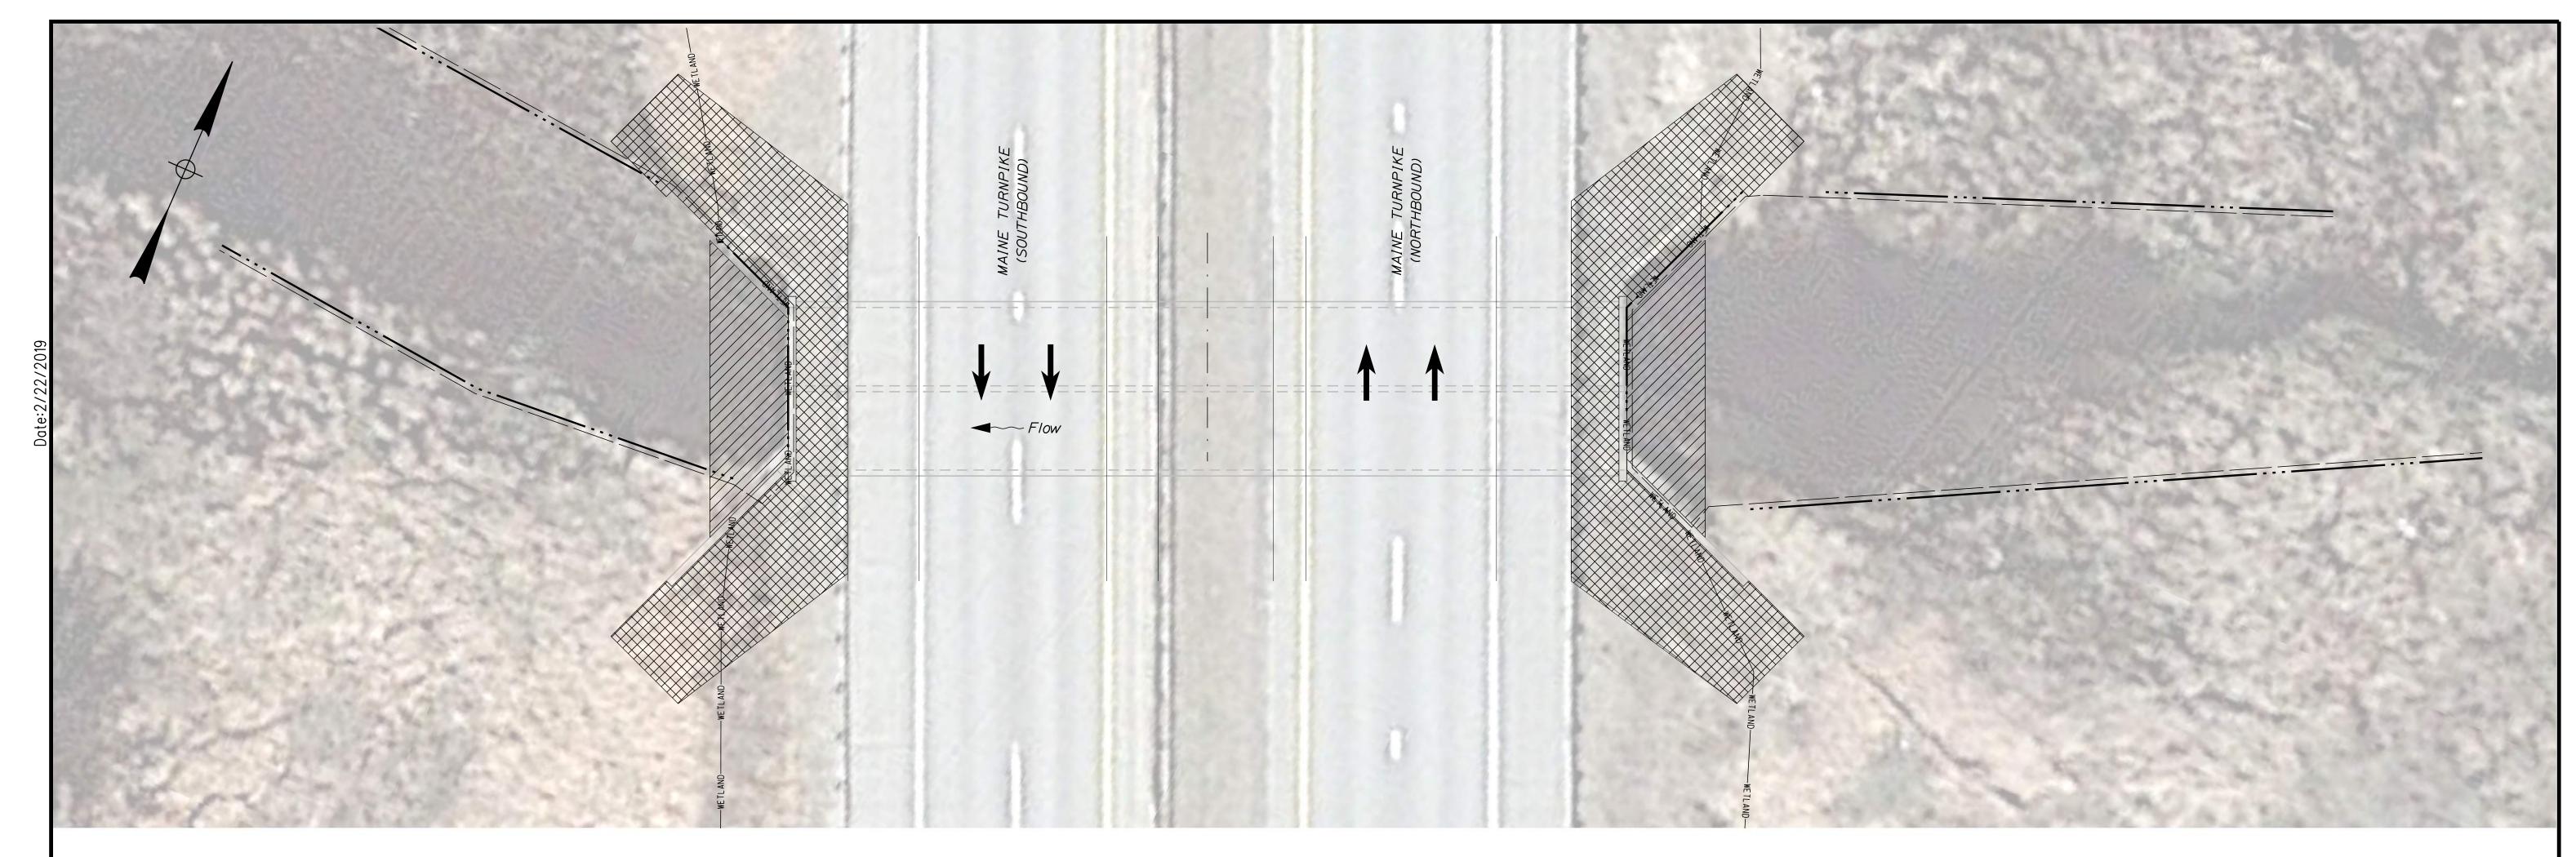
# THE GOLD STAR MEMORIAL HIGHWAY

# NORTHERN BRIDGE REPAIRS & BENNETT ROAD EMERGENCY VEHICLE RAMPS

PLEASANT RIVER CULVERT (MILE 62.3) M.O.T. SIGN SUMMARY

SHEET NUMBER: PC-01

MTA PROJECT MANAGER: Ralph C. Norwood, IV



LIMIT OF DISTURBANCE PLAN - PLEASANT RIVER CULVERT

#### <u>LEGEND:</u>



COFFERDAM LIMIT OF DISTURBANCE

CONTRACTOR'S LIMIT OF DISTURBANG AREA FOR ACCESS AND STORAGE CONTRACTOR'S LIMIT OF DISTURBANCE

# AREAS:

COFFERDAM LIMIT OF DISTURBANCE:

PLEASANT RIVER CULVERT = 0.013 ACRES

CONTRACTOR'S LIMIT OF DISTURBANCE AREA FOR ACCESS AND STORAGE:

PLEASANT RIVER CULVERT = 0.046 ACRES


#### NOTES:

CONTRACT:2019.11

- I. EROSION AND SEDIMENT CONTROL DEVICES REQUIRED FOR THE CONTRACTOR'S ACCESS LOCATIONS AND STORAGE AREAS WILL NOT BE MEASURED FOR PAYMENT.
- 2. SEE SPECIFICATIONS FOR CONTRACTOR'S SUBMITTAL REQUIREMENTS IF INCREASING THE LIMITS OF DISTURBANCE TO THE PROJECT ESTIMATED QUANTITIES.

#### Designed by: Scale: 1'' = 10' T-Y-LININTERNATIONAL By Date Revision CONSULTANT PROJECT MANAGER: DanielS. Myers By TSK By Date DSM 1/2019 1/2019 Checked Designed In Charge of DSM 1/2019 1/2019

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THE GOLD STAR MEMORIAL HIGHWAY

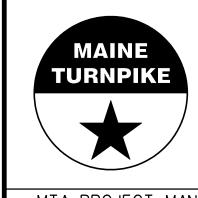NORTHERN BRIDGE REPAIRS & BENNETT ROAD EMERGENCY VEHICLE RAMPS PLEASANT RIVER CULVERT (MILE 62.3) LIMIT OF DISTURBANCE

SHEET NUMBER: PC-02

MTA PROJECT MANAGER: Ralph C. Norwood, IV

<u>NOTE:</u>

LIMIT OF CONCRETE SURFACE REPAIRS

LIMIT OF EPOXY INJECTED CRACK REPAIRS


EXISTING CONCRETE


--- EXISTING AND PROPOSED GROUND

I. FOR PROCEDURAL NOTES SEE SHEET "BRIDGE GENERAL NOTES"

| PLEASANT R | YVER  | CULVE  | RT | (MILE | 62.3 |
|------------|-------|--------|----|-------|------|
| ESTIMATE   | D QUA | ANTITY | OF | REPA. | IRS  |


|                  | HEADWALLS | WINGWALLS | CULVERT BARRELS | TOTAL    |
|------------------|-----------|-----------|-----------------|----------|
| CRACK REPAIRS    | 0 L.F.    | 12 L.F.   | 108 L.F.        | 48 L.F.  |
| CONCRETE REPAIRS | 30 S.F.   | 5 S.F.    | 90 S.F.         | 125 S.F. |

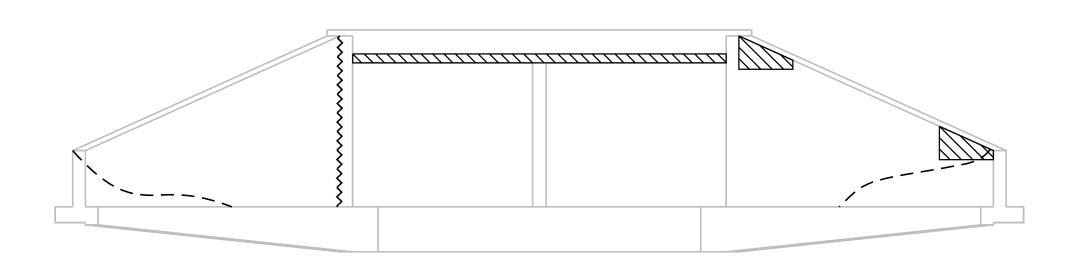

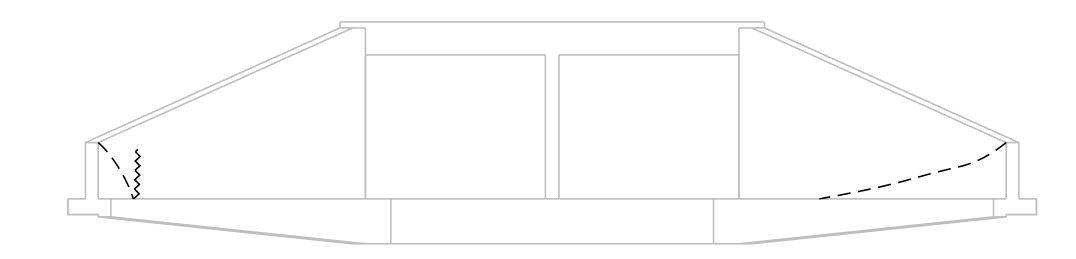

WEST END VIEW

EAST END VIEW

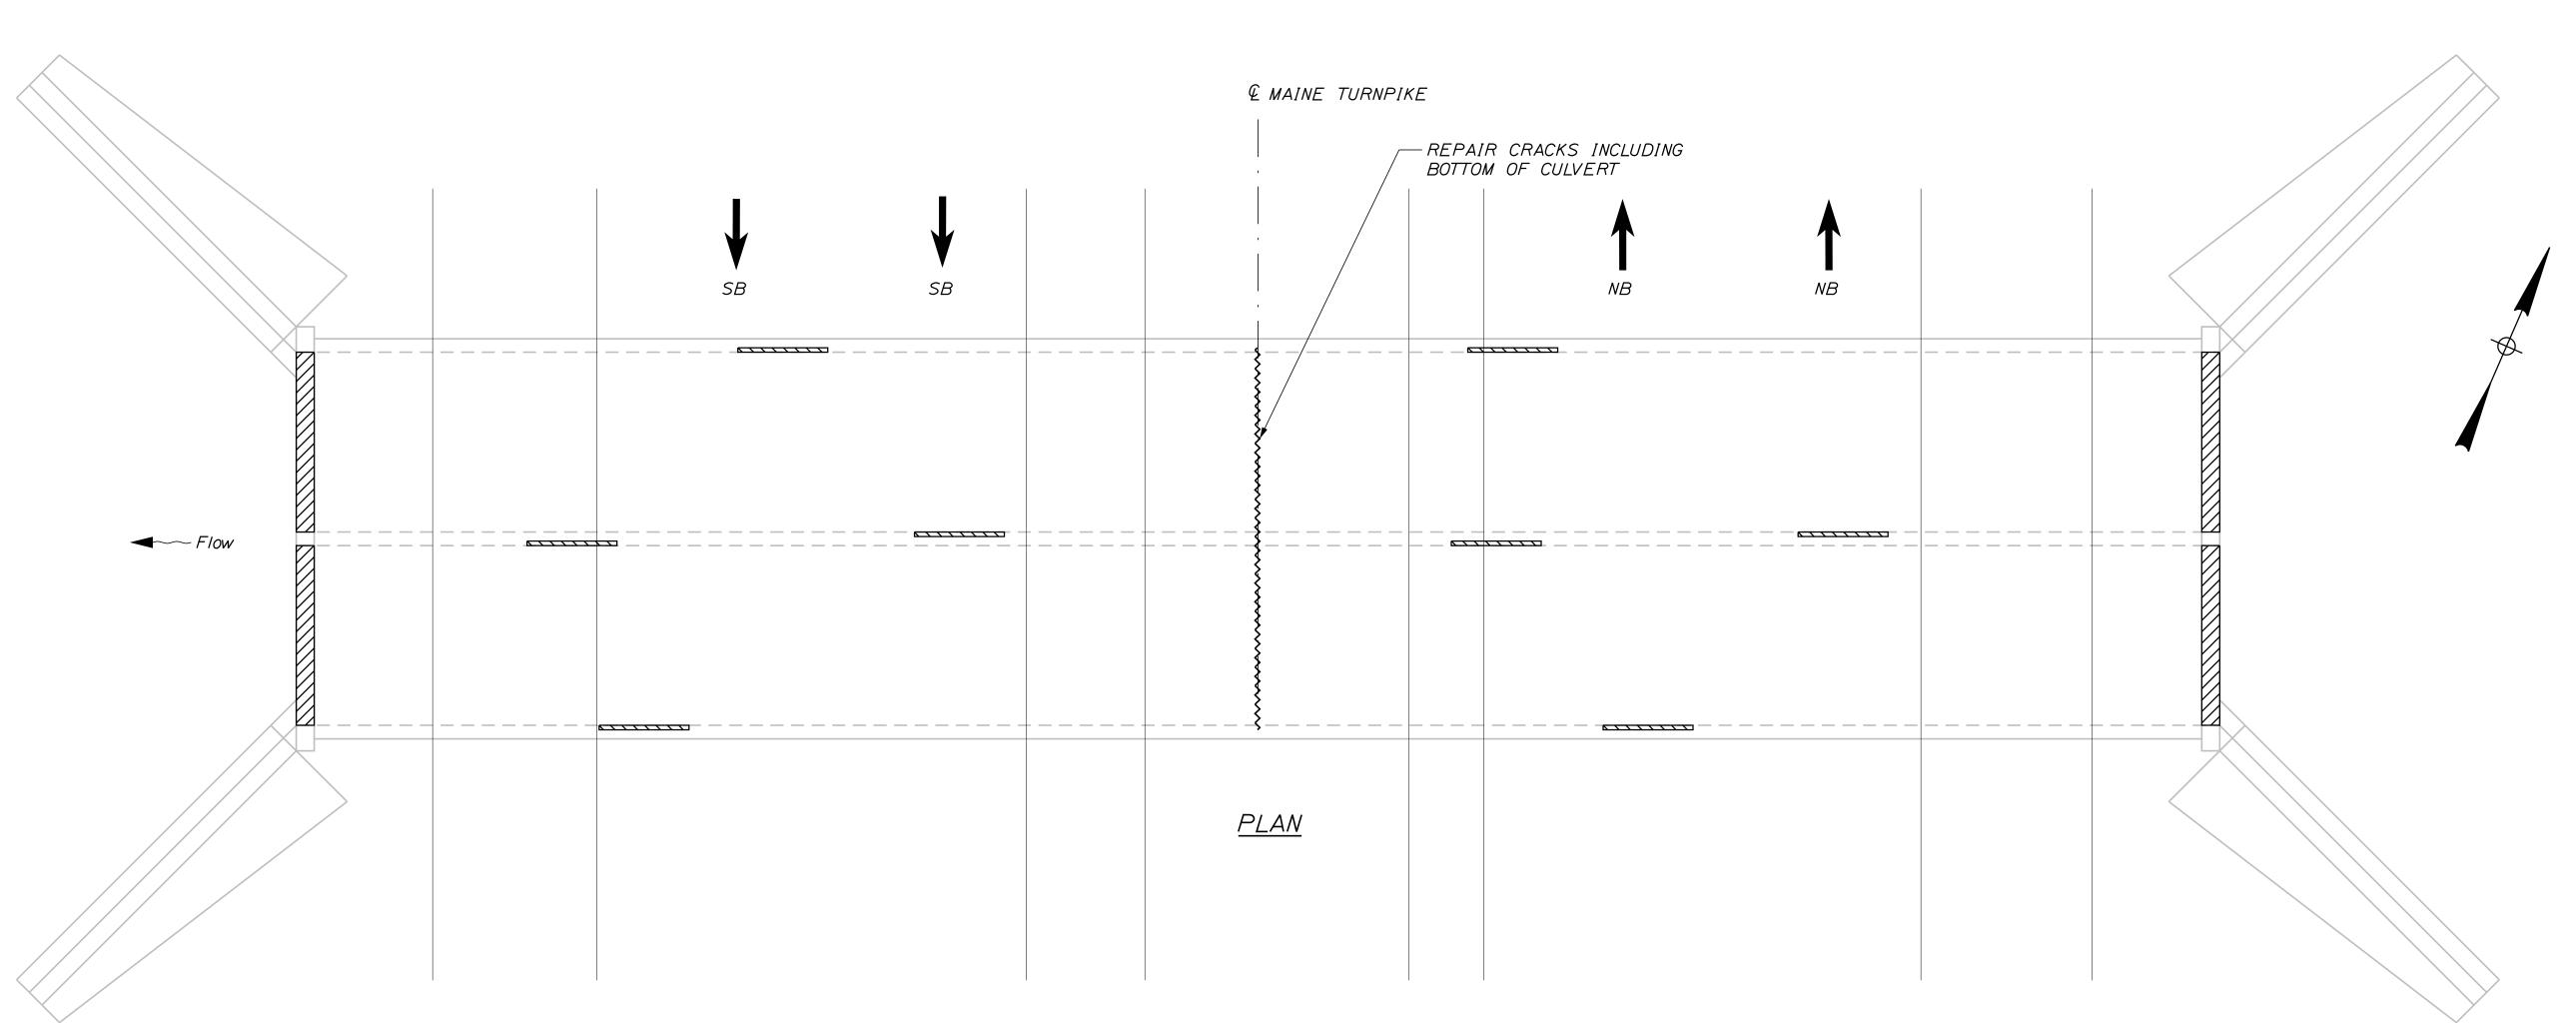

3/16" = 1'-0" T-Y-LININTERNATIONAL By Date Revision CONSULTANT PROJECT MANAGER: DanielS. Myers By Date
DSM 9/2018 Checked BLT 12/2018 In Charge of DSM 1/2019

T.Y. Lin International 12 Northbrook Drive Building A, Suite One Falmouth, Maine 04105 TEL: (207) 781-4721 FAX: (207) 781-4753



THE GOLD STAR MEMORIAL HIGHWAY

NORTHERN BRIDGE REPAIRS & BENNETT ROAD EMERGENCY VEHICLE RAMPS PLEASANT RIVER CULVERT (MILE 62.3)

CULVERT REPAIRS

SHEET NUMBER: PC-03 CONTRACT:2019.11 90 OF 105

|                           |            |              |                                       | TEVT OF        | MENCIONE                                | (INCLIEC) | MUMDED                            | 601          | 0.0    |        |                       |       |
|---------------------------|------------|--------------|---------------------------------------|----------------|-----------------------------------------|-----------|-----------------------------------|--------------|--------|--------|-----------------------|-------|
| IDENTIFI-<br>CATION       |            | E OF<br>GN   | TEXT                                  | LETTER         | WENSIONS<br>VERTICAL                    | ARROW     | NUMBER<br>OF<br>SIGNS<br>REQUIRED | COL<br>BACK- | LEGEND | BORDER | AREA IN<br>SQUARE     | NOTES |
| NUMBER                    |            | HEIGHT       |                                       | HEIGHT         | SPACING                                 | RTE. MKR. | REQUIRED                          | GROUND       | BORDER | RADIUS | FEET                  |       |
| CS-I                      | 48"        | 48"          | EXPECT<br>STOPPED<br>TRAFFIC          | 8C<br>8C<br>8C | 4"<br>4"                                |           | 4                                 | ORANGE       | BLACK  |        | 16.00<br>(64)         |       |
| CS-10                     | 48"        | 48"          | TRUCKS ENTERING                       | 7C<br>7C       | 6"                                      |           | 2                                 | ORANGE       | BLACK  |        | 16.00<br>(32)         |       |
| G20-2                     | 48"        | 24"          | END<br>ROAD WORK                      | CONFOR         | DIMENSIONS<br>RM TO "STA<br>NY SIGNS" - | NDARD     | 4                                 | ORANGE       | BLACK  |        | 8.00<br>(32)          |       |
| G20-5aP                   | 36"        | 24"          | WORK ZONE                             |                |                                         |           | 4                                 | ORANGE       | BLACK  |        | 6.00<br>(24)          |       |
| R2-I<br>(50)              | 48"        | 60"          | SPEED<br>LIMIT<br>50                  |                |                                         |           | 4                                 | WHITE        | BLACK  |        | 20.00<br>(80)         |       |
| R2-6aP                    | 36"        | 24"          | FINES<br>DOUBLE                       |                |                                         |           | 4                                 | WHITE        | BLACK  |        | 6.00<br>(24)          |       |
| R2-I2                     | 36"        | 5 <b>4</b> " | END<br>WORK<br>ZONE<br>SPEED<br>LIMIT |                |                                         |           | 4                                 | WHITE        | BLACK  |        | /3.50<br>(54)         |       |
| W3-4                      | 48"        | 48"          | BE<br>PREPARED<br>TO STOP             |                |                                         |           | 4                                 | ORANGE       | BLACK  |        | 16.00<br>(64)         |       |
| W3-5                      | 48"        | 48"          | SPEED LIMIT 50                        |                |                                         |           | 4                                 | ORANGE       | BLACK  |        | 16.00<br>(64)         |       |
| W4-2<br>(LEFT)<br>(RIGHT) | 48"<br>48" | 48"<br>48"   |                                       | V              | ∇                                       | ∇         | 4<br>4                            | ORANGE       | BLACK  |        | 16.00<br>(64)<br>(64) |       |

| IDENTIFI-<br>CATION<br>NUMBER | SI         | GN<br>HEIGHT | TEXT                                   | TEXT DIMENSIONS (INCHES)  LETTER VERTICAL ARROW  HEIGHT SPACING RTE. MKR. | NUMBER<br>OF<br>SIGNS<br>REQUIRED | COLOR BACK- LEGEND GROUND BORDER | BORDER<br>RADIUS | AREA IN<br>SQUARE<br>FEET  |
|-------------------------------|------------|--------------|----------------------------------------|---------------------------------------------------------------------------|-----------------------------------|----------------------------------|------------------|----------------------------|
| W8-I                          | 48"        | 48"          | BUMP                                   | TEXT DIMENSIONS SHALL CONFORM TO "STANDARD HIGHWAY SIGNS" - 2009          | 4                                 | ORANGE BLACK                     |                  | <i>16.00</i> ( <i>64</i> ) |
| W8-24a                        | 48"        | 48"          | RUMBLE<br>STRIPS<br>AHEAD              |                                                                           | 4                                 | ORANGE BLACK                     |                  | 16.00<br>(64)              |
| WI6-4P                        | 36"        | 30"          | NEXT<br>X FEET                         |                                                                           | 4                                 | ORANGE BLACK                     |                  | 7.50<br>(30)               |
| W20-I<br>(I MILE)<br>(AHEAD)  | 48"<br>48" | 48"<br>48"   | ROAD<br>WORK<br>1 MILE                 |                                                                           | 4 4                               | ORANGE BLACK                     |                  | 16.00<br>(64)<br>(64)      |
| W20-5<br>(RIGHT)<br>(LEFT)    | 48"<br>48" | 48"<br>48"   | RIGHT<br>LANE<br>CLOSED<br>1/2 MILE    |                                                                           | 4 4                               | ORANGE BLACK                     |                  | 16.00<br>(64)<br>(64)      |
| W2I-5                         | 48"        | 48"          | SHOULDER<br>WORK                       |                                                                           | 2                                 | ORANGE BLACK                     |                  | 16.00<br>(32)              |
| W2I-5a<br>(RIGHT)<br>(LEFT)   | 48"<br>48" | 48"<br>48"   | LEFT<br>SHOULDER<br>CLOSED             |                                                                           | 2 2                               | ORANGE BLACK                     |                  | 16.00<br>(32)<br>(32)      |
| W2I-5b<br>(RIGHT)<br>(LEFT)   | 48"<br>48" | 48"<br>48"   | RIGHT<br>SHOULDER<br>CLOSED<br>1000 FT |                                                                           | 2 2                               | ORANGE BLACK                     |                  | 16.00<br>(32)<br>(32)      |

| Sca | le:          |    |      | Designed by | •      |            |                 |     |        |
|-----|--------------|----|------|-------------|--------|------------|-----------------|-----|--------|
|     | NOT TO SCALE |    |      | T-Y         |        | NINTE      | ERNATI          | ON  | AL     |
| No. | Revision     | Ву | Date |             |        |            |                 |     |        |
|     |              |    |      | CONSULTANT  | PROJEC | T MANAGER: | Daniel S. Myers |     |        |
|     |              |    |      |             | Ву     | Date       |                 | Ву  | Date   |
|     |              |    |      | Designed    | TWA    | 1/2019     | Checked         | JJB | 1/2019 |
|     |              | ·  |      | Drawn       | TWA    | 1/2019     | In Charge of    | DSM | 1/2019 |

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# THE GOLD STAR MEMORIAL HIGHWAY


# NORTHERN BRIDGE REPAIRS & BENNETT ROAD EMERGENCY VEHICLE RAMPS

COLE BROOK CULVERT (MILE 65.25) M.O.T. SIGN SUMMARY

SHEET NUMBER: CB-01

CONTRACT:2019.11

MTA PROJECT MANAGER: Ralph C. Norwood, IV

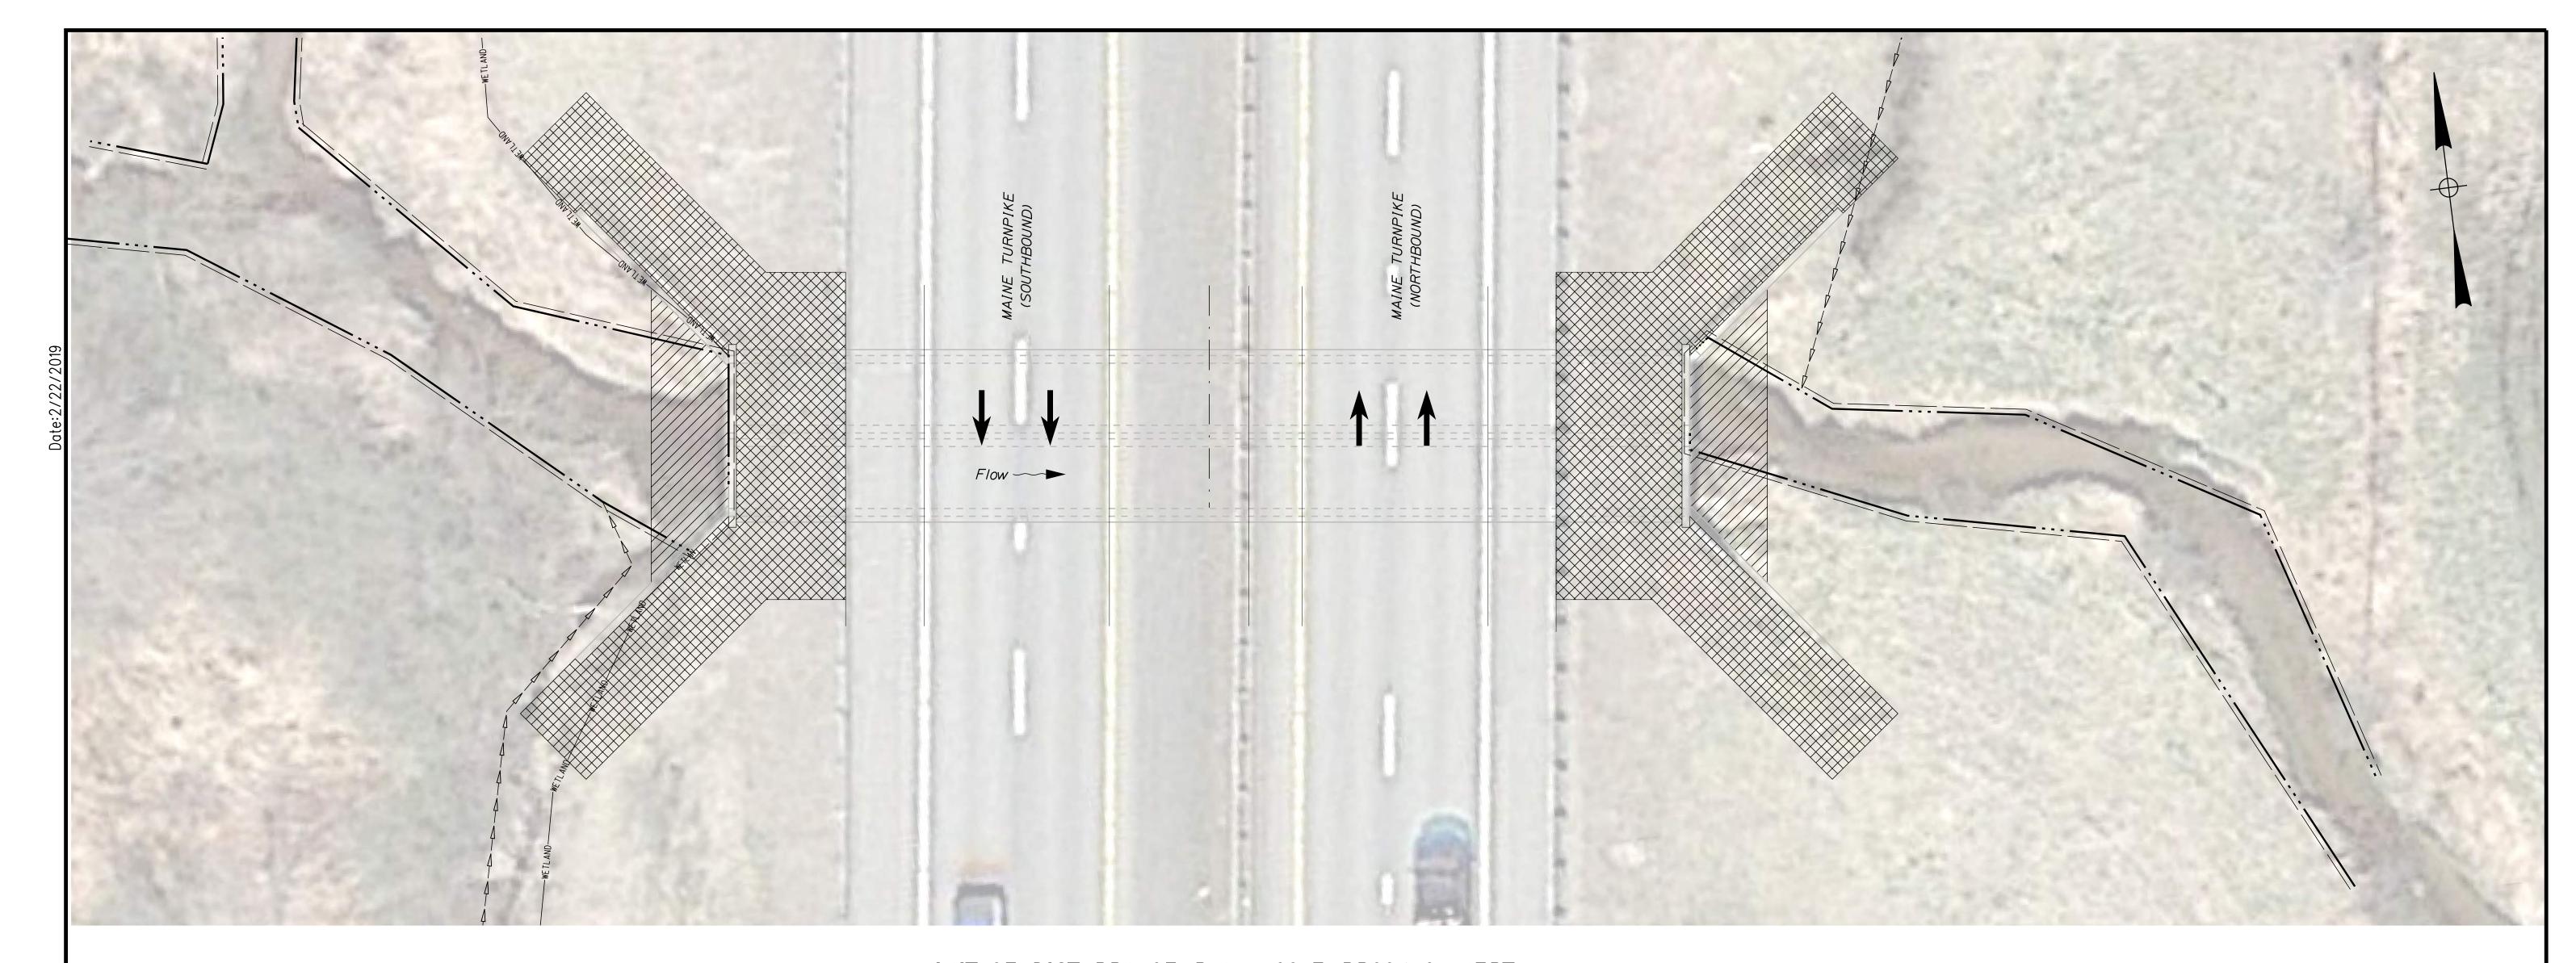

<u>LIMIT OF DISTURBANCE PLAN - COLE BROOK CULVERT</u>

LEGEND:



COFFERDAM LIMIT OF DISTURBANCE



CONTRACTOR'S LIMIT OF DISTURBANCE
AREA FOR ACCESS AND STORAGE

### AREAS:

COFFERDAM LIMIT OF DISTURBANCE:

COLD BROOK CULVERT = 0.013 ACRES

CONTRACTOR'S LIMIT OF DISTURBANCE AREA FOR ACCESS AND STORAGE:

COLD BROOK CULVERT = 0.064 ACRES


#### NOTES:

CONTRACT:2019.11

- I. EROSION AND SEDIMENT CONTROL DEVICES REQUIRED FOR THE CONTRACTOR'S ACCESS LOCATIONS AND STORAGE AREAS WILL NOT BE MEASURED FOR PAYMENT.
- 2. SEE SPECIFICATIONS FOR CONTRACTOR'S SUBMITTAL REQUIREMENTS IF INCREASING THE LIMITS OF DISTURBANCE TO THE PROJECT ESTIMATED QUANTITIES.

| <u>-[0[</u> | Scale: |           |    |      | Designed b | y:     |           |                   |     |        |   |
|-------------|--------|-----------|----|------|------------|--------|-----------|-------------------|-----|--------|---|
| TA\XXX_LOD  |        | 1'' = 10' |    |      | T-Y        | 'LII   | NINT      | ERNATI            | ON  | AL     | Ţ |
| \MS         | No.    | Revision  | Ву | Date |            |        |           |                   |     |        |   |
| ::<br>e:    |        |           |    |      | CONSULTANT | PROJEC | T MANAGER | : Daniel S. Myers |     |        |   |
| an          |        |           |    |      |            | Ву     | Date      |                   | Ву  | Date   |   |
| ilename:    |        |           |    |      | Designed   | DSM    | 1/2019    | Checked           | DSM | 1/2019 |   |
| ت           |        |           |    |      | Drawn      | JJL    | 1/2019    | In Charge of      | DSM | 1/2019 |   |

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THE GOLD STAR MEMORIAL HIGHWAY

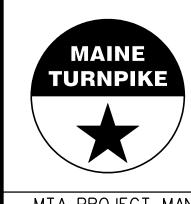NORTHERN BRIDGE REPAIRS & BENNETT ROAD EMERGENCY VEHICLE RAMPS COLE BROOK CULVERT (MILE 65.25) LIMIT OF DISTURBANCE.

SHEET NUMBER: CB-02

MTA PROJECT MANAGER: Ralph C. Norwood, IV

<u>LEGEND:</u>

<u>NOTE:</u>

LIMIT OF CONCRETE SURFACE REPAIRS

LIMIT OF EPOXY INJECTED CRACK REPAIRS


EXISTING CONCRETE


--- EXISTING AND PROPOSED GROUND

I. FOR PROCEDURAL NOTES SEE SHEET "BRIDGE GENERAL NOTES"

COLE BROOK CULVERT (MILE 65.2) ESTIMATED QUANTITY OF REPAIRS

WINGWALLS HEADWALLS CULVERT BARRELS TOTAL275 L.F. CRACK REPAIRS 10 L.F. 43 L.F. 222 L.F. CONCRETE REPAIRS 0 S.F. 0 S.F. 100 S.F. 100 S.F.

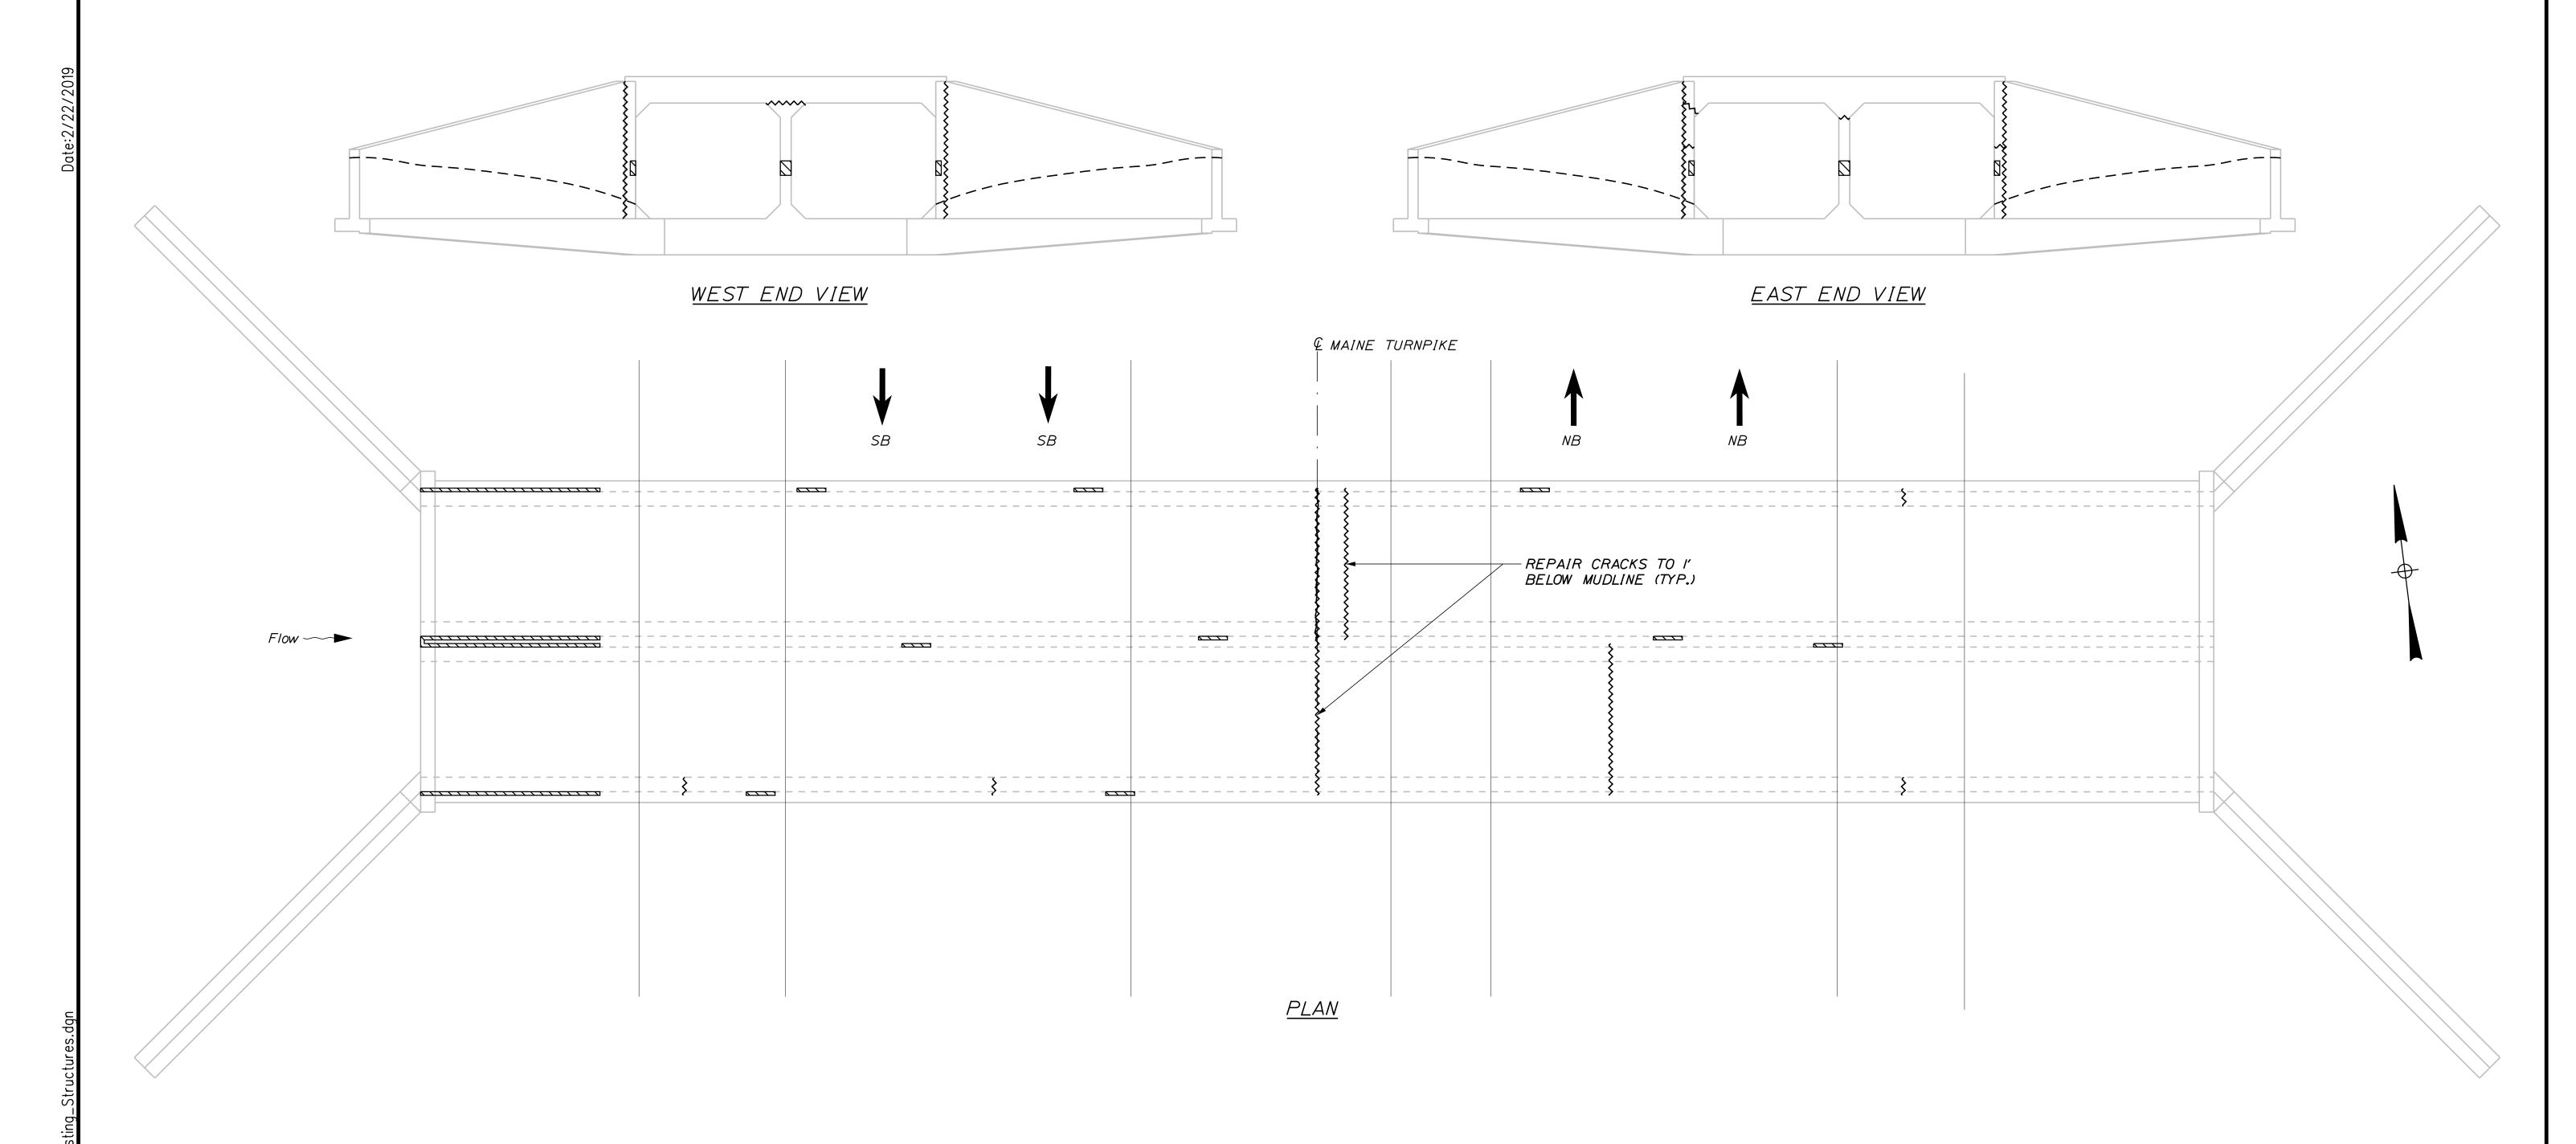

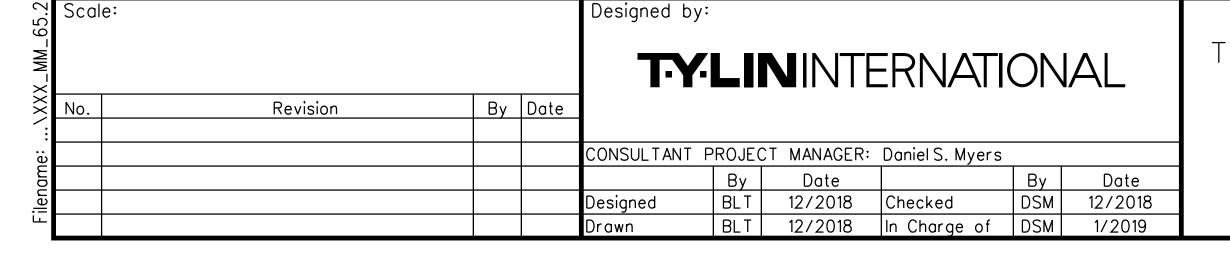

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THE GOLD STAR MEMORIAL HIGHWAY

NORTHERN BRIDGE REPAIRS & BENNETT ROAD EMERGENCY VEHICLE RAMPS

COLE BROOK CULVERT (MILE 65.25) CULVERT REPAIRS

CONTRACT:2019.11

SHEET NUMBER: CB-03

MTA PROJECT MANAGER: Ralph C. Norwood, IV

| IDENTIFI-<br>CATION<br>NUMBER | SI         | OF<br>GN<br>HEIGHT | TEXT                                  | TEXT<br>LETTE<br>HEIGH | DIN<br>R<br>HT | MENSIONS<br>VERTICAL<br>SPACING      | (INCHES)<br>ARROW<br>RTE. MKR. | NUMBER<br>OF<br>SIGNS<br>REQUIRED | COL<br>BACK-<br>GROUND | OR<br>LEGEND<br>BORDER | BORDER<br>RADIUS | AREA IN<br>SQUARE<br>FEET | NOTES |
|-------------------------------|------------|--------------------|---------------------------------------|------------------------|----------------|--------------------------------------|--------------------------------|-----------------------------------|------------------------|------------------------|------------------|---------------------------|-------|
| CS-I                          | 48"        | 48"                | EXPECT<br>STOPPED<br>TRAFFIC          | 8C<br>8C<br>8C         |                | 4"<br>4"                             |                                | 4                                 | ORANGE                 | BLACK                  |                  | 16.00<br>(64)             |       |
| CS-10                         | 48"        | 48"                | TRUCKS<br>ENTERING                    | 7C<br>7C               |                | 6"                                   |                                | 2                                 | ORANGE                 | BLACK                  |                  | 16.00<br>(32)             |       |
| G20-2                         | 48"        | 24"                | END<br>ROAD WORK                      | CONF                   | FOR            | IMENSIONS<br>M TO "STA<br>Y SIGNS" - | NDARD                          | 4                                 | ORANGE                 | BLACK                  |                  | 8.00<br>(32)              |       |
| G20-5aP                       | 36"        | 24"                | WORK ZONE                             |                        |                |                                      |                                | 4                                 | ORANGE                 | BLACK                  |                  | 6.00<br>(24)              |       |
| R2-I<br>(50)                  | 48"        | 60"                | SPEED<br>LIMIT<br>50                  |                        |                |                                      |                                | 4                                 | WHITE                  | BLACK                  |                  | 20.00<br>(80)             |       |
| R2-6aP                        | 36"        | 24"                | FINES<br>DOUBLE                       |                        |                |                                      |                                | 4                                 | WHITE                  | BLACK                  |                  | 6.00<br>(24)              |       |
| R2-I2                         | 36"        | 54"                | END<br>WORK<br>ZONE<br>SPEED<br>LIMIT |                        |                |                                      |                                | 4                                 | WHITE                  | BLACK                  |                  | 13.50<br>(54)             |       |
| W3-4                          | 48"        | 48"                | BE<br>PREPARED<br>TO STOP             |                        |                |                                      |                                | 4                                 | ORANGE                 | BLACK                  |                  | 16.00<br>(64)             |       |
| W3-5                          | 48"        | 48"                | SPEED LIMIT 50                        |                        |                |                                      |                                | 4                                 | ORANGE                 | BLACK                  |                  | 16.00<br>(64)             |       |
| W4-2<br>(LEFT)<br>(RIGHT)     | 48"<br>48" | 48"<br>48"         |                                       | V                      |                | V                                    |                                | 4 4                               | ORANGE                 | BLACK                  |                  | 16.00<br>(64)<br>(64)     |       |

| IDENTIFI-<br>CATION<br>NUMBER | SI         | OF<br>GN<br>HEIGHT | TEXT                                   | TEXT L<br>LETTER<br>HEIGHT | DIMENSION<br>R VERTIC<br>SPACIN    | IS (INCH<br>AL ARI<br>NG RTE. | HES)<br>ROW<br>MKR. | NUMBER<br>OF<br>SIGNS<br>REQUIRED | COL<br>BACK-<br>GROUND | OR<br>LEGEND<br>BORDER | BORDER<br>RADIUS | AREA IN<br>SQUARE<br>FEET | NOTES |
|-------------------------------|------------|--------------------|----------------------------------------|----------------------------|------------------------------------|-------------------------------|---------------------|-----------------------------------|------------------------|------------------------|------------------|---------------------------|-------|
| W8-/                          | 48"        | 48"                | BUMP                                   | CONF                       | DIMENSIC<br>ORM TO "S<br>WAY SIGNS | DNS SHA<br>STANDAR            | ALL<br>PD           | 4                                 | ORANGE                 | BLACK                  |                  | 16.00<br>(64)             |       |
| W8-24a                        | 48"        | 48"                | RUMBLE<br>STRIPS<br>AHEAD              |                            |                                    |                               |                     | 4                                 | ORANGE                 | BLACK                  |                  | 16.00<br>(64)             |       |
| WI6-4P                        | 36"        | <i>30</i> "        | NEXT<br>1000 FEET                      |                            |                                    |                               |                     | 4                                 | ORANGE                 | BLACK                  |                  | 7.50<br>(30)              |       |
| W2O-I<br>(I MILE)<br>(AHE AD) | 48"<br>48" | 48"<br>48"         | ROAD<br>WORK<br>1 MILE                 |                            |                                    |                               |                     | 4 4                               | ORANGE                 | BLACK                  |                  | 16.00<br>(64)<br>(64)     |       |
| W20-5<br>(RIGHT)<br>(LEFT)    | 48"<br>48" | 48"<br>48"         | RIGHT<br>LANE<br>CLOSED<br>1/2 MILE    |                            |                                    |                               |                     | 4 4                               | ORANGE                 | BLACK                  |                  | 16.00<br>(64)<br>(64)     |       |
| W2I-5                         | 48"        | 48"                | SHOULDER<br>WORK                       |                            |                                    |                               |                     | 2                                 | ORANGE                 | BLACK                  |                  | 16.00<br>(32)             |       |
| W2I-5a<br>(RIGHT)<br>(LEFT)   | 48"<br>48" | 48"<br>48"         | LEFT<br>SHOULDER<br>CLOSED             |                            |                                    |                               |                     | 2<br>2                            | ORANGE                 | BLACK                  |                  | 16.00<br>(32)<br>(32)     |       |
| W2I-5b<br>(RIGHT)<br>(LEFT)   | 48"<br>48" | 48"<br>48"         | RIGHT<br>SHOULDER<br>CLOSED<br>1000 FT | V                          | V                                  |                               | ∇                   | 2 2                               | ORANGE                 | BLACK                  |                  | 16.00<br>(32)<br>(32)     |       |

CONTRACT:2019.11

| ا<br>د | Scale: |              |    |      | Designed by | <b>/</b> : |            |                 |     |        |
|--------|--------|--------------|----|------|-------------|------------|------------|-----------------|-----|--------|
|        |        | NOT TO SCALE |    |      | T-Y         | LII        | NINTE      | ERNATI          | ON  | AL     |
|        | No.    | Revision     | Ву | Date |             |            |            |                 |     |        |
|        |        |              |    |      | CONSULTANT  | PROJEC     | T MANAGER: | Daniel S. Myers |     |        |
|        |        |              |    |      |             | Ву         | Date       |                 | Ву  | Date   |
|        |        |              |    |      | Designed    | TWA        | 1/2019     | Checked         | JJB | 1/2019 |
|        |        |              |    |      | Drawn       | TWA        | 1/2019     | In Charge of    | DSM | 1/2019 |

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# THE GOLD STAR MEMORIAL HIGHWAY


NORTHERN BRIDGE REPAIRS & BENNETT ROAD EMERGENCY VEHICLE RAMPS

FOSTER BROOK CULVERT (MILE 72.9) M.O.T. SIGN SUMMARY

SHEET NUMBER: FB-01

94 OF 105

MTA PROJECT MANAGER: Ralph C. Norwood, IV

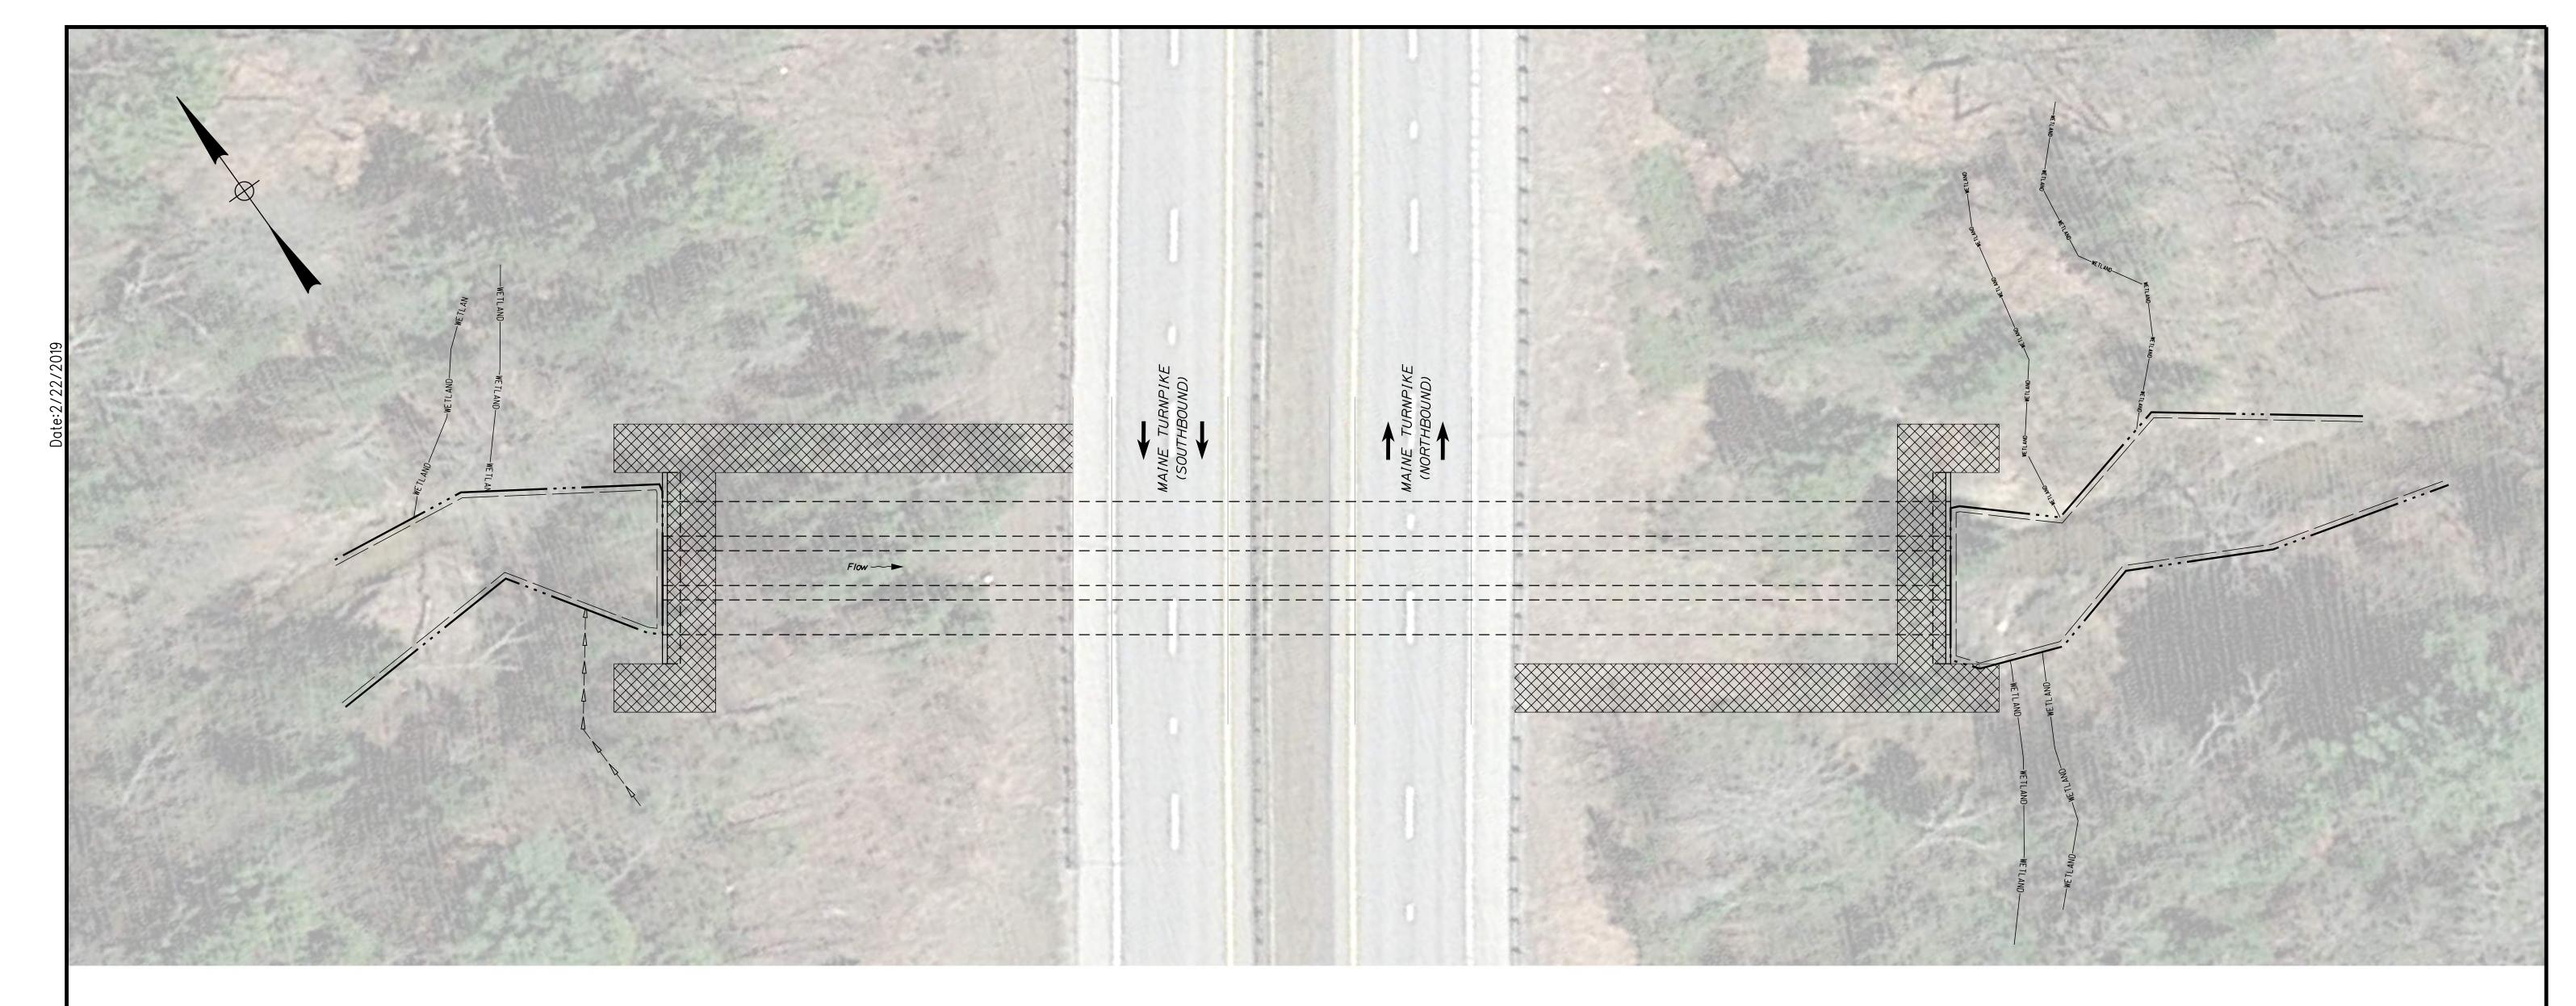

#### <u>LIMIT OF DISTURBANCE PLAN - FOSTER BROOK CULVERT</u>

#### <u>LEGEND:</u>

CONTRACT LIMIT OF DISTURBANCE

CONTRACTOR'S LIMIT OF DISTURBANCE

AREA FOR ACCESS AND STORAGE

# AREAS:

CONTRACT LIMIT OF DISTURBANCE:

FOSTER BROOK CULVERT = 0.00 ACRES CONTRACTOR'S LIMIT OF DISTURBANCE AREA FOR ACCESS AND STORAGE:

FOSTER BROOK CULVERT = 0.07 ACRES

#### NOTES:

CONTRACT:2019.11

- I. EROSION AND SEDIMENT CONTROL DEVICES REQUIRED FOR THE CONTRACTOR'S ACCESS LOCATIONS AND STORAGE AREAS WILL NOT BE MEASURED FOR PAYMENT.
- 2. SEE SPECIFICATIONS FOR CONTRACTOR'S SUBMITTAL REQUIREMENTS IF INCREASING THE LIMITS OF DISTURBANCE TO THE PROJECT ESTIMATED QUANTITIES.

| -L0         | Scal | e:            |    |      | Designed b | y:     |           |                   |     |        |   |
|-------------|------|---------------|----|------|------------|--------|-----------|-------------------|-----|--------|---|
| STA\XXX_LOI |      | 1/16" = 1'-0" |    |      | T-\        | /LII   | VINT      | ERNATI            | ON  | AL     | ⊤ |
| .VMS        | No.  | Revision      | Ву | Date | ]          |        |           |                   |     |        |   |
| :<br>:e:    |      |               |    |      | CONSULTANT | PROJEC | T MANAGER | : Daniel S. Myers |     |        | 1 |
| g           |      |               |    |      |            | Ву     | Date      |                   | Ву  | Date   |   |
| ilename:    |      |               |    |      | Designed   | DSM    | 1/2019    | Checked           | DSM | 1/2019 |   |
| ᇤ           |      |               |    |      | Drawn      | JJL    | 1/2019    | In Charge of      | DSM | 1/2019 | 1 |

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THE GOLD STAR MEMORIAL HIGHWAY

NORTHERN BRIDGE REPAIRS & BENNETT ROAD EMERGENCY VEHICLE RAMPS


FOSTER BROOK CULVERT (MILE 72.9) LIMIT OF DISTURBANCE

SHEET NUMBER: FB-02

MTA PROJECT MANAGER: Ralph C. Norwood, IV

#### NOTES:

- I. PIPE TIES TO BE INSTALLED AT FIRST THREE JOINT LOCATIONS AT BOTH INLET AND OUTLET OF CULVERT BARRELS UNLESS JOINT IS COVERED BY SLIP-LINED CMP.
- 2. EACH JOINT TO BE STABILIZED BY 2 PIPE TIES ON THE UPPER PORTION OF THE JOINT AS SHOWN.
- 3. PIPE TIES TO BE PAID FOR UNDER ITEM 603.55, "CONCRETE PIPE

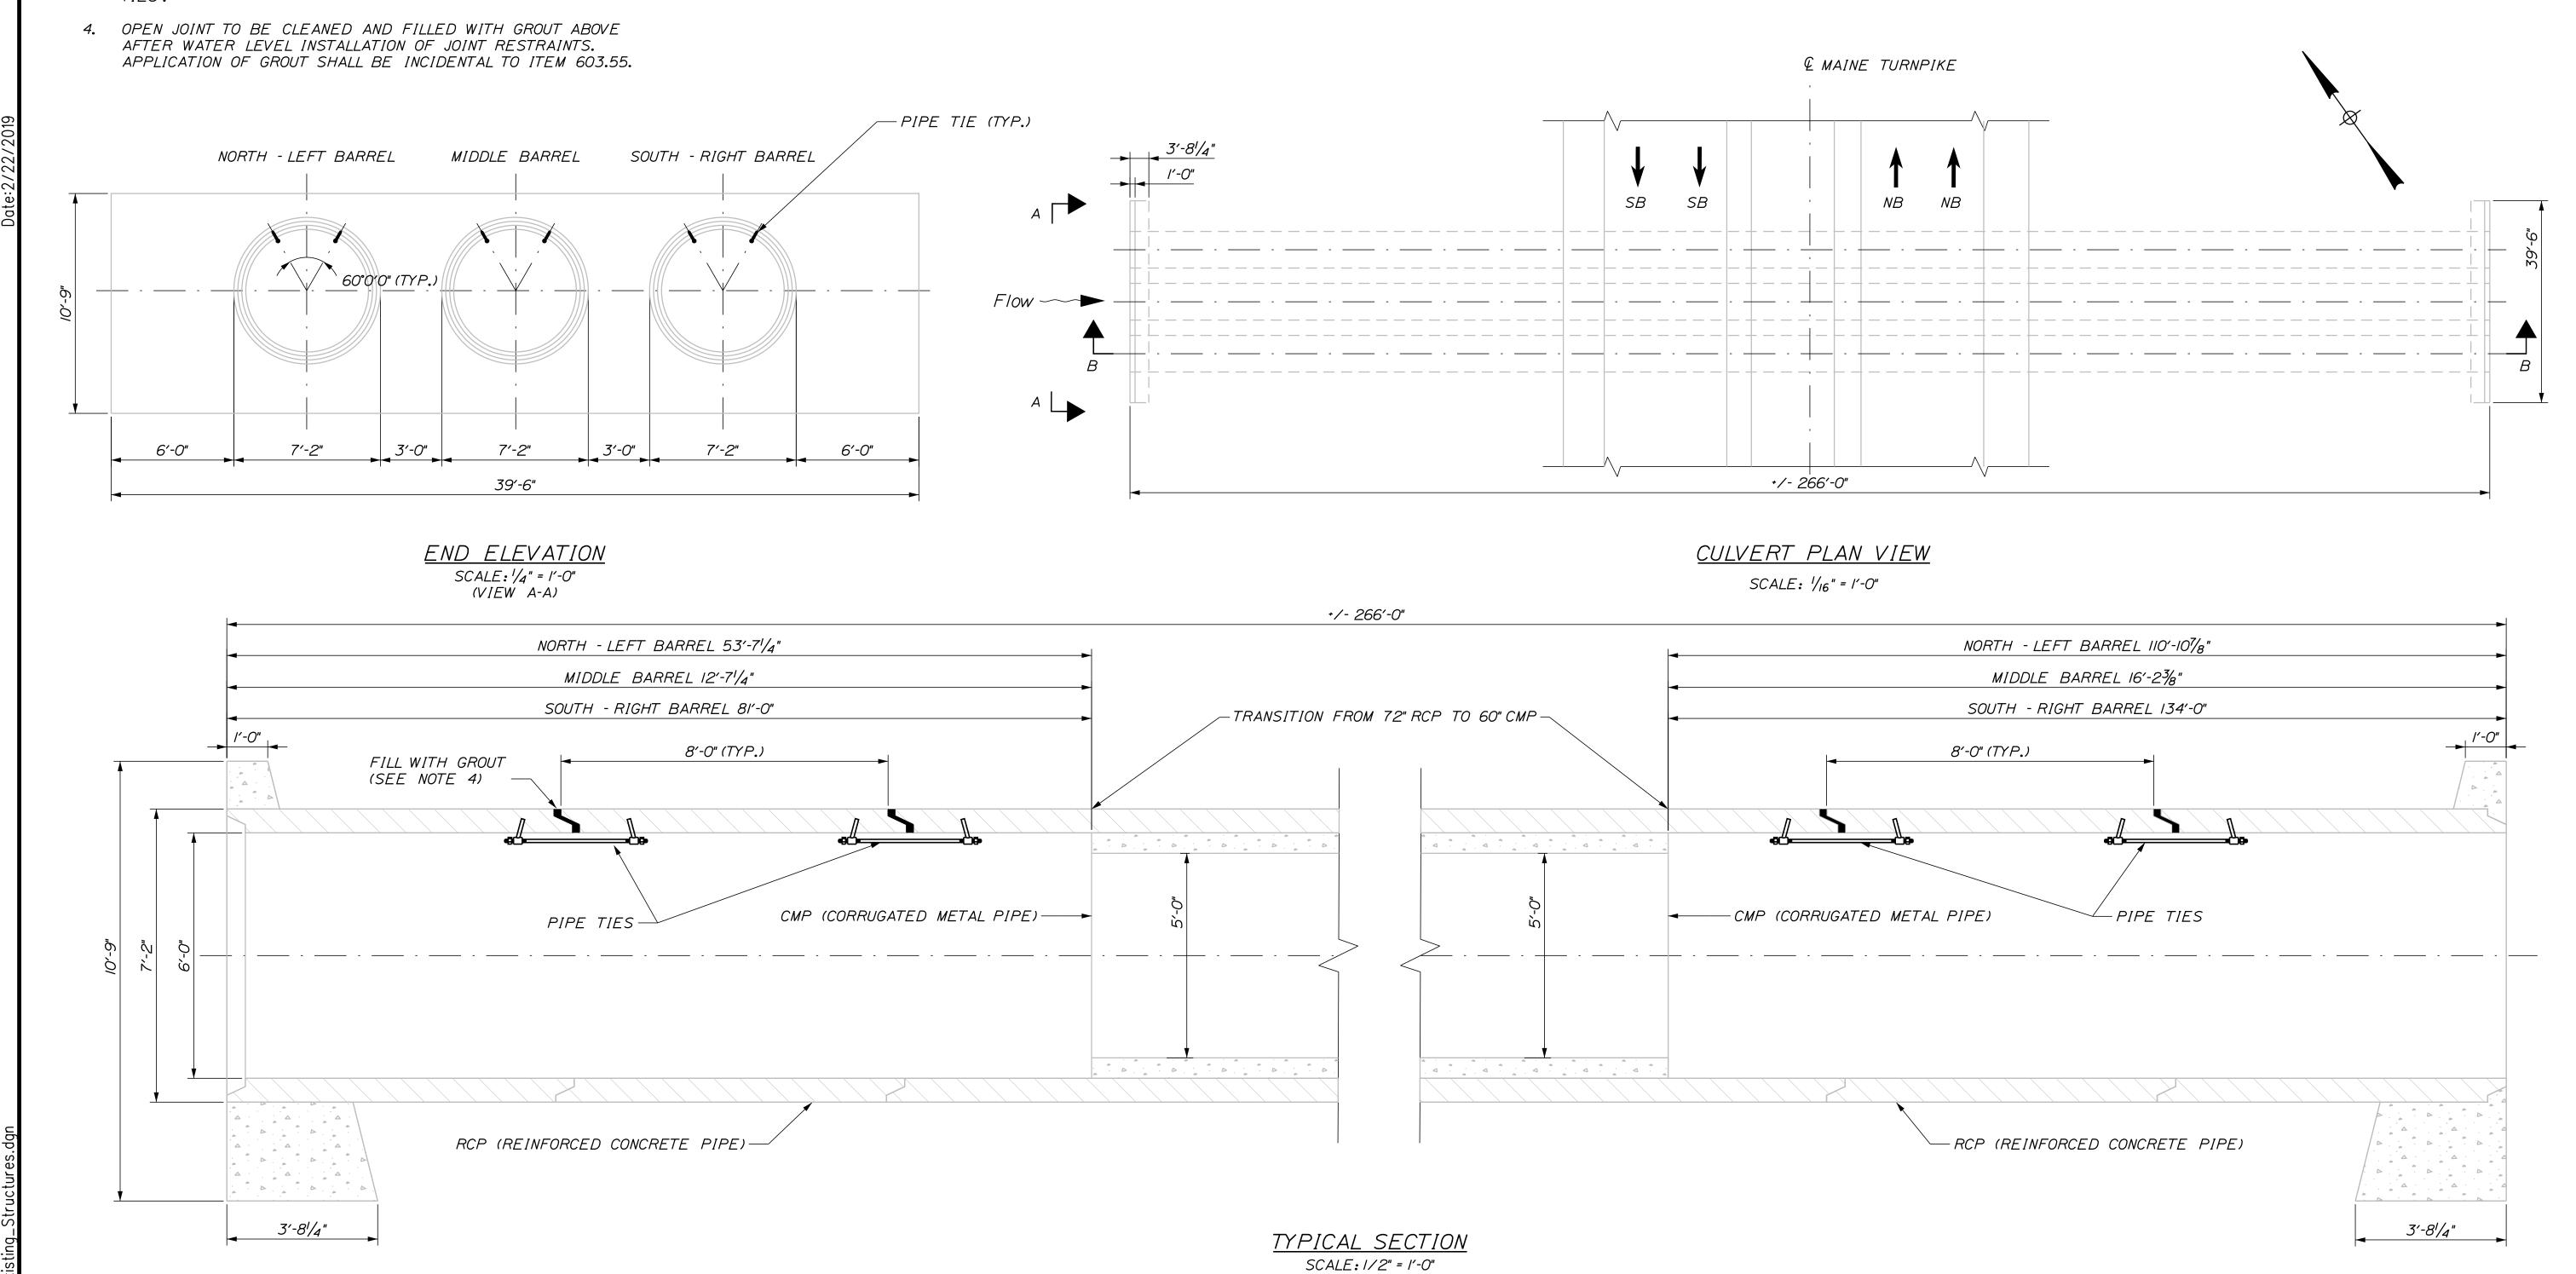

Designed by: Scale: AS NOTED T-Y-LININTERNATIONAL By Date Revision CONSULTANT PROJECT MANAGER: DanielS. Myers By Date JJL 12/2018 Checked DSM 12/2018 Designed JJL 12/2018 In Charge of DSM 1/2019

T.Y. Lin International 12 Northbrook Drive Building A, Suite One Falmouth, Maine 04105 TEL: (207) 781-4721 FAX: (207) 781-4753



THE GOLD STAR MEMORIAL HIGHWAY


NORTHERN BRIDGE REPAIRS & BENNETT ROAD EMERGENCY VEHICLE RAMPS

FOSTER BROOK (MILE 72.9) CULVERT REPAIRS

SHEET NUMBER: FB-03

MTA PROJECT MANAGER: Ralph C. Norwood, IV

CONTRACT:2019.11 96 OF 105

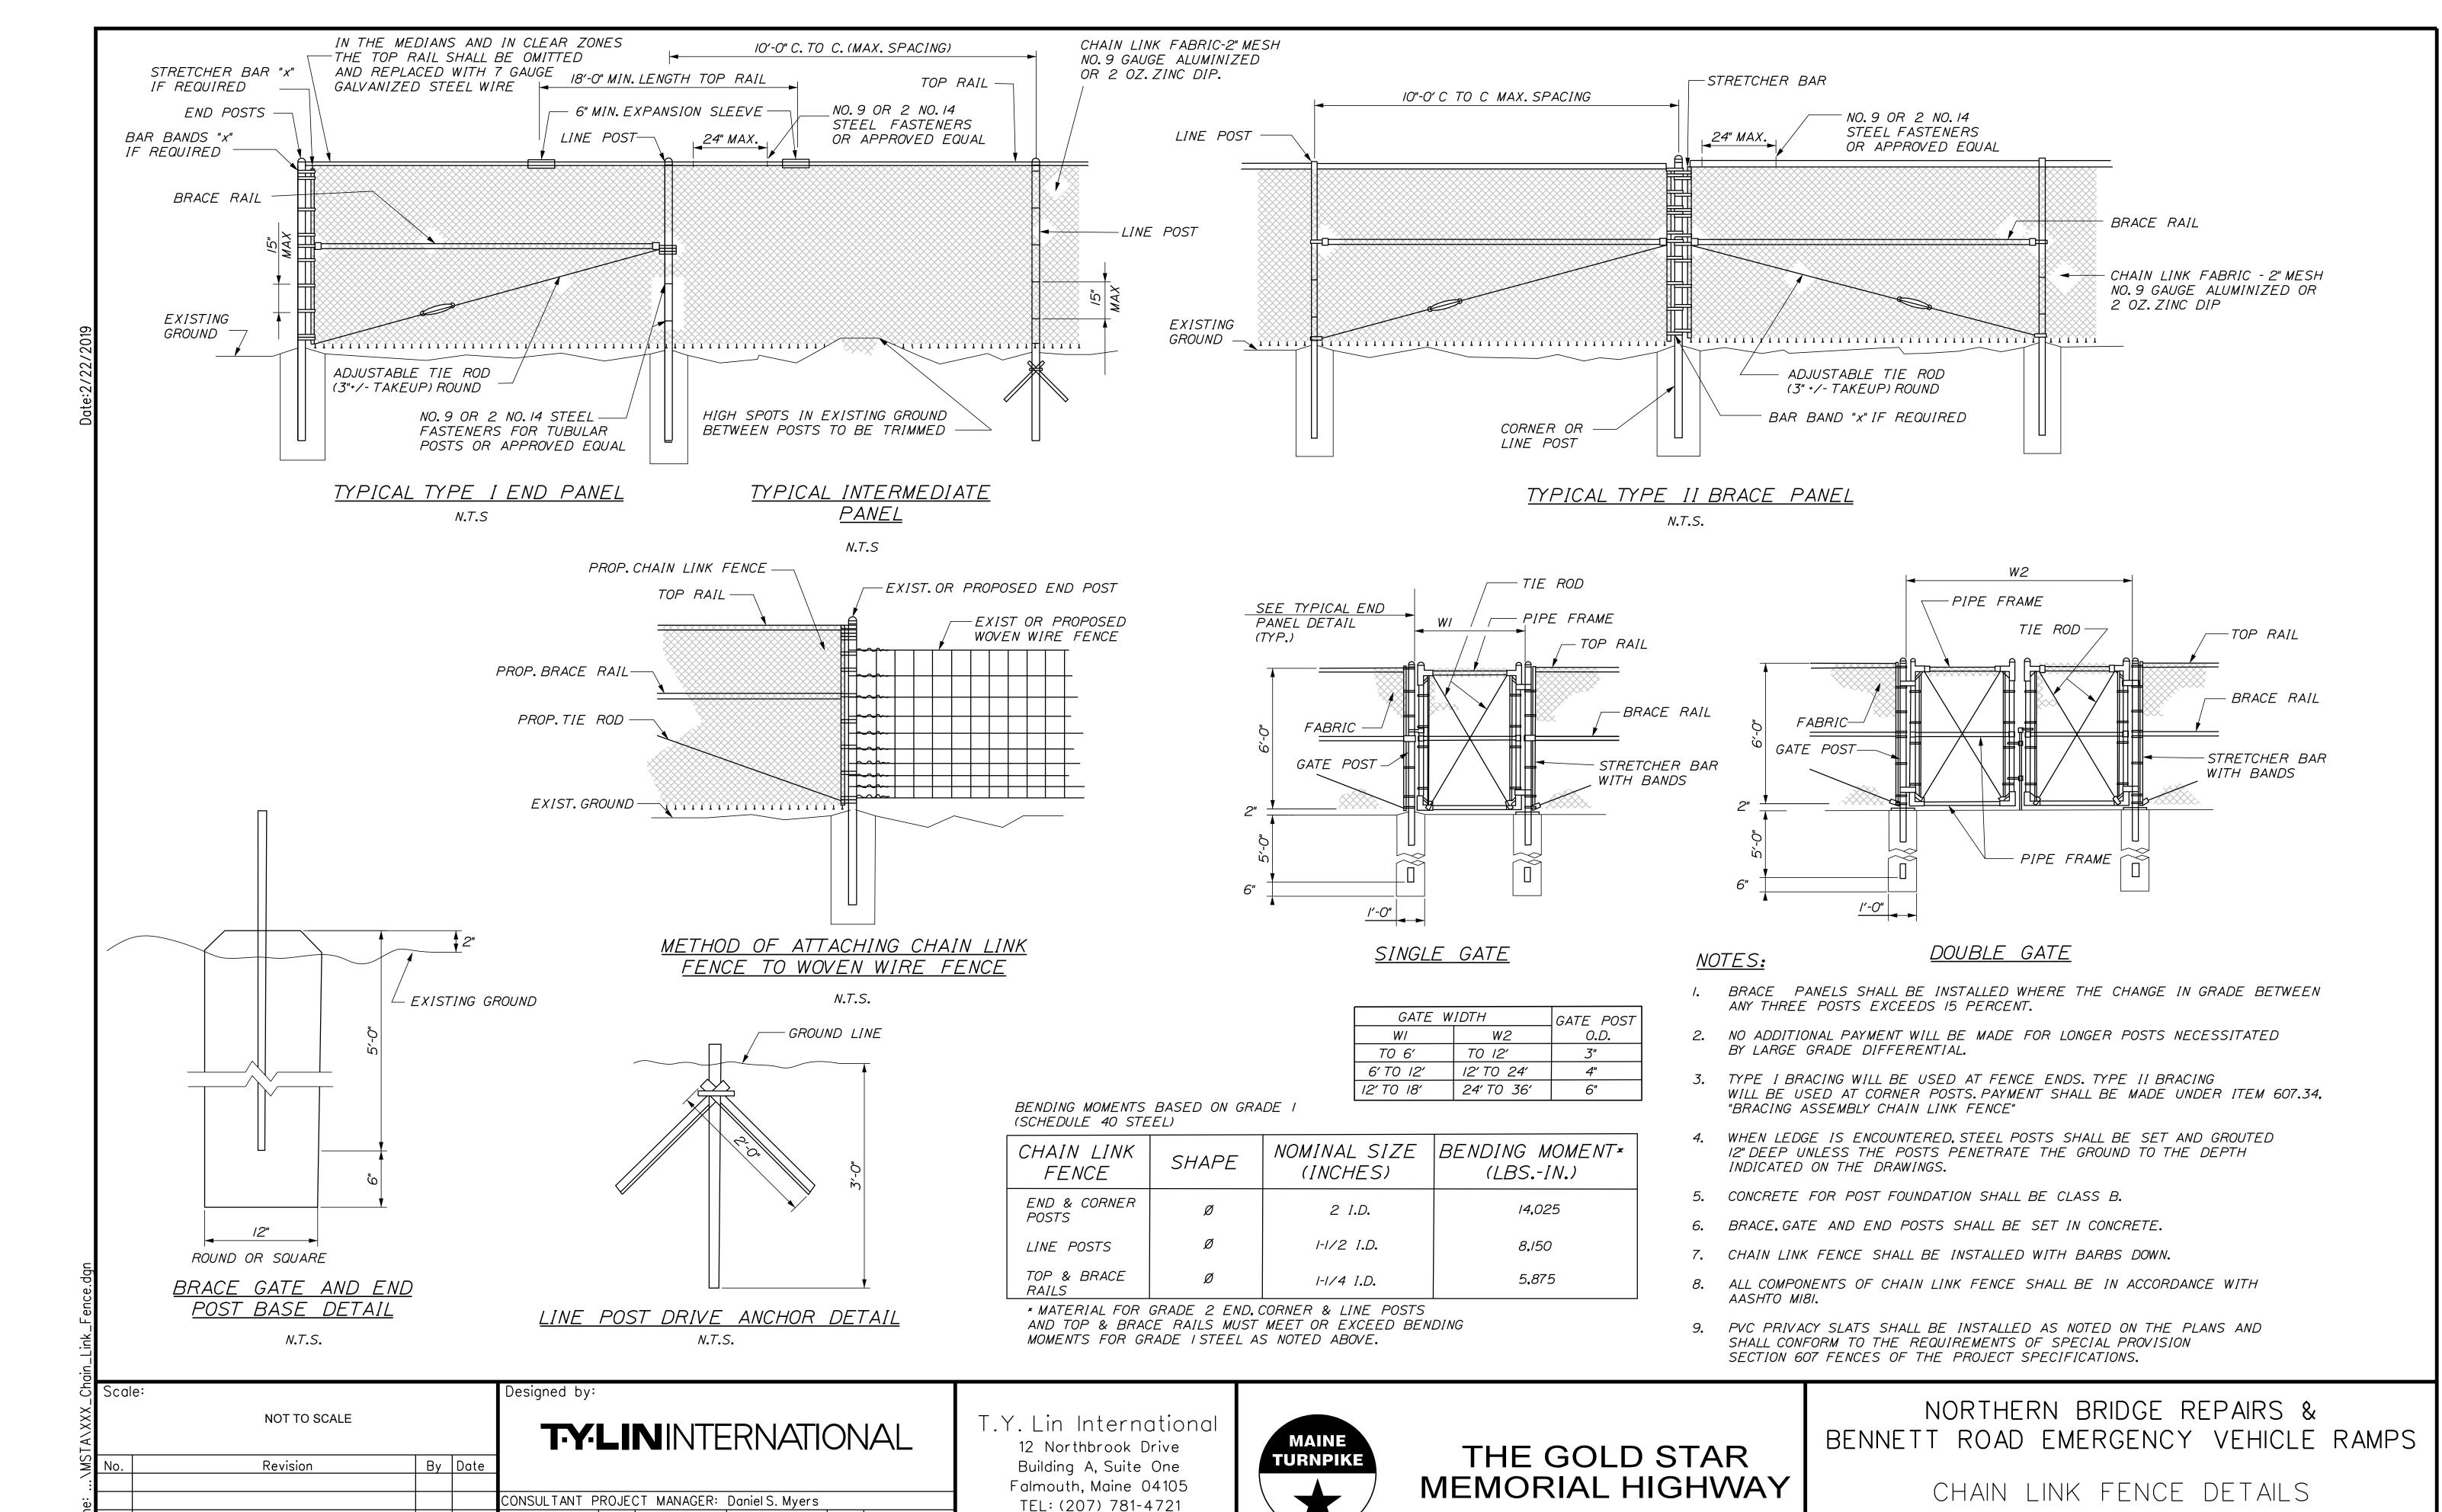

By

TSK

Date

1/2019

1/2019

FAX: (207) 781-4753

Date

1/2019

1/2019

Checked

In Charge of DSM

TSK

Designed


SHEET NUMBER: DET-01 97 OF 105


CONTRACT:2019.11

MTA PROJECT MANAGER: Ralph C. Norwood, IV


#### GENERAL NOTES:


- I. SOIL ANCHOR TUBES INSTALLED AS PART OF CAT, FLEAT OR TRAILING TERMINAL ENDS SHALL NOT PROTRUDE FROM THE GROUND MORE THAN 31#2". ADDITIONAL SITE GRADING MAY BE REQUIRED TO ADJUST SOIL TUBE REVEAL AND IF REQUIRED SHALL NOT DIRECT STORMWATER SURFACE DRAINAGE TOWARDS THE SHOULDER OR TRAVEL WAY. ADDITIONAL SITE GRADING SHALL BE INCIDENTAL TO THE END TERMINAL INSTALLATION.
- 2. TRANSITION RAIL HEIGHT ON TERMINAL END-ANCHORED ENDS FROM 271#2" AT THE END OF THE RAIL TO 30" HEIGHT OVER A 25 LINEAR FOOT LENGTH.
- 3. I" HOLE IN CONCRETE SHALL BE FORMED BY A METHOD APPROVED BY THE ENGINEER.

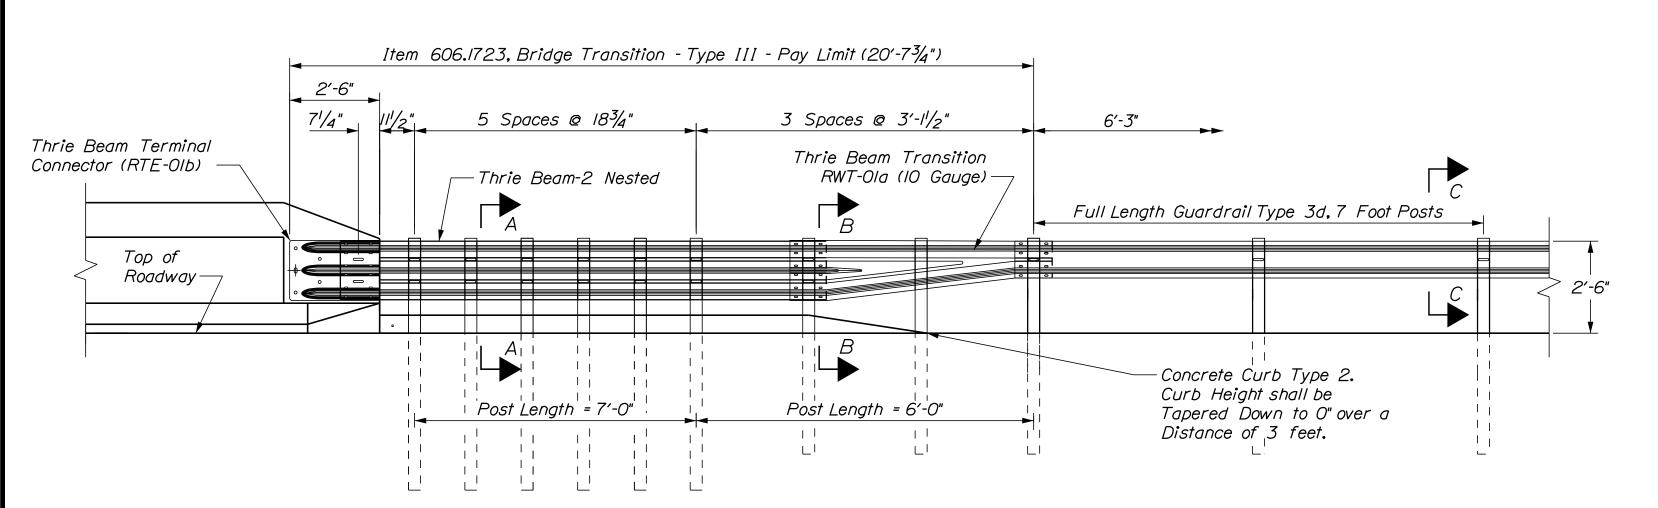


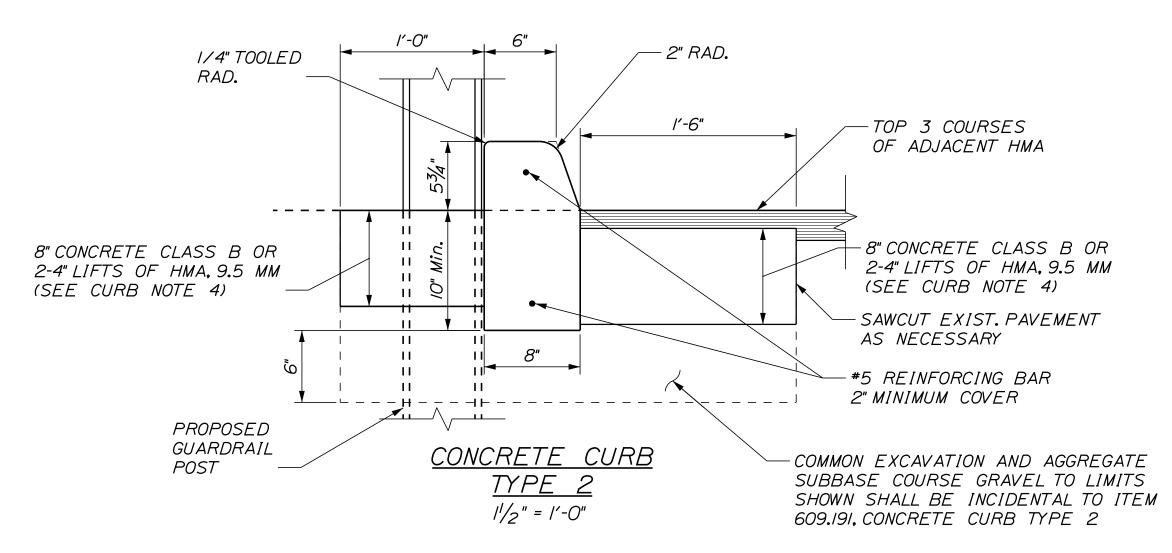

CONTRACT:2019.11

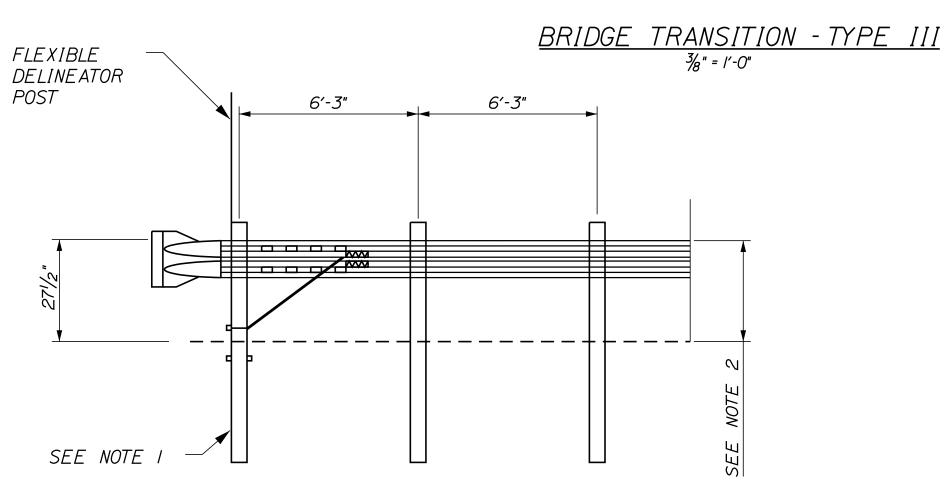

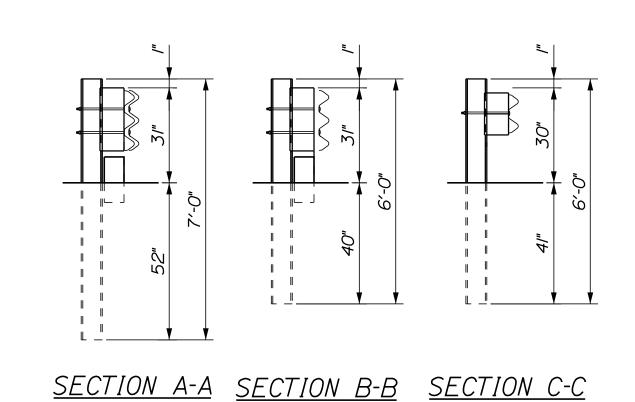

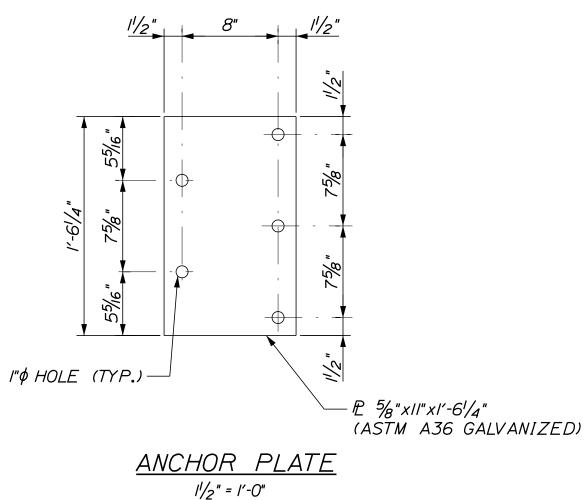

TERMINAL END - ANCHORED END - 31" W-BEAM GUARDRAIL (<u>ITEM 606.1351)</u>

NTS

Designed

By Date

Revision

Scale:

Designed by: T-Y-LININTERNATIONAL CONSULTANT PROJECT MANAGER: DanielS. Myers Ву Date

Checked

In Charge of DSM

TSK

1/2019

1/2019

1/2019

1/2019

T.Y. Lin International 12 Northbrook Drive Building A, Suite One Falmouth, Maine 04105 TEL: (207) 781-4721 FAX: (207) 781-4753



THE GOLD STAR MEMORIAL HIGHWAY

NORTHERN BRIDGE REPAIRS & BENNETT ROAD EMERGENCY VEHICLE RAMPS

GUARDRAIL DETAILS

SHEET NUMBER: DET-02

MTA PROJECT MANAGER: Ralph C. Norwood, IV

## DIMENSIONS FOR SLOPE OF 2:1


| D           | A<br>(FT) | B<br>(FT)    | C<br>(FT)     | E<br>(FT)   | F<br>(FT)    | G<br>(FT)    | STONE<br>DEPTH<br>(FT) | STONE<br>(CY) |
|-------------|-----------|--------------|---------------|-------------|--------------|--------------|------------------------|---------------|
| 12"         | 1.00      | 4.00         | 3.00          | 2.00        | 6.00         | 1.00         | 1.50                   | 1.30          |
| <i>15</i> " | 1.00      | <b>4.</b> 50 | <i>3.37</i>   | 2.25        | <b>6.</b> 75 | 1.63         | 1.50                   | 1.70          |
| 18"         | 1.00      | 5.00         | <i>3.</i> 75  | 2.50        | 7.50         | 2.25         | 1.50                   | 2.09          |
| 24"         | 1.00      | 6.00         | <b>4.</b> 50  | 3.00        | 9.00         | 3.50         | 1.50                   | 3.12          |
| <i>30</i> " | 1.00      | 7.00         | 5 <b>.</b> 25 | <i>3.50</i> | 10.50        | <b>4.</b> 75 | 1.50                   | 4.33          |

#### DIMENSIONS FOR SLOPE OF 4:1


| D   | A<br>(FT) | B<br>(FT) | C<br>(FT)    | E<br>(FT)    | F<br>(FT)    | G<br>(FT) | STONE<br>DEPTH<br>(FT) |              |
|-----|-----------|-----------|--------------|--------------|--------------|-----------|------------------------|--------------|
| 12" | 1.00      | 8.00      | 6.00         | 2.00         | 6.00         | 0.00      | 1.50                   | 2.20         |
| 15" | 1.00      | 9.00      | <b>6.</b> 75 | 2.25         | <b>6.</b> 75 | 0.00      | 1.50                   | 2.80         |
| 18" | 1.00      | 10.00     | 7.50         | <b>2.</b> 50 | 7.50         | 0.00      | 1.50                   | <i>3.40</i>  |
| 24" | 1.00      | 12.00     | 9.00         | 3.00         | 9.00         | 0.00      | 1.50                   | <b>4.</b> 86 |
| 30" | 1.00      | 14.00     | 10.50        | <i>3.50</i>  | 10.50        | 0.00      | 1.50                   | 6.58         |

#### DIMENSIONS FOR SLOPE OF 6:1

| D   | A<br>(FT) | B<br>(FT) | C<br>(FT)    | E<br>(FT) | F<br>(FT)     | G<br>(FT) | STONE<br>DEPTH<br>(FT) |             |
|-----|-----------|-----------|--------------|-----------|---------------|-----------|------------------------|-------------|
| 12" | 0.50      | 9.00      | 7.50         | 1.50      | <i>4.</i> 50  | 0.00      | 1.50                   | 2.30        |
| 15" | 0.50      | 10.50     | <b>8.</b> 75 | 1.75      | 5 <b>.</b> 50 | 0.00      | 1.50                   | 2.93        |
| 18" | 0.50      | 12.00     | 10.00        | 2.00      | <b>6.</b> 50  | 0.00      | 1.50                   | <i>3.57</i> |
| 24" | 0.50      | 15.00     | 12.50        | 2.50      | 8.00          | 0.00      | 1.50                   | 5.44        |
| 30" | 0.50      | 18.00     | 15.00        | 3.00      | 9.50          | 0.00      | 1.50                   | 7.71        |

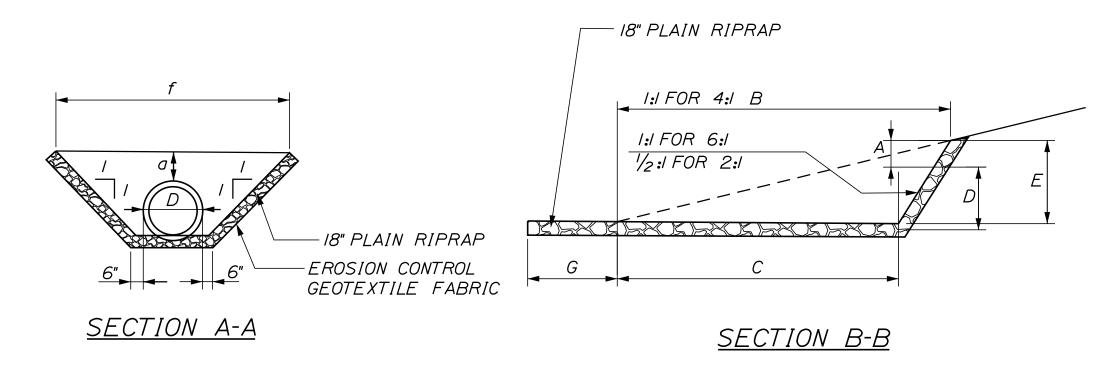



ROADWAY CULVERT END SLOPE TREATMENT

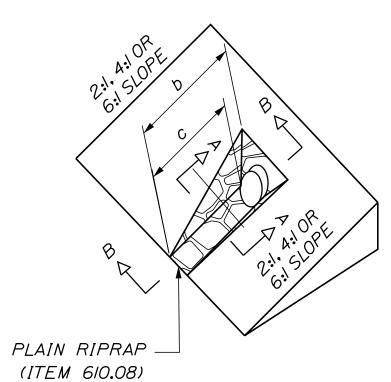


## NOTES:

- I. THE DIMENSIONS SHOWN ARE APPROXIMATE AND MAY BE MODIFIED BY THE RESIDENT.
- 2. STONE QUANTITIES ARE FOR ONE END OF THE PIPE.

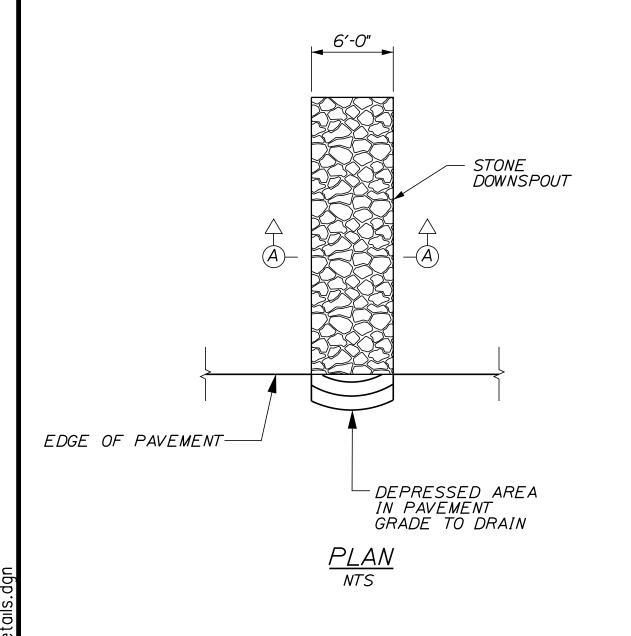

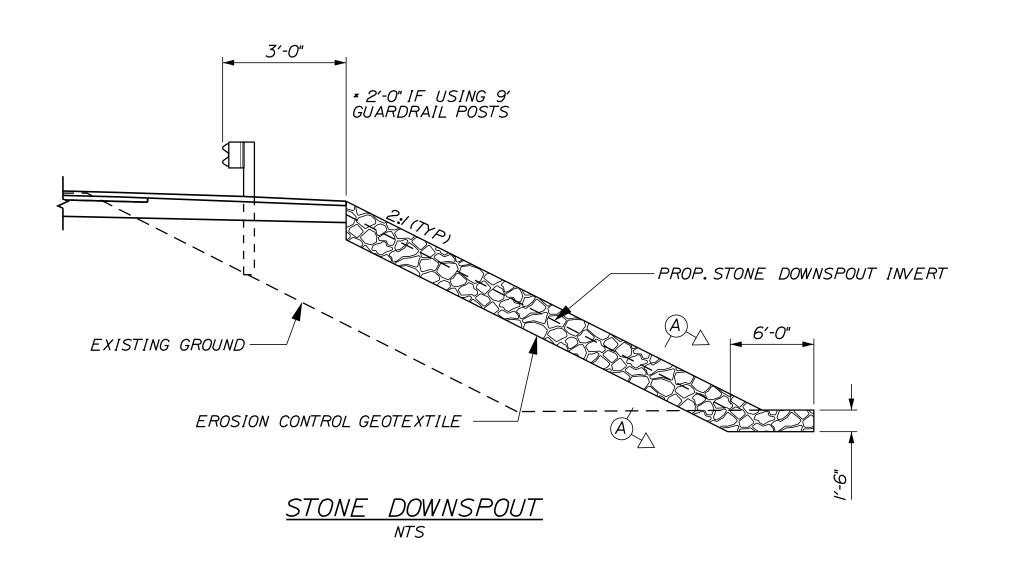

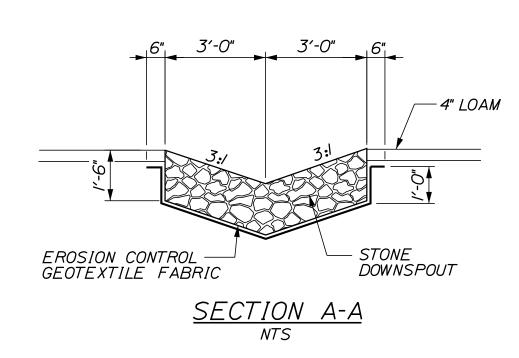

ILF OF DOWNSPOUT= 0.33 CY OF PLAIN RIPRAP ILF OF DOWNSPOUT= 1.04 SY OF EROSION CONTROL GEOTEXTILE FABRIC

#### NOTES:

- 1. STONE FOR STONE DOWNSPOUTS SHALL MEET THE REQUIREMENTS OF MAINEDOT SPECIFICATION 703.29 AND WILL BE PAID FOR UNDER ITEM 610.08. PLAIN RIPRAP.
- 2. CURBING MUST BE IN PLACE PRIOR TO GUARDRAIL INSTALLATION.

| ď       | Scal | e:           |    |      | Designed by: |       |            |                 |     |        |   |
|---------|------|--------------|----|------|--------------|-------|------------|-----------------|-----|--------|---|
| TA\XXX_ |      | NOT TO SCALE |    |      | T-Y-         | LII   | NINTE      | ERNATI          | ON  | AL     | T |
| .\MS    | No.  | Revision     | Ву | Date |              |       |            |                 |     |        |   |
| me: .   |      |              |    |      | CONSULTANT F | ROJEC | T MANAGER: | Daniel S. Myers |     |        | 1 |
|         |      |              |    |      |              | Ву    | Date       |                 | Ву  | Date   |   |
| ilen    |      |              |    |      | Designed     | TSK   | 1/2019     | Checked         | TSK | 1/2019 |   |
| ഥ       |      |              |    |      | Drawn        | MJD   | 1/2019     | In Charge of    | DSM | 1/2019 |   |

T.Y. Lin International 12 Northbrook Drive Building A, Suite One Falmouth, Maine 04105 TEL: (207) 781-4721 FAX: (207) 781-4753



THE GOLD STAR MEMORIAL HIGHWAY


NORTHERN BRIDGE REPAIRS & BENNETT ROAD EMERGENCY VEHICLE RAMPS

DRAINAGE DETAILS


SHEET NUMBER: DET-03

MTA PROJECT MANAGER: Ralph C. Norwood, IV

CONTRACT:2019.11 99 OF 105

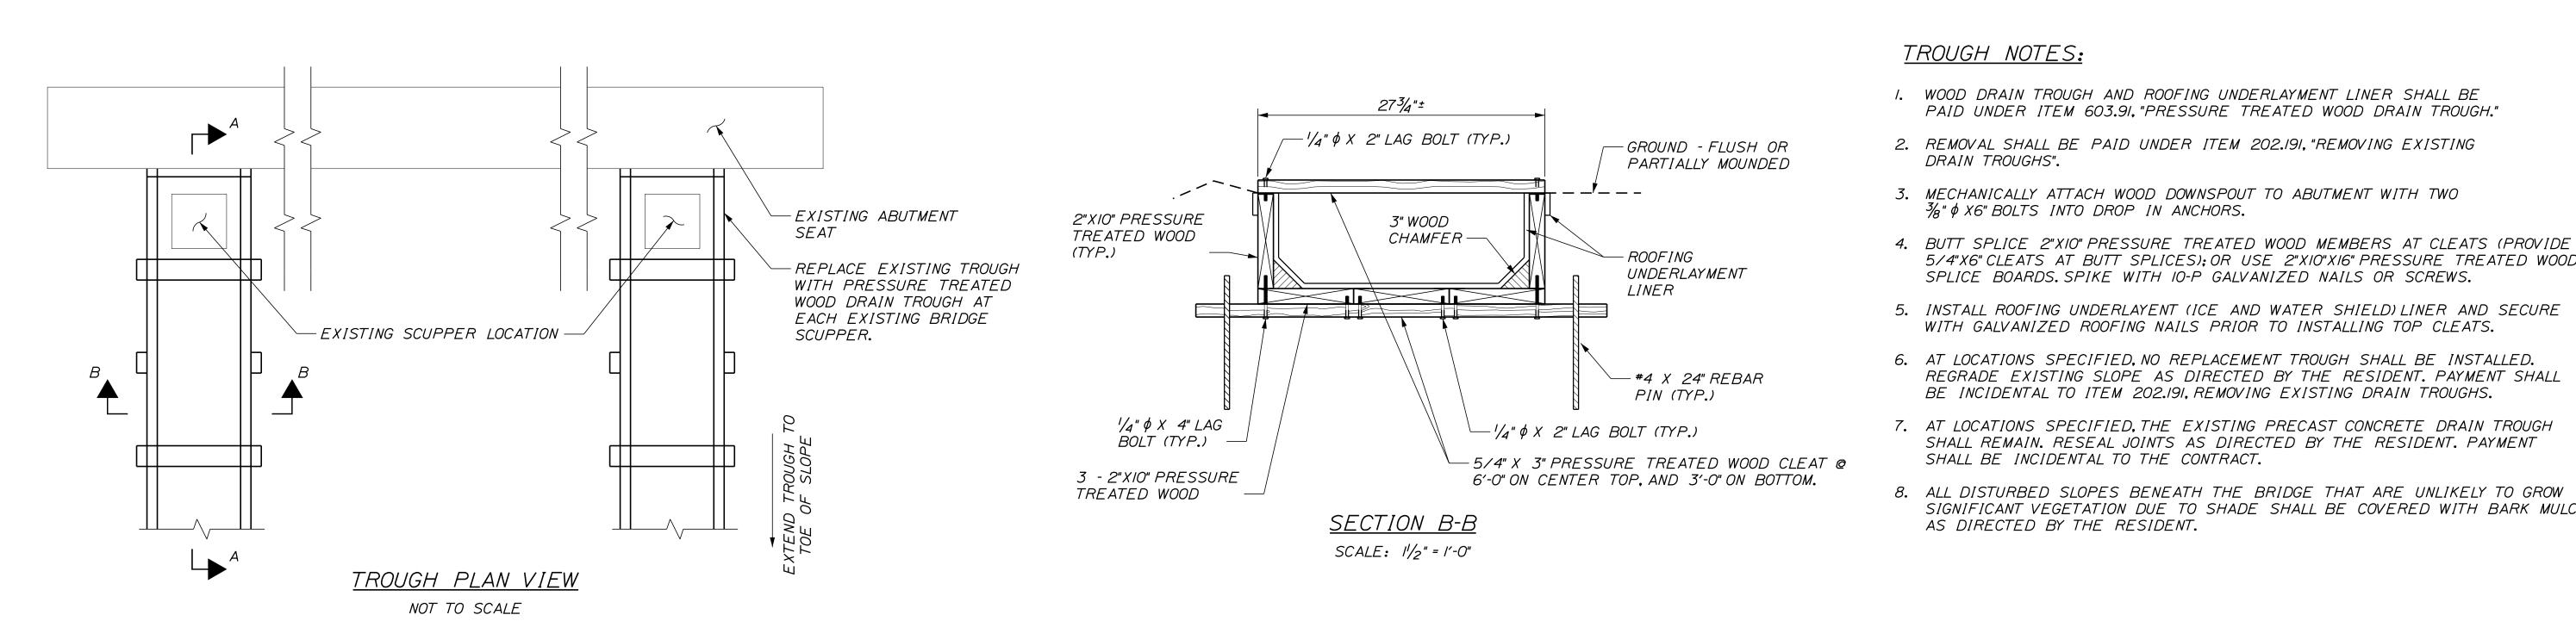

|                          | LOCATION OF DRAIN TROUGH WORK                | : TABLE                             |
|--------------------------|----------------------------------------------|-------------------------------------|
| LOCATION                 | ABUTMENT I                                   | ABUTMENT 2                          |
| ROUTE 26 (MILE 64.3)     | REMOVE EXISTING DRAIN TROUGH (NOTE 6)        | REMOVE EXISTING TROUGHS AND REPLACE |
|                          |                                              | WITH WOOD BRIDGE DRAIN TROUGHS      |
| WEBSTER ROAD (MILE 82.7) | RESET & REPAIR PRECAST, SEAL CRACKS (NOTE 7) | - NONE -                            |
| PLAINS ROAD (MILE 95.6)  | RESET & REPAIR PRECAST, SEAL CRACKS (NOTE 7) | RESET AND REPAIR PRECAST, SEAL      |
|                          |                                              | CRACKS, REPAIR EROSION (NOTE XXX)   |

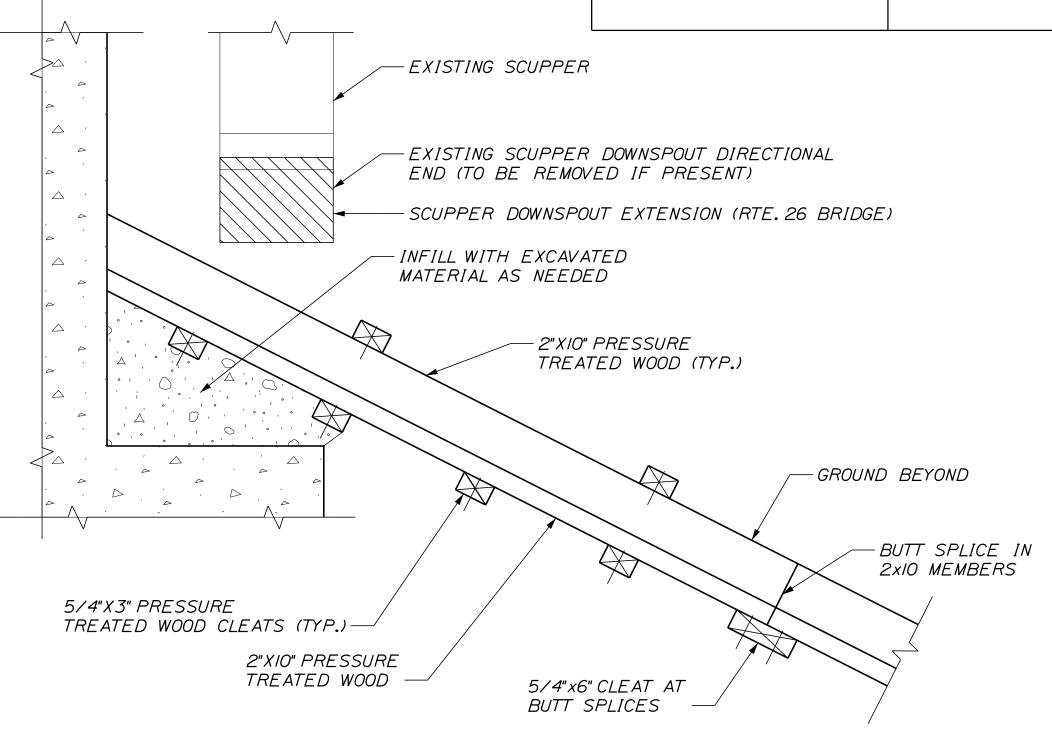

#### SECTION A-A NOT TO SCALE

Designed by:

Scale:



# THE GOLD STAR MEMORIAL HIGHWAY

# BENNETT ROAD EMERGENCY VEHICLE RAMPS

MISCELLANEOUS DETAILS

SHEET 1 OF 3

SHEET NUMBER: DET-04

MTA PROJECT MANAGER: Ralph C. Norwood, IV

CONTRACT:2019.11

#### NOT TO SCALE T.Y. Lin International T-Y-LININTERNATIONAL 12 Northbrook Drive By Date Building A, Suite One Revision Falmouth, Maine 04105 CONSULTANT PROJECT MANAGER: DanielS. Myers TEL: (207) 781-4721 Ву Date FAX: (207) 781-4753 DSM 9/2018 NLB 9/2018 Checked Designed In Charge of DSM 9/2018

1/2019

NORTHERN BRIDGE REPAIRS &

PAID UNDER ITEM 603.91, "PRESSURE TREATED WOOD DRAIN TROUGH."

SPLICE BOARDS. SPIKE WITH 10-P GALVANIZED NAILS OR SCREWS.

WITH GALVANIZED ROOFING NAILS PRIOR TO INSTALLING TOP CLEATS.

BE INCIDENTAL TO ITEM 202.191, REMOVING EXISTING DRAIN TROUGHS.

5/4"X6" CLEATS AT BUTT SPLICES); OR USE 2"XIO"XI6" PRESSURE TREATED WOOD

REGRADE EXISTING SLOPE AS DIRECTED BY THE RESIDENT. PAYMENT SHALL

SHALL REMAIN. RESEAL JOINTS AS DIRECTED BY THE RESIDENT. PAYMENT

SIGNIFICANT VEGETATION DUE TO SHADE SHALL BE COVERED WITH BARK MULCH

(TYP.)

- MODIFY SPLICE

**SPLICE** ✓

l'-6"

-EXIST. S.S. SET SCREW

1/4"\$\phix3/4"LG. 20 UNC

FLAT POINT, SOCKET HEAD.

MAX. PROJECTION \(\frac{3}{6}\)"

(MAY BE MISSING)

DRAIN TROUGHS".

3/4" \$\phi X6" BOLTS INTO DROP IN ANCHORS.

SHALL BE INCIDENTAL TO THE CONTRACT.

2'-0"

SPLICE

SPLICE MODIFICATION RAILING - ELEVATION

SCALE: 1/2" = 1'-0" (TWO BAR RAILING SHOWN,

THREE BAR RAILING SIMILAR)

/′-O"

SPLICE MODIFICATION DETAIL

SCALE: 1/2" = 1'-0"

(ELEVATION VIEW FROM BACK SIDE OF RAIL)

AS DIRECTED BY THE RESIDENT.


PROPOSED 5/16" \$


HOLES IN RAIL AND SPLICE BAR

PORPOSED 5/15" \$

HOLE IN RAIL

(TWO LOCATIONS)

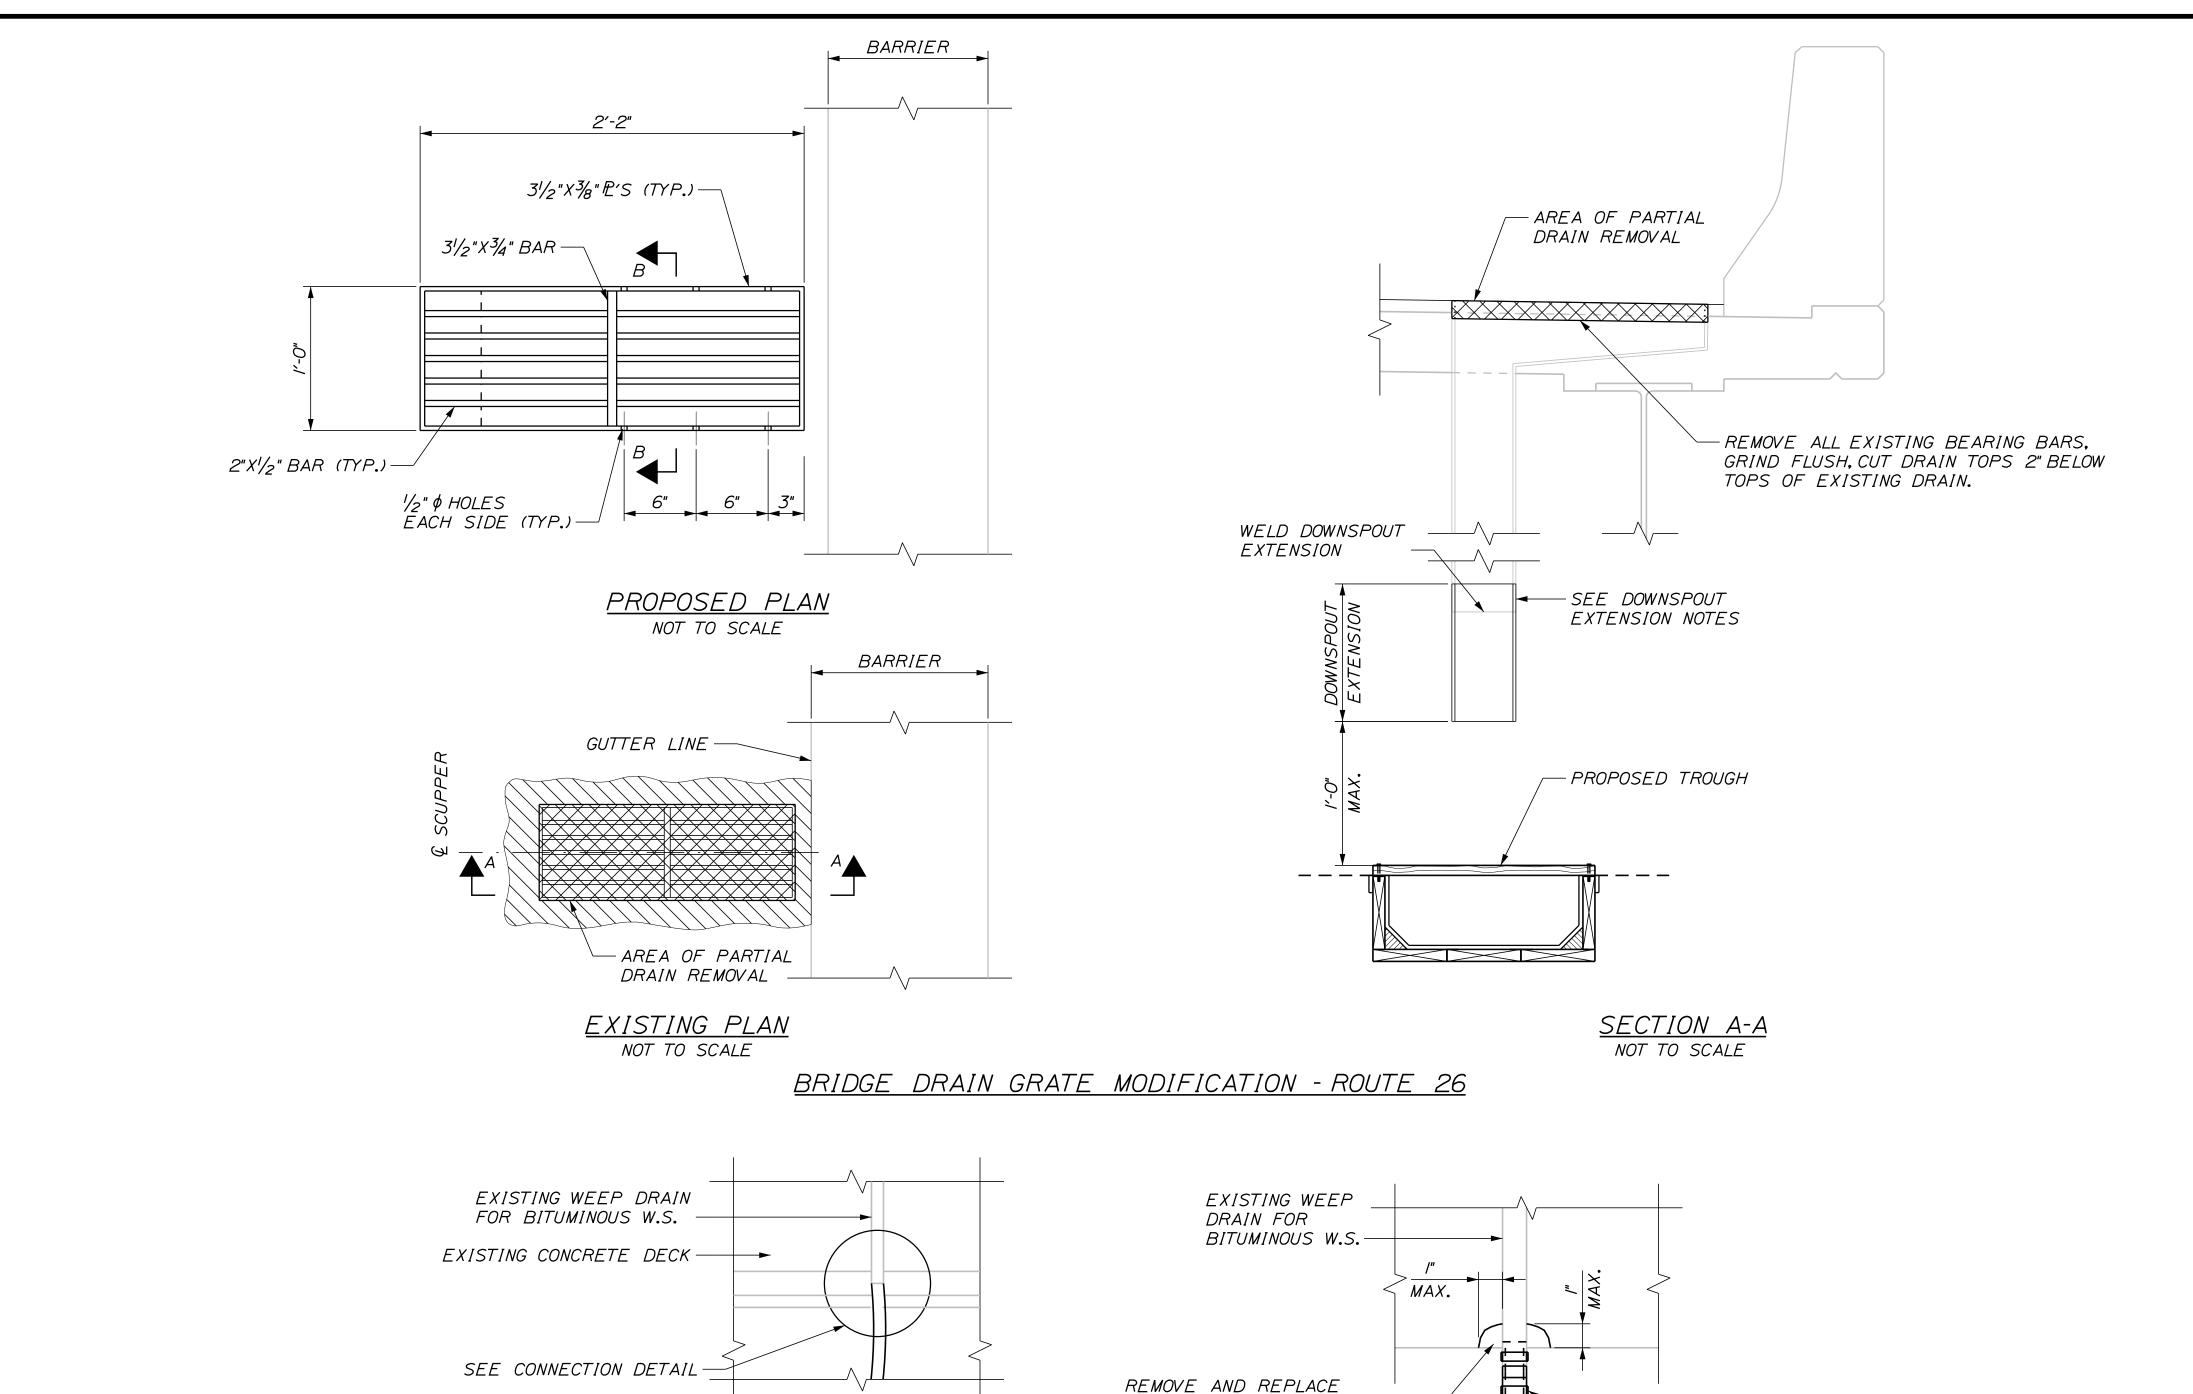

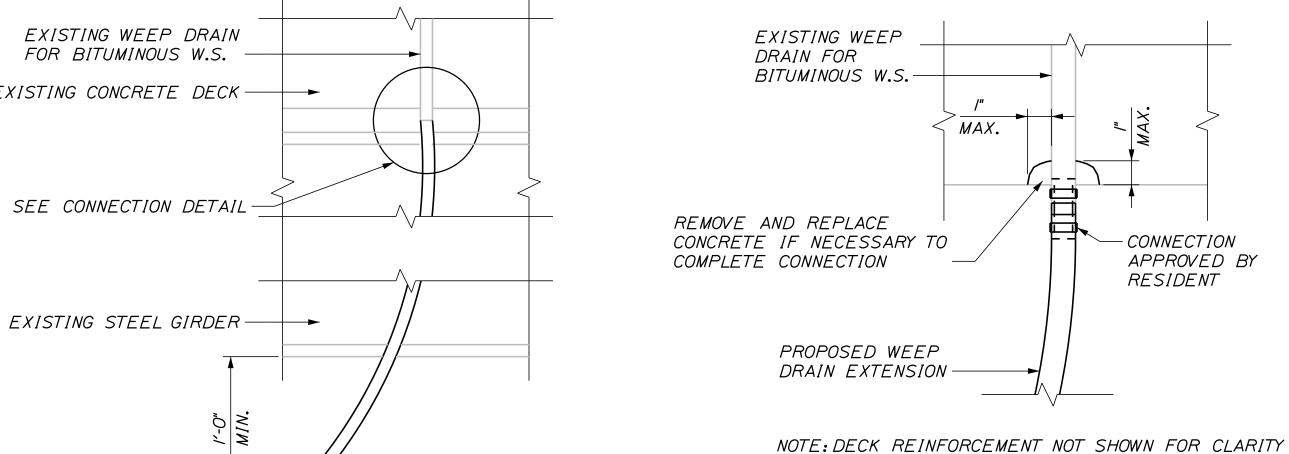

WEEP DRAIN EXTENSION WEEP DRAIN CONNECTION DETAIL SCALE: 3" = 1'-0" NOT TO SCALE

# THE GOLD STAR

# NORTHERN BRIDGE REPAIRS & BENNETT ROAD EMERGENCY VEHICLE RAMPS

DOWNSPOUT EXTENSION NOTES:

EXTENSIONS.

AFTER WELDING.

MODIFICATION."

EXTENSIONS.

AFTER FABRICATION.

GALVANIZING COMPOUND.

SPECIFICATIONS.

MODIFICATION."

I. PRIOR TO STARTING THE WORK THE CONTRACTOR SHALL FIELD MEASURE EACH DRAIN. THIS INFORMATION SHALL BE USED FOR THE FABRICATION OF THE DOWNSPOUT

2. DOWNSPOUT EXTENSIONS SHALL CONFORM TO ASTM A 36

3. PREPARE NEW AND EXISTING DOWNSPOUT FOR FIELD

4. PAYMENT FOR ALL LABOR, EQUIPMENT AND MATERIALS

BE UNDER ITEM 502.701, "BRIDGE DRAIN GRATE

AND SHALL BE HOT DIP GALVANIZED AFTER FABRICATION.

WELD, FIELD WELD THE EXTERIOR PERIMETER JOINTS BETWEEN NEW AND EXISTING DOWNSPOUTS THE INTERIOR AND EXTERIOR OF THE NEW DOWNSPOUT WELDS SHALL BE COATED WITH AN APPROVED COLD GALVANIZING COMPOUND

ASSOCIATED WITH THE BRIDGE DRAIN MODIFICATION WILL

BRIDGE DRAIN GRATE MODIFICATION NOTES:

I. PRIOR TO STARTING THE WORK THE CONTRACTOR SHALL

2. CONTRACTOR SHALL CLEANLY CUT AND REMOVE THE TOP OF EXISTING DRAINS 2" BELOW EXISTING TOP OF DRAIN. THE DECK CONCRETE AROUND THE FULL PERIMETER OF

THE DRAIN SHALL BE MECHANICALLY REMOVED TO A

MINIMUM DEPTH OF 1/2" BY A MINIMUM WIDTH OF 3".

GRATE EXTENSIONS SHALL BE HOT DIP GALVANIZED

4. ALIGNMENT TABS ARE OPTIONAL. AFFIX AND GALVANIZE

5. PREPARE EXISTING DRAIN BODY AND NEW DRAIN TOP

GRATE EXTENSION FOR FIELD WELD. FIELD WELD THE

INTERIOR AND EXTERIOR OF THE NEW TOP OF DRAIN

SELECTED FROM THE MTA APPROVED PRODUCTS LIST. CONCRETE PATCH SHALL BE PLACED, FINISHED AND CURED IN ACCORDANCE WITH THE MANUFACTURERS

EXTERIOR PERIMETER JOINT BETWEEN EXISTING DRAIN BODY AND NEW TOP OF DRAIN AFTER WELDING, THE

3. ALL PLATES SHALL CONFORM TO ASTM A 36. DRAIN

WITH DRAIN GRATE EXTENSIONS, IF USED

SHALL BE COATED WITH AN APPROVED COLD

6. AREAS OF CONCRETE REMOVAL SHALL BE PATCHED USING A SHALLOW CONCRETE PATCHING MATERIAL

7. PAYMENT FOR ALL LABOR, EQUIPMENT AND MATERIALS

ASSOCIATED WITH THE BRIDGE DRAIN MODIFICATION WILL BE UNDER ITEM 502.701, "BRIDGE DRAIN GRATE

FIELD MEASURE EACH DRAIN. THIS INFORMATION SHALL BE USED FOR THE FABRICATION OF THE DRAIN GRATE

> MISCELLANEOUS DETAILS SHEET 2 OF 3

SHEET NUMBER: DET-05

CONTRACT:2019.11 MTA PROJECT MANAGER: Ralph C. Norwood, IV

MEMORIAL HIGHWAY

AS NOTED T-Y-LININTERNATIONAL By Date Revision CONSULTANT PROJECT MANAGER: DanielS. Myers Ву Date DSM 1/2019 DSM 1/2019 Checked Designed

Scale:

Designed by:

In Charge of DSM

1/2019

1/2019

T.Y. Lin International 12 Northbrook Drive Building A, Suite One Falmouth, Maine 04105 TEL: (207) 781-4721 FAX: (207) 781-4753

MAINE


**TURNPIKE** 




0.625" Inner border Black, 1.500" Radius, 0.375" Outer border, White on Red; [STATE LAW] D 2K;

1.500" Radius, 0.625" Border, 0.375" Indent, Black on White; [3 FEET MIN] D 2K; [TO PASS] D 2K; [BICYCLES OR] D 2K; [PEDESTRIANS] D 2K;

NEW SIGN DETAIL - ROUTE 26

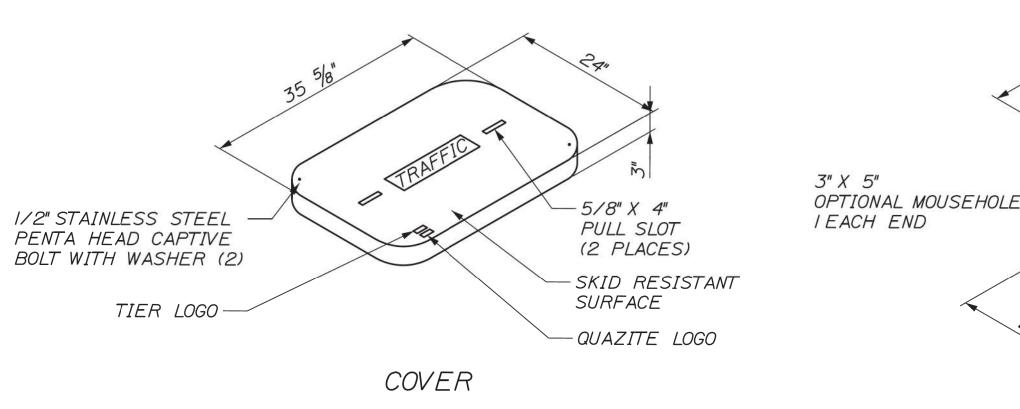


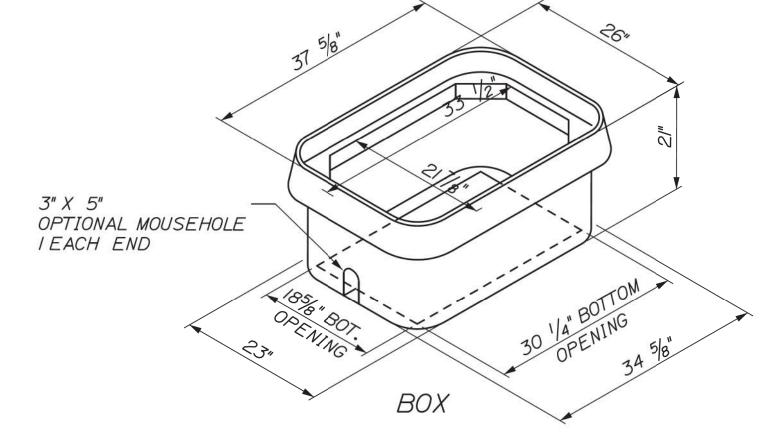

QUAZITE BOX DETAIL

| _Misc   | Scal | le:          |    |      | Designed b | y:     |            |                 |     |        |   |
|---------|------|--------------|----|------|------------|--------|------------|-----------------|-----|--------|---|
| TA\XXX. |      | NOT TO SCALE |    |      | T-\        | /LII   | VINT       | ERNATI          | ON. | AL     | Т |
| \MS     | No.  | Revision     | Ву | Date |            |        |            |                 |     |        |   |
| e:      |      |              |    |      | CONSULTANT | PROJEC | T MANAGER: | Daniel S. Myers |     |        | 1 |
| ame     |      |              |    |      |            | Ву     | Date       |                 | Ву  | Date   |   |
| ilen    |      |              |    |      | Designed   | DSM    | 1/2019     | Checked         | DSM | 1/2019 |   |
| ഥ       |      |              |    |      | Drawn      | JJB    | 1/2019     | In Charge of    | DSM | 1/2019 | 1 |

T.Y. Lin International 12 Northbrook Drive Building A, Suite One Falmouth, Maine 04105 TEL: (207) 781-4721 FAX: (207) 781-4753

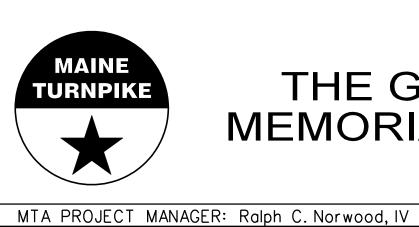



# THE GOLD STAR MEMORIAL HIGHWAY


NORTHERN BRIDGE REPAIRS & BENNETT ROAD EMERGENCY VEHICLE RAMPS MISCELLANEOUS DETAILS

SHEET 3 OF 3

SHEET NUMBER: DET-06 CONTRACT:2019.11 102 OF 105

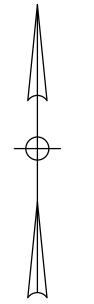

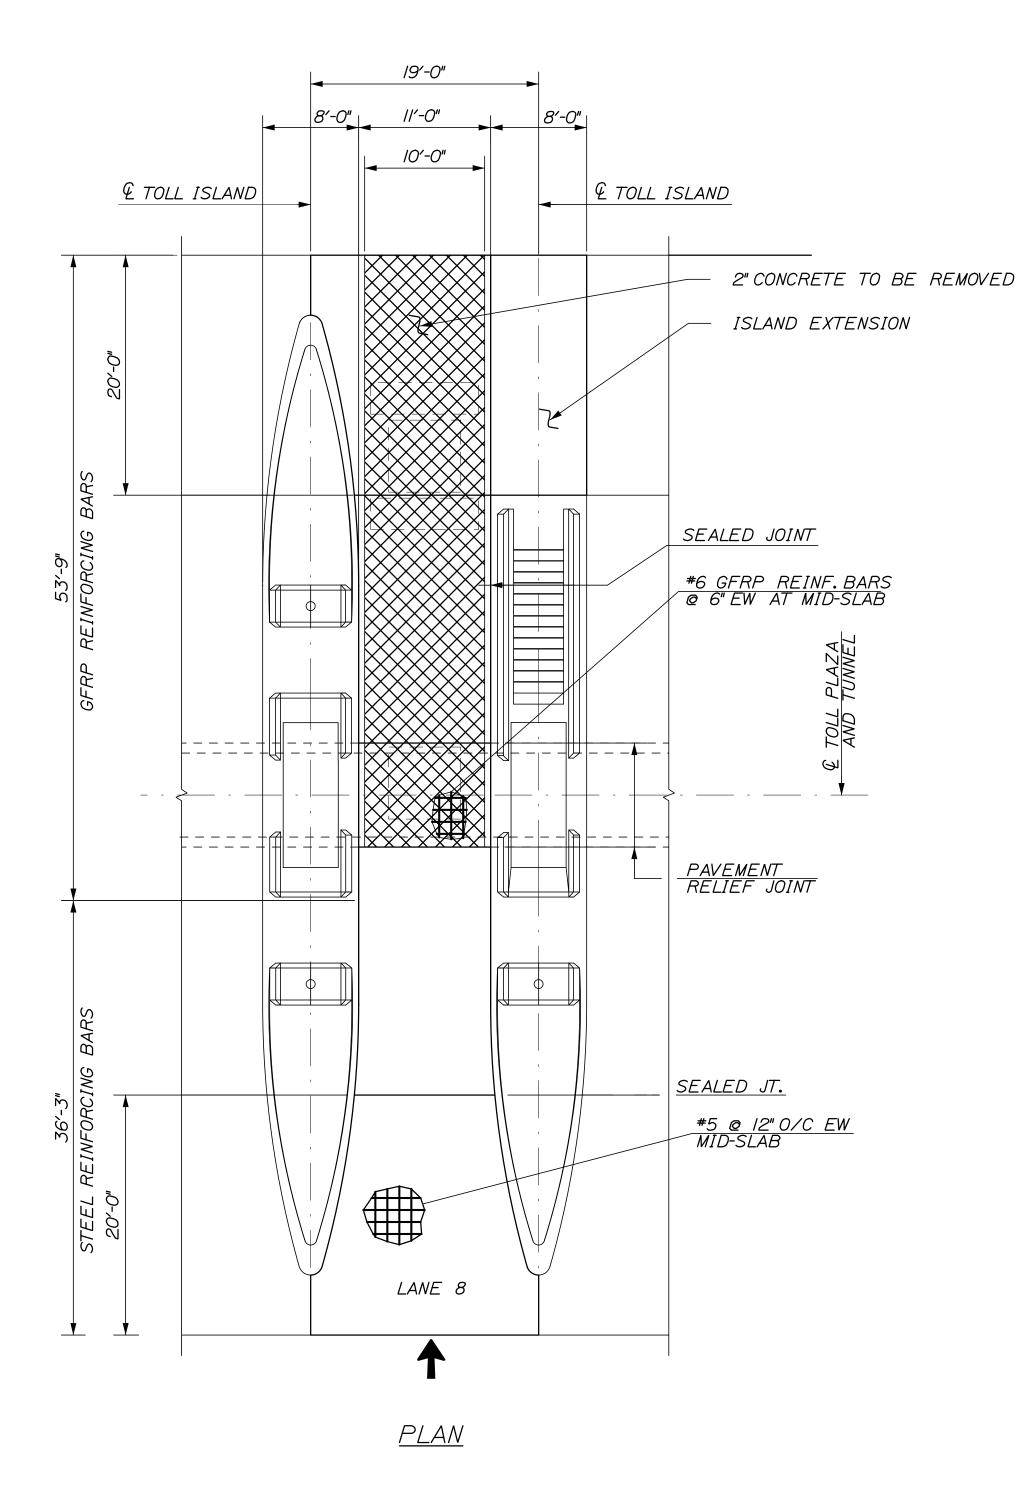

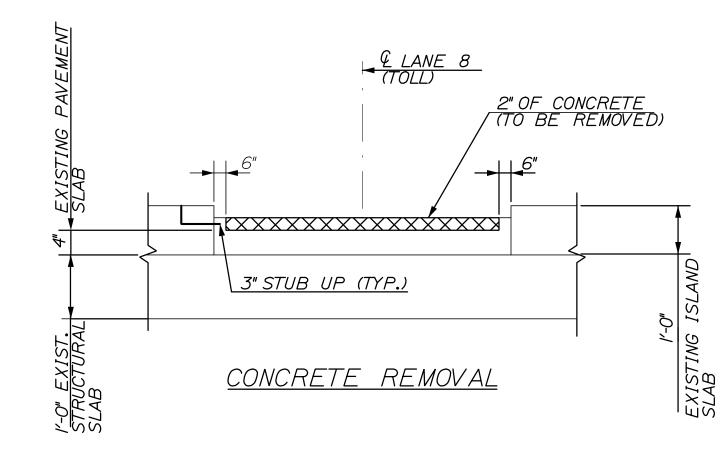

GENERAL NOTES:

- I.SELF LEVELING ELASTOMERIC SEALANT SHALL BE SIKA FLEX IA OR AN APPROVED EQUAL.
- 2. A 2" DEEP, LONGITUDINAL SAW CUT SHALL BE MADE PRIOR TO ANY CONCRETE REMOVAL
- 3. GFRP REINFORCING IS AT A DEPTH OF 3".
- 4. LOOP LEAD STUB UPS SHALL BE AVOIDED DURING DEMOLITION. ANY DAMAGE TO STUB UPS SHALL BE REPAIRED BY CONTRACTOR.

CONCRETE NOTES:

- I. CONCRETE SHALL BE MTA CLASS AAA DECK WITH 5 LBS OF SYNTHETIC FIBER.
- 2. CONCRETE SHALL BE PLACED TO EXISTING GRADES.
- 3. CONTRACTOR SHALL USE A STRAIT CEMENT SLURRY AS A BONDING AGENT. THE BONDING AGENT WILL NOT BE ALLOWED TO DRY BEFORE PLACING OF CONCRETE AND SHALL NOT BE PLACE ON THE SLAB TO A DISTANCE GREATER THAN 10 FEET BEFORE CONCRETE IS PLACED.
- 4. CONTRATOR SHALL SUBMIT THEIR CONCRETE PLACEMENT PROCEDURES FOR REVIEW AND APPROVAL TO THE DESIGNER AT LEAST ONE (I) WEEK PRIOR TO PLACEMENT.

| Scale: |          |    |      | Designed by | <b>/</b> : |            |                |          |       |
|--------|----------|----|------|-------------|------------|------------|----------------|----------|-------|
|        | NTS      |    |      |             |            |            | ITB            |          |       |
| No.    | Revision | Ву | Date |             |            |            |                |          |       |
|        |          |    |      | CONSULTANT  | PROJEC     | T MANAGER: | R. Bruce Munge | er, P.E. |       |
|        |          |    |      |             | Ву         | Date       |                | Ву       | Date  |
|        |          |    |      | Designed    | RBM        | 02/19      | Checked        | RBM      | 02/19 |
|        |          |    |      | Drawn       | MHP        | 02/19      | In Charge of   | RAL      | 02/19 |

HNTB CORPORATION
340 County Road, Suite 6-C
Westbrook, ME 04092
TEL (207) 774-5155
FAX (207) 228-0909




THE GOLD STAR MEMORIAL HIGHWAY NEW GLOUCESTER CASH LANE 8 REHABILITATION


DEMO PAVEMENT PLAN


SHEET NUMBER: S-01


MTA PROJECT MANAGER: William Yates

CONTRACT: 2019.11 103 OF 105

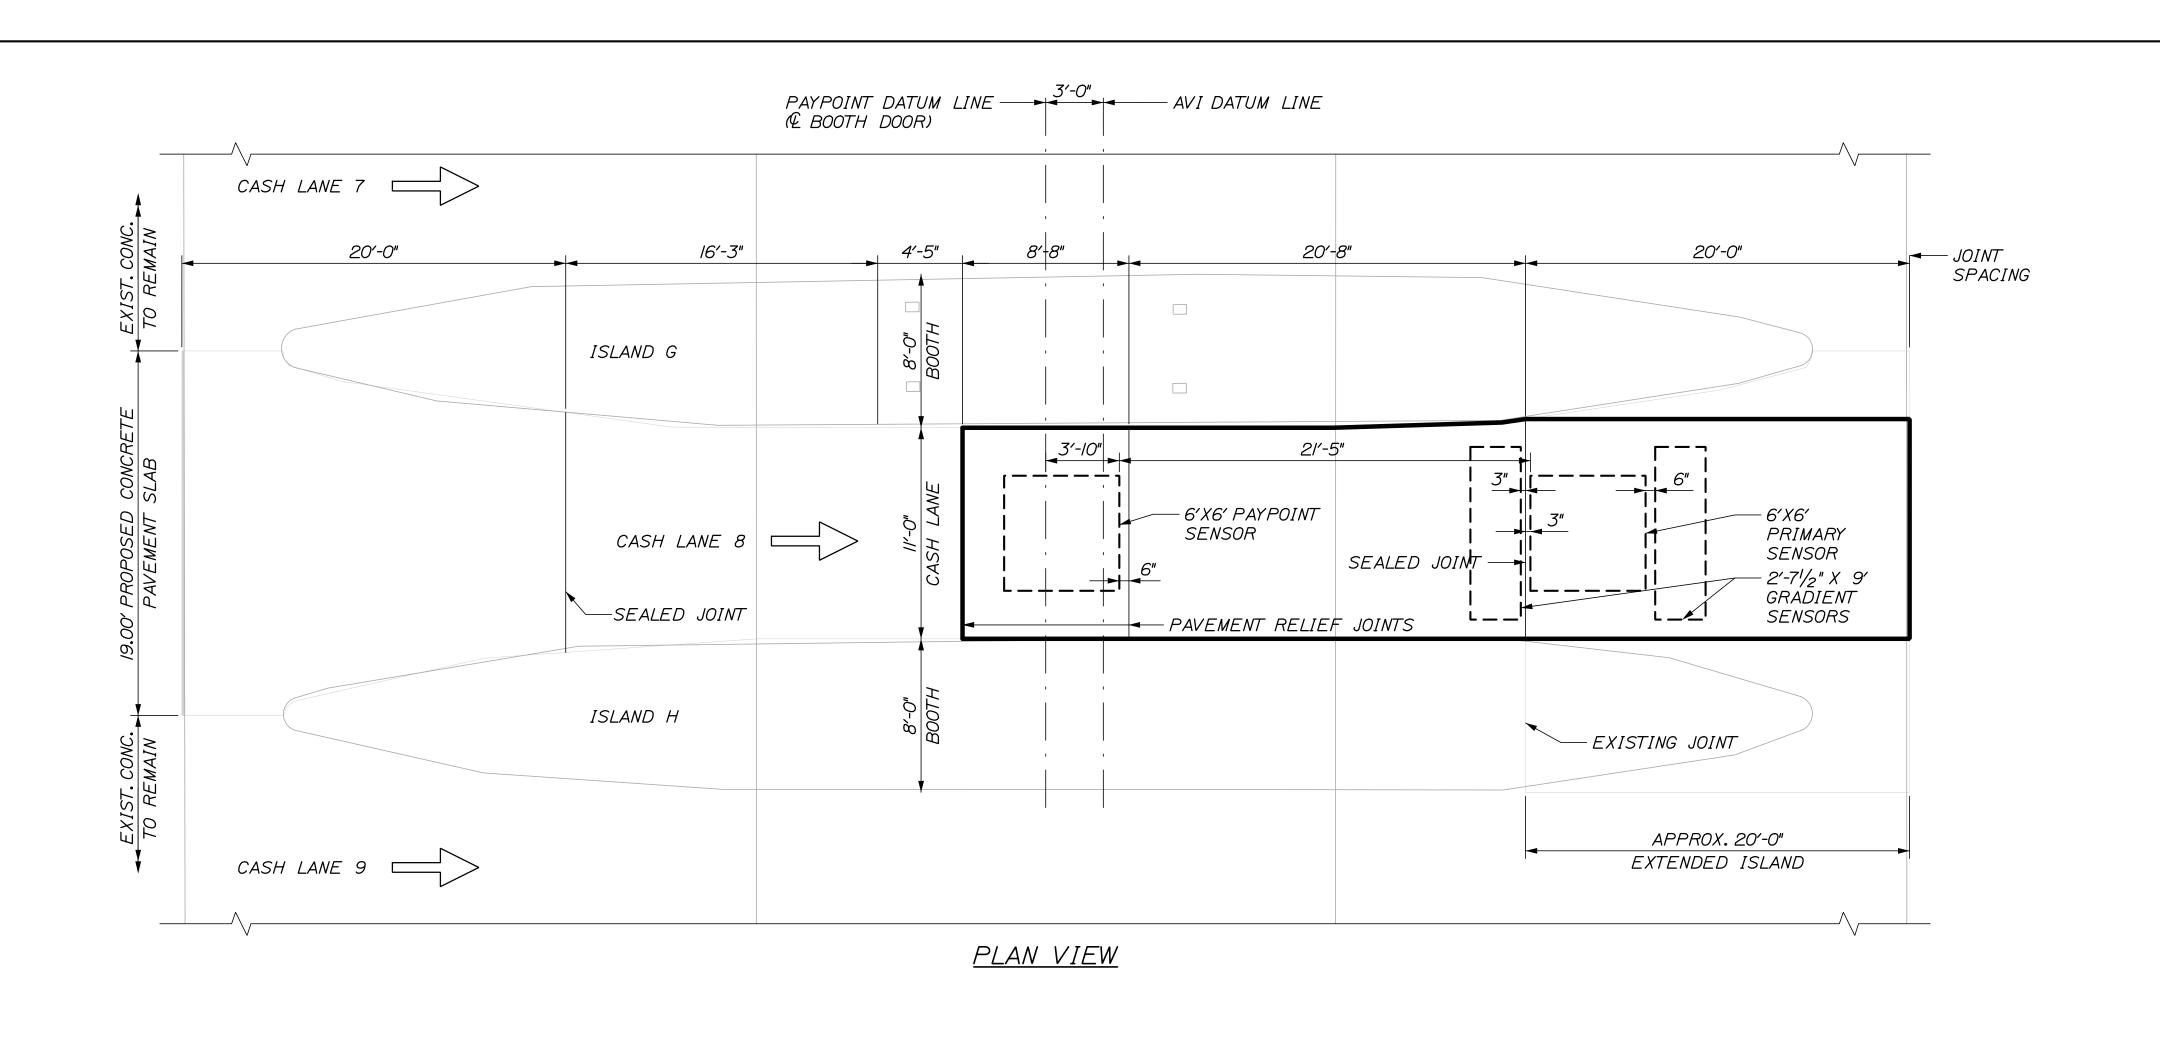

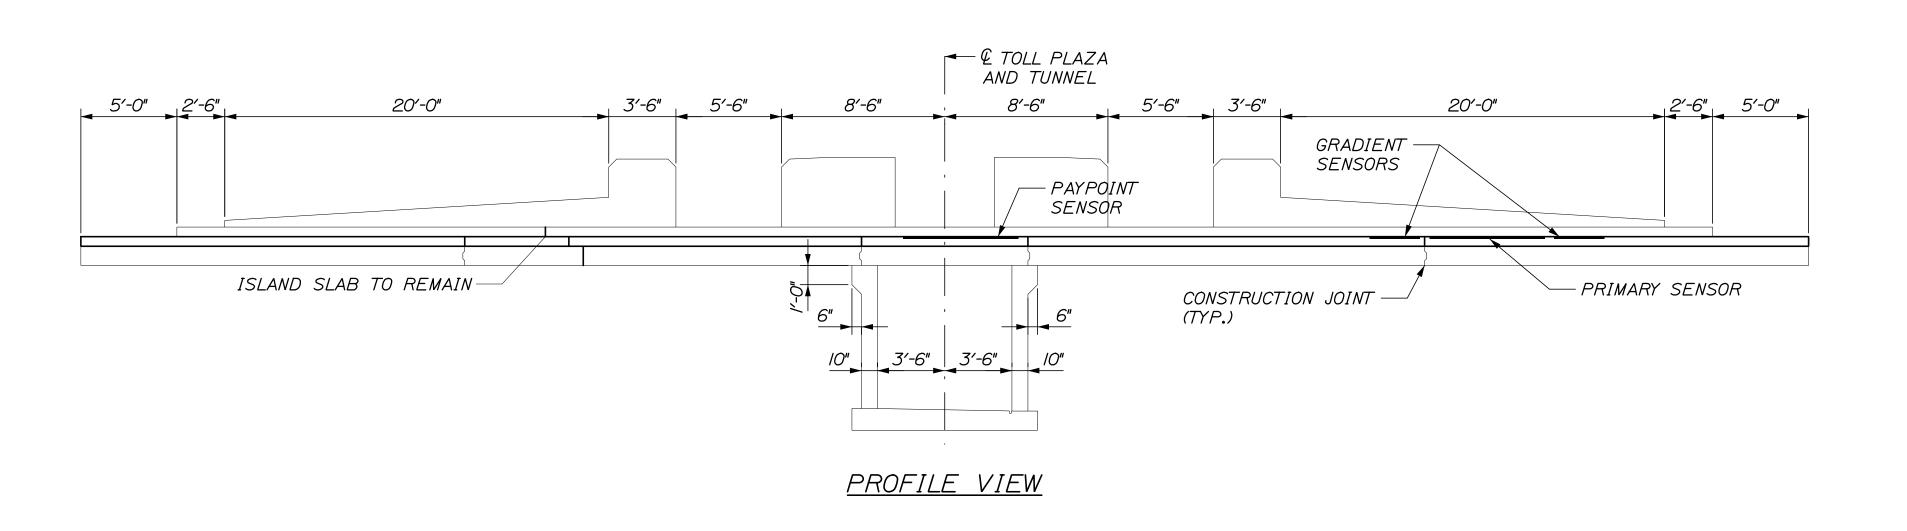


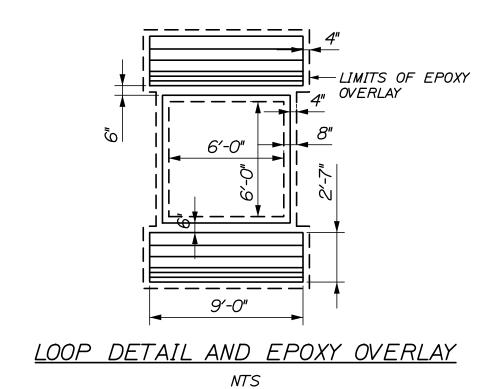

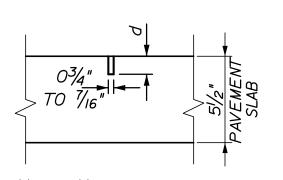

d = 11/4"TO 11/2" FOR SINGLE LEAD CUT 21/2" FOR MULTIPLE LEAD CUT 3"+ AT PITCH POCKET ENTRY

> LEAD-IN CUT NTS

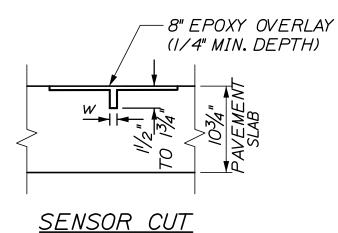

NTS

w = 1/2" FOR GRADIENT ENDS
3/8" FOR ALL OTHER CUTS


#### NOTES.

I. TRANSCORE SHALL INJECT DURANT LOOP SEALANT INTO SAW CUT BEFORE INSTALLING SENSORS AND LEADS. TRANSCORE SHALL PROVIDE EQUIPMENT, TEMPLATES AND EPOXY. SEE SPECIAL PROVISIONS SECTION 655 FOR MORE INFORMATION.

2. ALL LAYOUT FOR PRIMARY AND GRADIENT SENSORS SHALL BE VERIFIED BY TRANSCORE PRIOR TO CUTTING CONCRETE.

- 3. 1/4" DEPRESSION FOR EPOXY OVERLAY SHALL BE COMPLETED AFTER SAW CUTTING CONCRETE FOR LOOPS.
- 4. MEASUREMENT FOR ITEM 515.23 EPOXY OVERLAY SHALL BE 11.5 SY PER LANE.
- 5. LOOP LAYOUT IS TYPICAL FOR ALL ENTRY LANES.

CONTRACT:2019.11

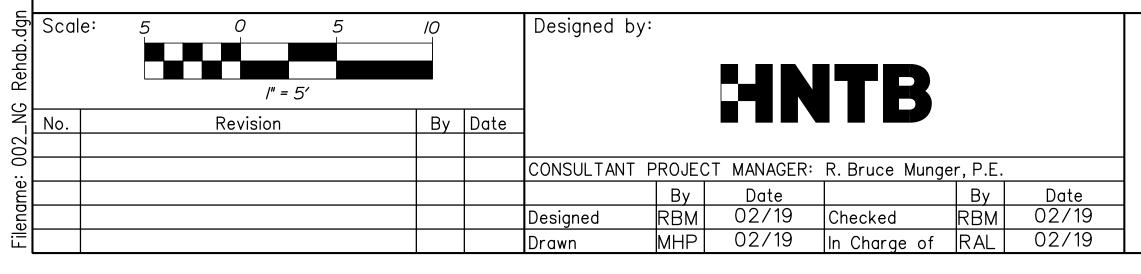

HNTB CORPORATION

340 County Road, Suite 6-C
Westbrook, ME 04092
TEL (207) 774-5155
FAX (207) 228-0909



THE GOLD STAR
MEMORIAL HIGHWAY

NEW GLOUCESTER
CASH LANE 8 REHABILITATION

REHAB PAVEMENT SLAB

SHEET NUMBER: S-02

MTA PROJECT MANAGER: William Yates

