MAINE TURNPIKE AUTHORITY

DANIEL E. WATHEN, CHAIR ROBERT D. STONE, VICE CHAIR MICHAEL J. CIANCHETTE, MEMBER JOHN E. DORITY, MEMBER ANN R. ROBINSON, MEMBER THOMAS J. ZUKE, MEMBER KAREN S. DOYLE, MEMBER EX-OFFICIO

S. PETER MILLS, EXECUTIVE DIRECTOR

KENNEBUNK SB SERVICE PLAZA (MM 25.5)

CREDIFORD BROOK CULVERT (MM 18.7

CONTRACT 2018.06 PARKING INSTALLATION **KENNEBUNK SB SERVICE PLAZA (MM 25.5)** PAVING REHABILITATION BIDDEFORD INTERCHANGE (MM 31.6)

BRIDGE AND CULVERT REPAIRS CREDIFORD BROOK CULVERT (MM 18.75) ROUTE 111 UNDERPASS (MM 31.3) BIDDEFORD INTERCHANGE UNDERPASS (MM 31.6)

INDEX OF SHEETS

TITLE SHEET **ESTIMATED QUANTITIES**

CONSTRUCTION PHASING AND MAINTENANCE OF TRAFFIC

KENNEBUNK SERVICE PLAZA PARKING

BIDDEFORD INTERCHANGE PAVING

WESTBROOK LEWISTON **AUBURN** FALMOUTH ATLANTIC **OCEAN** BIDDEFOR

LOCATION MAP

HNTB



APPROVED:

			1	1			1	
				KENNEBUNK	ROUTE III		BIDDEFORD	
ITEM NO.	ITEM DESCRIPTION	UNIT	BROOK	SERVICE	BRIDGE	INTER.	INTER.	TOTAL
			CULVERT	PLAZA	Brilboz	BRIDGE	PAVING	
201.23	Removing Single Tree Top Only	EΑ		6				6
201.24	Removing Stump	EΑ		6				6
202.12	Removing Existing Structural Concrete	CY				10		10
202.202	Removing Pavement Surface - Mainline	SY					27700	27700
202.2021	Removing Pavement Surface - Bridge Deck	SY			1550	1400		2950
202,2026	Removing Pavement Surface - Drainage Paths	SY					150	150
203.20	Common Excavation	CY		360				360
304,10	Aggregate Subbase Course - Gravel	CY		265			5	270
304.14	Aggregate Base Course - Type A	CY		36			_	36
403.208	Hot Mix Asphalt, 12.5 mm Nominal Maximum Size	TON		32	130			162
403.2081	Hot Mix Asphalt, I2.5 mm Nominal Maximum Size, (Polymer Modified) - RAP	TON		32	130	120	2300	2420
403.2084		TON					25	25
403.212	Hot Mix Asphalt, 4.75 mm Nominal Maximum Size	TON					760	760
403.213	Hot Mix Asphalt, I2.5 mm Nominal Maximum Size (Base and Intermediate Base Course)	TON		74		3	118	195
409.15	Bituminous Tack Coat - Applied	GAL		20	80	70	2250	2420
	**	LF.						
419.30	Sawing Bituminous Pavement			145	150	100	45 7050	440
424.323	Asphalt Rubber Fiber Crack Sealer	LB	-				3050	3050
470.08	Berm Dropoff Correction - Grindings	TON					170	170
502.21	Structural Concrete, Abutments and Retaining Walls	CY				15		15
503.14	Epoxy-Coated Reinforcing Steel, Fabricated and Delivered	LB				3600		3600
503./5	Epoxy-Coated Reinforcing Steel, Placing	LB				3600		3600
507.095	Aluminum Bridge Railing - Splice Modification	EΑ			4	4		8
5/4.06	Curing Box for Concrete Cylinders	EΑ	/		0.5	0.5		2
5/5,20/	Pigmented Protective Coating for Concrete Surfaces	SY			300			300
5/5,202	Clear Protective Coating for Concrete Surfaces	SY	1200		500	600		2300
5/8.39	Granite Curb Joint Mortar and Bedding Mortar Repair	LF	,200			180		180
518 . 40	Epoxy Injection Crack Repair	LF	120		10	40		170
518.43		LF	120		470	600		1070
	Parapet Joint Repair		50					
5/8.5/	Repair of Upward Facing Surfaces - Below Reinforcing Steel < 8 inches	SF	50		25	25		100
518 . 511	Repair of Upward Facing Culvert Surfaces - Below	SF	160					160
	Reinforcing Steel < 8 inches							
518 . 53	Culvert Floor Refacing	SF	1650					1650
518.60	Repair of Vertical Surfaces < 8 inches	SF	245		<i>1</i> 5			260
518.86	Bridge Joint Header Concrete Replacement	SF			450			450
520.2228	Metal Armor Repair	LF			10			10
520.2234	·	LF			150			150
520.23	Expansion Device - Asphaltic Plug Joint	LF			,,,,	97		97
526.306	Temporary Concrete Barrier, Type I - Supplied by Authority	LS				1		
527.342	Work Zone Crash Cushions - TL-2	UN				2		2
603.1753	18 Inch Reinforced Concrete Pipe - Class V	LF					44	44
603.28	Concrete Collar	EA					/	
604.184	Rebuild Catch Basin to Grade - Type II	EA					2	2
606.1723	Bridge Transition - Type III	EA				8		8
606.178	Guardrail Beam	LF					653	653
606.278	Terminal End - Anchored End	EΑ					1	/
606.352	Reflectorized Beam Guardrail Delineator	EΑ					290	290
606.353	Delineator Post	EΑ					88	88
	Delineator Post - Remove and Stack	EA					88	88
606 . 3621		LF					7363	7363
606.3622	, ,	LF					1525	1525
606.369	Guardrail - Remove and Stack	LF	1				1525	1525
						-		
606.471	Single Offset Block - W-Beam	EA					86	86
606.48	Single Galvanized Steel Post	EA					74	74
607.24	Remove and Reset Fence	LF		35				35
609.15	Sloped Curb Type I	LF				4 5		<i>4</i> 5
609,238	Terminal Curb Type I - 8'	EA		/				1
609,441	Curbing Removed and Stacked	LF		115				115
615.07	Loam	CY		20				20
618.13	Seeding Method Number I	UN		2				2
619.1201	Mulch - Plan Quantity	UN		2				2
619,1202	Temporary Mulch	LS	0.7	0.2	0./			7
619.14	Erosion Control Mix	CY	40	20	10	<u> </u>		70
626,12	36" x 24" x 36" Quazite Junction Box	EA	+		10		3	3
						-	J J	
626./3	18" x 12" x 18" Quazite Junction Box	EA		4				4
626.22	Non-Metallic Conduit	LF		240				240
626.32	24" Diameter Concrete Foundation	EA		/				/
627.712	White or Yellow Pavement Marking Line	LF				2810	21790	24600
627.77	Removing Existing Pavement Marking	SF				520		520

			CREDIFORD	KENNEBUNK		RIDDEFORD	BIDDEFORD	
ITEM NO.	ITEM DESCRIPTION	UNIT	BROOK	SERVICE	ROUTE III	INTER.	INTER.	TOTAL
172111 1101	THE MIDES OF MITTER	0,117	CULVERT	PLAZA	BRIDGE	BRIDGE	PAVING	707712
627.812	Temporary Raised Pavement Markers	EA	00272717	, 2,12,1		Britbol	1/70	1170
627.943	Pavement Marking Line - Recessed Tape, Solid White or	1F					1300	/300
027.575	Yellow Lane Line, 6 - inch width						,300	7500
627.944	Pavement Markings - Recessed Tape, Words, Arrows, Stop	SF					490	490
027.577	Bars	J ,					,50	750
629.05	Hand Labor , Straight Time	HR	20	10	20	20		70
631.10	Air Compressor (including operator)	HR	20		20	20		60
631,11	Air Tool (including operator)	HR	20		20	20		60
631,12	All Purpose Excavator (including operator)	HR	10	10	10	10		40
631,172	Truck - large (including operator)	HR	10	,,,	10	10		30
631.36	Foreman	HR	10		10	10		30
631.40	Welder (including operator)	HR			20	20		40
631.53	Electrician	HR		20			20	40
631.54	Electrician's Apprentice	HR		20			20	40
634,208	Remove and Reset Light Standard	EΑ		/				1
643,901	Interconnect Wire IMSA 50-2 #I4 AWG	LF					480	480
645.106	Demount Regulatory, Warning, Confirmation, and Route	EΑ		3				3
	Marker Assembly Sign							
645.//6	Reinstall Regulatory, Warning, Confirmation and Route	EΑ		3				3
	Marker Assembly Sign							
652.361	Traffic Control Devices and Maintenance of Traffic Control	LS	1					1
	Devices: Crediford Brook							
652.361	Traffic Control Devices and Maintenance of Traffic Control	LS		/				1
	Devices: Kennebunk Service Plaza							
652.361	Traffic Control Devices and Maintenance of Traffic Control	LS			/			/
	Devices: Route III							
652.361	Traffic Control Devices and Maintenance of Traffic Control	LS				0.5	0.5	/
	Devices: Biddeford							
<i>652.38</i>	Flagger	HR			40			40
652 . 41	Portable-Changeable Message Sign	EΑ					5	5
652 . 411	Portable-Changeable Message Sign	CD					60	60
<i>652.4</i> 5	Truck Mounted Attenuator	CD					10	10
652 .4 51	Automated Trailer Mounted Speed Limit Sign	CD					20	20
655.101	#6 AWG Wire	LF		1000				1000
655.//	#IO AWG Wire	LF		250				250
655.204	3" Schedule 80 PVC Conduit	LF					700	700
656.50	Baled Hay, in place	EA	20	2	10	10		42
656,632	30 inch Temporary Silt Fence	LF	500	100	300	300		1200
659.10	Mobilization	LS	0.15	0.10	0.25	0.25	0.25	/

.dgn	Scal	e:			Designed by:	:				
Quantities.dgn							HN	ITB		
- 1	No.	Revision	Ву	Date						
002										
					CONSULTANT I	PROJEC	T MANAGER:	Ashley E. Steph	ens, P	.E.
ä						Ву	Date		Ву	Date
ilename:					Designed	AES	2\18	Checked	LZD	2\18
Ĕ					Drawn	PEB	2\18	In Charge of	RAL	2\18

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THE GOLD STAR MEMORIAL HIGHWAY

BRIDGE AND CULVERT REPAIRS

ESTIMATED QUANTITIES

SHEET NUMBER: EQ-01

MTA PROJECT MANAGER: Ralph C. Norwood, IV, P.E., P.T.O.E.

THE AUTHORITY HAS PROGRAMMED TWO FIELD VISITS FOR MAINE TURNPIKE UTILITY COORDINATION ON THIS PROJECT. SHOULD THE CONTRACTOR NEED ADDITIONAL SIGN LOCATIONS AND/OR ADDITIONAL EXCAVATION LOCATIONS MARKED, OR SHOULD THE CONTRACTOR FAIL TO MAINTAIN THE AUTHORITY'S PREVIOUSLY ESTABLISHED DIG SAFE MARKS, THE AUTHORITY SHALL DEDUCT THE ADDED MARKING COSTS FROM THE CONTRACTOR'S PAYMENTS.

- 3. EXCAVATIONS ACCOMPLISHED AS PART OF THIS PROJECT SHALL BE CONSTRUCTED IN ACCORDANCE WITH OSHA SUBPART P OF 29 CFR PART 1926.650-652 (CONSTRUCTION STANDARDS FOR EXCAVATIONS).
- 4. ALL DETAILS SHALL BE IN CONFORMANCE WITH MAINE DEPARTMENT OF TRANSPORTATION (MAINEDOT) STANDARD DETAILS HIGHWAY AND BRIDGES 2014, WITH LATEST REVISIONS, AND MAINEDOT BEST MANAGEMENT PRACTICES FOR EROSION AND SEDIMENT CONTROL, LATEST REVISION, UNLESS OTHERWISE INCLUDED IN THESE PLANS.
- 5. REINFORCING STEEL SHALL HAVE A CLEAR COVER OF 2" UNLESS OTHERWISE NOTED.
- 6. CHAMFER ALL EXPOSED CONCRETE EDGES 3/4" UNLESS OTHERWISE NOTED.
- 7. WHERE DRILLING AND ANCHORING OF REINFORCING STEEL IS SPECIFIED THE CONTRACTOR SHALL USE A MATERIAL LISTED ON THE MAINEDOT PREQUALIFIED LIST OF CONCRETE ADHESIVE ANCHORING MATERIALS. THE DEPTH OF EMBEDMENT SHALL BE SUFFICIENT TO DEVELOP 125% OF THE YIELD STRENGTH OF THE BAR, BUT SHALL BE NO LESS THAN THE MINIMUM DEPTH OF EMBEDMENT WHEN SPECIFIED. WHERE MINIMUM EMBEDMENT DEPTHS HAVE NOT BEEN SPECIFIED BAR LENGTHS HAVE BEEN DEVELOPED BASED ON AN ASSUMED EMBEDMENT DEPTH OF 9" FOR *5 BARS AND 12" FOR *6 BARS, THE CONTRACTOR SHALL VERIFY THE REQUIRED DEPTH OF EMBEDMENT AND ADJUST THE REQUIRED BAR LENGTHS AS REQUIRED.
- 8. THERE ARE NO PERMANENT OR TEMPORARY EASEMENTS ASSOCIATED WITH THIS PROJECT. ALL WORK SHALL BE COMPLETED WITHIN THE EXISTING RIGHT OF WAY.
- 9. THE CONTRACTOR SHALL SUBMIT THE PROPOSED STAGING AREA(S) TO THE RESIDENT PRIOR TO STARTING WORK.
- IO. CONTRACTOR IS REQUIRED TO MAINTAIN ACCESS TO ALL DRIVEWAYS AND SIDE ROAD DURING CONSTRUCTION UNLESS OTHERWISE SHOWN ON THE PLANS.
- II. ANY DAMAGE TO FINAL PAVEMENT, SLOPES, OR STRUCTURES CAUSED BY THE CONTRACTOR'S EQUIPMENT, PERSONNEL OR OPERATIONS SHALL BE REPAIRED TO THE SATISFACTION OF THE RESIDENT. ALL WORK, EQUIPMENT, AND MATERIALS REQUIRED TO MAKE REPAIRS SHALL BE AT THE
- 12. COPIES OF AS-BUILT PLANS ARE POSTED ON THE MAINE TURNPIKE AUTHORITY WEBSITE AT WWW.MAINETURNPIKE.COM/PROJECT-AND-PLANNING/CONSTRUCTION-CONTRACTS.ASPX. THE COMPLETENESS AND ACCURACY OF THESE PLANS IS NOT GUARANTEED.

MATERIALS

SUBSTRUCTURE CONCRETE REPAIR MATERIALS SHALL BE PER SPECIAL PROVISION 518. ALL OTHER CONCRETE SHALL BE CLASS AAA.

REINFORCING STEEL

AASHTO M31, GRADE 60. ALL REINFORCING SHALL BE EPOXY-COATED.

DRAINAGE NOTES

I. NO EXISTING DRAINAGE SHALL BE ABANDONED, REMOVED OR PLUGGED WITHOUT APPROVAL OF THE RESIDENT.

EROSION CONTROL

- I. ALL TEMPORARY EROSION CONTROL DEVICES SHALL BE INSTALLED IN ACCORDANCE WITH THE MAINE DEPARTMENT OF TRANSPORTATION BEST MANAGEMENT PRACTICES.
- 2. ADDITIONAL MEASURES MAY BE PROPOSED BY THE CONTRACTOR DUE TO SITE OR WEATHER CONDITIONS. THE RESIDENT MAY DIRECT THE CONTRACTOR TO IMPLEMENT ADDITIONAL MEASURES. ANY ADDITIONAL MEASURES APPROVED BY THE RESIDENT WILL BE MEASURED FOR PAYMENT.

GUARDRAIL NOTES

- I. AT THE END OF THE WORK DAY, EVERYDAY, THE CONTRACTOR IS REQUIRED TO HAVE AN APPROVED CRASHWORTHY END TREATMENT ON ALL GUARDRAIL WITHIN ALL WORK AREAS THAT ARE ACCESSIBLE TO
- 2. CONNECTIONS FOR PROPOSED GUARDRAIL TO EXISTING GUARDRAIL SHALL BE INCIDENTAL TO THE PROPOSED GUARDRAIL ITEMS.
- 3. FOR ALL NEW GUARDRAIL TYPE 3d, OFFSET BLOCKS SHALL BE NON-WOOD CONFORMING TO NCHRP 350 TEST LEVEL.
- 4. ALL PROPOSED GUARDRAIL AND RESET GUARDRAIL SHALL BE INSTALLED IN A MANNER TO AVOID DRAINAGE STRUCTURES AND UTILITIES.

LIGHTING

- I. EXISTING CONDUIT IS ASBESTOS CEMENT CONDUIT. CONTRACTOR SHALL TAKE EXTREME CARE NOT TO DAMAGE IT.
- 2. ALL WIRE SHALL BE COPPER, NO ALUMINUM WIRE IS ALLOWED.
- 3. PROPOSED NON-METALLIC CONDUIT SHALL BE 2" SCHEDULE 80 PVC AND CONTAIN FOUR #6 AND ONE **#IO** (GROUND) WIRES. CONSISTENT WITH EXISTING CIRCUIT. CONTRACTOR TO FIELD VERIFY.
- 4. CONTRACTOR SHALL ONLY EXCAVATE AN AMOUNT OF UTILITY TRENCH THAT CAN BE BACKFILLED IN THE SAME DAY. UTILITY TRENCHES SHALL NOT BE LEFT OPEN OVER NIGHT.

EARTHWORK

I. WASTE MATERIALS SHALL BE DISPOSED OF OFF THE PROJECT SITE, IN ACCORDANCE WITH ALL ENVIRONMENTAL REGULATIONS.

LIST OF ABBREVIATIONS

ABUT. - ABUTMENT ADDL. - ADDITIONAL ALT. - ALTERNATE

APPROX. - APPROXIMATELY

BOT. - BOTTOM BRG. - BEARING CL. - CLEAR

€ - CENTERLINE CONC. - CONCRETE

CONSTR. - CONSTRUCTION DEMO. - DEMOLITION

DIA. - DIAMETER

EA. - EACH

EB - EASTBOUND E.F. - EACH FACE

EL. - ELEVATION

EQ. - EQUAL

EXIST. - EXISTING

EXP. - EXPANSION F.F. - FAR FACE

JT. - JOINT

MAX. - MAXIMUM

MAINEDOT - MAINE DEPARTMENT OF TRANSPORTATION

MIN. - MINIMUM

MTA - MAINE TURNPIKE AUTHORITY

NB - NORTHBOUND N.F. - NEAR FACE

N.T.S. - NOT TO SCALE

PED. - PEDESTAL

PGL - PROFILE GRADE LINE

P - PLATE

PROP. - PROPOSED

P.S.I. - POUNDS per SQUARE INCH

RDWY. - ROADWAY SHI DR. - SHOULDER

SB - SOUTHBOUND

SP. - SPACES

STA. - STATION

T.&B. - TOP & BOTTOM

TPKE. - TURNPIKE

TYP. - TYPICAL

U.O.N. - UNLESS OTHERWISE NOTED

VERT. - VERTICAL WB - WESTBOUND

W.P. - WORKING POINT

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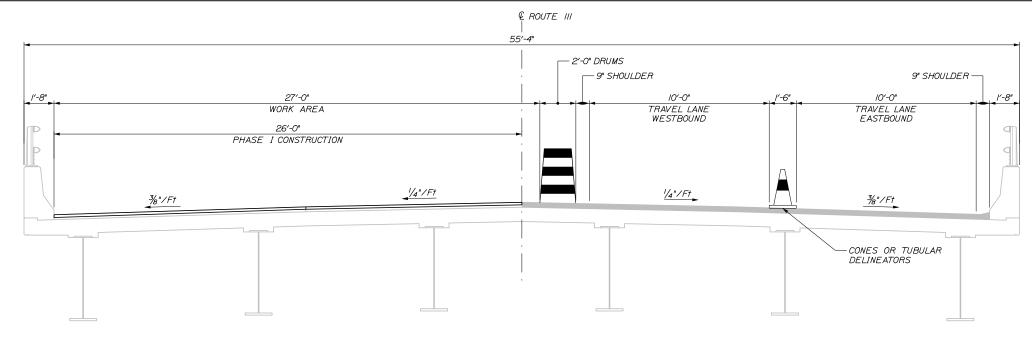
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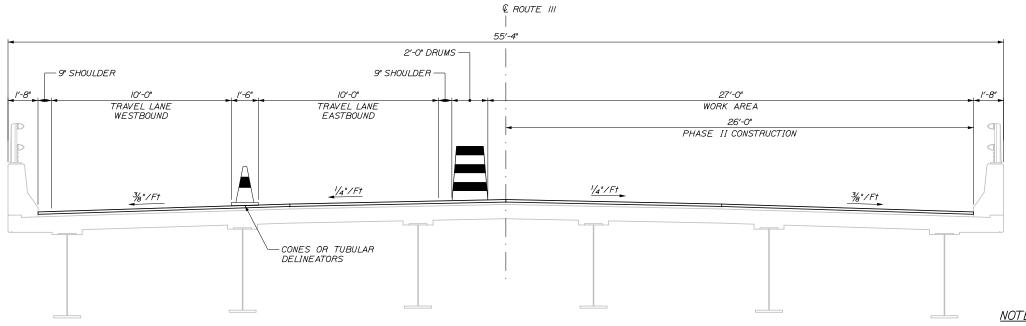
THE GOLD STAR MEMORIAL HIGHWAY BRIDGE AND CULVERT REPAIRS

GENERAL NOTES

SHEET NUMBER: GN-01



PHASE I CONSTRUCTION



PHASE II CONSTRUCTION

CONTRACT:2018.06

I. PHASE I AND II HEADER, JOINT INSTALLATION, AND PARAPET REPAIRS SHALL BE UNDERTAKEN AT NIGHT TO MINIMIZE IMPACT ON THE TRAFFIC.

2. AT THE END OF EACH WORK SHIFT ANY OPEN DECK OR AN THE END OF EACH WORK SHIFT AND OFEN DECK OF HEADER AREAS SHALL BE STEEL PLATED TO PREVENT PEDESTRIANS AND VEHICLES FROM FALLING INTO THE OPENING(S). PAYMENT SHALL BE INCIDENTAL TO RELATED CONTRACT ITEMS.

3. PARAPET REPAIRS SHALL ONLY OCCUR OVER CLOSED TRAVEL LANES OR SHOULDERS. SEE THE SPECIFICATIONS FOR PERMITTED TRAVEL LANE AND SHOULDER CLOSURE

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2\18 In Charge of RAL Designed


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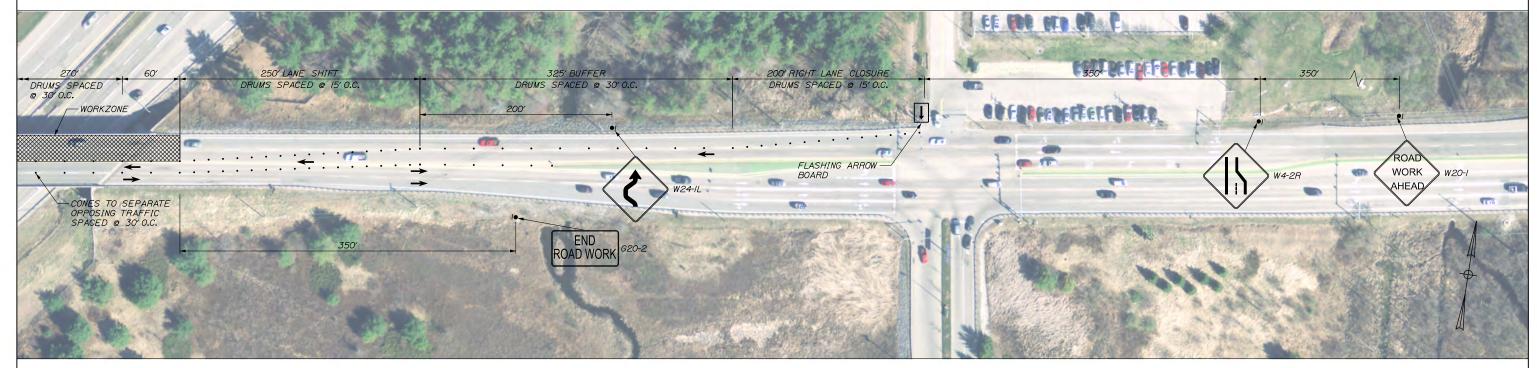
THE GOLD STAR **MEMORIAL HIGHWAY** BRIDGE AND CULVERT REPAIRS MAINTENANCE OF TRAFFIC ROUTE 111

CONSTRUCTION PHASING


SHEET NUMBER: MOT-01



<u>PLAN</u>

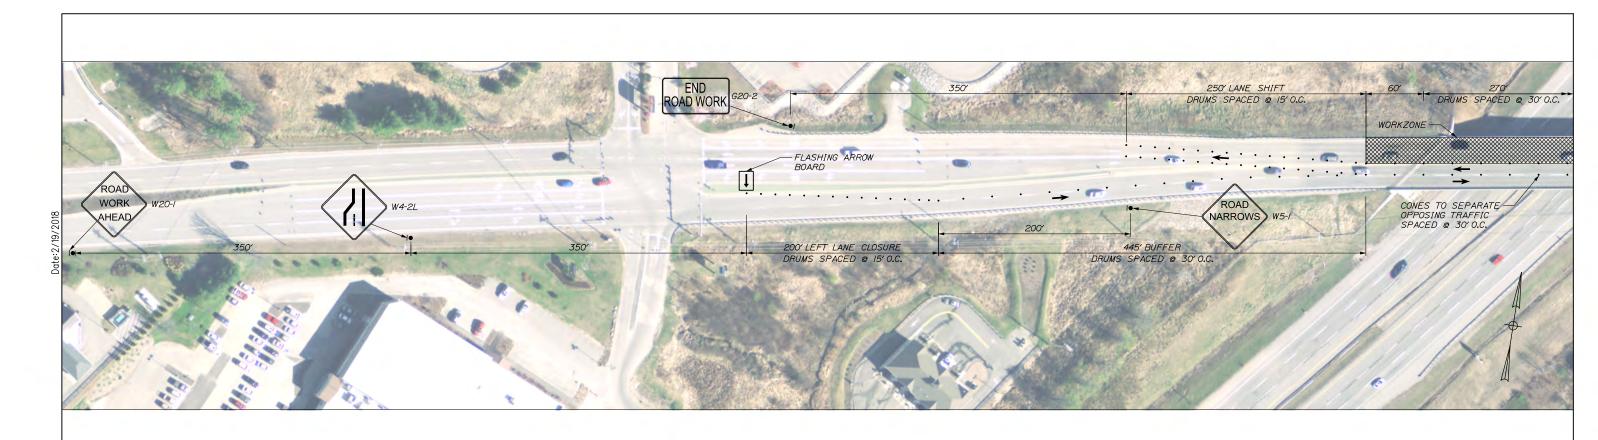

<u>PLAN</u>

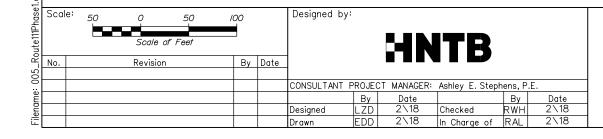


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THE GOLD STAR MEMORIAL HIGHWAY MAINTENANCE OF TRAFFIC ROUTE 111 PHASE I

SHEET NUMBER: MOT-02
CONTRACT:2018.06 5 0F 48


BRIDGE AND CULVERT REPAIRS



<u>PLAN</u>

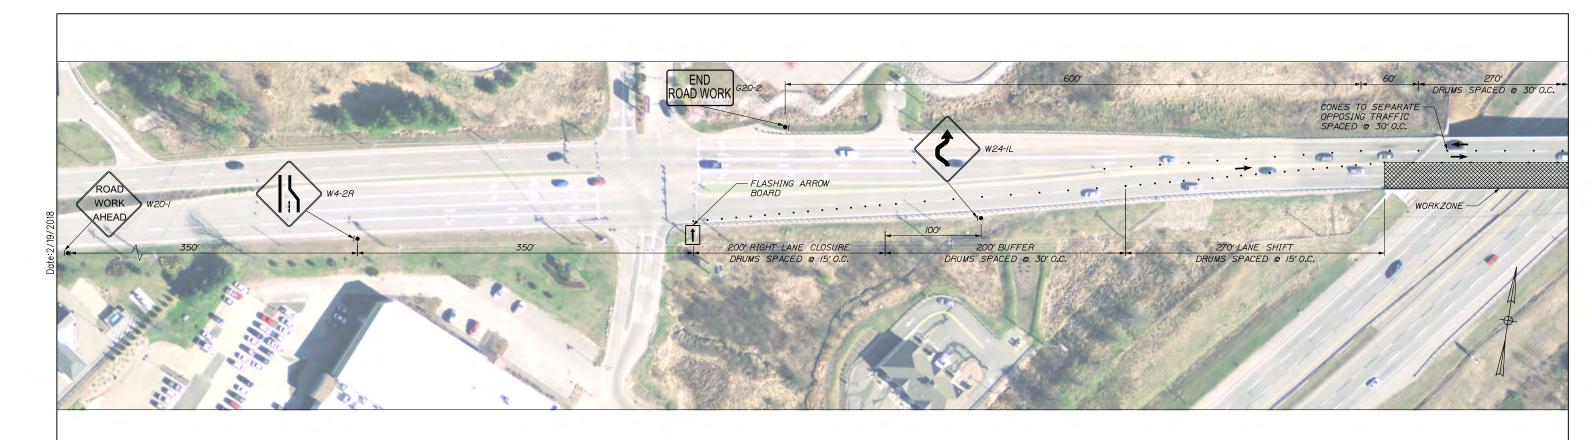

<u>PLAN</u>

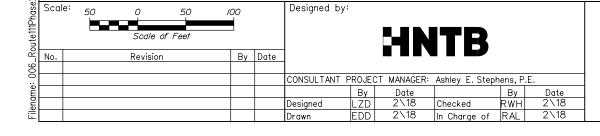

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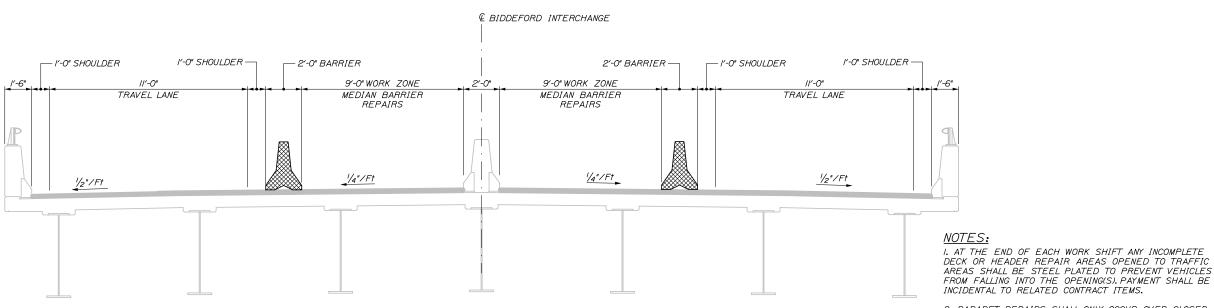


THE GOLD STAR MEMORIAL HIGHWAY MAINTENANCE OF TRAFFIC ROUTE 111 PHASE II

SHEET NUMBER: MOT-03
CONTRACT:2018.06 6 OF 48

BRIDGE AND CULVERT REPAIRS

PHASE I CONSTRUCTION



PHASE II CONSTRUCTION

INCIDENTAL TO RELATED CONTRACT ITEMS. 2. PARAPET REPAIRS SHALL ONLY OCCUR OVER CLOSED TRAVEL LANES OR SHOULDERS. SEE THE SPECIFICATIONS FOR PERMITTED TRAVEL LANE AND SHOULDER CLOSURE

3. END POST MODIFICATIONS AND PARAPET REPAIRS SHALL OCCUR DURING PHASE I. MEDIAN BARRIER REPAIRS SHALL OCCUR DURING PHASE II.

4. ALL EXISTING ASPHALTIC PLUG JOINT BRIDGING PLATES SHALL BE REMOVED AS PART OF THE PROPOSED WORK.

5. PAVEMENT MILLING, PAVING, AND ASPHALTIC PLUG JOINT INSTALLATION WORK MAY BE COMPLETED WITH NIGHTLY

RAMP CLOSURES IN ACCORDANCE WITH SPECIAL ROVISION

풀| Scale: Designed by: By Date Revision CONSULTANT PROJECT MANAGER: Ashley E. Stephens, P.E. Ву Designed 2\18 In Charge of RAL

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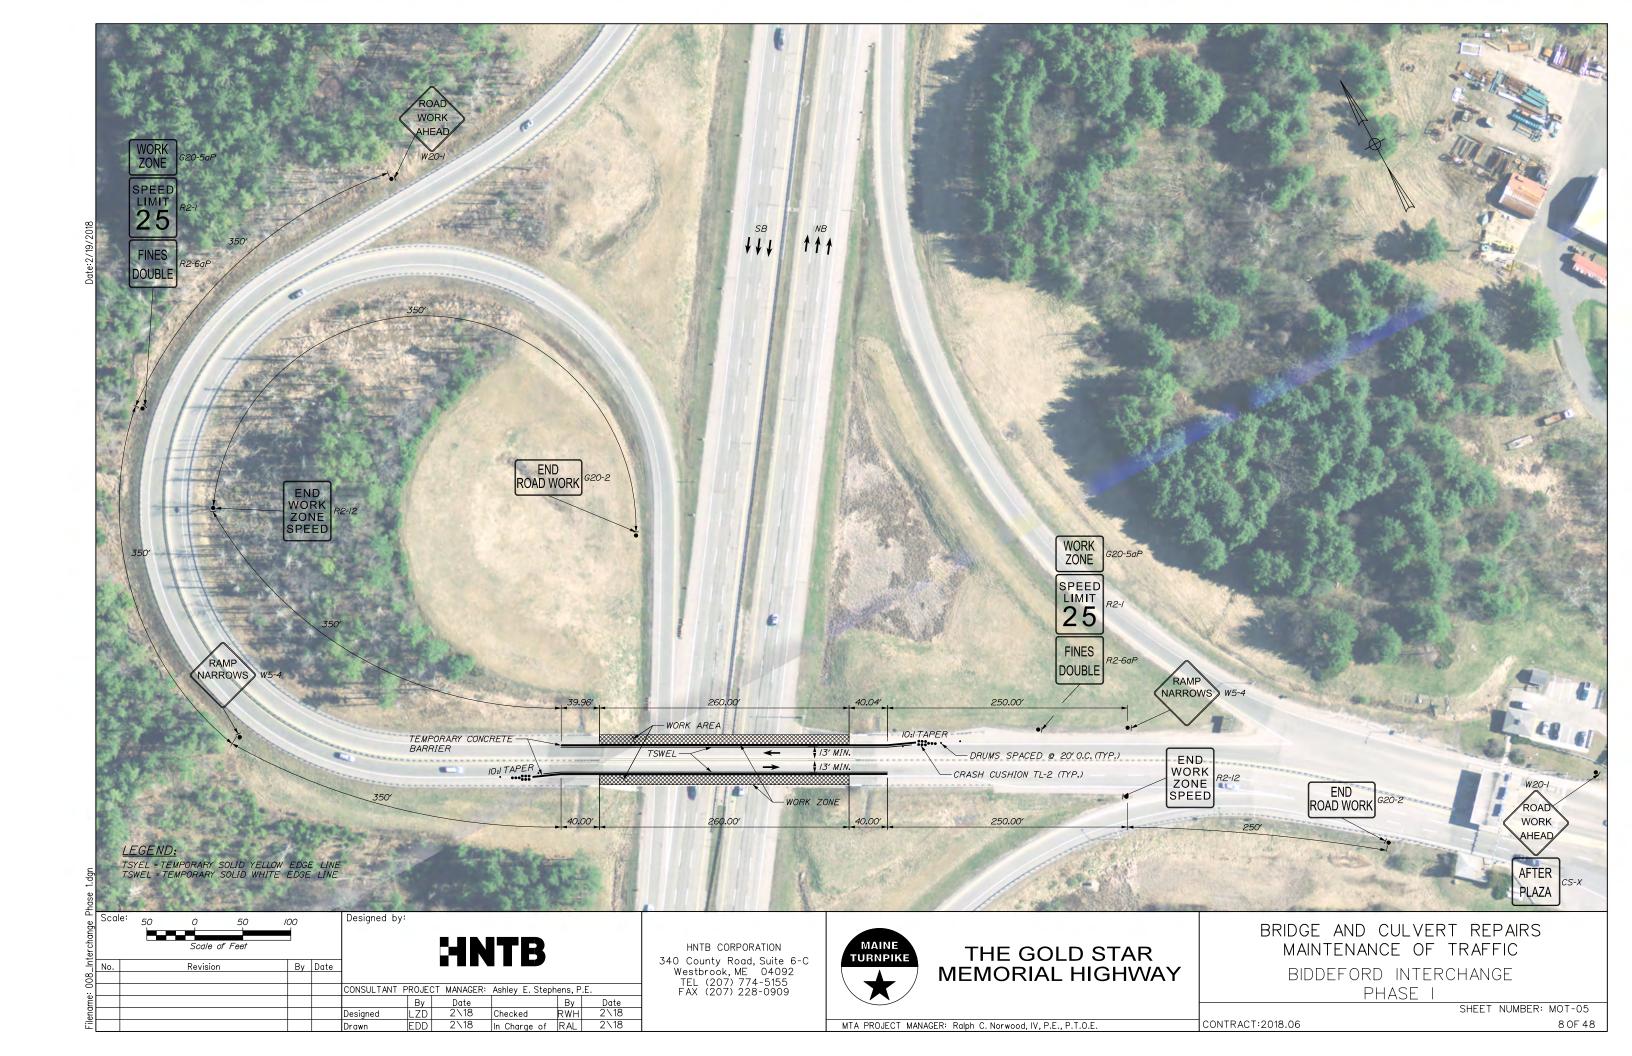
THE GOLD STAR **MEMORIAL HIGHWAY** MAINTENANCE OF TRAFFIC BIDDEFORD INTERCHANGE


BRIDGE AND CULVERT REPAIRS


CONSTRUCTION PHASING


CONTRACT:2018.06

SHEET NUMBER: MOT-04



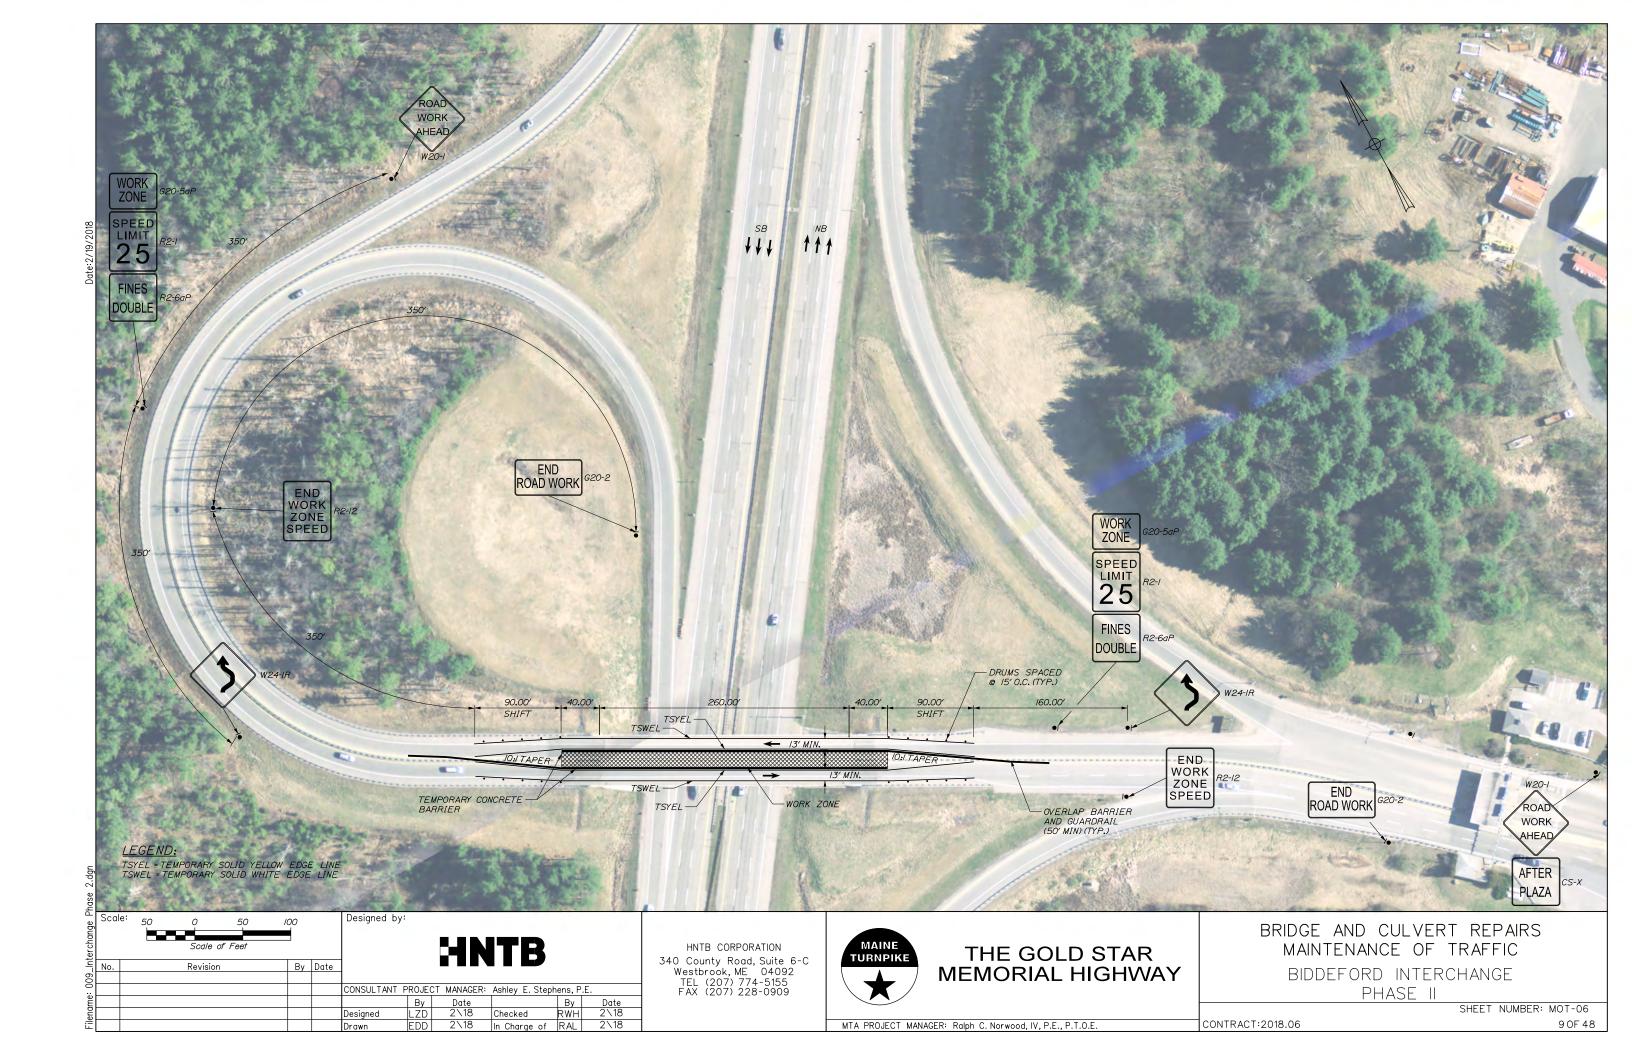

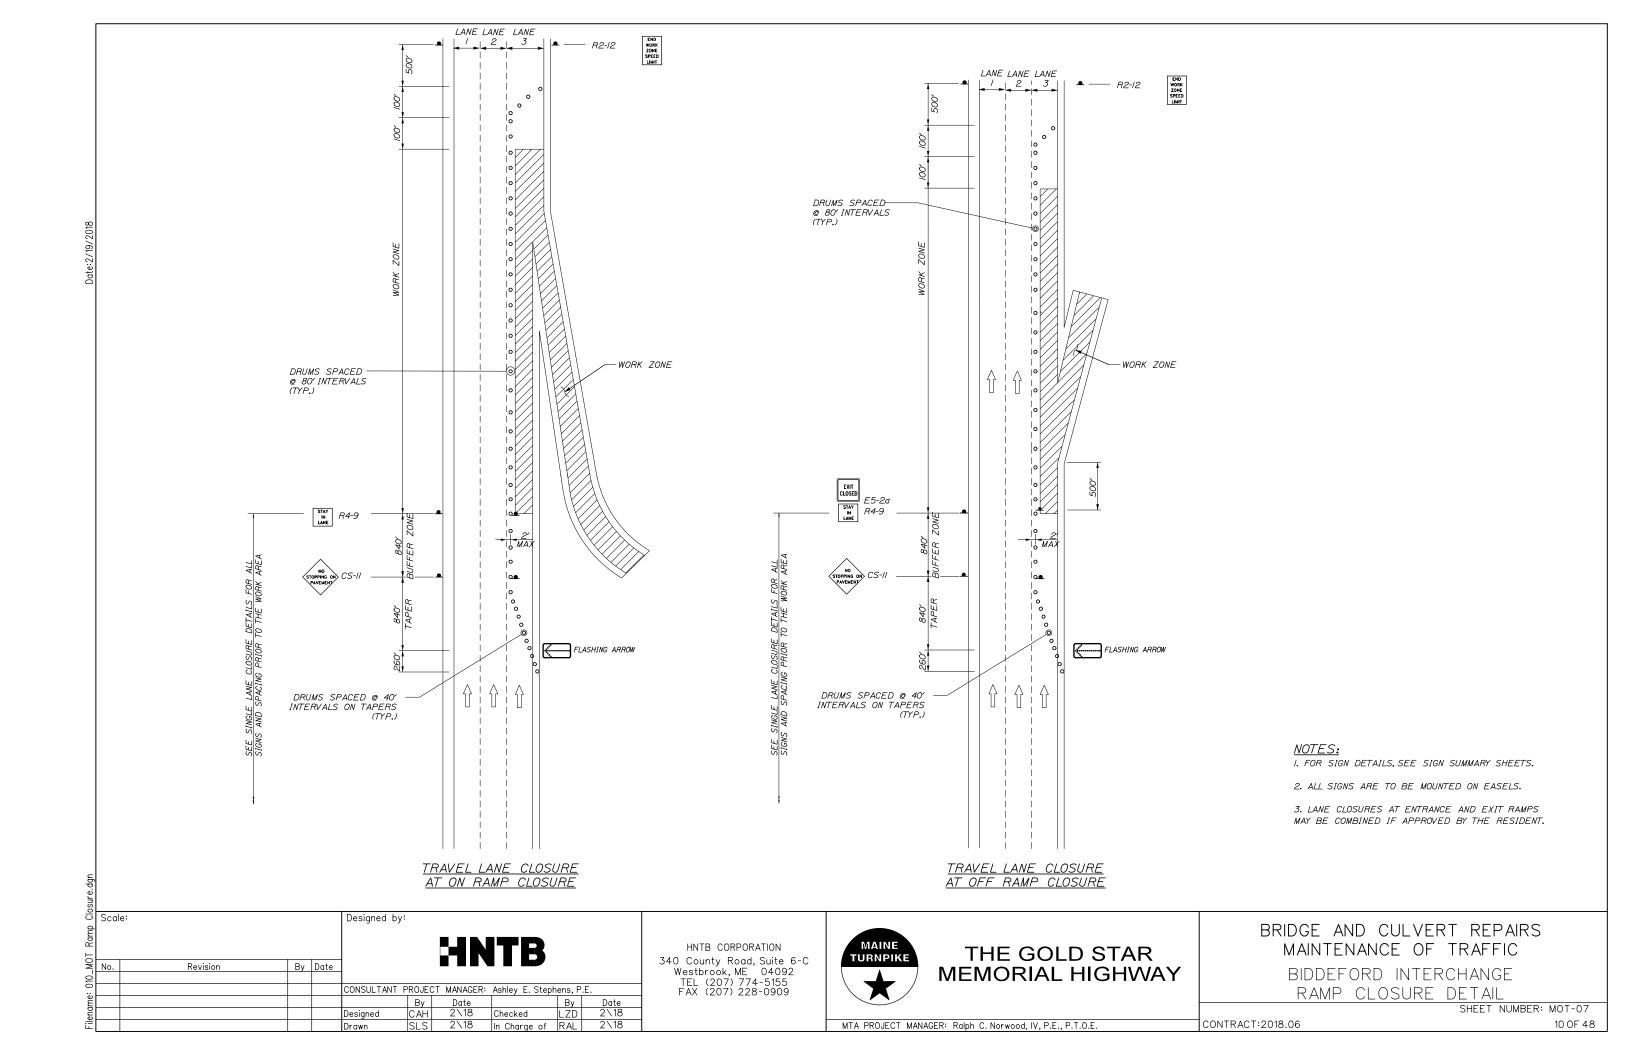

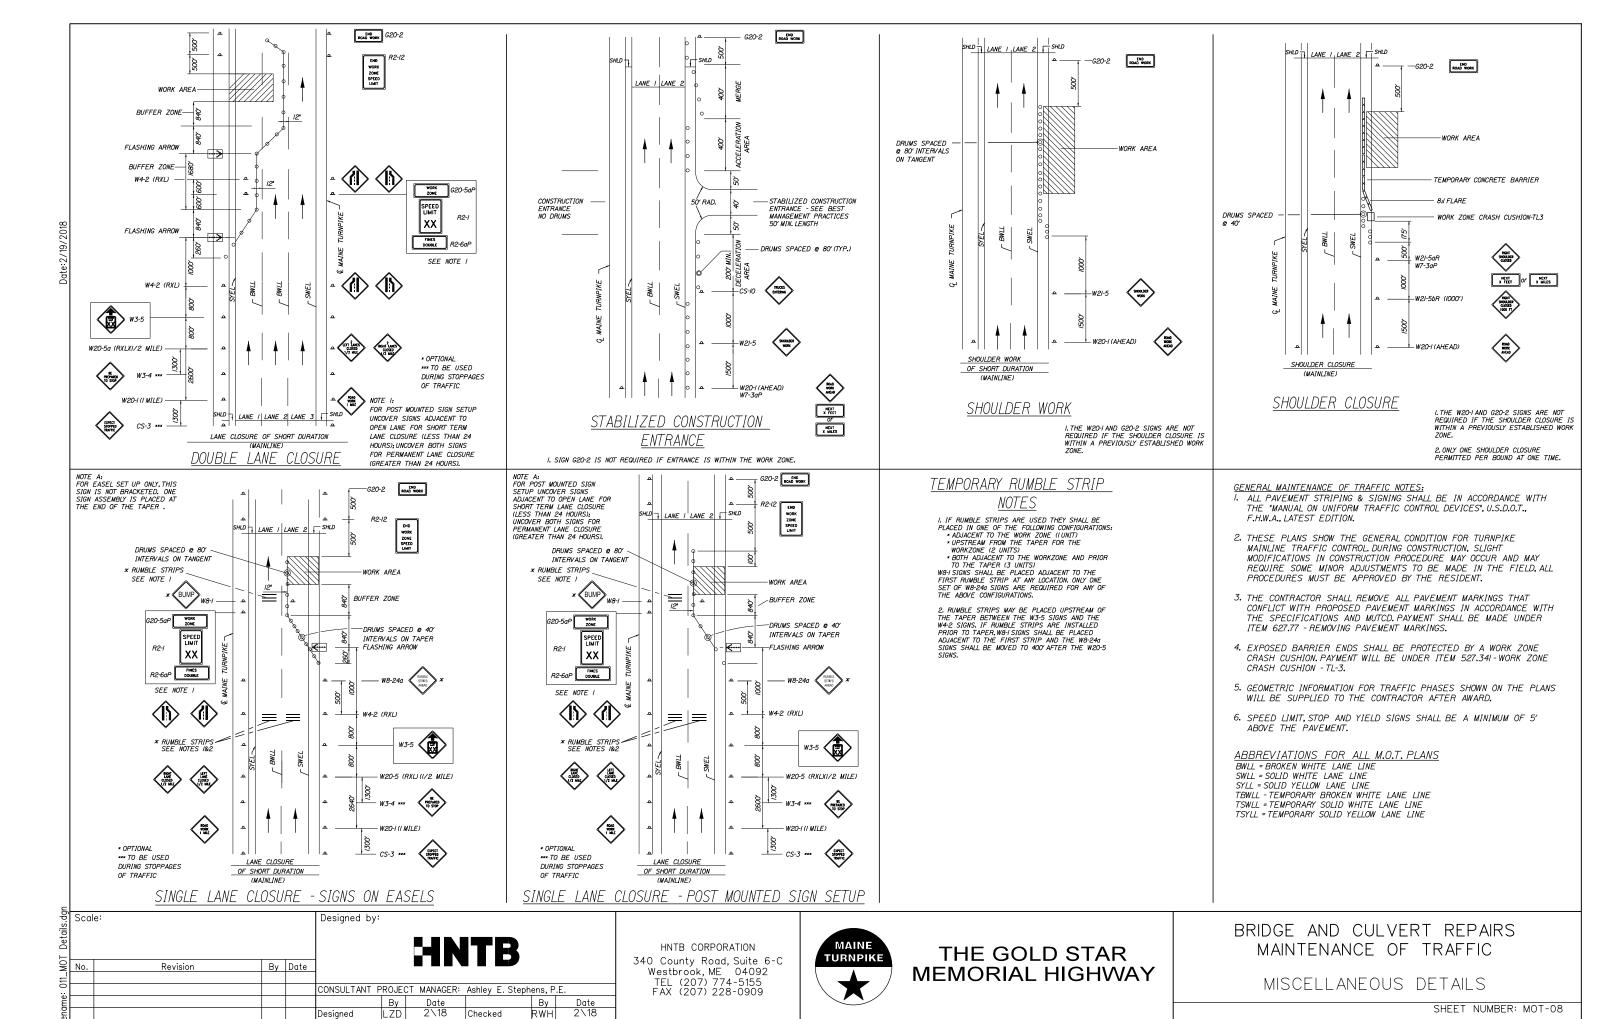

In Charge of RAL

MTA PROJECT MANAGER: Ralph C. Norwood, IV. P.E., P.T.O.E.

CONTRACT: 2018.06 11 OF 48

IDENTIFI-		E OF GN		TEXT DII	MENSIONS	(INCHES)		BER F		COL	OR .		BORDER	AREA IN
CATION NUMBER	WIDTH	HEIGHT	TEXT		VERTICAL SPACING		SI	INS VIRED		CK- UND		END DER	RADIUS	SQUARE FEET
CS-X	48"	24"	AFTER PLAZA	CONFOR	IMENSIONS RM TO "STA AY SIGNS"	ANDARD	BY	BD THE PACTOR	ORA	NGE	BLA	4CK		8.00 (TBD)
CS-II	48"	48"	NO STOPPING ON PAVEMENT											16.00 (TBD)
E5-2	48"	36"	EXIT CLOSED											12.00 (TBD)
PLACARD	48"	18"	AHEAD											6.00 (TBD)
G20-2	48"	24"	END ROAD WORK											8.00 (TBD)
G20-5aP	48"	24"	WORK ZONE						1		,			8.00 (TBD)
R2-I (25)	48"	60"	SPEED LIMIT XX						WH.	ITE	BLA	ACK		20.00 (TBD)
R2-6aP	48"	24"	FINES DOUBLED											8.00 (TBD)
R2-I2	48"	60"	END WORK ZONE SPEED											20.00 (TBD)
R4-9	36"	48"	STAY IN LANE	,			1		,					12.00 (TBD)

IDENTIFI-		E OF IGN		TEXT DI	MENSIONS	(INCHES)		BER F		COL	OR		BORDER	AREA IN
CATION NUMBER	WIDTH	HEIGHT	TEXT	LETTER HEIGHT	VERTICAL SPACING	ARROW RTE.MKR.	SIC	GNS VIRED	BA GRC	CK- DUND	LEG BOR	SEND RDER	RADIUS	SQUARE FEET
W3-5 (25)	48"	48"	SPEED LUHIT XX	CONFOR	DIMENSIONS RM TO "STA VAY SIGNS"	ANDARD	BY	BD THE RACTOR		NGE	BL/	ACK		16.00 (TBD)
W4-2L	48"	48"												16.00 (TBD)
W4-2R	48"	48"												16.00 (TBD)
W5-/	48"	48"	ROAD											16.00 (TBD)
W5-4	48"	48"	RAMP											16.00 (TBD)
W8-I	48"	48"	BUMP											16.00 (TBD)
W8-/5×	48"	48"	GROOVED PAVEMENT											16.00 (TBD)
W8-I5P*	30"	24"	0											16.00 (TBD)
W/3-4P	24"	24"	ON RAMP		,				1		,			16.00 (TBD)

^{*}TO BE INSTALLED ON MAINE TURNPIKE 500' BEFORE EXIT RAMP AND ON ROUTE III EB AND WB 500' BEFORE TURNPIKE ENTRANCE WHEN GROOVED PAVEMENT EXISTS.

Sco	ale:					Designed by:	:				
No.		NOT TO	SCALE					HN	ITR		
		Revision		Ву	Date						
						CONSULTANT F	PROJEC	T MANAGER:	Ashley E. Steph	nens, P.I	Ε.
							Ву	Date		Ву	Date
						Designed	LZD	2\18	Checked	RWH	2\18
						Drawn	EDD	2\18	In Charge of	RAL	2\18

HNTB CORPORATION 340 County Road, Suite 6-C Westbrook, ME 04092 TEL (207) 774-5155 FAX (207) 228-0909



THE GOLD STAR MEMORIAL HIGHWAY

BRIDGE AND CULVERT REPAIRS MAINTENANCE OF TRAFFIC

SIGN SUMMARY I

SHEET NUMBER: MOT-09

MTA PROJECT MANAGER: Ralph C. Norwood, IV, P.E., P.T.O.E.

IDENTIFI- CATION		E OF IGN		TEXT DI	MENSIONS	(INCHES)		BER F		COL)R		BORDER	AREA I
NUMBER	WIDTH	HEIGHT	TEXT	LETTER HEIGHT	VERTICAL SPACING	ARROW RTE.MKR.	SI	, GNS VIRED	BAI GRO	CK- UND		END	RADIUS	SQUARE FEET
W20-I (AHEAD)	48"	48"	ROAD WORK XXXX	CONFOR	NIMENSIONS RM TO "ST, AY SIGNS"	ANDARD	BY	BD THE ACTOR	ORA	NGE	BL	ACK		16.00 (XX)
W20-5L (I/2 MILE)	48"	48"	LEFT LANE CLOSED XXX											16.00 (XX)
W20-5R (I/2 MILE)	48"	48"	RIGHT LANE CLOSED XXX											16.00 (XX)
W24-IL	48"	48"												16.00 (XX)
W24-IR	48"	48"	\$,					16.00 (XX)

Scale: Designed by: NOT TO SCALE By Date Revision CONSULTANT PROJECT MANAGER: Ashley E. Stephens, P.E.
 Date
 By
 Date

 2\18
 Checked
 RWH
 2\18

 2\18
 In Charge of
 RAL
 2\18
 Designed Drawn

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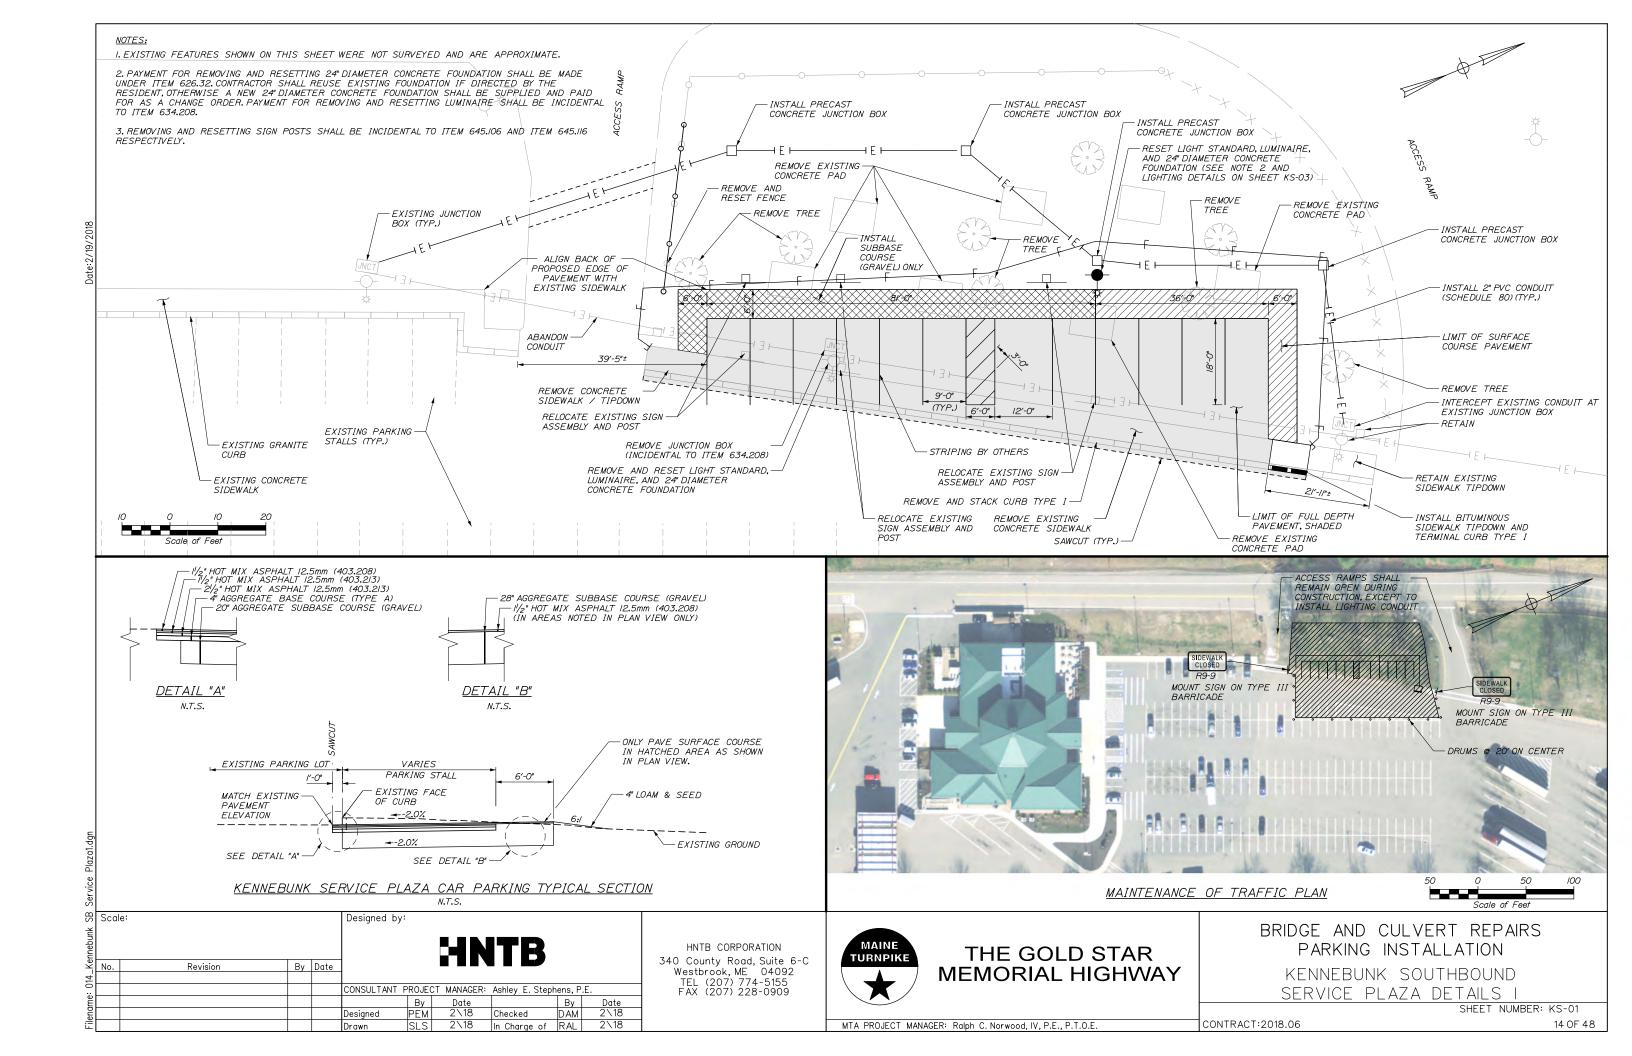



BRIDGE AND CULVERT REPAIRS MAINTENANCE OF TRAFFIC

SIGN SUMMARY II

CONTRACT: 2018.06

SHEET NUMBER: MOT-10




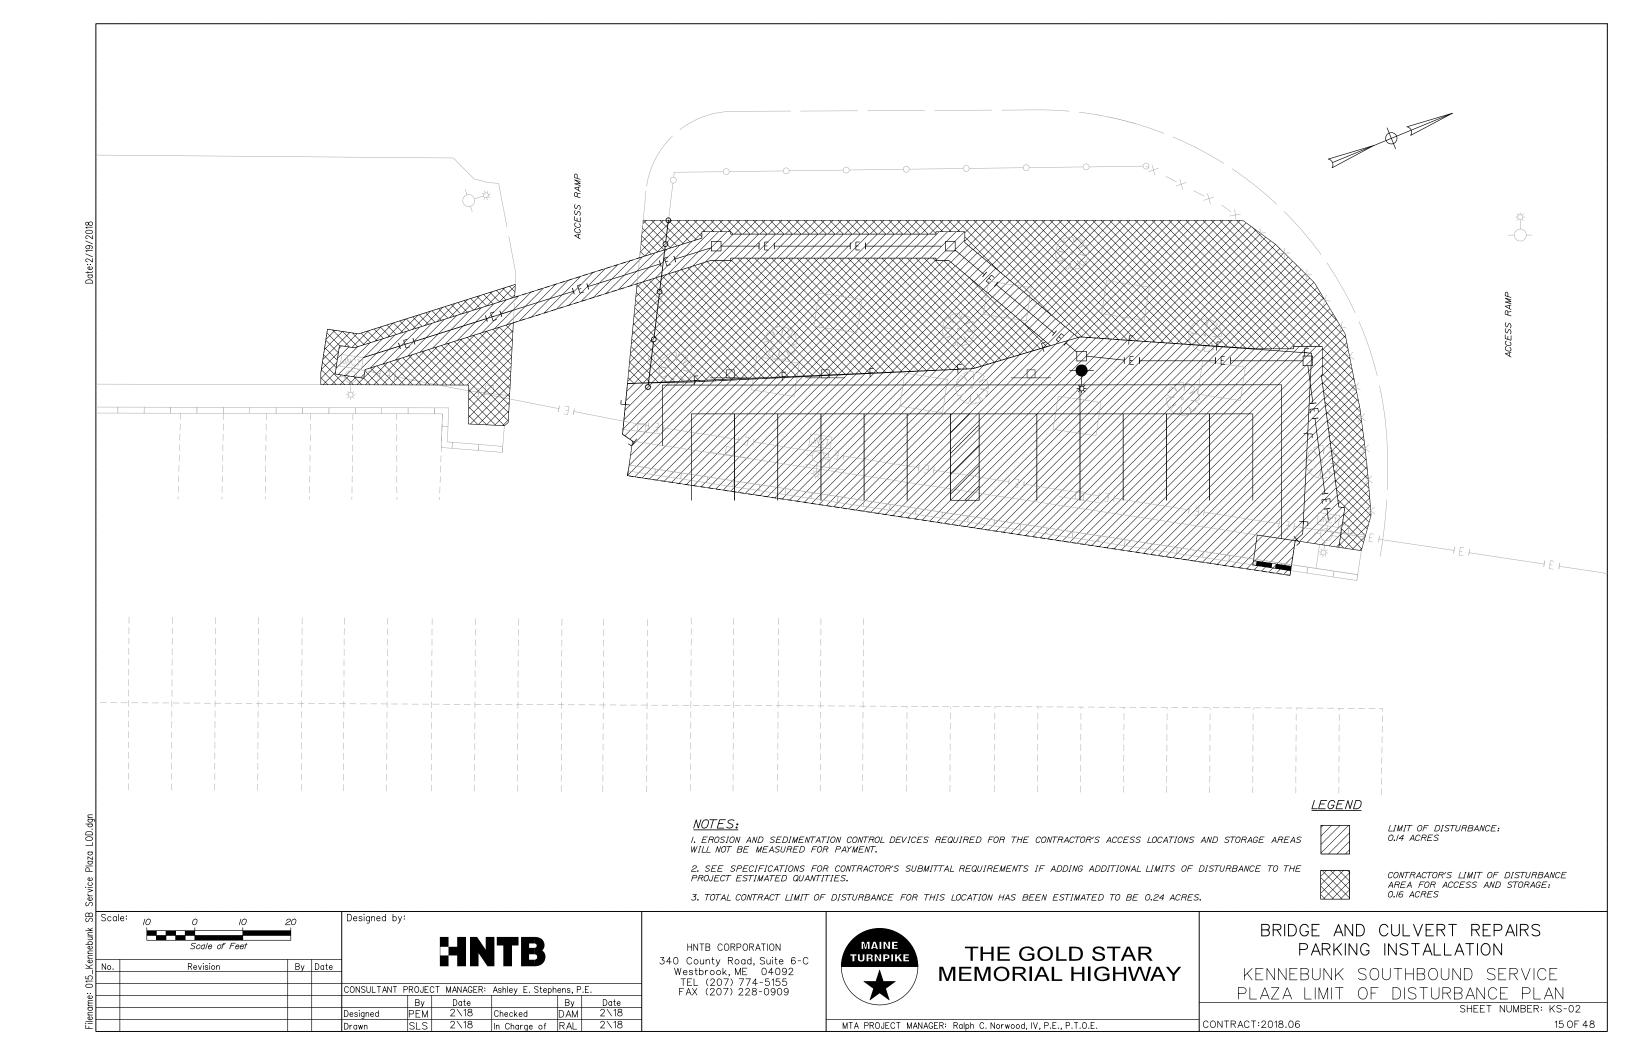

I. SEE SHEET CD-01 FOR STANDARD CONDUIT TRENCH DETAIL

2. QUAZITE® JUNCTION BOXES FOR HIGHWAY LIGHTING SHALL BE QUAZITE AND IN ACCORDANCE WITH SPECIAL PROVISION 626.

3. SPLICES IN JUNCTION BOX SHALL BE MADE WITH ILSCO USPA-350-SS-DB SAFETYSUB WATER TIGHT DIRECT BURY SPLICE WIRE RANGE 350MCM-10-STR, ONLY. PROVIDE ENOUGH SLACK IN THE WIRE TO ALLOW REMOVAL OF SPLICES AND NEATLY ARRANGE WIRE IN BOX.

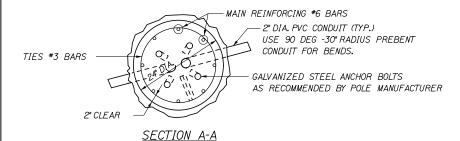




-SLOPE

EMBANKMENT


FOUN


EMOVE AND DISPOSE EXISTING CONCRETE H

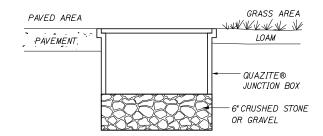

JUNCTION BOX COVER & FRAME


INSTALL JUNCTION BOXES ON GRADE

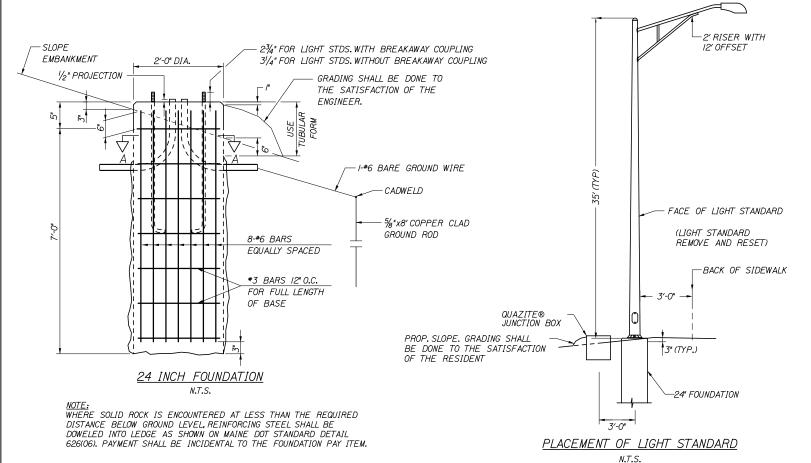

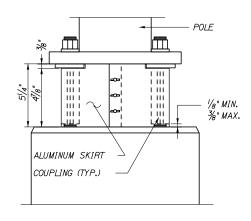

BREAKAWAY COUPLINGS AND SKIRT DETAIL * N.T.S.

* BREAKAWAY COUPLINGS SHALL BE REQUIRED ON ALL NEW LIGHT STANDARDS

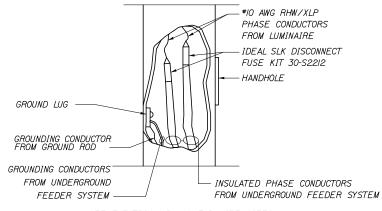

*SEE ELECTRICAL PLANS FOR WIRE SIZES

TYPICAL POLE WIRING DETAIL

SB		e:			Designed by:					
.Kennebunk		NOT TO SCALE					HN	ITR		
-Ke	No.	Revision	Ву	Date						
016.										
					CONSULTANT F	PROJEC	CT MANAGER:	Ashley E. Steph	ens, P	E.
me						Ву	Date		Ву	Date
Filename					Designed	PEM	2\18	Checked	DAM	2\18
File					Drawn	SLS	2\18	In Charge of	RAL	2\18

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BACKFILL WITH AGGREGATE SUBBASE


COURSE-GRAVEL WHERE APPLICABLE
GRADE 4" LOAM WHERE APPLICABLE

MATCH SURROUNDING AREA


THE GOLD STAR MEMORIAL HIGHWAY BRIDGE AND CULVERT REPAIRS PARKING INSTALLATION KENNEBUNK SOUTHBOUND SERVICE PLAZA DETAILS II

SHEET NUMBER: KS-03


MTA PROJECT MANAGER: Ralph C. Norwood, IV. P.E., P.T.O.E.

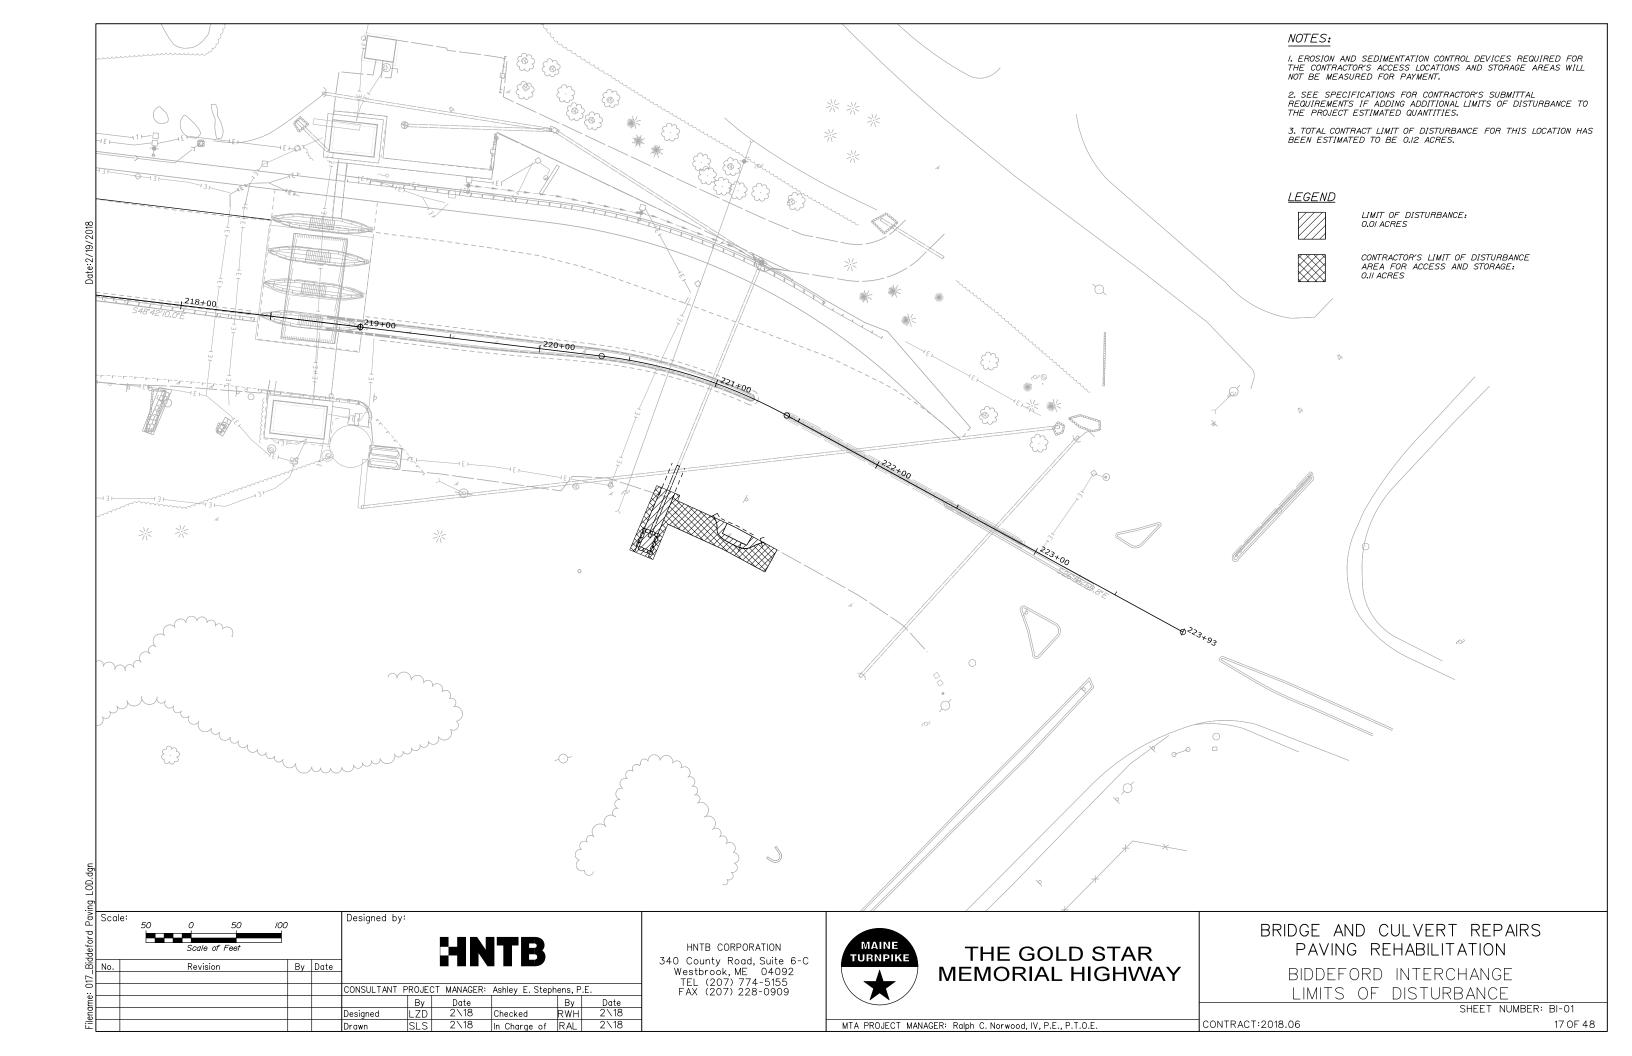

MILL AND FILL RAMP WITHOUT GUARDRAIL SECTION A-A

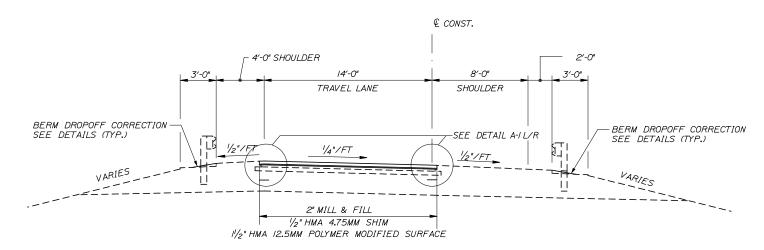

MILL AND FILL RAMP WITH GUARDRAIL SECTION A-A

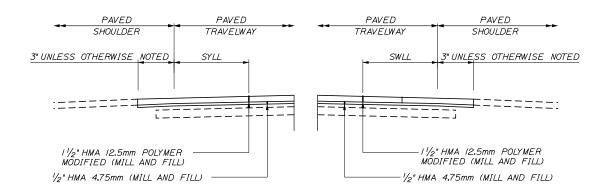

<u>DETAIL A-IL</u> N.T.S.

<u>DETAIL A-IR</u> N.T.S.

* 2" = 35' |\|\/2" = 29' * VARIES PROP. MILLING -DEPTH VARIES (2" MAX.) HOT BITUMINOUS PAVEMENT PLACED ON SAND (SEE NOTES 5 & 6) EXIST. PAVEMENT STRUCTURE

TEMPORARY BITUMINOUS RAMP

NOTES:

I. MILL TO 3 INCHES LEFT OF SYLL AND 3 INCHES RIGHT OF SWLL UNLESS OTHERWISE NOTED. MILL AND FILL TO DOUBLE GUARDRAIL IN MEDIAN WEST OF PLAZA, AND GRANITE CURB IN MEDIAN EAST OF

2. BITUMINOUS TACK COAT IS REQUIRED BETWEEN THE EXISTING PAVEMENT AND THE HMA 4.75MM SHIM; AND THE HMA 4.75MM SHIM AND 12.5MM POLYMER MODIFIED SURFACE.


3. FULL DEPTH PATCHES ON SHOULDERS, IF REQUIRED, WILL BE PAID UNDER 403.2084 HOT MIX ASPHALT, 12.5MM NOMINAL MAXIMUM SIZE (SIDEWALKS, DRIVES, ISLANDS, AND INCIDENTALS)

4. A COATING OF ASPHALT LOW MODULUS JOINT SEALER (ASTM D6690 TYPE IV) SHALL BE APPLIED AT THE TOP SURFACE LIFT TO ALL TRANSVERSE BUTT JOINTS AND LONGITUDINAL JOINTS EXCEPT WHERE THE NOTCHED WEDGE IS USED.

5. HOT MIX ASPHALT FOR TEMPORARY RAMPS WILL NOT BE MEASURED FOR PAYMENT, BUT SHALL BE INCIDENTAL TO HOT MIX ASPHALT 12.5MM POLYMER MODIFIED.

6. REMOVAL OF TEMPORARY BITUMINOUS RAMPS WILL NOT BE MEASURED FOR PAYMENT, BUT SHALL BE INCIDENTAL TO HOT MIX ASPHALT 12.5MM

CONTRACT:2018.06

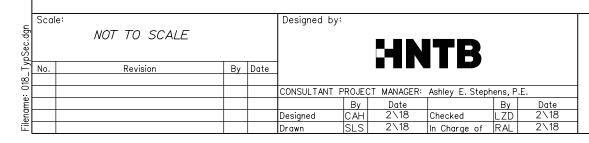



HNTB CORPORATION 340 County Road, Suite 6-C Westbrook, ME 04092 TEL (207) 774-5155 FAX (207) 228-0909





THE GOLD STAR **MEMORIAL HIGHWAY** BRIDGE AND CULVERT REPAIRS PAVING REHABILITATION BIDDEFORD INTERCHANGE TYPICAL SECTIONS

SHEET NUMBER: BI-02

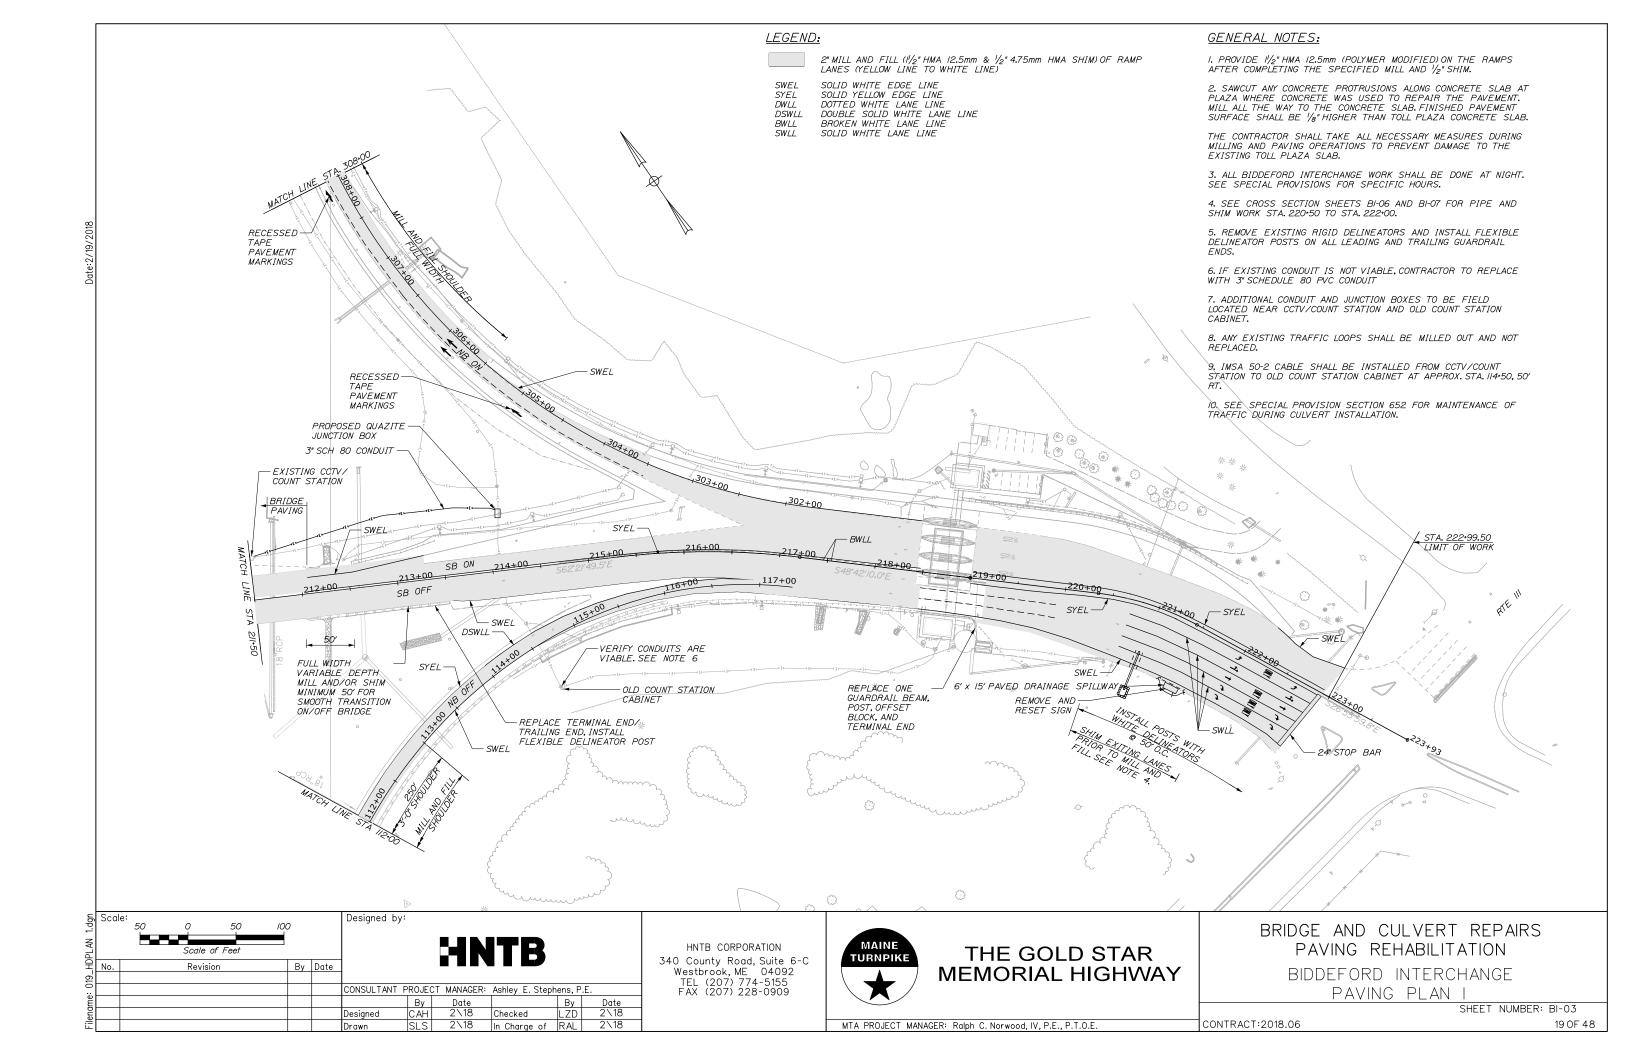

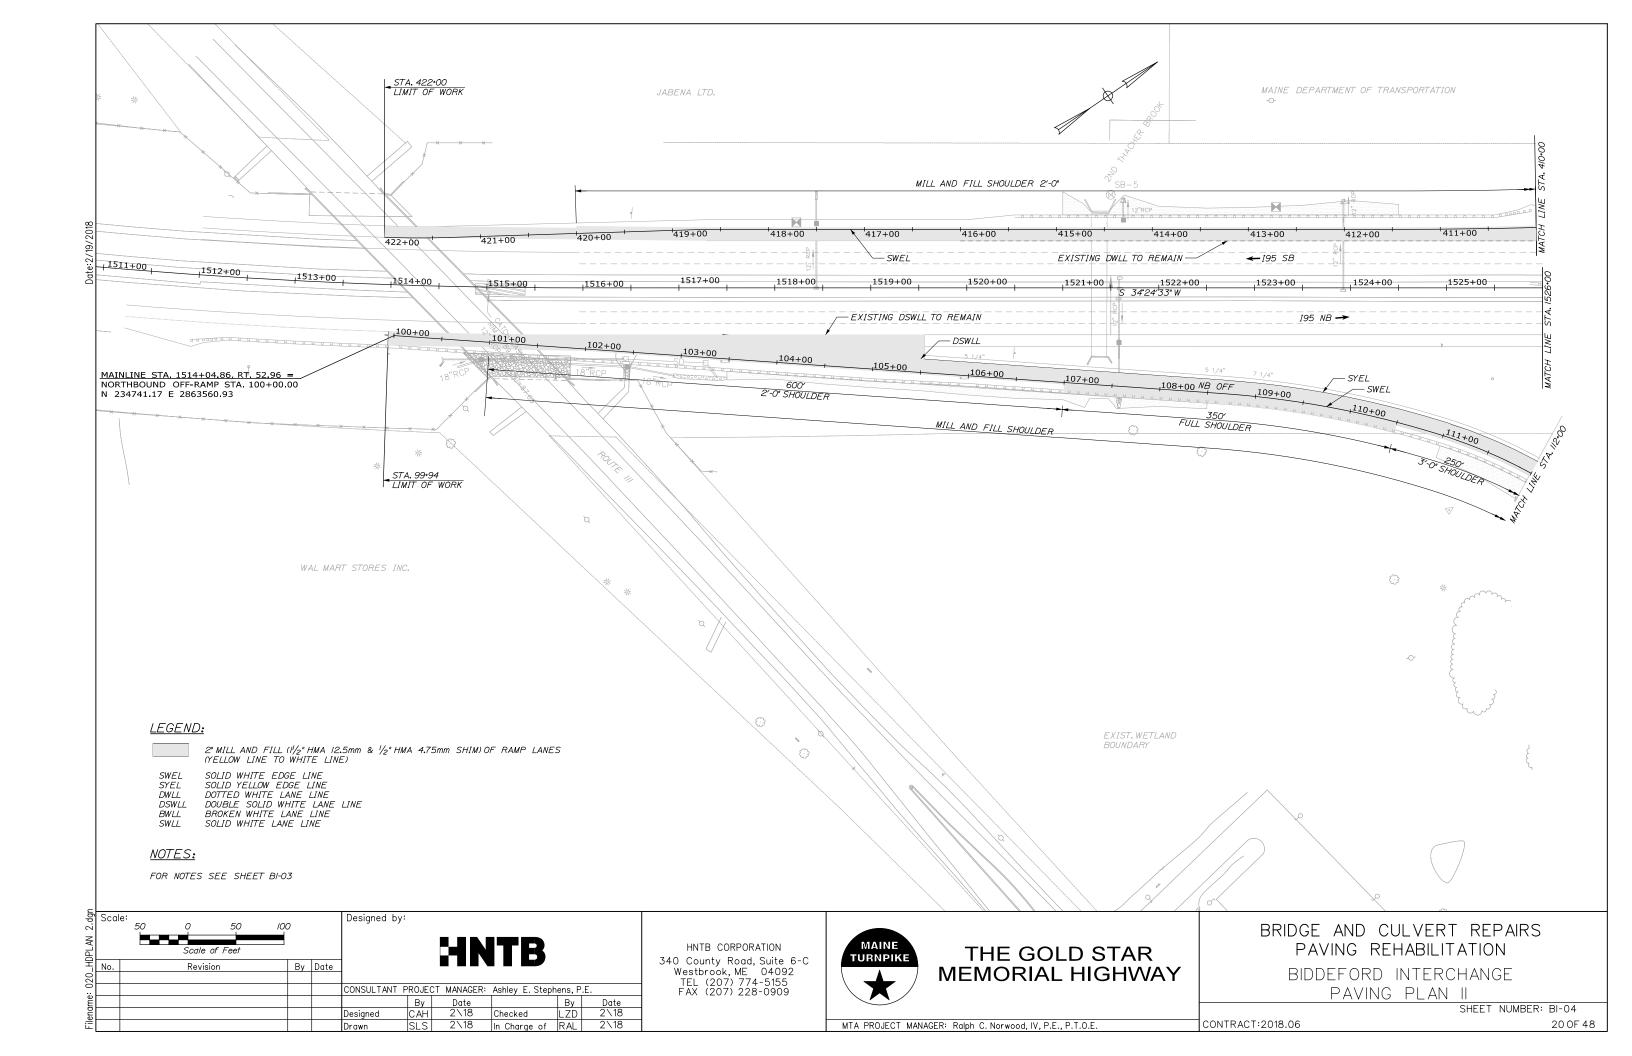

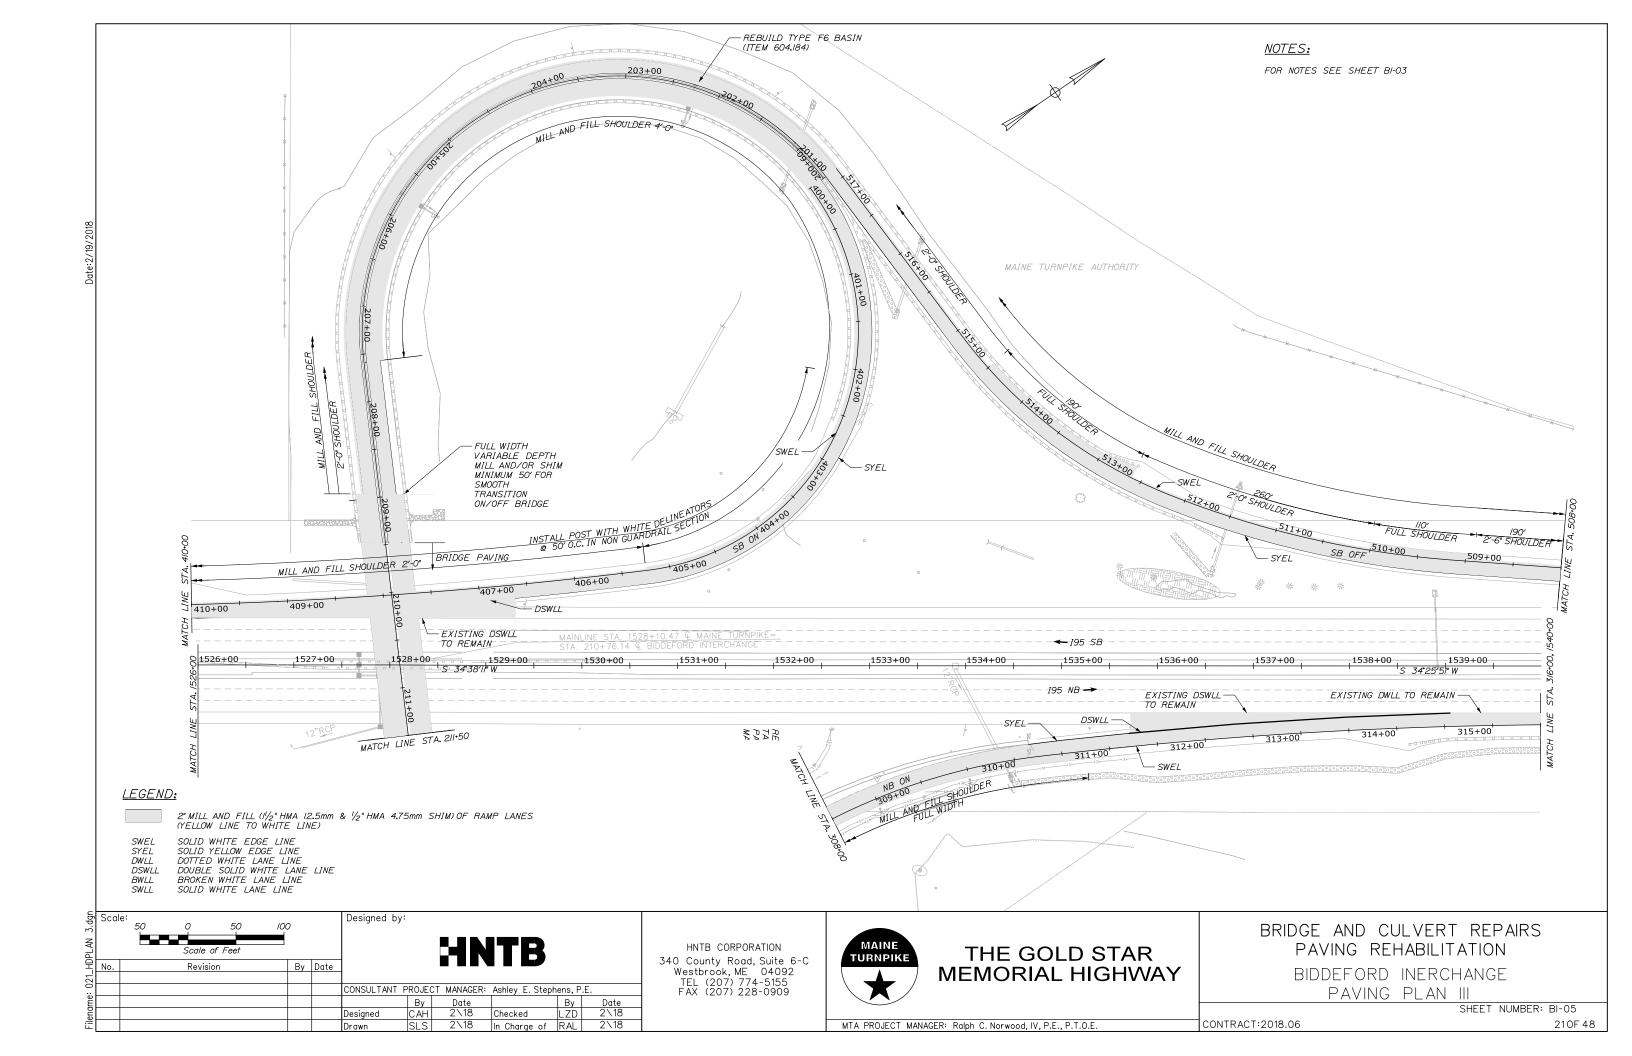

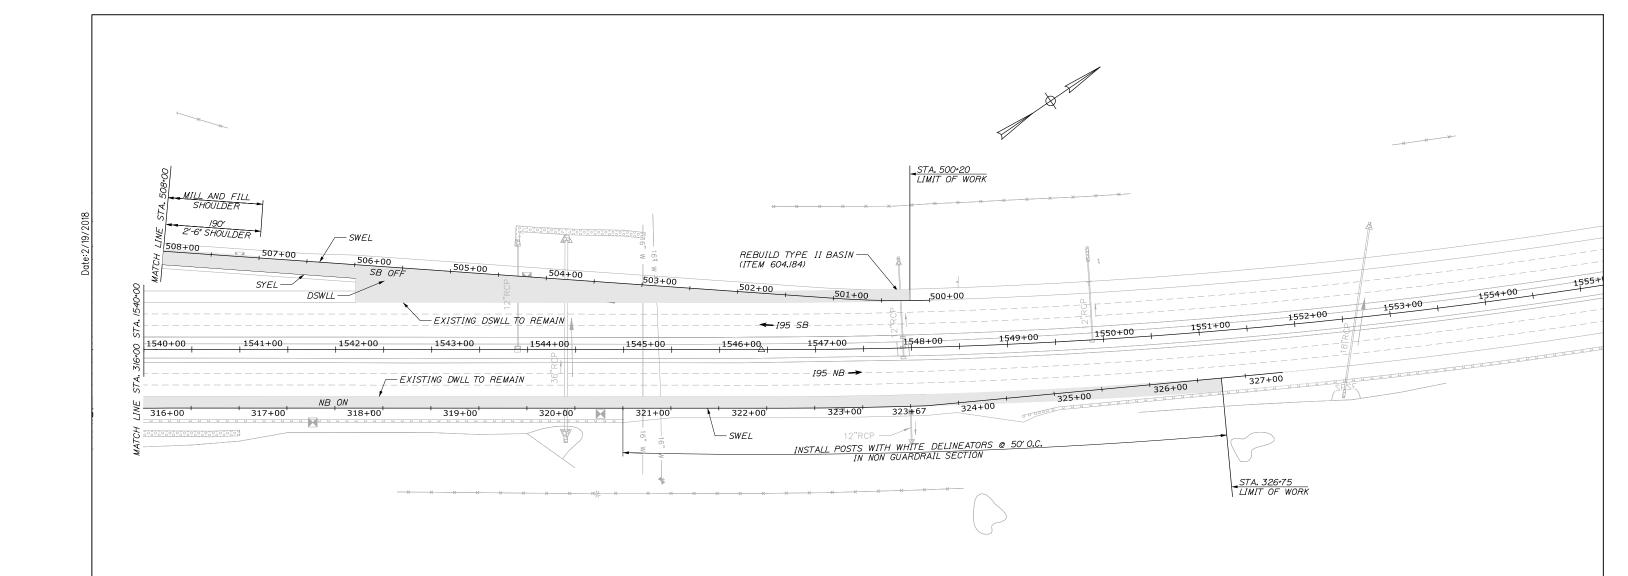

LEGEND:

2" MILL AND FILL (1½" HMA 12.5mm & ½" HMA 4.75mm SHIM)OF RAMP LANES (YELLOW LINE TO WHITE LINE)

SWEL SOLID WHITE EDGE LINE
SYEL SOLID YELLOW EDGE LINE
DWILL DOTTED WHITE LANE LINE
DSWLL DOUBLE SOLID WHITE LANE LINE
BWILL BROKEN WHITE LANE LINE
SWLL SOLID WHITE LANE LINE

NOTES:

FOR NOTES SEE BI-03

5	2cale:	50	0	50	100			Designed by	/·				
L			Scale of	f Feet						HN	ITB		
	No.		Revisio	n		Ву	Date						
								CONSULTANT	PROJEC	T MANAGER:	Ashley E. Stepl	nens, P.	Ε.
									By	Date		Ву	Date
			· ·					Designed	CAH	2\18	Checked	LZD	2\18
								Drawn	SLS	2\18	In Charge of	RAL	2\18

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THE GOLD STAR MEMORIAL HIGHWAY

BRIDGE AND CULVERT REPAIRS
PAVING REHABILITATION
BIDDEFORD INTERCHANGE
PAVING PLAN IV


SHEET NUMBER: BI-06
CONTRACT:2018.06 22 OF 48


CONSTRUCTION SEQUENCE NOTES:


- I. CONTRACTOR SHALL PLACE SHIM TO THE DEPTHS AND CROSS SLOPES NOTED ON CROSS SECTIONS 221+00 and 221+50.
- 2. AREA SHALL THEN BE MILLED 2", SHIMMED 1/2", AND FILLED 1/2" CONSISTENT WITH THE FULL INTERCHANGE.
- 3. FOR MAINTENANCE OF TRAFFIC DURING CULVERT INSTALLATION SEE SPECIAL PROVISION 652.


DRAINAGE NOTE:

CONTRACTOR SHALL FIELD VERIFY EXIST. PIPE SLOPE AND INVERTS. PROPOSED INVERTS SHALL BE DETERMINED AND APPROVED BY THE RESIDENT. THERE SHALL BE A 3" DROP BETWEEN INVERT IN AND INVERT OUT AT CATCH BASIN. ADD RIPRAP OUTLE PROTECTION.

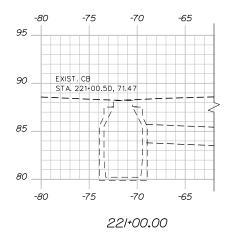

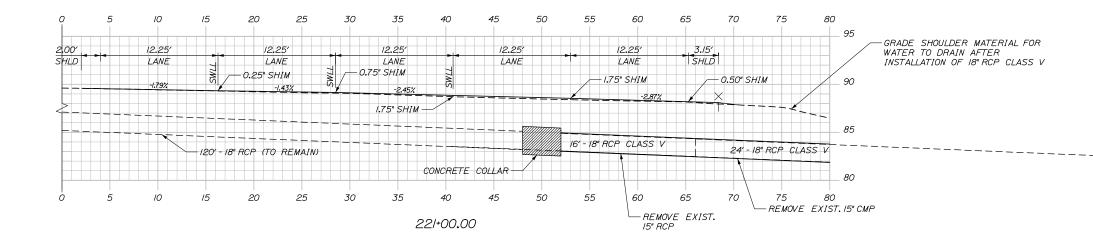

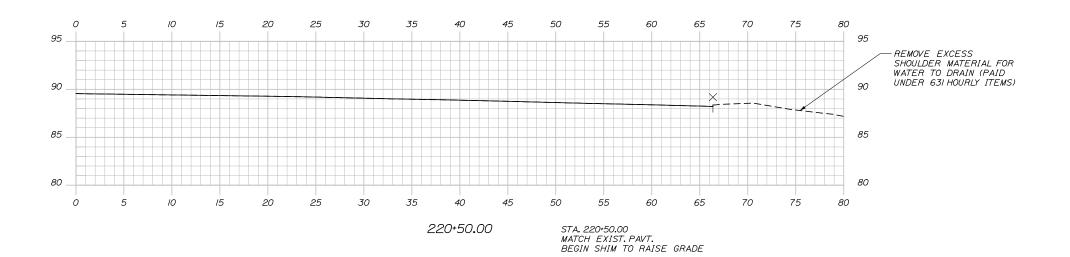

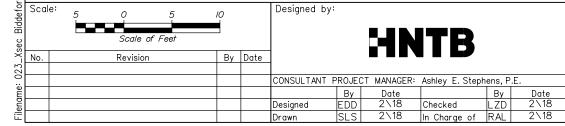

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THE GOLD STAR MEMORIAL HIGHWAY

PAVING REHABILITATION
BIDDEFORD INTERCHANGE CROSS SECTIONS


BRIDGE AND CULVERT REPAIRS


DEFORD INTERCHANGE CROSS SECTIONS STA. 220+50 TO STA. 221+00


SHEET NUMBER: BI-07
CONTRACT:2018.06 23 OF 48

-Xsec Biddeford Paving1.dgn



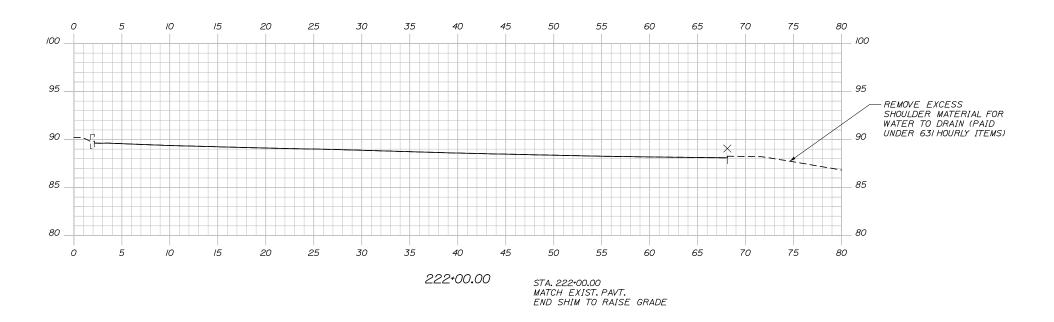

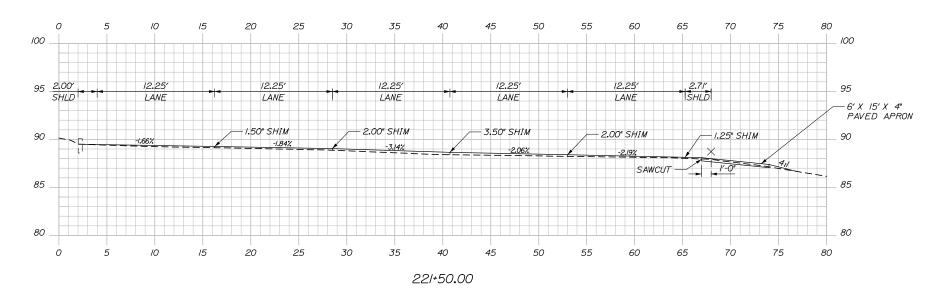

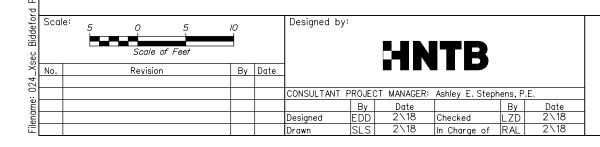

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THE GOLD STAR MEMORIAL HIGHWAY

STAR
IGHWAY
BIDDEFORD INTERCHANGE CROSS SECTIONS
STA. 221+50 TO STA. 222+00

A. 221+50 | O | S | A. 222+00 | SHEET NUMBER: BI-08

MTA PROJECT MANAGER: Ralph C. Norwood, IV, P.E., P.T.O.E.

SHEET NUMBER: BI-08
CONTRACT:2018.06 24 OF 48

BRIDGE AND CULVERT REPAIRS

SCHEDULE OF EXIT 32 GUARDRAIL WORK

	LOC	CATION OF WOR		1		GUARDRAIL STRUCTURE	ITEM 606,1723	ITEM 606,178	TTEN 606 078	ITEM 606.3621	ITEM 606.3622	ITEM 606,369	ITEM 606,471	ITEM 606.48	DESCRIPTION
MILE MARKER	LOCATION DESCRIPTION	APPROX. STATION	STING APPROX. STATION OF TERMINAL END OR ENDPOST	STATION	STATION TRAILING END		BRIDGE TRANSITION TYPE III	GUARDRAIL BEAM	ITEM 606.278 TERMINAL END - ANCHORED END		GUARDRAIL ADJUST, DOUBLE RAIL	GUARDRAIL -	SINGLE OFFSET BLOCK -W BEAM	SINGLE GALVANIZED STEEL POST	OF WORK
NB Off Ramp	Right Shoulder	1511+96.50	1512+34.00	<i>1511+96.50</i>	1512+34.00	FLEAT 350		12.5		0.0					See Installation Notes I and 2.
NB Off Ramp	Right Shoulder	1512+34.00	218+87.50	1512+34.00	218+87.50	Type 3D Single Rail		102.5		2050.0			17	17	See Installation Notes I and 2.
NB Off Ramp	Right Shoulder	218+87.50	219+00	218+87.50	219+00	Terminal End -Trailing End		0.0		0.0					See Installation Notes I and 2.
NB Off Ramp	Right Shoulder	219+25	219+50	2/9+25	2/9+50	Type 3D Single Rail		12.5		0.0			/	/	See Installation Note I.
NB On Ramp	Right Shoulder	1538+62.50	1539+00	1538+62.50	/539+00	FLEAT 350		12.5		0.0					See Installation Notes I and 2.
NB On Ramp	Right Shoulder	1539+00	1544+87 . 50	1539+00	1544+87.50	Type 3D Single Rail		37.5		<i>587.</i> 5			5	5	See Installation Note I.
NB On Ramp	Right Shoulder	<i>1544+87.50</i>	<i>1545+00</i>	1544+87.50	1545+00	Terminal End -Trailing End		0.0		0.0					See Installation Notes I and 2.
NB On Ramp	Right Shoulder	1549+12.50	<i>1549+50</i>	1549+12.50	1549+50	FLEAT 350		12.5		0.0					See Installation Notes I and 2.
NB On Ramp	Right Shoulder	<i>1549+50</i>	<i>1559+40.99</i>	1549+50	1559+40.99	Type 3D Single Rail		50.0		1,000.0			8	8	See Installation Note I.
NB On Ramp	Right Shoulder	<i>1559+40.99</i>	1559+53 . 49	1559+40.99	1559+53.49	Terminal End -Trailing End		0.0		0.0					See Installation Notes I and 2.
SB Off Ramp	Left Shoulder	5//+49.72	5//+87.22	511+49.72	5//+87.22	FLEAT 350		12.5		0.0					See Installation Notes I and 2.
SB Off Ramp	Left Shoulder	511+87.22	5/6+64.30	511+87.22	5/6+64.30	Type 3D Single Rail		25.0		<i>487.</i> 5			4	4	See Installation Note I.
SB Off/ SB On Ramp	Left Shoulder	5/6+64.30	209+22.64	5/6+64.30	209+22.64	Type 3D Double Rail		100.0		0.0	912.5		14	7	See Installation Note I.
B Off/ SB On Ramp	Left Shoulder	209+22.64	209+47.64	209+22.64	209+47.64	Type A Attachment Double Rail	2.0	0.0		0.0		37.5			See Installation Note I.
B Off/ SB On Ramp	Left Shoulder	212+04.64	212+29,64	2/2+04.64	212+29.64	Type A Attachment Double Rail	2.0	0.0		0.0		37.5			See Installation Note I.
SB Off/ SB On Ramp	Left Shoulder	212+29.64	218+20,44	212+29.64	218+20.44	Type 3D Double Rail		62.5		0.0	612.5		10	5	See Installation Note I.
SB Off/ SB On Ramp	Left Shoulder	218+20.44	218+41,10	218+20.44	218+41.10	Bridge Transition Type III		0.0		0.0					See Installation Note I.
SB Off Ramp	Right Shoulder	5/2+60,22	512+97.72	5/2+60.22	5/2+97.72	FLEAT 350		12.5		0.0					See Installation Notes I and 2.
SB Off Ramp	Right Shoulder	512+97.72	209+09,58	512+97.72	209+09.58	Type 3D Single Rail		62.5		1325.0			10	10	See Installation Note I.
SB Off Ramp	Right Shoulder	209+09.58	209+34.58	209+09,58	209+34.58	Type A Attachment Single Rail	1.0	0.0		0.0		18.8			See Installation Note I.
SB Off Ramp	Right Shoulder	212+11.71	2/2+36.70	212+11.71	2/2+36.70	Type A Attachment Single Rail	1.0	0.0		0.0		18.8			See Installation Note I.
SB Off Ramp	Right Shoulder	2/2+36.70	2/3+36.70	2/2+36.70	2/3+36.70	Type 3D Single Rail		12.5		100.0			1	1	See Installation Note I.
SB Off Ramp	Right Shoulder	2/3+36.70	213+50.00	2/3+36,70	2/3+50.00	Terminal End -Trailing End		0.0	1.0	0.0					See Installation Note I.
SB On Ramp	Riaht Shoulder	402+45.85	402+58.77	402+45.85	402+58.77	Terminal End - Trailing End		0.0		0.0					See Installation Note I.
SB On Ramp	Left / Right Shoulder	402+45,85	209+12.58	402+45.85	209+12.58	Type 3D Single Rail		50.0		1025.0			9	9	See Installation Note I.
SB On Ramp	Left Shoulder	209+12.58	209+37.58	209+12,58	209+37,58	Type A Attachment Single Rail	1.0	0.0		0.0		18.8			See Installation Note I.
SB On Ramp	Left Shoulder	212+17.60	212+42.60	212+17.60	212+42.60	Type A Attachment Single Rail	1.0	0.0		0.0		18.8			See Installation Note I.
SB On Ramp	Left Shoulder	2/2+42.60	2/3+06.87	212+42.60	2/3+06.87	Type 3D Single Rail		12.5		87.5			1	,	See Installation Note I.
SB On Ramp	Left Shoulder	2/3+06.87	213+44.37	2/3+06.87	2/3+44.37	FLEAT 350		12.5		0.0					See Installation Note I.
SB On Ramp	Left Shoulder	400+25.00	402+41.18	400+25,00	402+41,18	Type 3D Single Rail		12.5		2/2.5			2	2	See Installation Note I.
SB On Ramp	Left Shoulder	402+41.18	402+53.68	402+41,18	402+53.68	Terminal End - Trailing End		0.0		0.0				_	See Installation Note I.
SB On Ramp	Left Shoulder	1520+50	1520+62,50	1520+50	1520+62.50	Terminal End - Trailing End		0.0		0.0					See Installation Note I.
SB On Ramp	Left Shoulder	1520+62,50	1525+50	1520+62.50	1525+50	Type 3D Single Rail		25.0		487.5			4	4	See Installation Note I.
SB On Ramp	Left Shoulder	1525+50	1525+87.5	1525+50	1525+87.5	FLEAT 350		12.5		0.0			,	,	See Installation Note I.
	22 200.00.	, ,		,		TOTALS	8.0	652.5	1.0	7362.5	1525.0	150.0	86.0	74.0	TTT THE STATE OF T

GENERAL NOTES:

I. APPROXIMATE STATION IS THE LEADING END OR TRAILING END OF THE EXISTING GUARDRAIL ASSEMBLY.

2. REPAIR DAMAGED GUARDRAIL BEAMS AS INDICATED OR AS DIRECTED BY THE RESIDENT ENGINEER.

- 3. REPLACE ALL RIGID GUARDRAIL DELINEATOR POSTS WITH FLEXIBLE DELINEATORS AS PER SECTION 606 GUARDRAIL DELINEATOR POST.
- 4. INDICATED INSTALLATION LOCATION OF FLEAT UNITS REFERS TO LOCATION OF THE FLEAT CRASH HEAD.

INSTALLATION NOTES:

I. ADJUST GUARDRAIL TO 30-INCH ABOVE EDGE OF PAVEMENT.TAPER GUARDRAIL UP TO 30-INCH HEIGHT FROM CRASH ENDS OVER 25-FOOT LENGTH.

2. REMOVE EXISTING END SECTION AND STACK; INSTALL ANCHORED TRAILING END.

Schedu	Scal	e:			Designed by:					
Guardrail Sche							HN	ITR		
-1 L	No.	Revision	Ву	Date						
025										
I					CONSULTANT F	PROJEC	CT MANAGER:	Ashley E. Steph	ens, P.	E.
ilename						Ву	Date		Ву	Date
띪					Designed	CAH	2\18	Checked	LZD	2\18
ĚΓ					Drawn	SLS	2\18	In Charge of	RAL	2\18

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THE GOLD STAR **MEMORIAL HIGHWAY**


BRIDGE AND CULVERT REPAIRS PAVING REHABILITATION BIDDEFORD INTERCHANGE GUARDRAIL SCHEDULE

SHEET NUMBER: BI-09

MTA PROJECT MANAGER: Ralph C. Norwood, IV, P.E., P.T.O.E.

BERM DROPOFF CORRECTION WITH GUARDRAIL


MEDIAN GUARDRAIL N.T.S.

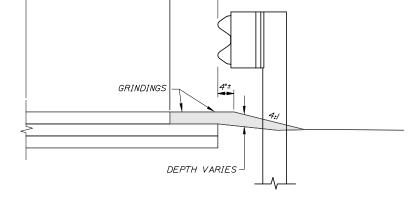



VARIES

BERM DROPOFF CORRECTION WITH GUARDRAIL RIGHT OUTSIDE SHOULDER

EXISTING SHOULDER

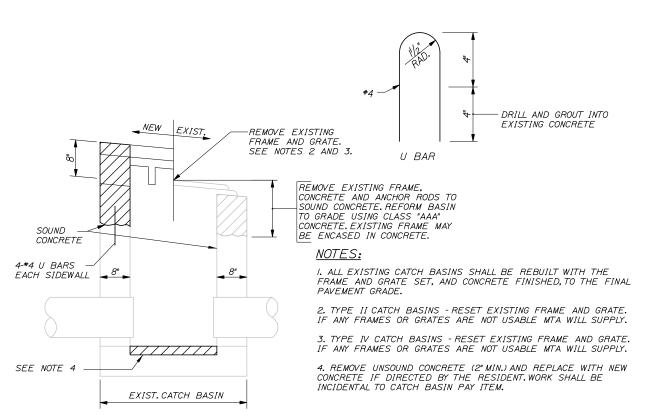

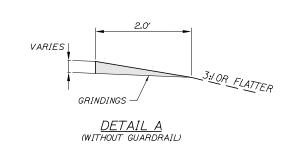

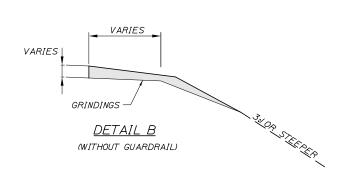

REBUILD CATCH BASIN TO GRADE - TYPE II, IV, AND BI

(TYPE II BASINS INCLUDE F-STYLE BASINS)

Scal	e:			Designed by	:				
No						HN	ITB		
No.	Revision	Ву	Date]					
				CONSULTANT	PROJEC	T MANAGER:	Ashley E. Steph	nens, P.E	
					Ву	Date		Ву	Date
				Designed	CAH	2\18	Checked	LZD	2\18
				Drawn	SLS	2\18	In Charge of	RAL	2\18

HNTB CORPORATION 340 County Road, Suite 6-C Westbrook, ME 04092 TEL (207) 774-5155 FAX (207) 228-0909



THE GOLD STAR **MEMORIAL HIGHWAY**

BRIDGE AND CULVERT REPAIRS PAVING REHABILITATION BIDDEFORD INTERCHANGE BERM DETAILS

SHEET NUMBER: BI-10 CONTRACT:2018.06

DIMENSIONS FOR SLOPE OF 2:1

							STONE	STONE
D	a	ь	С	е	f	g	DEPTH	(CY)
	(FT)	(FT)	(FT)	(FT)	(FT)	(FT)	(FT)	' '
12"	1.00	4.00	3.00	2.00	6.00	1.00	1.50	1.30
15"	1.00	4.50	3.37	2.25	6.75	1.63	1.50	1.70
18"	1.00	5.00	3.75	2.50	7.50	2.25	1.50	2.09
21"	1.00	5.50	4.13	2.75	8.25	2.88	1.50	2.58
24"	1.00	6.00	4.50	3.00	9.00	3.50	1.50	3.12
30"	1.00	7.00	5.25	3.50	10.50	4.75	1.50	4.33
36"	1.00	8.00	6.00	4.00	12.00	6.00	1.50	5.75
42"	1.00	9.00	6.75	4.50	13.50	7.25	1.50	7.37
48"	1.00	10.00	7.50	5.00	15.00	8.50	1.50	9.18
54"	1.00	11.00	8.25	5.50	16.50	9.75	1.50	11.19
60"	1.00	12.00	9.00	6.00	18.00	11.00	1.50	13.40
66"	1.00	13.00	9.75	6.50	19.50	12.25	1.50	15.81
72"	1.00	14.00	10.50	7.00	21.00	13.50	1.50	18.41
84"	1.00	16.00	12.00	8.00	24.00	16.00	1.50	24.22

DIMENSIONS FOR SLOPE OF 4:1


							STONE	STONE
D	а	b	С	е	f	g	DEPTH	(CY)
	(FT)	(FT)	(FT)	(FT)	(FT)	(FT)	(FT)	
12"	1.00	8.00	6.00	2.00	6.00	0.00	1.50	2.20
15"	1.00	9.00	6.75	2.25	6.75	0.00	1.50	2.80
18"	1.00	10.00	7.50	2.50	7.50	0.00	1.50	3.40
21"	1.00	11.00	8.25	2.75	8.25	0.00	1.50	4.10
24"	1.00	12.00	9.00	3.00	9.00	0.00	1.50	4.86
30"	1.00	14.00	10.50	3.50	10.50	0.00	1.50	6.58
36"	1.00	16.00	12.00	4.00	12.00	0.00	1.50	8.56
42"	1.00	18.00	13.50	4.50	13.50	0.50	1.50	10.92
48"	1.00	20.00	15.00	5.00	15.00	1.00	1.50	13.57
54"	1.00	22.00	16.50	5.50	16.50	1.50	1.50	16.50
60"	1.00	24.00	18.00	6.00	18.00	2.00	1.50	19.72
66"	1.00	26.00	19.50	6.50	19.50	2.50	1.50	23.22
72"	1.00	28.00	21.00	7.00	21.00	3.00	1.50	27.01
84"	1.00	32.00	24.00	8.00	24.00	4.00	1.50	35.45


DIMENSIONS FOR SLOPE OF 6:1

							STONE	STONE
D	а	b	С	е	f	g	DEPTH	(CY)
	(FT)	(FT)	(FT)	(FT)	(FT)	(FT)	(FT)	
12"	0.50	9.00	7.50	1.50	4.50	0.00	1.50	2.30
15"	0.50	10.50	8.75	1.75	5.50	0.00	1.50	2.93
18"	0.50	12.00	10.00	2.00	6.50	0.00	1.50	3.57
21"	0.50	13.50	11.25	2.25	7.25	0.00	1.50	4.46
24"	0.50	15.00	12.50	2.50	8.00	0.00	1.50	5.44
30"	0.50	18.00	15.00	3.00	9.50	0.00	1.50	7.71
36"	0.50	21.00	17.50	3.50	11.00	0.00	1.50	10.37
42"	0.50	24.00	20.00	4.00	12.50	0.00	1.50	13.42
48"	0.50	27.00	22.50	4.50	14.00	0.00	1.50	16.87
54"	0.50	30.00	25.00	5.00	15.50	0.00	1.50	20.70
60"	0.50	33.00	27.50	5.50	17.00	0.00	1.50	24.93
66"	0.50	36.00	30.00	6.00	18.50	0.00	1.50	29.55
72"	0.50	39.00	32.50	6.50	20.00	0.00	1.50	34.56
84"	0.50	45.00	37.50	7.50	23.00	0.00	1.50	45.76


NOTES:

- I. THE DIMENSIONS SHOWN ARE APPROXIMATE AND ME BE MODIFIED BY THE RESIDENT.
- 2. STONE QUANTITIES ARE FOR ONE END OF THE PIPE

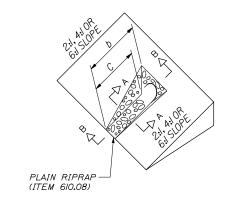


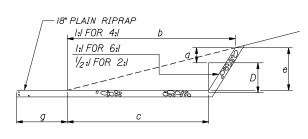


SECTION B-B

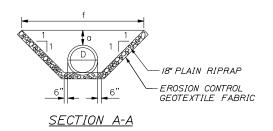

ROADWAY CULVERT END SLOPE TREATMENT

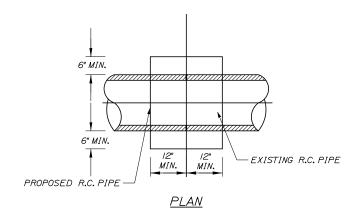

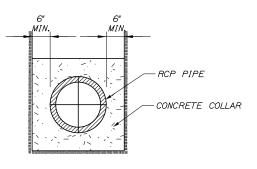

<u>SECTION</u>

CONCRETE COLLAR N.T.S.

CONCRETE COLLAR	WIDTH SCHEDULE					
PIPE DIA. (INCHES)	WIDTH OF CONC. (INCHES)					
12	24					
15	24					
18	24					
24	24					
30	30					
36	36					
42	48					
48	48					

NOTES:

- I. CONNECTION AND PIPE TO BE BACKFILLED PER ASTM D232I(CRUSHED STONE).
- 2. CONCRETE SHALL BE CLASS A FIBER REINFORCED.

CONTRACT:2018.06

3. SEE CONCRETE COLLAR WIDTH SCHEDULE FOR DIMENSIONS.

Scale	e:			Designed by:					
							ITB		
No.	Revision	Ву	Date	1					
				CONSULTANT F	PROJEC	T MANAGER:	Ashley E. Steph	iens, P.E	
					Ву	Date		Ву	Date
				Designed	CAH	2\18	Checked	LZD	2\18
				Drawn	SLS	2\18	In Charge of	RAL	2\18

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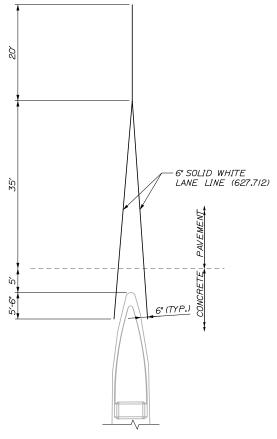
THE GOLD STAR MEMORIAL HIGHWAY BRIDGE AND CULVERT REPAIRS
PAVING REHABILITATION

BIDDEFORD INTERCHANGE
DRAINAGE DETAILS

SHEET NUMBER: BI-11

MTA PROJECT MANAGER: Ralph C. Norwood, IV, P.E., P.T.O.E.


27 OF 48



TOLL PLAZA ISLAND APPROACH AND DEPARTURE STRIPING

NOTES:

- I. THE CONTRACTOR SHALL FURNISH ALL TEMPORARY STRIPING AT BIDDEFORD INTERCHANGE. TEMPORARY STRIPES SHALL NOT BE PAINTED ON THE FINAL PAVEMENT SURFACE.
- 2. THE CONTRACTOR SHALL INSTALL THE PERMANENT RAMP STRIPING THE PERMANENT RAMP STRIPING SHALL BE INSTALLED PER THE TOLERANCES OUTLINED IN THE 627 SPECIFICATIONS.
- 3. THE CONTRACTOR SHALL SURVEY AND TIE THE EXISTING PAVEMENT MARKING LINES ON THE RAMPS AND IN THE PLAZA AREAS AT BIDDEFORD INTERCHANGE PRIOR TO REMOVING, MILLING, OR PAVING OVER THE EXISTING PAVEMENT MARKING LINES AT THE EXIT. THE CONTRACTOR SHALL USE THE SURVEYED INFORMATION TO RE-ESTABLISH THE PAVEMENT MARKING LINES AFTER THE SURFACE PAVING IS COMPLETED. THIS WORK SHALL BE INCIDENTAL TO THE 627 PAY ITEM(S).
- 4. THE CONTRACTOR SHALL STRIPE THE APPROACH AND DEPARTURE AREAS IN FRONT OF THE TOLL ISLANDS AS SHOWN ON THE STRIPING DETAIL ON THIS PAGE.
- 5. THE CONTRACTOR SHALL INSTALL THE WORD AND ARROW PAVEMENT MARKINGS AT THE SIGNALIZED INTERSECTION WITH ALFRED STREET AS SHOWN ON THE STRIPING DETAIL ON THIS PAGE. THE WORD AND ARROW PAVEMENT MARKINGS SHALL BE PAID BY THE SQUARE FOOT BASED ON THE AREAS NOTED ON PAGE 627(02) OF THE MAINEDOT STANDARD DETAILS.

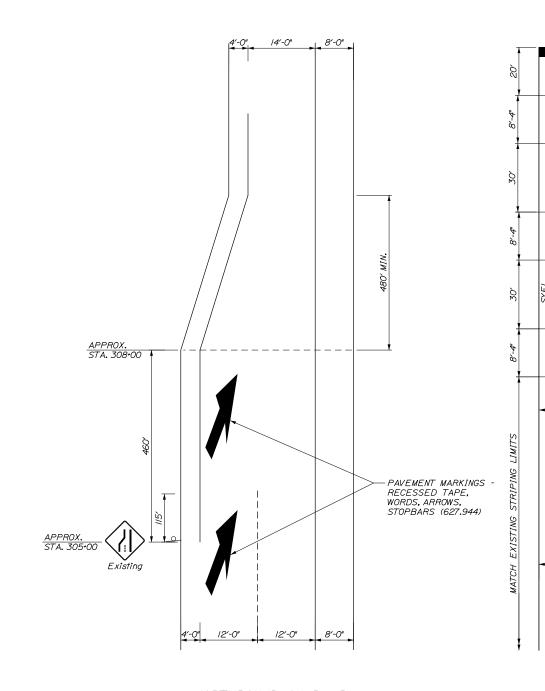

NORTHBOUND ON RAMP LANE REDUCTION DETAIL INTERSECTION STRIPING

CONTRACT:2018.06

12'-3"

12'-3"

12'-3"

12'-3"

12'-3"

STOP LINE

Scale: Designed by: By Date Revision CONSULTANT PROJECT MANAGER: Ashley E. Stephens, P.E Ву Checked LZD
In Charge of RAL Designed 2\18

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THE GOLD STAR **MEMORIAL HIGHWAY**


BRIDGE AND CULVERT REPAIRS PAVING REHABILITATION BIDDEFORD INTERCHANGE PAVEMENT MARKING DETAILS

SHEET NUMBER: BI-12

PAVEMENT MARKINGS -RECESSED TAPE, WORDS, ARROWS, STOPBARS

- PAVEMENT MARKING LINE -RECESSED TAPE, SOLID WHITE OR YELLOW LANE LINE, 6 - INCH WIDTH (627.943)

(627.944)

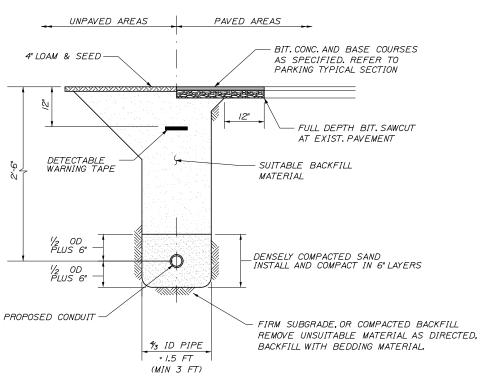

STANDARD PIPE/CONDUIT TRENCH DETAIL N.T.S.

STANDARD PIPE/CONDUIT TRENCH NOTES:

- I. BEDDING SHALL BE COMPACTED TO A MINIMUM 95% STANDARD PROCTOR DENSITY. USE HAND TAMPERS OR VIBRATORY COMPACTORS.
- 2. FILTER FABRIC SHALL BE INSTALLED AGAINST THE TRENCH WALLS IN THE HAUNCHING AND BEDDING ZONES WHEN FINE SANDS, SILT, CLAY, OR ORGANIC MATERIALS ARE ENCOUNTERED AT THE TRENCH BOTTOM.
- 3. CONTRACTOR SHALL SHORE TRENCH SIDES WHEN REQUIRED OR AS DIRECTED BY THE RESIDENT.
- 4. PAYMENT FOR CONDUIT, ALL LABOR, EQUIPMENT AND MATERIALS INCLUDING EXCAVATION, BEDDING, PAYEMENT, AND BACKFILL SHALL BE PAID FOR UNDER ITEM 626.22, NON-METALLIC CONDUIT OR 655.204, 3° SCHEDULE 80 PVC CONDUIT.

ţaj	Scal	e:			Designed by:	:				
.Conduit De		NOT TO SCALE					HN	ITR		
029_Cc	No.	Revision	Ву	Date						
					CONSULTANT I	PROJEC	CT MANAGER:	Ashley E. Steph	nens, P	E.
me						Ву	Date		Ву	Date
ilename					Designed	PEM	2\18	Checked	DAM	2\18
Ē					Drawn	SLS	2\18	In Charge of	RAL	2\18

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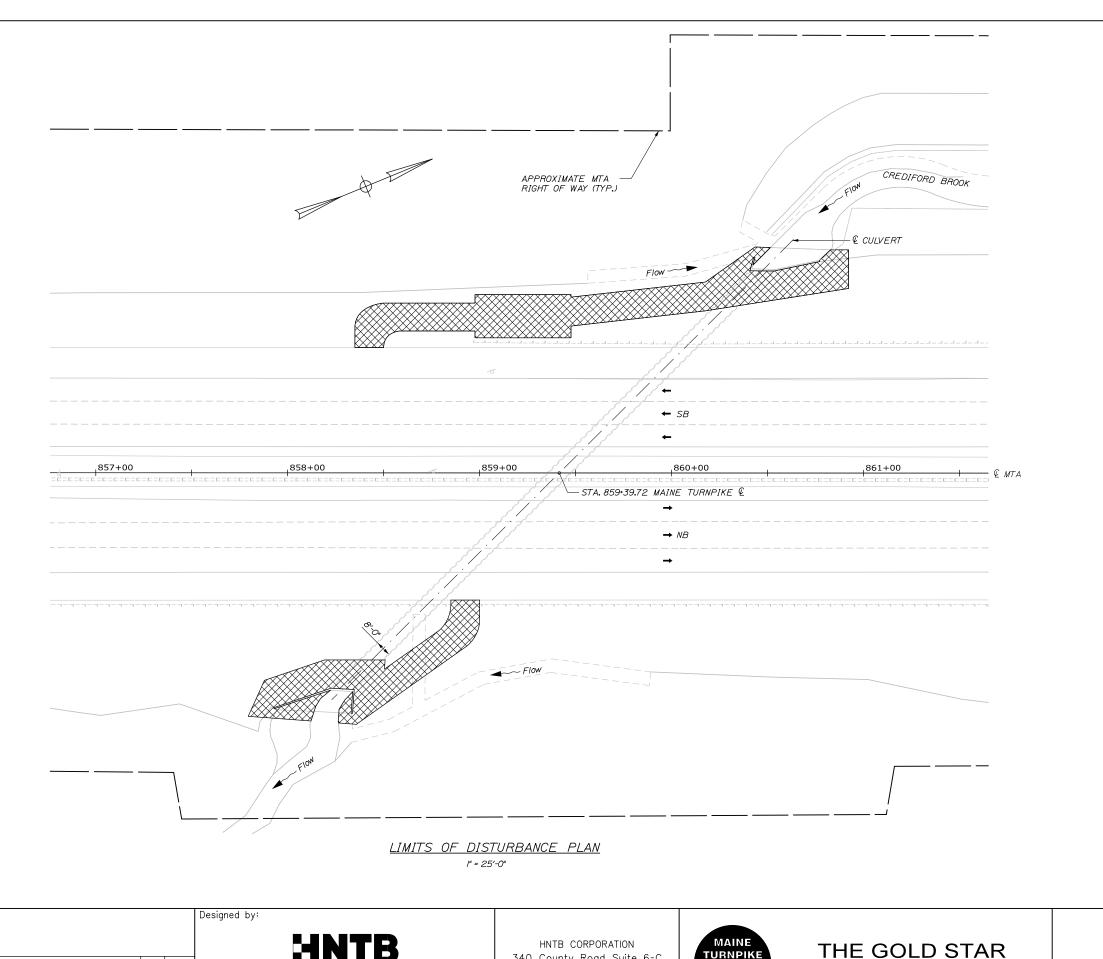
THE GOLD STAR MEMORIAL HIGHWAY

BRIDGE AND CULVERT REPAIRS
PAVING REHABILITATION

CONDUIT DETAILS

CONTRACT:2018.06

SHEET NUMBER: CD-01



340 County Road, Suite 6-C Westbrook, ME 04092 TEL (207) 774-5155 FAX (207) 228-0909

彲 Scale:

Revision

By Date

Designed

CONSULTANT PROJECT MANAGER: Ashley E. Stephens, P.E.

2\18

Ву

Checked AES
In Charge of RAL

<u>LEGEND</u>



CONTRACTOR'S LIMIT OF DISTURBANCE AREA FOR ACCESS AND STORAGE: 0.31 ACRES

- I. ALL EROSION AND SEDIMENTATION CONTROL SHALL BE INCIDENTAL TO THE RELATED CONTRACT ITEMS.
- 2. SEE SPECIFICATIONS FOR CONTRACTOR'S SUBMITTAL REQUIREMENTS IF ADDING ADDITIONAL LIMITS OF DISTURBANCE TO THE PROJECT ESTIMATED QUANTITIES.
- 3. TOTAL CONTRACT LIMIT OF DISTURBANCE FOR THIS LOCATION HAS BEEN ESTIMATED TO BE 0.31 ACRES.
- 4. FOR CULVERT REPAIRS SEE SHEETS S-02 TO S-05.
- 5. FOR IN-WATER WORK WINDOW AND ALLOWANCES, REFER TO SPECIAL PROVISION 107.4.7, LIMITATIONS OF OPERATIONS.

BRIDGE AND CULVERT REPAIRS


CREDIFORD BROOK LIMITS OF DISTURBANCE


SHEET NUMBER: S-01


TURNPIKE


MTA PROJECT MANAGER: Ralph C. Norwood, IV, P.E., P.T.O.E


MEMORIAL HIGHWAY

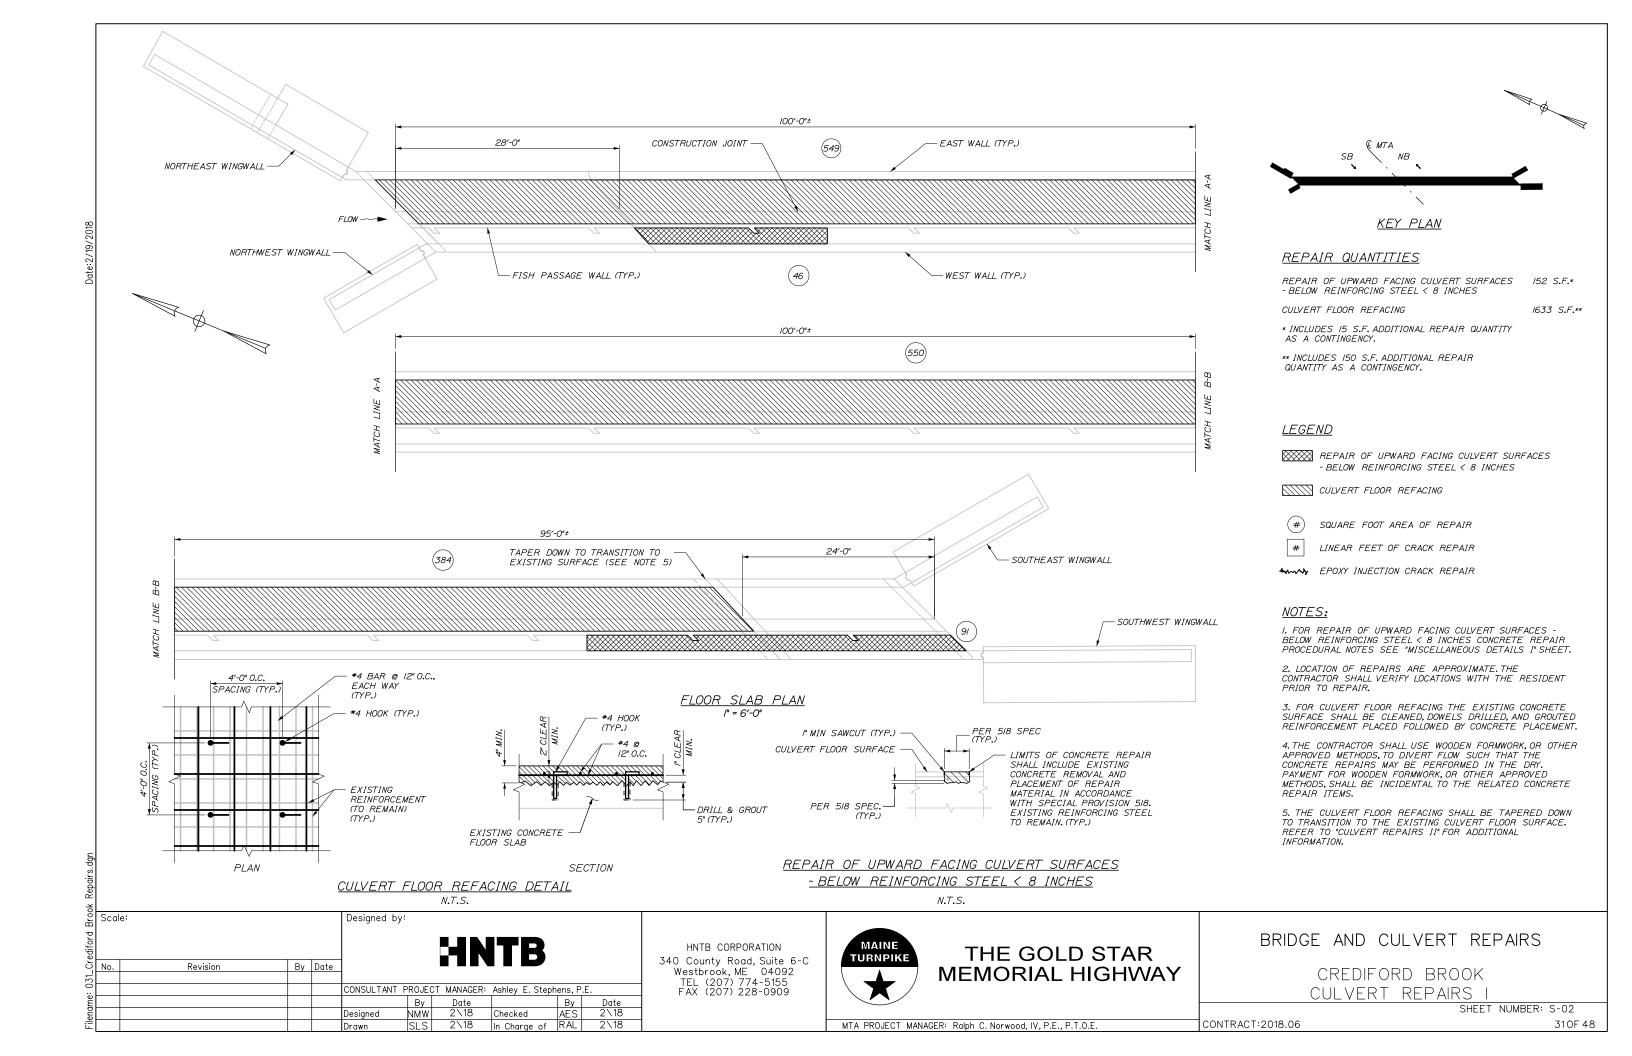

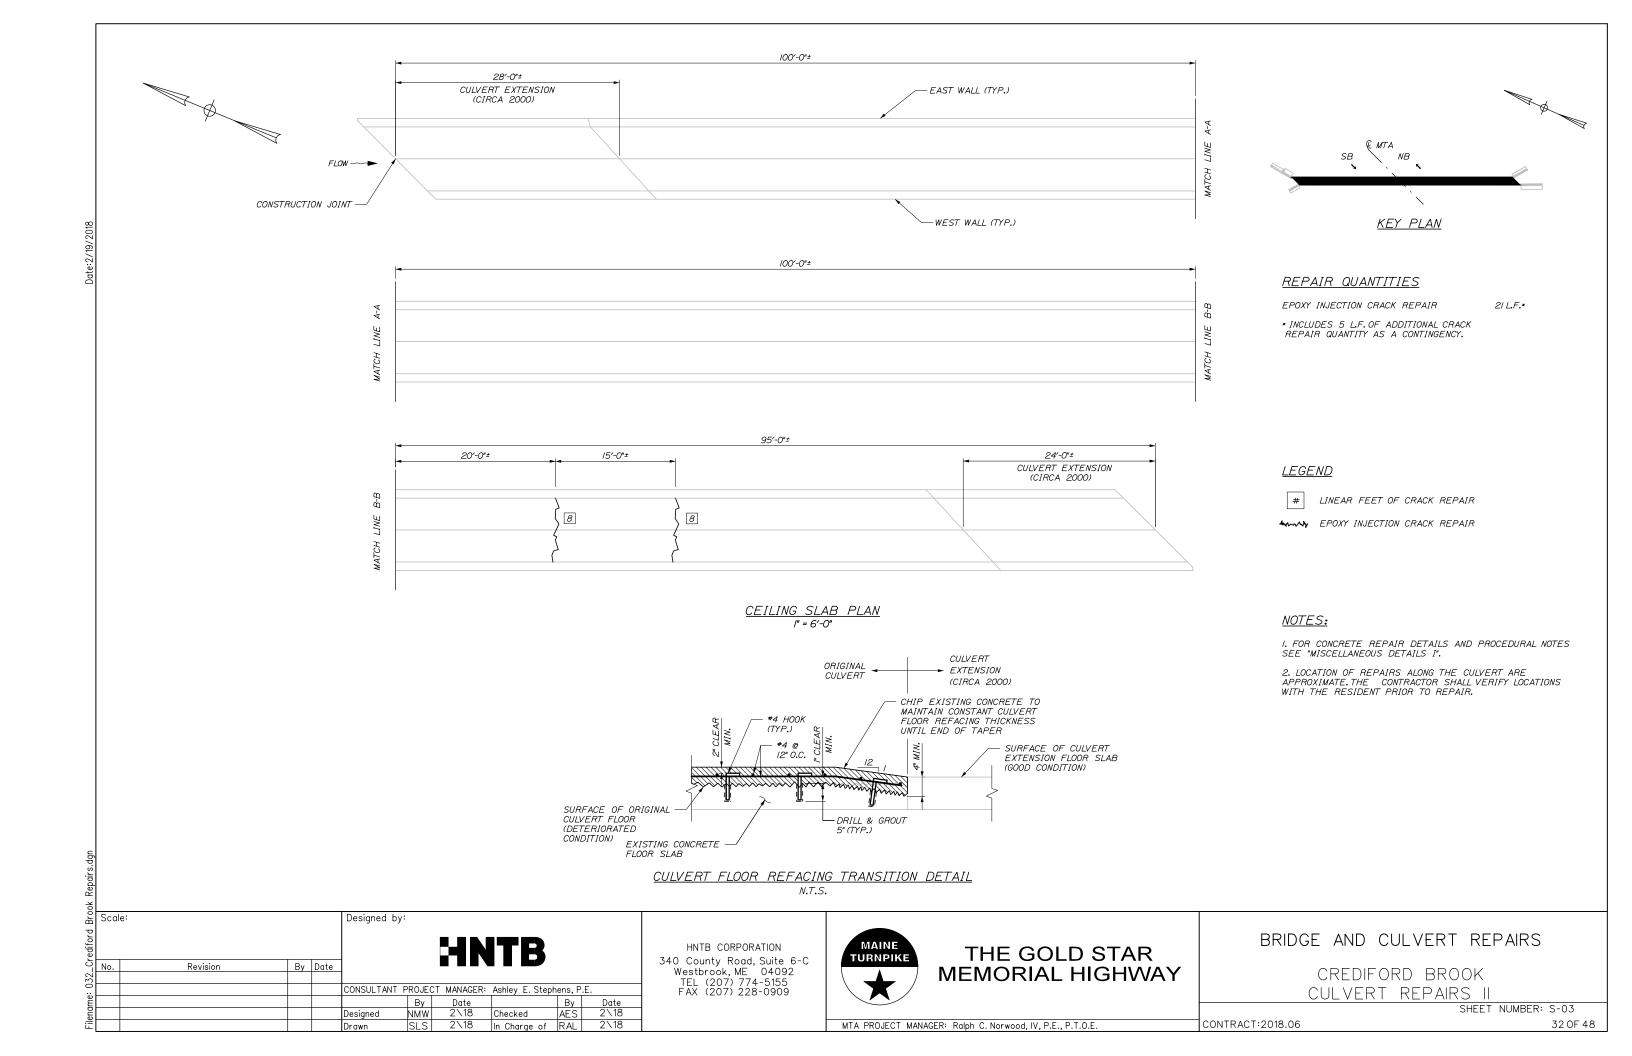

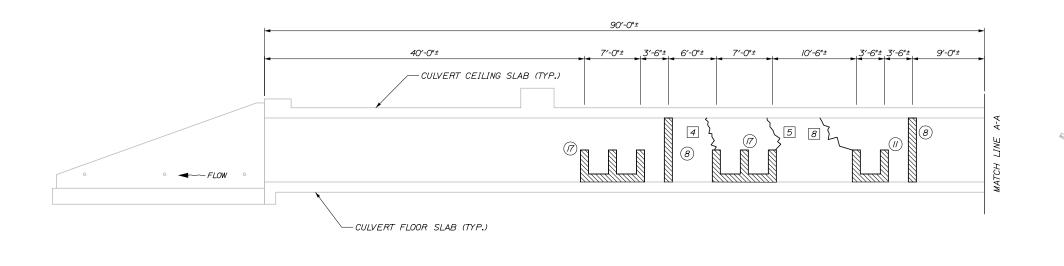

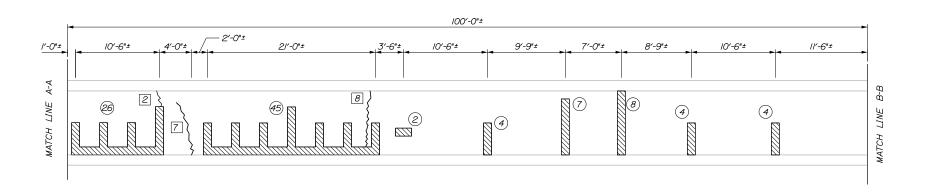

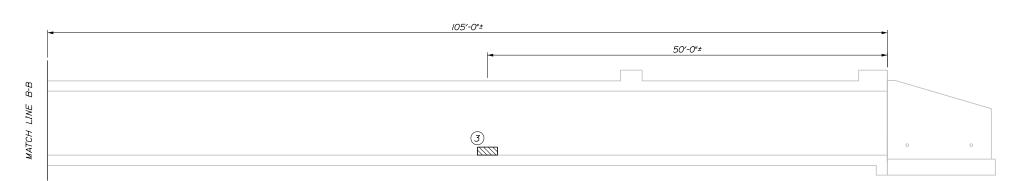

WEST WALL ELEVATION (LOOKING WEST)

REPAIR QUANTITIES

€ MTA

SB

REPAIR OF VERTICAL SURFACES < 8 INCHES

174 S.F.*

EPOXY INJECTION CRACK REPAIR

39 L.F.**

* INCLUDES 10 S.F. ADDITIONAL REPAIR QUANTITY AS A CONTINGENCY.

** INCLUDES 5 L.F. OF ADDITIONAL CRACK REPAIR QUANTITY AS A CONTINGENCY.

LEGEND

REPAIR OF VERTICAL SURFACES < 8 INCHES

KEY PLAN

SQUARE FOOT AREA OF REPAIR

LINEAR FEET OF CRACK REPAIR

LEPOXY INJECTION CRACK REPAIR

NOTES:

I. FOR CONCRETE REPAIR DETAILS AND PROCEDURAL NOTES SEE "MISCELLANEOUS DETAILS I AND II".

2. LOCATION OF REPAIRS ALONG THE CULVERT ARE APPROXIMATE. THE CONTRACTOR SHALL VERIFY LOCATIONS WITH THE RESIDENT PRIOR TO REPAIR.

3. THE CONTRACTOR SHALL USE WOODEN FORMWORK, OR OTHER APPROVED METHODS, TO DIVERT FLOW SO THAT THE CONCRETE REPAIRS MAY BE PERFORMED IN THE DRY IS ACCEPTABLE. PAYMENT FOR WOODEN FORMWORK, OR OTHER APPROVED METHODS, SHALL BE INCIDENTAL TO THE RELATED CONCRETE REPAIR ITEMS.

/" = 6'-0"

뚦 Scale: Designed by: By Date Revision CONSULTANT PROJECT MANAGER: Ashley E. Stephens, P.E. Ву Checked AES
In Charge of RAL Designed 2\18

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THE GOLD STAR **MEMORIAL HIGHWAY**


CREDIFORD BROOK


BRIDGE AND CULVERT REPAIRS

CULVERT REPAIRS III

SHEET NUMBER: S-04

MTA PROJECT MANAGER: Ralph C. Norwood, IV, P.E., P.T.O.E.

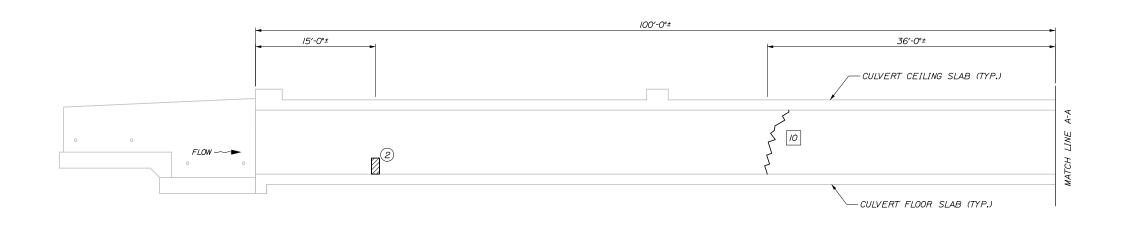

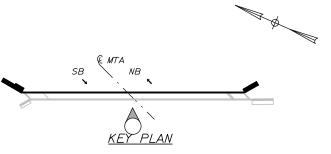

REPAIR QUANTITIES

REPAIR OF VERTICAL SURFACES < 8 INCHES

67 S.F.*

EPOXY INJECTION CRACK REPAIR

57 L.F.**

* INCLUDES 10 S.F. ADDITIONAL REPAIR QUANTITY AS A CONTINGENCY.

** INCLUDES 5 L.F. OF ADDITIONAL CRACK REPAIR QUANTITY AS A CONTINGENCY.

LEGEND

REPAIR OF VERTICAL SURFACES < 8 INCHES

SQUARE FOOT AREA OF REPAIR

LINEAR FEET OF CRACK REPAIR


**** EPOXY INJECTION CRACK REPAIR


NOTES:

I. FOR CONCRETE REPAIR DETAILS AND PROCEDURAL NOTES SEE "MISCELLANEOUS DETAILS I AND II".

2. LOCATION OF REPAIRS ALONG THE CULVERT ARE APPROXIMATE. THE CONTRACTOR SHALL VERIFY LOCATIONS WITH THE RESIDENT PRIOR TO REPAIR.

3. THE CONTRACTOR SHALL USE WOODEN FORMWORK, OR OTHER APPROVED METHODS, TO DIVERT FLOW SO THAT THE CONCRETE REPAIRS MAY BE PERFORMED IN THE DRY IS ACCEPTABLE. PAYMENT FOR WOODEN FORMWORK, OR OTHER APPROVED METHODS, SHALL BE INCIDENTAL TO THE RELATED CONCRETE REPAIR ITEMS.

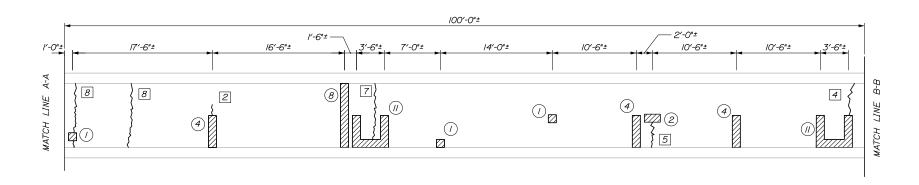

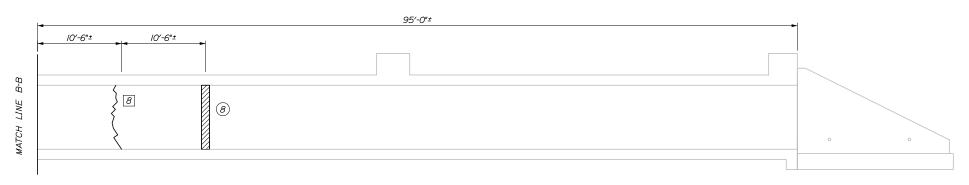

EAST WALL ELEVATION (LOOKING EAST) /" = 6'-0"

彲 Scale: Designed by: By Date Revision CONSULTANT PROJECT MANAGER: Ashley E. Stephens, P.E. Ву Checked AES In Charge of RAL Designed 2\18

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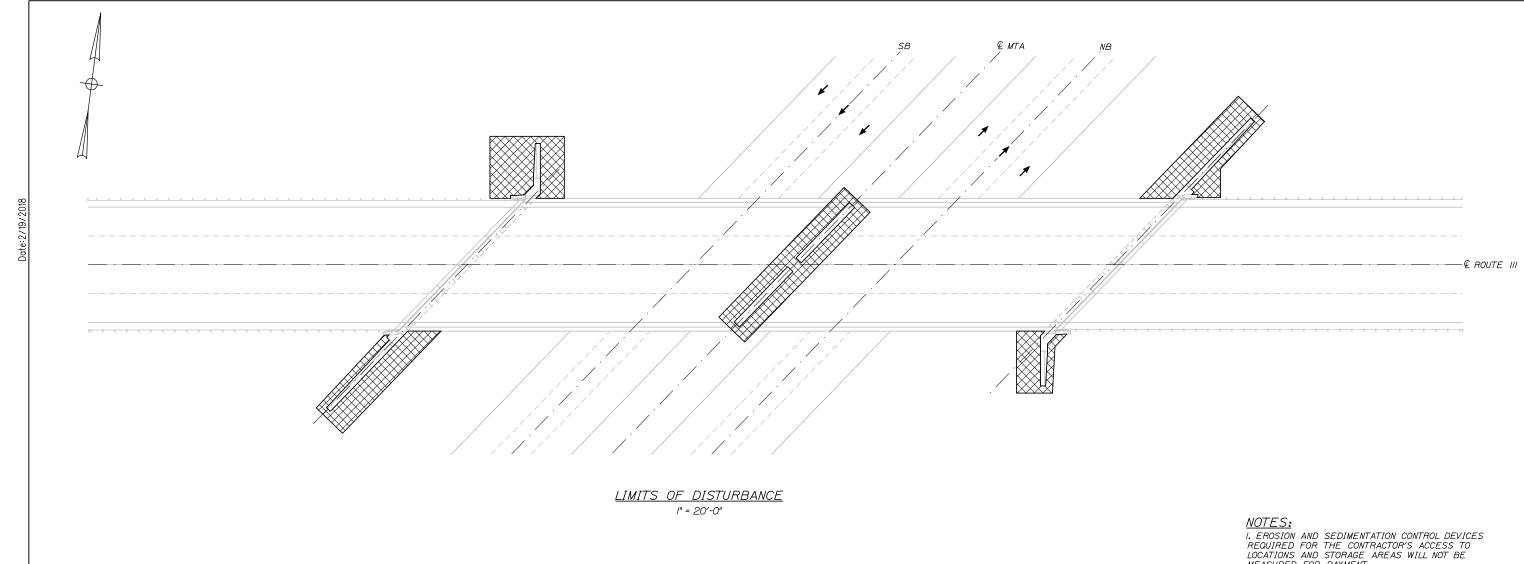
THE GOLD STAR **MEMORIAL HIGHWAY**

CREDIFORD BROOK CULVERT REPAIRS IV

BRIDGE AND CULVERT REPAIRS

SHEET NUMBER: S-05

CONTRACT:2018.06



- MEASURED FOR PAYMENT.
- 2. SEE SPECIFICATIONS FOR CONTRACTOR'S SUBMITTAL REQUIREMENTS IF ADDING ADDITIONAL LIMITS OF DISTURBANCE TO THE PROJECT ESTIMATED QUANTITIES.
- 3. AN ADDITIONAL 0.05 ACRES HAS BEEN ESTIMATED FOR CONTRACTOR ACCESS LOCATIONS AND STORAGE AREAS.
- 4. TOTAL CONTRACT LIMIT OF DISTURBANCE FOR THIS LOCATION HAS BEEN ESTIMATED TO BE 0.13 ACRES.

<u>LEGEND</u>



CONTRACT:2018.06

CONTRACTOR'S LIMIT OF DISTURBANCE AREA FOR ACCESS AND STORAGE:

Scale: Designed by: By Date Revision CONSULTANT PROJECT MANAGER: Ashley E. Stephens, P.E. Ву 2\18 Checked AES 2\18 In Charge of RAL Designed

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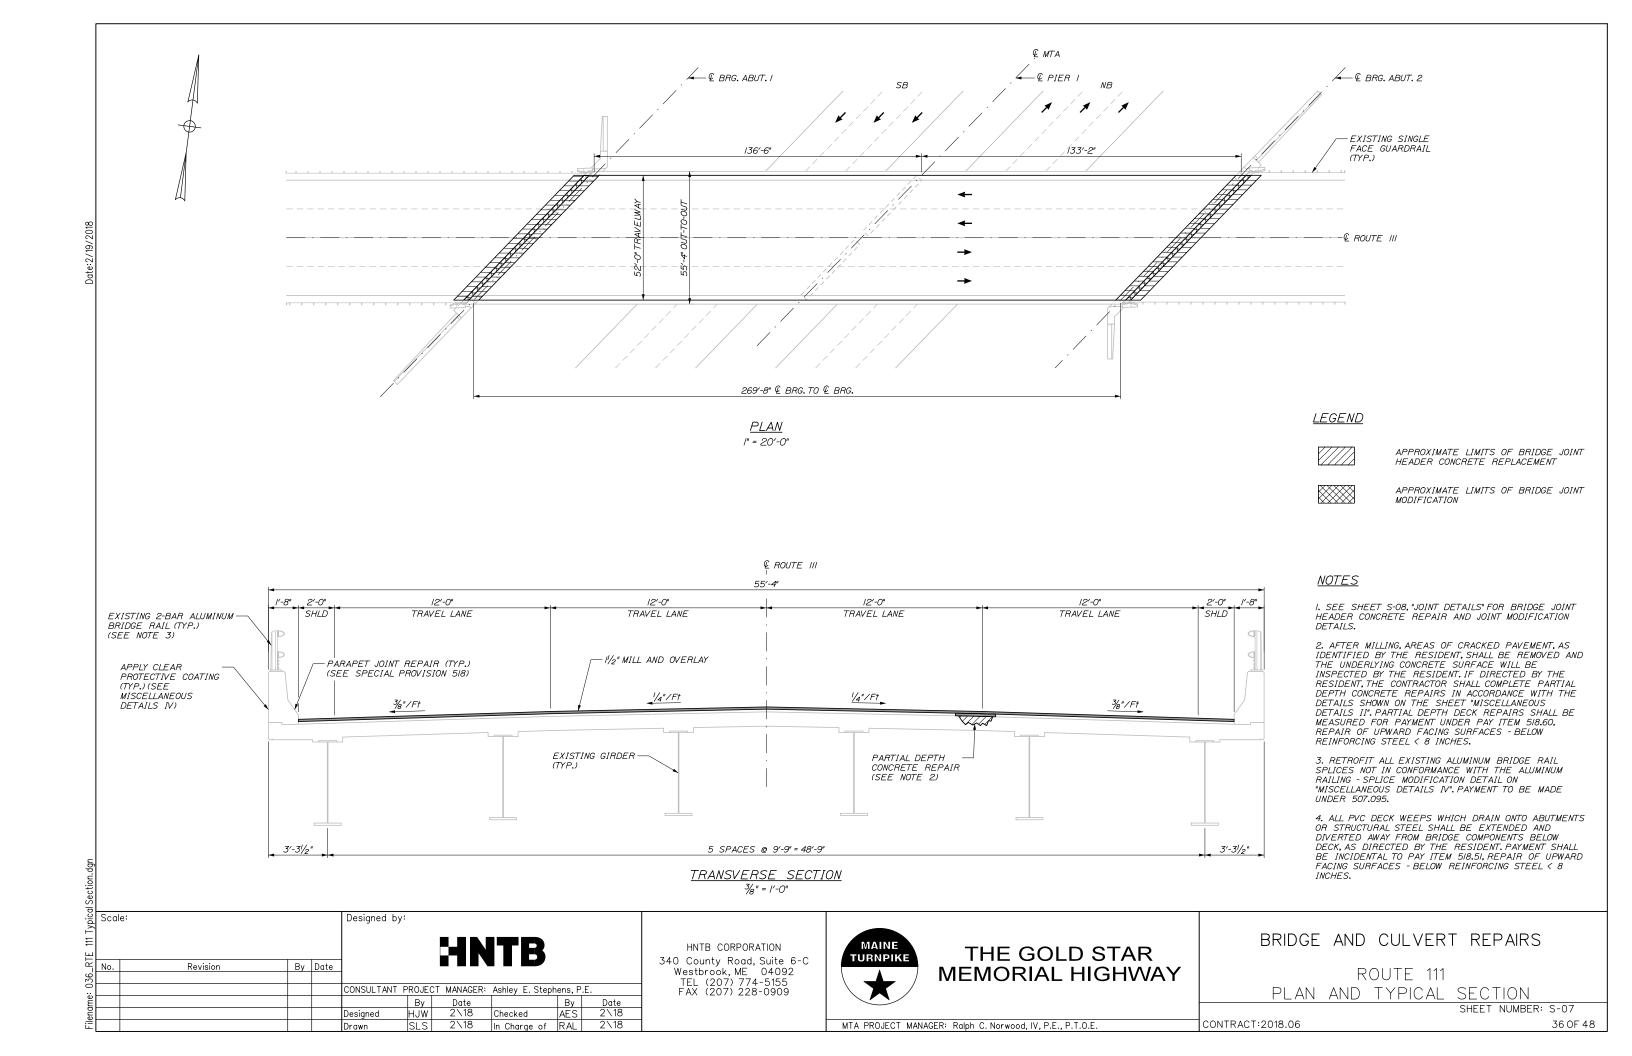



THE GOLD STAR **MEMORIAL HIGHWAY**

ROUTE 111 LIMITS OF DISTURBANCE

BRIDGE AND CULVERT REPAIRS

SHEET NUMBER: S-06



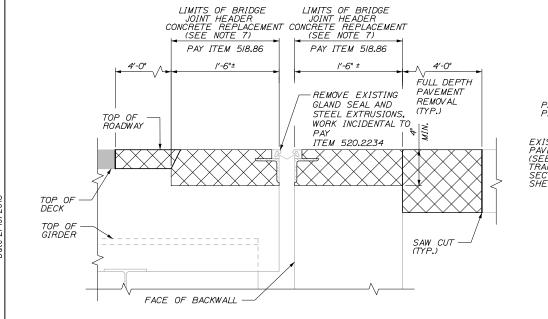

PROPOSED BRIDGE JOINT PROPOSED BRIDGE JOINT , HEADER CONCRETE HEADER CONCRETE FULL DEPTH BRG.


→ PAY ITEM 518.86 PAY ITEM 518.86 PAVEMENT REMOVAL 4'-0' l'-6"± l'-6"± PAVEMENT (TYP.) DETAIL A EXISTING PAVEMENT (SEE TRANSVERSE SECTION SHEET S-07) DECK -WATERPROOFING MEMBRANE GIRDER SAW CUT (TYP.) " DIA. PVC MEMBRANE DRAIN. EXTEND TO CLEAR ABUTMENT SEAT BY 6" HORIZONTALLY, OR 3" BELOW GIRDER, WHICHEVER IS LOWER (SEE NOTE 9)


BRIDGE JOINT MODIFICATION - DEMOLITION

|//2" = |'-0"

BRIDGE JOINT MODIFICATION - RECONSTRUCTION

|//=" = |'-0"

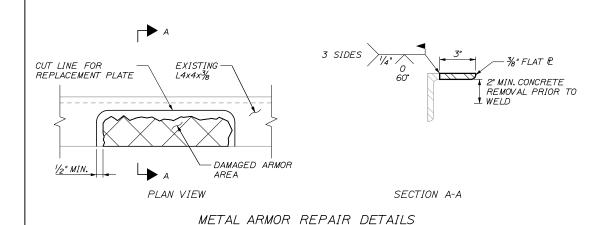

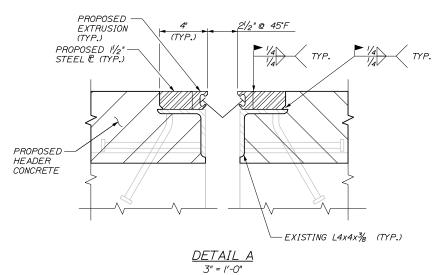

EXPANSION JOINT NOTES

I. METAL FOR JOINT ARMOR MODIFICATION SHALL BE AASHTO M270 GRADE 36, EXCEPT AS OTHERWISE NOTED. THE ENTIRE ASSEMBLY, STEEL PLATE, EXTRUSION, AND GLAND SEAL, SHALL BE MEASURED FOR PAYMENT UNDER PAY ITEM 520.2234. THE TOP SIDE OF THE COMPLETED JOINT ASSEMBLY SHALL BE COLD GALVANIZED WITH BUSH APPLIED ZRC COLD GALVANIZING COMPOUND IN STRICT ACCORDANCE WITH THE MANUFACTURER'S RECOMMENDATIONS AFTER FABRICATION.

2. ALL FIELD WELDED SPLICES IN THE PROPOSED JOINT ARMOR SHALL BE $\frac{3}{6}$ "BEVEL WELDS AND SHALL EXTEND BEYOND ALONG THE THE FULL LENGTH OF THE TOP AND BACK FACE OF THE METAL EXTRUSION.

3. SHOP DRAWINGS SHALL BE SUBMITTED TO THE RESIDENT FOR APPROVAL.

4. THE GLAND SEAL SHALL BE INSTALLED IN ONE CONTINUOUS PIECE AFTER THE JOINT ARMOR IS INSTALLED AND DECK PAVING IS COMPLETE.

5. JOINT SEALS SHALL HAVE A MINIMUM MOVEMENT RATING OF 4 INCHES. SEALS SHALL BE D.S. BROWN E2M-SEAL OR WATSON BOWMAN ACME SE-400, OR AN APPROVED EQUAL.

6. DIMENSIONS AND INFORMATION SHOWN ON THE PLANS ARE BASED ON AS-BUILT AND STANDARD DETAIL DRAWINGS. THE CONTRACTOR SHALL FIELD VERIFY JOINT OPENING AND GLAND SEAL EXTRUSION THICKNESS PRIOR TO SUBMISSION OF SHOP DRAWINGS.

7. EXISTING BRIDGE JOINT HEADER CONCRETE SHALL BE REMOVED TO SOLID CONCRETE, BUT NOT LESS THAN 4 INCHES BELOW EXISTING ROADWAY SURFACE OR 2 INCHES BELOW TOP MAT OF REINFORCING STEEL, WHICHEVER IS LOWER. BRIDGE JOINT HEADER CONCRETE REMOVAL AND REPLACEMENT SHALL BE MEASURED FOR PAYMENT UNDER PAY ITEM 518.86, BRIDGE JOINT HEADER CONCRETE REPLACEMENT, ALL PAVEMENT AND MEMBRANE REMOVAL AND REPLACEMENT REQUIRED TO COMPLETE THE JOINT HEADER CONCRETE REPLACEMENT SHALL BE INCIDENTAL TO ITEM 202.2021.

8. NO VENTS ARE PRESENT TO RELEASE AIR TRAPPED BELOW THE L4X4X% HORIZONTAL LEG OF THE JOINT ARMOR DURING CONCRETE PLACEMENT. THE CONTRACTOR SHALL PLACE CONCRETE TO ELIMINATE ENTRAPPED AIR SUCH THAT THE EXISTING L4X4X% HORIZONTAL LEG FULLY BEARS ON CONCRETE.

9. ALL PVC MEMBRANE DRAIN EXTENSIONS SHALL BE INCIDENTAL TO PAY ITEM 518.51, REPAIR OF UPWARD FACING SURFACES - BELOW REINFORCING STEFI & R INCHES

IO. METAL ARMOR REPAIR SHALL BE MEASURED FOR PAYMENT UNDER PAY ITEM 520.2228.

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Westbrook, ME 04092
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THE GOLD STAR MEMORIAL HIGHWAY BRIDGE AND CULVERT REPAIRS

ROUTE 111 JOINT REPAIR DETAILS

SHEET NUMBER: S-08

MTA PROJECT MANAGER: Ralph C. Norwood, IV, P.E., P.T.O.E.

CONTRACT:2018.06 37 OF 4

10 L.F.**

LIMIT OF SURFACE PATCH REPAIR

<u>LEGEND</u>

SQUARE FOOT AREA OF REPAIR


LINEAR FOOT LENGTH OF CRACK

*** EPOXY INJECTION CRACK REPAIR


NOTES:

I. FOR CONCRETE REPAIR DETAIL AND PROCEDURAL NOTES SEE "MISCELLANEOUS DETAILS I".


2. CONCRETE AND CRACK REPAIRS ARE NOT ANTICIPATED AT ABUTMENT IOR PIER I.

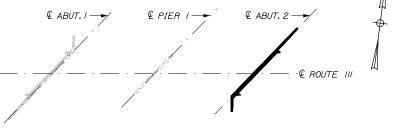

KEY PLAN

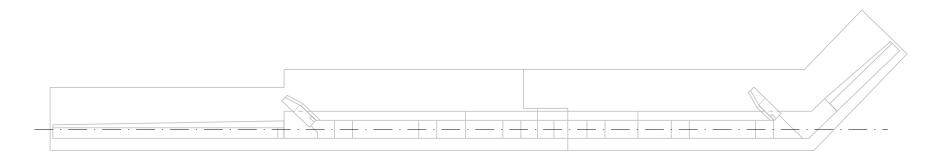

ABUTMENT 2 SEAT PLAN 1/8" = 1'-0"

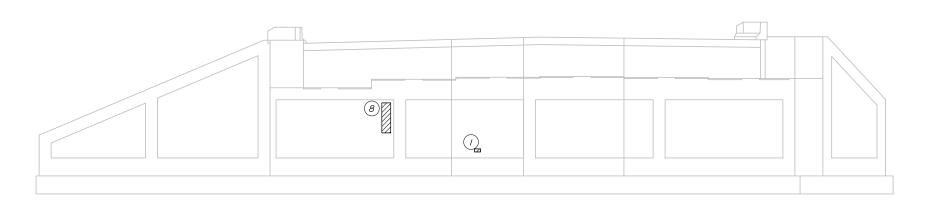

ABUTMENT 2 ELEVATION 1/8" = 1'-0"

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RTE 111 East										
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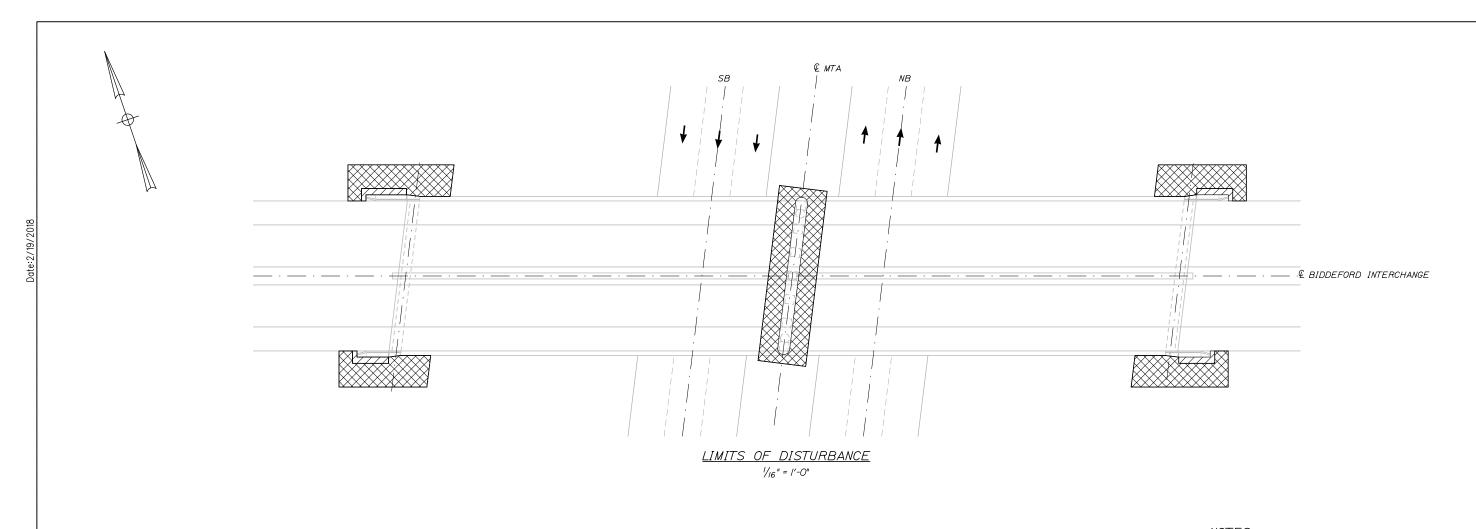
THE GOLD STAR **MEMORIAL HIGHWAY**

ROUTE 111

SUBSTRUCTURE REPAIR: ABUTMENT 2

BRIDGE AND CULVERT REPAIRS

MTA PROJECT MANAGER: Ralph C. Norwood, IV, P.E., P.T.O.E. CONTRACT:2018.06



NOTES:

I. EROSION AND SEDIMENTATION CONTROL DEVICES REQUIRED FOR THE CONTRACTOR'S ACCESS TO LOCATIONS AND STORAGE AREAS WILL NOT BE MEASURED FOR PAYMENT.

2. SEE SPECIFICATIONS FOR CONTRACTOR'S SUBMITTAL REQUIREMENTS IF ADDING ADDITIONAL LIMITS OF DISTURBANCE TO THE PROJECT ESTIMATED QUANTITIES.

3. AN ADDITIONAL 0.05 ACRES HAS BEEN ESTIMATED FOR CONTRACTOR ACCESS LOCATIONS AND STORAGE AREAS.

4. TOTAL CONTRACT LIMIT OF DISTURBANCE FOR THIS LOCATION HAS BEEN ESTIMATED TO BE 0.12 ACRES.

<u>LEGEND</u>



CONTRACTOR'S LIMIT OF DISTURBANCE AREA FOR ACCESS AND STORAGE: 0.06 ACRES



LIMIT OF DISTURBANCE: O.OI ACRES

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THE GOLD STAR **MEMORIAL HIGHWAY**

BIDDEFORD INTERCHANGE


BRIDGE AND CULVERT REPAIRS

LIMITS OF DISTURBANCE

SHEET NUMBER: S-10

MTA PROJECT MANAGER: Ralph C. Norwood, IV, P.E., P.T.O.E.

CONTRACT:2018.06

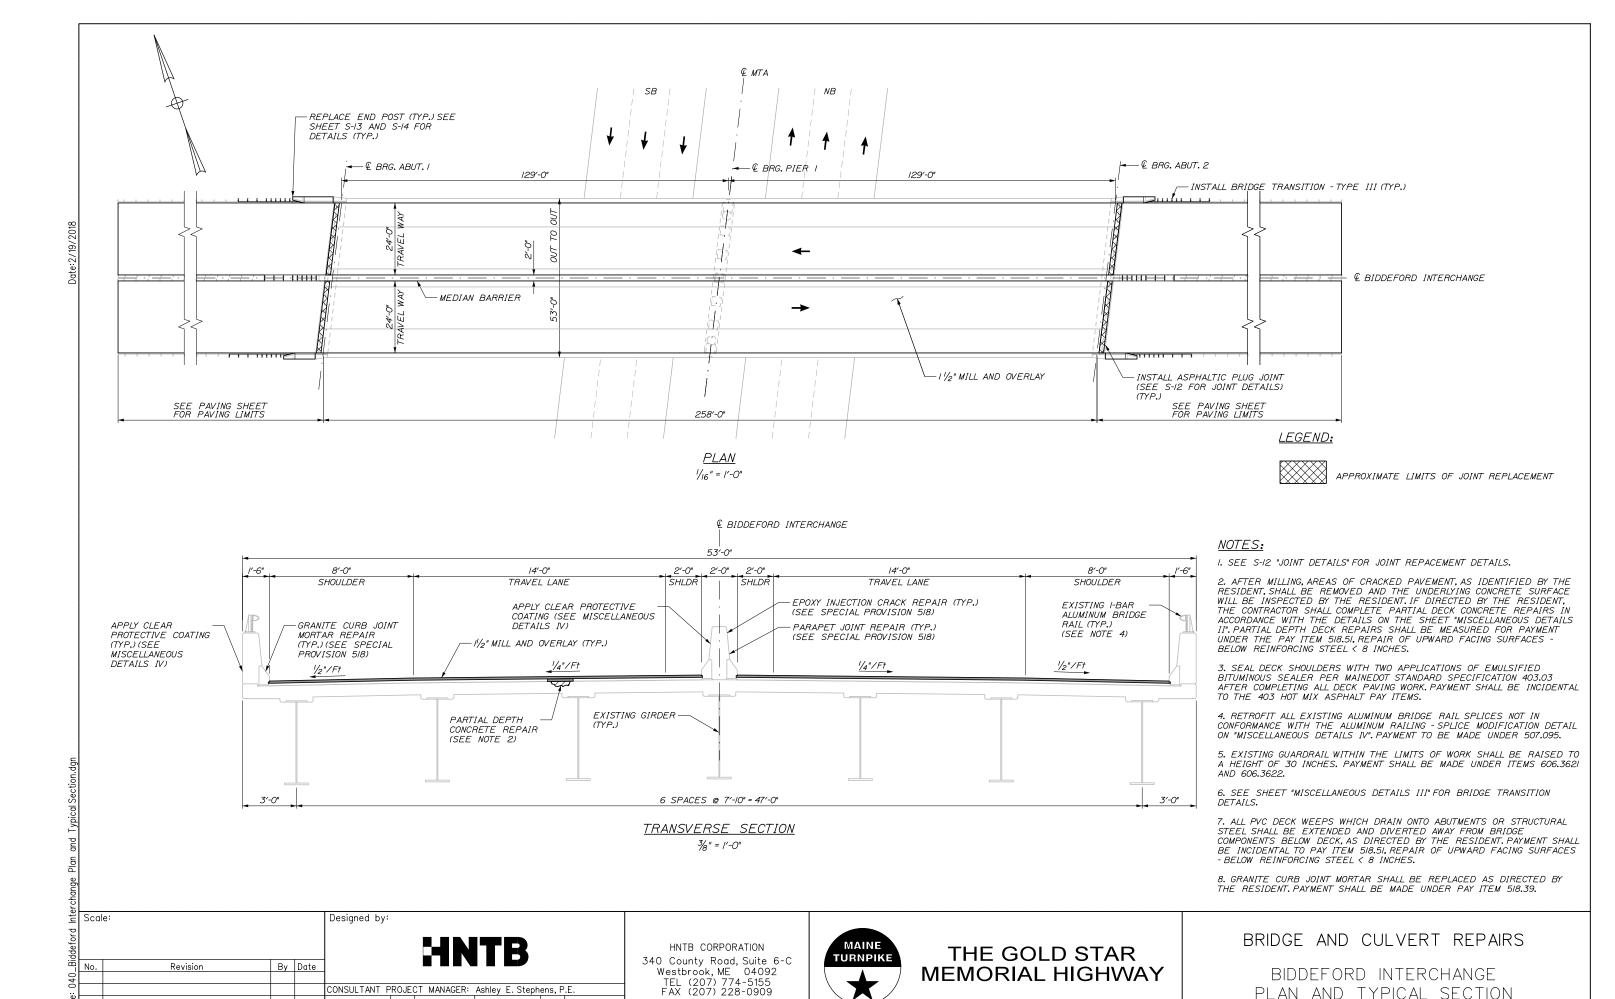

CONSULTANT PROJECT MANAGER: Ashley E. Stephens, P.E

2\18

Designed


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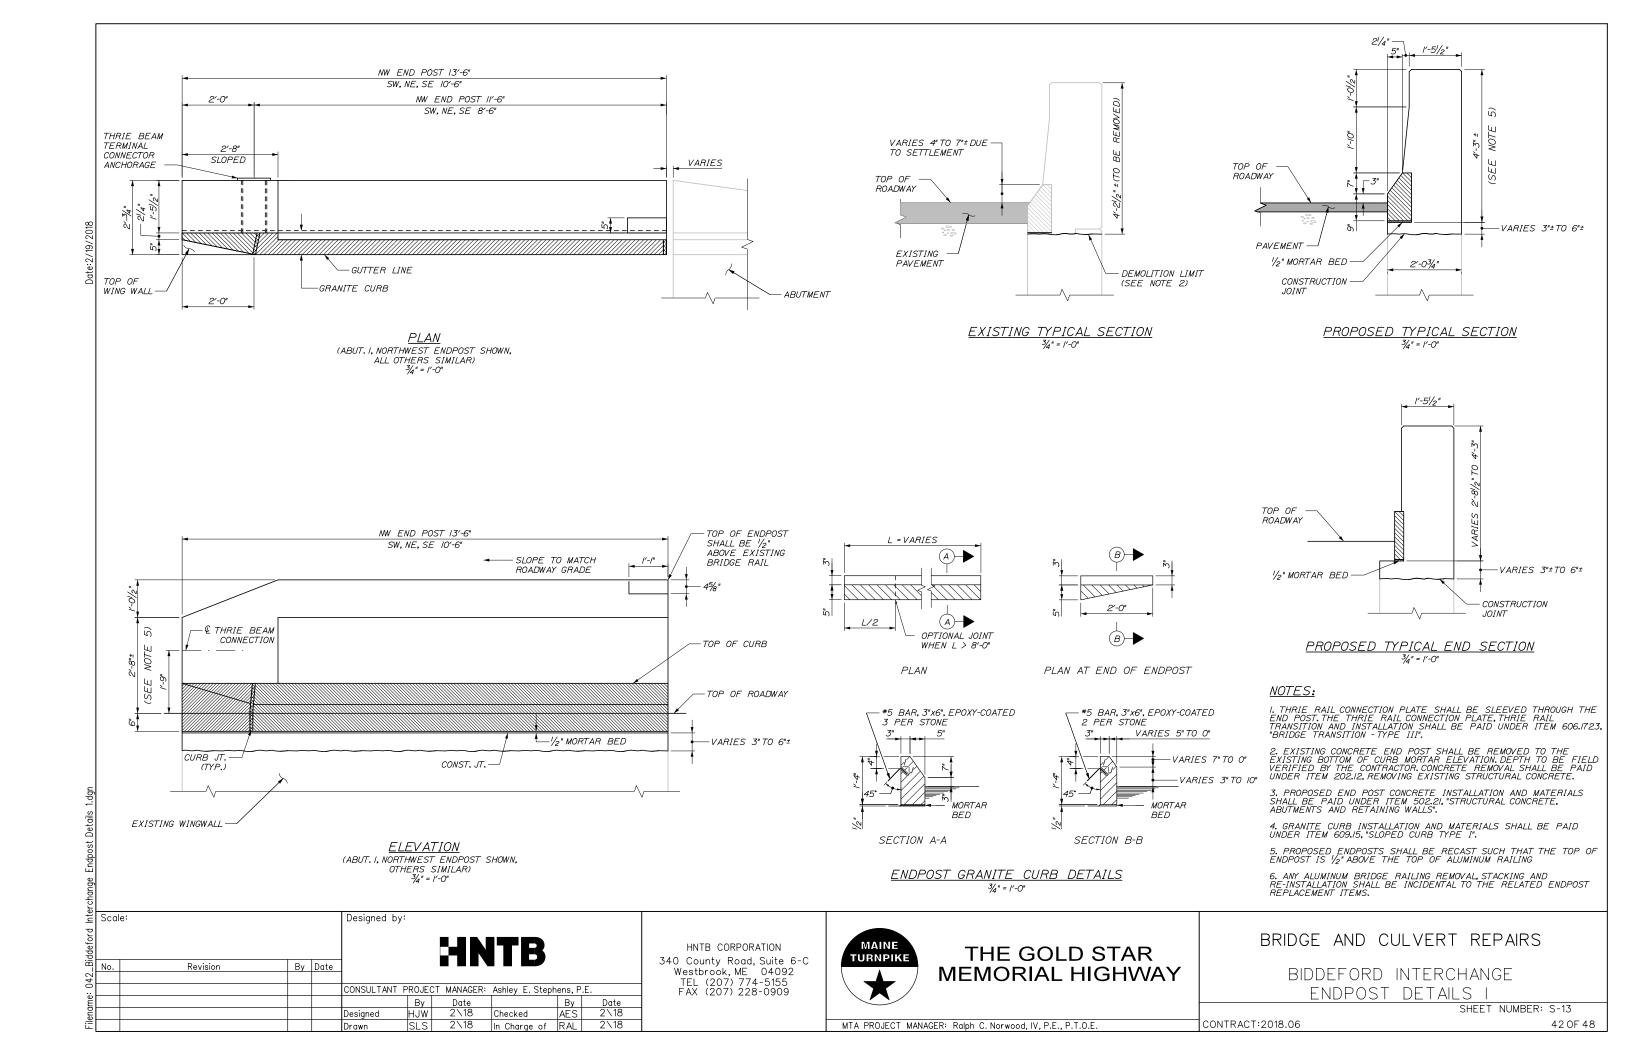
In Charge of RAL


PLAN AND TYPICAL SECTION SHEET NUMBER: S-11


MTA PROJECT MANAGER: Ralph C. Norwood, IV. P.E., P.T.O.E.


CONTRACT:2018.06



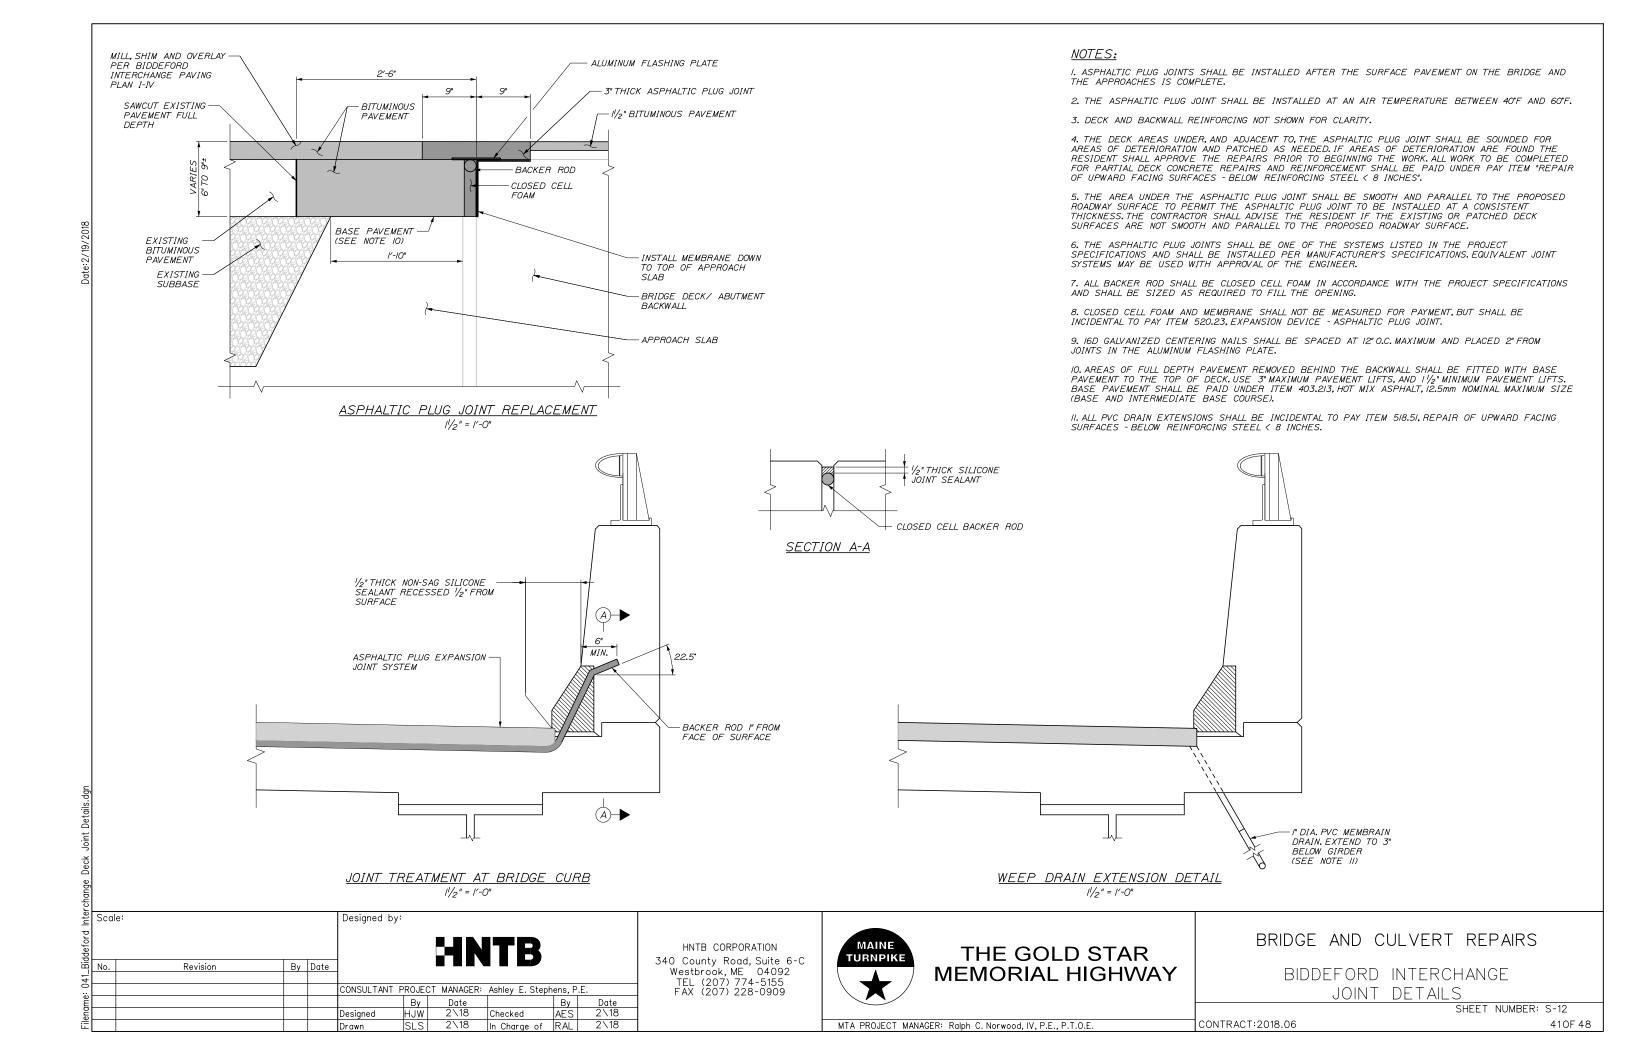

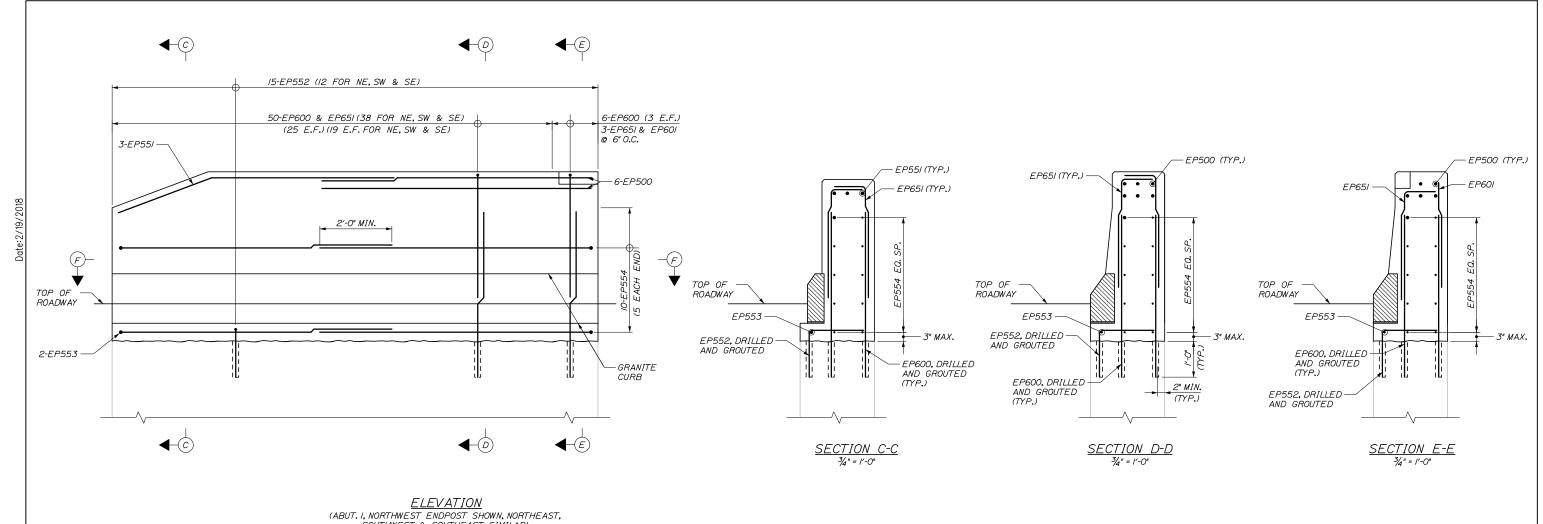

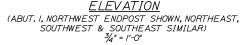

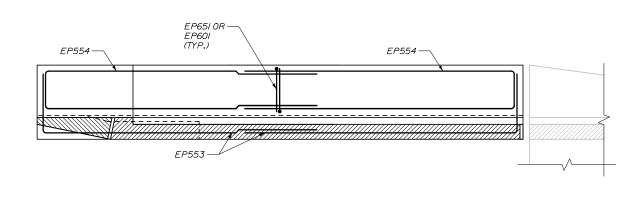

<u>SECTION F-F</u> 3/4" = 1'-0"

<u>NOTES:</u>

I. NORTHWEST END POST BAR QUANTITIES SHOWN.OTHER END POST BAR QUANTITIES SHOWN IN PARENTHESES WHERE DIFFERENT. 2. BARS SHOWN HEREIN ARE EQUALLY SPACED UNLESS OTHERWISE NOTED.

3. END POST REINFORCEMENT SHALL BE PAID UNDER THE 503 REINFORCING STEEL PAY ITEMS.

폴 Scale: Designed by: By Date Revision CONSULTANT PROJECT MANAGER: Ashley E. Stephens, P.E. Ву Checked AES
In Charge of RAL Designed 2\18

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THE GOLD STAR **MEMORIAL HIGHWAY**

BIDDEFORD INTERCHANGE


ENDPOST DETAILS II


BRIDGE AND CULVERT REPAIRS


SHEET NUMBER: S-14 CONTRACT:2018.06

MTA PROJECT MANAGER: Ralph C. Norwood, IV, P.E., P.T.O.E.


REPAIR TO CORRODED DECK REINFORCING - DETAIL I

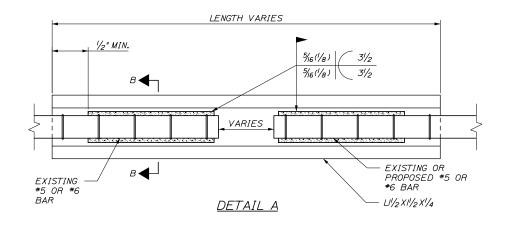

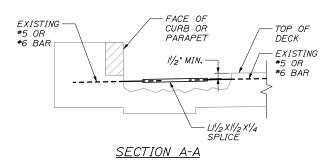


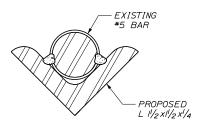

SECTION B-B

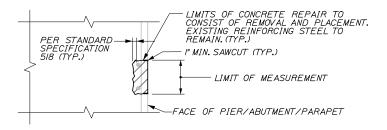

VERTICAL CONCRETE SURFACE PATCH/REPAIR DETAIL /" = /'-O"

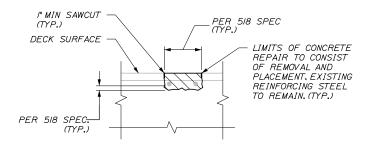

UPWARD FACING CONCRETE SURFACE PATCH/REPAIR DETAIL /" = /'-O"

CORRODED DECK REINFORCING NOTES:

- I. ALL REINFORCING BARS LOCATED WITHIN AREAS OF REPAIR OF UPWARD FACING SURFACES - BELOW REINFORCING STEEL < 8 INCHES, WHICH EXHIBIT MORE THAN 25% SECTION LOSS, SHALL BE REPAIRED PER THE DETAILS ON THIS SHEET.
- 2. ALL REINFORCING BARS RECEIVING WELD MATERIAL SHALL BE THOROUGHLY CLEANED OF DEBRIS, SLAG, AND CORROSION PRODUCTS BEFORE WELDING. CLEANING SHALL BE BY
- 3. THE ENDS OF EXISTING REINFORCING BARS TO BE WELDED WILL EXHIBIT NO MORE THAN 25% SECTION LOSS.
- 4. ALL WELDING SHALL BE IN ACCORDANCE WITH AWS DI.4: STRUCTURAL WELDING CODE - REINFORCING STEEL.
- 5. ANGLE IRON SPLICE PIECES SHALL BE L 1/2 X1/2 X1/4 (UNCOATED) CONFORMING TO ASTM A36. OTHER SIZES OF ANGLE IRON, HAVING A CROSS SECTIONAL AREA OF AT LEAST 0.56 SQUARE INCHES AND PROVIDING A MINIMUM CLEAR COVER TO THE DECK SURFACE OF AT LEAST 1.5", MAY BE SUBSTITUTED WITH APPROVAL OF THE RESIDENT.

CONCRETE REPAIR PROCEDURAL NOTES:

I. CONCRETE REPAIRS SHALL BE PAID UNDER 518 ITEMS.

REMOVAL PROCEDURES:

- I. PRIOR TO THE START OF THE CONCRETE REMOVALS, THE RESIDENT AND THE CONTRACTOR SHALL SOUND THE CONCRETE AND AGREE ON THE REMOVAL LIMITS. SHOULD THE REMOVAL AREA LIMITS APPEAR TO CHANGE DURING THE DEMOLITION PROCESS, THE CONTRACTOR SHALL NOTIFY THE RESIDENT. THE RESIDENT AND CONTRACTOR SHALL AGREE ON THE REVISED PAY LIMITS PRIOR TO THE CONTRACTOR CONTINUING REMOVALS.
- 2. PERFORM I INCH DEEP SAWCUTS ALONG LIMITS OF REMOVAL.
- 3. CHIP CONCRETE TO DEPTH REQUIRED PER THE MAINEDOT SPECIFICATION 518.

CONCRETE SURFACE PATCH/REPAIR PROCEDURE:

- I. PREPARE AND PATCH REPAIR AREAS WITH CLASS AAA MODIFIED CONCRETE. SEE SPECIFICATIONS FOR MATERIAL, PREPARATION, PLACEMENT, AND CURING
- 2. PERFORM GENERAL FINISHING (SEE BELOW).

EPOXY INJECTION CRACK REPAIR:

- I. PREPARE CONCRETE SURFACE AND CRACK AREA BY CLEANING SUBSTRATE WITH WIRE BRUSH TO REMOVE LAITANCE AND CONTAMINANTS. BLAST CLEAN THE CRACK AND CONCRETE SURFACE; DO NOT USE WATER.
- 2. SET INJECTION PORTS ALONG THE LENGTH OF THE CRACK USING A HIGH-MODULUS, LOW VISCOSITY EPOXY SUCH AS SIKADUR 35, SIKADUR 55, OR APPROVED EQUAL ONCE SET SEAL PORTS AND CRACK WITH THE SAME EPOXY ADHESIVE, EPOXY SEAL AROUND PORTS SHALL BE ALLOWED TO CURE PRIOR TO CRACK INJECTION.

GENERAL FINISHING:

I. ALL EXPOSED SUBSTRUCTURE SURFACES SHALL BE COATED WITH A PROTECTIVE COATING SUITABLE FOR CONCRETE SURFACES AFTER PATCHING IS COMPLETE AND PATCH MATERIALS HAVE CURED IN ACCORDANCE WITH SPECIAL

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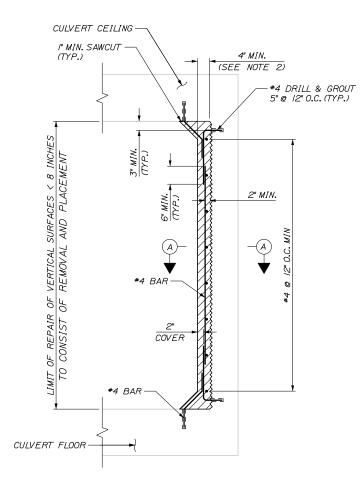


THE GOLD STAR MEMORIAL HIGHWAY BRIDGE AND CULVERT REPAIRS


MISCELLANEOUS DETAILS I

SHEET NUMBER: S-15


CONTRACT:2018.06





CULVERT WALL REPAIR DETAIL (CREDIFORD BROOK) 3/4" = 1'-0"

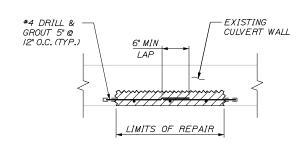

SECTION A-A

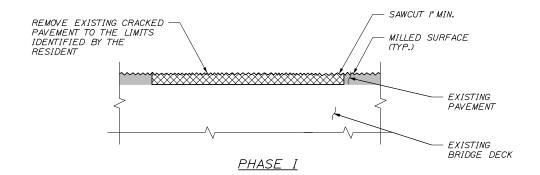

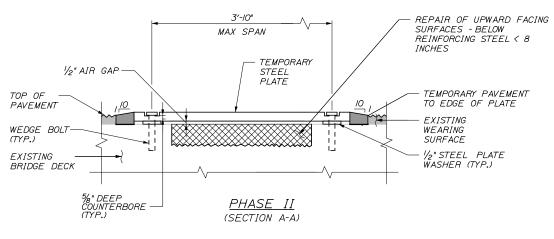

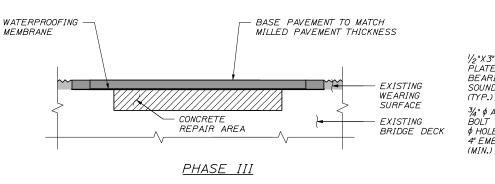


PARTIAL DEPTH CONCRETE DECK REPAIR DETAIL (ROUTE III & BIDDEFORD INTERCHANGE) 11/2" = 1'-0"

CULVERT WALL REPAIR NOTES:

- I. REFER TO "MISCELLANEOUS DETAILS I" FOR CONCRETE
- 2. CHIP CONCRETE TO SPECIFIED DEPTH. SEE THE MAINEDOT SPECIFICATION 518 FOR ADDITIONAL INFORMATION.
- 3. REINFORCEMENT FOR REPAIRS TO CULVERT WALLS SHALL BE INCIDENTAL TO PAY ITEM 518.60, "REPAIR OF VERTICAL SURFACES < 8 INCHES".

BRIDGE DECK REPAIR NOTES:

- I. REFER TO "MISCELLANEOUS DETAILS I" FOR CONCRETE
- 2. AT THE END OF EACH WORK SHIFT ANY UNFINISHED DECK OR HEADER AREAS SHALL BE STEEL PLATED PER THESE DETAILS AND THE SPECIFICATION BEFORE REOPENING THE ROADWAY TO TRAFFIC. THE PLATE SHALL REMAIN OVER THE PATCH UNTIL THE CONCRETE REACHES THE SPECIFIED DESIGN STRENGTH.
- 3. REMOVAL OF PAVEMENT ABOVE REPAIR AREAS AND TEMPORARY STEEL PLATE REQUIRED FOR PARTIAL DEPTH DECK CONCRETE REPAIRS, WATERPROOFING MEMBRANE AND REINFORCEMENT SHALL BE INCIDENTAL TO THE RELATED CONTRACT PAY ITEMS.
- 4. TEMPORARY STEEL PLATES SHALL BE ASTM A572 GRADE 50 OR APPROVED EQUAL.
- 5. CONTRACTOR MAY PROPOSE ALTERNATE TEMPORARY PLATE DESIGNS IN ACCORDANCE WITH SPECIAL PROVISION 510.
- 6. ALL TEMPORARY ANCHORS USED TO SECURE THE TEMPOARAY PLATE SHALL BE VIBRATION RESISTANT, FULLY REMOVABLE, AND SHALL NOT PROTRUDE MORE THAN 1/4" ABOVE THE TOP SURFACE OF THE PLATE EACH ANCHOR SHALL HAVE A MINIMUM ULTIMATE CAPACITY OF 10 KIPS, AND A MINIMUM SHEAR STRENGTH OF 10 KIPS IN 4,000 PSI CONCRETE. THE PROPOSED ANCHORS SHALL BE SUBMITTED TO THE RESIDENT FOR APPROVAL.

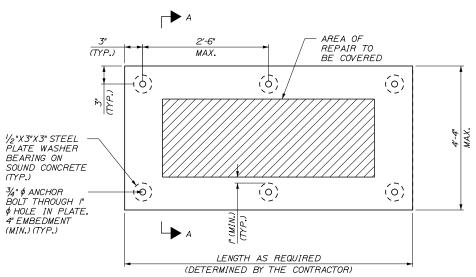

TEMPORARY STEEL PLATE DETAIL 11/2" = 1'-0"

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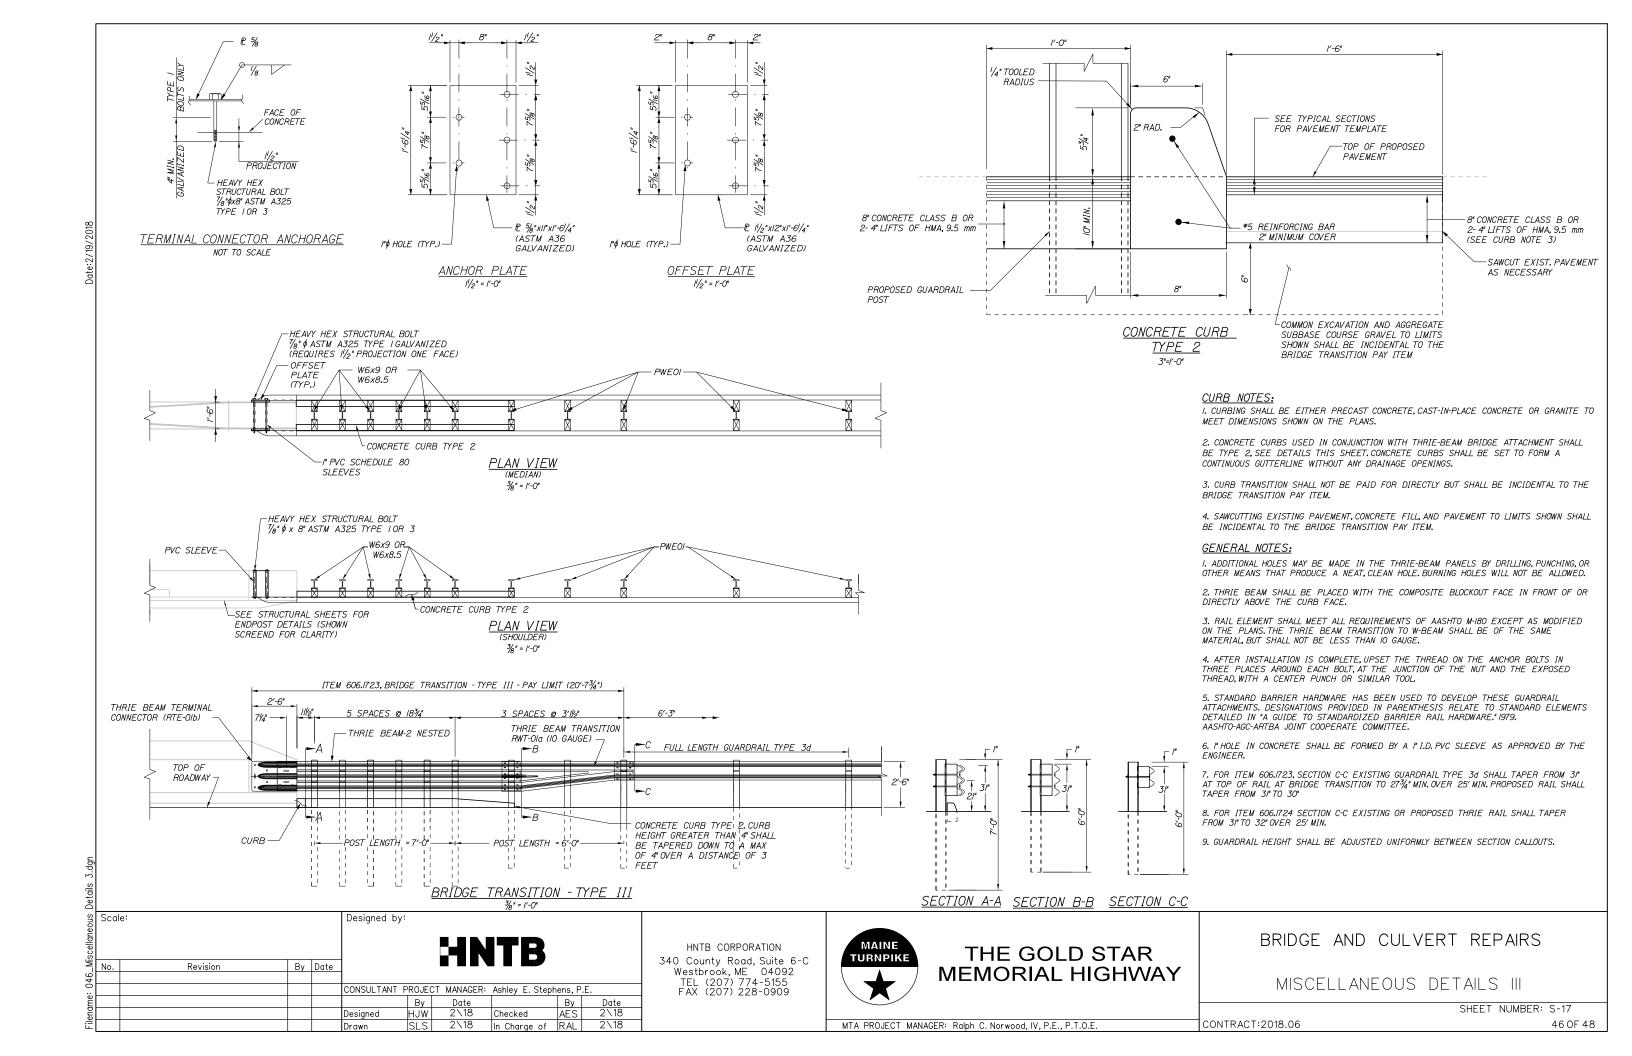
MTA PROJECT MANAGER: Ralph C. Norwood, IV. P.E., P.T.O.E.


THE GOLD STAR **MEMORIAL HIGHWAY**

MISCELLANEOUS DETAILS II

BRIDGE AND CULVERT REPAIRS

SHEET NUMBER: S-16 CONTRACT:2018.06



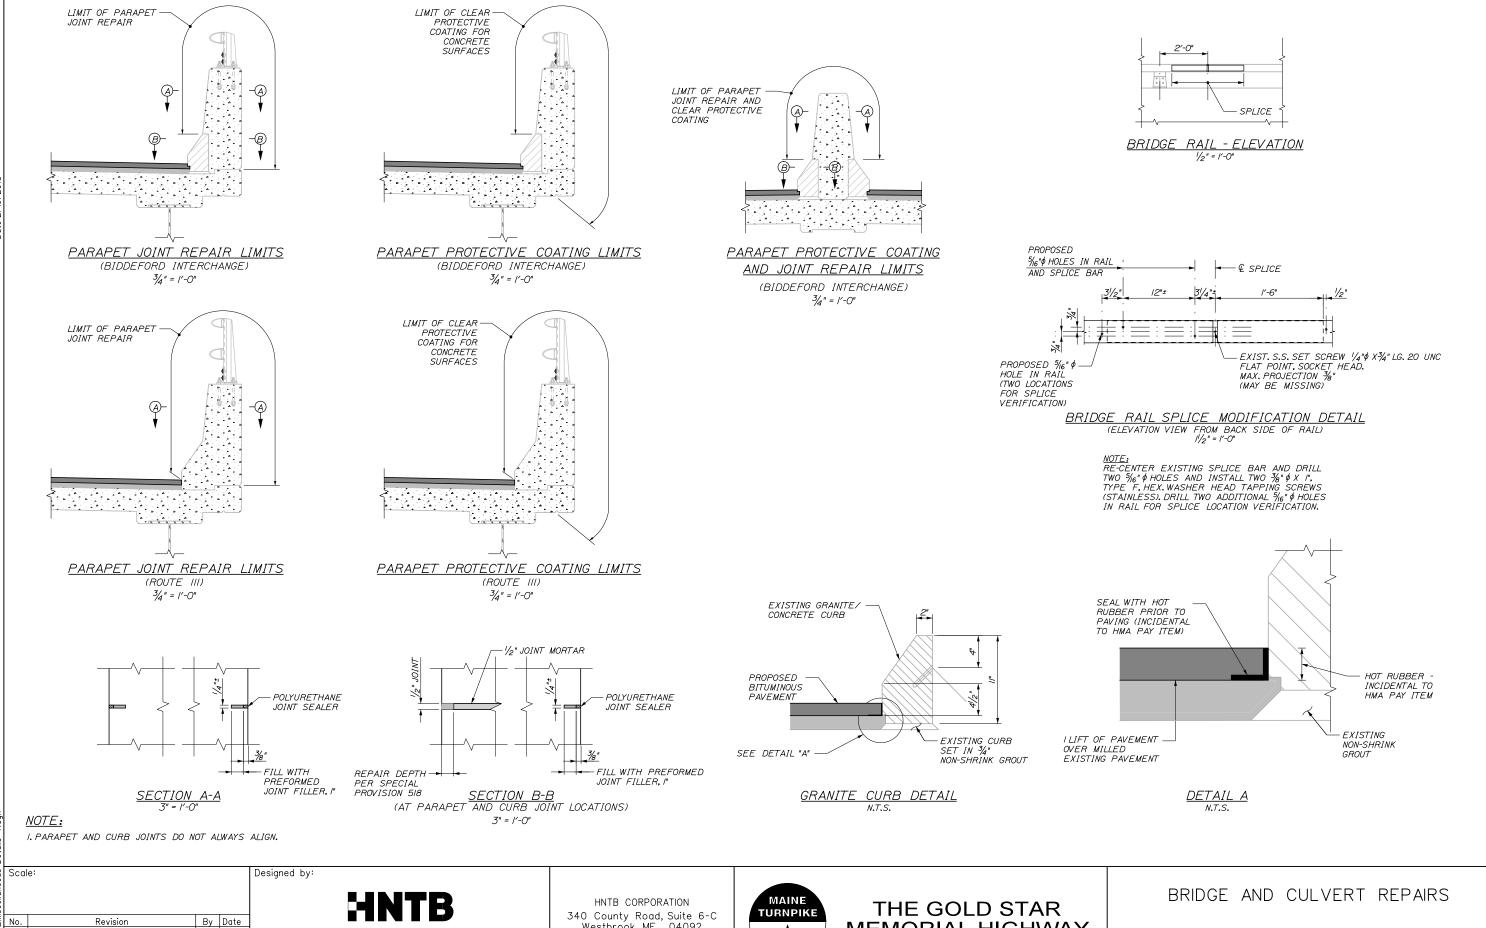

CONSULTANT PROJECT MANAGER: Ashley E. Stephens, P.E Ву Checked AES
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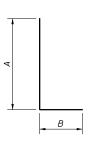


MEMORIAL HIGHWAY


MISCELLANEOUS DETAILS IV

SHEET NUMBER: S-18 CONTRACT:2018.06


MTA PROJECT MANAGER: Ralph C. Norwood, IV. P.E., P.T.O.E.



TYPE 118

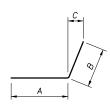

TYPE 119

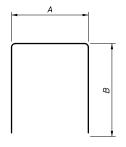

TYPE 129

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THE GOLD STAR **MEMORIAL HIGHWAY**

BIDDEFORD INTERCHANGE

BRIDGE AND CULVERT REPAIRS

REINFORCING STEEL SCHEDULE

SHEET NUMBER: S-19 CONTRACT:2018.06 48 OF 48

MTA PROJECT MANAGER: Ralph C. Norwood, IV, P.E., P.T.O.E.