

MAINE TURNPIKE AUTHORITY

DANIEL E. WATHEN, CHAIR ROBERT D. STONE, VICE CHAIR MICHAEL J. CIANCHETTE, MEMBER JOHN E. DORITY, MEMBER ANN R. ROBINSON, MEMBER THOMAS J. ZUKE, MEMBER BRUCE A. VAN NOTE, MEMBER EX-OFFICIO

S. PETER MILLS, EXECUTIVE DIRECTOR

CONTRACT 2019.07 ROUTE 109 / EXIT 19 IMPROVEMENTS


CONTRACT 2019.07 ROUTE 109 / EXIT 19 IMPROVEMENTS **VOLUME II**


LOCATION MAP


MAINE TURNPIKE AUTHORITY

PETER S. MERFELD, P.E. CHIEF OPERATIONS OFFICER

DIRECTOR OF ENGINEERING AND BUILDING MAINTENANCE

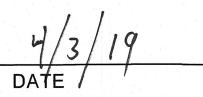

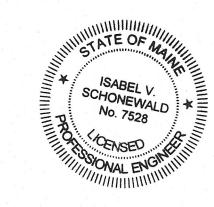

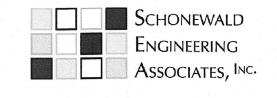

ISABEL V. SCHONEWALD, P.E. SCHONEWALD ENGINEERING ASSOCIATES, INC.

PRESIDENT AND CHIEF ENGINEER - SHEET 8



S. DUCHARME

T-Y-LININTERNATIONAL

INDEX OF SHEETS

MAINTENANCE OF TRAFFIC PLANS

FOUNDATION AND BORING PLAN

SIGN DETAILS/SUMMARY

LIMIT OF DISTURBANCE PLAN

SIGN STRUCTURE CROSS SECTION

ESTIMATED QUANTITIES AND GENERAL NOTES

MAINTENANCE OF TRAFFIC SIGN SUMMARY

DESCRIPTION

TITLE SHEET

SIGNAL PLAN

SHEET NO.

Kerni S. Dun

4/2/2019 DATE

PROJECT MANAGER - SHEETS 1-7, 9-12

2019.07

KEVIN S. DUCHARME, P.E T.Y.LIN INTERNATIONAL



ITEM NO.	ITEM DESCRIPTION	UNIT	QUANTITY
526.301	TEMPORARY CONCRETE BARRIER, TYPE I	LS	1
527.342	WORK ZONE CRASH CUSHIONS - TL-2	UN	1
607.44	SAFETY FENCE	LF	80
615.07	LOAM	CY	0.5
618.14	SEEDING METHOD NUMBER 2	UN	0.02
619.1202	TEMPORARY MULCH	LS	1
626.32	24" FOUNDATION	EΑ	2
627.712	WHITE OR YELLOW PAINTED PAVEMENT MARKING LINE	LF	/35
<i>627.</i> 75	WHITE OR YELLOW PAVEMENT & CURB MARKING	SF	95
627.78	TEMPORARY PAVEMENT MARKING LINE, WHITE OR YELLOW	LF	/35
629.05	HAND LABOR - STRAIGHT TIME	HR	5
631.12	ALL PURPOSE EXCAVATOR (INCLUDING OPERATOR)	HR	5
631.172	TRUCK, LARGE (INCLUDING OPERATOR)	HR	5
631.36	FOREMAN	HR	5
643.71	TRAFFIC SIGNAL MODIFICAION: EXIT 19 AND ROUTE 109/SANFORD RD INTERSECTION	LS	/
643.83	VIDEO DETECTION SYSTEM	LS	/
<i>643.</i> 97	WOOD POLES WITH GUYS AND SPAN WIRES	ΕA	1
645.103	DEMOUNT GUIDE SIGN	EΑ	/
645.106	DEMOUNT REGULATORY, WARNING, CONFIRMATION, AND ROUTE MARKER ASSEMBLY SIGN	EΑ	2
645.15	CANTILEVER GUIDE SIGN: (STA. 10+62.00)	LS	1
645.251	ROADWAY GUIDE SIGNS, TYPE I	SF	150
645.289	STEEL H-BEAM POLES	LB	720
645.292	REGULATORY, WARNING, CONFIRMATION, AND ROUTE MARKER ASSEMBLY SIGNS TYPE II	SF	47
652.33	DRUM	EΑ	90
<i>652.34</i>	CONE	EΑ	30
<i>652.35</i>	CONSTRUCTION SIGNS	SF	240
652 . 631	MAINTENANCE OF TRAFFIC CONTROL DEVICES	LS	1
<i>652.38</i>	FLAGGERS	HR	140
<i>656.632</i>	30 INCH TEMPORARY SILT FENCE	LF	260
659.10	MOBILIZATION	LS	/

GENERAL

- I. ALL WORK SHALL BE DONE IN ACCORDANCE WITH THE MAINE DEPARTMENT OF TRANSPORTATION'S STANDARD SPECIFICATIONS LATEST REVISION AND THE MAINE DEPARTMENT OF TRANSPORTATION'S STANDARD DETAILS HIGHWAYS & BRIDGES LATEST REVISION UNLESS OTHERWISE NOTED OR INCLUDED IN THESE PLANS.
- 2. NO SEPARATE PAYMENT FOR SUPERINTENDENT OR FOREMAN WILL BE MADE FOR THE SUPERVISION OF EQUIPMENT BEING PAID FOR UNDER THE EQUIPMENT RENTAL ITEMS.
- 3. "UNDETERMINED LOCATIONS" SHALL BE DETERMINED BY THE RESIDENT.
- 4. THE CONTRACTOR IS REQUIRED TO MAINTAIN ACCESS TO ALL DRIVEWAYS AND SIDE ROADS DURING CONSTRUCTION UNLESS OTHERWISE NOTED ON THE PLANS.
- 5. THE CONTRACTOR SHALL SUBMIT THEIR PROPOSED STAGING AREA(S) TO THE RESIDENT FOR APPROVAL PRIOR TO STARTING WORK.
- 6. RIGHT OF WAY AND PROPERTY LINES ARE SHOWN FOR INFORMATIONAL PURPOSES ONLY.
- 7. GEOTECHNICAL INFORMATION FURNISHED OR REFERRED TO IN THE PLAN SET IS FOR BIDDER'S AND CONTRACTOR'S USE. NO ASSURANCE IS GIVEN THAT THE INFORMATION OR INTERPRETATIONS WILL BE REPRESENTATIVE OF ACTUAL SUBSURFACE CONDITIONS AT THE TIME OF CONSTRUCTION. THE AUTHORITY SHALL NOT BE RESPONSIBLE FOR THE BIDDER'S AND CONTRACTOR'S INTERPRETATIONS OF, OR CONCLUSIONS DRAWN FROM THE GEOTECHNICAL INFORMNATION. THE BORING LOGS CONTAINED IN THE PLAN SET PRESENT FACTUAL AND INTERPRETIVE SUBSURFACE INFORMATION COLLECTED AT DISCRETE LOCATIONS. DATA PROVIDED MAY NOT BE REPRESENTATIVE OF THE SUBSURFACE CONDITIONS BETWEEN BORING LOCATIONS.
- 8. WHERE SIGNS REQUIRE A SIX (6) INCH PANEL, THE 6-INCH PANEL SHALL BE ATTACHED AT THE BOTTOM ON THE SIGN, EXCEPT WHERE NOTED.
- 9. THE CONTRACTOR SHALL STAKE OUT THE LOCATIONS OF ALL SIGNS TO BE INSTALLED ON NEW SUPPORTS FOR REVIEW AND APPROVAL BY THE RESIDENT PRIOR TO ORDERING AND FABRICATING SUPPORTS.
- IO. THE CONTRACTOR SHALL BE RESPONSIBLE FOR CONDUCTING THEIR OWN ACTUAL ELEVATION AND CROSS-SECTION INVESTIGATIONS FOR SIGNS
 PROPOSED FOR NEW SUPPORTS.
- II. EXISTING SIGNS SHALL BE MAINTAINED UNTIL THE NEW SIGNS ARE INSTALLED.WHEN NEW SIGNS ARE INSTALLED IN FRONT OF EXISTING SIGNS, THE CONTRACTOR SHOULD INSTALL THE SUPPORTS AND THE SIGN ON THE SAME DAY.ALTERNATIVELY,THE CONTRACTOR MAY ELECT TO INSTALL THE SUPPORTS IN ADVANCE OF INSTALLING THE SIGN; HOWEVER,THE CONTRACTOR SHALL NOT LEAVE POSTS INSTALLED FOR MORE THAN ONE WEEK PRIOR TO INSTALLING THE NEW SIGN.
- 12. ALL EXCAVATION IS INCIDENTAL TO THE APPLICABLE ITEMS.

SIGNING

1. 24" FOUNDATION SHALL BE COMPLETED IN ACCORDANCE WITH THE MAINE DEPARTMENT OF TRANSPORTATION'S 2002 STANDARD DETAILS.

<u>UTILITY</u>

I. THE UTILITIES INVOLVED IN THIS CONTRACT ARE AS FOLLOWS:

MAINE TURNPIKE AUTHORITY

CENTRAL MAINE POWER CO.
CONSOLIDATED COMMUNICATIONS
CHARTER COMMUNICATIONS (SPECTRUM)
UNITIL
WELLS SANITARY DISTRICT

- 2 ALL UTILITY FACILITIES SHALL BE ADJUSTED BY THE RESPECTIVE UTILITIES UNLESS OTHERWISE NOTED.
- 3. EXISTING UTILITIES ON THESE PLANS WERE COMPILED FROM FIELD SURVEY AND VARIOUS OTHER SOURCES.LOCATIONS ARE NOT GUARANTEED TO BE ACCURATE NOR IS IT GUARANTEED THAT ALL UTILITIES ARE SHOWN.NO SEPARATE OR ADDITIONAL COMPENSATION WILL BE ALLOWED TO THE CONTRACTOR DUE TO ANY VARIANCE BETWEEN THE DATA SHOWN ON THE PLANS AND THE ACTUAL FIELD CONDITIONS ENCOUNTERED.NO WORK SHALL BE STARTED UNTIL THE OWNERS OF THE VARIOUS UTILITIES ARE NOTIFIED BY THE CONTRACTOR OF THE PROPOSED CONSTRUCTION.THE CONTRACTOR IS ALSO REQUIRED TO CALL DIG SAFE AT 1-888-344-7233 AT LEAST 72 HOURS PRIOR TO THE START OF THE WORK.

EARTHWORK

- I. ALL WASTE MATERIAL SHALL BE DISPOSED OF OFF THE PROJECT IN ACCORDANCE WITH CHAPTER 404, DEPARTMENT OF ENVIRONMENTAL PROTECTION SOLID WASTE MANAGEMENT RULES.
- 2. EXCAVATIONS ACCOMPLISHED AS PART OF THIS PROJECT SHALL BE CONSTRUCTED IN ACCORDANCE WITH OSHA SUBPART P OF 29 CFR PART 1926.650-652 (CONSTRUCTION STANDARDS FOR EXCAVATION).

EROSION CONTROL

- I. ALL WORK SHALL BE DONE IN ACCORDANCE WITH THE MAINE DEPARTMENT OF TRANSPORTATION'S BEST MANAGEMENT PRACTICES
 FOR EROSION CONTROL & SEDIMENT CONTROL LATEST EDITION UNLESS OTHERWISE NOTED OR INCLUDED IN THESE PLANS.
- 2. THE ANTICIPATED EROSION CONTROL DEVICES ARE SHOWN ON THE PLANS. THE CONTRACTOR SHALL PROPOSE ACTUAL TYPE AND LOCATION OF DEVICES FOR APPROVAL BY THE RESIDENT. ADDITIONAL MEASURES MAY BE PROPOSED BY THE CONTRACTOR DUE TO SITE OR WEATHER CONDITIONS. THE RESIDENT MAY DIRECT THE CONTRACTOR TO IMPLEMENT ADDITIONAL MEASURES. ANY ADDITIONAL MEASURES APPROVED BY THE RESIDENT WILL BE MEASURED FOR PAYMENT.
- 3. FOUR (4) INCHES OF LOAM HAS BEEN ESTIMATED FOR ALL DISTURBED SLOPE AREAS UNLESS OTHERWISE SPECIFIED ON THE PLANS.
 ACTUAL PLACEMENT OF THE LOAM SHALL BE AS DESIGNATED BY THE RESIDENT.
- 4. ALL SLOPES SHALL BE SEEDED WITH SEEDING METHOD NUMBER 2.
- 5. MULCH SHALL BE APPLIED IN AREAS SEEDED.

 -		le:			Designed b	ру:						
TA\002.		NOT TO SCALE			T-Y-LININTERNATIONAL							
\MS	No.	Revision	Ву	Date	1							
: e:					CONSULTAN	T PROJEC	T MANAGER:	Kevin Ducharm	ne			
a						Ву	Date		Ву	Date		
Filen					Designed	TWA	3/2019	Checked	KŚD	3/2019		
ت					Drawn	TWA	3/2019	In Charge of	KSD	3/2019		

T.Y. Lin International 12 Northbrook Drive

Building A, Suite One Falmouth, Maine 04105 TEL: (207) 781-4721 FAX: (207) 781-4753



THE GOLD STAR MEMORIAL HIGHWAY


ROUTE 109 IMPROVEMENTS


ESTIMATED QUANTITIES & GENERAL NOTES

SHEET NUMBER:

CONTRACT:2019.07

2 OF 12

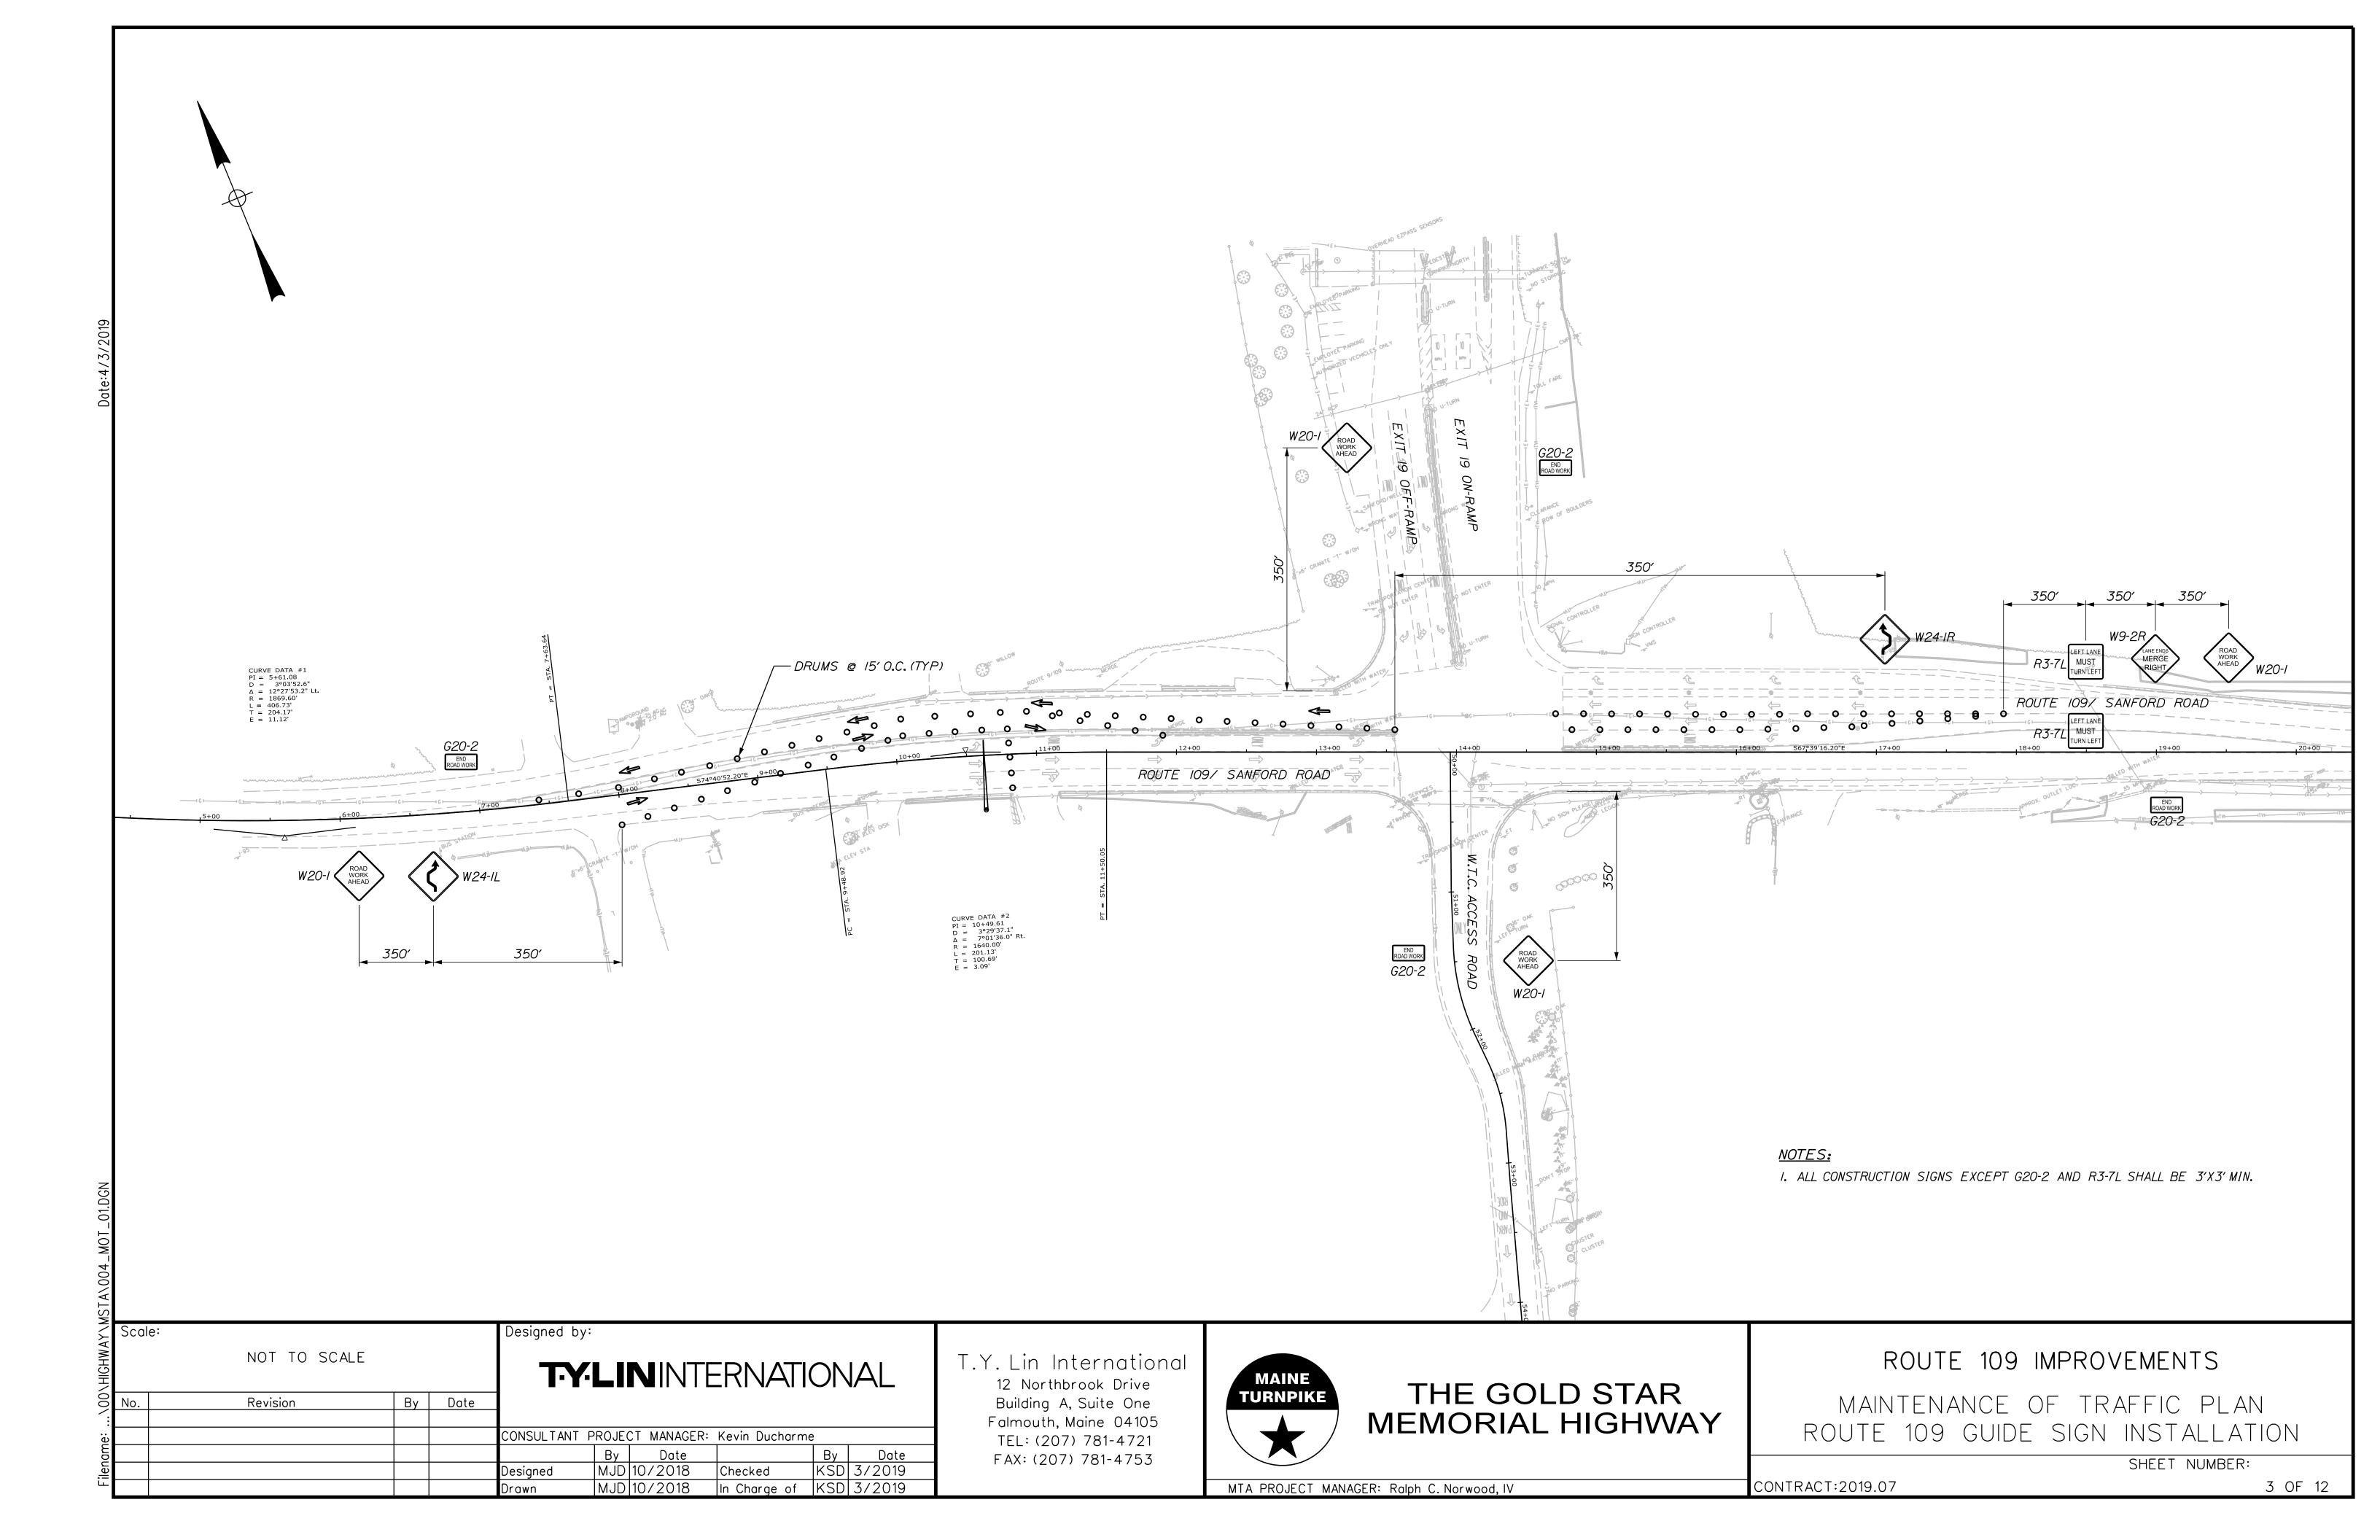

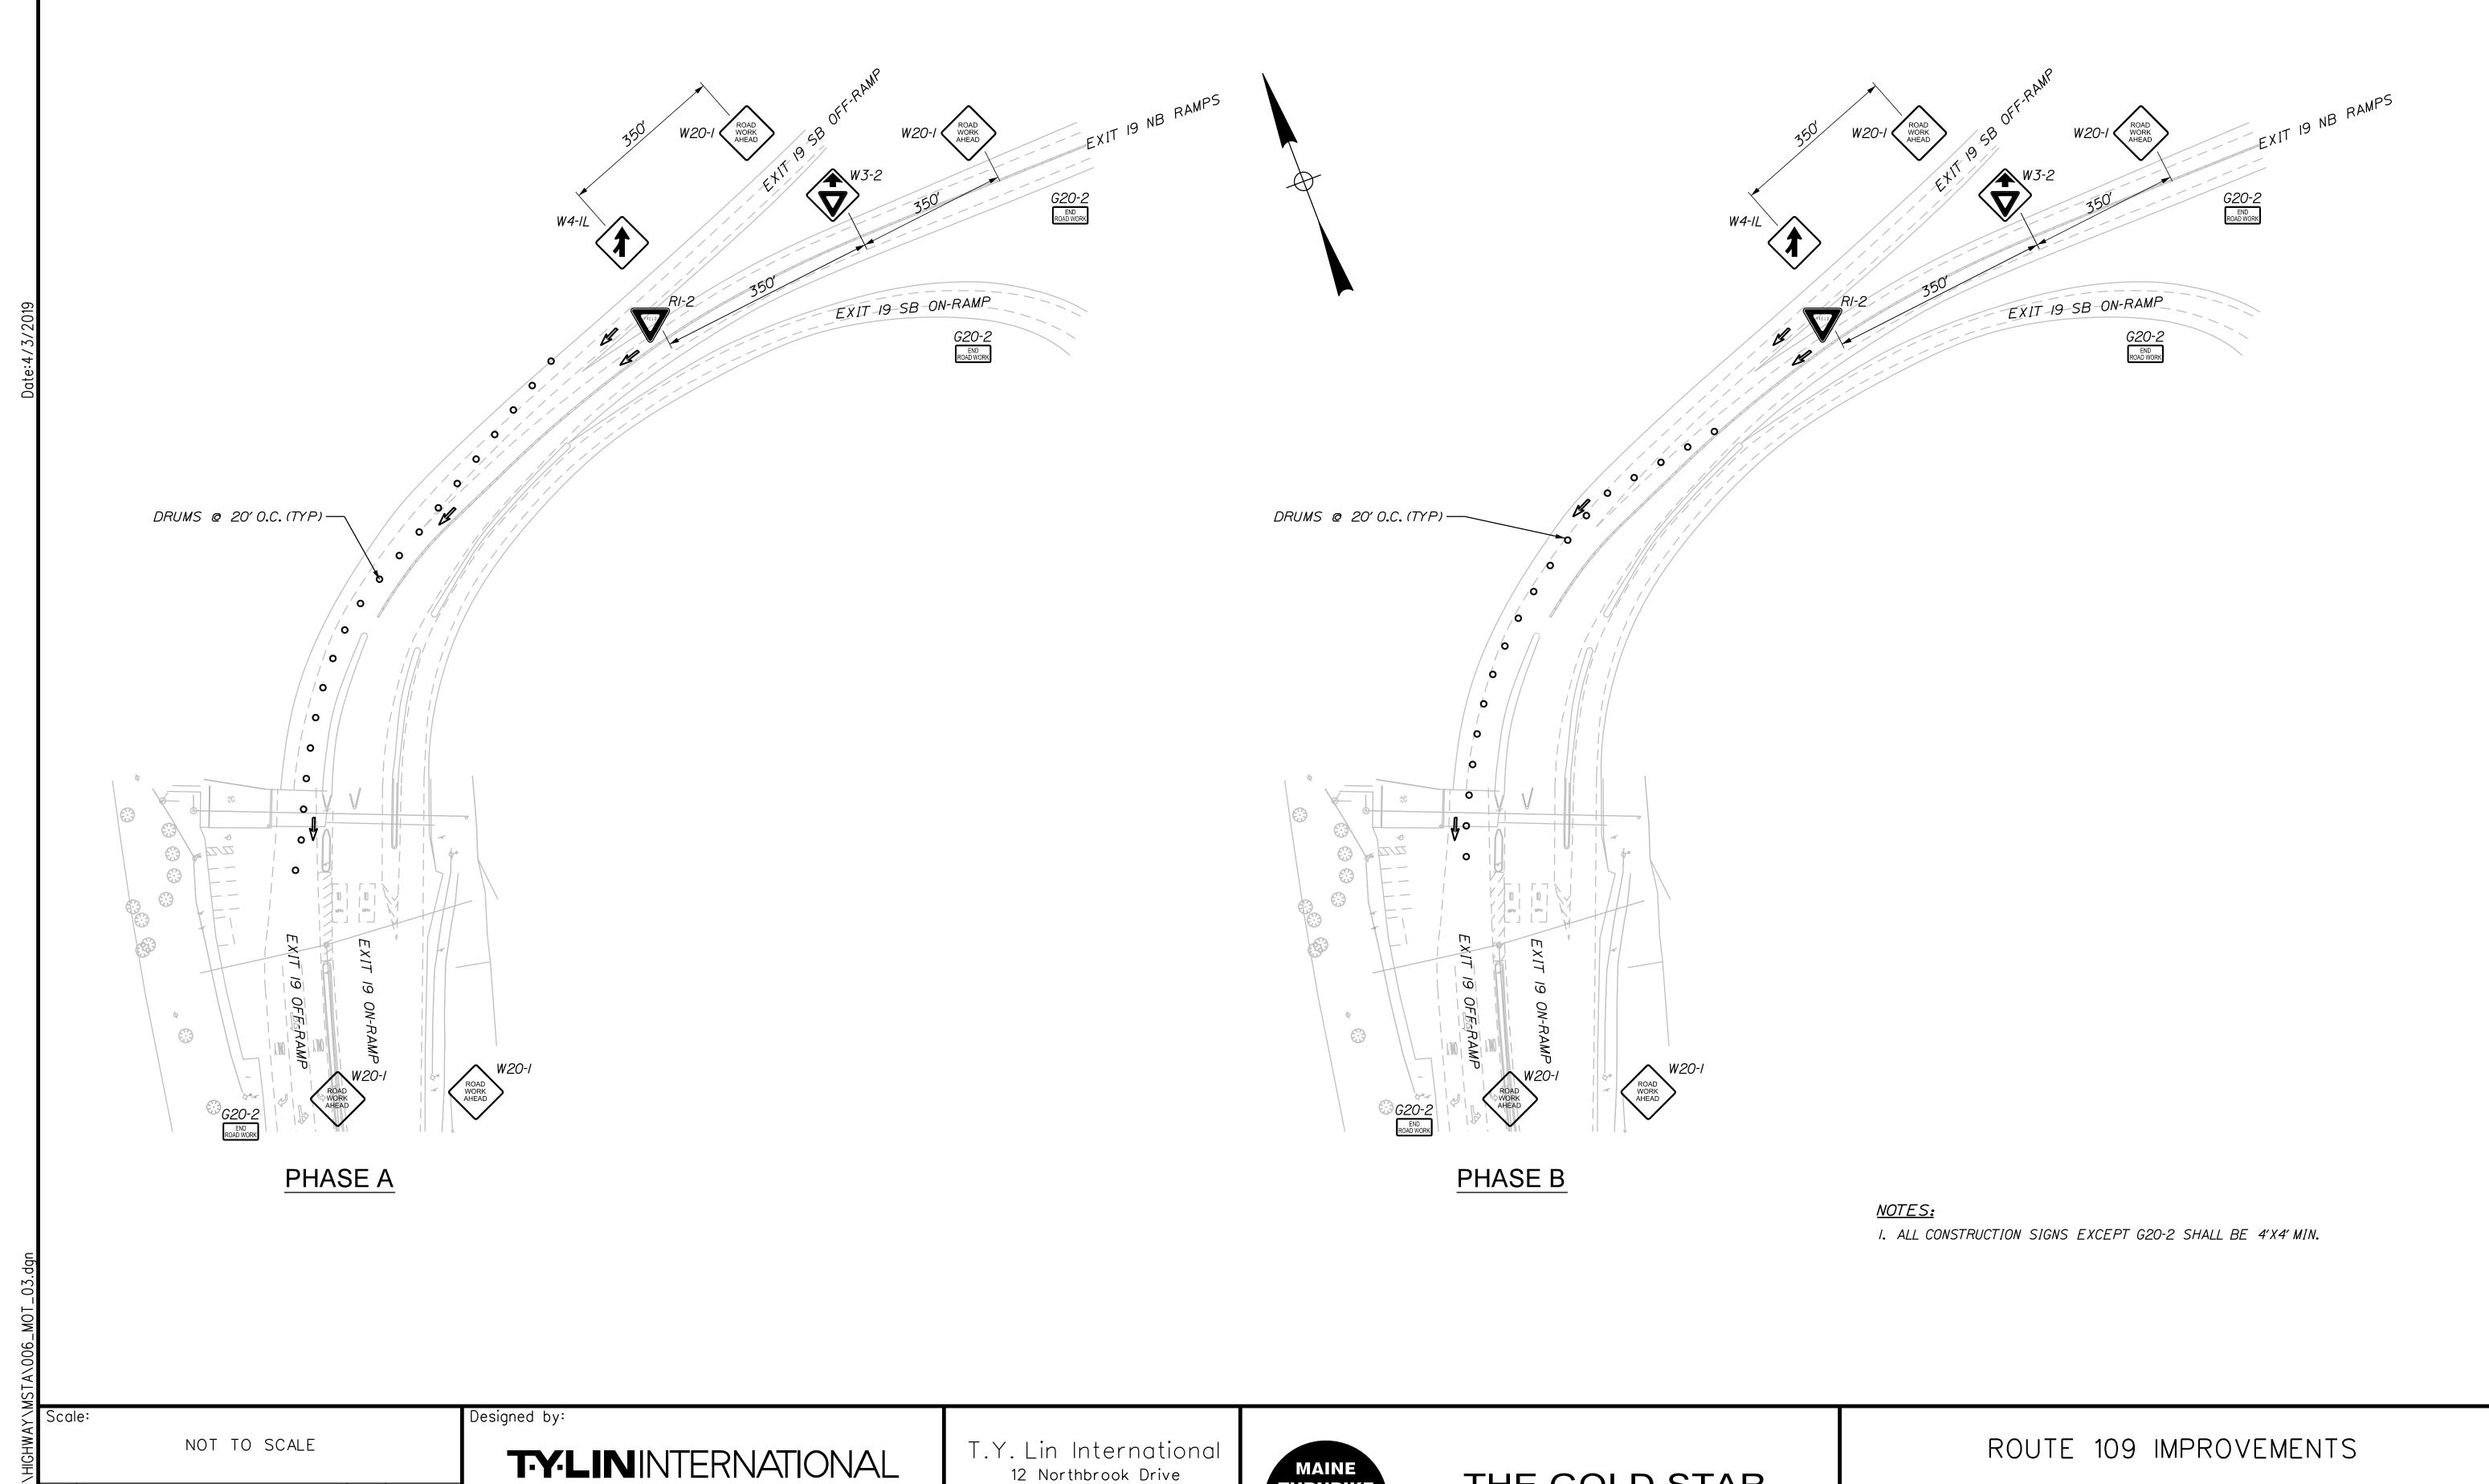

By Date Revision CONSULTANT PROJECT MANAGER: Kevin Ducharme By Date
Checked KSD 3/2019
In Charge of KSD 3/2019 By Date MJD 10/2018 MJD 10/2018 Designed

12 Northbrook Drive Building A, Suite One Falmouth, Maine 04105 TEL: (207) 781-4721 FAX: (207) 781-4753

TURNPIKE

THE GOLD STAR MEMORIAL HIGHWAY

MAINTENANCE OF TRAFFIC PLAN EXIT 19 OFF RAMPS SIGN INSTALLATION

SHEET NUMBER:

CONTRACT:2019.07 4 OF 12

MTA PROJECT MANAGER: Ralph C. Norwood, IV

IDENTIFI-	CIZE	. OF		TFXT	DIME	NSIO	NS I	(INCH	FS)	NUMBER	COL	0R		1054 14	
CATION	SI	GN	TEXT	LETTE	ER VL	ERTIC	CAL	ARR	?OW	NUMBER OF SIGNS	BACK-	LEGEND	BORDER RADIUS	AREA IN SQUARE	NOTES
NUMBER	WIDTH	HEIGHT		HEIGH	$T \mid S$	PACI	'NG	RTE.	MKR.	REQUIRED	GROUND	BORDER	NADIOS	FEET	
G20-2	48" 36"	24" 18"	END ROAD WORK	CON	T DIM FORM HWAY	TO ":	STAI	NDARI		3 4	ORANGE	BLACK		8.00 (24) 4.50 (18)	
RI-2	48"	48"	Y I E L D							/	RED	WHITE		6.93 (6.93)	
R3-7L	30"	<i>30</i> "	LEFT LANE MUST TURN LEFT							2	ORANGE	BLACK		6 . 25 (12 . 5)	
W3-2	48"	48"								/	ORANGE	BLACK		16.00 (16)	
W4-IL (LEFT)	48"	48"								/	ORANGE	BLACK		16.00 (16)	
W9-2R	<i>36</i> "	36"	LANE ENDS MERGE RIGHT							/	ORANGE	BLACK		9.00 (9)	
W20-I (AHEAD)	48" 36"	48" 36"	ROAD WORK AHEAD							4 4	ORANGE	BLACK		16.00 (64) 9.00 (36)	
W2I-5	36"	<i>36</i> "	SHOULDER			T7		7	7	1	ORANGE	BLACK		9.00 (9)	

IDENTIFI-		OF OF	TEVT		1	(INCHES)	NUMBER OF	COL		BORDER	AREA IN	NOTES
CATION NUMBER		GN HEIGHT	TEXT	LETTER HEIGHT	VERTICAL SPACING	RTE. MKR.	SIGNS REQUIRED	BACK- GROUND	LEGEND BORDER	RADIUS	SQUARE FEET	NOTES
W24-IL	36"	36"		TEXT DIMENSIONS SHALL CONFORM TO "STANDARD HIGHWAY SIGNS" - 2009		/	ORANGE	BLACK		9 . 00 (9)		
W24-IR	36"	<i>36</i> "	5	V	V		,	ORANGE	BLACK		9 . 00 (9)	

W20-I (AHEAD) NOTE: W20-I (AHEAD) NOTE: W20-I (AHEAD) NOTE: W20-I (AHEAD) W20-I (AHEAD) W20-I (AHEAD) W20-I (AHEAD) W20-I (AHEAD) NOTE: NOTE: NOTE: W20-I (AHEAD) NOTE: NOTE: W20-I (AHEAD) NOTE: NOT

GENERAL MAINTENANCE OF TRAFFIC NOTES:

- I. ALL PAVEMENT STRIPING & SIGNING SHALL BE IN ACCORDANCE WITH THE "MANUAL ON UNIFORM TRAFFIC CONTROL DEVICES", U.S.D.O.T., F.H.W.A., LATEST EDITION. NOTE THERE IS A 2009 EDITION OF MUTCD.
- 2. THESE PLANS SHOW THE GENERAL CONDITION FOR TRAFFIC CONTROL. DURING CONSTRUCTION, SLIGHT MODIFICATIONS IN CONSTRUCTION PROCEDURE MAY OCCUR AND MAY REQUIRE SOME MINOR ADJUSTMENTS TO BE MADE IN THE FIELD. ALL PROCEDURES MUST BE APPROVED BY THE RESIDENT.
- 3. THE CONTRACTOR SHALL REMOVE ALL PAVEMENT MARKINGS THAT CONFLICT WITH PROPOSED PAVEMENT MARKINGS IN ACCORDANCE WITH THE SPECIFICATIONS AND MUTCD. PAYMENT SHALL BE MADE UNDER ITEM 627.77 REMOVING PAVEMENT MARKINGS.
- 4. YIELD SIGN SHALL BE A MINIMUM OF 5' ABOVE THE PAVEMENT.
- 5. EXPOSED BARRIER ENDS SHALL BE PROTECTED BY A WORK ZONE CRASH CUSHION. PAYMENT WILL BE UNDER ITEM 527.342 WORK ZONE CRASH CUSHION TL-2.
- 6. DO NOT DAMAGE PAVEMENT. THE CONTRACTOR SHALL BE RESPONSIBLE FOR REPAIRING ANY DAMAGE DONE TO THE EXISTING PAVEMENT SURFACE AS A RESULT OF CONSTRUCTION.

ABBREVIATIONS FOR ALL M.O.T. PLANS:

BWLL = BROKEN WHITE LANE LINE SWEL = SOLID WHITE EDGE LINE SYEL = SOLID YELLOW EDGE LINE

DYCL = DOUBLE YELLOW CENTER LINE

TBWLL = TEMPORARY BROKEN WHITE LANE LINE TSWEL = TEMORARY SOLID WHITE EDGE LINE

TSYEL = TEMPORARY SOLID YELLOW EDGE LINE

SHOULDER CLOSURE

ESTABLISHED WORK ZONE.

MOT	Scal	e:			Designed b	y:				
TA\007_		NOT TO SCALE			T-Y	'LII	V INTE	ERNATI	ON	AL
SMV.	No.	Revision	Ву	Date						
: G					CONSULTANT	PROJEC	T MANAGER:	Kevin Ducharm	e	
ilename:						Ву	Date		Ву	Date
llen	·				Designed	TWA	3/2019	Checked	KSD	3/2019
╙┃					Drawn	TWA	3/2019	In Charge of	KSD	3/2019

T.Y. Lin International
12 Northbrook Drive
Building A, Suite One
Falmouth, Maine 04105
TEL: (207) 781-4721
FAX: (207) 781-4753



THE GOLD STAR MEMORIAL HIGHWAY ROUTE 109 IMPROVEMENTS


MAINTENANCE OF TRAFFIC SIGN SUMMARY


SHEET NUMBER:

CONTRACT:2019.07


LI MONDLIN


9.07 5 OF 12

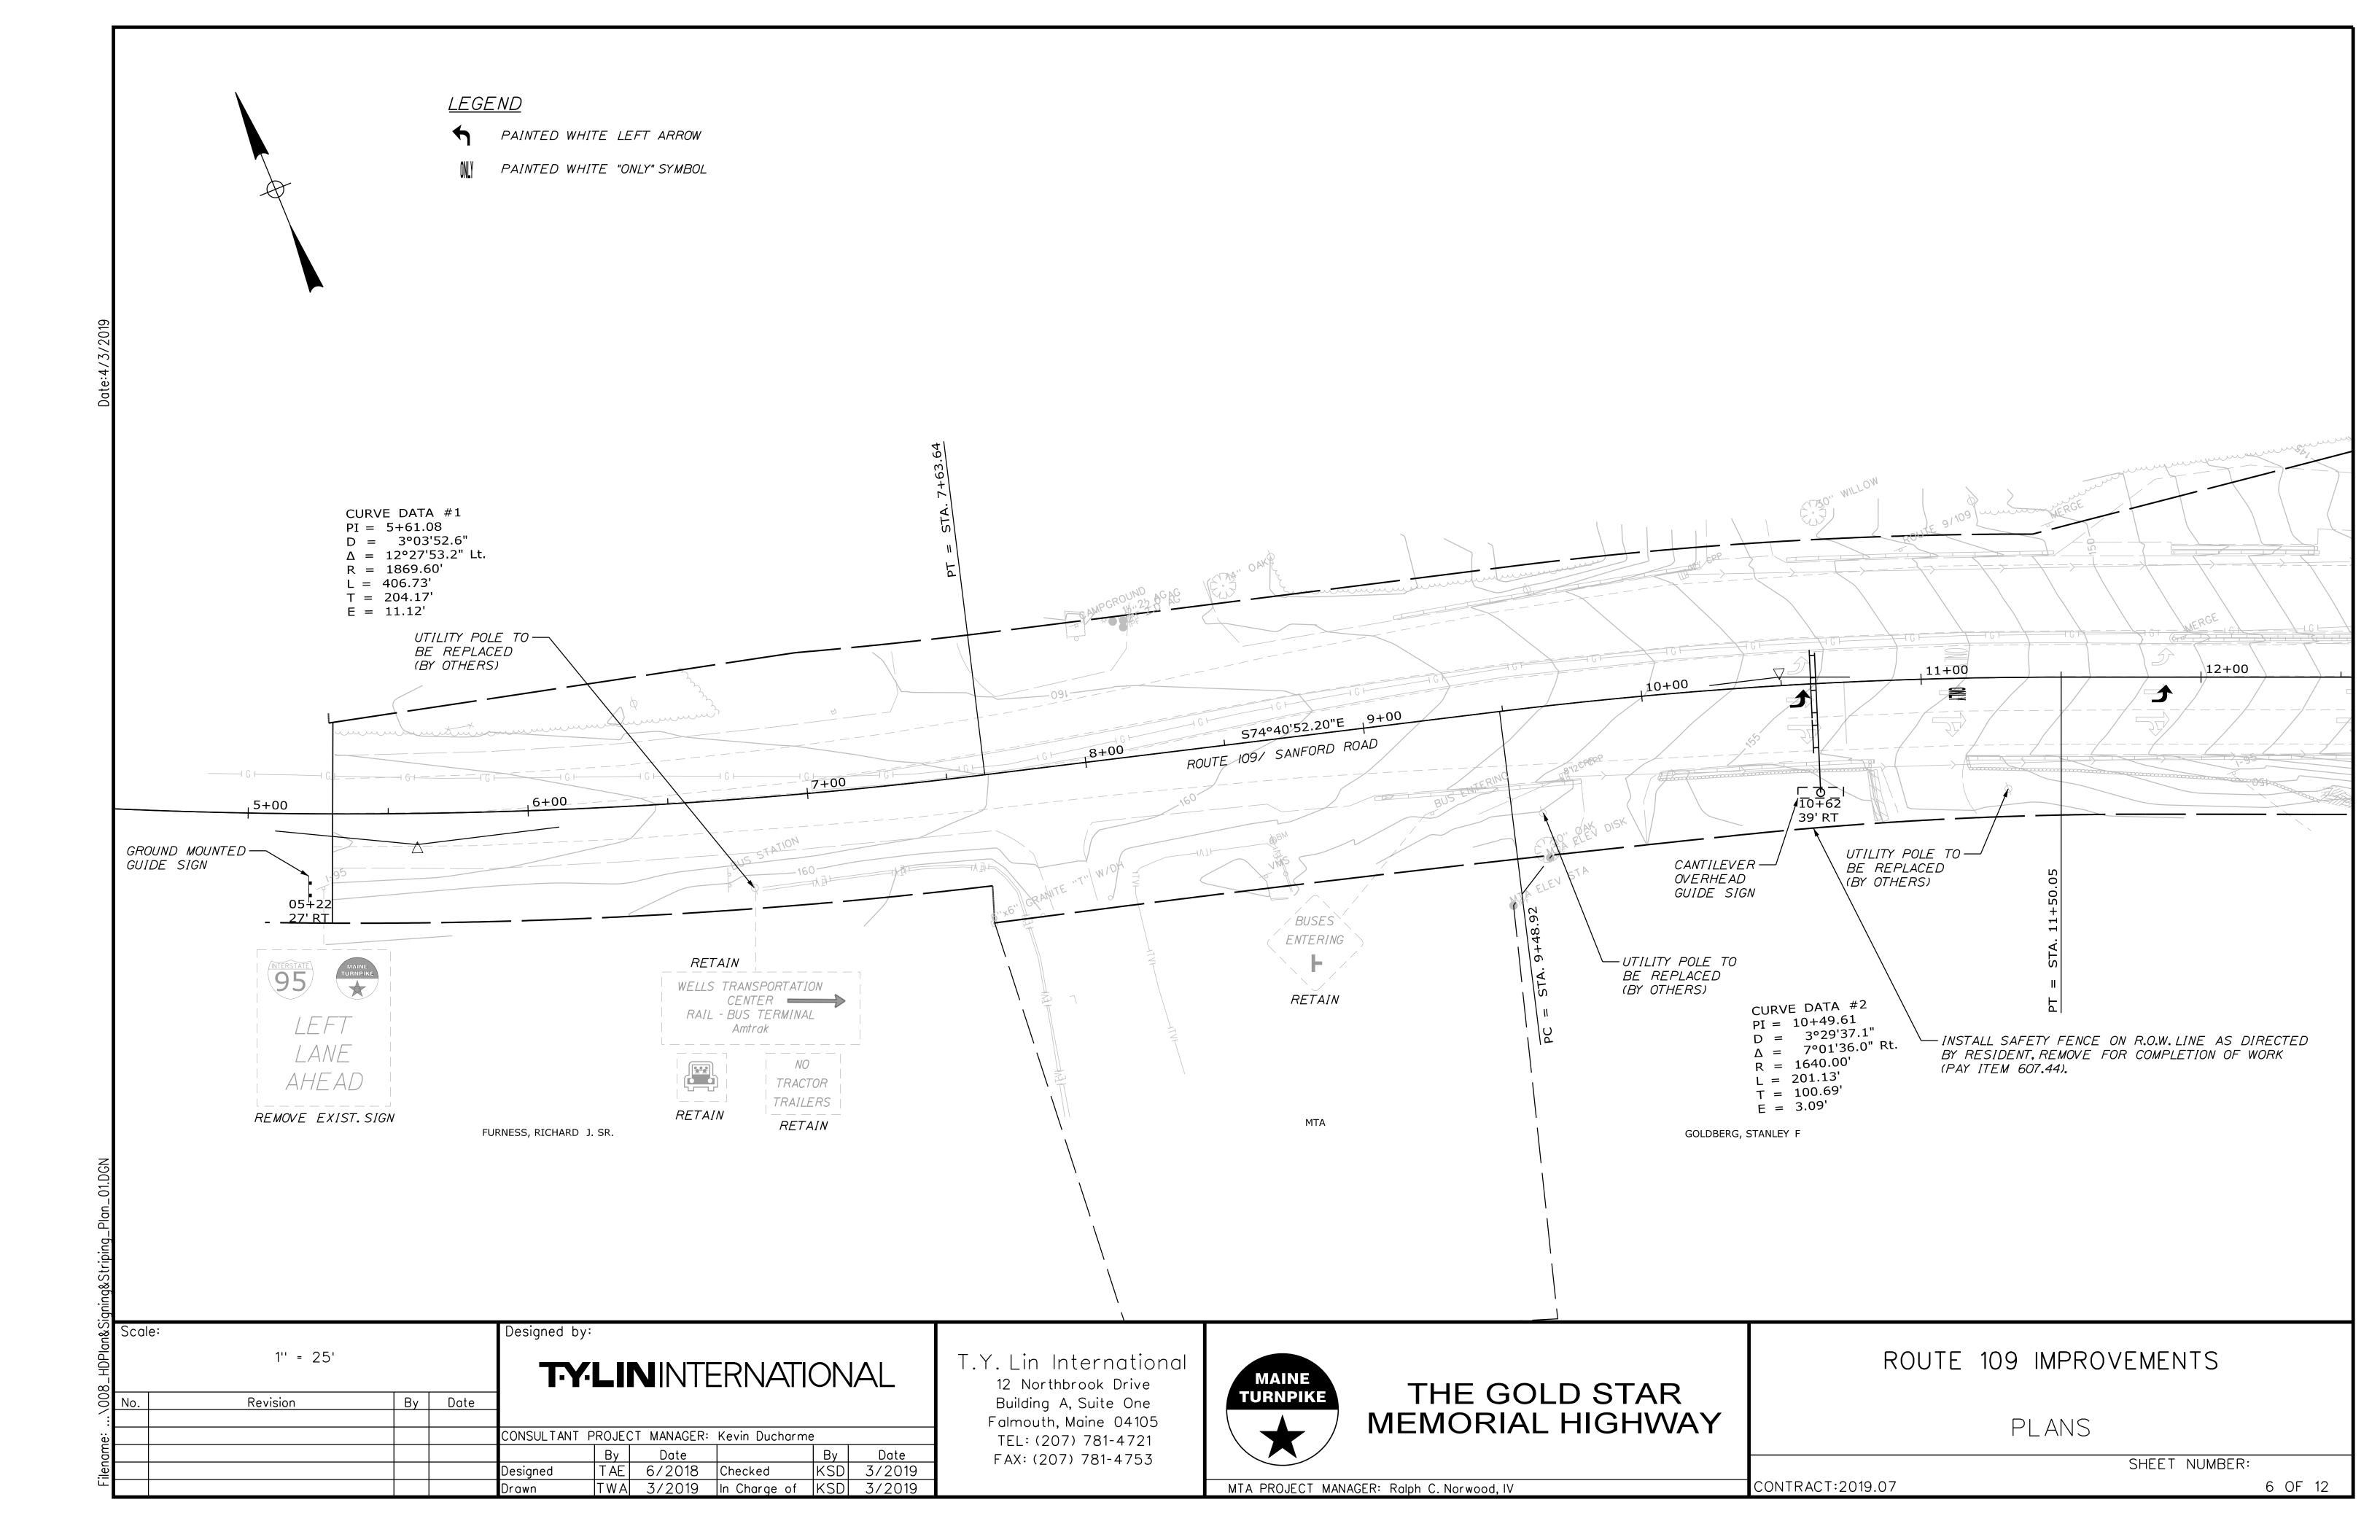

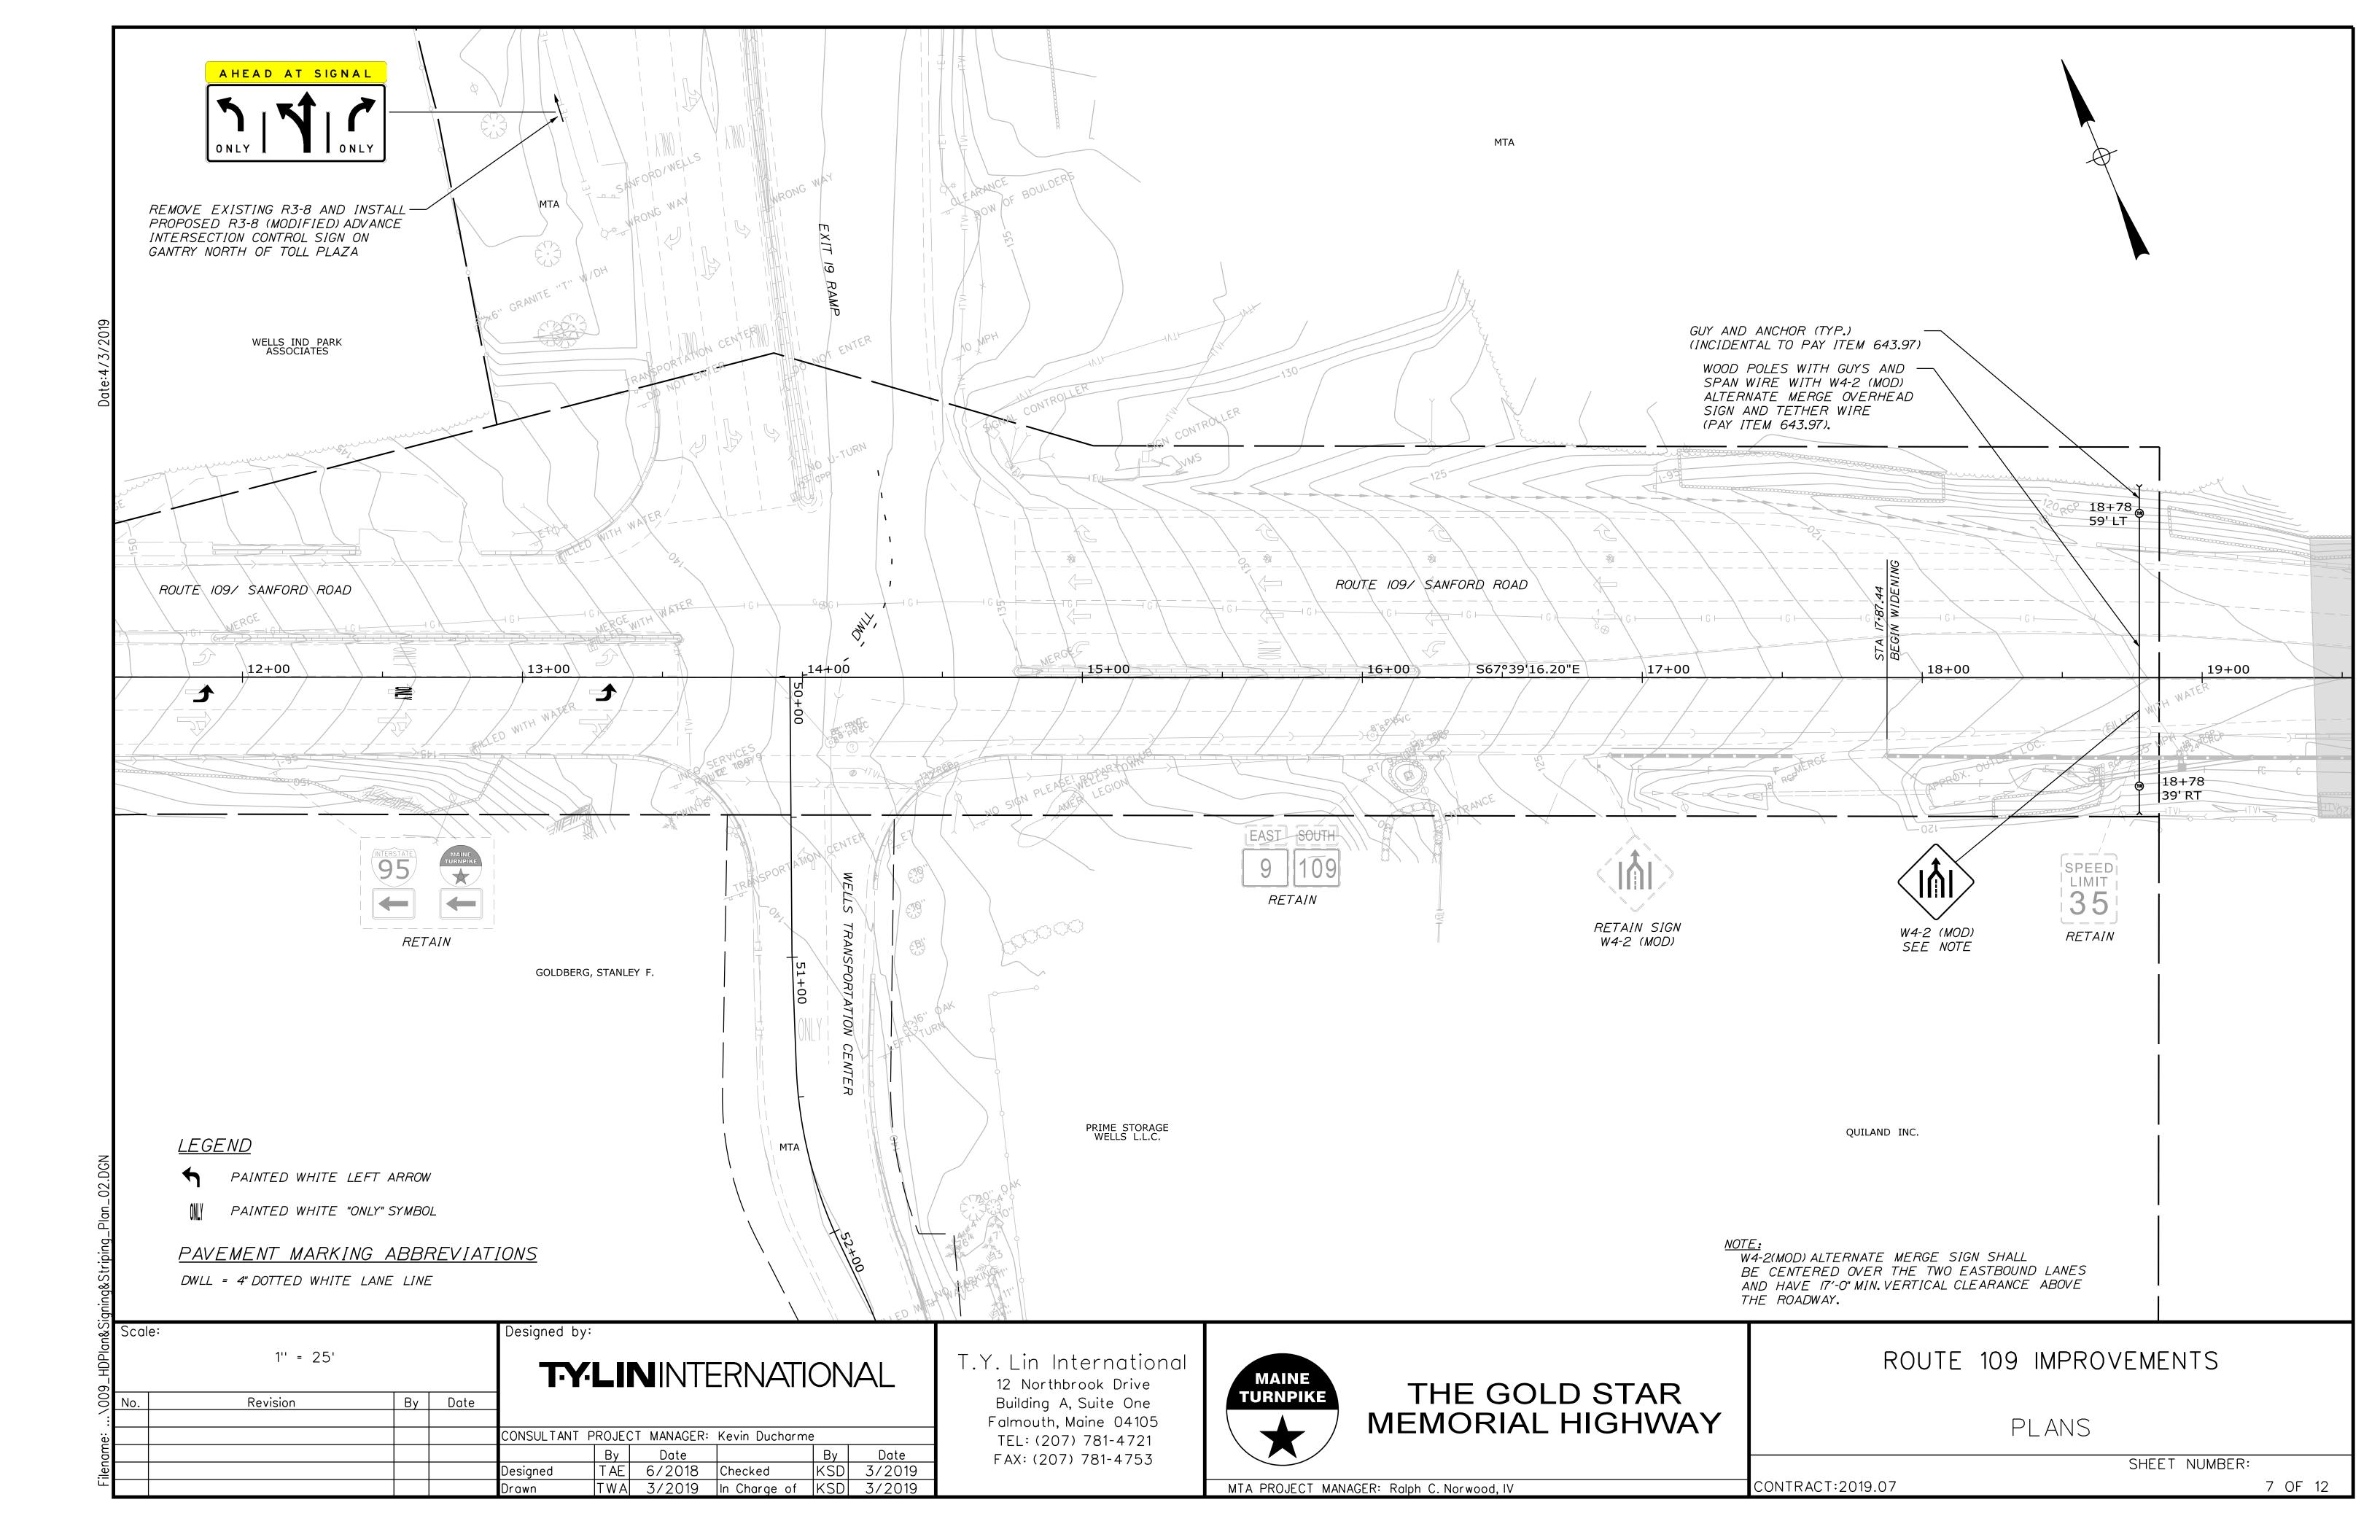

CANTILEVER OVERHEAD SIGN FOUNDATION NOTES 1. THE CONCRETE FOUNDATION FOR THE CANTILEVER OVERHEAD SIGN SHALL Boring No.: HB-WELLS-101 PROJECT: OHSS on Route 109 (Sanford Road) BE IN ACCORDANCE WITH MAINEDOT SPECIFICATION 626.034 AS REVISED MeTPK Wells Interchange (Exit 19) Proj. No.: 18-015 BY SPECIAL PROVISION 645. OCATION: Wells, Maine New England Boring Contractors | Elevation (ft.) 154 ft (est'd) Core Barrel: NQ2 Schaefer/ Titus Sampler: standard split-spoon 2. IF A SINGLE DRILLED SHAFT FOUNDATION IS PROPOSED. SIZING OF THE Mobile Drill B-53 (truck #B-24) Hammer Wt./Fall: 140 lbs / 30 inches Logged By: Schonewald Ria Type: DRILLED SHAFT FOUNDATION SHALL BE BASED ON STANDARD DETAILS Date Start/Finish: 10/2/18 0955-1225 Drilling Method: cased wash boring Hammer Type: auto hammer 626(03) AND 626(04) WITH CHARTS P32-1 THROUGH 3 (SOILS WITH PHI = 32 SUMMARY OF SUBSURFACE PROBE INFORMATION Boring Location: Station 10+70, 24 ft RT Casing ID/OD: NW (3") to 8.2 ft Hammer Efficiency: 0.938 DEG.) USING ACTUAL LOADS (BENDING MOMENT AND TORSION) THAT WILL BE Auger ID/OD: SSA to 5 ft Water Level*: none observed **GROUND MOUNTED GUIDE SIGN SUPPORTS** IMPARTED TO THE FOUNDATION ELEMENT BY THE SIGN SUPERSTRUCTURE. WOH = weight of 140lb. hammer WOR = weight of rods I-uncorrected = N value AASHTO / USCS soil classifications #200 = percent fines WC = water content (%) **ROUTE 109 (SANFORD RD) AT MeTPK EXIT 19 - WELLS** = Thin Wall Tube Sample ammer efficiency = calculated hammer efficiency -- = not recorded CONSOL= 1-D consolidation test BOREHOLE ADVANCEMENT METHODS: UU=Unconsolidated undrained triaxial test Unsuccessful Thin Wall Tube Sample attempt S_u = Insitu Field Vane Shear Strength (psf) 3. IF ROCK IS ENCOUNTERED ABOVE THE REQUIRED BOTTOM OF THE DRILLED SA/HSA=solid/hollow stem auger LL=Liquid Limit / PL=Plastic Limit / Pl=Plasticity Index C=roller cone/OPEN/PUSH=hydraulic push UCT qp = peak compressive strength of rock WELLS, MAINE Unsuccessful Insitu Vane Shear Test attem SHAFT, THE CONTRACTOR SHALL SUBMIT A SITE-SPECIFIC DETAIL FOR DOWELING THE DRILLED SHAFT TO THE ROCK THAT IS SUFFICIENT TO RESIST THE ACTUAL BENDING MOMENT AND TORSION. THE DOWELING Visual Description and Remarks **GROUNDWATER** EXPLORATION | APPROXIMATE LOCATION | PREDOMINANT SOIL | BOTTOM DEPTH **EXPLORATION** BOTTOM DESIGN SHALL BE PREPARED AND SEALED BY A PROFESSIONAL ENGINEER CONDITION NUMBER **TYPE** STATION OFFSET TYPE (ft. BGS) (1) (ft. BGS) LICENSED IN THE STATE OF MAINE. DOWELING TO ROCK WILL BE INCIDENTAL TO THE SIGN COST. HB-WELLS-102 5+22 21' RT sand and gravel fill 4.1 auger refusal none observed probe HB-WELLS-102A 5+27 21' RT 9.0 auger refusal probe sand and gravel fill none observed 1D: Brown, dry to damp, dense, Gravelly fine to coarse 4. IF AN ALTERNATE FOUNDATION SYSTEM IS PROPOSED, IT SHALL BE 23-25-22-14 SAND, little Silt with chunks of weathered asphalt to 2.5 DESIGNED AND SEALED BY A PROFESSIONAL ENGINEER LICENSED IN THE HB-WELLS-102B 22' RT 3.6 5+18 probe sand and gravel fill auger refusal none observed STATE OF MAINE IN ACCORDANCE WITH MAINEDOT SPECIFICATION 626.034 AS REVISED BY SPECIAL PROVISION 645 AND WITH THE FOLLOWING NOTE: (1) BGS = BELOW GROUND SURFACE ADDITIONAL REQUIREMENTS: A. SHALLOW SPREAD FOOTINGS SHALL BEAR ON A 1-FOOT THICK LAYER OF COMPACTED BEDDING MATERIAL CONFORMING TO MAINEDOT STANDARD SPECIFICATION 703.19 GRANULAR BORROW MATERIAL FOR UNDERWATER D: Brown, damp, m. dense, fine to coarse Sandy BACKFILL THAT IS PLACED ON PREPARED SUBGRADE. THE BOTTOM OF THE GRAVEL, trace to little Silt. 8-10-10-11 FOOTINGS SHALL BE FOUNDED AT LEAST 5 FEET BELOW THE LOWEST SURROUNDING FINAL GRADE FOR FROST PROTECTION. REGARDLESS OF THE CALCULATED FACTORED BEARING PRESSURES, THE FOOTINGS SHALL NOT BE .1 ft: Casing fetches up; roller cone ahead. LESS THAN 4 FEET SQUARE. THE DESIGNER SHALL SELECT APPROPRIATE RESISTANCE FACTORS, AS WELL AS SITE-SPECIFIC VALUES FOR BEARING 8.0 ft; Casing refusal; roller cone to refusal at 8.2 ft. CAPACITY, MODULUS OF SUBGRADE REACTION, AND INTERFACE FRICTION 1: Hard, typically fresh, aphanitic to fine grained, dark ANGLE. USE OF PRESUMPTIVE BEARING CAPACITIES SHALL NOT BE grey HORNFELS with occasional quartz inclusions. Close, typically low angle, sometimes blocky breaks; ALLOWED. SURFACE WATER AND GROUNDWATER SHALL BE CONTROLLED TO undulating, rough, typically discolored, and open with occasional mud infilling. Highly broken and fractured at ALLOW CONSTRUCTION OF SHALLOW SPREAD FOOTING IN THE DRY.FILL 9.7 to 10.5, 11.3 to 11.6, and 11.8 to 12.5 ft. MATERIAL SHOULD BE PLACED IN LOOSE LIFTS NOT TO EXCEED 12 INCHES 1:50/ 2:30/ 2:50/ 4:00/ -- min:sec/ft AND COMPACTED TO 95 PERCENT OF THE MATERIAL'S MAXIMUM DRY VERY POOR ROCK QUALITY DENSITY AS DETERMINED BY AASHTO T-180. B. IF A PAIR OF DRILLED SHAFTS IS PROPOSED TO SUPPORT THE OVERHEAD SIGN, THE DESIGNER SHALL EVALUATE THE REACTIONS AT THE TOP OF Bottom of Exploration at 12.7 feet below ground EACH DRILLED SHAFT THAT ARE IMPARTED BY THE ACTUAL LOADS (AXIAL BENDING MOMENT, AND TORSION) BY USE OF VETTED GROUP DRILLED SHAFT SOFTWARE, SUCH AS GROUP OR FB MULTIPIER. THE DESIGNER SHALL SELECT APPROPRIATE RESISTANCE FACTORS, AS WELL AS SITE-SPECIFIC VALUES FOR GROUNDWATER DEPTH, AND NOMINAL UNIT SIDE RESISTANCE AND TIP RESISTANCE. Water level readings have been made at times and under conditions stated. Groundwater fluctuations may occur due to conditions other than those present at the time measurements were made. **Boring No.:** HB-WELLS-101 11+00 10+00ROUTE 109/ SANFORD ROAD HB-WELLS-101 12.7' 5+00 HB-WELLS-102 4.1' -CANTILEVER OVERHEAD HB-WELLS-102A HB-WELLS-102B GUIDE SIGN *3.6′ 3.6′* MATCH EXSITING -ENTERING STA. 7+50.00 GROUND MOUNTED GUIDE SIGN WELLS TRANSPORTATION RAIL - BUS TERMINAL <u>NOTES</u> <u>LEGEND</u> I. TEST BORINGS WERE COMPLETED BY NEW ENGLAND BORING CONTRACTORS ON OCTOBER 2, 2018 AND WERE OBSERVED AND LOGGED BY SCHONEWALD ENGINEERING TEST BORING OR PROBE ASSOCIATES, INC. AHEAD TRACTOR HB-WELLS-IOI I.D. TRAILERS 2, LOCATIONS OF THE EXPLORATIONS WERE DETERMINED IN THE FIELD BY TAPING FROM DEPTH OF EXPLORATION PROMINENT SITE FEATURES AND SHOULD BE CONSIDERED APPROXIMATE. REMOVE EXIST. SIGN DEPTH OF REFUSAL AND/OR BEDROCK FURNESS, RICHARD J. SR. Scale: Designed by: ROUTE 109 IMPROVEMENTS 1'' = 25' T.Y. Lin International T-Y-LININTERNATIONAL MAINE 12 Northbrook Drive THE GOLD STAR **TURNPIKE** Building A, Suite One By Date Revision GUIDE SIGN FOUNDATIONS WITH BORING Associates, Inc MEMORIAL HIGHWAY Falmouth, Maine 04105 CONSULTANT PROJECT MANAGER: Kevin Ducharme LOCATION PLAN AND SUBSURFACE DATA TEL: (207) 781-4721 Ву Date FAX: (207) 781-4753 SHEET NUMBER: | KSD | 10/2018 | Checked IVS 3/2019 Designed 8 OF 12 CONTRACT:2019.07 MJD| 10/2018 | In Charge of | KSD| 3/2019 MTA PROJECT MANAGER: Ralph C. Norwood, IV

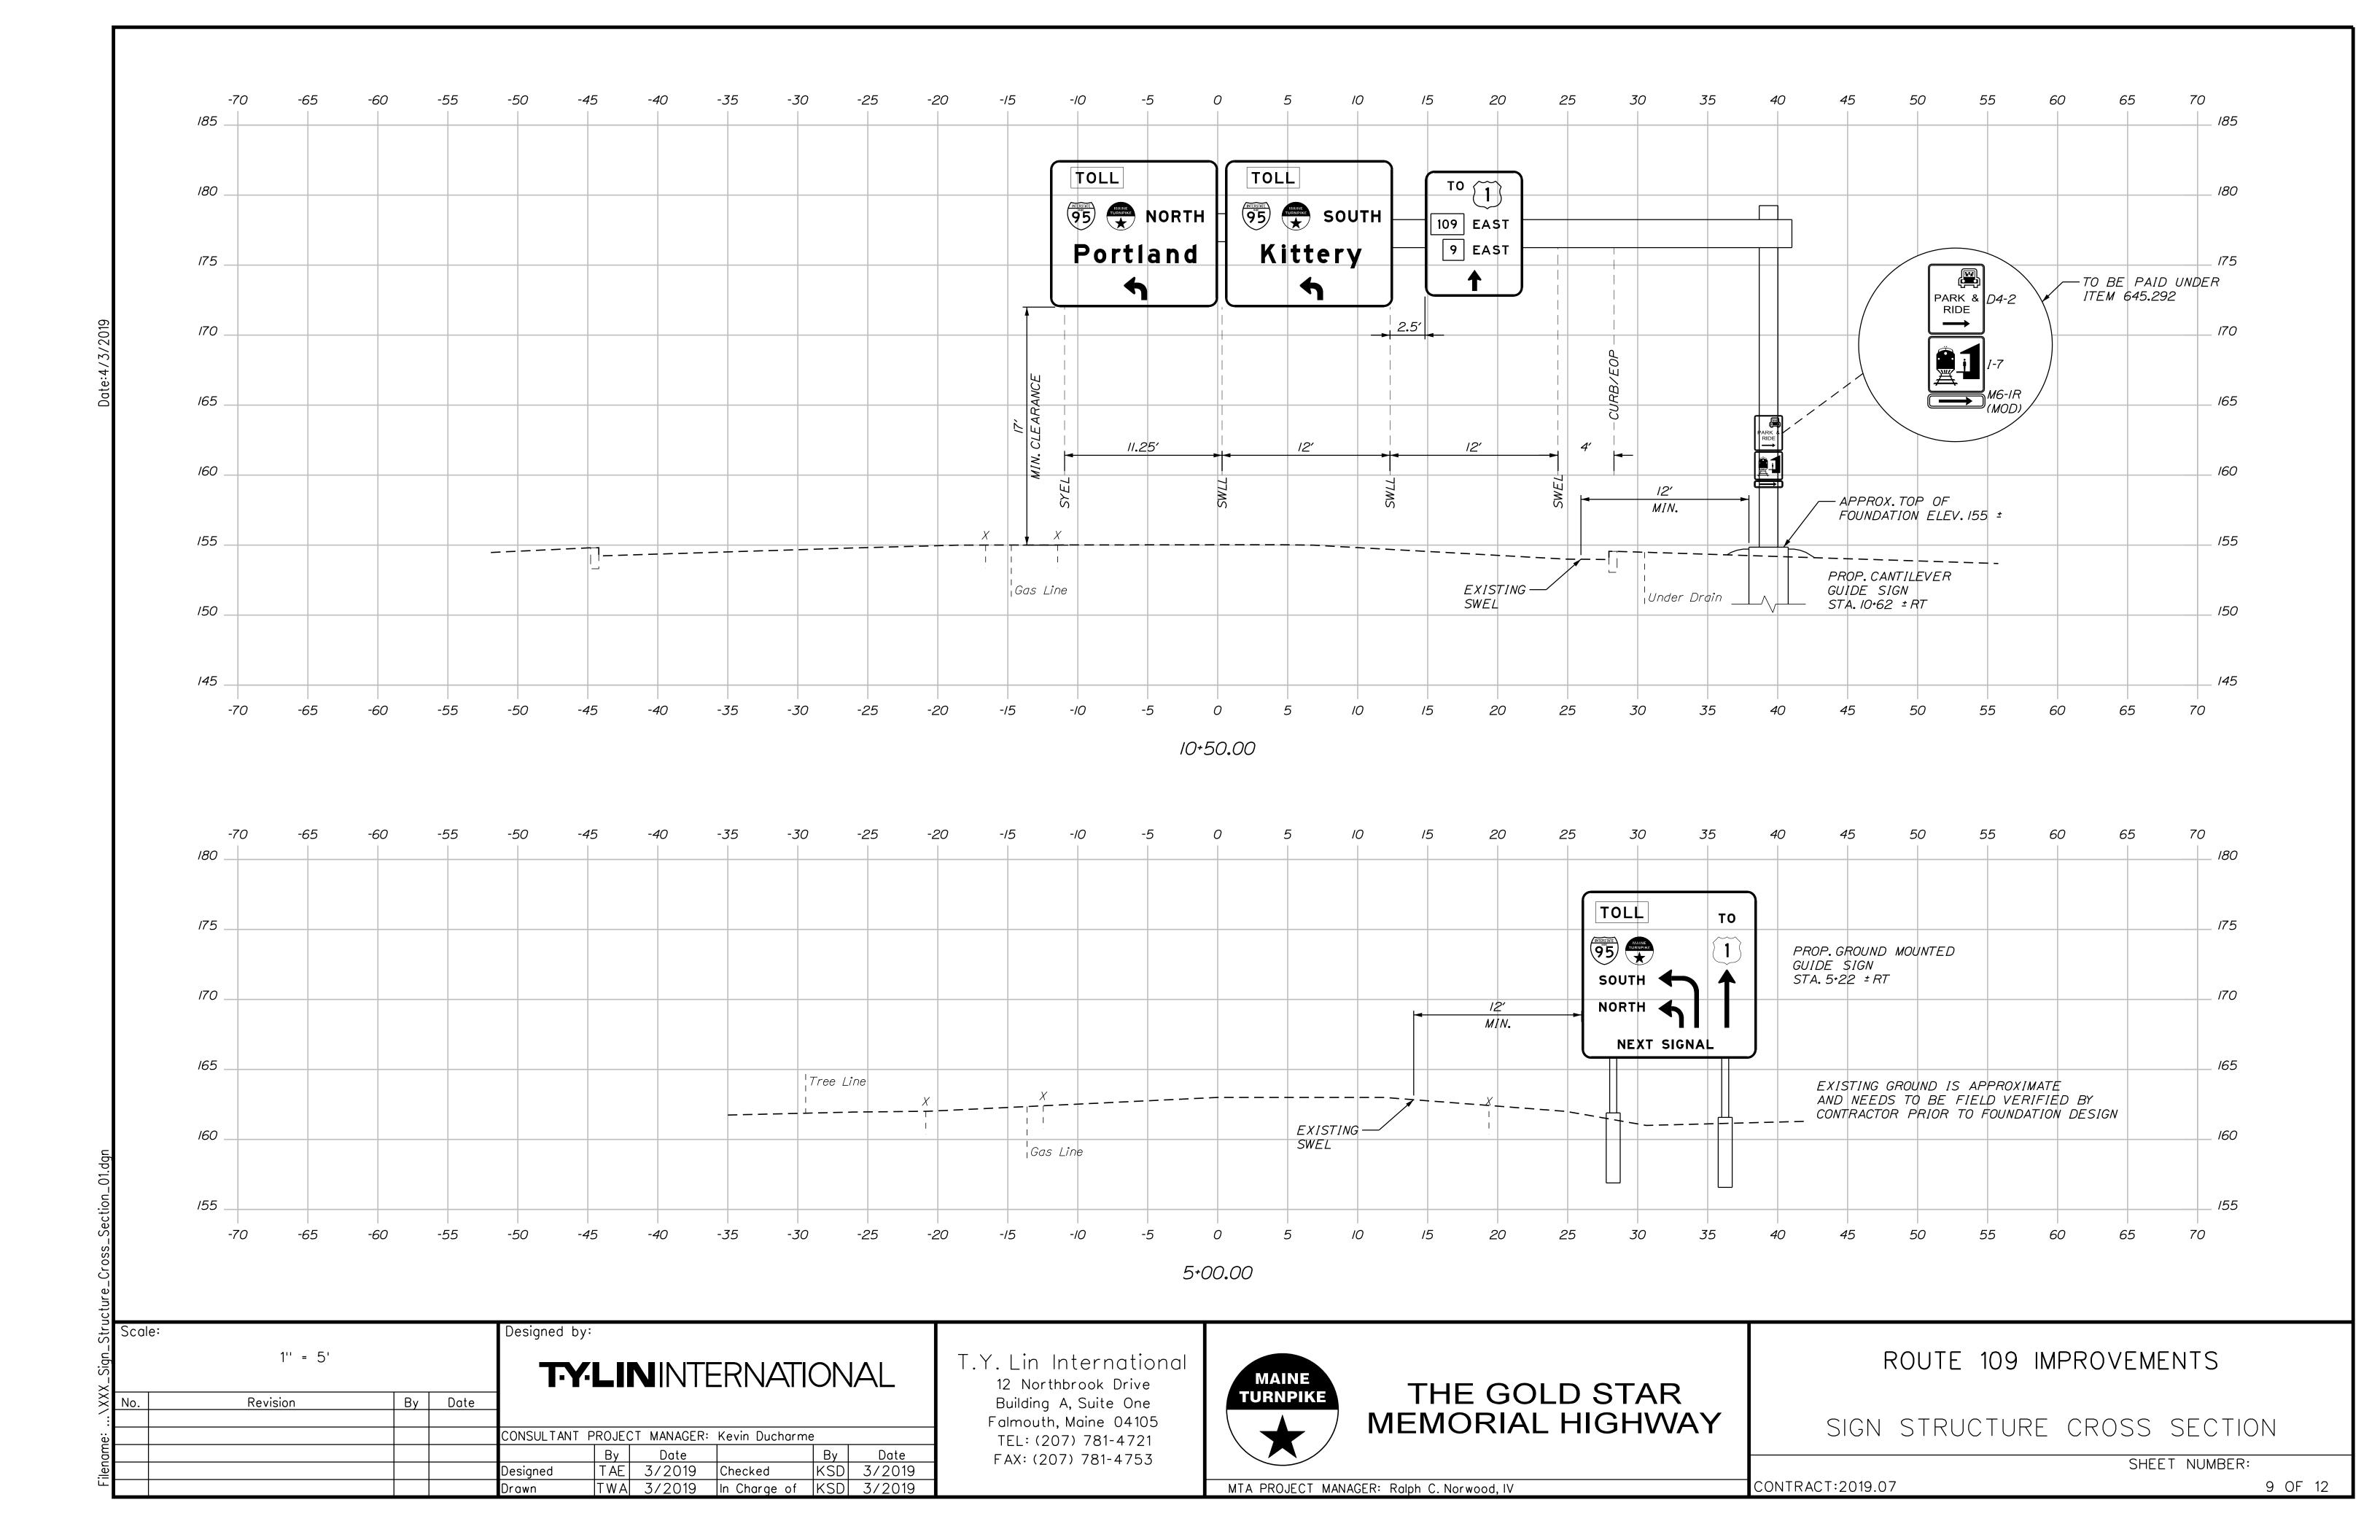

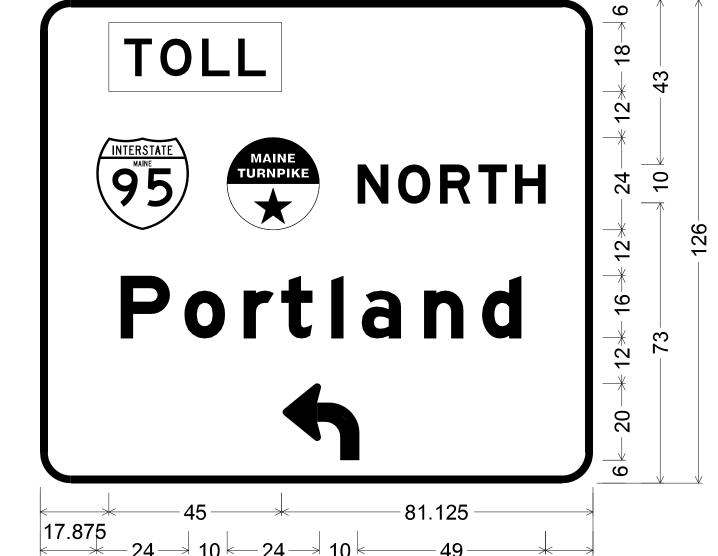

Rectangle Fluorescent yellow;
Rounded Rectangle 12.000" Radius;


[NORTH] E Mod; [Portland] E Mod;


90 Deg Advance Turn Arrow Custom 20.000" X 20.000";

18.75	45	*	80.25	
1175		-24-*12*-		10.75
31-		86		10.75 - 27
<		* 20 *	60	>
		144		

8.000" Radius, 2.000" Border, White on Green;
Rectangle Fluorescent yellow;
Rounded Rectangle 12.000" Radius;
[SOUTH] E Mod; [Kittery] E Mod;
90 Deg Advance Turn Arrow Custom 20.000" X 20.000";

IDENTIFI-	SIZE	OF		TEX	(T DI	MENS	ONS	(INCH	(ES)	NUMBER	COL	.OR	000000	AREA IN	
CATION NUMBER		GN HE IGHT	TEXT	LET HE I		VER7 SPA	ICAL CING	ARI RTE.	ROW MKR.	OF SIGNS REQUIRED	BACK- GROUND	LEGEND BORDER	BORDER RADIUS	SQUARE FEET	NOTES
D4-2	24"	30"	PARK & RIDE	CC	NFOR	DIMENS RM TO NY SIG	"STA	NDAR		/	GREEN	WHITE		5 . 00 (5)	
I-7	24"	24"								/	GREEN	WHITE		4.00 (4)	
M6-IR (MOD)	24"	6"								1	GREEN	WHITE		1.00 (1)	
R3-5L	30"	36"	ONLY							/	WHITE	BLACK		7.50 (7.5)	
R3-8a (MOD)	60"	48"	AHEAD AT SIGNAL ONLY ONLY							/	YELLOW WHITE	BLACK BLACK		20 . 00 (20)	
W4-2 (MOD)	36"	36"			V	,	7		7	/	YELLOW	BLACK		9 . 00 (9)	

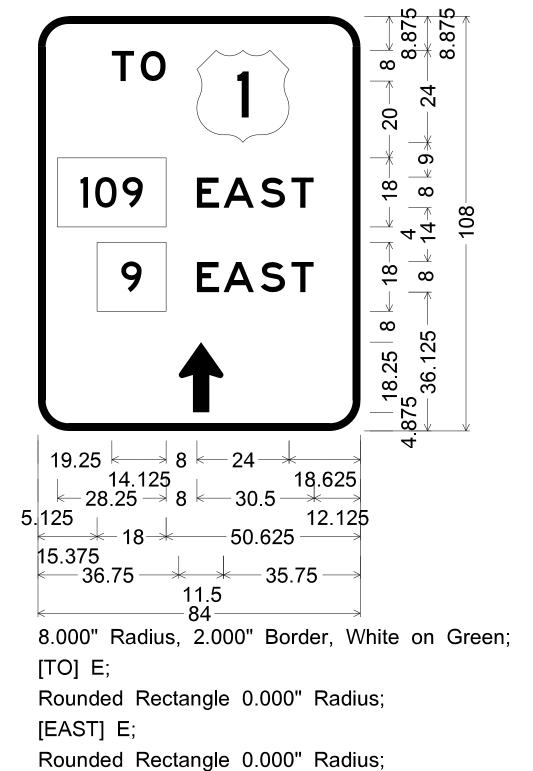

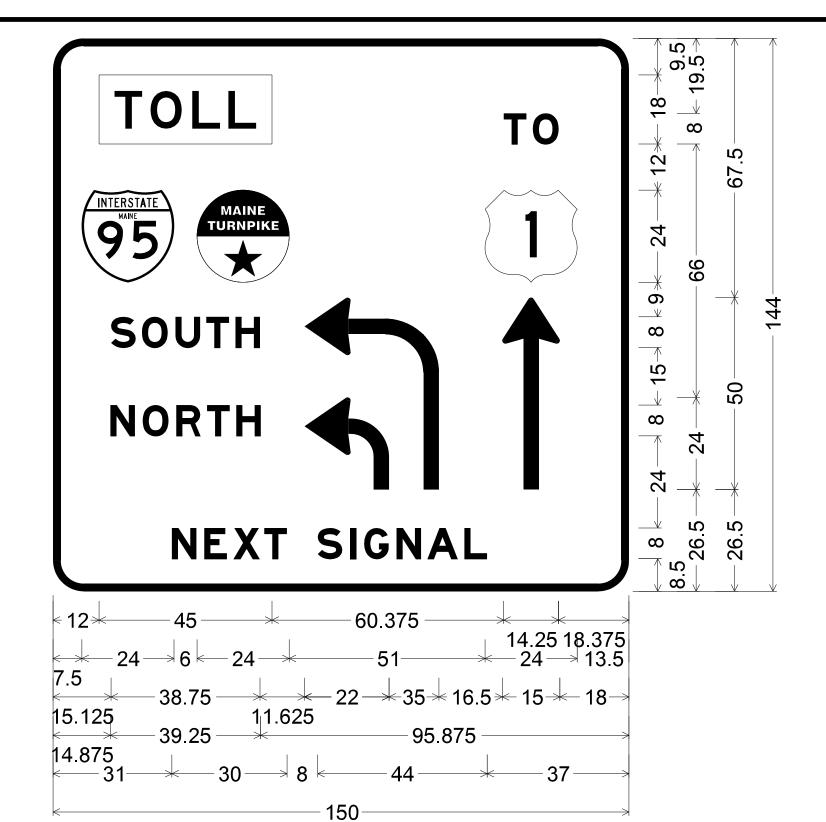

8.000" Radius, 2.000" Border, White on Green;

Rectangle Fluorescent yellow;

[TO] E Mod; Rounded Rectangle 12.000" Radius;

[SOUTH] E Mod; [NORTH] E Mod; [] E Mod;

90 Deg Advance Turn Arrow Custom 22.000" X 24.000";

90 Deg Advance Turn Arrow Custom 35.000" X 50.000";

Arrow Custom - 50.000" 90°; [NEXT SIGNAL] E Mod;

NOTES:

- I. ALL PAVEMENT STRIPING & SIGNING SHALL BE IN ACCORDANCE WITH THE "MANUAL ON UNIFORM TRAFFIC CONTROL DEVICES", U.S.D.O.T., F.H.W.A., LATEST EDITION. NOTE THERE IS A 2009 EDITION OF MUTCD.
- 2. THE CONTRACTOR SHALL REMOVE ALL PAVEMENT MARKINGS THAT CONFLICT WITH PROPOSED PAVEMENT MARKINGS IN ACCORDANCE WITH THE SPECIFICATIONS AND MUTCD. PAYMENT SHALL BE MADE UNDER ITEM 627.77 REMOVING PAVEMENT MARKINGS.


ABBREVIATIONS FOR ALL PLANS:

BWLL = BROKEN WHITE LANE LINE SWEL = SOLID WHITE EDGE LINE SYEL = SOLID YELLOW EDGE LINE DYCL = DOUBLE YELLOW CENTER LINE

DWLL = DOTTED WHITE LANE LINE

Deta	Scale:				Designed b	y:				
X_Sign_	Scale:	NOT TO SCALE			T-Y	/LII	V INTE	ERNATI	ON	AL
\X	No.	Revision	Ву	Date	1					
					CONSULTANT	PROJEC	T MANAGER:	Kevin Ducharm	е	
aB						Ву	Date		Ву	Date
r ilename:					Designed	TWA	3/2019	Checked	KSD	3/2019
_					Drawn	TWA	3/2019	In Charge of	KSD	3/2019

T.Y. Lin International
12 Northbrook Drive
Building A, Suite One
Falmouth, Maine 04105
TEL: (207) 781-4721
FAX: (207) 781-4753

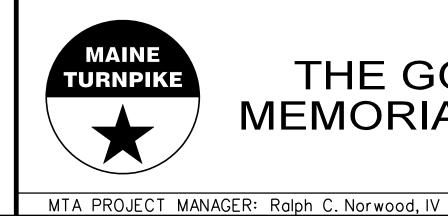

[EAST] E;

THE GOLD STAR
MEMORIAL HIGHWAY

ROUTE 109 IMPROVEMENTS

SIGN DETAILS / SIGN SUMMARY

SHEET NUMBER:

CONTRACT:2019.07

10 OF 12

PHASING DIAGRAM

				131110 D11	<u></u>				
				TIME PERIC	DD .				
	RT. 109 LT.	RT. 109	ROAD NAME	ROAD NAME	RT. 109 LT.	RT 109	EXIT 19	TRANS. CTR.	ROAD NAME
LOCATION	WB	EB	DIR	DIR	EB	WB	SB	NB	DIR
PHASE	/	2	3	4	5	6	7	8	9
MINIMUM INITIAL	5	10	-	-	5	10	5	5	-
PASSAGE TIME	3	3	-	-	3	3	3	3	-
MAXIMUM /*	10	25	-	-	30	25	20	<i>1</i> 5	-
MAXIMUM 2*	10	25	-	-	25	25	30	<i>15</i>	-
YELLOW	4	4	-	-	4	4	4	4	-
ALL RED	2	2	-	-	2	2	2	2	-
PED. WALK	-	-	-	-	-	-	-	-	-
PED. CLEARANCE (FDW)	-	-	-	-	-	-	-	-	-
PED, CLEARANCE (DW)	-	-	-	-	-	-	-	-	-
RECALL	-	SOFT	-	-	-	SOFT	-	-	-
DETECTOR OPERATION	PR	PR	-	-	PR	PR	PR	PR	-
PREEMPTION PRIORITY**	3	4	-	-	4	3	6	5	-
FLASH	Y	Υ	-	-	Y	Υ	R	R	-
DUAL ENTRY	-	-	-	-	-	-	-	-	-
NOTES:		<u> </u>		<u> </u>		<u> </u>		<u> </u>	

(G-)

AI, B3, D3

TAE 3/2019 Checked

TWA 3/2019 In Charge of KSD 3/2019

NOIES: S = SOFT RECALL MAX = MAX RECALL

PR = PRESENCE

Y = YELLOW MAXI = FREE OPERATION R = RED

FDW = FLASHING DON'T WALK DW = DON'T WALK

C-MAX = COORDINATED MAX MAX2 = UNDER COORDINATION D = DARK O = RECALL OFF

* MAX IIS FROM 6AM - IOAM, MAX 2 IS FOR ALL *OTHER TIMES*

** PHASE IS ACTIVATED WHEN PREEMPTION CALL IS RECEIVED.


PHASES 1.5 SHALL NOT BE PERMITTED

GENERAL NOTES:


- I. THE CONTRACTOR SHALL REMOVE ALL CONFLICTING SIGNS, PAYMENT WILL BE INCIDENTAL TO ITEM 643.80 - TRAFFIC SIGNAL MODIFICATIONS. ALL REMOVED EQUIPMENT IS THE PROPERTY OF THE MTA AND SHALL BE STACKED AT THE MTA SIGN SHOP AT MM 58.3.
- 2. THE CONTRACTOR SHALL VERIFY THE LOCATION, DEPTH, AND MATERIAL OF ALL SUBSURFACE UTILITIES.
- 3. ALL TRAFFIC SIGNAL WORK SHALL BE COMPLETED IN A MANNER THAT WILL CAUSE A MINIMUM DISRUPTION TO TRAFFIC.
- 4. EXISTING POWER SUPPLY TO CONTROLLER CABINET SHALL BE REMOVED.

SIGNAL NOTES:


- I. TRAFFIC SIGNAL EQUIPMENT SHALL MEET THE REQUIREMENTS
- POLYCARBONATE HOUSING.
- 4. ALL SIGNAL HEADS SHALL HAVE 5" LOUVERED REFLECTORIZED BACKPLATES.

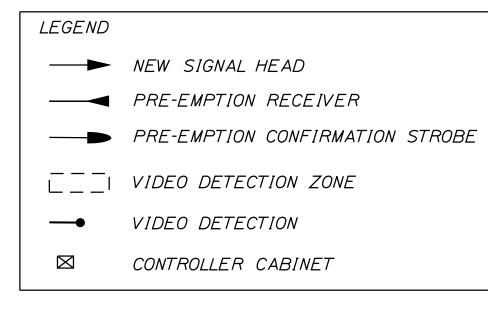


SIGNAL FACE

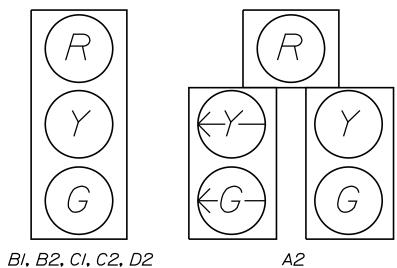

KSD 3/2019

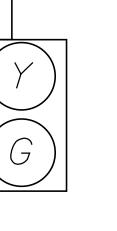

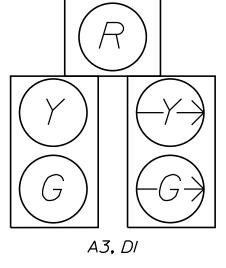

MAINE **TURNPIKE**

THE GOLD STAR MEMORIAL HIGHWAY

INSTALL NEW CONTROLLER - CABINET

ROUTE 109 IMPROVEMENTS

T50+00

ROUTE 109 EASTBOUND

EXISTING SPAN WIRE MOUNTED SIGNS

ONLY

R3-5a

REMOVE

AND DISPOSE

R3-6R

WELLS

CENTER

TRANSPORTATION

51+00

CONTRACT:2019.07

SIGNAL PLAN SHEET NUMBER: 11 OF 12 MTA PROJECT MANAGER: Ralph C. Norwood, IV

ROUTE 109 EASTBOUND

PROPOSED SPAN WIRE MOUNTED SIGNS

ONLY

PROPOSED

RETAIN

ONLY

MAJOR ITEMS REQUIRED

NEW SIGNAL HEAD

OVERHEAD SIGN

EXIT 19 RAMP

VIDEO DETECTION SYSTEM

NEW CONTROLLER CABINET

REMOVE AND DISPOSE OF MISC. SIGNAL EQUIPMENT

NECESSARY DUCT, WIRE & CABLE, LABOR, TOOLS, MISC.

MATERIAL & EQUIPMENT TO COMPLETE THE INSTALLATION

> REMOVE EXISTING CONTROLLER CABINET

"VIDEO DETECTION -

AREA (TYP.)

POWER FROM EXISTING SOURCE

REMOVE AND DISPOSE

NEW OVERHEAD SIGN

QUANTITY

I EACH

I EACH

I EACH

I EACH

I EACH

ITEM

- OF THE MTA SPECIAL PROVISIONS.
- 2. VEHICLE SIGNAL HEAD HOUSING SHALL BE A 12" ALUMINUM OR
- 3. ALL SIGNAL HEADS SHALL BE 12" DIAMETER LED.
- 5. ALL SIGNAL HEADS SHALL BE EQUIPPED WITH TUNNEL VISORS.

6. ALL SIGNAL HEADS SHALL BE NEW.

Designed by: Scale: 1'' = 25' **TY-LIN**INTERNATIONAL Revision By Date CONSULTANT PROJECT MANAGER: Kevin Ducharme Date

Designed

T.Y. Lin International 12 Northbrook Drive Building A, Suite One Falmouth, Maine 04105

TEL: (207) 781-4721

FAX: (207) 781-4753

