FURNPIKE

THE GOLD STAR **MEMORIAL HIGHWAY**

MAINE TURNPIKE AUTHORITY

DANIEL E. WATHEN, CHAIR ROBERT D. STONE, VICE CHAIR MICHAEL J. CIANCHETTE, MEMBER JANE L. LINCOLN, MEMBER ANN R. ROBINSON, MEMBER THOMAS J. ZUKE, MEMBER BRUCE A. VAN NOTE, MEMBER EX-OFFICIO

S. PETER MILLS, EXECUTIVE DIRECTOR

CONTRACT 2022.02 EXIT 36 IMPROVEMENTS AND PAVEMENT REHABILITATION MM 35.5 TO MM 36.2 **EXIT 25 PAVING**

> **CULVERT OUTLET DITCHING** MM 34.9

> > **EXIT 25 PAVING** MM 25.5

EXITS 32 & 42 INTERSECTION MODIFICATIONS MM 31.6 & MM 42.5



SHEET NO. **DESCRIPTION** TITLE SHEET **ESTIMATED QUANTITIES GENERAL NOTES** TYPICAL SECTIONS MAINTENANCE OF TRAFFIC - GENERAL NOTES MAINTENANCE OF TRAFFIC - DETAILS MAINTENANCE OF TRAFFIC - EXIT 36 NORTHBOUND **ACCELERATION LANE** MAINTENANCE OF TRAFFIC - I-195 SHOULDER RECONSTRUCTION MAINTENANCE OF TRAFFIC - LANE CLOSURES AT RAMPS MAINTENANCE OF TRAFFIC - SIGN SUMMARY DRAINAGE DETAILS 21 DRAINAGE PATH FOR MILLING DETAILS STRIPING DETAILS BERM DROPOFF CORRECTION DETAILS **GUARDRAIL DETAILS**

CULVERT OUTLET DITCHING PLAN

LIMIT OF DISTURBANCE PLAN

GOOSEFARE BROOK CULVERT REMOVAL PLAN


EXITS 32 & 42 INTERSECTION MODIFICATION PLANS

INDEX OF SHEETS

HNTB

2022.02

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LIGHTING DETAILS

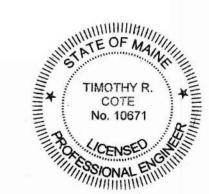GENERAL PLANS

CROSS SECTIONS

EXIT 25 PAVING PLAN

INDEX PLAN

40-41

APPROVED:

MAINE TURNPIKE AUTHORITY

LOCATION MAP

2-23-22

YORK BEACH

2/22/22

MM 25.5

MM 34.9

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	ESTIMATED QUANTITIES					
ITEM NO.	ITEM	UNIT	EXIT 36 QUANTITY	EXIT 25 QUANTITY	EXITS 32&42 QUANTITY	TOTAL QUANTITY
201.11	CLEARING	AC	1			1
202.202	REMOVING PAVEMENT SURFACE	SY	29,700	9900	20	39,620
202,2026	REMOVING PAVEMENT SURFACE - DRAINAGE PATHS	SF	290			290
203 . 20	COMMON EXCAVATION GRANULAR BORROW	CY	3090 1771			3090 1771
203.33	SPECIAL FILL - STREAMBED MATERIAL	CY	8			8
304.10	AGGREGATE SUBBASE COURSE - GRAVEL	CY	560			560
304.14	AGGREGATE BASE COURSE - TYPE A	CY	370			370
403,207	HOT MIX ASPHALT, 19.0 mm NOMINAL MAXIMUM SIZE	TON	440			440
403.2081	HOT MIX ASPHALT, 12.5 mm (POLYMER MODIFIED) - RAP	TON	2650	840		3490
403.211	HOT MIX ASPHALT, 9.5 mm NOMINAL MAXIMUM SIZE (SHIMMING)	TON	50	50		100
403.213	HOT MIX ASPHALT, 12.5 mm NOMINAL MAXIMUM SIZE (BASE AND INTERMEDIATE BASE COURSE)	TON	140			140
409.152	BITUMINOUS TACK COAT NTSS - IHM TRACKLESS - APPLIED	GAL	2050	600		2650
419.30	SAWING BITUMINOUS PAVEMENT	LF	1750			1750
424.323	ASPHALT RUBBER MASTIC CRACK SEALER - APPLIED	LB	3150	990		4140
470.08	BERM DROPOFF CORRECTION - GRINDINGS	TON	310	130		440
470.081	BERM CORRECTION	LF	990			990
511.071	COFFERDAM	LS	1			/
5/5 . 20/	PIGMENTED PROTECTIVE COATING FOR CONCRETE SURFACES	SY	610			610
<i>526.301</i>	TEMPORARY CONCRETE BARRIER TYPE I	LF	1350			1350
527.341	WORK ZONE CRASH CUSHION - TL-3	UNIT	1			1
603.155	12 INCH REINFORCED CONCRETE PIPE - CLASS III	<u>LF</u>	20			20
603.215	36 INCH REINFORCED CONCRETE PIPE - CLASS III	LF	16			16
603.28	CONCRETE COLLAR	EA	4			4
603.7415	REMOVE & RELAY 15" CONCRETE PIPE	LF	8			8
603.7418	REMOVE & RELAY 18" CONCRETE PIPE	LF	8			8
604.18	ADJUSTING MANHOLE OR CATCH BASIN TO GRADE	EA	1			1
604.182	CLEANING EXISTING CATCH BASIN AND MANHOLE	EA	10			10
604.184	REBUILD CATCH BASIN TO GRADE - TYPE II	EA	1			1
604.246	CATCH BASIN TYPE F5	EA	1			1
605.//	IZ INCH UNDERDRAIN TYPE C	<u>LF</u>	IIO			IIO
606.13	31" W-BEAM GUARDRAIL - MID-WAY SPLICE (7' STEEL POSTS, 8" OFFSET BLOCKS, SINGLE FACED)	LF	520			520
606.1307	31" W-BEAM GUARDRAIL - MID-WAY SPLICE FLARED TERMINAL	EA	4			4
606.132	31" W-BEAM GUARDRAIL - MID-WAY SPLICE (7' STEEL POSTS, 8" OFFSET BLOCKS, DOUBLE FACED)	LF	47			47
606.1351	31" W-BEAM GUARDRAIL - MID-WAY SPLICE TERMINAL END - ANCHORED END	EA	8			8
606. <i>1</i> 78	GUARDRAIL BEAM REFLECTORIZED BEAM GUARDRAIL DELINEATOR	LF EA	50 200			50 200
606.356	UNDERDRAIN DELINEATOR POST	EA	41			41
606.3561	DELINEATOR POST - REMOVE AND RESET	EA	20			20
606.362 <i>I</i>	GUARDRAIL ADJUST, SINGLE RAIL GUARDRAIL ADJUST, DOUBLE RAIL	LF LF	6550 240			6550 240
606.3822	SINGLE OFFSET BLOCK - W BEAM	EA	20			20
606.48	SINGLE GALVANIZED STEEL POST	EA	10			10
606.755	MODIFY WIDENED SHOULDER FOR GUARDRAIL TERMINAL	EA	4			4
610.08	PLAIN RIPRAP	CY	670			670
610.181	TEMPORARY STONE CHECK DAM	CY	38			38
610.213	VOID-FILLED RIPRAP - TYPE A OR B	CY	72			72
613.319	EROSION CONTROL BLANKET	SY	1050			1050
6/5.07	LOAM	CY	290			290
618.14	SEEDING METHOD NUMBER 2	UNIT	51			51
619.1201	MULCH - PLAN QUANTITY	UNIT	51			5/
619.1202	TEMPORARY MULCH	LS	1			1
619.1401	EROSION CONTROL MIX	CY	60			60
<i>620.58</i>	EROSION CONTROL GEOTEXTILE	SY	1700			1700

1T[11 ::0	ESTIMATED QUANTITIES	, , , ,	EXIT 36	EXIT 25	EXITS 32&42	TOTAL
ITEM NO.	ITEM	UNIT	QUANTITY		QUANTITY	QUANTI
626.121	QUAZITE JUNCTION BOX (36X24)	EA	7		4	//
626.122	QUAZITE JUNCTION BOX (18XII)	EA	//			//
626.22	NON-METALLIC CONDUIT	LF	4850		950	5800
626.223	HORIZONTAL DIRECTIONAL DRILLED CONDUIT	LF	710			710
626.32	24 INCH DIAMETER FOUNDATION	EA	5		1	6
626.35	CONTROLLER CABINET FOUNDATION	EA			1	1
626.36	REMOVE OR MODIFY CONCRETE FOUNDATION	EA			4	4
626.38	GROUND MOUNTED CABINET FOUNDATION	EA	1			1
626.48	60-INCH DIAMETER FOUNDATION	LF			48	48
627.18	12" SOLID WHITE PAVEMENT MARKING LINE	LF	550			550
627.712	WHITE OR YELLOW PAVEMENT MARKING LINE	LF	25,100	4950		30,050
627.73	TEMPORARY 6 INCH PAVEMENT MARKING TAPE	LF	620	7550		620
627 . 733	4" WHITE OR YELLOW PAVEMENT MARKING LINE	LF	OEO		340	340
627 . 755	WHITE OR YELLOW PAVEMENT & CURB MARKING	SF		420	500	920
021.15	WITTE ON TELEOW TAVEMENT & CONB MANNING	31		420	300	920
627.77	REMOVING EXISTING PAVEMENT MARKING	SF	600		2150	2750
627.78	TEMPORARY PAVEMENT MARKING LINE, WHITE OR YELLOW	LF	27,400	4950		32,350
627.812	TEMPORARY RAISED PAVEMENT MARKERS	EA	1650	150		1800
627.94	PAVEMENT MARKING TAPE	LF	170			170
627.941	PAVEMENT MARKING TAPE - DOTTED WHITE LANE LINE, 6-INCH WIDTH	LF	240			240
627.944	PAVEMENT MARKINGS - RECESSED TAPE - WORDS, ARROWS, STOP BARS	SF			60	60
	WAND LADOD CEDAROUT THE	,	00			
629.05	HAND LABOR, STRAIGHT TIME	HR	20			20
631 . 12	ALL PURPOSE EXCAVATOR (INCLUDING OPERATOR)	HR	10			10
631.133	SKID STEER (INCLUDING OPERATOR)	HR	20			20
631 . 172	TRUCK - LARGE (INCLUDING OPERATOR)	HR	20			20
631.22	FRONT END LOADER (INCLUDING OPERATOR)	HR	10			10
631.32	CULVERT CLEANER (INCLUDING OPERATOR)	HR	20			20
631.36	FOREMAN	HR	20			20
<i>631.53</i>	ELECTRICIAN	HR	20			20
634.1612	HIGHWAY LIGHTING PANEL AND SERVICE UPGRADES	LS	1			1
<i>634.2312</i>	CONVENTIONAL LIGHT STANDARD WITH LED FIXTURE - SUPPLIED BY THE AUTHORITY	EA	5			5
<i>643.</i> 71	TRAFFIC SIGNAL MODIFICATION AT: EXIT 32 AND ROUTE III	LS			1	/
643.9111	RESET EXISTING MAST ARM POLES: MA4 - Exit 32	LS			1	1
643.9112	RESET EXISTING MAST ARM POLES: MA3 - Exit 32	LS			1	1
643.9113	RESET EXISTING MAST ARM POLES: EXIT 42	LS			1	1
643.92	PEDESTAL POLE	EA			1	1
645.105	REMOVE AND STACK SIGN	EA			5	5
645.109	REMOVE AND RESET SIGN	EA			3	3
645.271	REGULATORY, WARNING, CONFIRMATION AND ROUTE ASSEMBLY SIGN, TYPE I	SF	7		35	42
<i>652.30</i>	FLASHING ARROW	EA	4			4
652 . 312	TYPE III BARRICADES	EA	4	2		6
652.33	DRUM	EA	310	_	60	370
652 . 34	CONE	EA	65	40	60	165
		SF		270		
652 . 35 652 . 361	CONSTRUCTION SIGNS MAINTENANCE OF TRAFFIC CONTROL DEVICES	LS	2680 0 . 91	0.04	190 0.05	3140 1
652 . 38	FLAGGERS	HR		190	/50	340
652 . 381	TRAFFIC OFFICERS	HR			33	33
652 . 41	PORTABLE-CHANGEABLE MESSAGE SIGN	EA	10			10
652 . 45			82		ı	83
	TRUCK MOUNTED ATTENUATOR	CD				
652 .4 52 652 .4 7	AUTOMATED TRAILER MOUNTED SPEED LIMIT SIGN SEQUENTIAL FLASHING WARNING LIGHTS	EA EA	30			<i>2</i> <i>30</i>
656.50	BALED HAY, IN-PLACE	EA	50			50
656 . 60	TEMPORARY BERMS	LF	1850			1850
CEC CO	TEMPORARY SLOPE DRAINS	LF	100			100
656 . 62						Γ
656.632	30" TEMPORARY SILT FENCE	LF	4720			4720

NNS7	Scale:				Designed by:					
IGHWAY		NOT TO SCALE	-			(Sta	antec		
\ <i>00\H</i>	No.	Revision	Ву	Date		`				
:					CONSULTANT F	PROJEC	CT MANAGER:	JOSEPH HOWE,	P.E.	
те						Ву	Date		Ву	Date
ilenc					Designed	THG	10\21	Checked	JRH	10\21
Fil					Drawn	CHL	10\21	In Charge of	JRH	10\21

STANTEC CONSULTING SERVICES INC. 2211 CONGRESS STREET SUITE 380 PORTLAND, ME 04102 TEL (207) 887-3448 FAX (207) 883-3376



THE GOLD STAR MEMORIAL HIGHWAY

EXIT 36 IMPROVEMENTS AND PAVEMENT REHABILITATION

ESTIMATED QUANTITIES

SHEET NUMBER: EQ-01

MTA PROJECT MANAGER: RALPH NORWOOD, IV, PE, PTOE

CONTRACT:2022.02

GENERAL NOTES:

- I. ALL WORK SHALL CONFORM TO THE 2014 MAINE DEPARTMENT OF TRANSPORTATION STANDARD SPECIFICATIONS FOR HIGHWAY AND BRIDGES, EXCEPT AS MODIFIED BY THE MAINE TURNPIKE AUTHORITY'S SUPPLEMENTAL SPECIFICATIONS AND SPECIAL PROVISIONS.
- 2. ALL STANDARD DETAILS SHALL BE IN CONFORMANCE WITH MAINE DEPARTMENT OF TRANSPORTATION (MAINE DOT) STANDARD DETAILS HIGHWAY AND BRIDGES LATEST REVISIONS AND MAINE DOT BEST MANAGMENT PRACTICES FOR EROSION AND SEDIMENT CONTROL LATEST REVISION UNLESS OTHERWISE INCLUDED IN THESE PLANS.
- 3. THE CONTRACTOR SHALL SUBMIT THEIR PROPOSED STAGING AREA(S) TO THE RESIDENT FOR APPROVAL PRIOR TO STARTING WORK.
- 4. AT THE CONTRACTOR'S OPTION. THE WORK AT EXIT 32 MAY BE LAID OUT RELATIVE TO EXISTING FEATURES IN LIEU OF FULL SURVEY AND SHALL BE APPROVED BY THE RESIDENT PRIOR TO THE START OF ANY CONSTRUCTION.
- 5. CONCRETE FOUNDATIONS NOT FULLY REMOVED SHALL BE MODIFIED SO THAT THE TOP OF THE REMAINING PORTION OF THE FOUNDATION IS A MINIMUM OF 2 FEET BELOW FINISHED GRADE, FINAL ELEVATION TO BE APPROVED BY THE RESIDENT PRIOR TO THE MODIFIED FOUNDATION BEING COVERED.
- 6. THE CONTRACTOR SHALL NOT RUN MILLING MACHINES, PAVERS, ROLLERS, OR OTHER HEAVY EQUIPMENT OVER THE TOLL SLABS.
- 7. AT THE CONTRACTOR'S OPTION, BITUMINOUS TACK COAT NTSS-IHM TACKLESS APPLIED AT EXIT 32 MAY BE SUBSTITUTED WITH BITUMINOUS TACK COAT RS-I OR RSIH - APPLIED.

EARTHWORK

- I. CLEARING LIMITS SHALL BE 10' BEYOND AND PARALLEL TO THE CONSTRUCTION SLOPE LINES AND 5' IN WETLANDS OR AS SHOWN ON THE PLANS UNLESS OTHERWISE AUTHORIZED BY THE RESIDENT, THE ACTUAL CLEARING LINES SHALL BE ESTABLISHED IN THE FIELD BY THE CONTRACTOR AND SHALL BE APPROVED BY THE RESIDENT PRIOR TO ANY CLEARING TAKING PLACE.
- 2. CLEARING AREAS BEYOND THE CONSTRUCTION SLOPE LIMITS AND OUTSIDE OF WETLAND AREAS SHALL BE GRUBBED AND STUMPS REMOVED, GRADED TO DRAIN, AND SEEDED, PAYMENT FOR GRUBBING AND STUMP REMOVAL SHALL BE UNDER ITEM 203.20 - COMMON EXCAVATION.
- 3. CLEARING AREAS BEYOND THE CONSTRUCTION SLOPE LIMITS AND WITHIN WETLANDS SHALL HAVE STUMPS CUT AS CLOSE TO THE GROUND AS PRACTICABLE AND THE EXISTING GROUND SHALL NOT BE UNDULY DISTURBED OR COMPACTED.
- 4. CLEARING IS NOT ALLOWED FROM JUNE IST TO JULY 3IST.
- 5. EXISTING INSLOPES STEEPER THAN 2:1 IN PROPOSED FILL AREAS SHALL BE BENCHED AS SHOWN IN THE DETAILS OR AS DIRECTED BY THE RESIDENT.
- 6. GRUBBING IN FILL AND MUCK EXCAVATION HAVE BEEN SHOWN ON THE CROSS SECTIONS. THESE LIMITS ARE APPROXIMATE AND HAVE BEEN USED FOR QUANTITY ESTIMATION PURPOSES ONLY. ACTUAL LIMITS MAY VARY BASED ON FIELD CONDITIONS AND AS DIRECTED BY THE RESIDENT, GRUBBING DEPTH HAS BEEN ESTIMATED AS 6" IN FIELD AREAS AND 12" IN WOODED AREAS, TOTAL MUCK EXCAVATION DEPTH HAS BEEN ESTIMATED AT 18".
- 7. WASTE MATERIALS SHALL BE DISPOSED OF OFF THE PROJECT SITE, IN ACCORDANCE WITH ALL APPLICABLE LOCAL. STATE AND FEDERAL ENVIRONMENTAL REGULATIONS.
- 8. ALL BORROW FOR THE EXIT 36 IMPROVEMENTS SHALL COME FROM SUITABLE EXCAVATION FROM THE NORTHBOUND ACCELERATION LANE CONSTRUCTION. THE CONTRACTOR SHALL PLAN THEIR WORK TO USE AVAILABLE MATERIAL.
- 9. EXCAVATIONS ACCOMPLISHED AS PART OF THIS PROJECT SHALL BE CONSTRUCTED IN ACCORDANCE WITH OSHA SUBPART P OF 29 CFR PART 1926,650-652 (CONSTRUCTION STANDARDS FOR EXCAVATIONS)
- 10. RIGHT OF WAY AND PROPERTY LINES ARE SHOWN FOR INFORMATIONAL PURPOSES ONLY.
- II. COMMON BORROW SHALL BE COMPACTED TO 90% OF ITS MAXIMUM DRY DENSITY AS DETERMINED BY THE MODIFIED PROCTOR. GRANULAR BORROW AND AGGREGATE SHALL BE COMPACTED TO 95% OF THEIR MAXIMUM DRY DENSITY AS DETERMINED BY THE MODIFIED PROCTOR.

DRAINAGE NOTES:

NOT TO SCALE

Revision

- I. NO EXISTING DRAINAGE SHALL BE ABANDONED, REMOVED OR PLUGGED WITHOUT APPROVAL OF THE RESIDENT.
- 2. INLETS AND OUTLETS OF ALL CULVERTS SHALL BE RIPRAPPED UNLESS OTHERWISE NOTED ON THE PLANS OR DIRECTED BY THE RESIDENT.
- 3. IF FOUNDATION MATERIAL IS REQUIRED UNDER CULVERTS, IT SHALL MEET THE REQUIREMENTS OF GRANULAR BORROW - UNDERWATER BACKFILL AND WILL BE PAID FOR AS GRANULAR BORROW.
- 4. ANY NECESSARY CUTTING OF EXISTING CATCH BASINS TO TAKE A PROPOSED PIPE WILL NOT BE PAID FOR SEPARATELY AND SHALL BE INCIDENTAL TO THE PROPOSED CULVERT ITEMS.

Designed by:

Designed

By Date

- 5. EXISTING CATCH BASINS TO REMAIN SHALL BE CLEANED AS DIRECTED BY THE RESIDENT. PAYMENT WILL BE MADE UNDER ITEM 604,182 CLEANING EXISTING CATCH BASIN AND MANHOLE. EXISTING CULVERTS TO REMAIN SHALL BE CLEANED AS DIRECTED BY THE RESIDENT UNDER ITEM 631.32 CULVERT CLEANER (INCLUDING OPERATORS).
- 6. ALL DITCH ELEVATIONS AND OFFSETS SHOWN ON THE CROSS SECTIONS ARE FOR THE FINISHED DITCH FLOW LINE.

Stantec

Checked

By

In Charge of JRH 10\21

Date

JRH 10 \ 21

CONSULTANT PROJECT MANAGER: JOSEPH HOWE, P.E.

Date

10\21

THG 10\21

EROSION CONTROL

- THE ANTICIPATED EROSION CONTROL DEVICES ARE SHOWN ON THE PLANS. THE CONTRACTOR SHALL PROPOSE ACTUAL TYPE AND LOCATION OF DEVICES FOR APPROVAL BY THE RESIDENT. ADDITIONAL MEASURES MAY BE PROPOSED BY THE CONTRACTOR DUE TO SITE OR WEATHER CONDITIONS. THE RESIDENT MAY DIRECT THE CONTRACTOR TO IMPLEMENT ADDITIONAL MEASURES. ANY ADDITIONAL MEASURES APPROVED BY THE RESIDENT WILL BE MEASURED FOR PAYMENT UNDER THE APPROPRIATE BID ITEMS.
- 2. ALL TEMPORARY EROSION CONTROL DEVICES SHALL BE INSTALLED IN ACCORDANCE WITH THE MAINE DEPARTMENT OF TRANSPORTATION BEST MANAGEMENT PRACTICES.
- 3. 4" LOAM HAS BEEN ESTIMATED FOR THE DISTURBED SLOPE AREA EXCEPT FOR CONDUIT INSTALLATION UNLESS OTHERWISE SPECIFIED ON THE PLANS, ACTUAL PLACEMENT OF THE LOAM SHALL BE AS DESIGNATED BY THE RESIDENT.
- 4. NEWLY DISTURBED EARTH SHALL BE MULCHED IN ACCORDANCE WITH SUPPLEMENTAL SPECIFICATION 656. PAYMENT WILL BE MADE UNDER ITEM 619.1202 - TEMPORARY MULCH.
- 5. TEMPORARY SEED SHALL BE APPLIED TO ALL DISTURBED AREAS THAT WILL NOT BE COMPLETED WITHIN 30 DAYS.
- TEMPORARY STONE CHECK DAMS SHALL BE INSTALLED IN ACCORDANCE WITH THE MAINEDEP BEST MANAGEMENT PRACTICES.
- 7. TEMPORARY BERMS AND TEMPORARY SLOPE DRAINS ARE ANTICIPATED AT ALL STONE DOWNSPOUT LOCATIONS WHILE GROWTH IS BEING ESTABLISHED
- 8. TEMPORARY EROSION CONTROL BLANKET, ITEM 613.319 SHALL BE INSTALLED IN ALL DITCHES AND 2:1 OR STEEPER SLOPES FROM TOP TO TOE OF SLOPE, LOAM AND SEED SHALL BE PLACED PRIOR TO THE INSTALLATION OF THE EROSION CONTROL BLANKET, LIMITS OF THE EROSION CONTROL BLANKET IN DITCHES SHALL BE 6'WIDE OR AS DESIGNATED BY THE RESIDENT.
- 9. UNLESS OTHERWISE NOTED; SEEDING METHOD NO. 2 SHALL BE UTILIZED ON ALL AREAS.
- 10. A DOUBLE ROW OF SILT FENCE PROTECTION SHALL BE INSTALLED AT ALL STREAM LOCATIONS AND OPEN WATER WFTIANDS AS SHOWN ON THE PLANS.
- II. STABILIZED CONSTRUCTION ENTRANCES MUST BE USED AND MAINTAINED. NO TRACKING OF SOIL ON THE MAINE TURNPIKE OR LOCAL ROADS WILL BE ALLOWED.
- 12. PLACE A TWO FOOT WIDE STRIP OF TEMPORARY EROSION CONTROL BLANKET ON THE SIDE SLOPES, ALONG THE TOP OF THE RIPRAP, AND BEHIND THE WINGWALLS.

UTILITY NOTES:

STANTEC CONSULTING SERVICES INC.

2211 CONGRESS STREET SUITE 380

PORTLAND, ME 04102

TEL (207) 887-3448

FAX (207) 883-3376

- EXISTING UTILITIES ON THESE PLANS WERE COMPILED FROM FIELD SURVEY AND VARIOUS OTHER SOURCES. LOCATIONS ARE NOT GUARANTEED TO BE ACCURATE NOR IS IT GUARANTEED THAT ALL UTILITIES ARE SHOWN, NO SEPARATE OR ADDITIONAL COMPENSATION WILL BE ALLOWED TO THE CONTRACTOR DUE TO ANY VARIANCE BETWEEN THE DATA SHOWN ON THE PLANS AND THE ACTUAL FIELD CONDITIONS ENCOUNTERED, NO WORK SHALL BE STARTED UNTIL THE OWNERS OF THE VARIOUS UTILITIES ARE NOTIFIED BY THE CONTRACTOR OF THE PROPOSED CONSTRUCTION. THE CONTRACTOR IS ALSO REQUIRED TO CONTACT DIG SAFE AT 1-888-7233. 811. OR WWW.DIGSAFE.COM IN CONFORMANCE WITH ALL STATE AND LOCAL LAWS, ORDINANCES, AND STATUTES.
- 2. THE MAINE TURNPIKE AUTHORITY IS A NON-MEMBER UTILITY OPERATOR AND IS NOT REGISTERED WITH THE DIG SAFE SYSTEM. THE CONTRACTOR SHALL CONTACT ALL NON-MEMBERS THROUGH WWW.OKTODIG.COM OR AS OTHERWISE REQUIRED BY THE MAINE PUBLIC UTILITIES COMMISSION. ALL PROPOSED EXCAVATION LOCATIONS SHALL BE MARKED AT THE TIME OF NOTIFICATION, NO EXCAVATION SHALL BE PERMITTED UNTIL THE AUTHORITY HAS LOCATED AND MARKED ITS UNDERGROUND UTILITIES. THE RESIDENT ENGINEER SHALL BE PROVIDED AN ELECTRONIC COPY OF ALL DIG SAFE TICKETS WITHIN 24 HOURS OF THEIR RELEASE FOR PROJECT NOTIFICATIONS AND 3RD PARTY UTILITY LOCATOR COORDINATION.
- 3. THE UTILITIES INVOLVED IN THIS CONTRACT ARE:

CENTRAL MAINE POWER MAINE TURNPIKE AUTHORITY KENNEBUNK WATER DISTRICT KENNEBUNK SEWER DISTRICT UNITILFIRSTLIGHT CONSOLIDATED COMMUNICATIONS

CHARTER COMMUNICATIONS CITY OF BIDDEFORD MAINE DEPARTMENT OF TRANSPORTATION

4. THE CONTRACTOR SHALL PROTECT ALL NEW AND EXISTING UTILITIES FROM DAMAGE DURING THE CONSTRUCTION AS APPROVED BY THE UTILITY OWNERS.

> MAINE THE GOLD STAR **TURNPIKE** MEMORIAL HIGHWAY

EXIT 36 IMPROVEMENTS AND PAVEMENT REHABILITATION

STRIPING LEGEND

6" BROKEN WHITE LANE LINE

6" DOTTED WHITE LANE LINE

6" SOLID WHITE LANE LINE

12" SOLID WHITE GORE LINE

6" SOLID YELLOW LANE LINE

SHEET NUMBER: GN-01

3 OF 56

MTA PROJECT MANAGER: RALPH NORWOOD, IV, PE, PTOE


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GENERAL NOTES


PAVEMENT MILL & OVERLAY

PAVEMENT LEGEND:

- $\bigcirc A = I'/2$ " HOT MIX ASPHALT 12.5 mm NOMINAL MAXIMUM SIZE (POLYMER MODIFIED)
- (B) = MILLING DEPTH VARIES TO ACHIEVE A 1/2" DEPTH AT THE EDGES OF LANE BEING MILLED.
- C = DOUBLE LAYER OF TACK ON NOTCHED EDGE
- (D) = BERM DROPOFF CORRECTION GRINDINGS (SEE DETAIL A, SHEET DT-06).
- (E) = BERM DROPOFF CORRECTION GRINDINGS SEE DETAIL B, SHEET DT-06).
- (F) = LIMITS OF MILL AND OVERLAY.

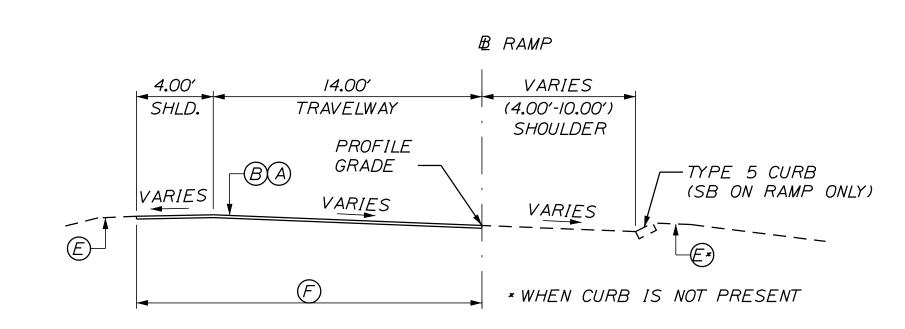

RAMP MILL AND OVERLAY WITHOUT GUARDRAIL

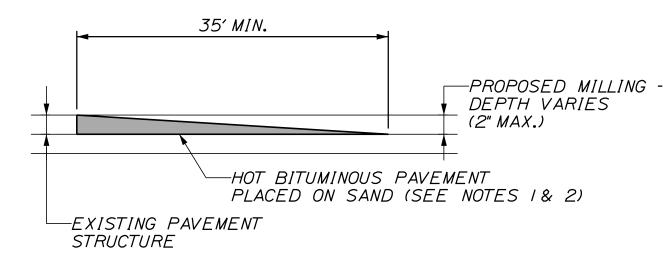


TEMPORARY BITUMINOUS RAMP


NOTES:

- HOT MIX ASPHALT FOR TEMPORARY RAMPS WILL NOT BE MEASURED FOR PAYMENT, BUT SHALL BE INCIDENTAL TO THE APPROPRIATE 403 ITEM.
- 2. REMOVAL OF TEMP. BITUMINOUS RAMPS WILL NOT BE MEASURED FOR PAYMENT, BUT SHALL BE INCIDENTAL TO THE APPROPRIATE 403 ITEM.

NOTES:

- COATING OF HOT RUBBERIZED ASPHALT (ASTM D6690 TYPE IV) SHALL BE APPLIED AT THE TOP SURFACE LIFT TO ALL TRANSVERSE BUTT JOINTS AND LONGITUDINAL JOINTS EXCEPT WHERE THE NOTCHED WEDGE IS USED.
- 2. BITUMINOUS TACK COAT IS REQUIRED BETWEEN EXISTING PAVEMENT AND PROPOSED HMA.
- 3. PAYMENT FOR HOT MIX ASPHALT 12.5 mm NOMINAL MAXIMUM SIZE WILL BE MADE UNDER ITEM 403.2081.
- 4. LANE WIDTHS VARY AT APPROACHES TO WESTBOUND TOLL PLAZA.
- 5. THE CONTRACTOR SHALL STRING EACH BRIDGE AND TOLL SLAB APPROACH / DEPARTURE LANE IN ADVANCE OF MILLING AND PAVING OPERATIONS. THIS WORK SHALL BE COMPLETED BY THE CONTRACTOR'S PERSONNEL EXPERIENCED IN STRINGING BRIDGE APPROACH LANES. THE CONTRACTOR SHALL PROVIDE ADVANCE NOTICE TO THE AUTHORITY'S RESIDENT SO THAT THEY CAN BE PRESENT.
- 6. CROSS SLOPE TRANSITIONS TO MATCH EXISTING CROSS SLOPES SHALL BE AS DIRECTED BY THE RESIDENT.
- 7. ALL PAVEMENT JOINTS WITH VERTICAL CONCRETE SURFACES SHALL HAVE HOT POURED BITUMINOUS SEALANT (INCIDENTAL TO RELATED PAVEMENT ITEMS).
- 8. 14' WIDE RAMP LANES SHALL BE PAVED IN A SINGLE PASS SUCH THAT LONGITUDINAL JOINTS ARE AT THE EDGES OF THE LANE.

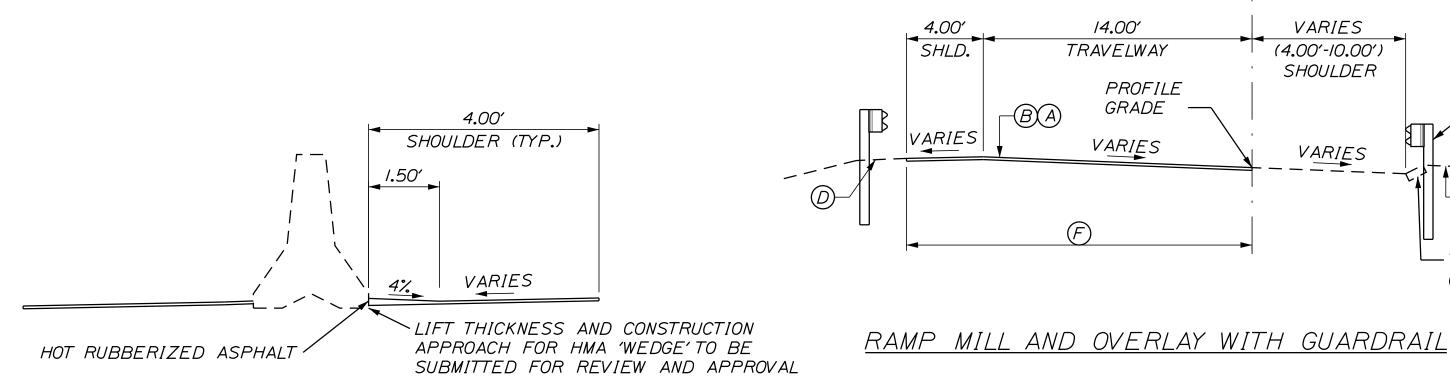

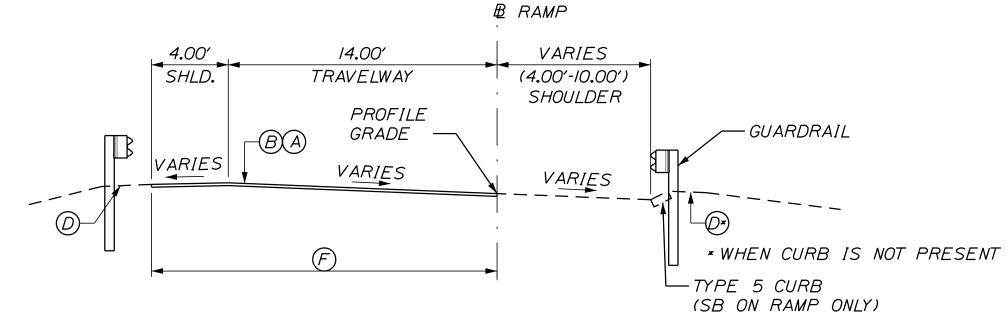

RAMP MILL AND OVERLAY ADJACENT TO BARRIER

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No.	Revision	Ву	Date							
				CONSULTANT	PROJE(CT MANAGER:	JOSEPH HOWE,	P.E.		1
					Ву	Date		Ву	Date	
				Designed	THG	10\21	Checked	JŔH	10\21	1
				Drawn	CHL	10\21	In Charge of	JRH	10\21	1

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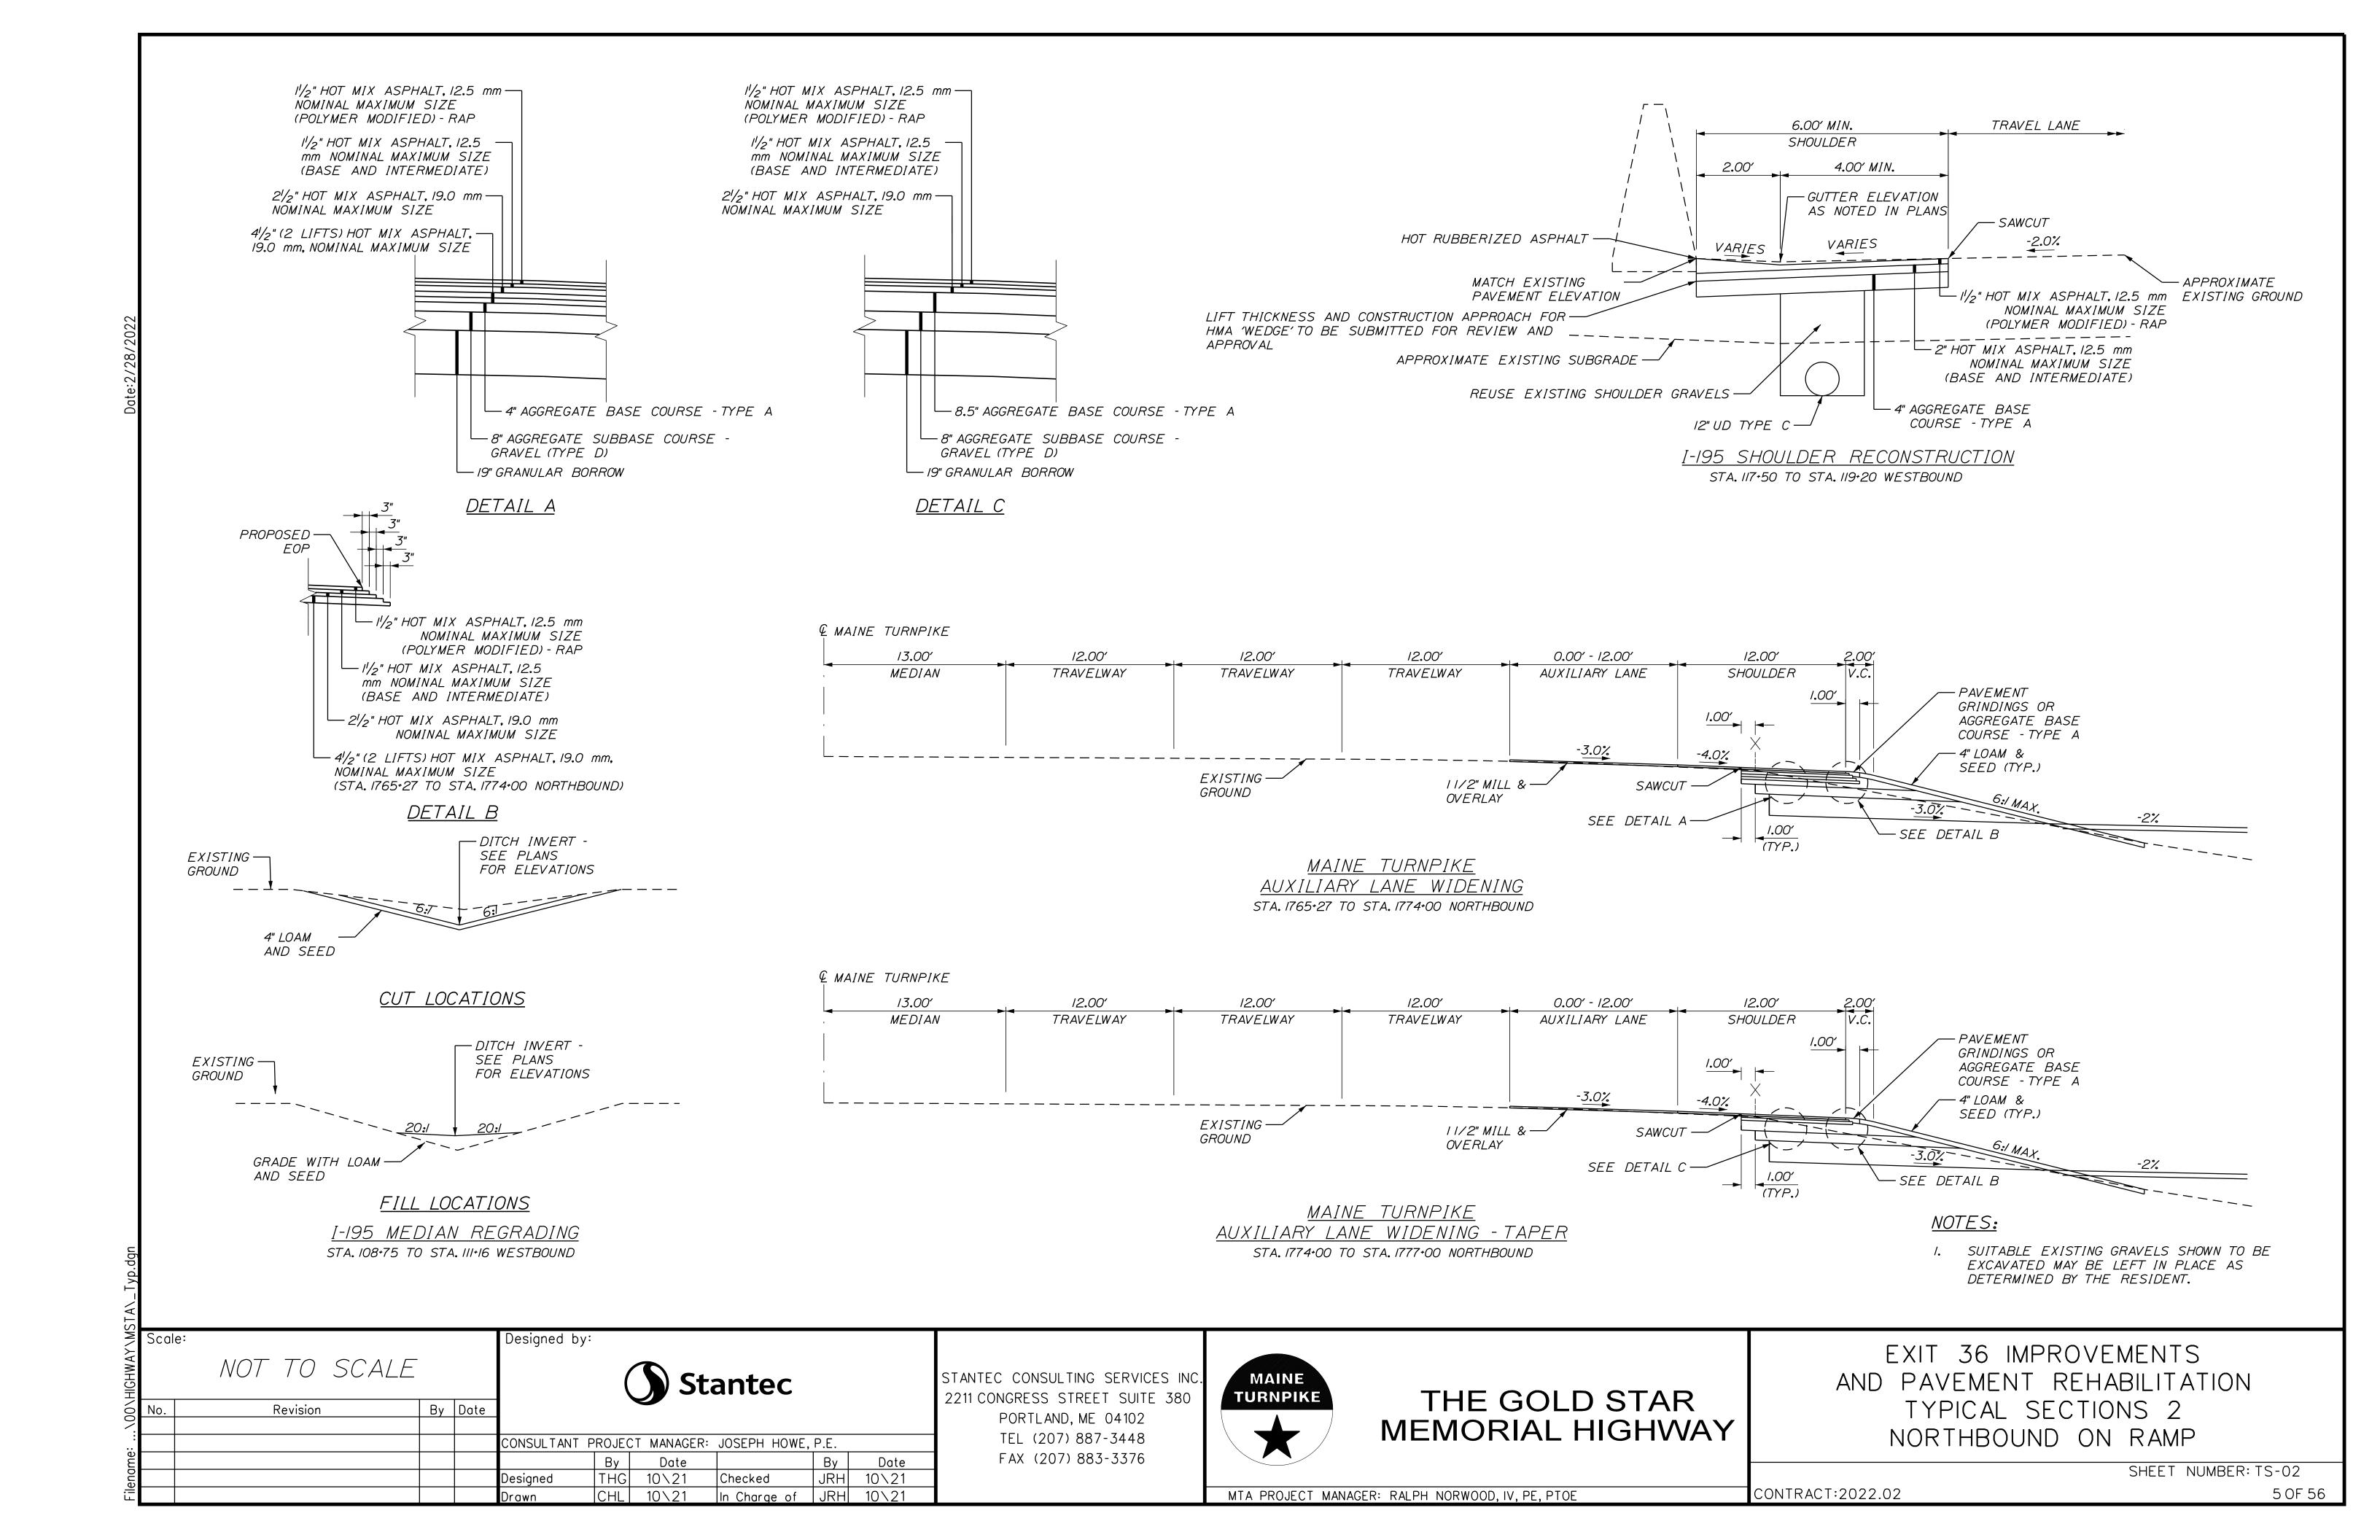
THE GOLD STAR MEMORIAL HIGHWAY


EXIT 36 IMPROVEMENTS AND PAVEMENT REHABILITATION TYPICAL SECTIONS 1 MILL AND OVERLAY


SHEET NUMBER: TS-01

MTA PROJECT MANAGER: RALPH NORWOOD, IV, PE, PTOE


4 OF 56 CONTRACT:2022.02




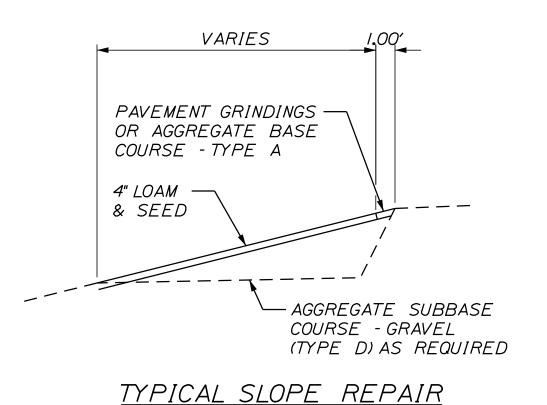

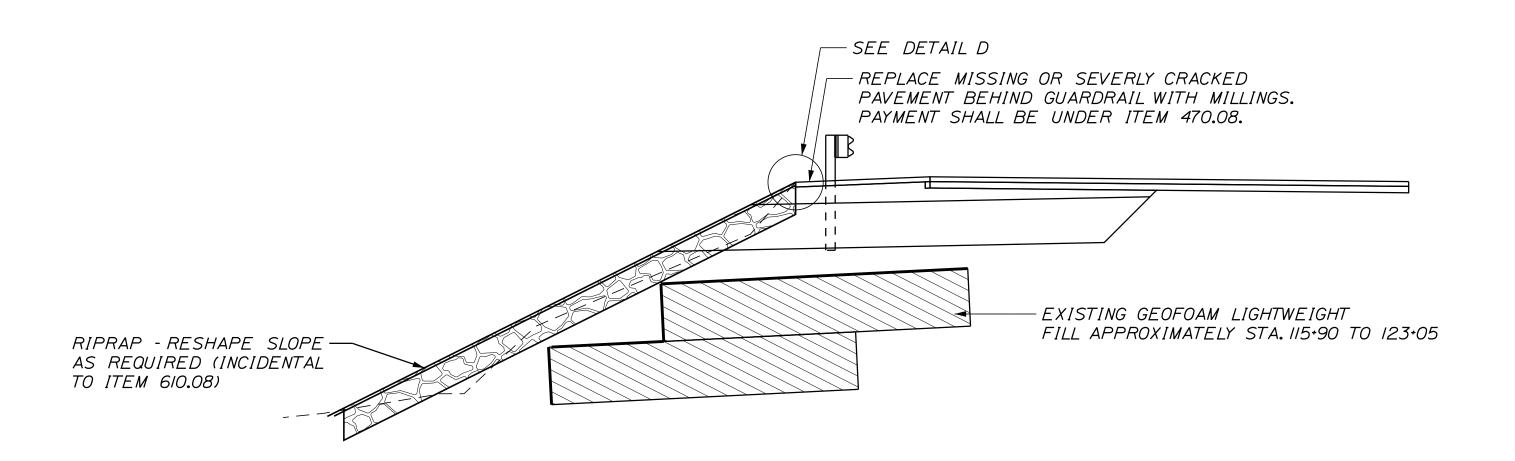

FULL LENGTH SLOPE REPAIR

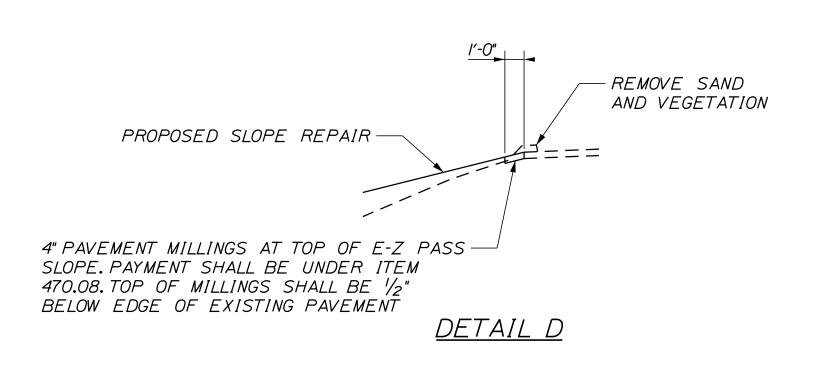

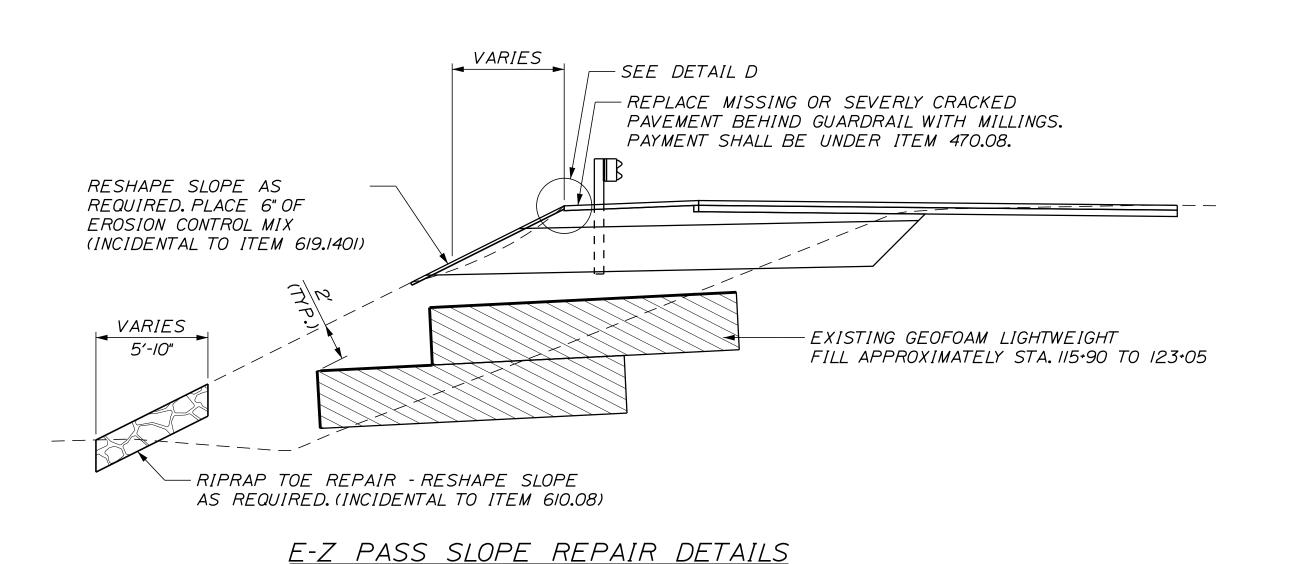

NOTES:

- I. SLOPE REPAIRS SHOWN ARE REPRESENTATIVE. SEE PLANS FOR APPROXIMATE LOCATIONS TO BE VERIFIED BY THE RESIDENT.
- 2. THE CONTRACTOR SHALL NOT DISTURB THE EXISTING GEOFOAM OR LINER. ANY DAMAGE TO THE GEOFOAM OR LINER SHALL BE REPAIRED BY THE CONTRACTOR AT NO COST TO THE AUTHORITY.

.HIGHWAY\M	Scal	e: NOT TO SCALE			Designed by:	(St	antec			STA 221
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					CONSULTANT F	PROJEC	T MANAGER:	JOSEPH HOWE,	P.E.		_
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ilena			·		Designed	THG	10\21	Checked	JRH	10\21	
Ē			·		Drawn	CHL	10\21	In Charge of	JRH	10\21	

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THE GOLD STAR MEMORIAL HIGHWAY

EXIT 36 IMPROVEMENTS
AND PAVEMENT REHABILITATION
TYPICAL SECTIONS 3
NORTHBOUND ON RAMP

SHEET NUMBER: TS-03

MTA PROJECT MANAGER: RALPH NORWOOD, IV, PE, PTOE

CONTRACT:2022.02 6 OF 56

- 3. THESE PLANS SHOW THE GENERAL CONDITION FOR TURNPIKE MAINLINE TRAFFIC CONTROL. DURING CONSTRUCTION, SLIGHT MODIFICATIONS IN CONSTRUCTION PROCEDURE MAY OCCUR AND MAY REQUIRE SOME MINOR ADJUSTMENTS TO BE MADE IN THE FIELD, ALL PROCEDURES MUST BE APPROVED BY THE RESIDENT.
- 4. THE CONTRACTOR SHALL REMOVE ALL PAVEMENT MARKINGS THAT CONFLICT WITH PROPOSED PAVEMENT MARKINGS IN ACCORDANCE WITH THE SPECIFICATIONS AND MUTCD, PAYMENT SHALL BE MADE UNDER ITEM 627.77 - REMOVING PAVEMENT MARKINGS.
- 5. TEMPORARY PAVEMENT MARKINGS SHALL BE PAINTED, UNLESS OTHERWISE NOTED. PAYMENT FOR MARKINGS SHALL BE UNDER ITEM 627.78 - TEMPORARY 6 INCH PAINTED PAVEMENT MARKING LINES. YELLOW OR WHITE.
- 6. TEMPORARY PAINTED PAVEMENT MARKINGS SHALL NOT BE INSTALLED ON NEW PAVEMENT; TEMPORARY PAVEMENT MARKING TAPE SHALL BE USED.
- 7. EXPOSED BARRIER ENDS SHALL BE PROTECTED BY A WORK ZONE CRASH CUSHION, PAYMENT WILL BE UNDER ITEM 527.341-WORK ZONE CRASH CUSHION - TL-3.
- 8. ALL TEMPORARY BARRIER SHALL BE SET WITH A MINIMUM 8: TAPER. THE 8: TAPER BARRIER LENGTH IS DEPENDENT ON THE LOCATION OF THE BARRIER RELATIVE TO THE MAINE TURNPIKE SHOULDERS OR LANES.
- 9. REMOVAL OF TEMPORARY PAVEMENT MARKINGS ON FINAL PAVEMENT SURFACE SHALL BE DONE IN SUCH A MANNER TO REMOVE AS LITTLE PAVEMENT AS POSSIBLE.
- IO. TRUCK MOUNTED ATTENUATOR SHALL NOT BE LOCATED WITHIN THE BUFFER ZONE.

II. SHEETS MT-01TO MT-12 APPLY TO EXITS 36 AND 25 ONLY.

MOT SIGN NOTES:

- I. THESE PLANS SHOW THE GENERAL LAYOUT OF CONSTRUCTION ZONE SIGNING; ALL LOCATIONS REQUIRING SIGNS MAY NOT BE SHOWN, ADDITIONAL MOT NOT SHOWN ON THE PLANS AND LAYOUT OF SIGNS MUST BE SUBMITTED TO AND APPROVED BY THE RESIDENT.
- 2. ALL PROPOSED CONSTRUCTION SIGNS ON MAINLINE AND 1-195 WILL BE PLACED ON BOTH SIDES OF THE ROAD UNLESS OTHERWISE SHOWN ON THE PLANS.
- 3. NO SIGNS ON EASELS SHALL BE PLACED ON 4 FT. SHOULDERS WITH GUARDRAIL, SIGNS REQUIRED AT THESE LOCATIONS SHALL BE PLACED ON TALLER EASELS ON THE MEDIAN SIDE OF THE GUARDRAIL.
- 4. ALL TEMPORARY LANE CLOSURE SIGNS ARE TO BE MOUNTED ON EASELS.
- 5. ERECT CS-3 AND W3-4 SIGNS IMMEDIATELY PRIOR TO SCHEDULED STOPPAGES FOR EQUIPMENT MOVES AND REMOVE THE CS-3 AND W3-4 SIGNS IMMEDIATELY AFTER THE SCHEDULED STOPPAGES ARE COMPLETE.
- 6. ALL MOT SIGN LOCATIONS ARE APPROXIMATE AND SHALL BE CONFIRMED BY THE RESIDENT.
- 7. EXISTING SIGNS THAT CONFLICT WITH CONSTRUCTION WORK ZONE SIGNS SHALL BE COVERED.
- 8. SPEED LIMIT, STOP, EXIT AND YIELD SIGNS SHALL BE A MINIMUM OF 5' ABOVE THE PAVEMENT TO THE BOTTOM OF SIGN.
- 9. TWO COMPLETE LANE CLOSURE EASEL MOUNTED SIGN PACKAGES (LEFT OR RIGHT LANE TURNPIKE), INCLUDING WORK ZONE SPEED SIGNS, HAVE BEEN INCLUDED IN THE CONTRACT TO PERMIT SETUP AND REMOVAL OF THE PERMANENT WORK ZONE MAINTENANCE OF TRAFFIC CONTROL DEVICES.

TEMPORARY RUMBLE STRIP NOTES:

- I. IF TEMPORARY RUMBLE STRIPS ARE USED THEY SHALL BE PLACED IN ONE OF THE FOLLOWING CONFIGURATIONS:
- * ADJACENT TO THE WORK ZONE (IUNIT)
- * UPSTREAM FROM THE TAPER FOR THE WORKZONE (2 UNITS)
- * BOTH ADJACENT TO THE WORKZONE AND PRIOR TO THE TAPER (3 UNITS)
- 2. W8-I SIGNS SHALL BE PLACED ADJACENT TO THE FIRST RUMBLE STRIP AT ANY LOCATION. ONLY ONE SET OF W8-24a SIGNS ARE REQUIRED FOR ANY OF THE ABOVE CONFIGURATIONS.
- 3. RUMBLE STRIPS MAY BE PLACED UPSTREAM OF THE TAPER BETWEEN THE W3-5 SIGNS AND THE W4-2 SIGNS, IF RUMBLE STRIPS ARE INSTALLED PRIOR TO TAPER, W8-1 SIGNS SHALL BE PLACED ADJACENT TO THE FIRST STRIP AND THE W8-240 SIGNS SHALL BE MOVED TO 400' AFTER THE W20-5 SIGNS.

ABBREVIATIONS FOR ALL M.O.T. PLANS:

BWLL = BROKEN WHITE LANE LINE

SWEL = SOLID WHITE EDGE LINE

SYEL = SOLID YELLOW EDGE LINE

TBWLL = TEMPORARY BROKEN WHITE LANE LINE TDWEL = TEMPORARY DOTTED WHITE EDGE LINE

TSWEL = TEMPORARY SOLID WHITE EDGE LINE

TSWLL = TEMPORARY SOLID WHITE LANE LINE

TSYCI = TEMPORARY SOLID YELLOW CENTER LINE

TSYEL = TEMPORARY SOLID YELLOW EDGE LINE

Designed by: Scale: NOT TO SCALE Stantec By Date Revision CONSULTANT PROJECT MANAGER: JOSEPH HOWE, P.E. By Date Date JRH 10\21 THG 10\21 Checked Designed In Charge of JRH 10\21 10\21

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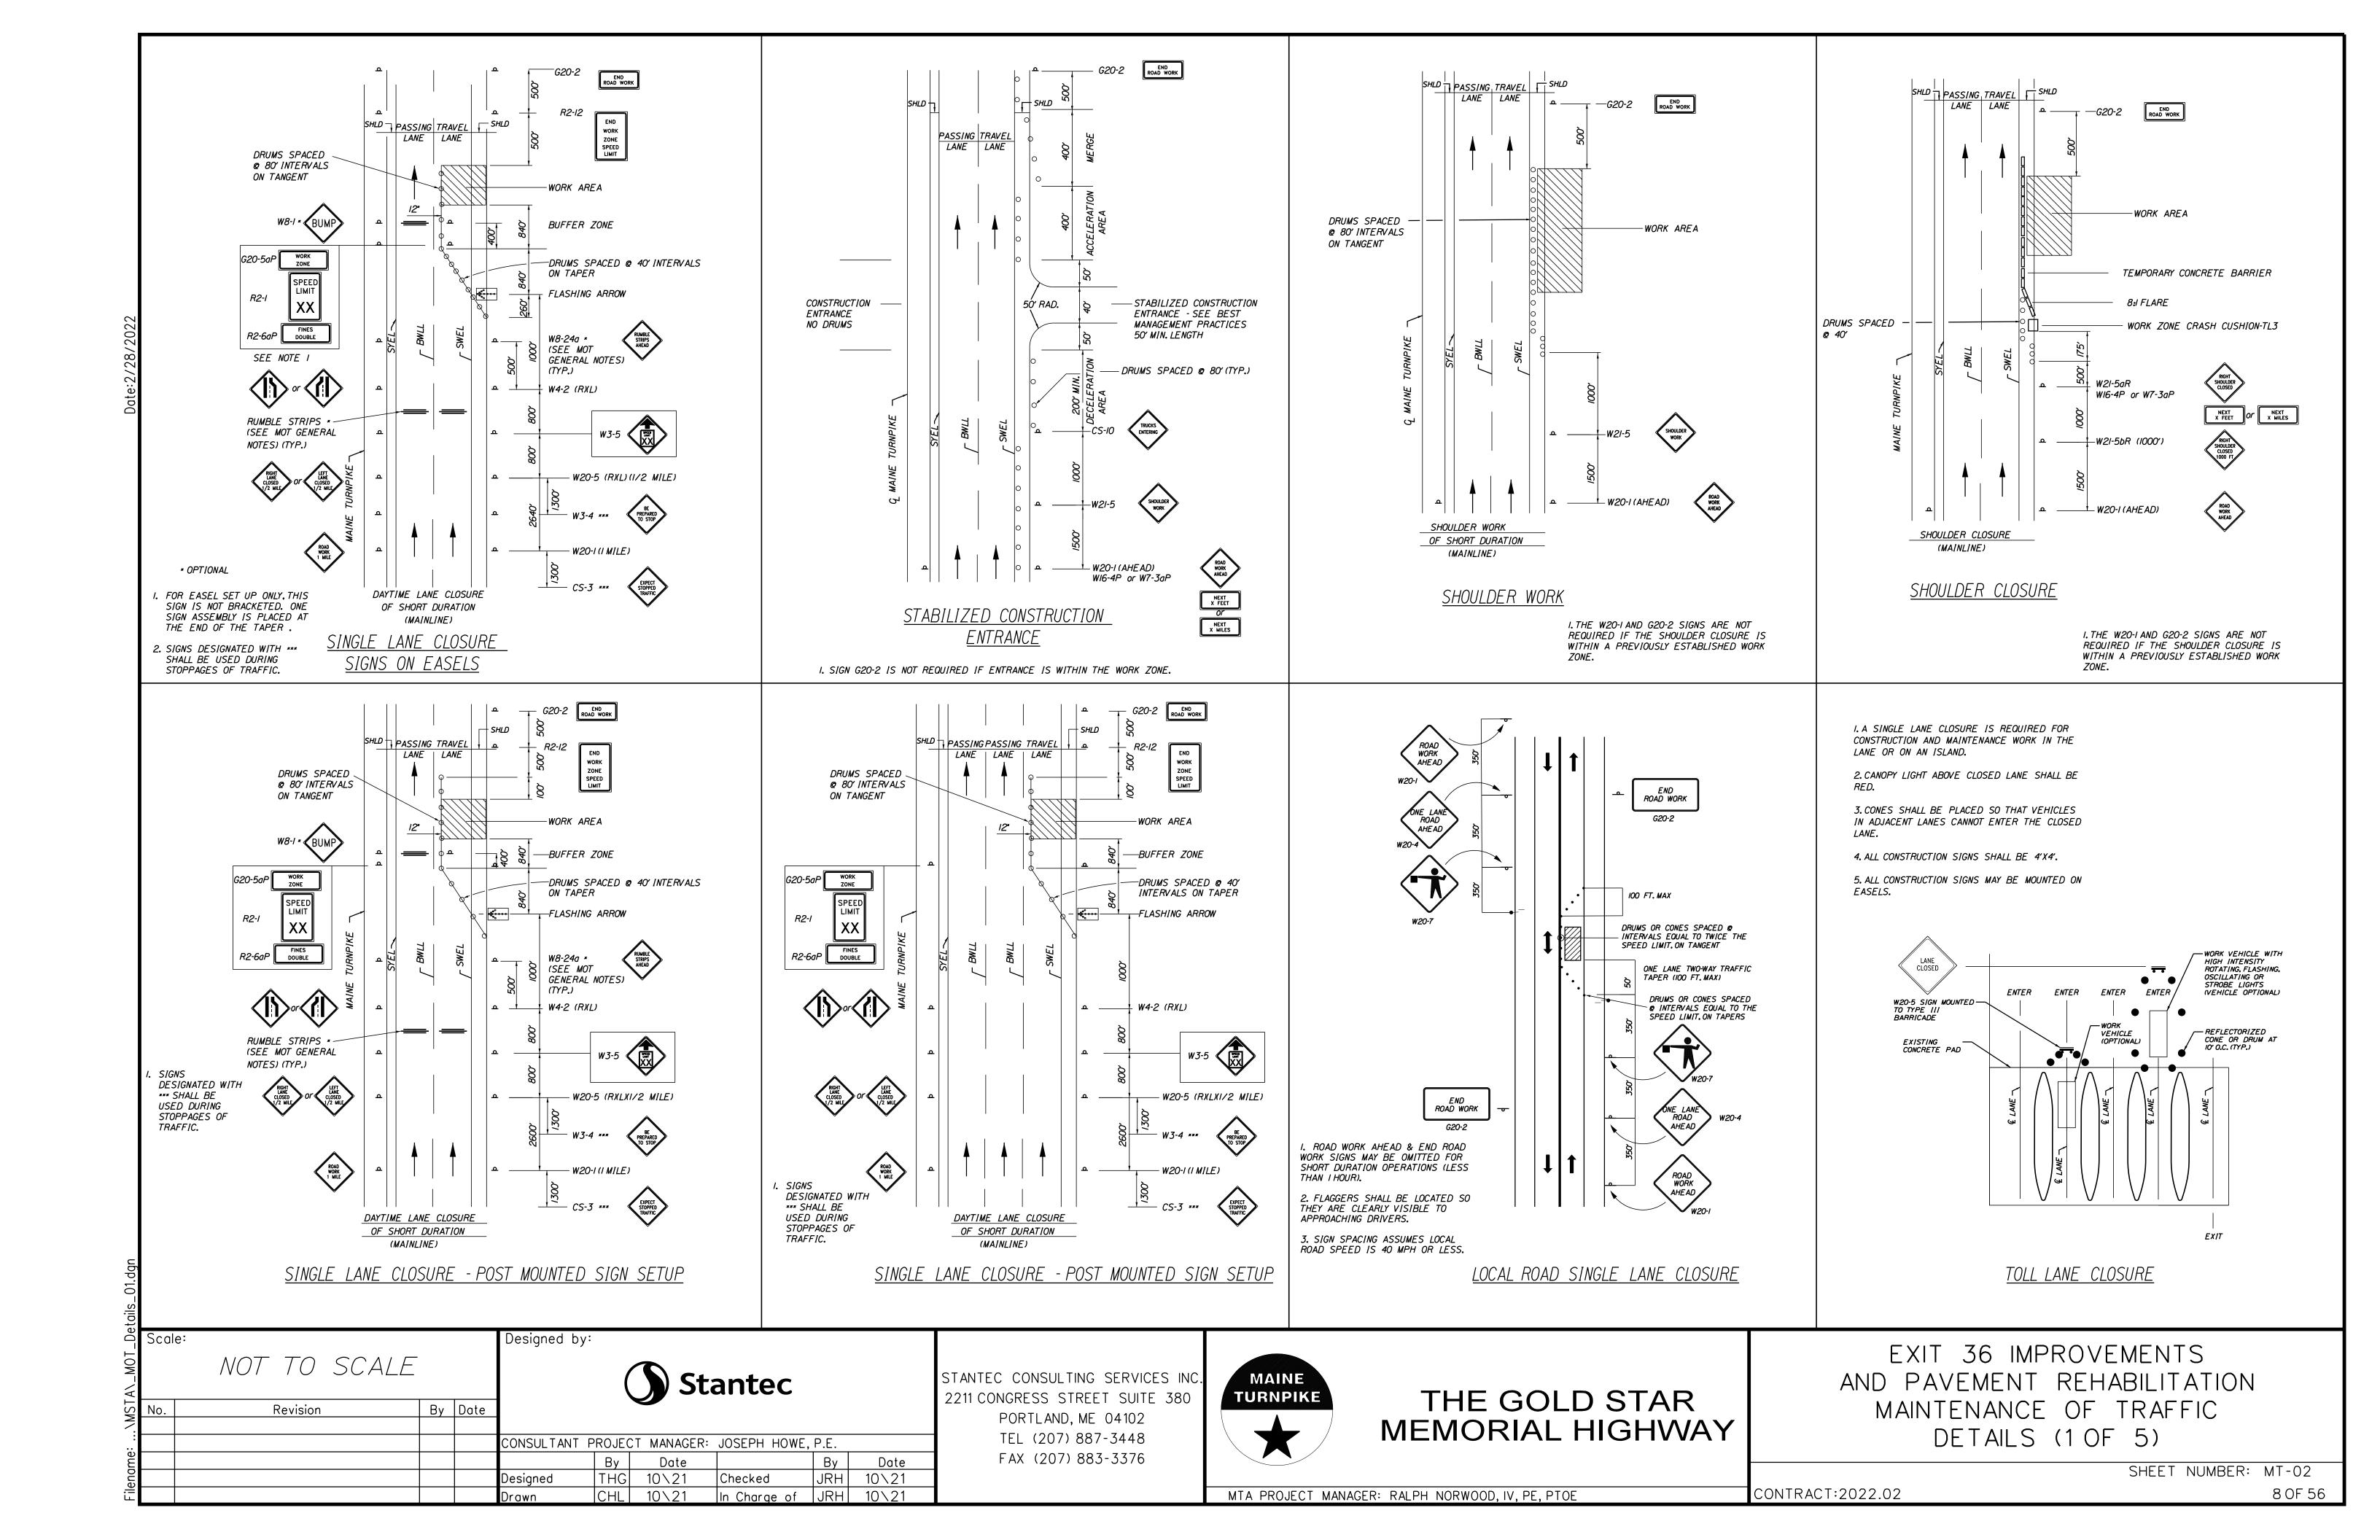
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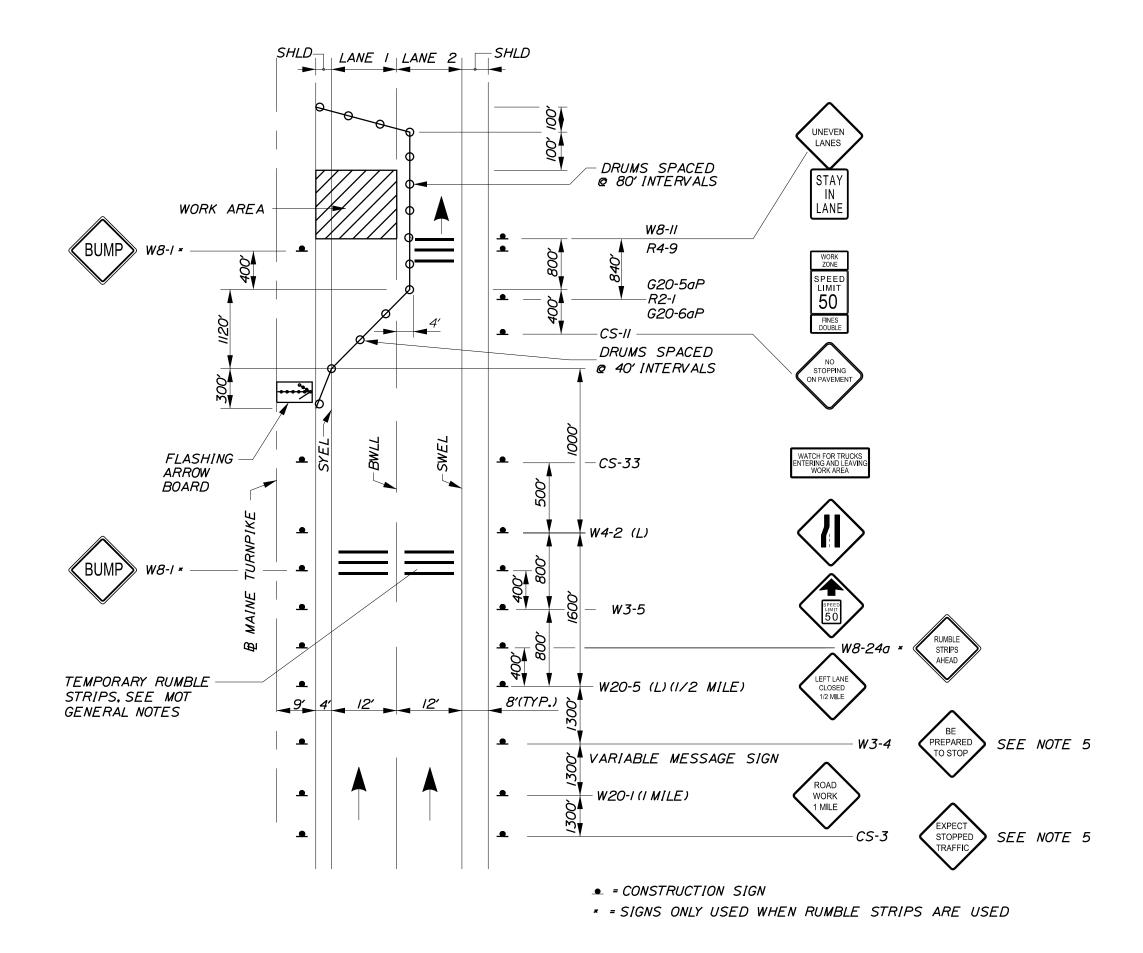
EXIT 36 IMPROVEMENTS AND PAVEMENT REHABILITATION MAINTENANCE OF TRAFFIC GENERAL NOTES

CONTRACT:2022.02

SHEET NUMBER: MT-01

MTA PROJECT MANAGER: RALPH NORWOOD, IV, PE, PTOE






LANE CLOSURE FOR MILLING AND PAVING OPERATIONS

LANE I

LANE CLOSURE FOR PAVEMENT MARKINGS

LANE 1

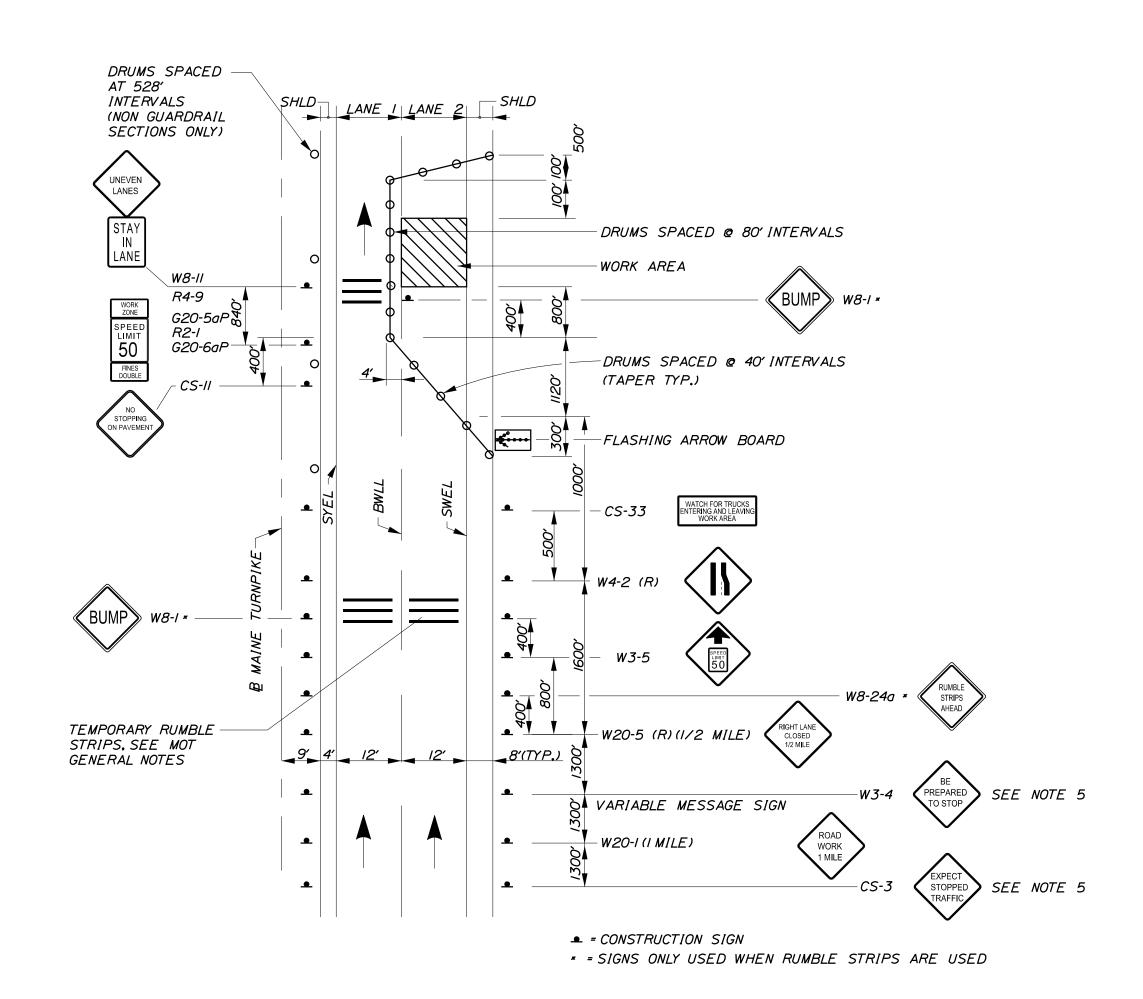

LANE CLOSURE FOR MILLING AND PAVING OPERATIONS

<u>LANE 2</u>

<u>NOTES:</u>

- I. FOR SIGN DETAILS, SEE SIGN SUMMARY SHEETS.
- 2. ALL TEMPORARY LANE CLOSURE SIGNS ARE TO BE MOUNTED ON EASELS.
- 3. STANDARD SINGLE LANE CLOSURES FOR LANES I AND 2 SHALL BE USED FOR DRAINAGE WORK, GUARDRAIL WORK, MEDIAN WORK, EQUIPMENT MOVES, BERM DROP OFF CORRECTION WORK, PAINTING OF SOLID WHITE LANE LINES, AND ALL OTHER WORK NOT REQUIRING ENCROACHMENT INTO THE ADJACENT LANE.
- 4. SEE SHEET M-3 FOR STANDARD SINGLE LANE CLOSURE DETAILS.
- 5. ERECT CS-3 AND W3-4 SIGNS IMMEDIATELY PRIOR TO SCHEDULED STOPPAGES FOR EQUIPMENT MOVES AND REMOVE THE CS-I AND W3-4 SIGNS IMMEDIATELY AFTER THE SCHEDULED STOPPAGES ARE COMPLETE.

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No.	Revision	Ву	Date	1						
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				Designed	THG	10\21	Checked	JRH	10\21	
				Drawn	CHL	10\21	In Charge of	JRH	10\21	

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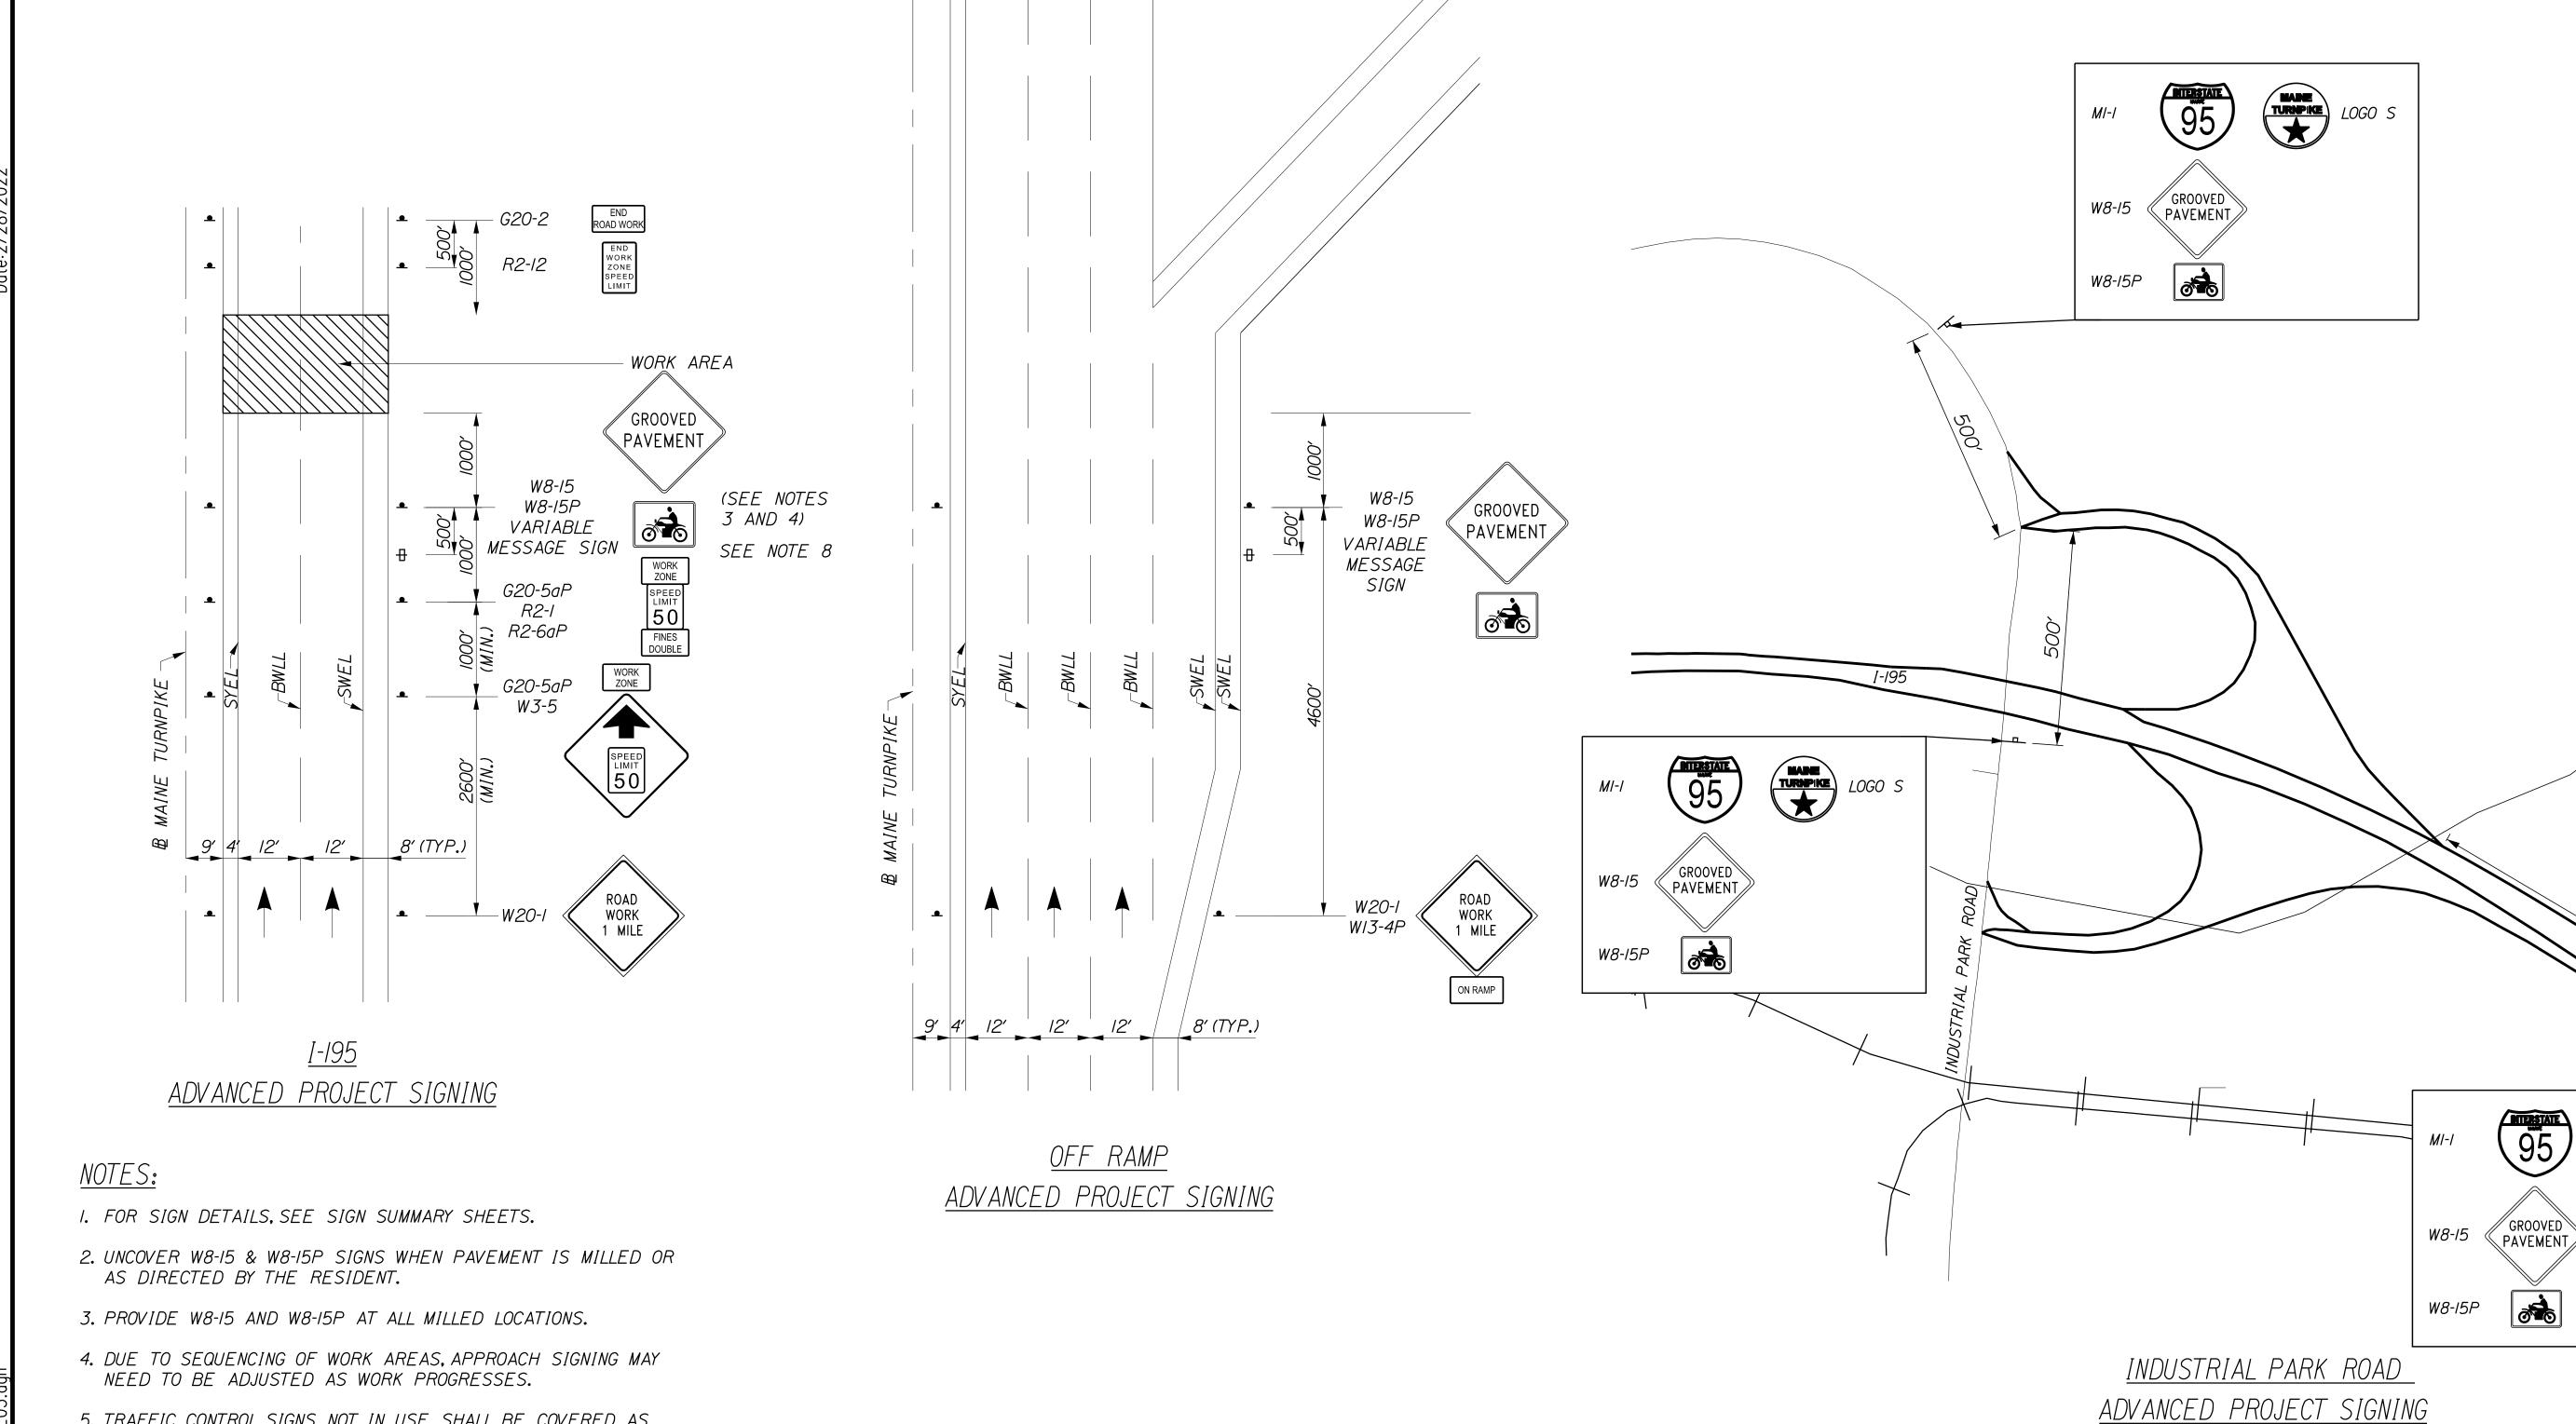
THE GOLD STAR
MEMORIAL HIGHWAY

EXIT 36 IMPROVEMENTS
AND PAVEMENT REHABILITATION
MAINTENANCE OF TRAFFIC
DETAILS (2 OF 5)

SHEET NUMBER: MT-03

MTA PROJECT MANAGER: RALPH NORWOOD, IV, PE, PTOE

CONTRACT:2022.02



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Scale:

5. TRAFFIC CONTROL SIGNS NOT IN USE SHALL BE COVERED AS

By Date

Designed by:

Designed

Stantec

Checked

By Date

JRH 10\21

In Charge of JRH 10\21

CONSULTANT PROJECT MANAGER: JOSEPH HOWE, P.E.

Date

10\21

THG 10\21

DIRECTED BY THE RESIDENT.

NOT TO SCALE

Revision

MAINE

TURNPIKE

EXIT 36 IMPROVEMENTS AND PAVEMENT REHABILITATION MAINTENANCE OF TRAFFIC DETAILS (3 OF 5)

SHEET NUMBER: MT-04

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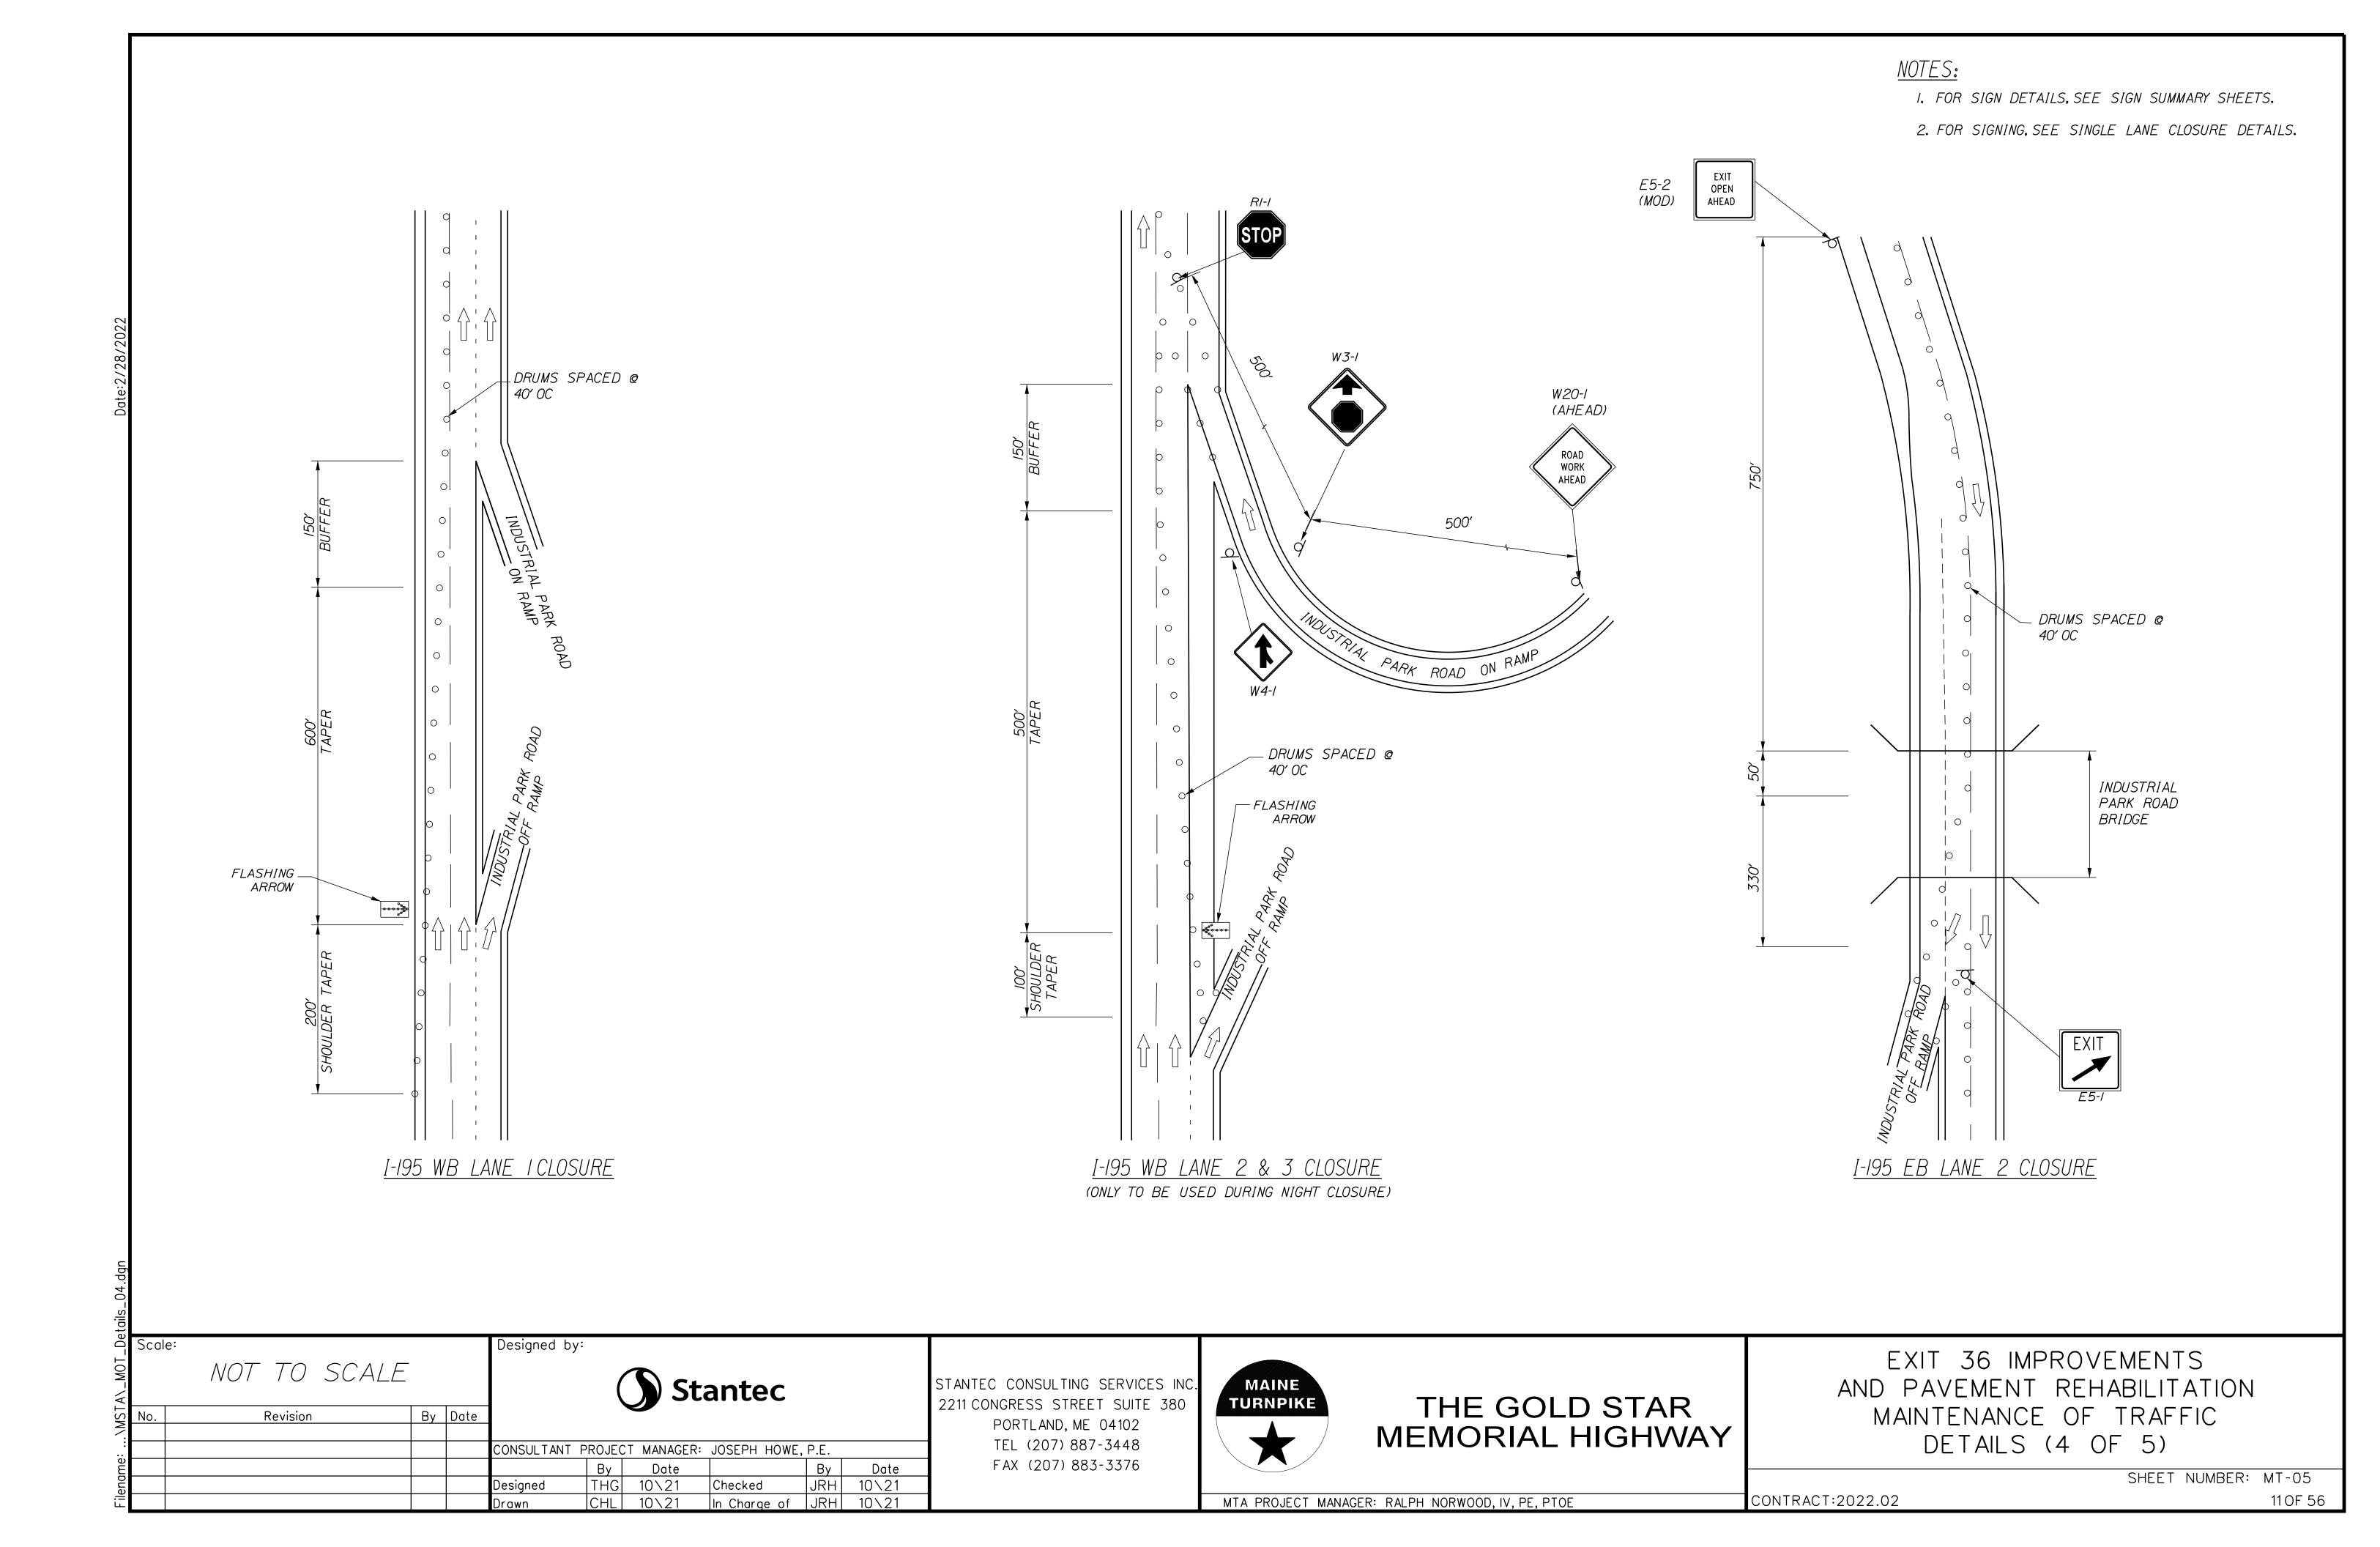
MTA PROJECT MANAGER: RALPH NORWOOD, IV, PE, PTOE


THE GOLD STAR


MEMORIAL HIGHWAY

CONTRACT:2022.02 10 OF 56

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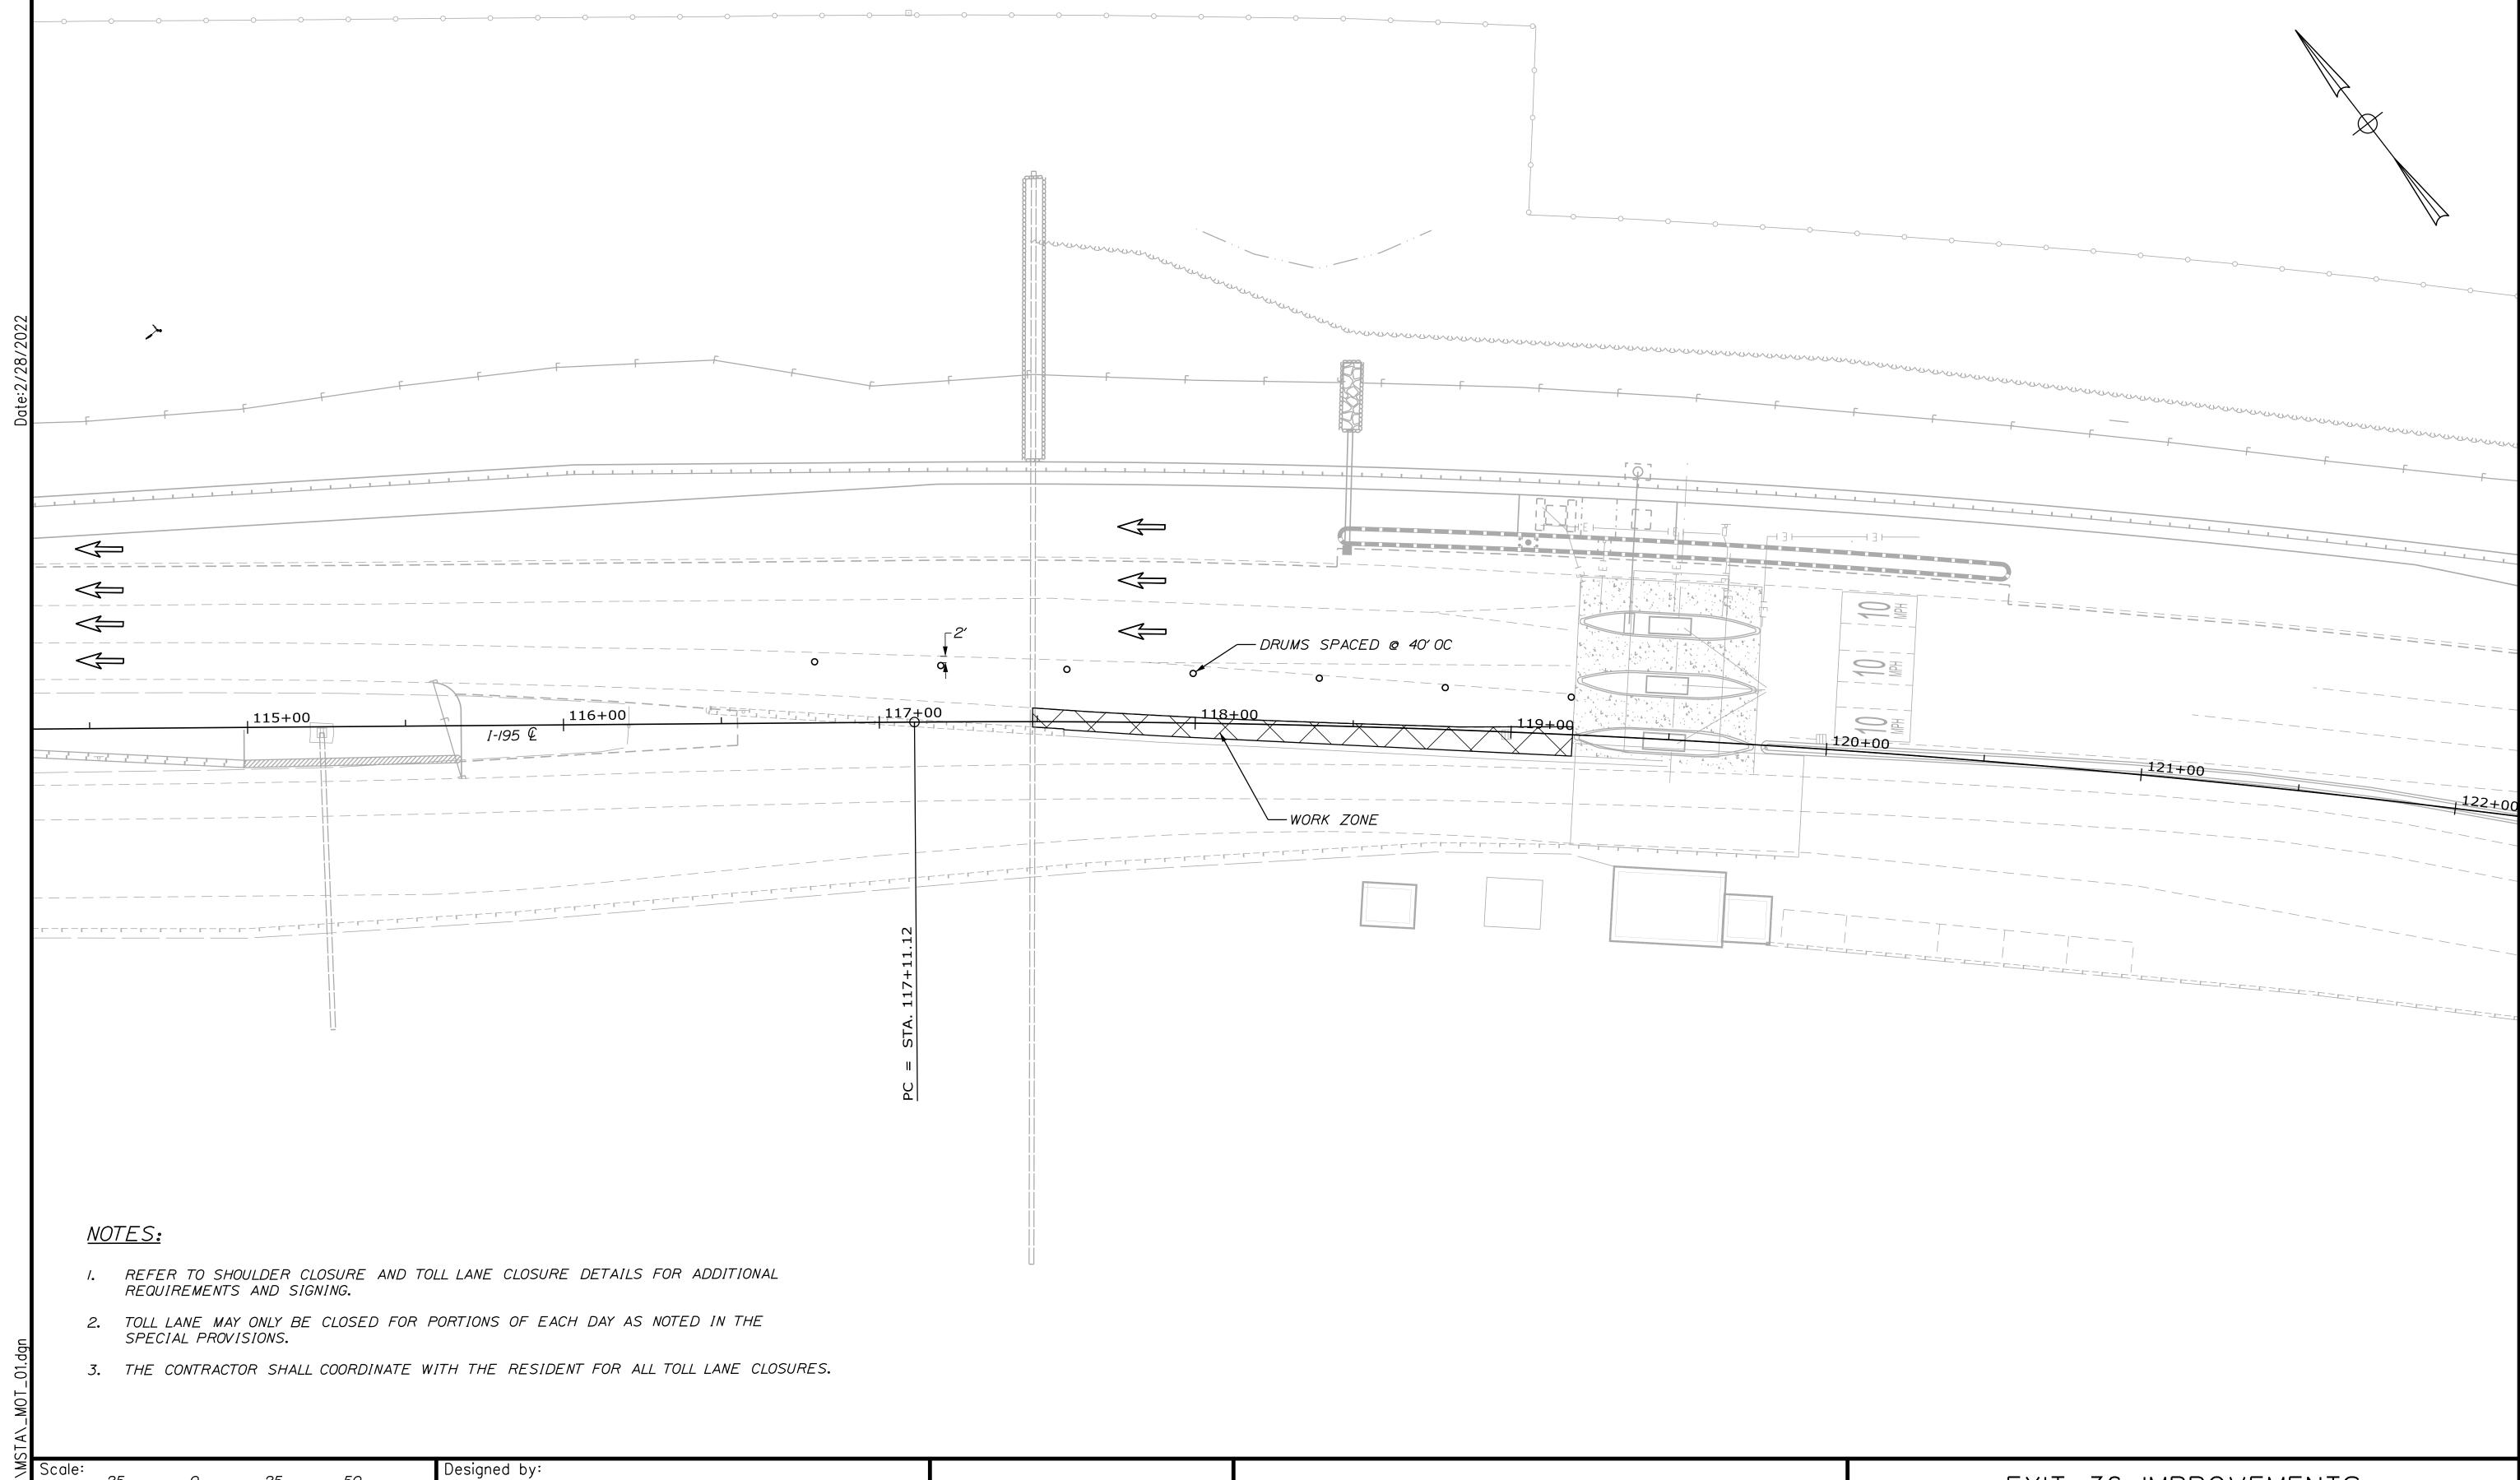
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In Charge of JRH 10\21

Designed

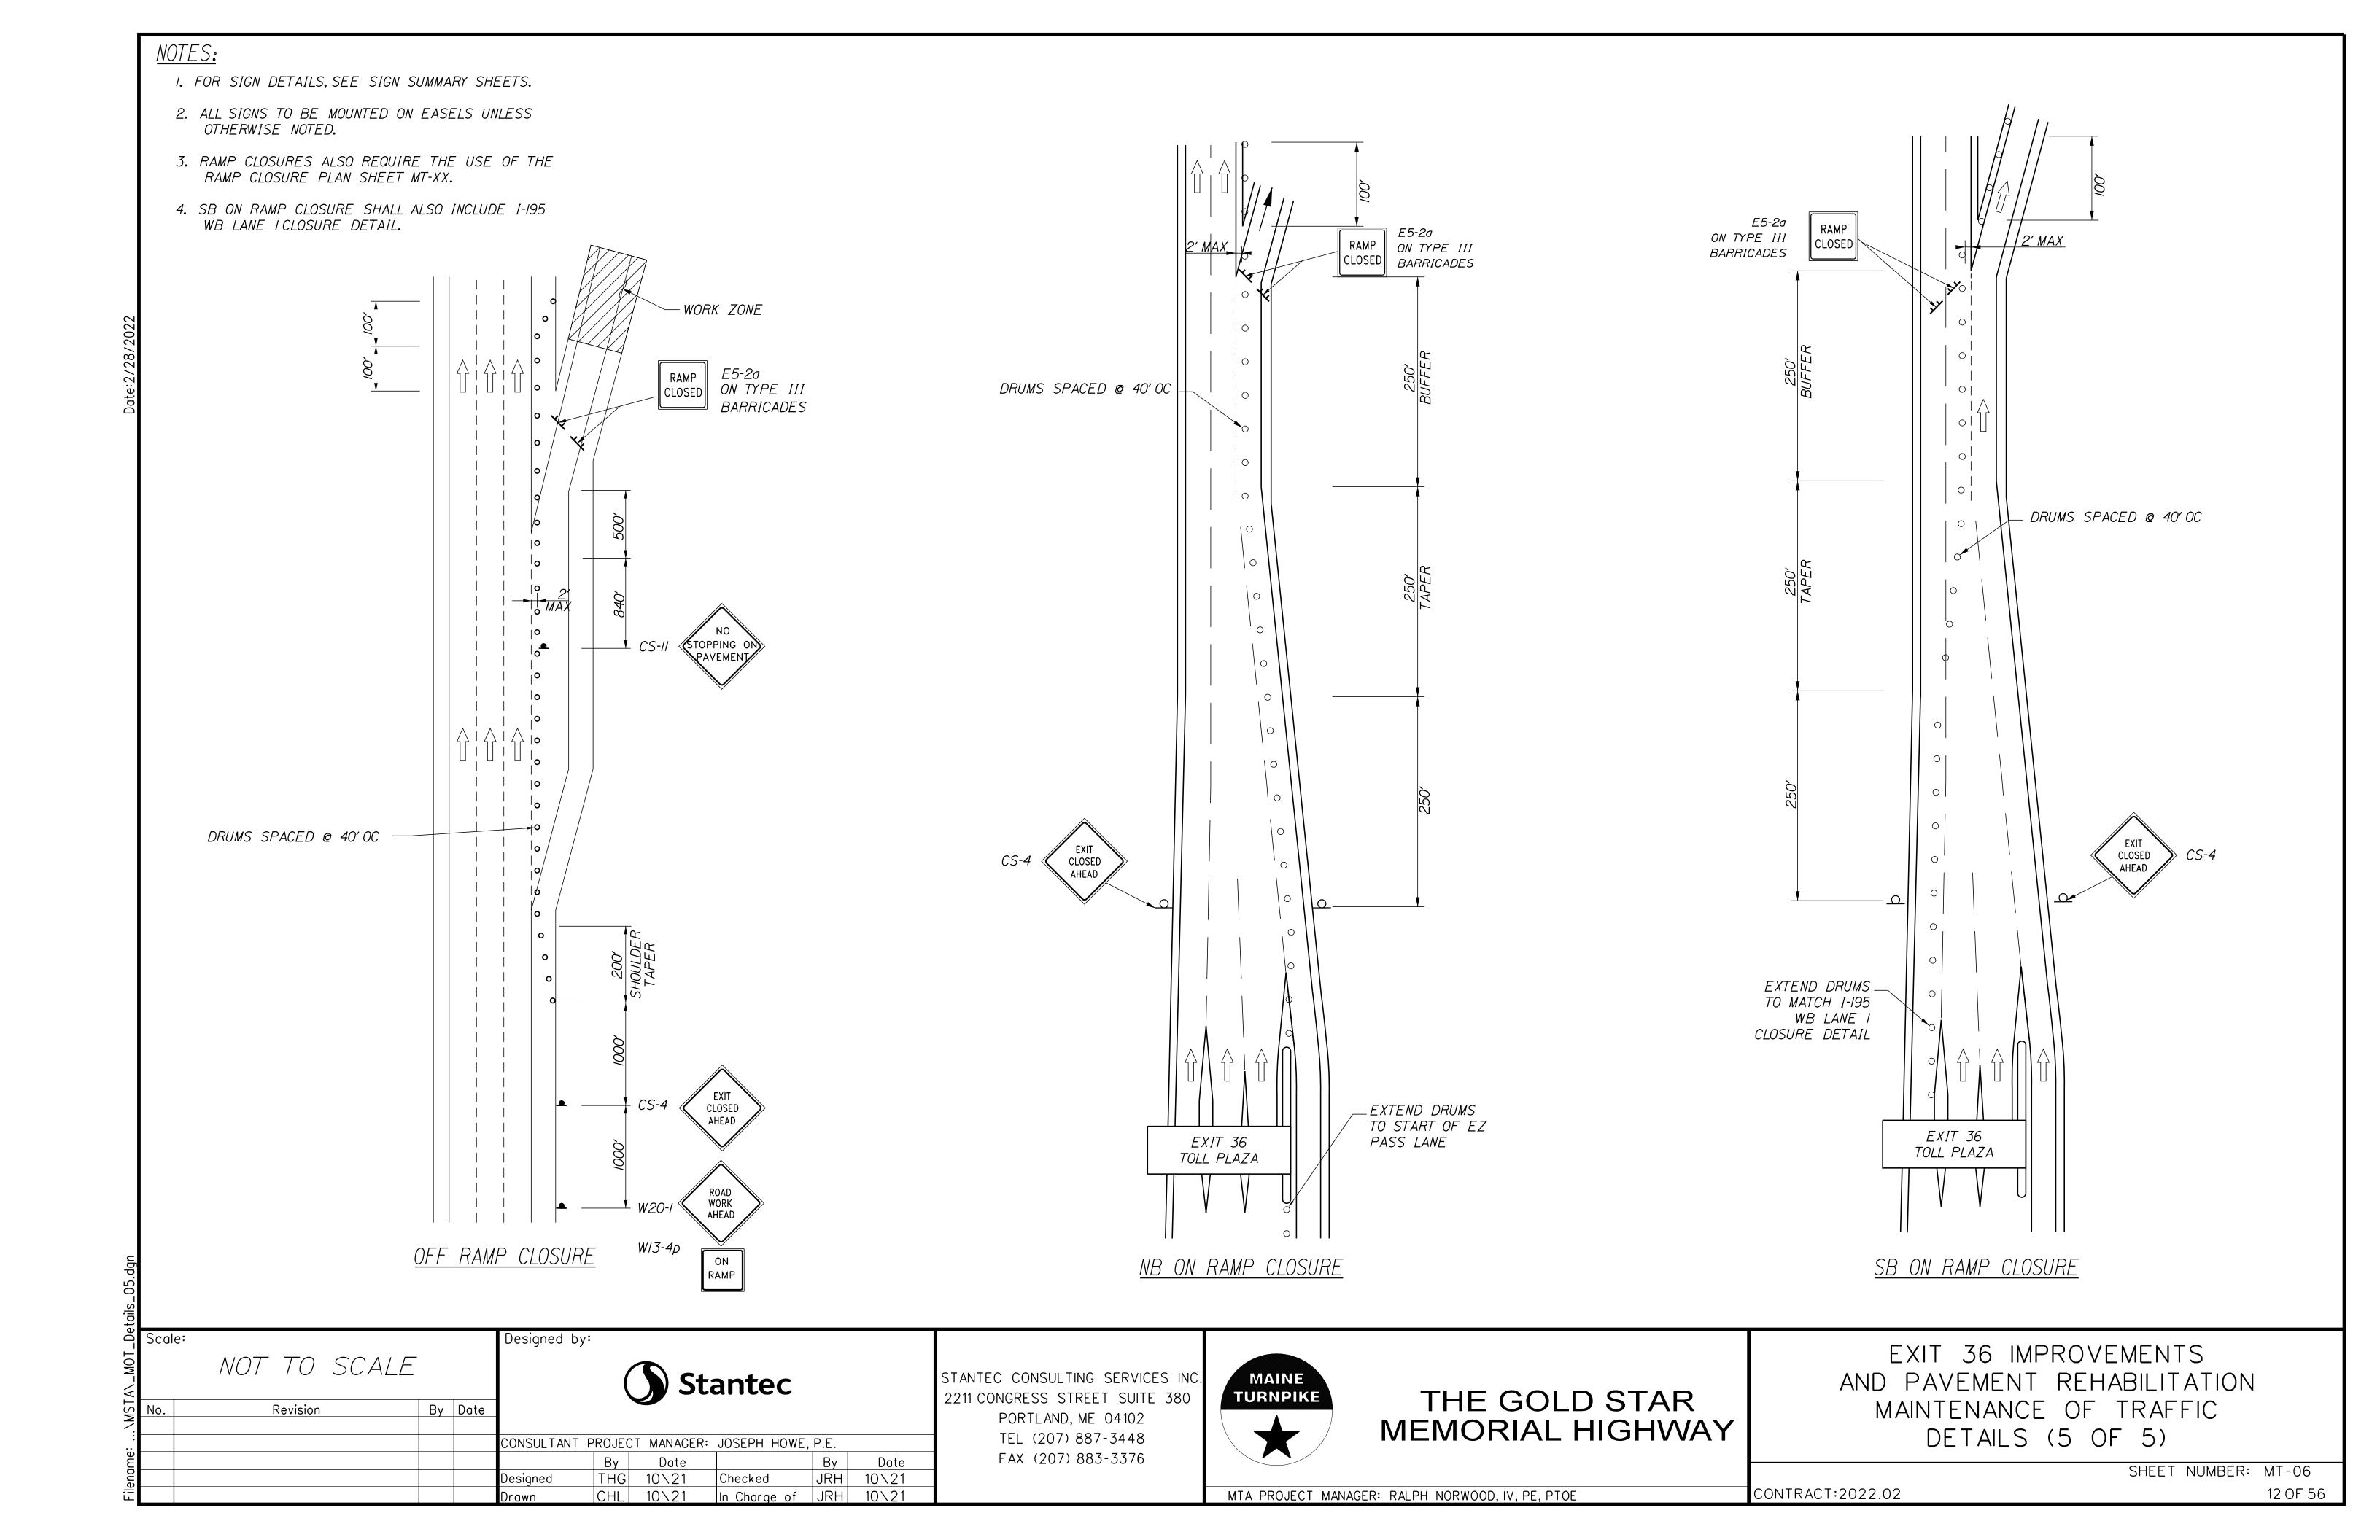MTA PROJECT MANAGER: RALPH NORWOOD, IV, PE, PTOE

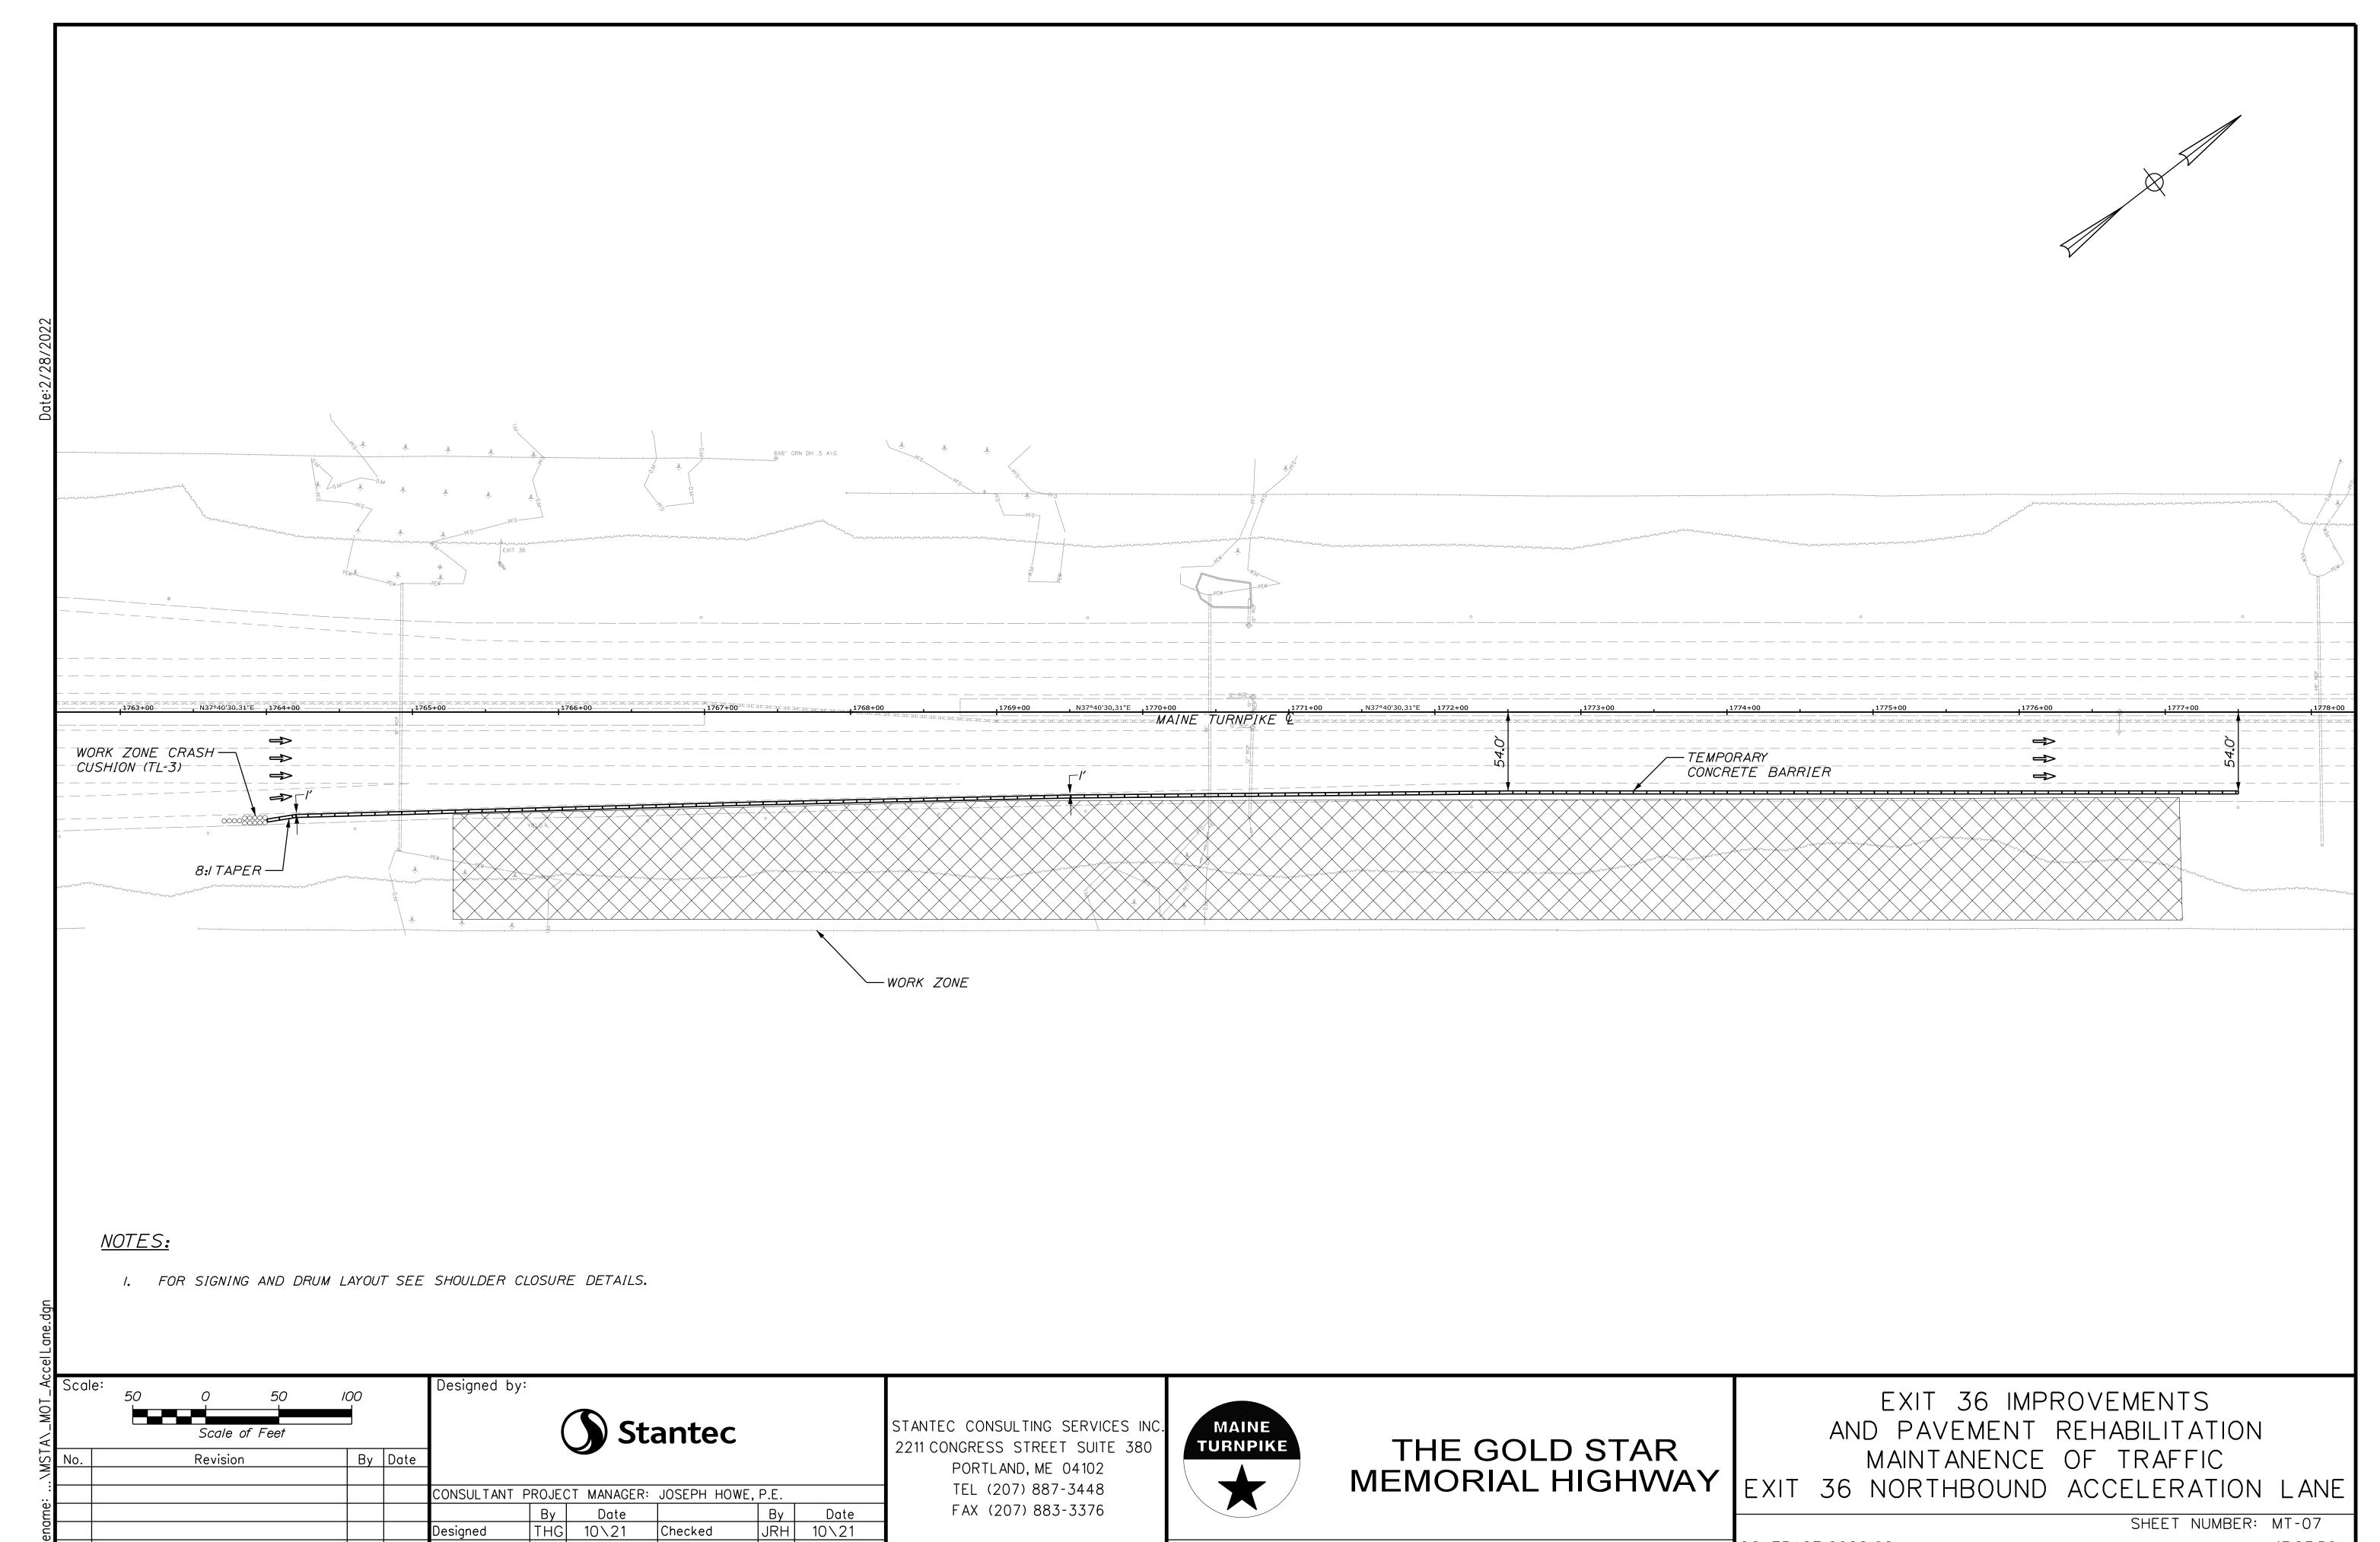SHEET NUMBER: MT-07 CONTRACT:2022.02 13 OF 56



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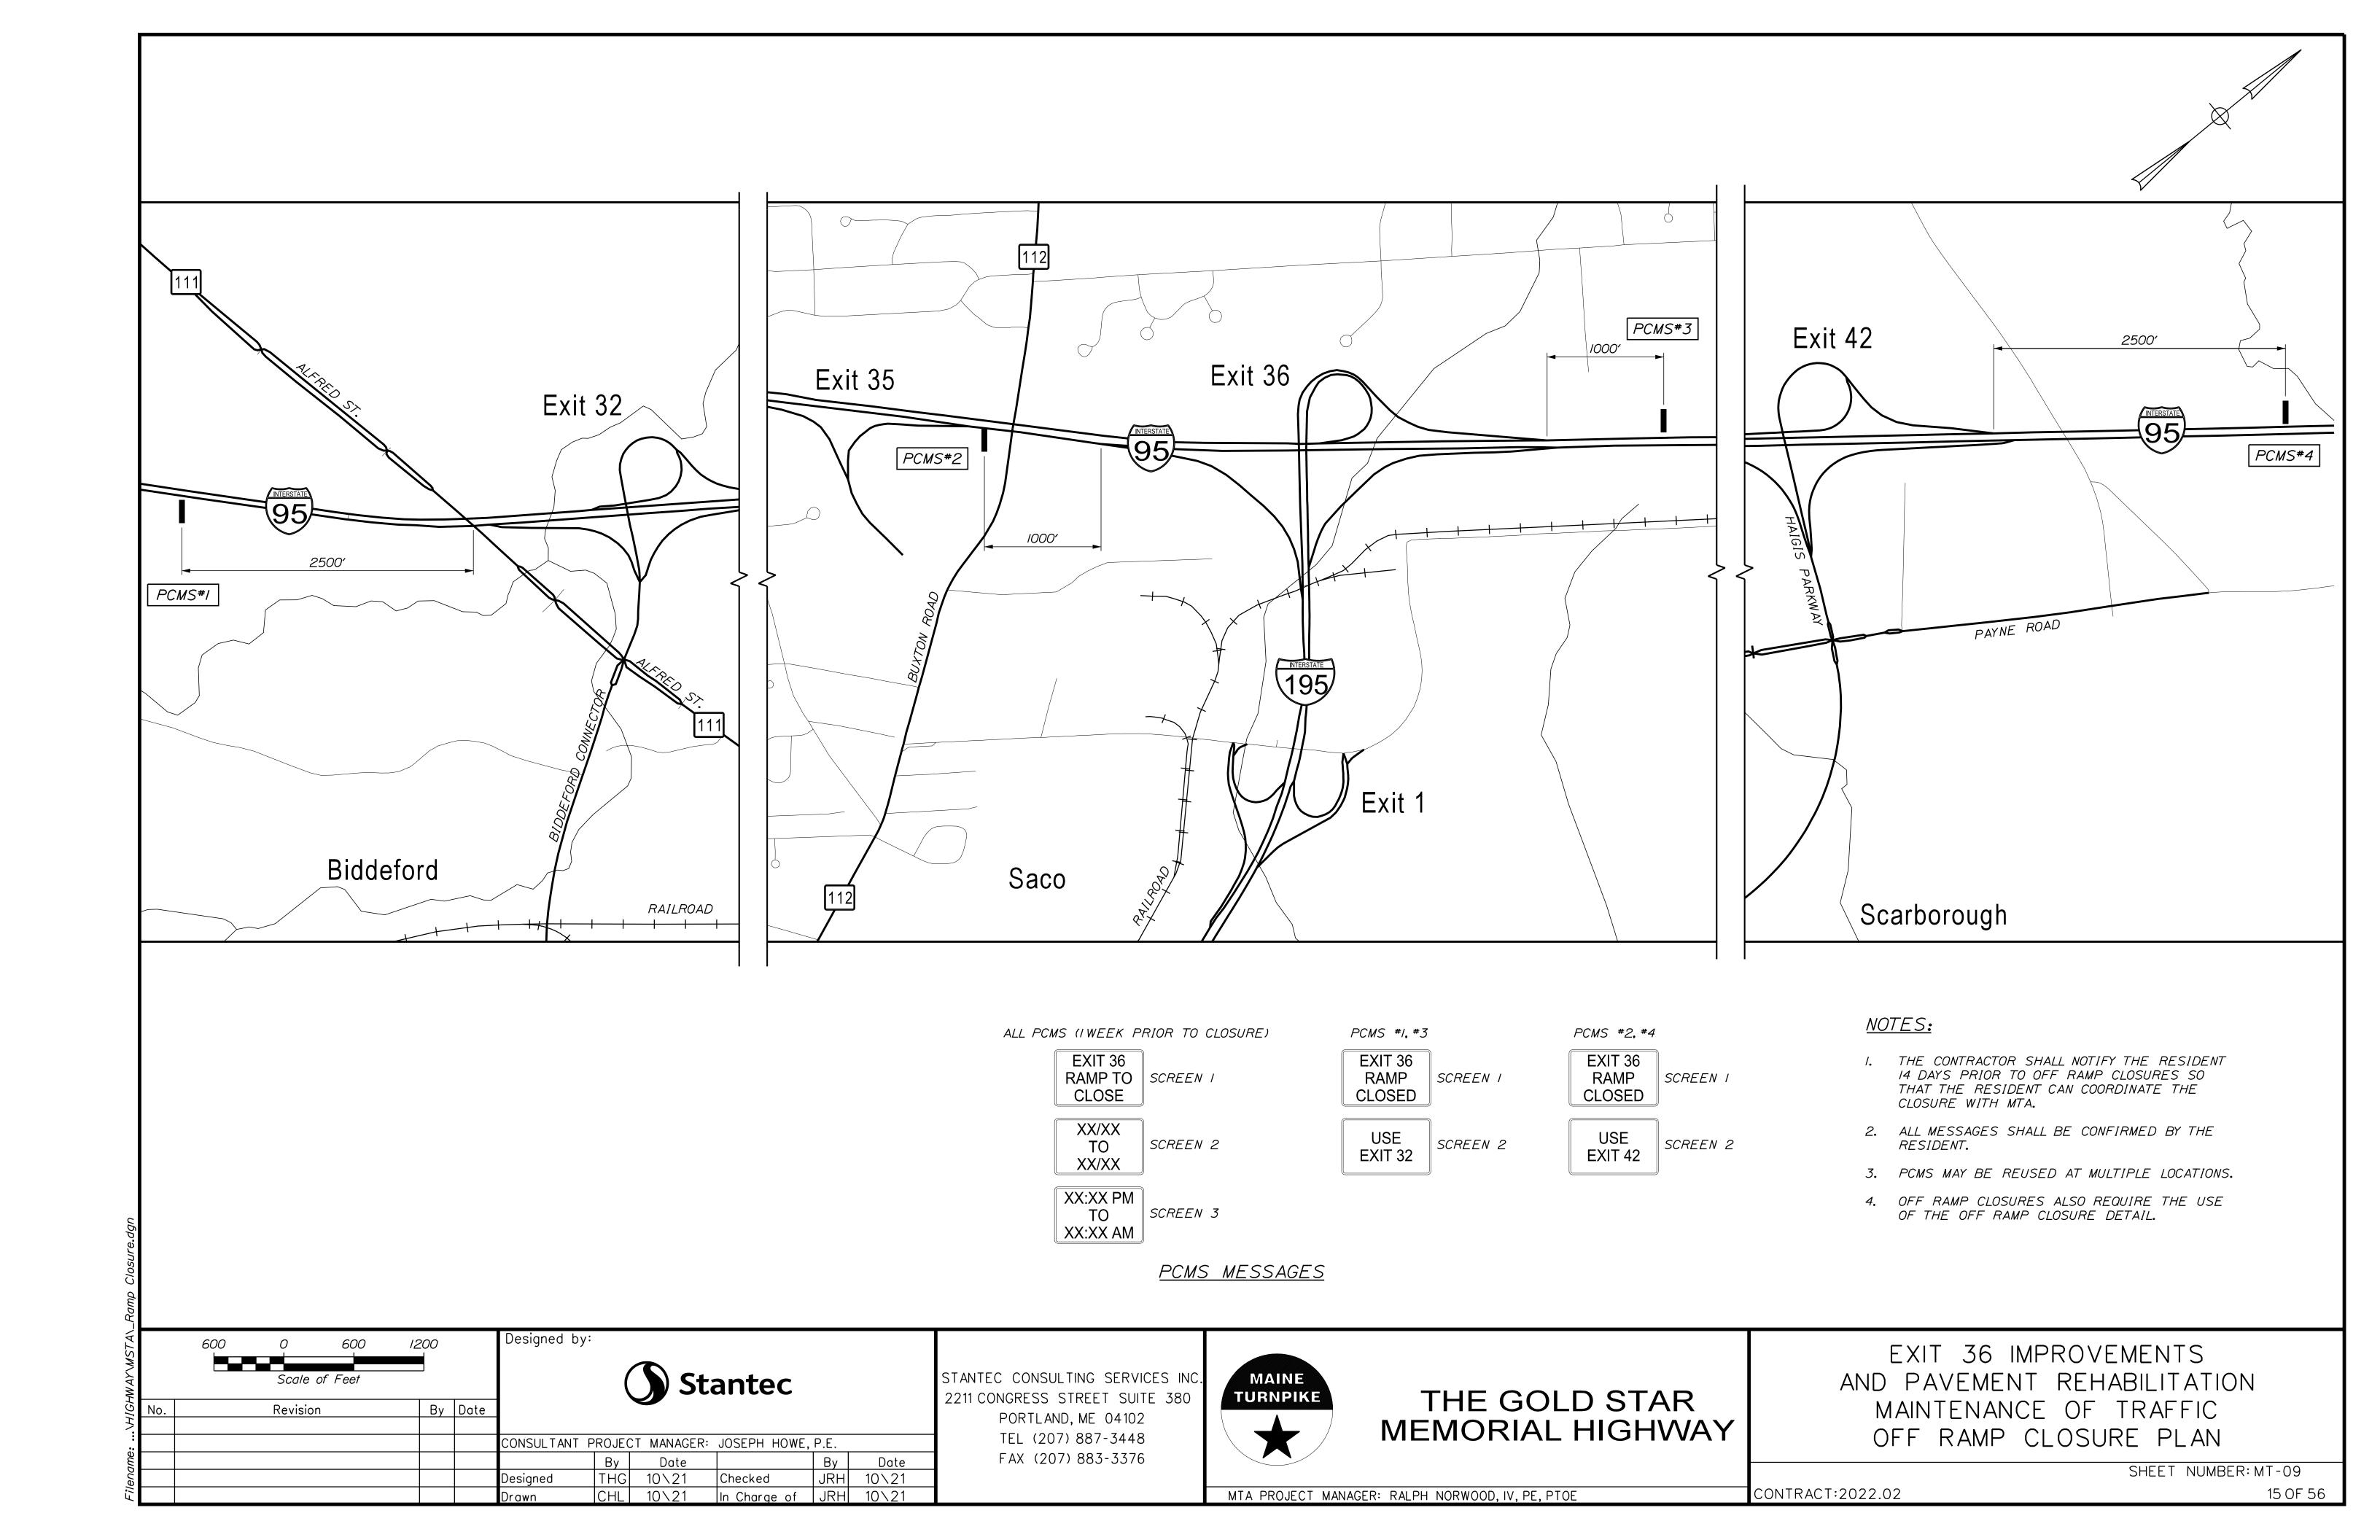
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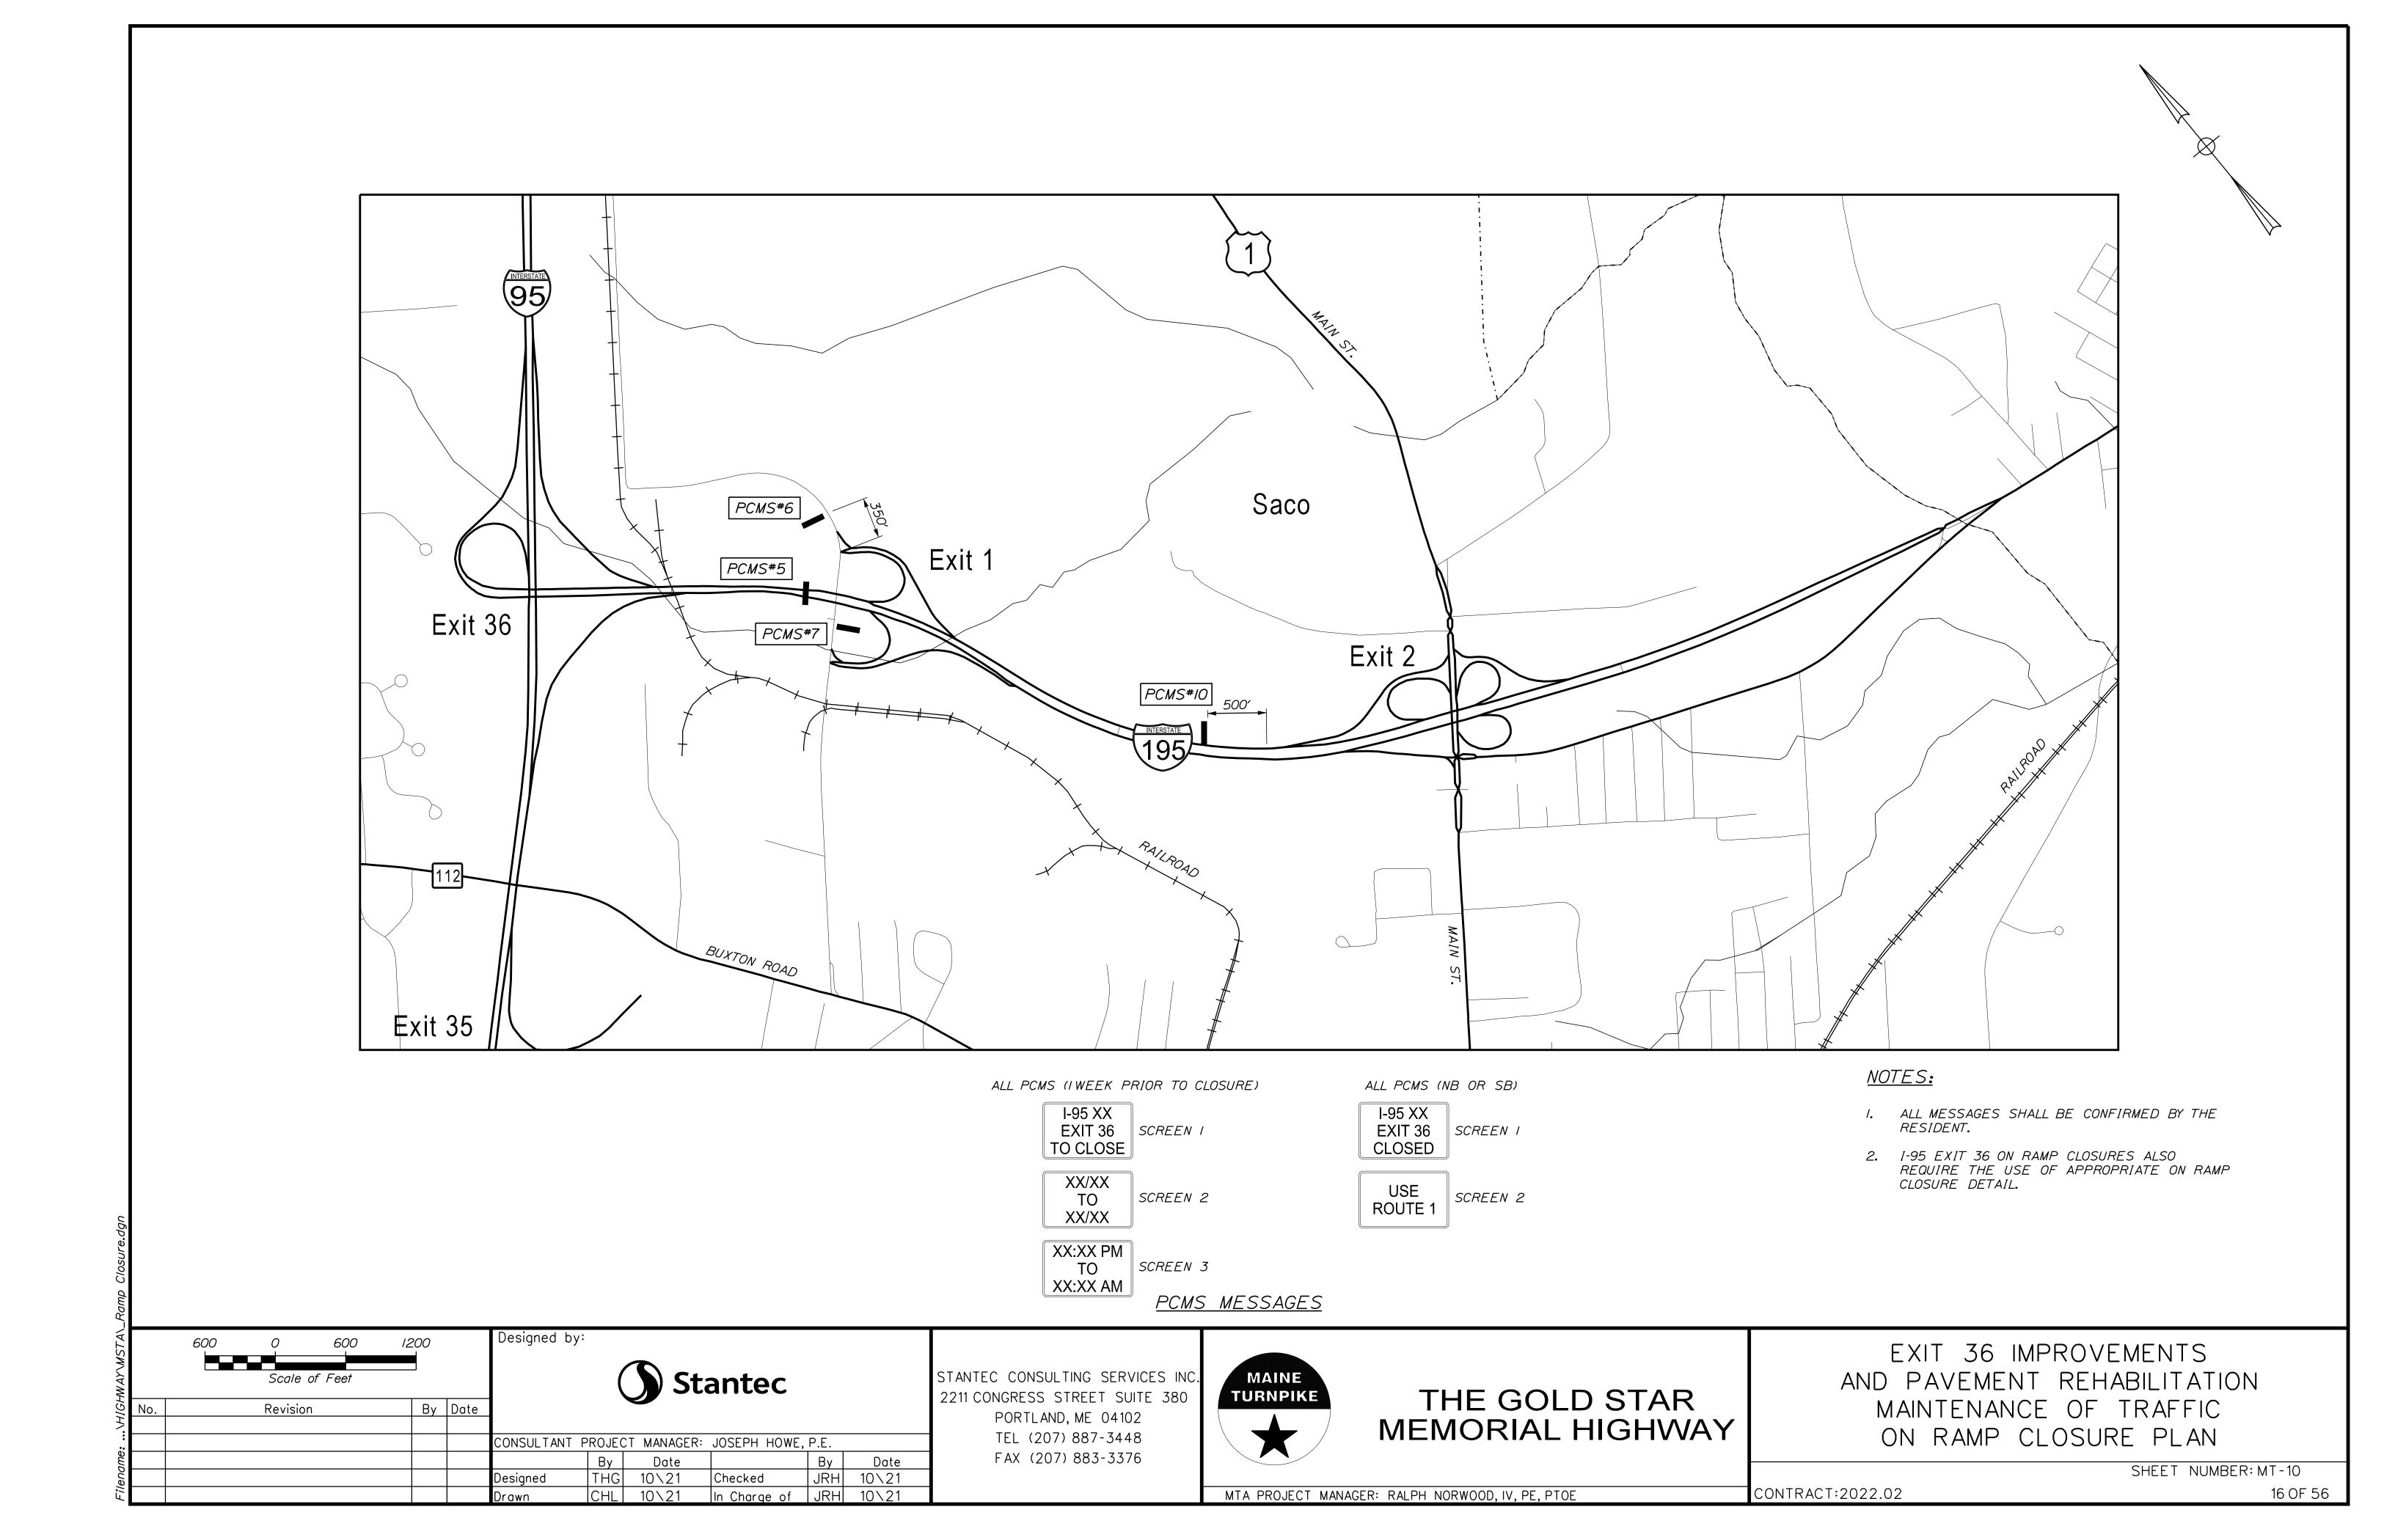


THE GOLD STAR
MEMORIAL HIGHWAY

EXIT 36 IMPROVEMENTS
AND PAVEMENT REHABILITATION
MAINTANENCE OF TRAFFIC
I-195 SHOULDER RECONSTRUCTION

SHEET NUMBER: MT-08
CONTRACT:2022.02 14 OF 56





IDENTIFI- CATION	SI	E OF GN	TEXT	LETTER	MENSIONS VERTICAL	(INCHES) ARROW	NUMBER OF SIGNS REQUIRED	BACK-	LEGEND	BORDER RADIUS	AREA IN SQUARE	NOTES
NUMBER CS-3	WIDTH 48"	HE IGHT	EXPECT STOPPED TRAFFIC	HE IGHT 6" 6" 6"	4" 4"	RIE. MKR.	REQUIRED 6	GROUND ORANGE	BORDER BLACK		16.00 (96)	
CS-4	48"	48"	EXIT CLOSED AHEAD	6" 6" 6"	4" 4"		2	ORANGE	BLACK		16.00 (32)	
CS-10	48"	48"	TRUCKS ENTERING	7" 7"	6"		3	ORANGE	BLACK		16.00 (48)	
CS-II	48"	48"	NO STOPPING ON PAVEMENT	6" 6" 6"	4" 4"		6	ORANGE	BLACK		16.00 (96)	
CS-33	96"	36"	WATCH FOR TRUCKS ENTERING AND LEAVING WORK AREA	6" 6" 6"	4" 4"		4	ORANGE	BLACK		24.00 (96)	
E5-I	72"	60"	EXIT	CONFO HIGH	DIMENSION: PRM TO "ST WAY SIGNS" DI2 SUPPLE	ANDARD ' - 2009	1	GREEN	WHITE		20.00 (20)	
E5-2 (MOD)	60"	48"	EXIT OPEN AHEAD				/	ORANGE	BLACK		20.00 (20)	
E5-2a	60"	48"	EXIT				4	ORANGE	BLACK		20 . 00 (80)	
G20-2	48"	24"	END ROAD WORK				10	ORANGE	BLACK		8.00 (80)	
G20-5aP	48"	24"	WORK ZONE	\ \ \ \ \ \ \ \ \ \ \ \ \ \ \ \ \ \ \	∀	V	6	ORANGE	BLACK		8.00 (48)	
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IDENTIFI-	SIZE		TEXT		DIMENSI	ONS (1	INCHES)	NUMBER OF	COL		BORDER	AREA IN	NOTES
CATION NUMBER	SI: WIDTH	GN HE IGHT	<i>Ι Ε λ Ι</i>	LETTEF HEIGHT	R VERT. SPAC	ICAL CING F	ARROW RTE.MKR	OF SIGNS REQUIRED	BACK- GROUND	LEGEND BORDER	RADIUS	SQUARE FEET	NUI ES
MI-1	36"	36"	95	CONF HIGH	DIMENS ORM TO WAY SIG 2012 SUI	"STAN GNS" - 1	IDARD 2009	3	RED/ BLUE	WHITE		9.00 (27)	
RI-I	48"	48"	STOP					/	RED	WHITE		16.00 (16)	
R2-I 35 50 60	48"	60"	SPEED LIMIT 50					4 2 6	WHITE	BLACK		20.00 (80) (40) (120)	
R2-6aP	48"	24"	FINES DOUBLE					6	WHITE	BLACK		8.00 (48)	
R2-I2	36"	<i>54</i> "	END WORK ZONE SPEED LIMIT					8	WHITE	BLACK		13 . 5 (108)	
R4-9	36"	48"	STAY IN LANE					4	WHITE	BLACK		12.00 (48)	
W3-/	48"	48"						/	ORANGE	BLACK/ RED		16.00 (16)	
W3-4	48"	48"	BE PREPARED TO STOP					6	ORANGE	BLACK		16.00 (96)	
W3-5 35 50 60	48"	48"	SPEED LIMIT 50					4 2 6	ORANGE	BLACK		16.00 (64) (32) (96)	
W <i>4</i> -1	48"	48"						/	ORANGE	BLACK		16.00 (16)	

CONTRACT:2022.02

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Revision By Date CONSULTANT PROJECT MANAGER: JOSEPH HOWE, P.E.

By Date THG 10\21

Designed

Stantec

By Date
Checked JRH 10\21
In Charge of JRH 10\21

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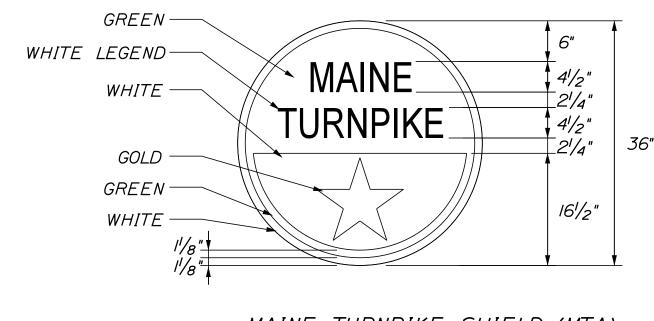
THE GOLD STAR MEMORIAL HIGHWAY

EXIT 36 IMPROVEMENTS AND PAVEMENT REHABILITATION MAINTENANCE OF TRAIFFIC SIGN SUMMARY (1 OF 2)

> SHEET NUMBER: MT-11 17 OF 56

IDENTIFI- CATION		C OF GN	TEXT	TEXT DI	VER7	ICAL	ARRO)W	NUMBER OF SIGNS	COL BACK-	OR LEGEND	BORDER	AREA IN SQUARE	NOTES	
NUMBER		HE IGHT		HEIGHT	SPA	CING	RTE. M	KR.	SIGNS REQUIRED	GROUND	BORDER	RADIUS	FEET		
W4-2 (LEFT) (RIGHT)	48"	48"			RM TO NAY S	"STA	NDARE - 2009)	2 6	ORANGE	BLACK		16.00 (32) (96)		
W7-3aP	36"	30"	NEXT X FEET						6	ORANGE	BLACK		7.50 (45)		
W8-I	48"	48"	BUMP						8	ORANGE	BLACK		16 . 00 (128)		
W8-II	48"	48"	UNEVEN						4	ORANGE	BLACK		16.00 (64)		
W8-15	48"	48"	GROOVED						9	ORANGE	BLACK		16.00 (144)		
W8-I5P	30"	24"							9	ORANGE	BLACK		5.00 (45)		
W8-24a	48"	48"	RUMBLE STRIPS AHEAD						4	ORANGE	BLACK		16.00 (64)		
W13-4P	30"	30"	ON RAMP						4	ORANGE	BLACK		6 . 25 (25)		
WI6-4P	36"	30"	NEXT X MILES						2	ORANGE	BLACK		7.50 (15)		
W2O-I (I MILE) (AHEAD)	48"	48"	ROAD WORK 1 MILE	N N			V		10 14	ORANGE	BLACK		16.00 (160) (224)		
cale:			Designed	d by:		1	V							 	

CATION	SIZE SIG		TEXT				(INCHES)	0F	COL			AREA IN	•
	'IDTH	HEIGHT	, _ , ,	LETTER HEIGHT	VERT SPA	TICAL CING	ARROW RTE.MKR.	SIGNS REQUIRED	BACK- GROUND	LEGEND BORDER	BORDER RADIUS	SQUARE FEET	NOTES
W20-4	48"	48"	ONE LANE ROAD AHEAD	HIGHV	DIMENS RM TO VAY SIO	"STAN GNS" -	IDARD 2009	4	ORANGE	BLACK		16.00 (64)	
W2O-5 (LEFT) (RIGHT) (LANE CLOSED)	48"	48"	LEFT LANE CLOSED 1/2 MILE					2 6 3	ORANGE	BLACK		16.00 (32) (96) (48)	
W20-7	48"	48"						5	ORANGE	BLACK		16.00 (80)	
W2I-5	48"	48"	SHOULDER WORK					3	ORANGE	BLACK		16.00 (48)	
W2I-5aR (LEFT) (RIGHT)	48"	48"	RIGHT SHOULDER CLOSED					/ /	ORANGE	BLACK		16.00 (16) (16)	
W2I-5bR (LEFT) (RIGHT)	48"	48"	RIGHT SHOULDER CLOSED 1000 FT	V	7	7	₩	/ /	ORANGE	BLACK		16.00 (16) (16)	
LOGO S	36"	36"	MAINE TURNPIKE		SEE D	ETAIL	S	3	SEE Di	ETAILS		9 . 00 (27)	



NOTE: FOR 24" SHEILD REDUCE ALL MEASUREMENTS BY 1/3.

MAINE TURNPIKE SHIELD (MTA)
NOT TO SCALE

CONTRACT:2022.02

NOT TO SCALE

No. Revision By Date

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By Date THG 10\21

Designed

CONSULTANT PROJECT MANAGER: JOSEPH HOWE, P.E.

Stantec

By Date
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In Charge of JRH 10\21


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PORTLAND, ME 04102

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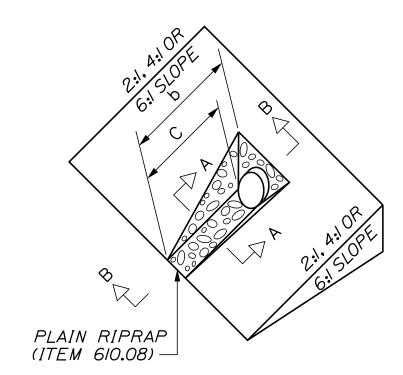



THE GOLD STAR MEMORIAL HIGHWAY EXIT 36 IMPROVEMENTS
AND PAVEMENT REHABILITATION
MAINTENANCE OF TRAFFIC
SIGN SUMMARY (2 OF 2)

SHEET NUMBER: MT-12 18 OF 56

DIMENSIONS FOR SLOPE OF 2:1

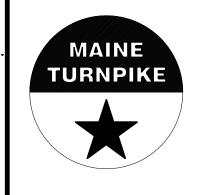							STONE	STONE
D	а	ь	С	е	f	g	DEPTH	(CY)
	(FT)	(FT)	(FT)	(FT)	(FT)	(FT)	(FT)	
12"	1.00	4.00	3.00	2.00	6.00	1.00	1.50	1.30
15"	1.00	4.50	3.37	2.25	6.75	1.63	1.50	1.70
18"	1.00	5.00	3.75	2.50	7.50	2.25	1.50	2.09
21"	1.00	5.50	4.13	2.75	8.25	2.88	1.50	2.58
24"	1.00	6.00	4.50	3.00	9.00	3.50	1.50	3.12
30"	1.00	7.00	5.25	3.50	10.50	4.75	1.50	4.33
36"	1.00	8.00	6.00	4.00	12.00	6.00	1.50	5.75
42"	1.00	9.00	6.75	4.50	13.50	7.25	1.50	7.37
48"	1.00	10.00	7.50	5.00	15.00	8.50	1.50	9.18
54"	1.00	11.00	8.25	5.50	16.50	9.75	1.50	11.19
60"	1.00	12.00	9.00	6.00	18.00	11.00	1.50	13.40
66"	1.00	13.00	9.75	6.50	19.50	12.25	1.50	15.81
72"	1.00	14.00	10.50	7.00	21.00	13.50	1.50	18.41
84"	1.00	16.00	12.00	8.00	24.00	16.00	1.50	24.22



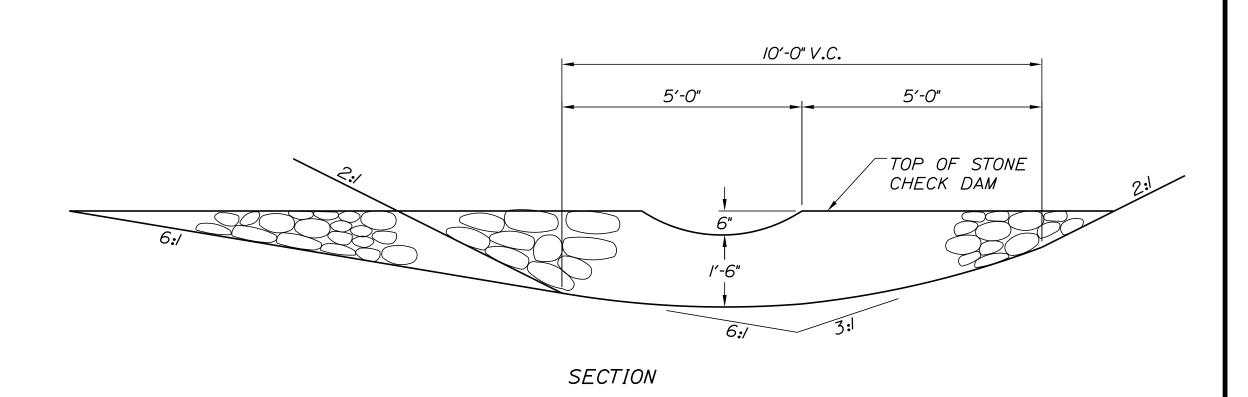

DIMENSIONS FOR SLOPE OF 4:1

							STONE	STONE
D	а	b	С	е	f	g	DEPTH	(CY)
	(FT)	(FT)	(FT)	(FT)	(FT)	(FT)	(FT)	
12"	1.00	8.00	6.00	2.00	6.00	0.00	1.50	2.20
15"	1.00	9.00	6.75	2.25	6.75	0.00	1.50	2.80
18"	1.00	10.00	7.50	2.50	7.50	0.00	1.50	3.40
21"	1.00	11.00	8.25	2.75	8.25	0.00	1.50	4.10
24"	1.00	12.00	9.00	3.00	9.00	0.00	1.50	4.86
30"	1.00	14.00	10.50	3.50	10.50	0.00	1.50	6.58
36"	1.00	16.00	12.00	4.00	12.00	0.00	1.50	8.56
42"	1.00	18.00	13.50	4.50	13.50	0.50	1.50	10.92
48"	1.00	20.00	15.00	5.00	15.00	1.00	1.50	13.57
54"	1.00	22.00	16.50	5.50	16.50	1.50	1.50	16.50
60"	1.00	24.00	18.00	6.00	18.00	2.00	1.50	19.72
66"	1.00	26.00	19.50	6.50	19.50	2.50	1.50	23.22
72"	1.00	28.00	21.00	7.00	21.00	3.00	1.50	27.01
84"	1.00	32.00	24.00	8.00	24.00	4.00	1.50	35.45

DIMENSIONS FOR SLOPE OF 6:1

(FT)

2.00

2.25

2.50

3.00

3.50

4.00

4.50

5.00

5.50

6.00

6.50

7.50

1.50

1.75

(FT)

4.50

5.50

6.50

7.25

8.00

9.50

11.00

12.50

14.00

15.50

17.00

18.50

20.00

23.00

(FT)

0.00

0.00

(FT)

9.00

10.50

12.00

13.50

15.00

18.00

21.00

24.00

27.00

30.00

33.00

36.00

39.00

45.00

(FT)

0.50

0.50

12"

15"

18"

21'

24"

30"

36"

42"

48"

54"

60"

66"

72"

84"

(FT)

7.50

8.75

10.00

11.25

12.50

15.00

17.50

20.00

22.50

25.00

27.50

30.00

32.50

37.50

STONE

(CY)

2.30

2.93

3.57

4.46

5.44

7.71

10.37

13.42

16.87

20.70

24.93

29.55

34.56

45.76

STONE

DEPTH

(FT)

1.50

1.50

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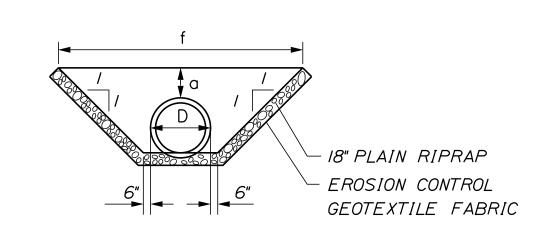
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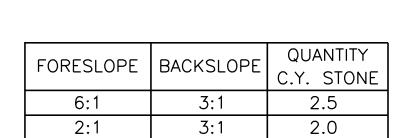
1.50

1.50



SECTION B-B



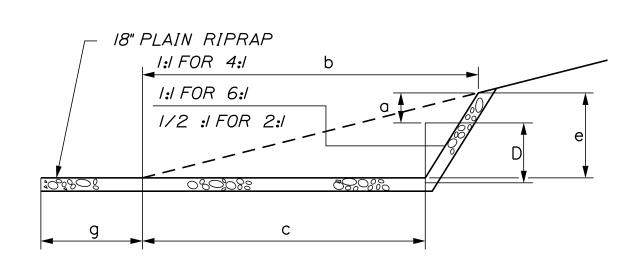

9'-10" (6**:**1 FORESLOPE)

6'-0" (2:1 FORESLOPE)

STONE DITCH CHECK DAM
(SEE PLAN SHEETS FOR LOCATION)

TOP OF STONE 7′-2" NOTES:

BOTTOM OF STONE

OF MDOT SPECIFICATION 703.29, STONE DITCH 2. TEMPORARY STONE CHECK DAMS WILL BE

I.STONE FOR TEMPORARY AND PERMANENT STONE

CHECK DAMS SHALL MEET THE REQUIREMENTS

PAID FOR UNDER ITEM 610.181.

ROADWAY CULVERT END SLOPE TREATMENT

SECTION A-A

I. THE DIMENSIONS SHOWN ARE APPROXIMATE AND MAY BE MODIFIED BY THE RESIDENT. 2.STONE QUANTITIES ARE FOR ONE END OF THE PIPE.

STONE CHECK DAM

PLAN

Scale:				Designed b	y:					
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No.	Revision	Ву	Date	- -						1
				CONSULTANT	PROJEC	T MANAGER	: JOSEPH HOWE	, P.E.		
					Ву	Date		Ву	Date	
				Designed	THG	10\21	Checked	JRH	10\21	
Ĕ				Drawn	CHL	10\21	In Charge of	JRH	10\21	


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THE GOLD STAR MEMORIAL HIGHWAY

EXIT 36 IMPROVEMENTS AND PAVEMENT REHABILITATION DRAINAGE DETAILS (1 OF 2)

SHEET NUMBER: DT-01 19 OF 56 CONTRACT:2022.02



MTA PROJECT MANAGER: RALPH NORWOOD, IV, PE, PTOE

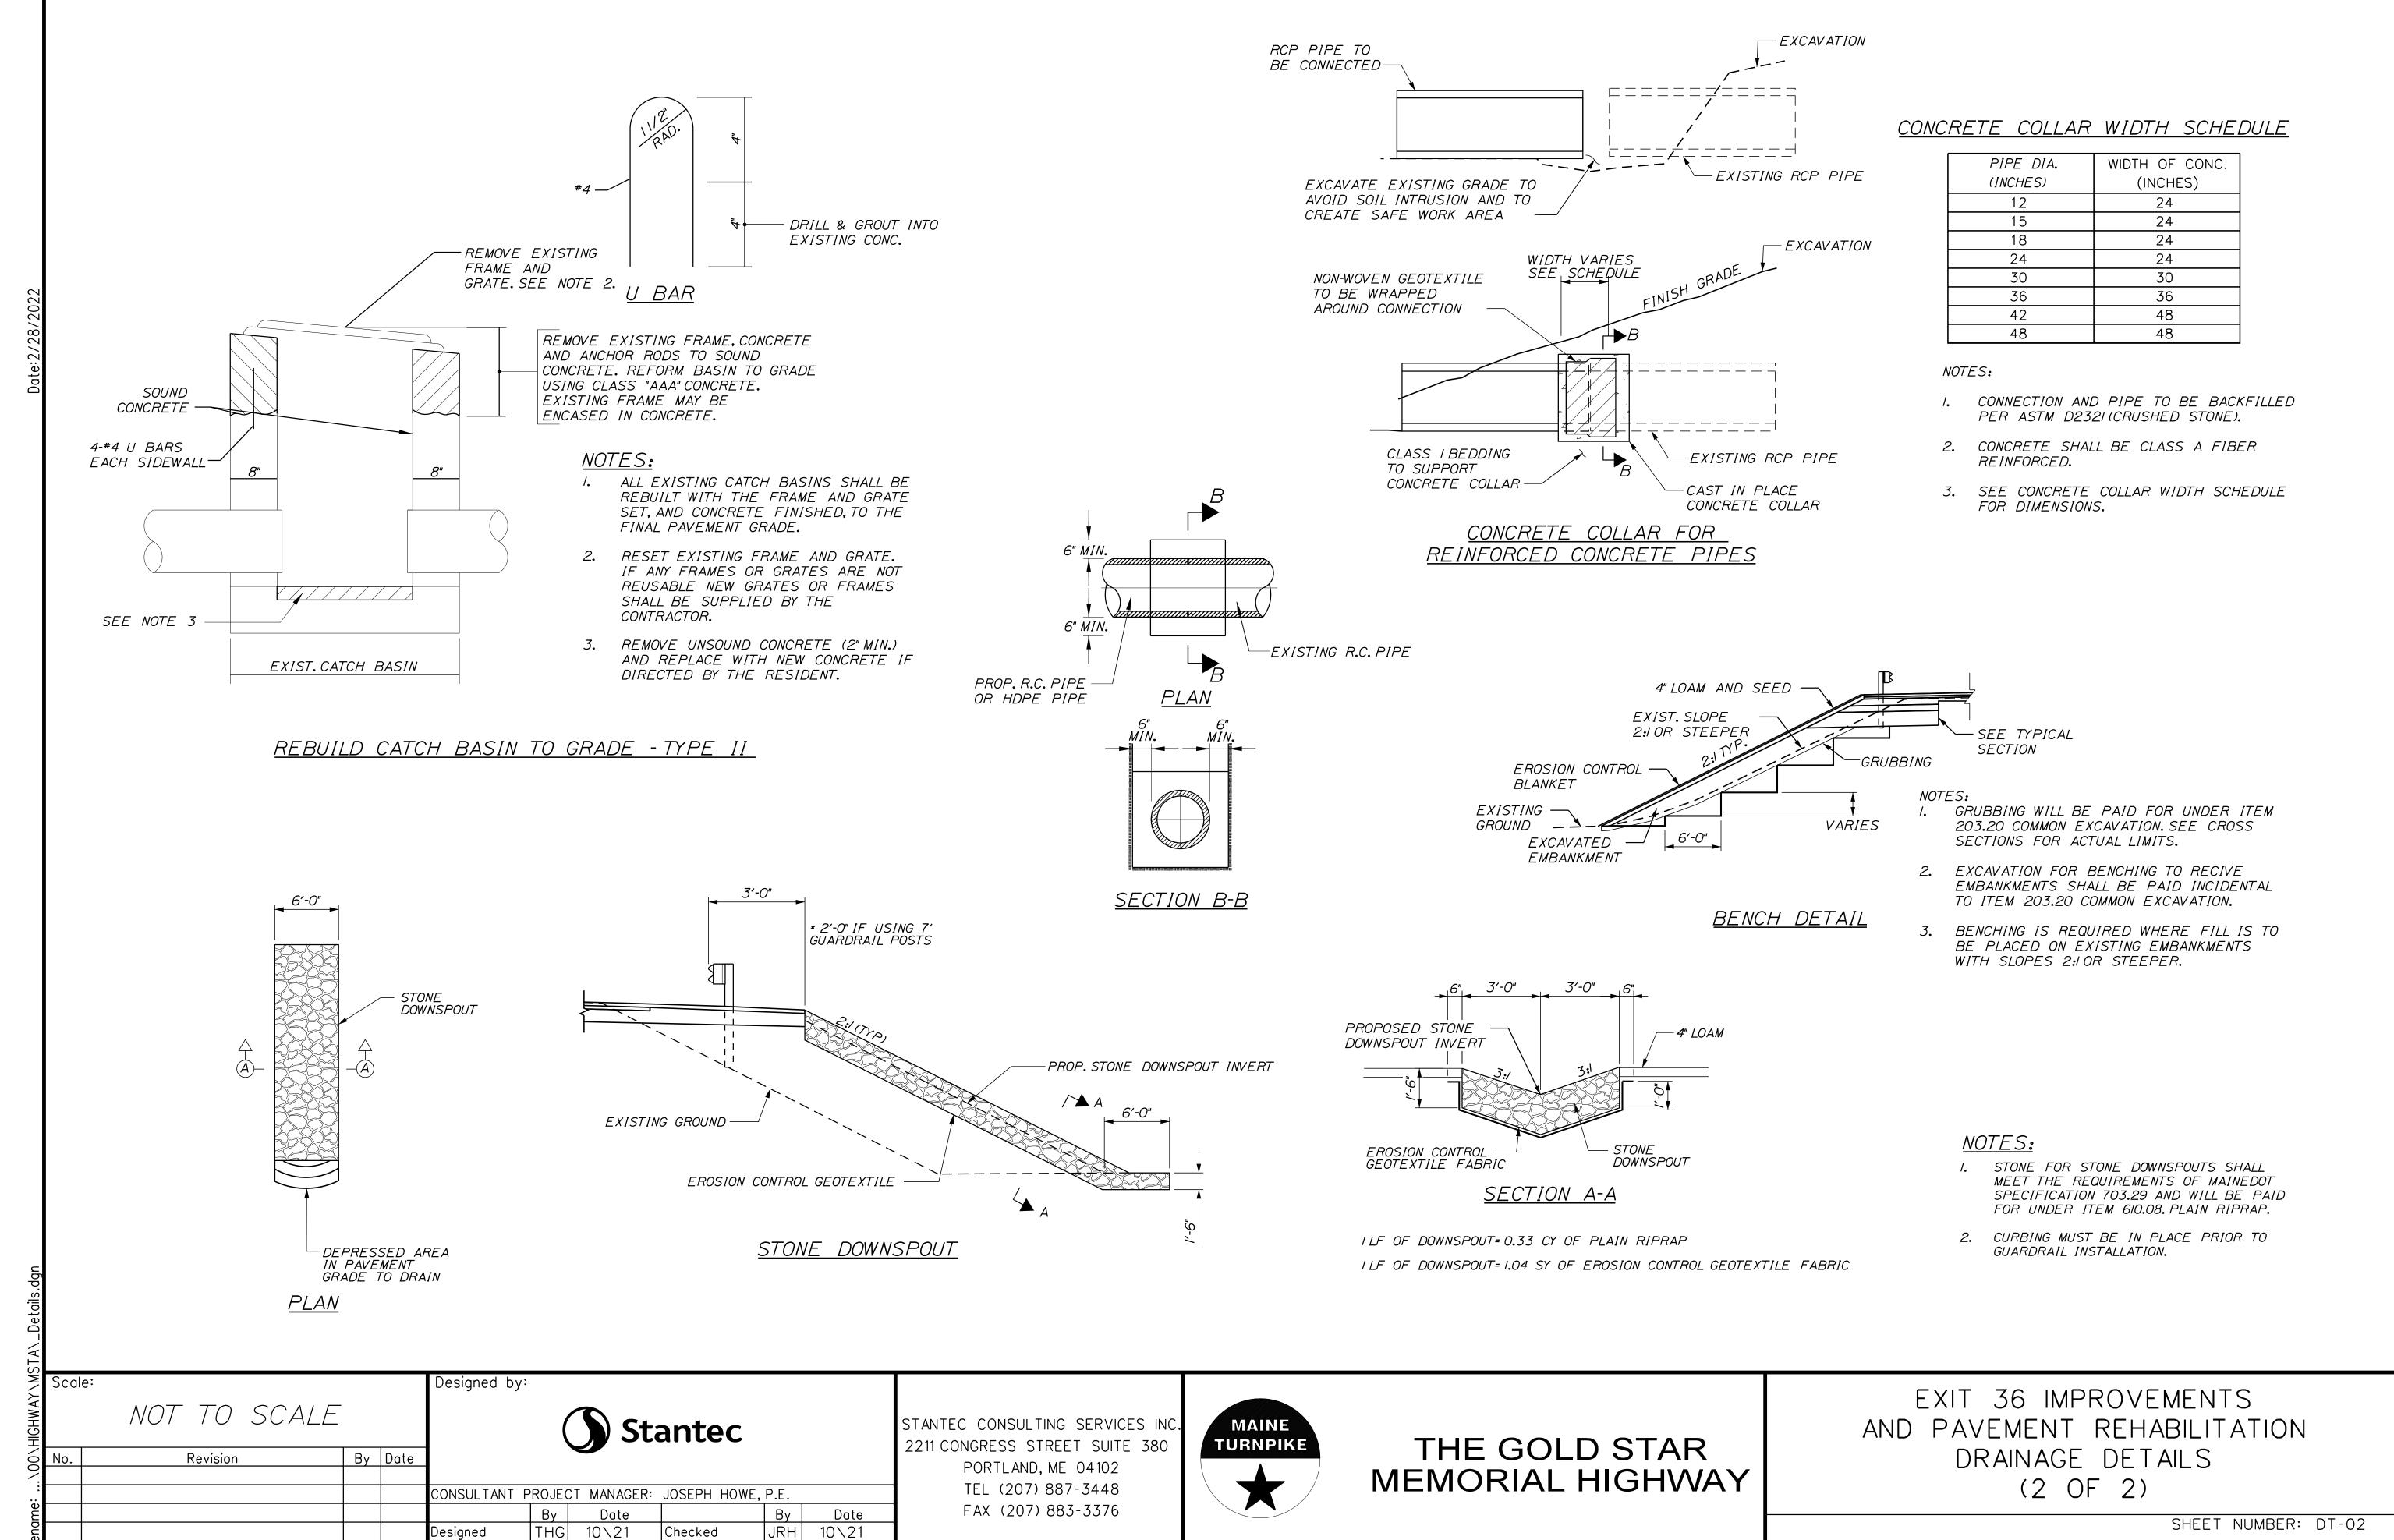
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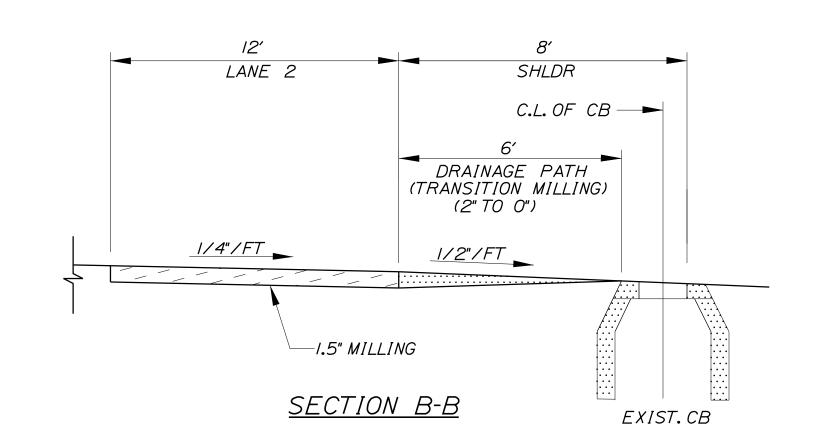
In Charge of JRH 10\21

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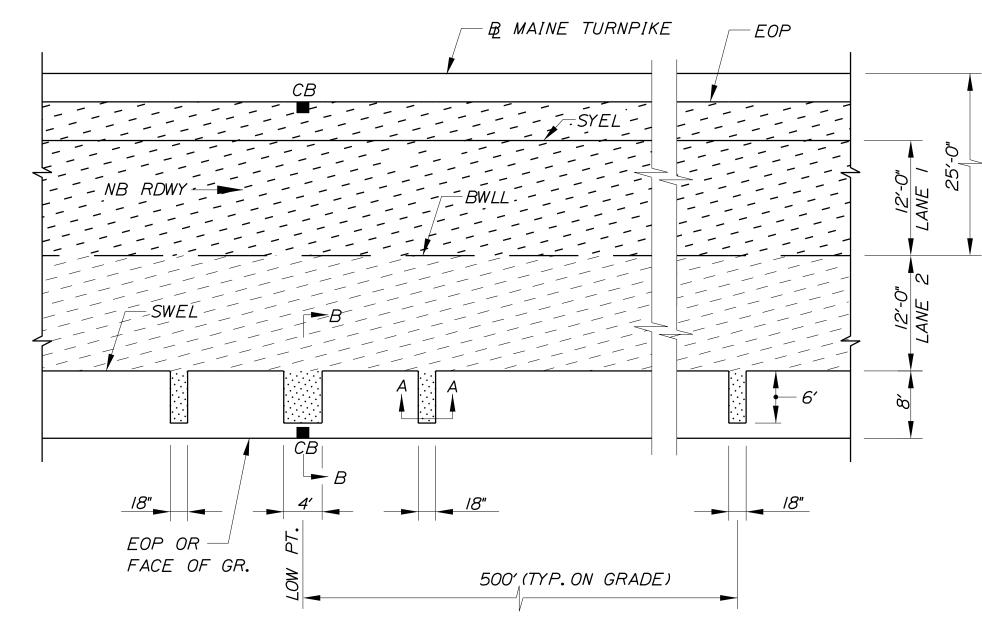
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20 OF 56








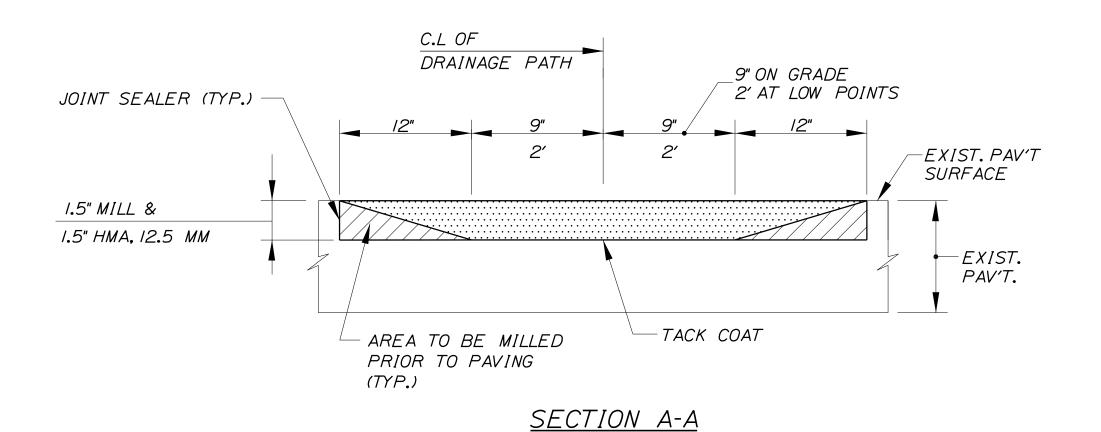



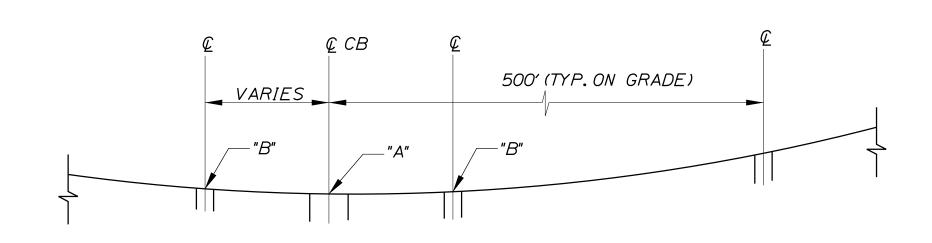

PROFILE ALONG EDGE OF MILLING

<u>LEGEND</u>

= DRAINAGE PATH MILLING

= TRAVEL LANE MILLING

NOTES:

I. POINT "B" IS I" HIGHER THAN POINT "A".

2. DRAINAGE PATH REQUIRED AT ALL LOW POINTS.

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No.	Revision	Ву	Date	1	·					
				CONSULTANT F	PROJEC	CT MANAGER:	JOSEPH HOWE,	P.E.		
					Ву	Date		Ву	Date	
2				Designed	THG	10\21	Checked	JRH	10\21	
<u> </u>				Drawn	CHL	10\21	In Charge of	JRH	10\21	

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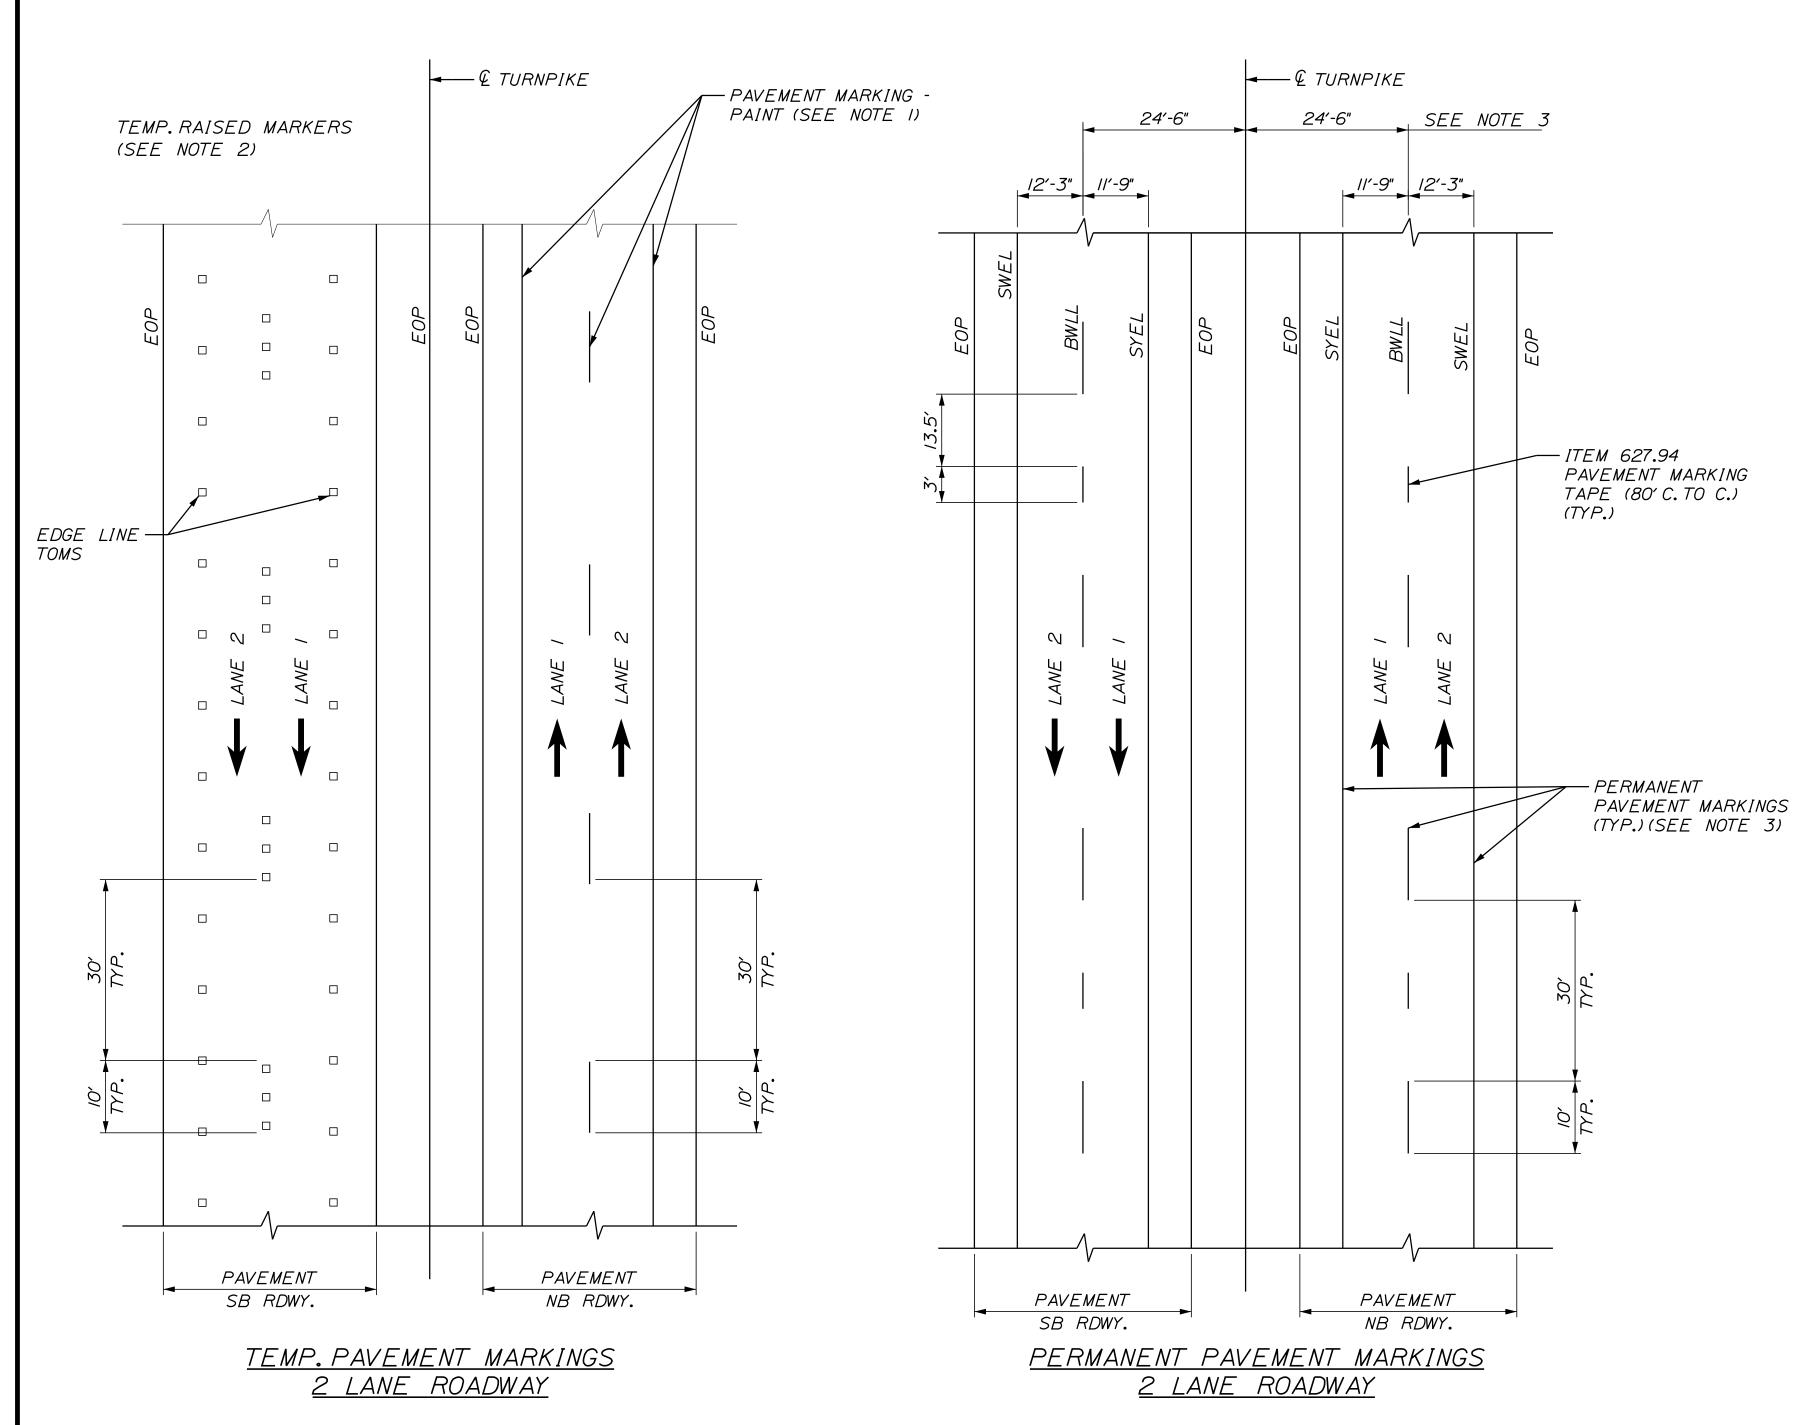
THE GOLD STAR MEMORIAL HIGHWAY

EXIT 36 IMPROVEMENTS AND PAVEMENT REHABILITATION

DRAINAGE PATH FOR MILLING DETAILS

SHEET NUMBER: DT-03 210F 56

MTA PROJECT MANAGER: RALPH NORWOOD, IV, PE, PTOE



80'-0"

80'-0"

80'-0"

80'-0"

80'-0"

5'-0"

5'-0"

ITEM 627.94
PERMANENT PAVEMENT
MARKINGS WITH TAPE
GROOVING DETAIL

<u>LEGEND</u>

SYEL = SOLID YELLOW EDGE LINE (6" PAINT)

SWEL = SOLID WHITE EDGE LINE (6" PAINT)

BWLL = BROKEN WHITE LANE LINE (6" PAINT)

EOP = EDGE OF PAVEMENT

NOTES:

- PERMANENT PAVEMENT MARKINGS SHALL BE 6" WIDE LINES.
- 2. PERMANENT PAVEMENT MARKINGS SHALL BE INSTALLED ON BOTH ROADWAYS.
- 3. THE OFFSET DISTANCE SHOWN ARE MEASURED FROM THE CENTER OF THE 6" PAINT LINES.
- 4. ALL EXISTING PAINT MARKINGS SHALL BE REMOVED PRIOR TO INSTALLATION OF ITEM 627.94 PAVEMENT MARKING TAPE AND SHALL BE INCIDENTAL TO INSTALLATION OF THE TAPE.
- 5. ON DECELERATION RAMPS, THE DWLL SHALL BEGIN AT THE BEGINNING OF THE FULL WIDTH DECELERATION LANE AND EXTEND TO THE THEORETICAL GORE MARKINGS.
- 6. ITEM 627.94 PAVEMENT MARKING TAPE FOR DWLL SHALL BE INSTALLED IN AN "IN-AND-OUT" GROOVING PATTERN. SEE DETAIL THIS SHEET.

NOTES:

- I. TEMPORARY PAVEMENT MARKINGS ON MILLED PAVEMENT SHALL BE 6" SOLID WHITE, BROKEN WHITE, AND SOLID YELLOW PAINT LINES.
- 2. TEMPORARY PAVEMENT MARKINGS ON NEW HMA 12.5mm, OR SHIM MATERIAL, SHALL BE TEMPORARY RAISED PAVEMENT MARKERS. "SOLID" WHITE AND "SOLID" YELLOW LANE LINES SHALL BE TEMPORARY RAISED PAVEMENT MARKERS SPACED AT 10'-O" C. TO C. "BROKEN" WHITE LANE LINES SHALL BE TEMPORARY RAISED PAVEMENT MARKERS SPACED 5'-O" C. TO C. EVERY 40'-O". TEMPORARY 6" PAVING MARKING TAPE SHALL BE USED ON RADII ON SURFACE PAVEMENT. A 3' PIECE EVERY 40'.

Scale: Designed by: NOT TO SCALE Stantec By Date Revision CONSULTANT PROJECT MANAGER: JOSEPH HOWE, P.E. Ву Date Date THG 10\21 JRH 10\21 Checked Designed In Charge of JRH 10\21 10\21

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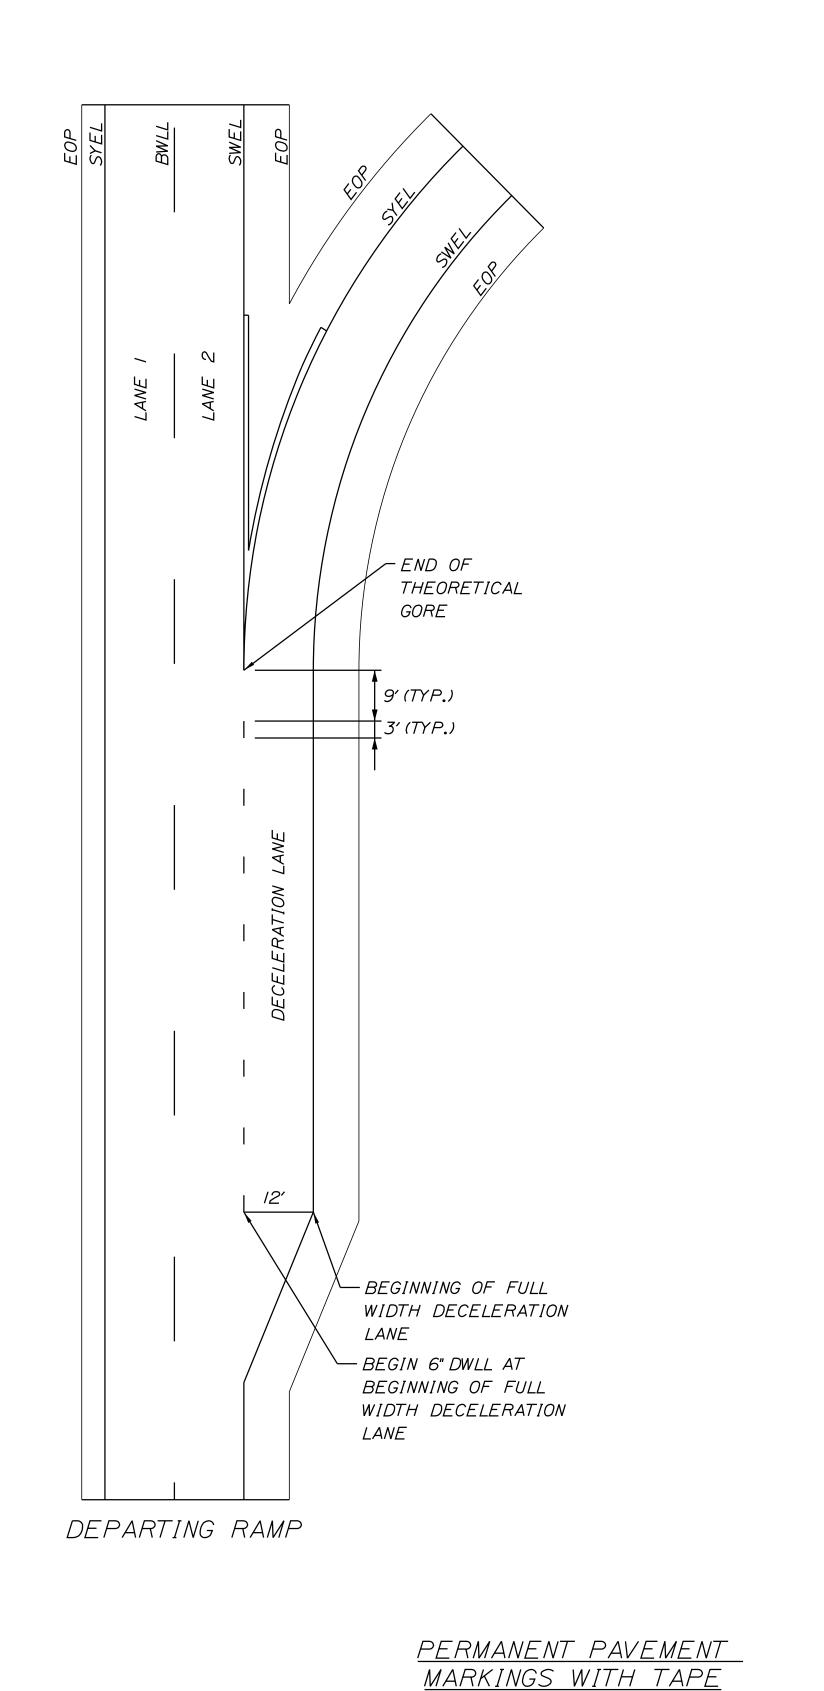



THE GOLD STAR
MEMORIAL HIGHWAY


EXIT 36 IMPROVEMENTS
AND PAVEMENT REHABILITATION
STRIPING DETAILS
(1 OF 2)

SHEET NUMBER: DT-04 22 OF 56

MTA PROJECT MANAGER: RALPH NORWOOD, IV, PE, PTOE



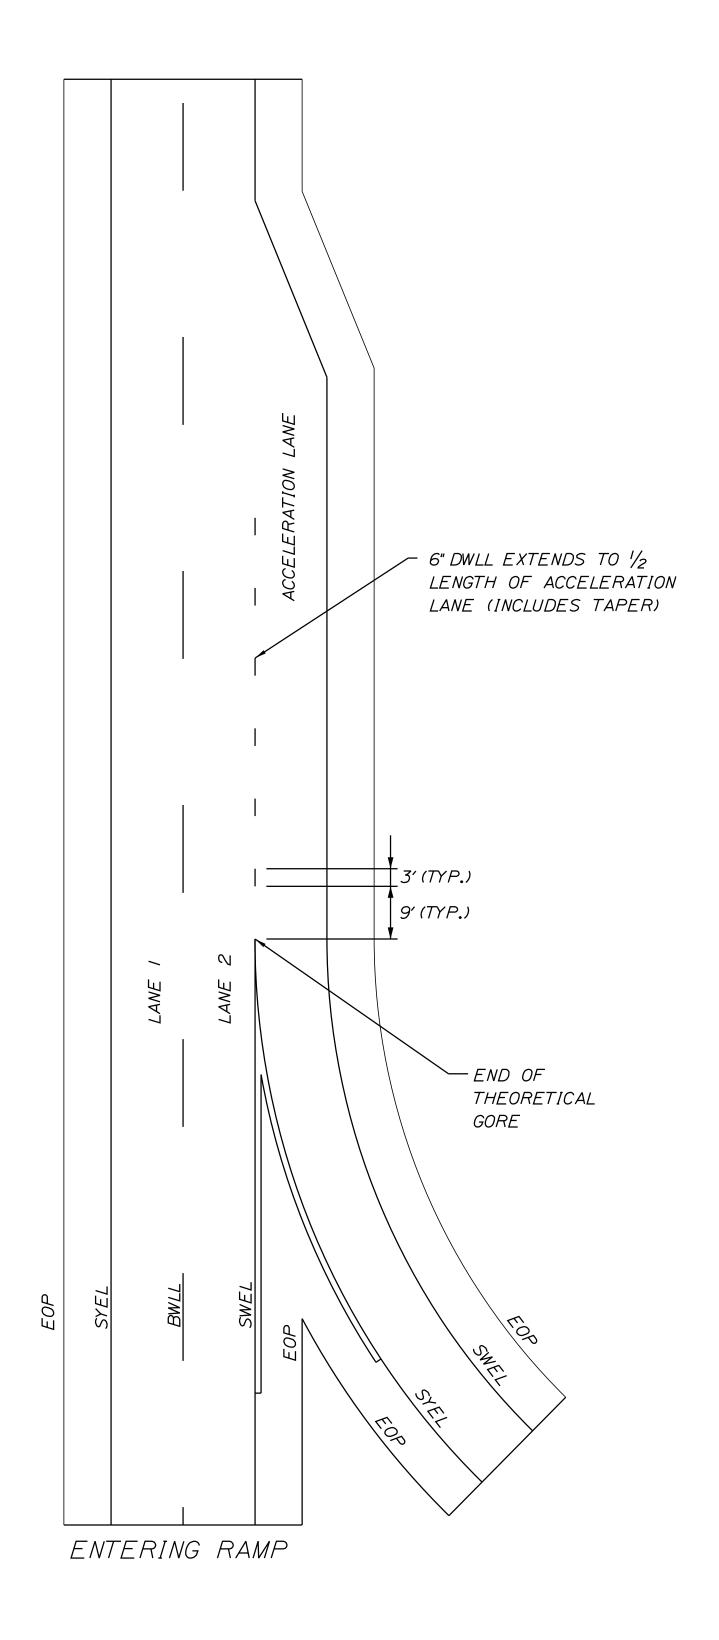

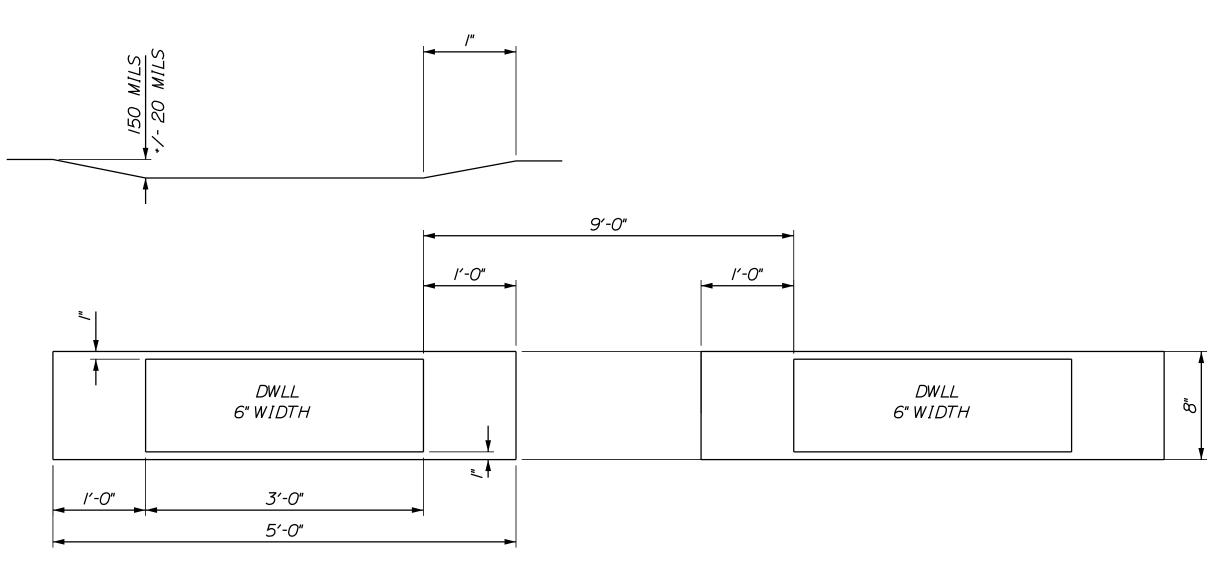

ITEM 627.941 DWLL PERMANENT PAVEMENT MARKINGS WITH TAPE GROOVING DETAIL

<u>LEGEND</u>

SYEL = SOLID YELLOW EDGE LINE (6" PAINT)

SWEL = SOLID WHITE EDGE LINE (6" PAINT)

BWLL = BROKEN WHITE LANE LINE (6" PAINT)

EOP = EDGE OF PAVEMENT

NOTES:

- I. ALL EXISTING PAINT MARKINGS SHALL BE REMOVED PRIOR TO INSTALLATION OF ITEM 627.941 PAVEMENT MARKING TAPE AND SHALL BE INCIDENTAL TO INSTALLATION OF THE TAPE.
- 2. ON DEPARTING RAMPS, THE DWLL SHALL BEGIN AT THE BEGINNING OF THE FULL WIDTH DECELERATION LANE AND EXTEND TO THE THEORETICAL GORE MARKINGS.
- 3. ON ENTERING RAMPS, THE DWLL SHALL BEGIN AT THE END OF THE THEORETICAL GORE MARKINGS AND SHALL EXTEND HALF THE TOTAL LENGTH OF THE RAMP INCLUDING THE TAPER.
- 4. ITEM 627.941 PAVEMENT MARKING TAPE FOR DWLL SHALL BE INSTALLED IN AN "IN-AND-OUT" GROOVING PATTERN. SEE DETAIL THIS SHEET.
- 5. CONTRACTOR SHALL FOLLOW MANUFACTURERS RECOMMENDATIONS FOR INSTALLATION OF THE TAPE. ANY CHANGES TO INSTALLATION PROCEDURES SHALL BE APPROVED THE RESIDENT ENGINEER.

	(ITEM 627.941 PAVEMENT MARKING TAPE)
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Stantec By Date Revision CONSULTANT PROJECT MANAGER: JOSEPH HOWE, P.E. By Date Date THG 10\21 JRH 10\21 Checked Designed In Charge of JRH 10\21 10\21

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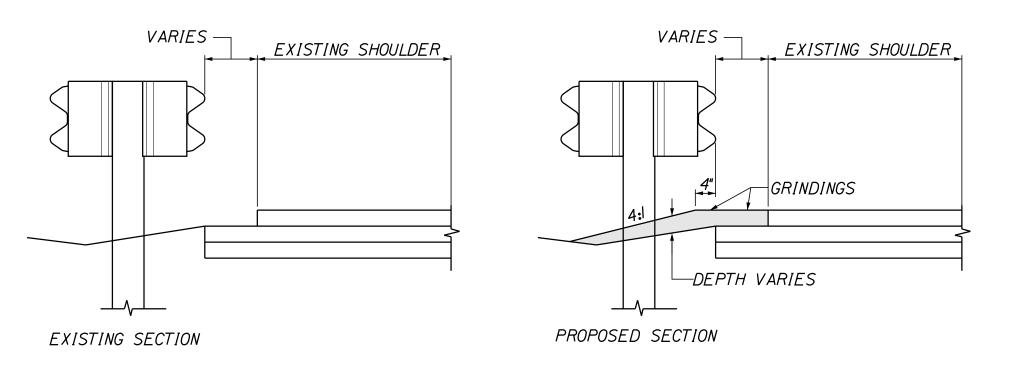
THE GOLD STAR MEMORIAL HIGHWAY

EXIT 36 IMPROVEMENTS AND PAVEMENT REHABILITATION STRIPING DETAILS (2 OF 2)


SHEET NUMBER: DT-05

MTA PROJECT MANAGER: RALPH NORWOOD, IV, PE, PTOE


CONTRACT:2022.02




BERM DROPOFF CORRECTION WITH GUARDRAIL MEDIAN GUARDRAIL

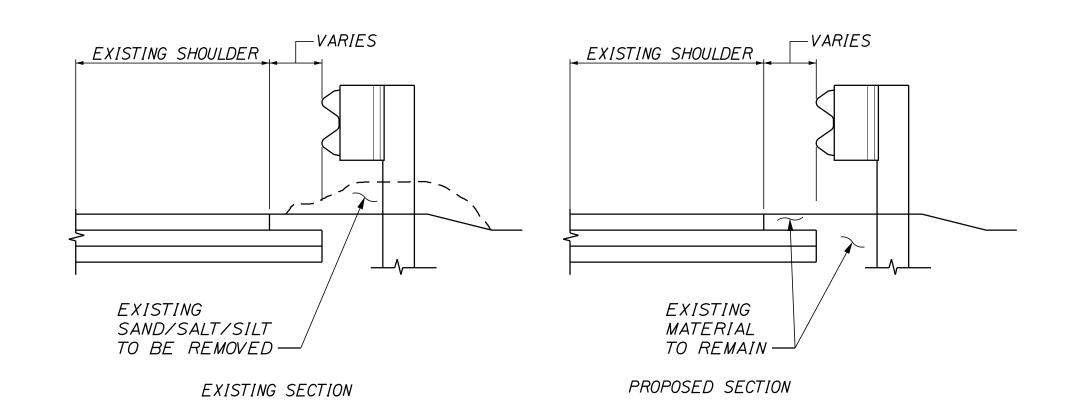

BERM CORRECTION WITH SAND REMOVAL

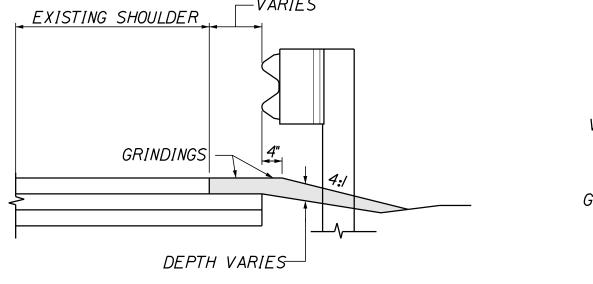



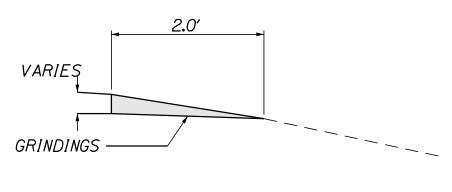

BERM DROPOFF CORRECTION <u>WITHOUT GUARDRAIL</u>

<u>NOTES:</u>

- I. BERM DROPOFF CORRECTION WILL BE PLACED AT ALL LOCATIONS UNLESS OTHERWISE DIRECTED BY THE RESIDENT.
- 2. BERM DROPOFF CORRECTION OF 3 INCHES OR MORE SHALL BE PLACED PRIOR TO SHIFTING TRAFFIC TO THE LANE ADJACENT TO THE SHOULDER REQUIRING CORRECTION.
- 3. BERM DROPOFF CORRECTION WILL BE PAID UNDER ITEM 470.08. BERM CORRECTION WILL BE PAID UNDER ITEM 470.081.

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File					Drawn	CHL	10\21	In Charge of	JRH	10\21	

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THE GOLD STAR MEMORIAL HIGHWAY

EXIT 36 IMPROVEMENTS AND PAVEMENT REHABILITATION

BERM DROPOFF CORRECTION DETAILS

SHEET NUMBER: DT-06 CONTRACT:2022.02 24 OF 56

GUARDRAIL EARTHWORK AND PAVEMENT REPAIR NOTES

- I. ALL EARTHWORK AND PAVEMENT REPAIRS ASSOCIATED WITH GUARDRAIL INSTALLATIONS AND/OR MODIFICATIONS FOR THIS CONTRACT SHALL BE INCIDENTAL TO THE GUARDRAIL ITEMS UNLESS OTHERWISE NOTED.
- 2. ALL DISTURBED AREAS DUE TO THE WORK PERFORMED UNDER THIS CONTRACT FOR GUARDRAIL REPAIRS, MODIFICATION AND/OR INSTALLATIONS SHALL BE REPAIRED AND RESTORED TO ORIGINAL CONDITION. GRASSED AREAS SHALL RECEIVE 4" OF LOAM, SEED, FERTILIZER AND MULCH. IN PAVED AREAS, SUBBASEGRAVEL SHALL BE REPLACED AND RECOMPACTED WITH MAINE DOT TYPE-D GRAVEL AND HOT MIX ASPHALT TO A THICKNESS TO MATCH SURROUNDING PAVEMENT.
- 3. COMPACTION OF EARTH AND/OR SUBBASE GRAVEL AROUND GUARDRAIL POSTS DISTURBED DURING THE WORK IS REQUIRED. ALL POSTS SHALL BE PLUMB AFTER COMPACTION.
- 4. EXCAVATION NECESSARY TO MAINTAIN DRAINAGE WAYS OUTSIDE OF THE EXISTING WIDENING OR THE SHOULDER WIDENING WORK AREA SHALL BE PAID FOR UNDER ITEM 631.12 ALL PURPOSE EXCAVATOR AS APPROVED BY THE RESIDENT ENGINEER. EXCAVATED MATERIAL SHALL BE USED TO GRADE ANY PROPOSED SLOPE AREA OUTSIDE OF 1:1 SLOPE LIMIT OR USED TO FLATTEN SLOPES OUTSIDE THE WORK AREA AS APPROVED BY THE RESIDENT. PLACEMENT AND COMPACTION OF THE EXCAVATED MATERIAL WILL NOT BE MEASURED SEPARATELY FOR PAYMENT.
- 5. ANY COMMON BORROW NECESSARY TO CONSTRUCT SHOULDER WIDENING SHALL COME FROM EXCAVATION WITHIN PROJECT LIMITS AND NO SEPARATE PAYMENT WILL BE MADE.
- 6. SLOPES CONSTRUCTED FROM THE ABOVE NOTED EXCAVATED MATERIAL SHALL BE LOAMED, SEEDED AND MULCHED. LOAM, SEED AND MULCHED. LOA
- 7. ANY REQUIRED CLEARING TO MODIFY WIDENED SHOULDER SHALL BE PAID UNDER ITEM 201.11 CLEARING.

GUARDRAIL INSTALLATION AND MODIFICATION NOTES

- I. THE CONTRACTOR SHALL FOLLOW ALL MANUFACTURER'S INSTALLATION INSTRUCTIONS FOR THE INSTALLATION AND/OR MODIFICATION OF ANY AND ALL GUARDRAIL COMPONENTS TO BE INSTALLED UNDER THIS CONTRACT. THE CONTRACTOR SHALL NOTIFY THE RESIDENT ENGINEER IF THE CONTRACTOR DISCOVERS CONFLICTS OR IRREGULARITIES OF ANY SORT BETWEEN THE MANUFACTURER'S INSTALLATION INSTRUCTIONS AND THESE CONTRACT DOCUMENTS.
- 2. THE CONTRACTOR IS REQUIRED TO HAVE AN APPROVED CRASH END TREATMENT ON ALL GUARDRAIL ENDS IN ALL WORK AREAS AT THE END OF EACH DAY. THE CONTRACTOR SHALL ENSURE THAT ENOUGH TIME EXISTS IN THE WORK DAY TO COMPLETE ALL MODIFICATIONS AND/OR INSTALLATIONS TO END TERMINALS. THE CONTRACTOR SHALL ENSURE THAT ALL PARTS AND MANPOWER ARE ON-SITE PRIOR TO UNDERTAKING ANY GUARDRAIL MODIFICATIONS.
- 3. EXISTING GUARDRAIL NOTED TO BE ADJUSTED SHALL BE ADJUSTED TO 30" (+0",-1/2") HEIGHT. GUARDRAIL HEIGHT SHALL BE MEASURED FROM THE EDGE OF PAVEMENT WHEN WITHIN 2 FEET. IF GUARDRAIL IS OFFSET FROM EDGE OF PAVEMENT GREATER THAN 2 FEET, THEN HEIGHT OF RAIL SHALL BE MEASURED AT GROUND ELEVATION ADJACENT TO EACH POST BELOW THE RAIL TO THE TOP OF GUARDRAIL AND AFTER FINAL GRADING OF SHOULDER.
- 4. PROPOSED GUARDRAIL SHALL BE INSTALLED TO THE HEIGHTS SHOWN IN THE GUARDRAIL DETAILS.
- 5. THE CONTRACTOR SHALL REMOVE AND DISPOSE OF ALL CUT BOLTS, DISCARDED PARTS, TRASH, PAVEMENT DEBRIS, ETC., AFTER COMPLETING GUARDRAIL MODIFICATIONS AND/OR INSTALLATIONS.
- 6. CONNECTIONS FOR PROPOSED RAIL TO EXISITNG RAIL SHALL BE INCIDENTAL TO THE INSTALLATION OF PROPOSED GUARDRAIL.
- 7. SOIL ANCHOR TUBES INSTALLED AS PART OF CAT,FLEAT OR TRAILING TERMINAL ENDS SHALL NOT PROTRUDE FROM THE GROUND MORE THAN 3½".ADDITIONAL SITE GRADING MAY BE REQUIRED TO ADJUST SOIL TUBE REVEAL AND IF REQUIRED SHALL NOT DIRECT STORMWATER SURFACE DRAINAGE TOWARDS THE SHOULDER OR TRAVEL WAY.ADDITIONAL SITE GRADING SHALL BE INCIDENTAL TO THE END TERMINAL INSTALLATION.
- 8. ALL DAMAGE TO GUARDRAIL COMPONENTS RESULTING FROM ADJUSTMENTS MADE TO THE GUARDRAIL SHALL BE REPAIRED AT NO ADDITIONAL COST TO THE AUTHORITY.

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						Ву	Date		Ву	Date
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					Drawn	CHL	10\21	In Charge of	JRH	10\21

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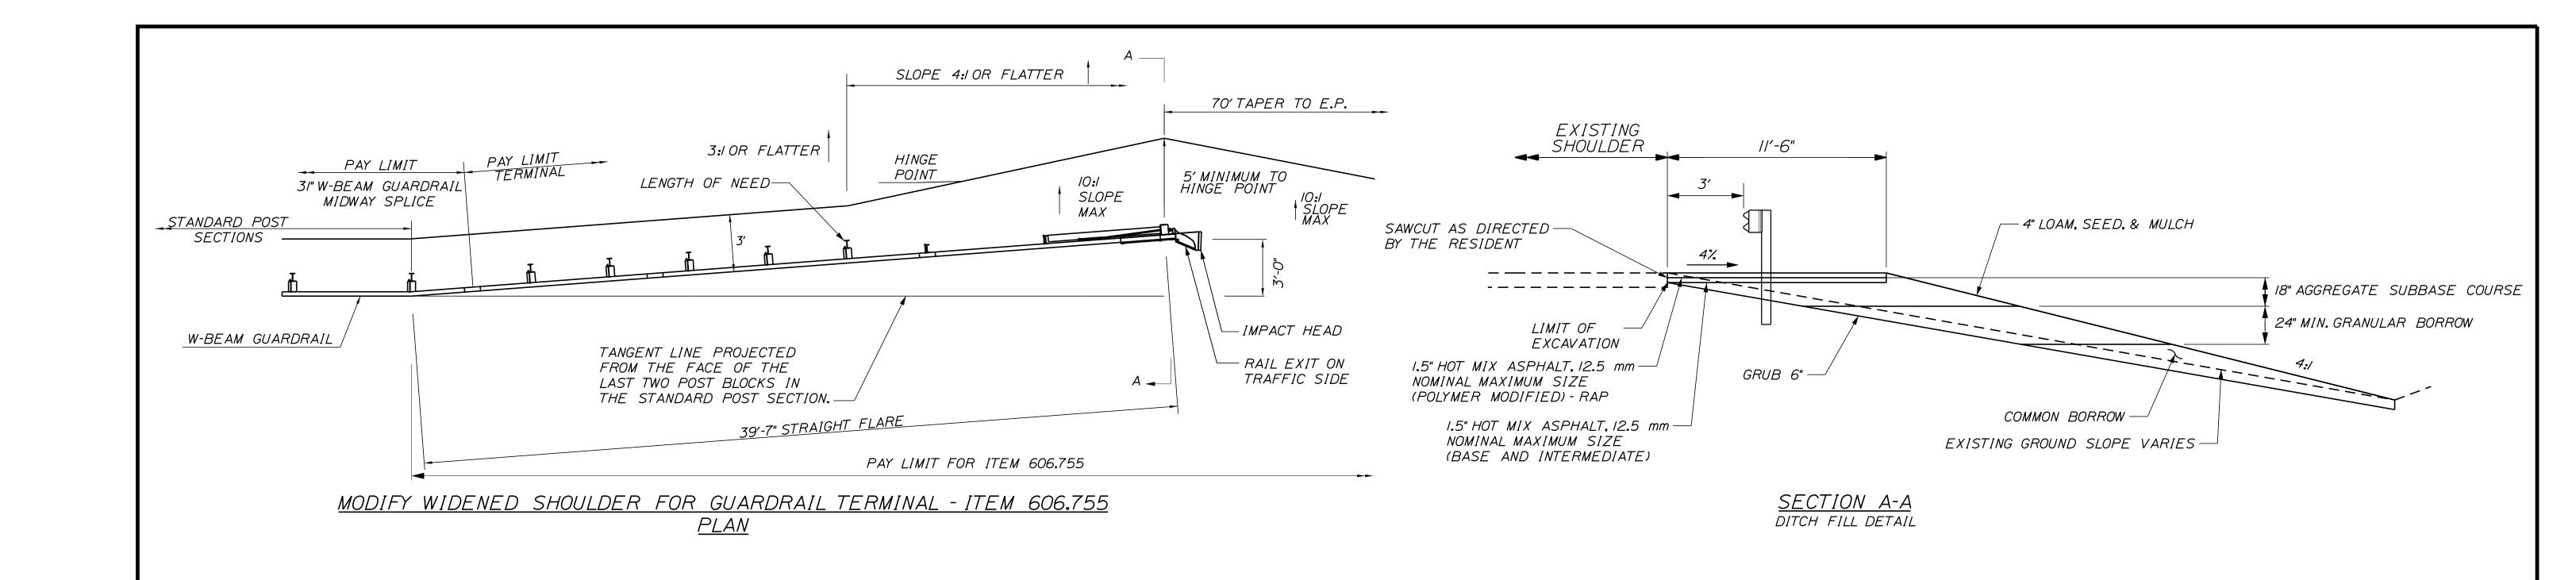



THE GOLD STAR MEMORIAL HIGHWAY


EXIT 36 IMPROVEMENTS
AND PAVEMENT REHABILITATION
GUARDRAIL DETAIL
(1 OF 3)

CONTRACT:2022.02

SHEET NUMBER: DT-07 25 OF 56



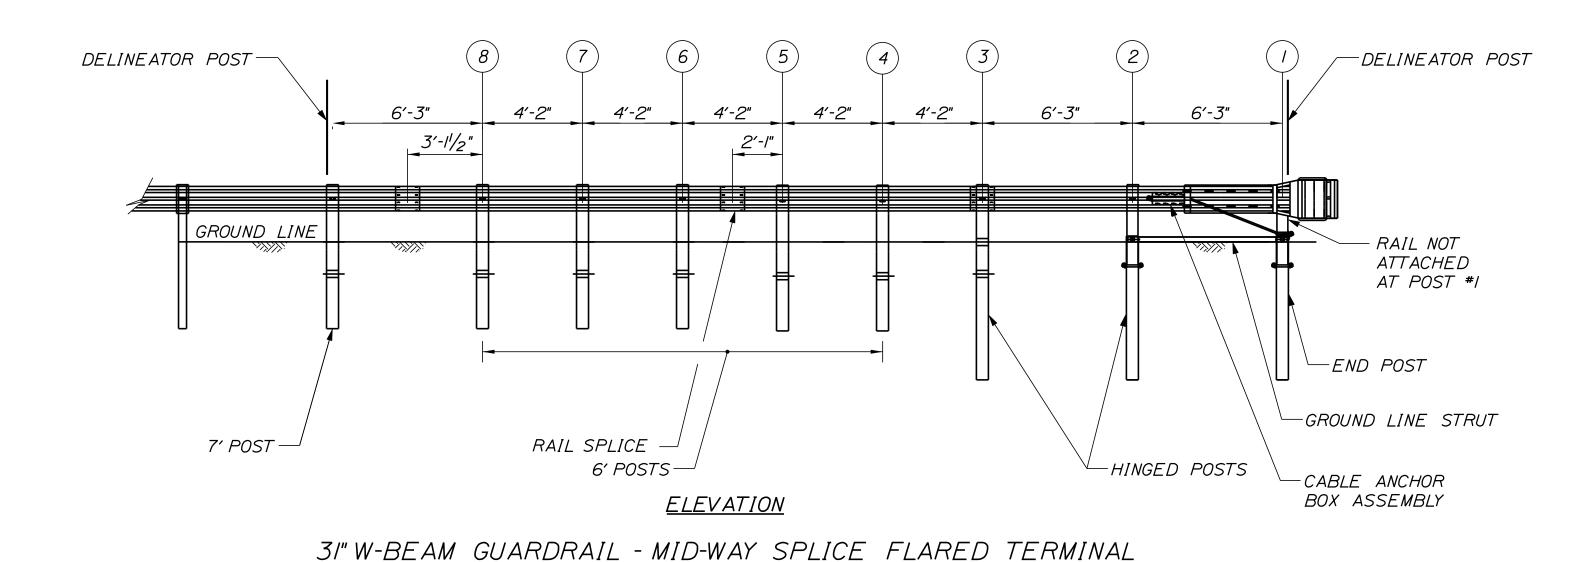

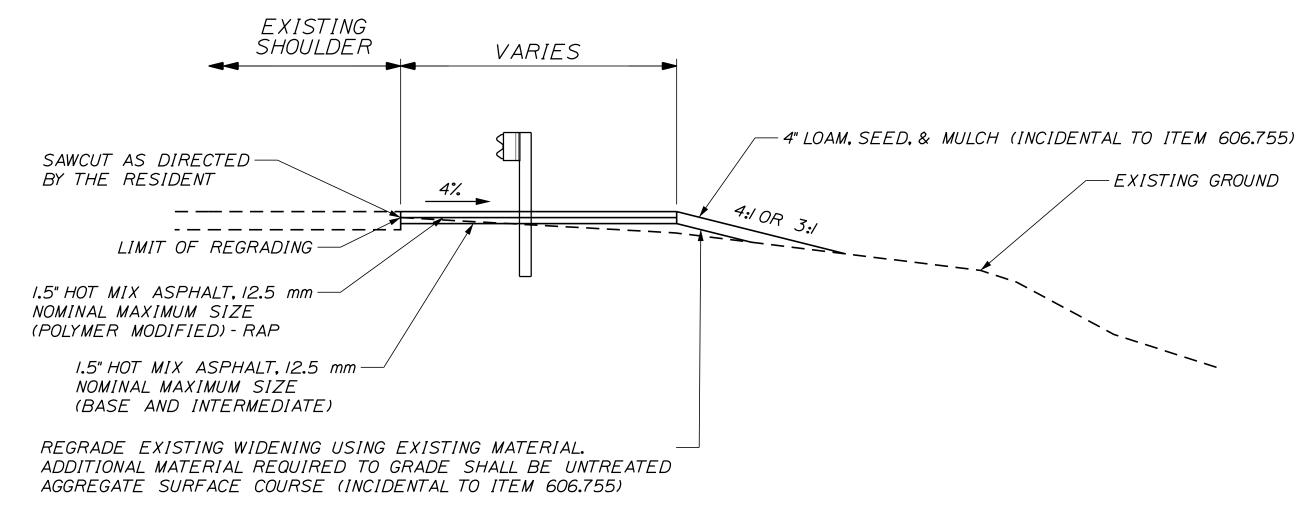

NOTES:

I. TERMINAL UNIT SHALL BE MFLEAT AND MASH CERTIFIED AS MANUFACTURED BY ROAD SYSTEMS INC.

SECTION A-A
REGRADING

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Ë					Drawn	CHL	10\21	In Charge of	JRH	10\21	

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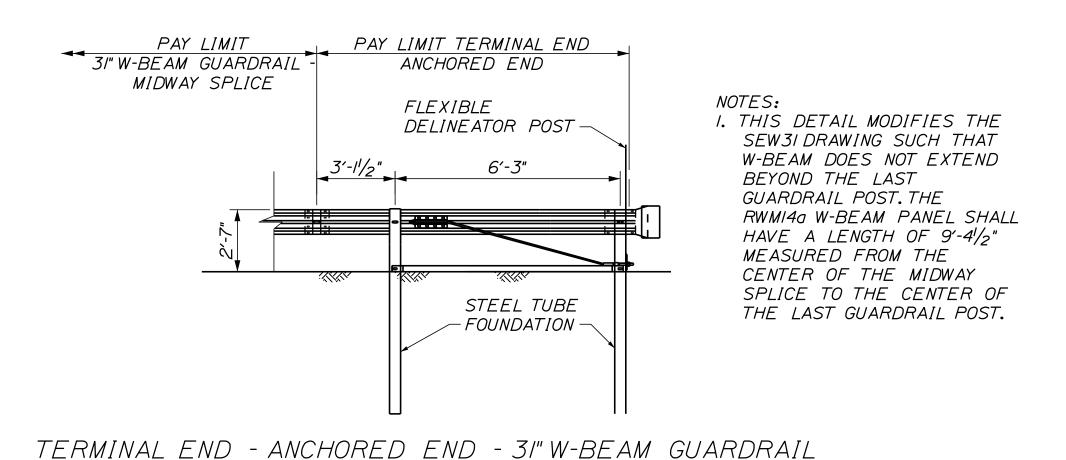


MTA PROJECT MANAGER: RALPH NORWOOD, IV, PE, PTOE

THE GOLD STAR MEMORIAL HIGHWAY

EXIT 36 IMPROVEMENTS
AND PAVEMENT REHABILITATION
GUARDRAIL DETAILS
(2 OF 3)

SHEET NUMBER: DT-08
CONTRACT:2022.02 26 OF 56



(ITEM 606.1351)


NOT TO SCALE

LENGTH OF TRANSITION = 34'-41/2" 31" W-BEAM GUARDRAIL -TRANSITION LENGTH PAID UNDER ITEM 606.13 31" W-BEAM GUARDRAIL MIDWAY SPLICE (SINGLE FACED) OR ITEM 606.132 31" W-BEAM GUARDRAIL (DOUBLE FACED) NEW GUARDRAIL EXISTING GUARDRAIL PAY LIMIT EXISTING (2'-33/4" TYP.) 10'-10'/4" 12'-6" 12'-6" 9'-41/2" 12'-6" -END TRANSITION - BEGIN TRANSITION 6′-3" TYPICAL POST SPACING GROUND LINE


TRANSITION FROM EXISTING GUARDRAIL TO 31" MID-WAY SPLICED GUARDRAIL NOT TO SCALE

NOTES:


- I. MAINTAIN STANDARD I" CLEARANCE OF POST ABOVE PANEL THROUGHOUT THE ENTIRE LENGTH OF TRANSITION.
- 2. A MINIMUM OF ONE (1) 12'-6" PANEL SHALL BE PLACED BETWEEN THIS TRANSITION AND THE START OF ANY END TREATMENT OR ANCHORAGE.
- 3. ALL NEW POST SHALL BE 84" IN LENGTH UNLESS OTHERWISE SPECIFIED BY THE ENGINEER.
- 4. ALL NEW POSTS AND OFFSET BLOCK MATERIALS SHALL

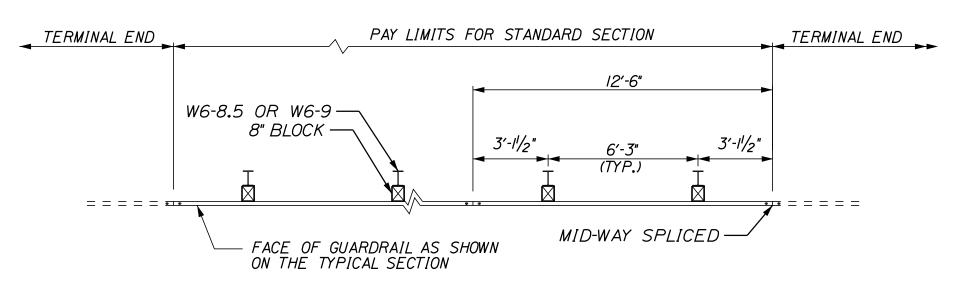


PLAN - SINGLE FACED

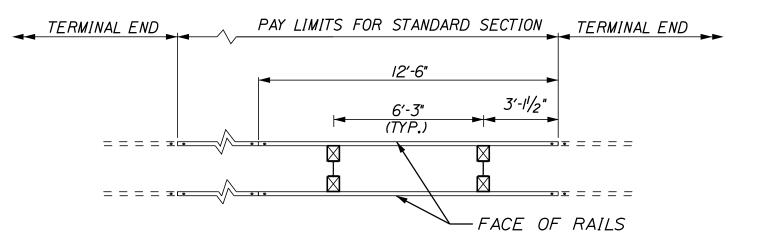

PLAN - DOUBLE FACED

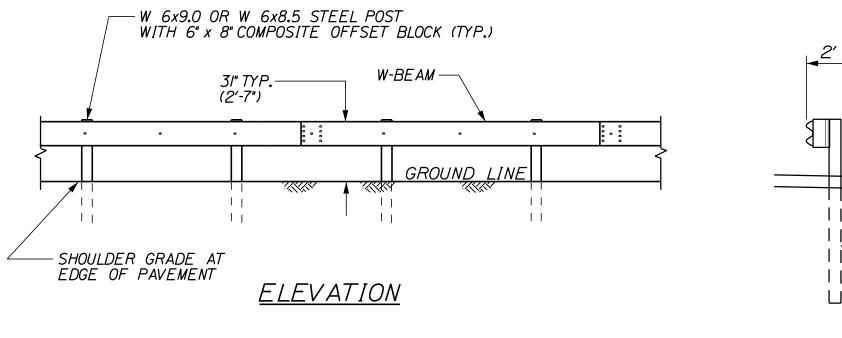

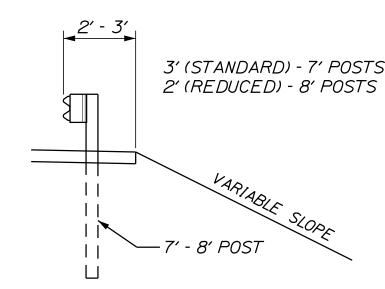

CROSS-SECTION

31" W-BEAM GUARDRAIL - MID-WAY SPLICE (8" OFFSET BLOCKS)

(ITEMS 606.13, 606.132)

NOT TO SCALE

GENERAL GUARDRAIL INSTALLATION NOTES:

- I. THE CONTRACTOR SHALL FOLLOW ALL MANUFACTURER'S INSTALLATION INSTRUCTIONS FOR THE INSTALLATION OF ALL GUARDRAIL COMPONENTS TO BE INSTALLED. THE CONTRACTOR SHALL NOTIFY THE RESIDENT ENGINEER OF ANY CONFLICTS OR IRREGULARITIES BETWEEN THE MANUFACTURER'S INSTALLATION INSTRUCTIONS AND THE CONTRACT DOCUMENTS.
- 2. THE CONTRACTOR IS REQUIRED TO HAVE AN APPROVED CRASH END TREATMENT ON ALL GUARDRAIL ENDS PRIOR TO THE REMOVAL OF ANY MOT FEATURES.
- 3. GUARDRAIL HEIGHT SHALL BE 31", -1/2". GUARDRAIL HEIGHT SHALL BE MEASURED FROM AT GROUND ELEVATION ADJACENT TO EACH POST.
- 4. THE CONTRACTOR SHALL REMOVE AND DISPOSE OF ALL CUT BOLTS, DISCARD PARTS, TRASH, PAVEMENT DEBRIS, ETC., AFTER COMPLETING THE GUARDRAIL INSTALLATION.
- 5. CONNECTION FOR PROPOSED RAIL TO EXISTING RAIL SHALL BE INCIDENTAL TO THE PROPOSED GUARDRAIL ITEMS.

	EXISTING GINEER.	UNLESS	OTHERWISE	SPECIFIED	BY

Designed by: Scale: NOT TO SCALE Stantec By Date Revision CONSULTANT PROJECT MANAGER: JOSEPH HOWE, P.E. By Date Date THG 10\21 JRH Checked 10\21 Designed In Charge of JRH 10\21 10\21

STANTEC CONSULTING SERVICES INC. 2211 CONGRESS STREET SUITE 380 PORTLAND, ME 04102 TEL (207) 887-3448 FAX (207) 883-3376



THE GOLD STAR MEMORIAL HIGHWAY


EXIT 36 IMPROVEMENTS AND PAVEMENT REHABILITATION GUARDRAIL DETAILS (3 OF 3)

SHEET NUMBER: DT-09

MTA PROJECT MANAGER: RALPH NORWOOD, IV, PE, PTOE

CONTRACT:2022.02

l'-6" MIN.

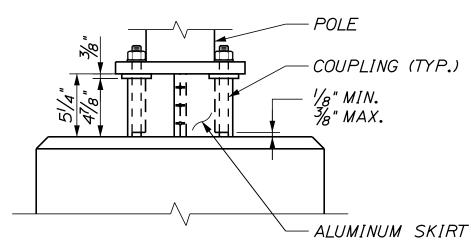

* BREAKAWAY COUPLINGS SHALL BE REQUIRED ON ALL NEW LIGHT STANDARDS EXCEPT POLES MOUNTED ON BARRIER


BREAKAWAY COUPLINGS AND SKIRT DETAIL

PAVED AREA

PAVEMENT

12" CRUSHED STONE

OR GRAVEL

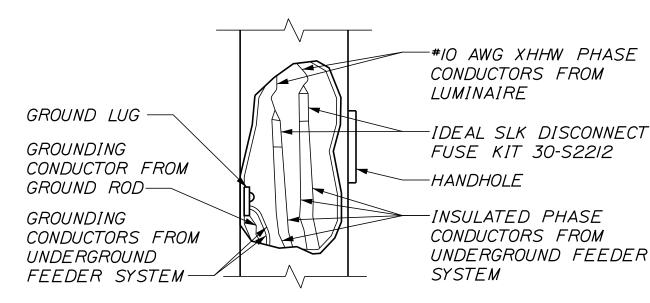


POLES

TYPICAL POLE WIRING DETAIL

WHERE SOLID ROCK IS ENCOUNTERED AT LESS THAN THE REQUIRED DISTANCE BELOW GROUND LEVEL, REINFORCING STEEL SHALL BE DOWELED INTO LEDGE AS SHOWN ON MAINEDOT STANDARD DETAIL 626(06). PAYMENT SHALL BE INCIDENTAL TO THE FOUNDATION PAY ITEM. -MAIN REINFORCING #6 BARS TIES #3 BARS —

- 2" DIA. PVC CONDUIT (TYP.) USE 90° - 30" RADIUS PREBENT CONDUIT FOR BENDS GALV. STEEL ANCHOR BOLTS AS RECOMMENDED BY POLE MANUFACTURER SECTION A-A -23/4" FOR LIGHT STANDARDS

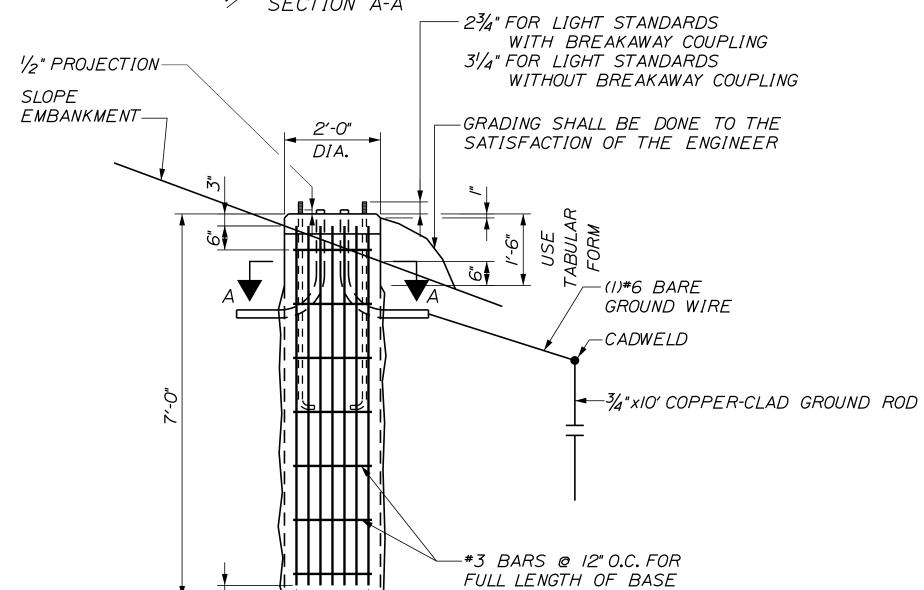

JUNCTION BOX COVER & FRAME

(TYP)

NOTES:

- INSTALL JUNCTION BOX ON GRADE.
- SPLICES IN BOX SHALL BE MADE WITH ILSCO USPA-350SS-DB DUAL RATED INSULATED, IN-LINE, WATERPROOF SPLICE, UL LISTED FOR DIRECT BURIAL (WIRE RANGE FROM 350KCMIL - 10AWG STRANDED) ONLY. PROVIDE ENOUGH SLACK IN THE WIRE TO ALLOW REMOVAL OF SPLICES AND NEATLY ARRANGE WIRE IN BOX.

GRASS AREA

LOAM

-QUAZITE

JUNCTION BOX

BOX PAY ITEM.


-3" PVC DRAIN PIPE WITH

CRITTER GUARD. EXTEND TO

DAYLIGHT. PAYMENT SHALL BE

INCIDENTAL TO THE JUNCTION

- THE COVER SHALL BE LABELED WITH THE FUNCTION DESIGNATION IN I" MIN TEXT AS FOLLOWS: -"LIGHTING" FOR LIGHTING CONDUIT -"COMMUNICATION" FOR COMMUNICATION CONDUITS -"SIGNAL" FOR SIGNAL CONDUITS
- COVER SHALL BE HEAVY DUTY TYPE TIER 22 WITH (2) 1/2" STAINLESS STEAL PENTA-HEAD BOLTS.

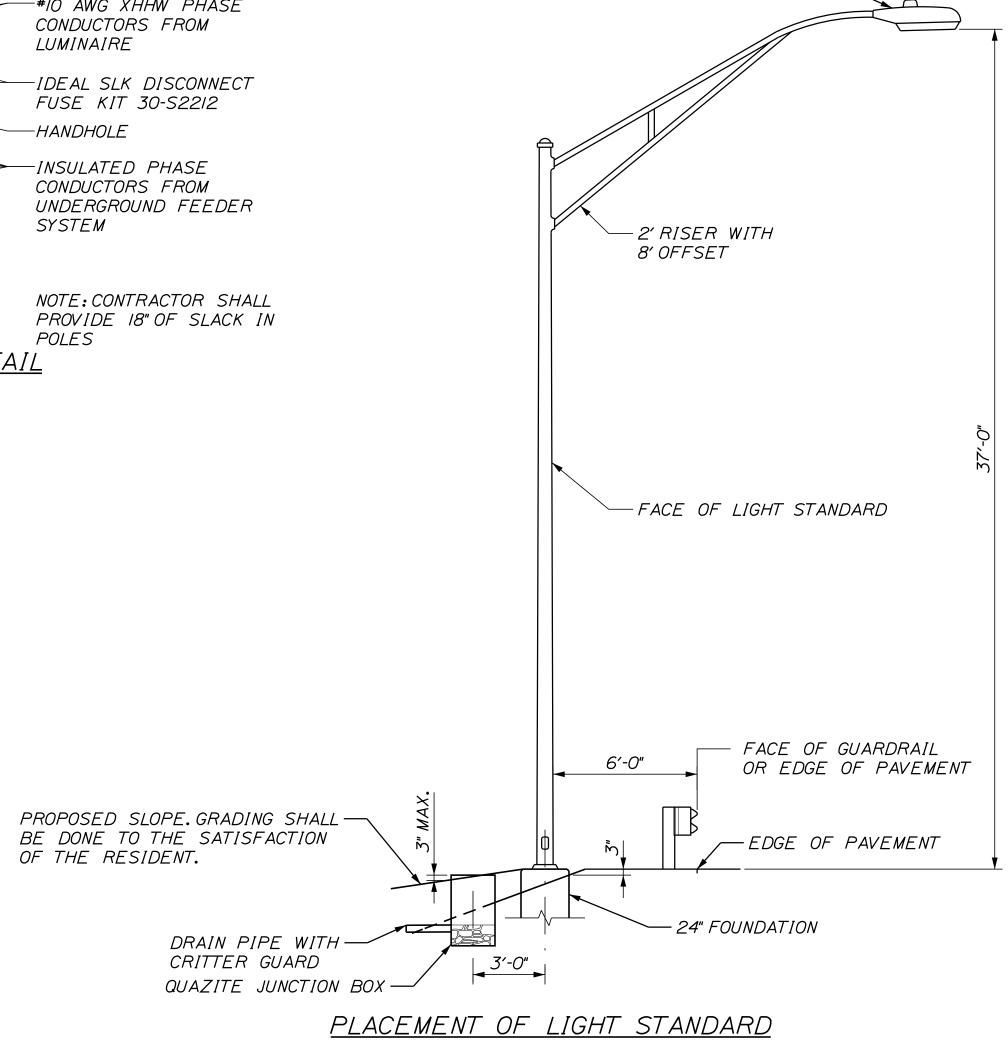

SHORTING CAP -


LUMINAIRE - SEE LUMINAIRE SCHEDULE

24 INCH FOUNDATION

(8)#6

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THE GOLD STAR MEMORIAL HIGHWAY

EXIT 36 IMPROVEMENTS AND PAVEMENT REHABILITATION

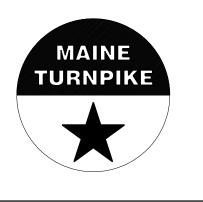LIGHTING DETAILS


SHEET NUMBER: DT-10

MTA PROJECT MANAGER: RALPH NORWOOD, IV, PE, PTOE

CONTRACT:2022.02 28 OF 56

- 3. ALL FIXTURES SHALL BE GASKETED AND HAVE SURGE PROTECTION AND A DOUBLE FUSE KIT. ALL FIXTURES SHALL BE GRAY. IF DIFFERENT FIXTURES ARE PROPOSED, THEY SHALL BE IES FULL CUTOFF, TYPE 3 IES DISTRIBUTION TYPE AS NOTED IN THE LUMINAIRE SCHEDULE, LED LUMINAIRES. B.U.G. RATINGS SHALL BE EQUAL TO OR BETTER THAN THE DESIGNED FIXTURES. THE CONTRACTOR MUST DEMONSTRATE THAT THE PROPOSED FIXTURES WILL REASONABLY EQUAL THE LIGHT LEVELS AND DISTRIBUTIONS SHOWN ON THE PLANS, IN THE OPINION OF MTA.
- 4. CONDUIT SHALL BE 3" MINIMUM, PVC SCHEDULE 80. MINIMUM BURIAL DEPTH FOR CONDUIT SHALL BE 30".
- 5. A JUNCTION BOX/HANDHOLE SHALL BE INSTALLED AT EACH POLE. THE WIRING IN CONDUITS SHALL BE CONTINUOUS BETWEEN JUNCTION BOXES/HANDHOLES WITHOUT RUNNING SPLICES IN CONDUITS.
- 6. UPON COMPLETION OF THIS PROJECT, THE CONTRACTOR SHALL FURNISH TO MTA A SET OF AS-BUILT PLANS FOR FUTURE REFERENCE AND SYSTEM MAINTENANCE. PAYMENT FOR THE AS-BUILT PLANS SHALL BE INCIDENTAL TO THE LIGHTING ITEMS.
- 7. ALL LIGHT BASES SHALL HAVE A GROUND ROD LOCATED ADJACENT TO THE POLE THAT IS BONDED TO THE GROUNDING CONDUCTOR. PAYMENT FOR THE GROUND ROD SHALL BE INCLUDED IN LIGHT POLE ITEM.
- 8. LIGHT STANDARDS AND LUMINAIRES SHALL BE PROVIDED BY THE AUTHORITY AND PAID UNDER ITEM 634.2312 CONVENTIONAL LIGHT STANDARD WITH LED FIXTURE SUPPLIED BY THE AUTHORITY AS NOTED IN SP 634.
- 9. LIGHTING SERVICE PANEL SHALL BE MARKED WITH ARC FLASH HAZARD TYPE I, 2, 3 OR 4 AND THE APPROPRIATE PPE REQUIRED. THE CONTRACTOR SHALL BE RESPONSIBLE FOR CONDUCTING AN ARC FLASH STUDY.
- 10. BREAKAWAY DEVICES FOR LIGHT POLES SHALL CONFORM TO THE LATEST VERSION OF "AASHTO STANDARD SPECIFICATIONS FOR STRUCTURAL SUPPORTS FOR HIGHWAY SIGNS, LUMINAIRES AND TRAFFIC SIGNALS" AND NCHRP REPORT 350. THE BREAKAWAY DEVICE SHALL BE DESIGNED SO THAT THE ANCHOR BOLTS WILL NOT BEND WHEN A VEHICLE HITS THE POLE. A FRANGIBLE COUPLING SUCH AS TRANSPO POLE-SAFE 5000 SERIES (WITH A FEMALE ANCHOR), THE MANITOBA SAFETY BASE WITH REACTION PLATE, OR APPROVED EQUAL SHALL BE USED. BREAKAWAY DEVICES SHALL BE INSTALLED ON ALL POLES EXCEPT THOSE LOCATED ON BARRIERS.
- II. WIRE SHALL BE STRANDED COPPER XHHW-2, SIZE AS NOTED ON THE PLANS.
- 12. FOUNDATIONS SHALL BE 24 INCH DIAMETER BY 7' HEIGHT FOUNDATIONS. PRECAST FOUNDATIONS MAY BE USED, AND IF USED SHALL INCLUDE CAST CONDUIT INSERTS.
- 13. EXISTING INTERCHANGE LIGHTING IS INTENDED TO REMAIN OPERATIONAL UNTIL NEW LIGHTING IS ACTIVATED, IF NECESSARY TO REMOVE OR DEACTIVATE ANY LUMINAIRE BEFORE NEW LIGHTING IS ACTIVATED, WHEN APPROVED BY THE RESIDENT, TEMPORARY LIGHTING SHALL BE USED TO MAINTAIN ILLUMINATION AND WILL BE INCIDENTAL TO THE PERMANENT LIGHTING. ALL TEMPORARY LIGHTING SHALL BE PROTECTED OR LOCATED OUTSIDE OF THE CLEAR ZONE.
- 14. AT EACH POLE, CONTRACTOR SHALL PROVIDE 18" OF EXTRA WIRE SLACK.
- 15. FOR ALL CONDUIT RUNS FROM HANDHOLE TO POLE, THE CONTRACTOR SHALL INSTALL 3"C WITH 2#10 AND I#10GND.
- 16. EXCAVATION AND AGGREGATE SUBBASE COURSE GRAVEL ARE INCIDENTAL TO ITEM 626.38 GROUND MOUNTED CABINET FOUNDATION.
- 17. PREWIRED CONDUIT IS NOT ALLOWED.
- 18. ALL DRILLED CONDUIT SHALL INCLUDE A TRACER WIRE. TRACER WIRE SHALL BE INCIDENTAL TO THE CONDUIT.
- 19. PROVIDE 3" RIGID METAL CONDUIT AT RISER POLE UP TO 10 FT MIN. PAYMENT FOR RISER SHALL BE INCIDENTAL TO ITEM 634,1612 HIGHWAY LIGHTING PANEL AND SERVICE UPGRADES.

BUS	100A			P	AN	EL	No		L)				LOCATION	LUND ROAD		
PANEL RATING	22KAI	C							PRO	POSE	D PANE	L	•	MOUNTING	MOUNT IN P44 ENG	CLOSURE	
SUPPLY VOLTAGE	240V/	480V							(INS	TALLE	D UNDE	R CONT	RACT	DRAWING No.			
SERVICE	1 PHA	SE, 3 WIRE							2022	2.02)							
WIRING		DESCRIPTION	\	/A OR \	N BRI	EAKER	CKT	RI IS	CKT	BRI	EAKER	<u> </u>	/4 OR \	W DESCRIPTION			WIRING
WIRE	COND		ØΑ	ØB	POLE					POLE		ØA	ØB		ı	COND	WIRE
\\ SEE SITE PLAN /	\\ /	LTS-EXISTING HHWY AT OFF RAMP	437			/ \\ 20 /		X	2	1	20			SPARE (FUT	JRE HHWY LTS)		
/	/ \\	/ HM-25		437	/ \	\\ / /\	3	x	4	1	20			SPARE (FUT	JRE HHWY LTS)		
SEE SITE PLAN		LTS-HM-24 &27, HHWY 311,313, 315	1272		\\ 2	/ \\ 20 /	5		6	\\ 2	/ \\ 20 /			SPARE (FUT	JRE HHWY LTS)		
SEE SITE PLAN		LTS-HM-24 &27, HHWY 312,314		1139	/ \	\\ / \	7	X	8	/ '	\\ / \			SPARE (FUT	JRE HHWY LTS)		
\\ SEE SITE PLAN /	// /	\\ LTS-EXISTING HM'S AT PLAZA /	873		\\ 2	/ \\ 20 /	9	х	10	\\ 2	/ \\ 20 /	1746		\\ LTS - EXISTIN	IG HHWY	/ \\	/ \\ SEE SITE PLAN
/ \\	/ \\	/ HM-22 & HM-23 \\		873	/ \	// //	11		12	/	\\		1746	/ HM-HM-26, HN	1-28	\\ / \\ \\	\//
\\ /	\\ /	\\\\\\\\\\\\\\\\\\\\\\\\\\\\\\\\\\\\\\			\\ 2	/ \\ 20 /		X	14	1	20			SPARE			
/	/ \'	\//			/ \	// //	15	X	16	1	20			SPARE			
\\ 2#10, 1#10G /	\\ 3/4" /	\\ LIGHTNING PROTECTION SPD'S			\\ 2	/ \\ 30 /	17		18	1	20			SPARE			
/	/ \\	\//			/ \	// //	19	X	20	1	20			SPARE			
2#12, 1#12G	3/4"	CONTROLS	100		1	20	21	X	22	1	20			SPARE			
2#12, 1#12G	3/4"	ENCLOSURE			1	15	23		24	1	20			SPARE			
		TOTAL 1	2682	2449					TOT	4L 2		1746	1746				
		TOTAL 2	1746	1746													
		TOTAL 1 + 2	4428	4195													
		CONN. LOAD TOTAL	86	522	_		N BRE			60A				_MAIN LUGS		N/A	
		AMPERES	1	8	_	FEE	DER E	ENT	RANC	E TOP	P/BOTTC	M		_ENCLOSURE TYP	PE	NEMA 4	<u>×</u>
							DER S	SIZE	<u> </u>	,	3#1/0			ACCESSORIES			
						SOL	JRCE						TRANS	FORMER			
RECONNECT EXIS	TING HI	GH MAST LIGHTING CKTS				PAN	IEL TY	PΕ		DO	OR-IN-D	OOR					

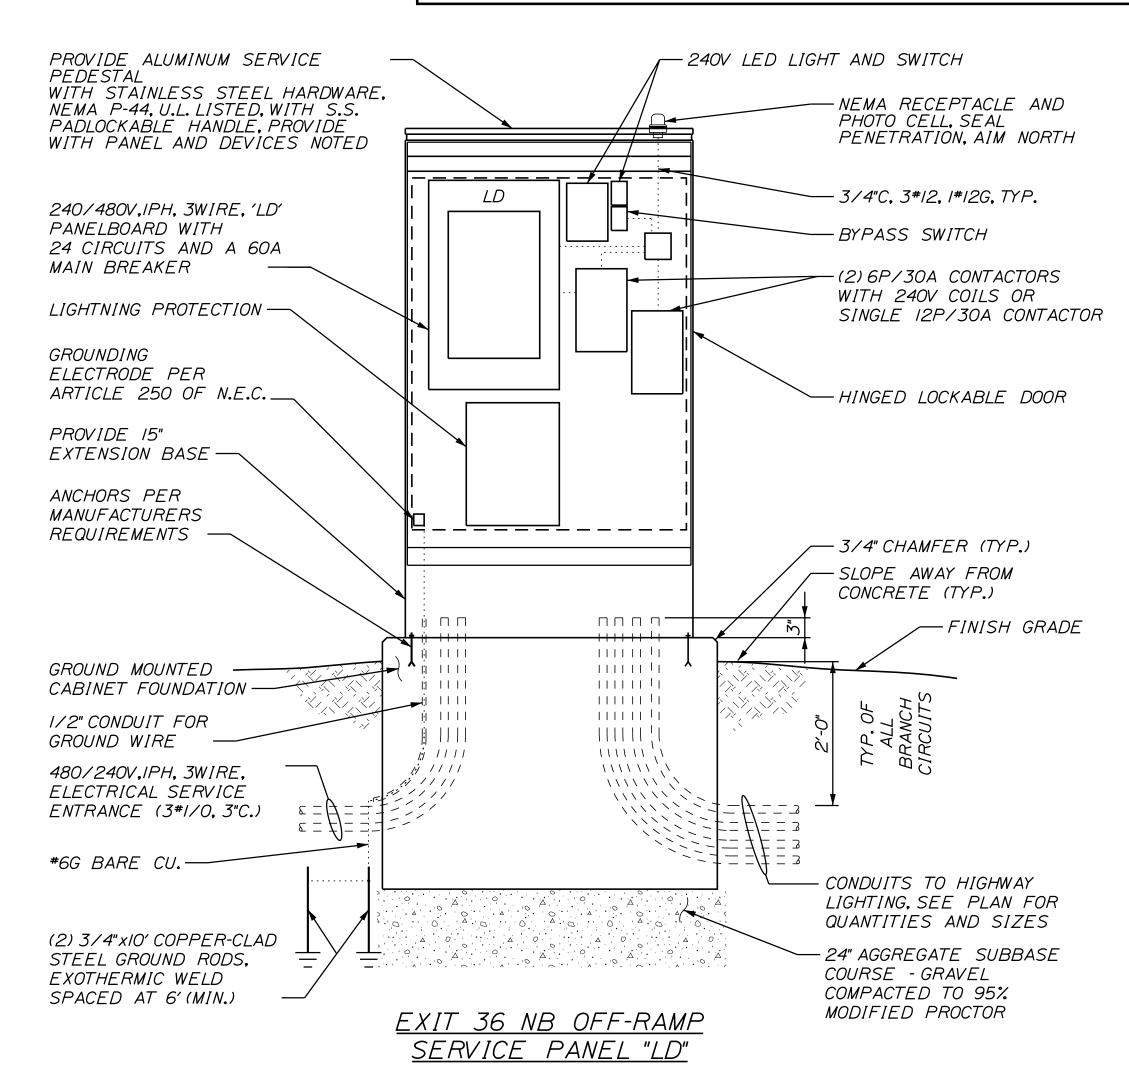

	ROADWAY LUMINAIRE SCHEDULE											
LABEL	CATALOG NUMBER	DESCRIBTION	MINIMUM LUMENS	LIGHT LOSS FACTOR	MAXIMUM WATTS							
A-LD	AMERICAN ELECTRIC ATBO B304 MVOLT R3 3K NL	LED COBRAHEAD, 3000K CCT, IES TYPE 3 DISTRIBUTION	17000	0.67	124							

ilename: ...\MSTA_Detail-Lighting_02.dgn

Designed by: Scale: NOT TO SCALE Stantec By Date Revision CONSULTANT PROJECT MANAGER: JOSEPH HOWE, P.E. Date By Date THG 10\21 JRH 10\21 Checked Designed

STANTEC CONSULTING SERVICES INC.
2211 CONGRESS STREET SUITE 380
PORTLAND, ME 04102
TEL (207) 887-3448
FAX (207) 883-3376

In Charge of JRH 10\21

10\21



THE GOLD STAR
MEMORIAL HIGHWAY


EXIT 36 IMPROVEMENTS AND PAVEMENT REHABILITATION


LIGHTING NOTES, SCHEDULES, AND DETAILS


CONTRACT:2022.02


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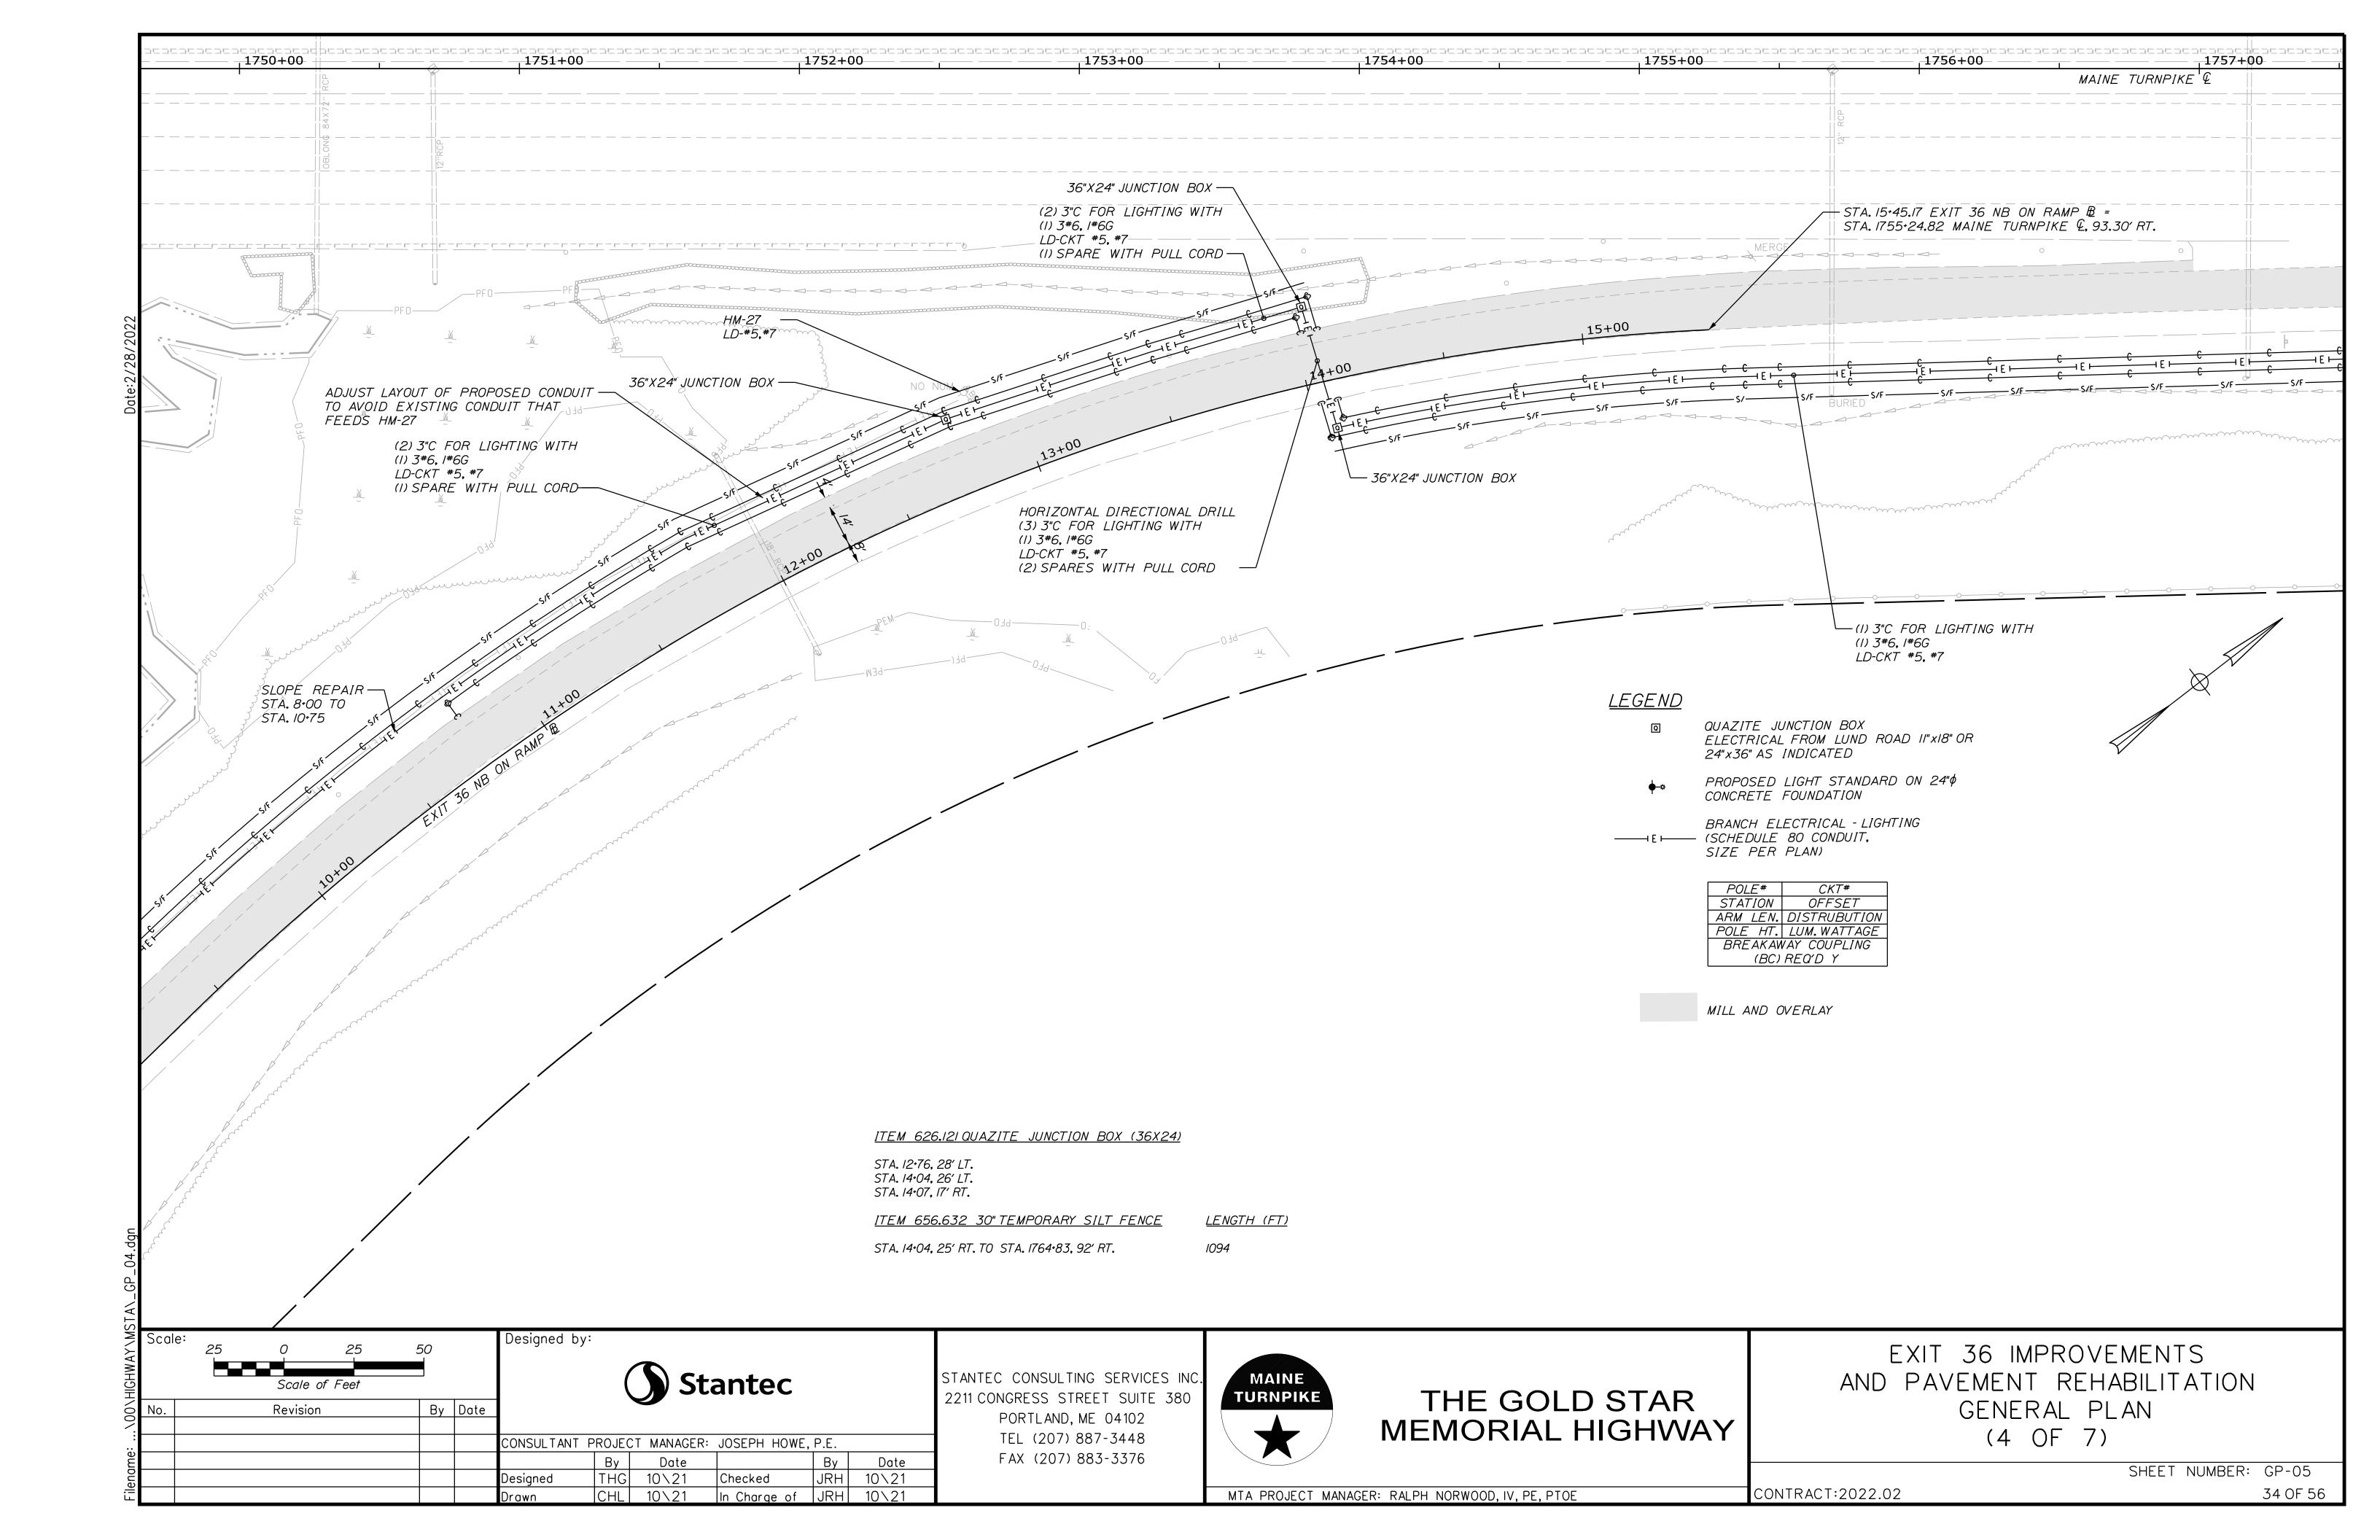
MTA PROJECT MANAGER: RALPH NORWOOD, IV, PE, PTOE




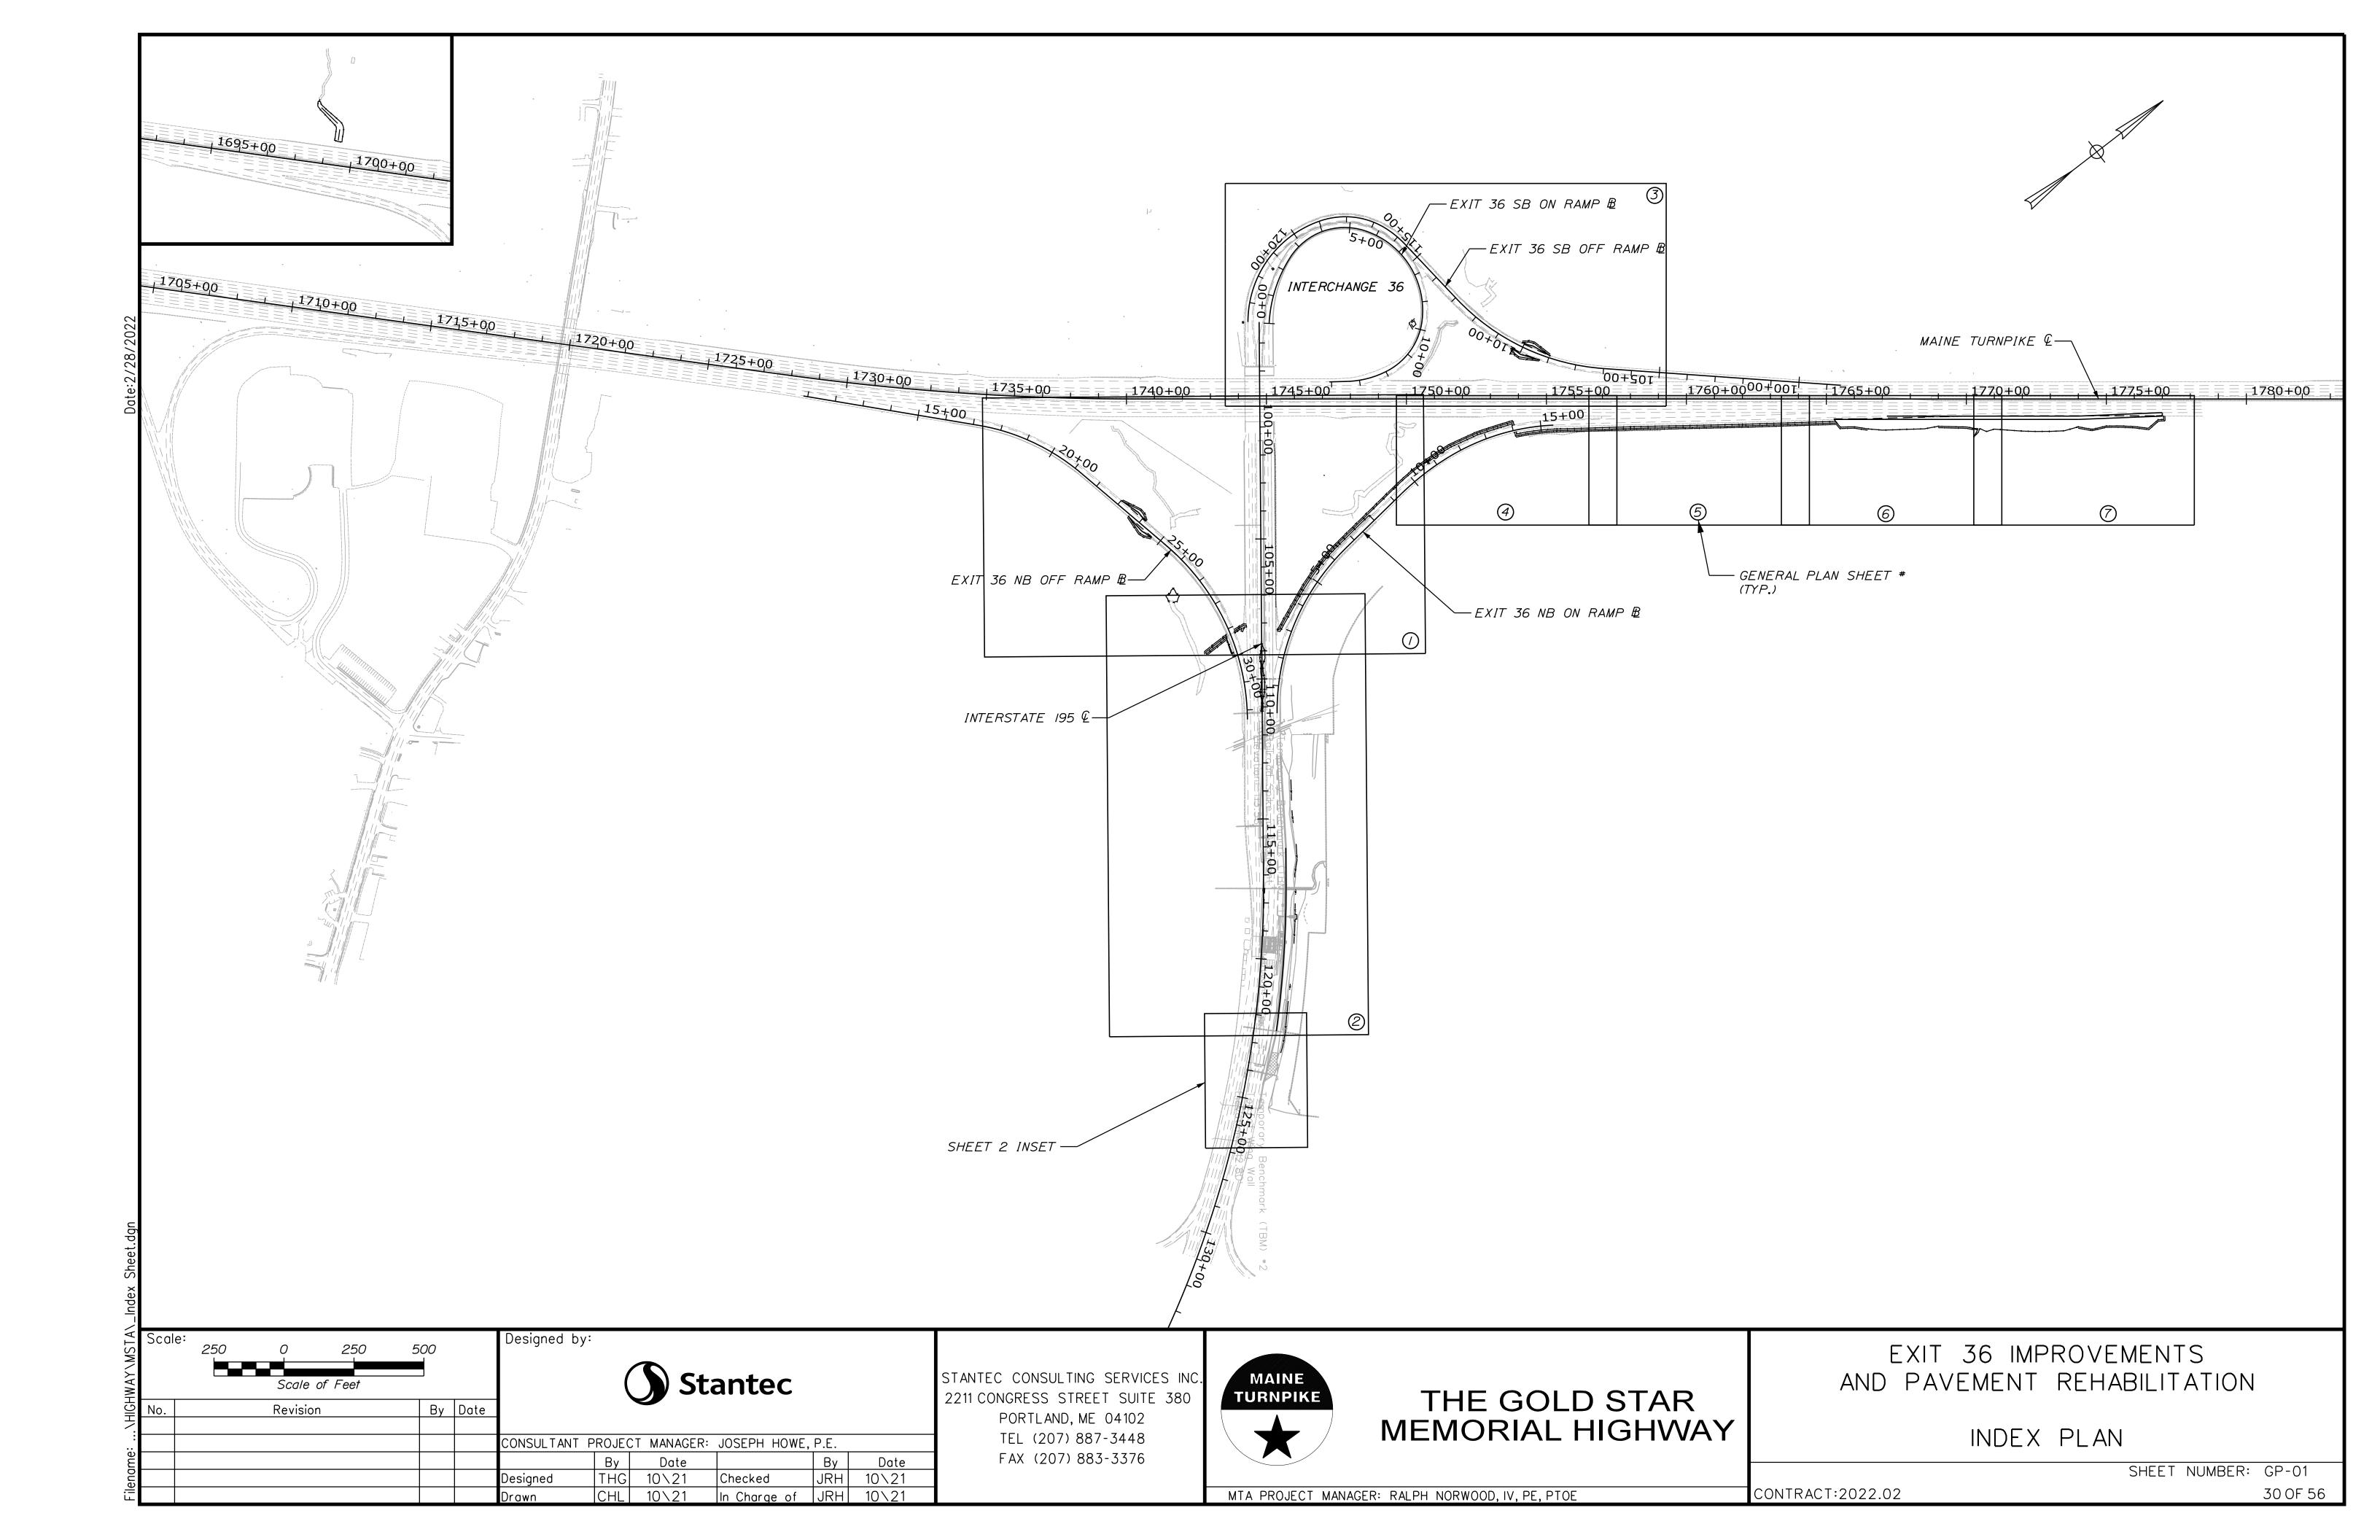


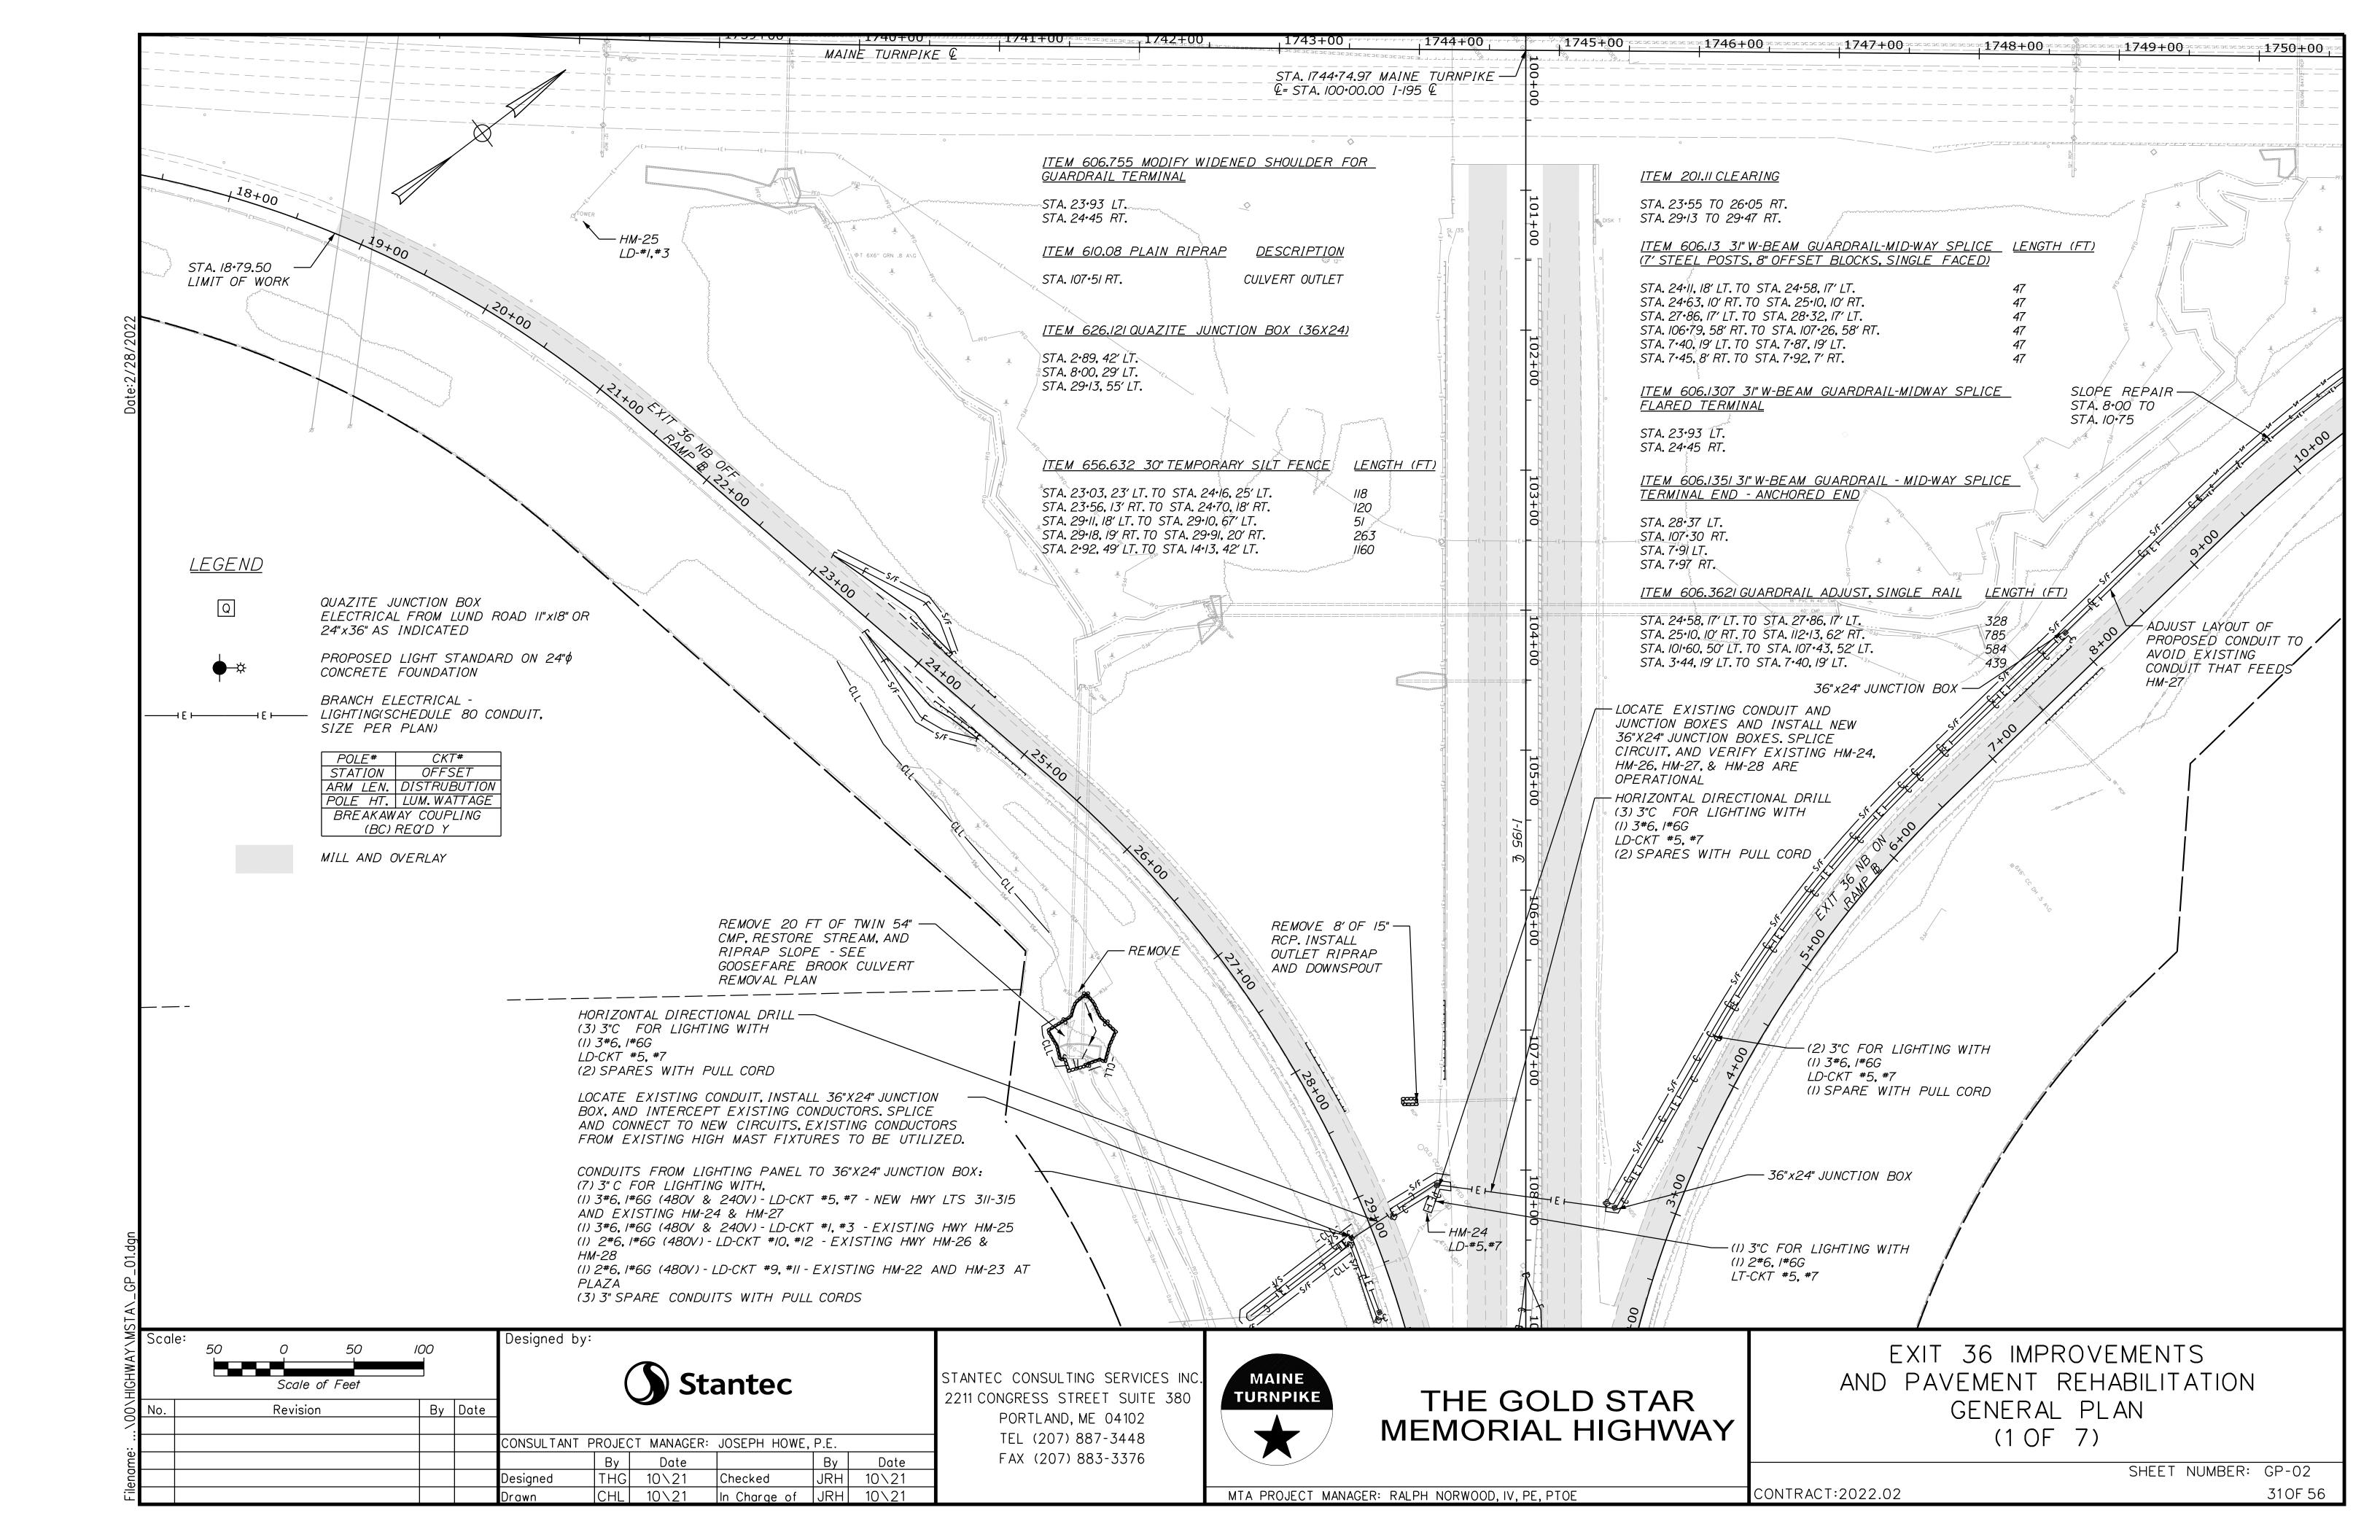


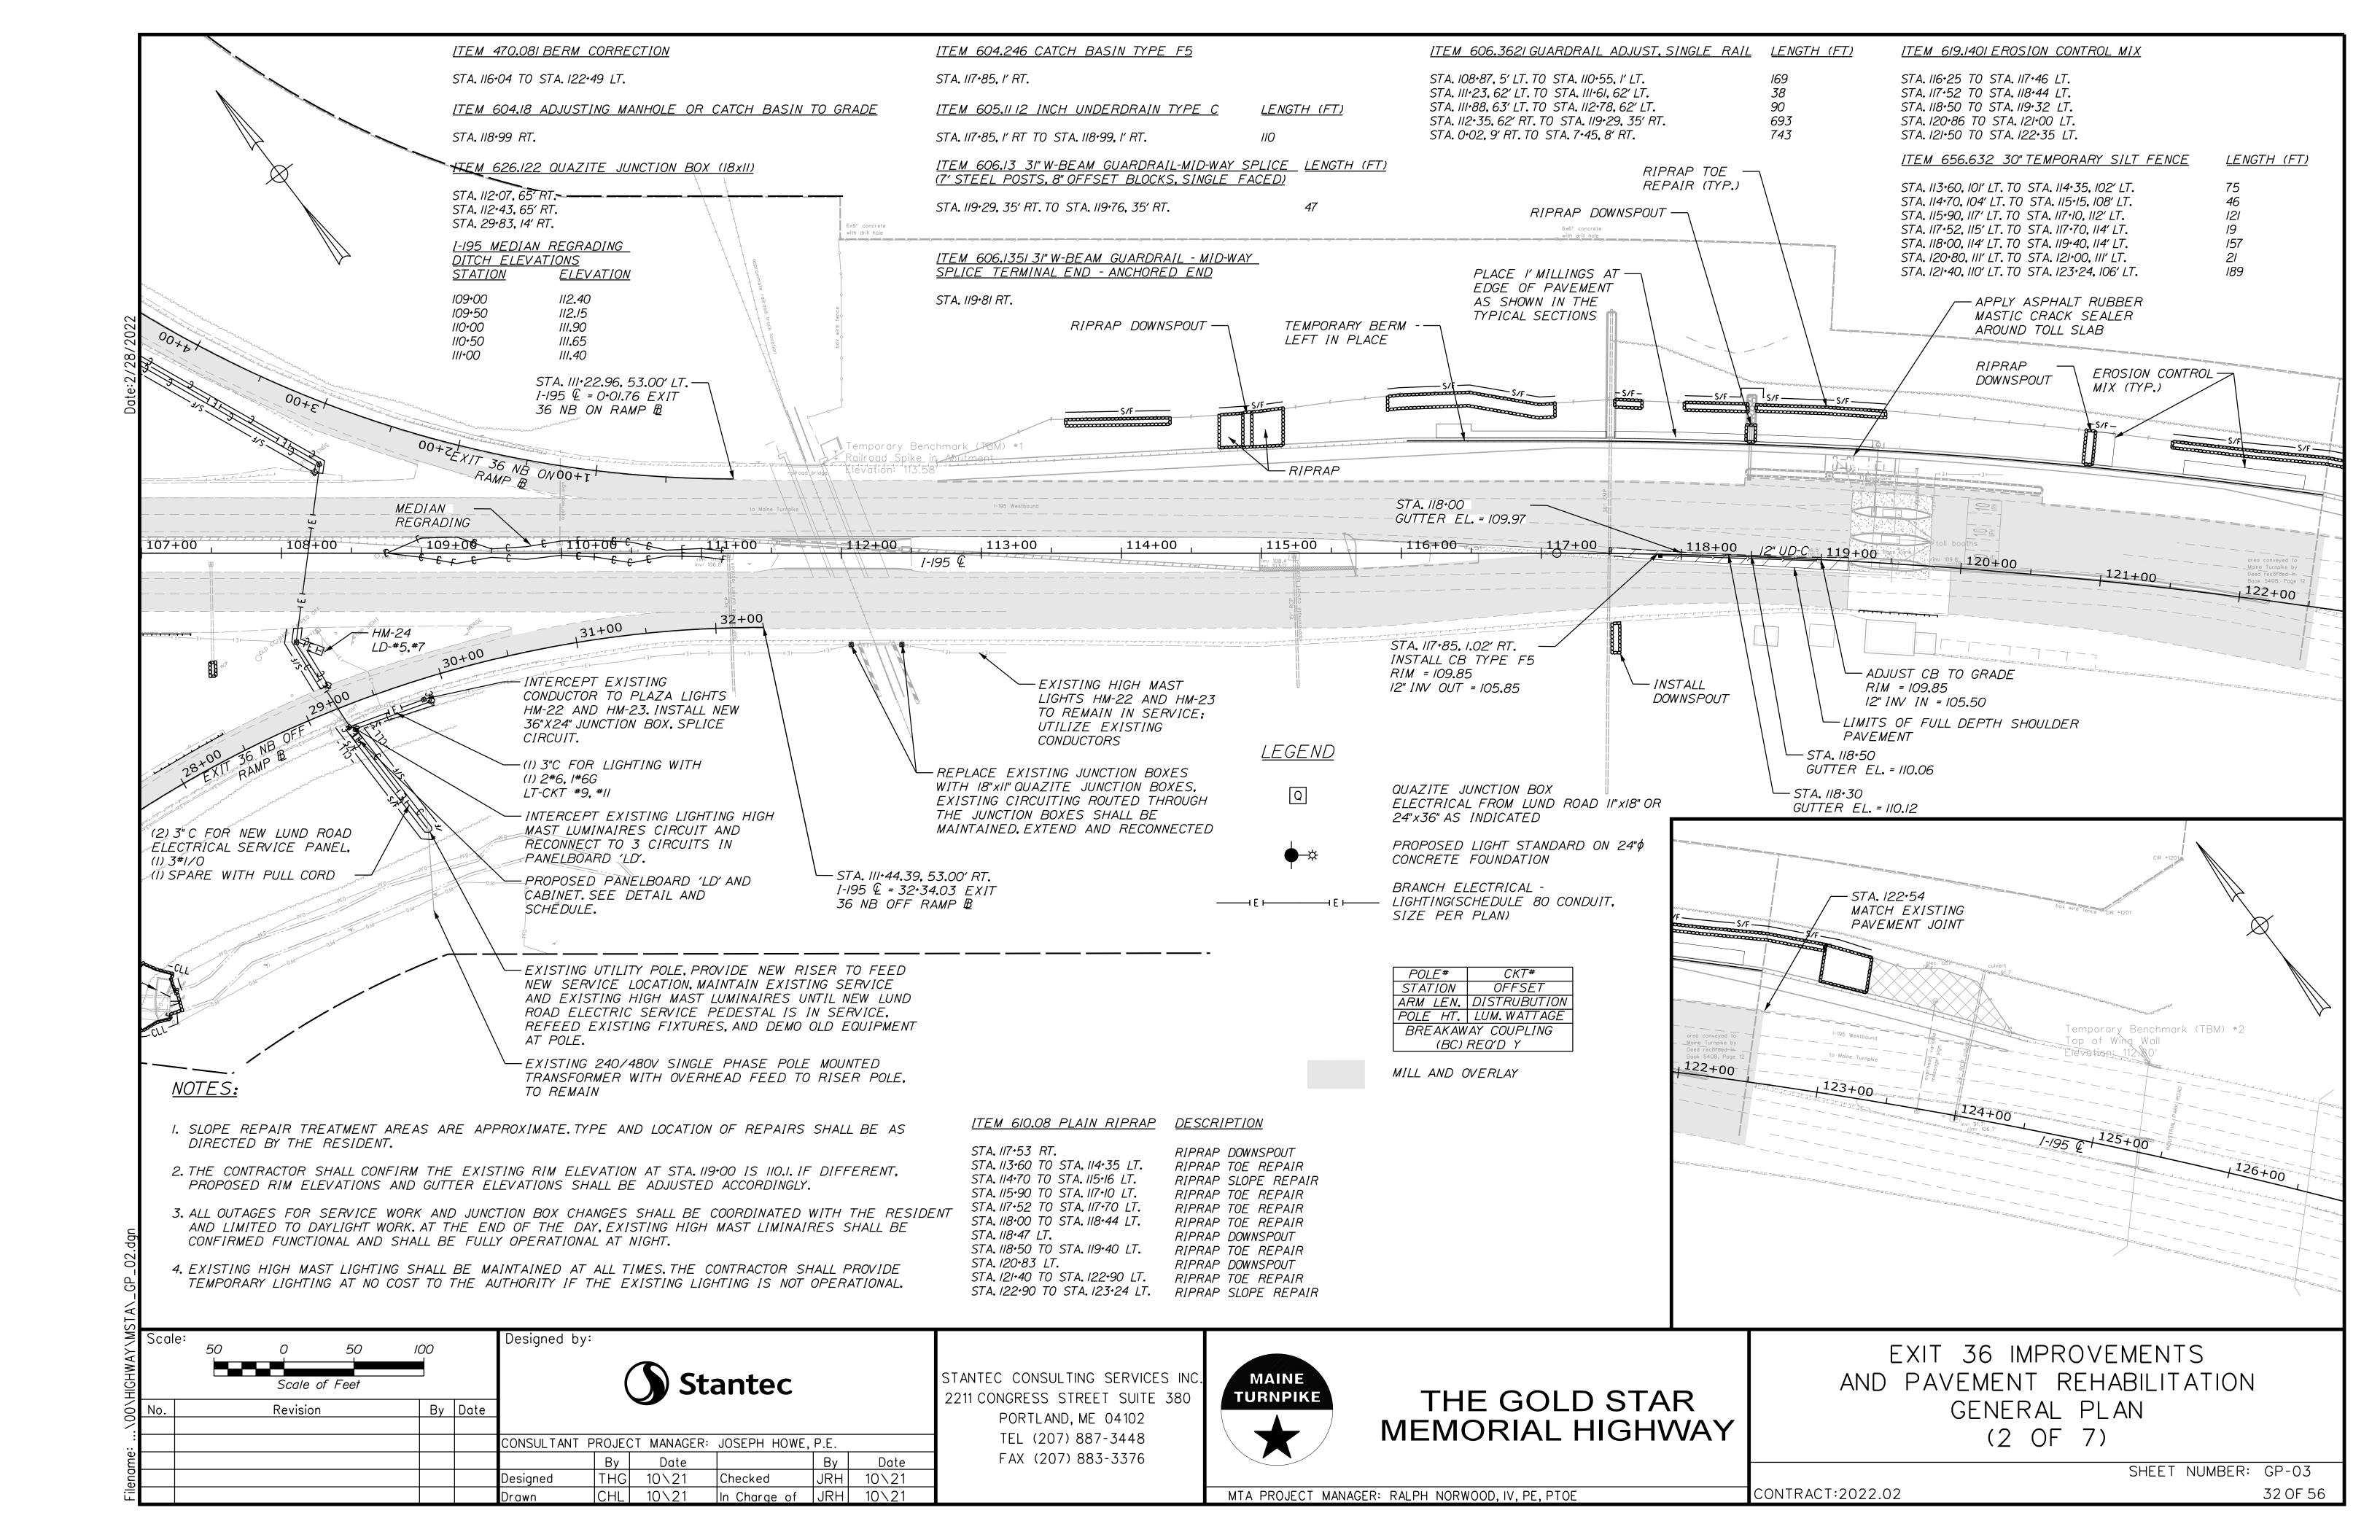


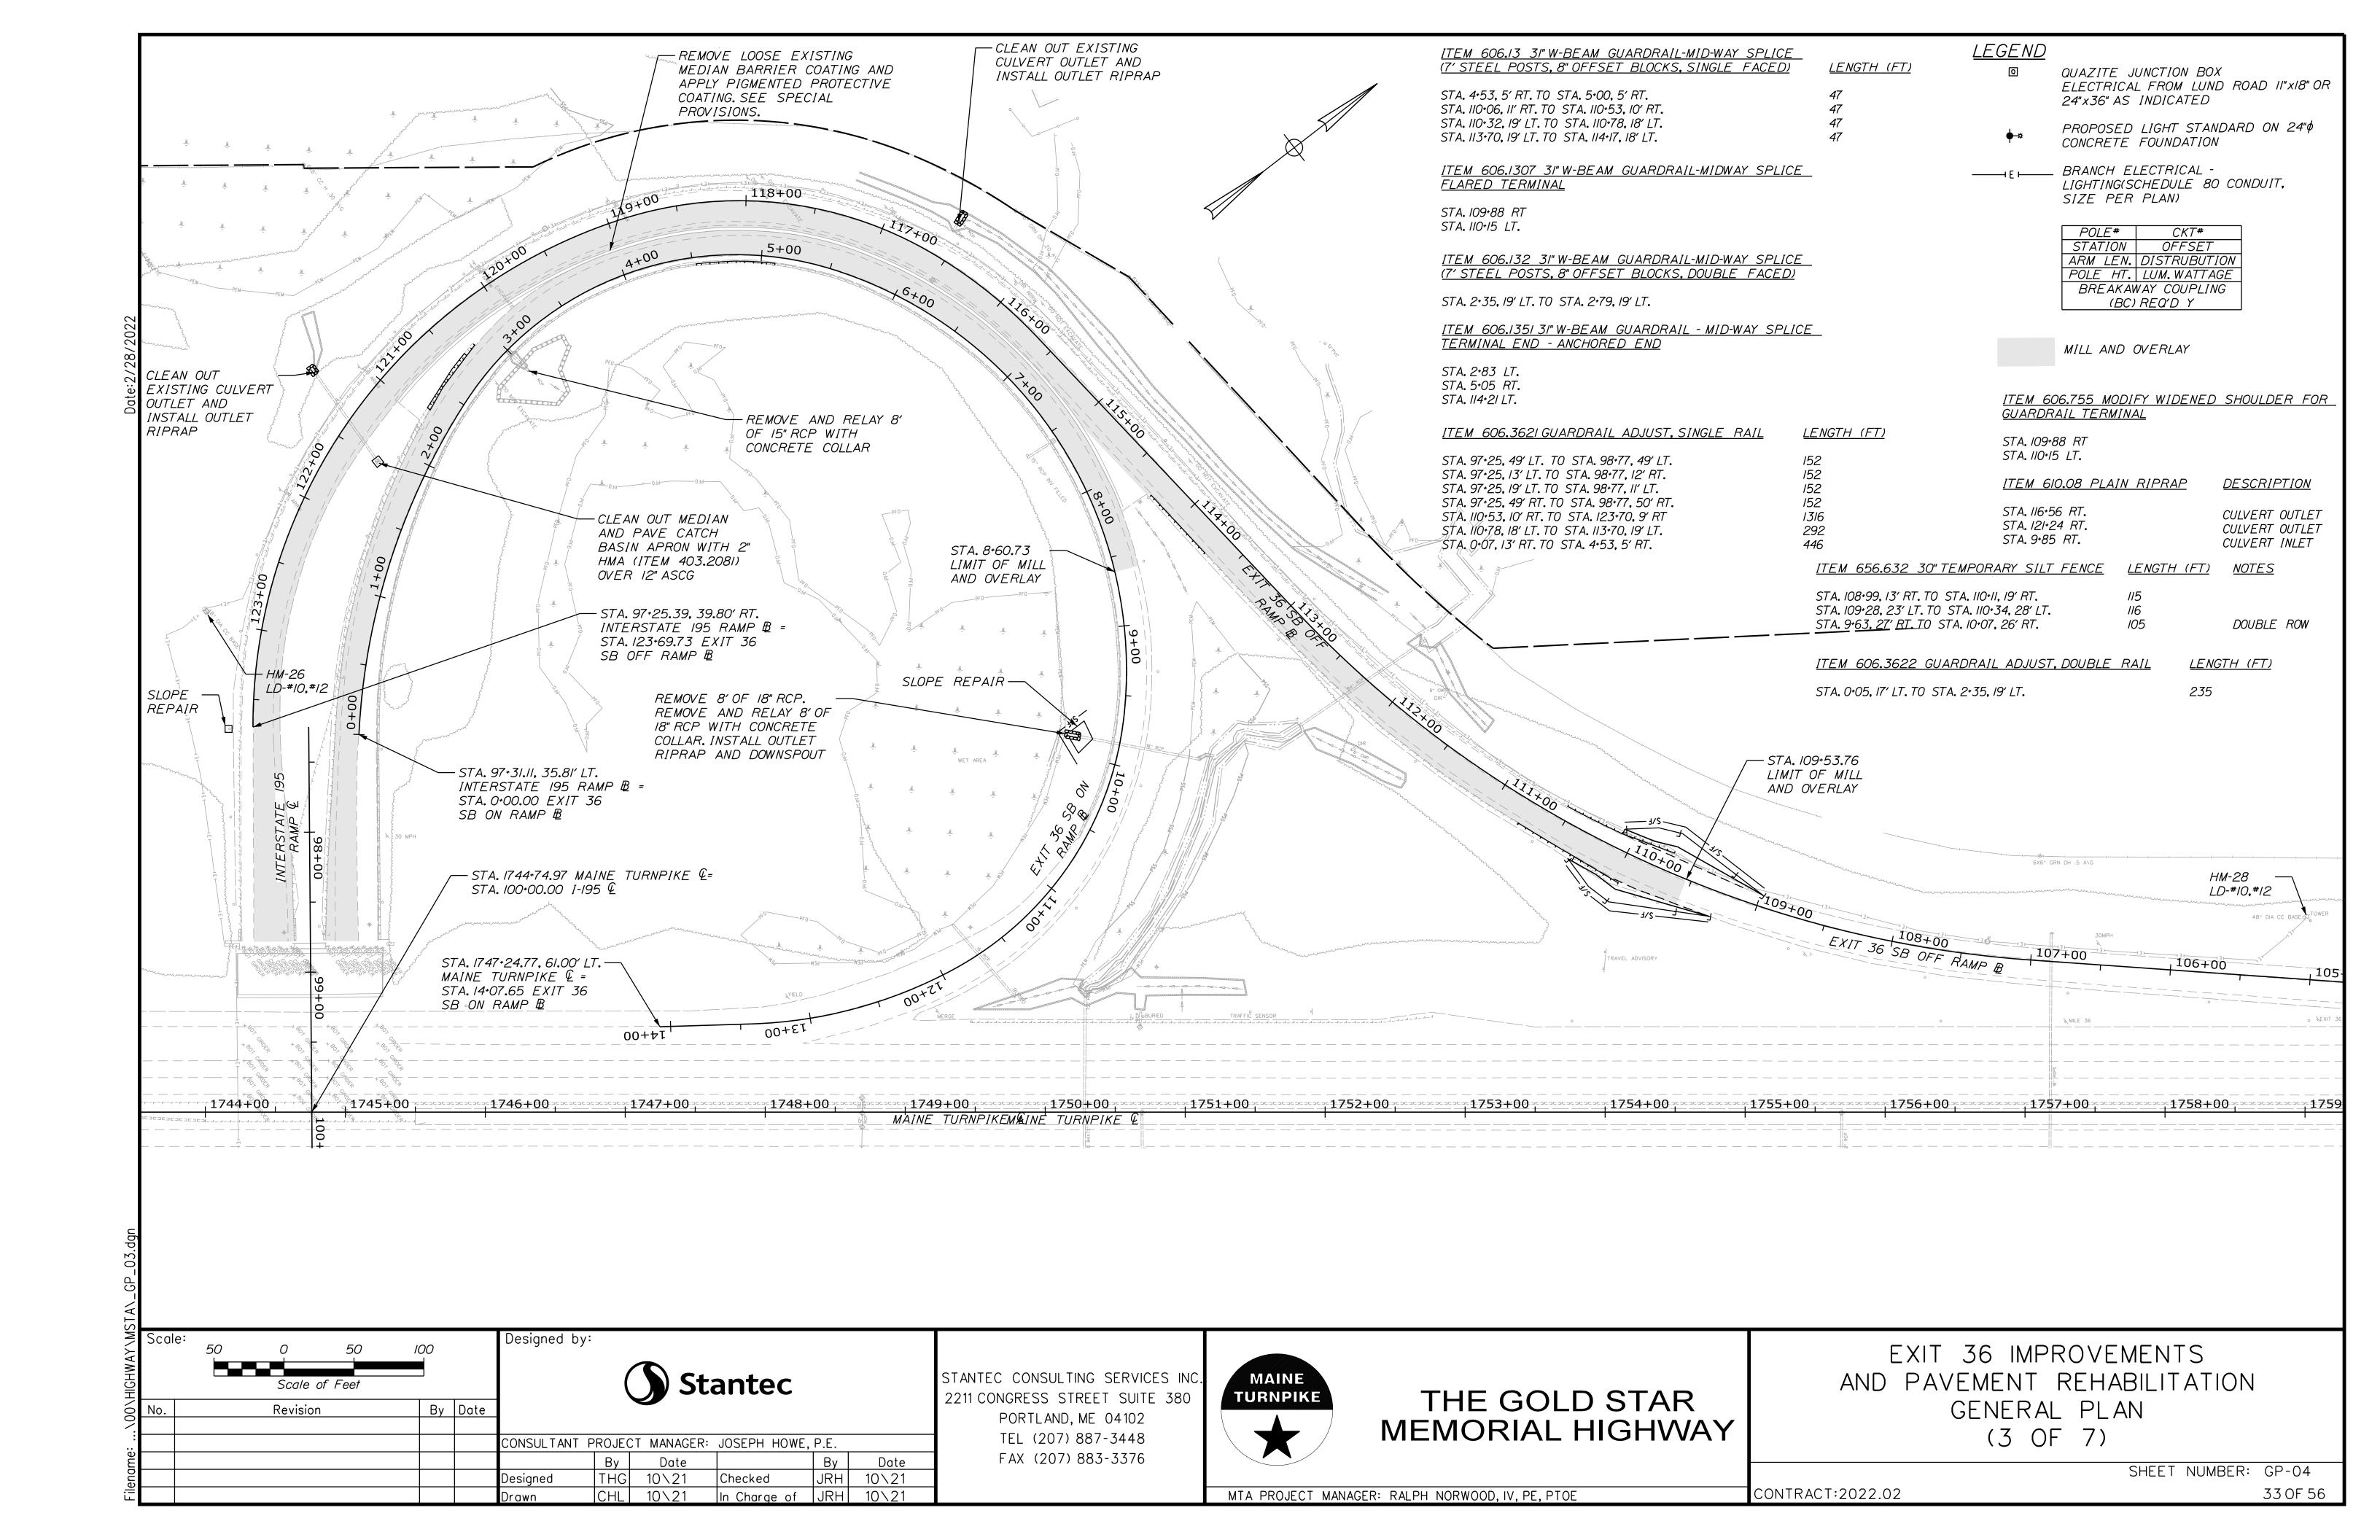


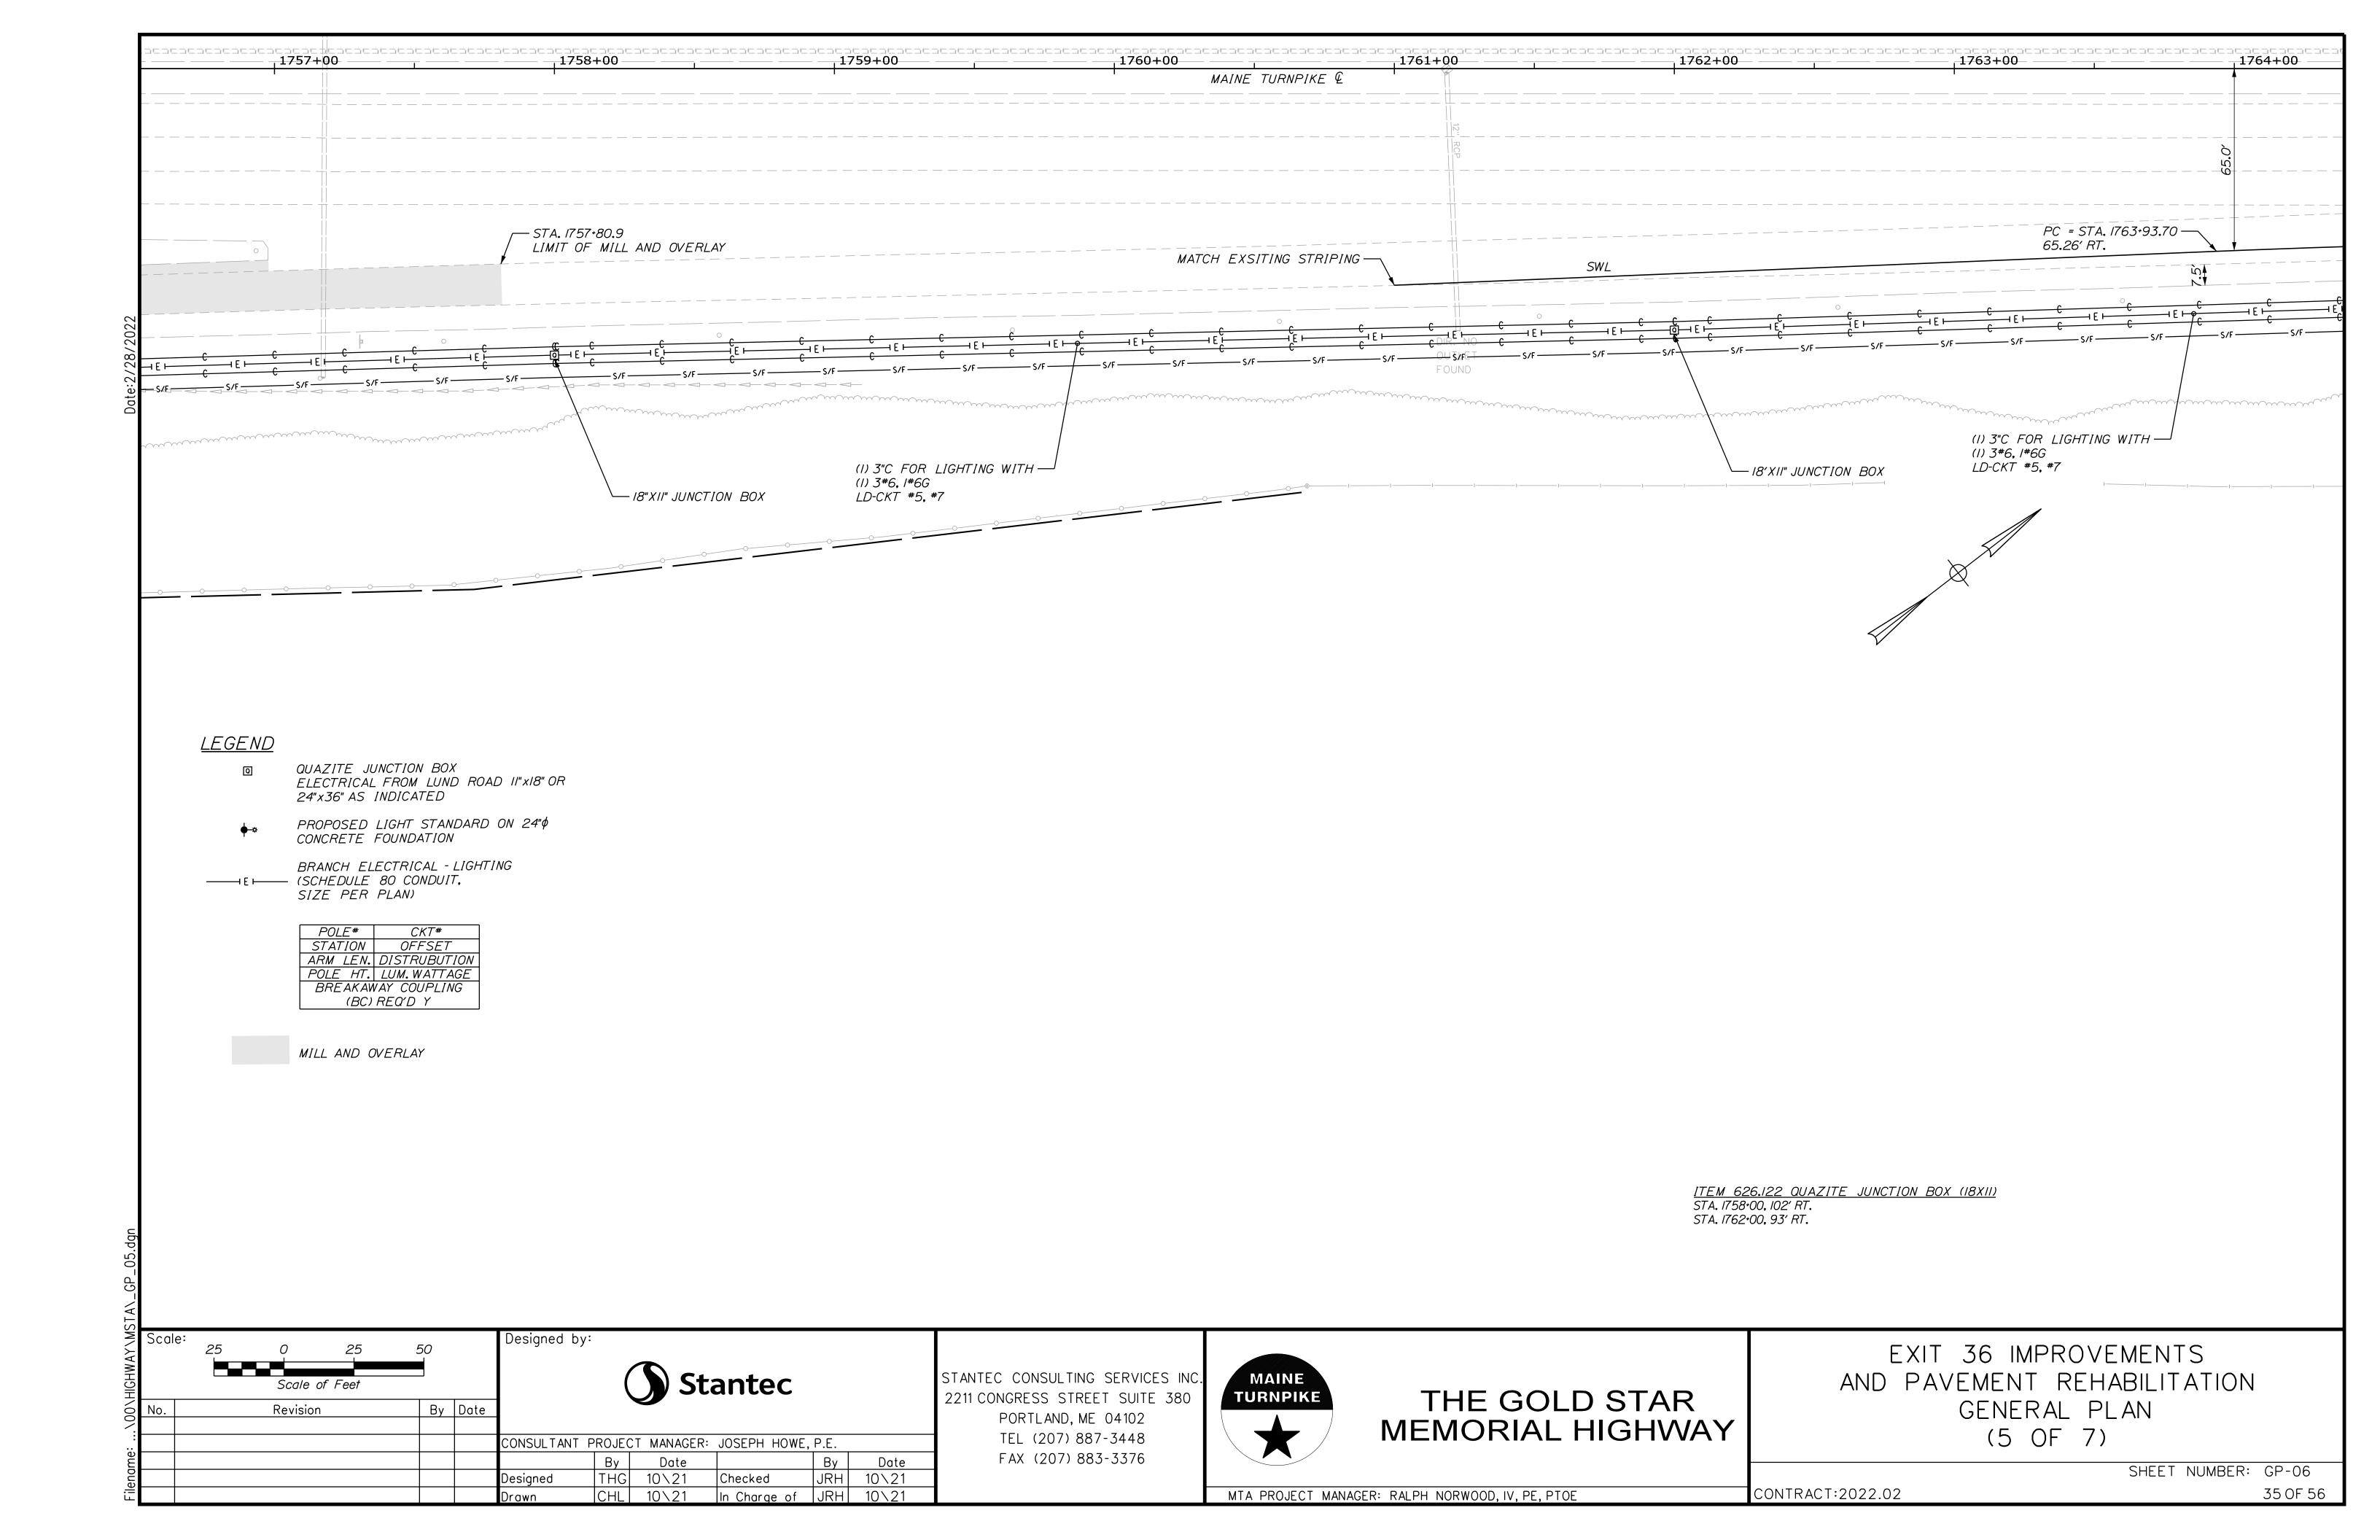


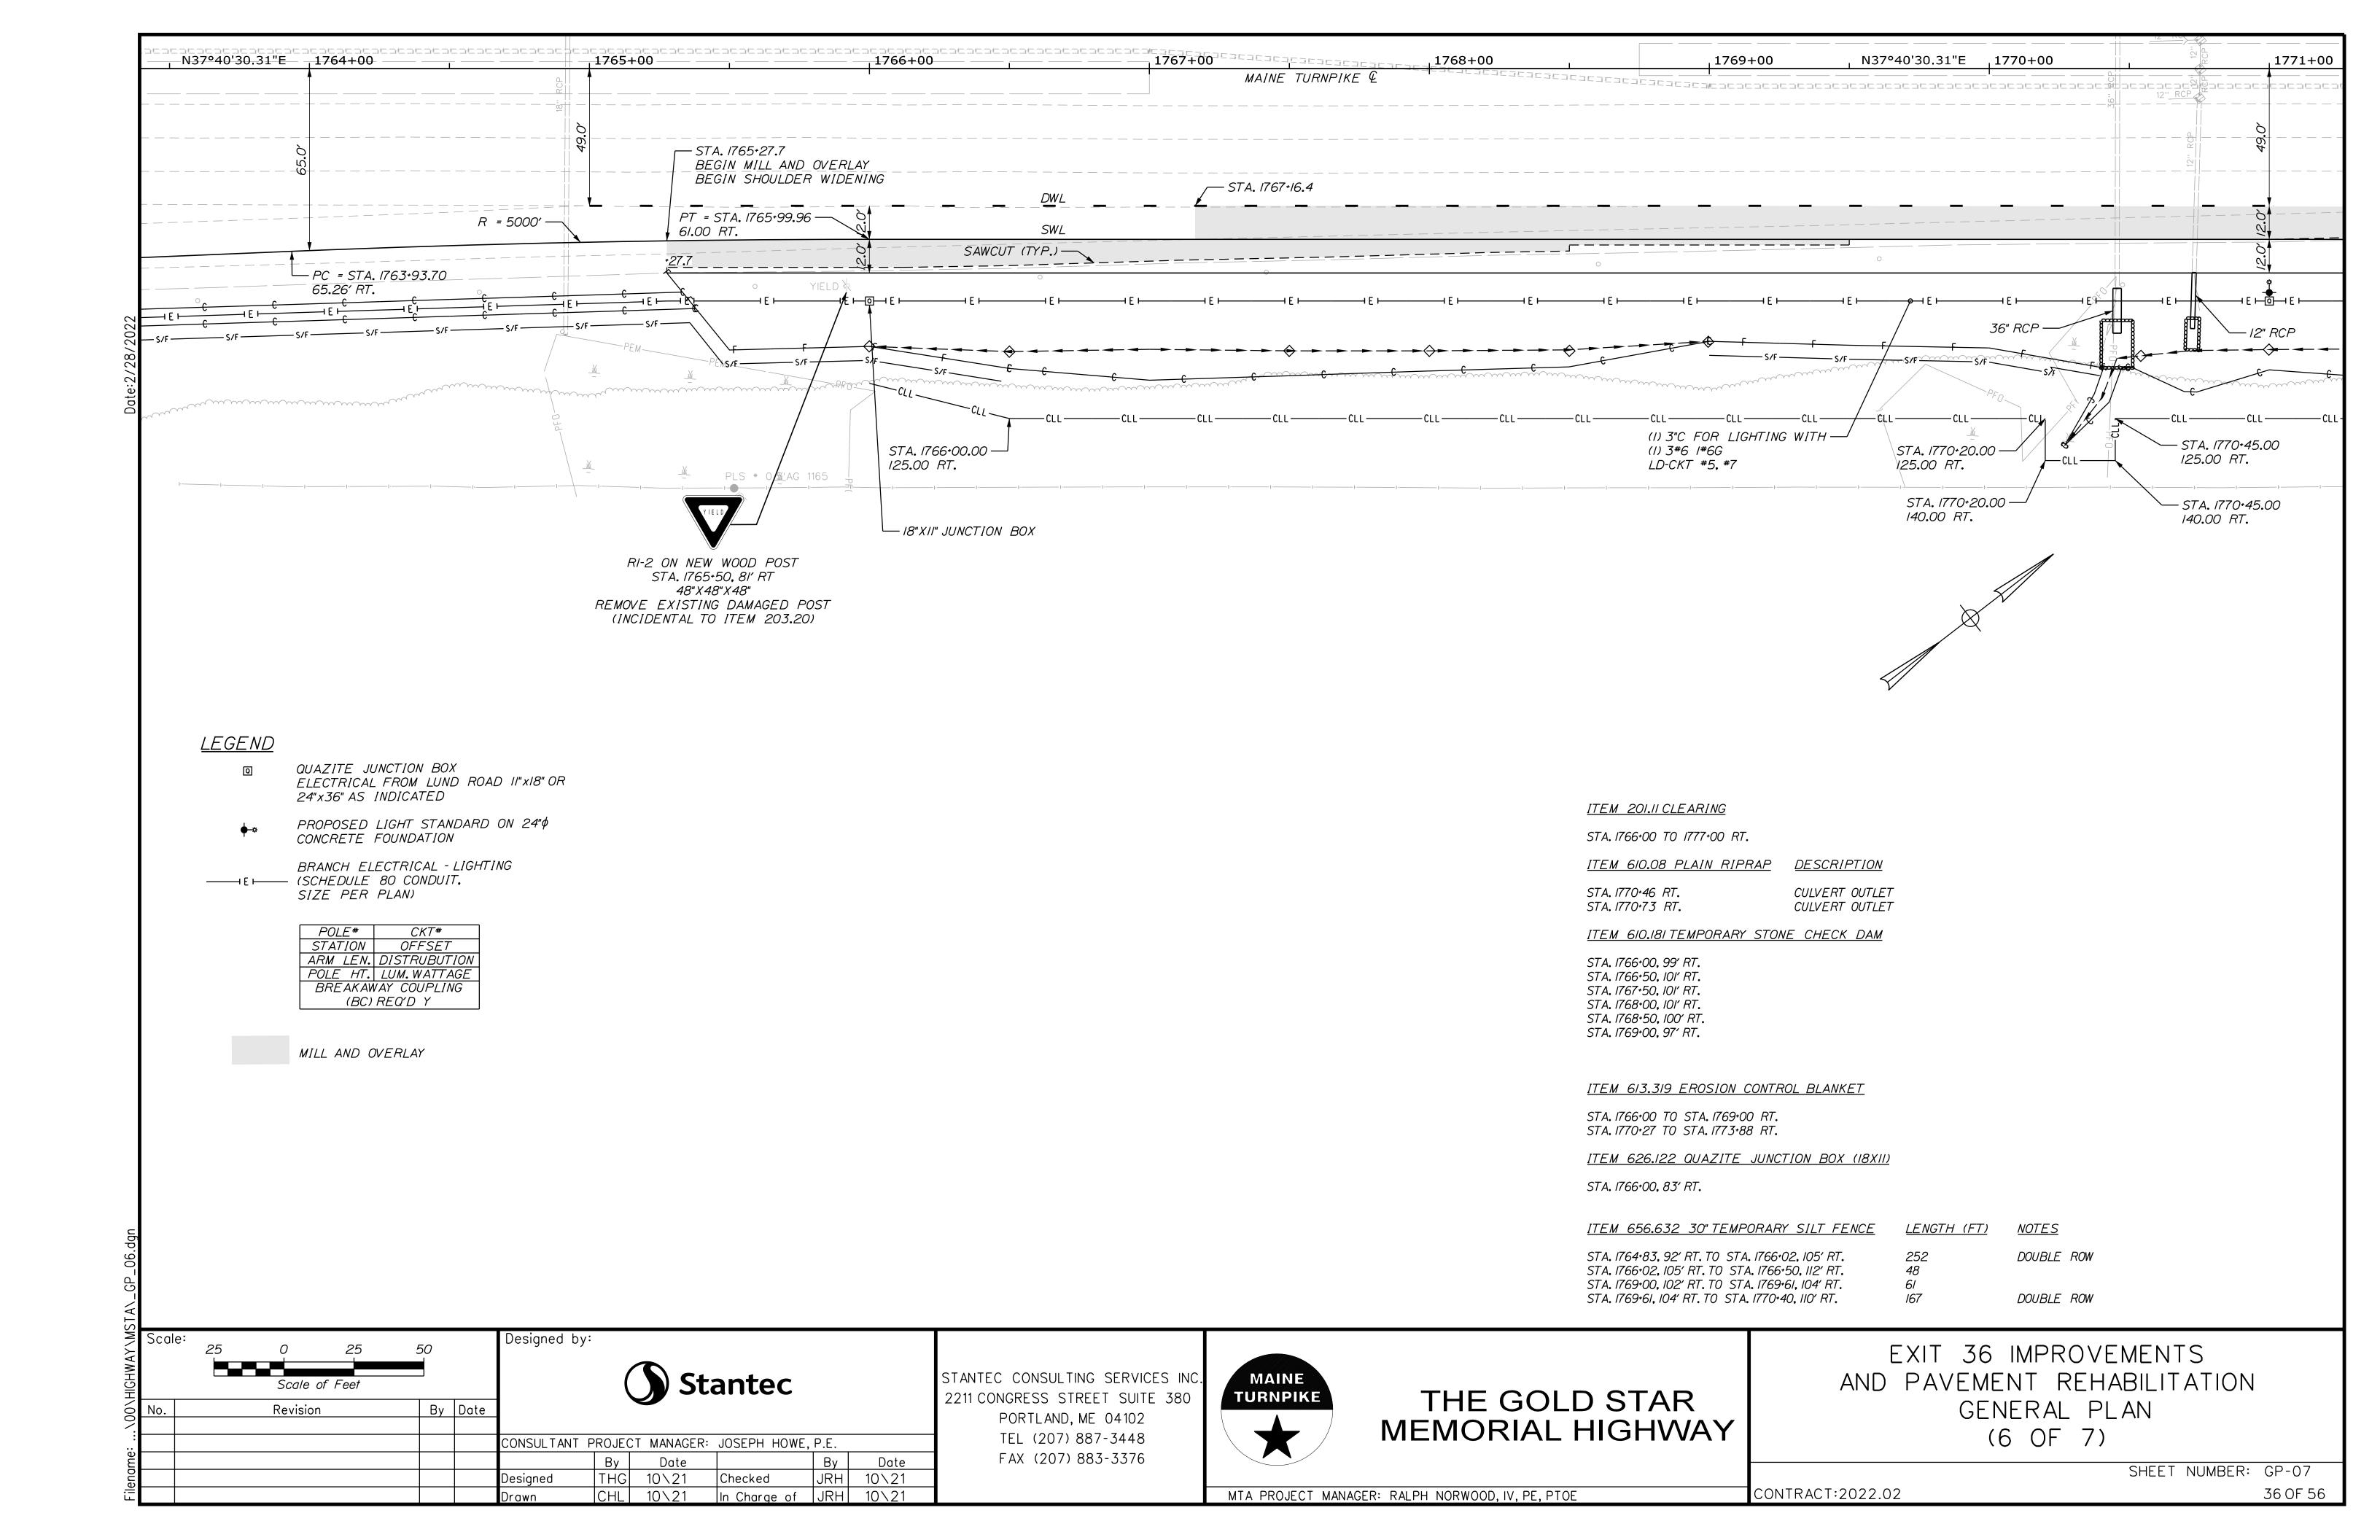

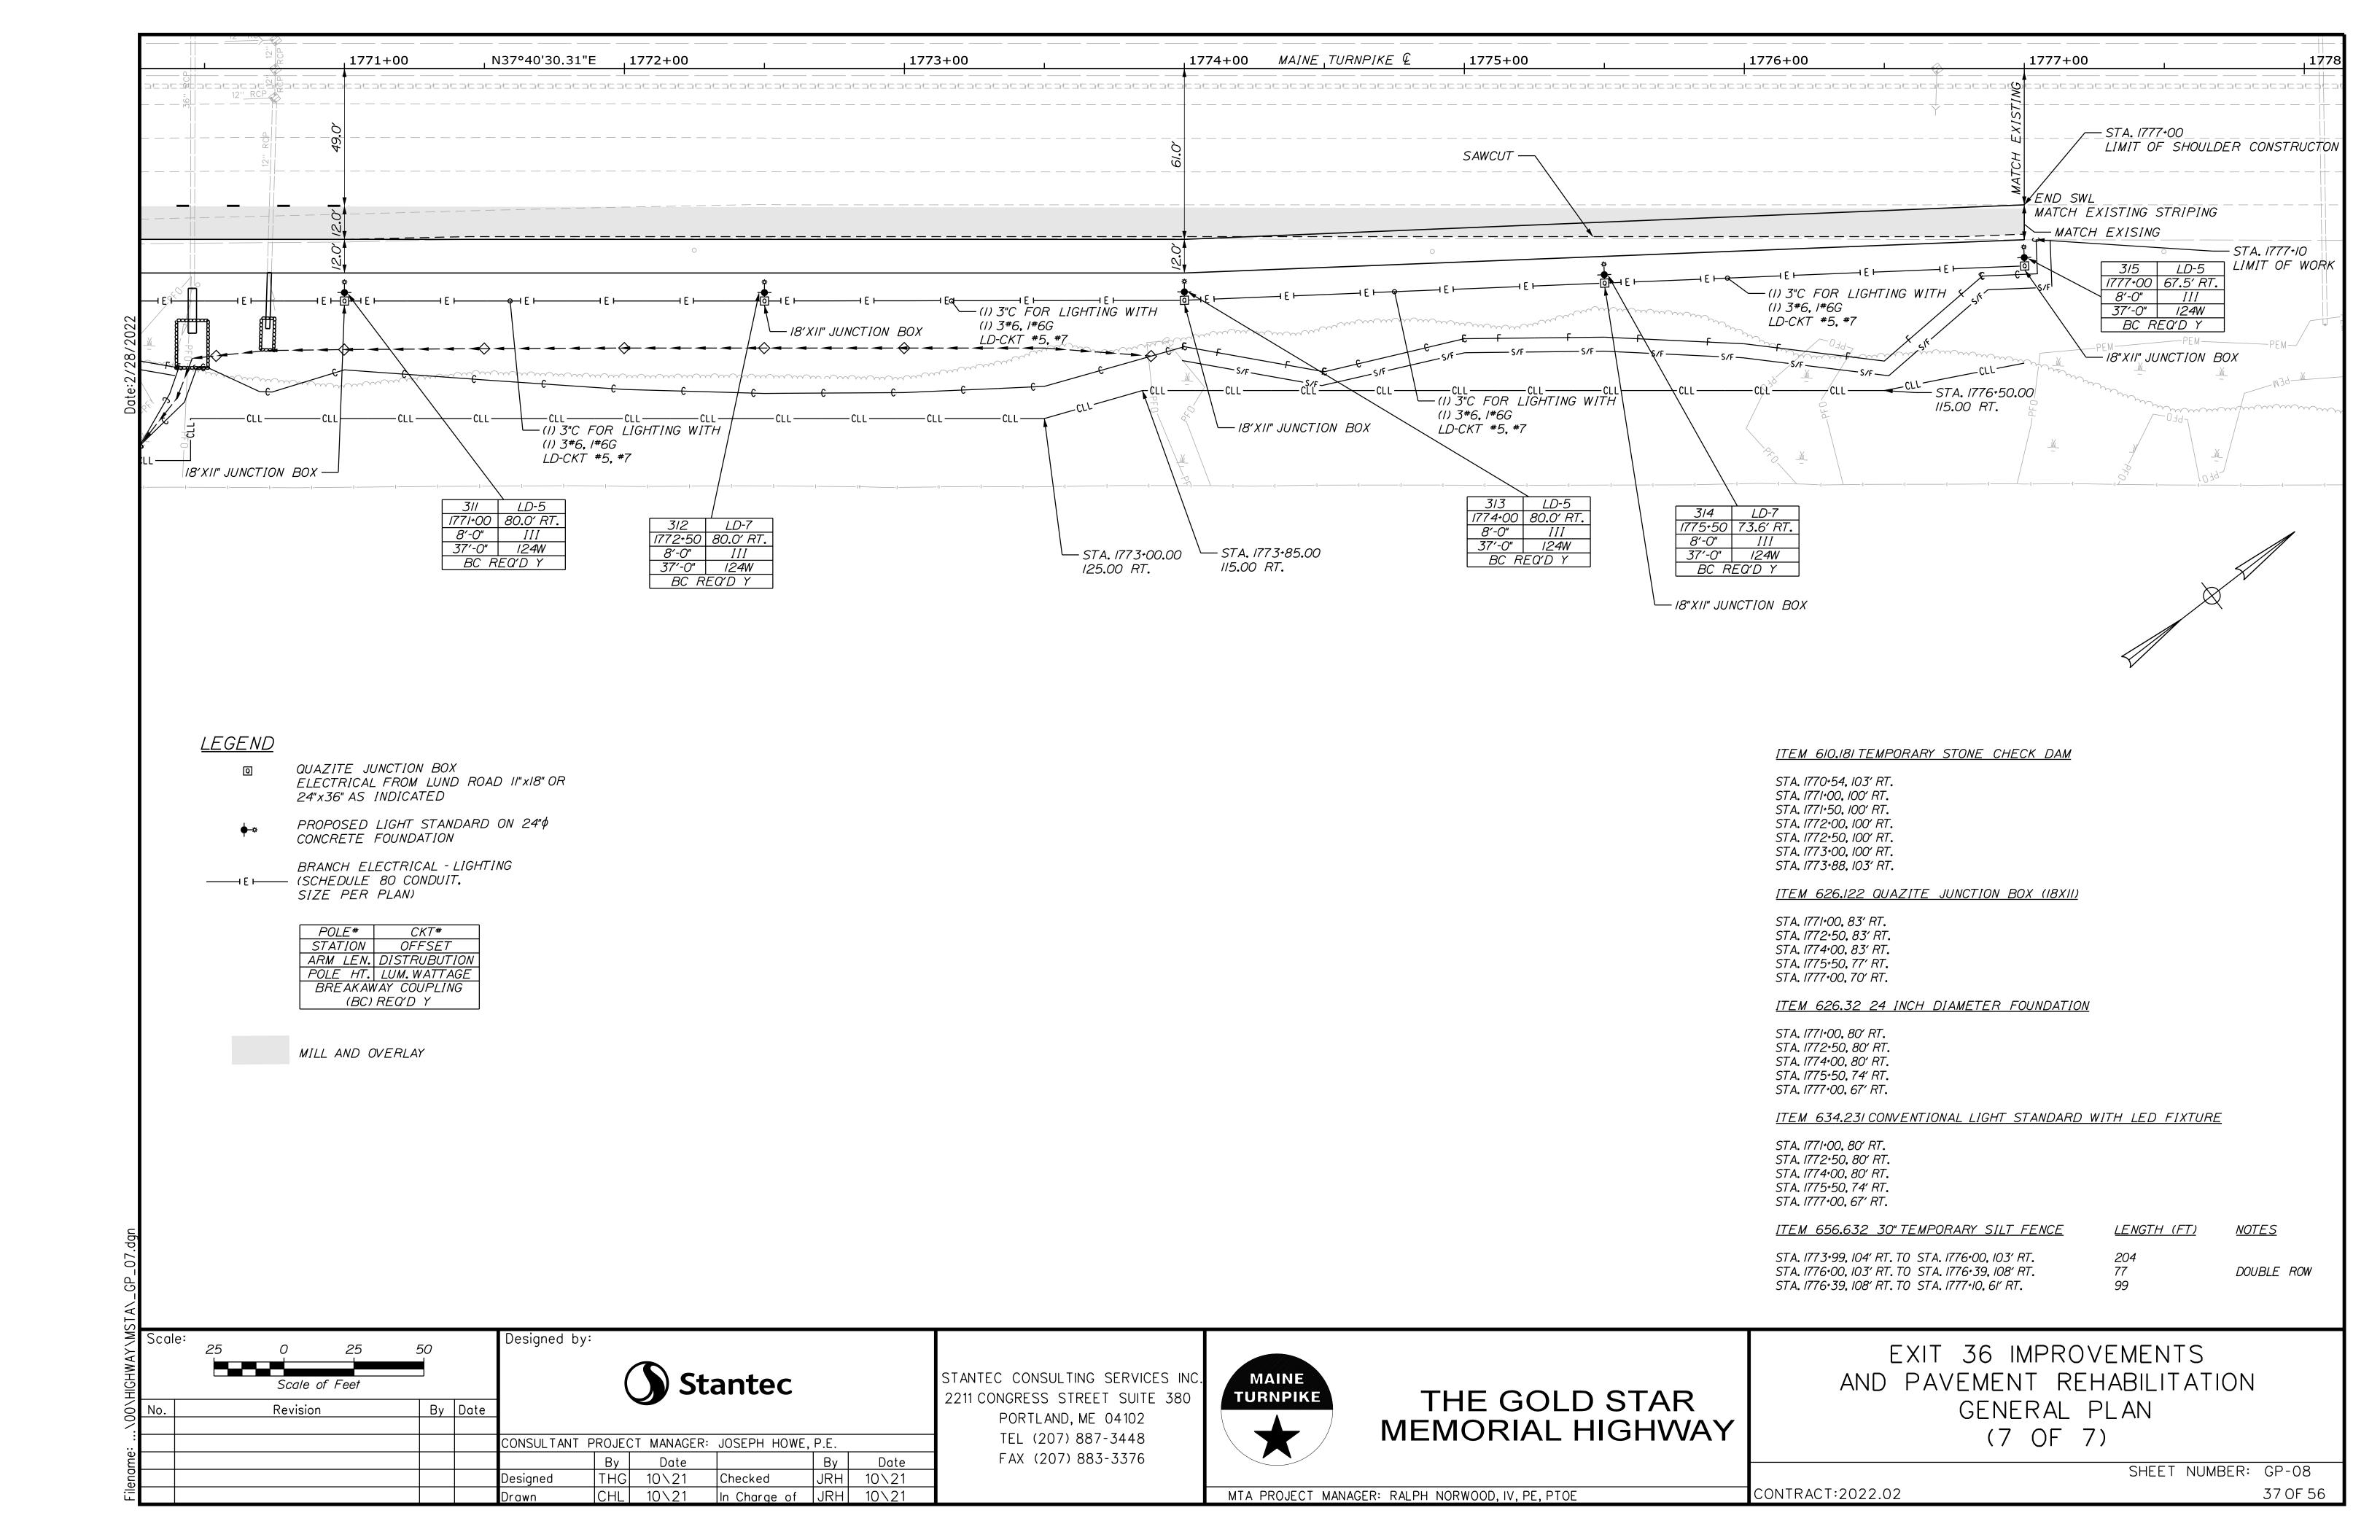

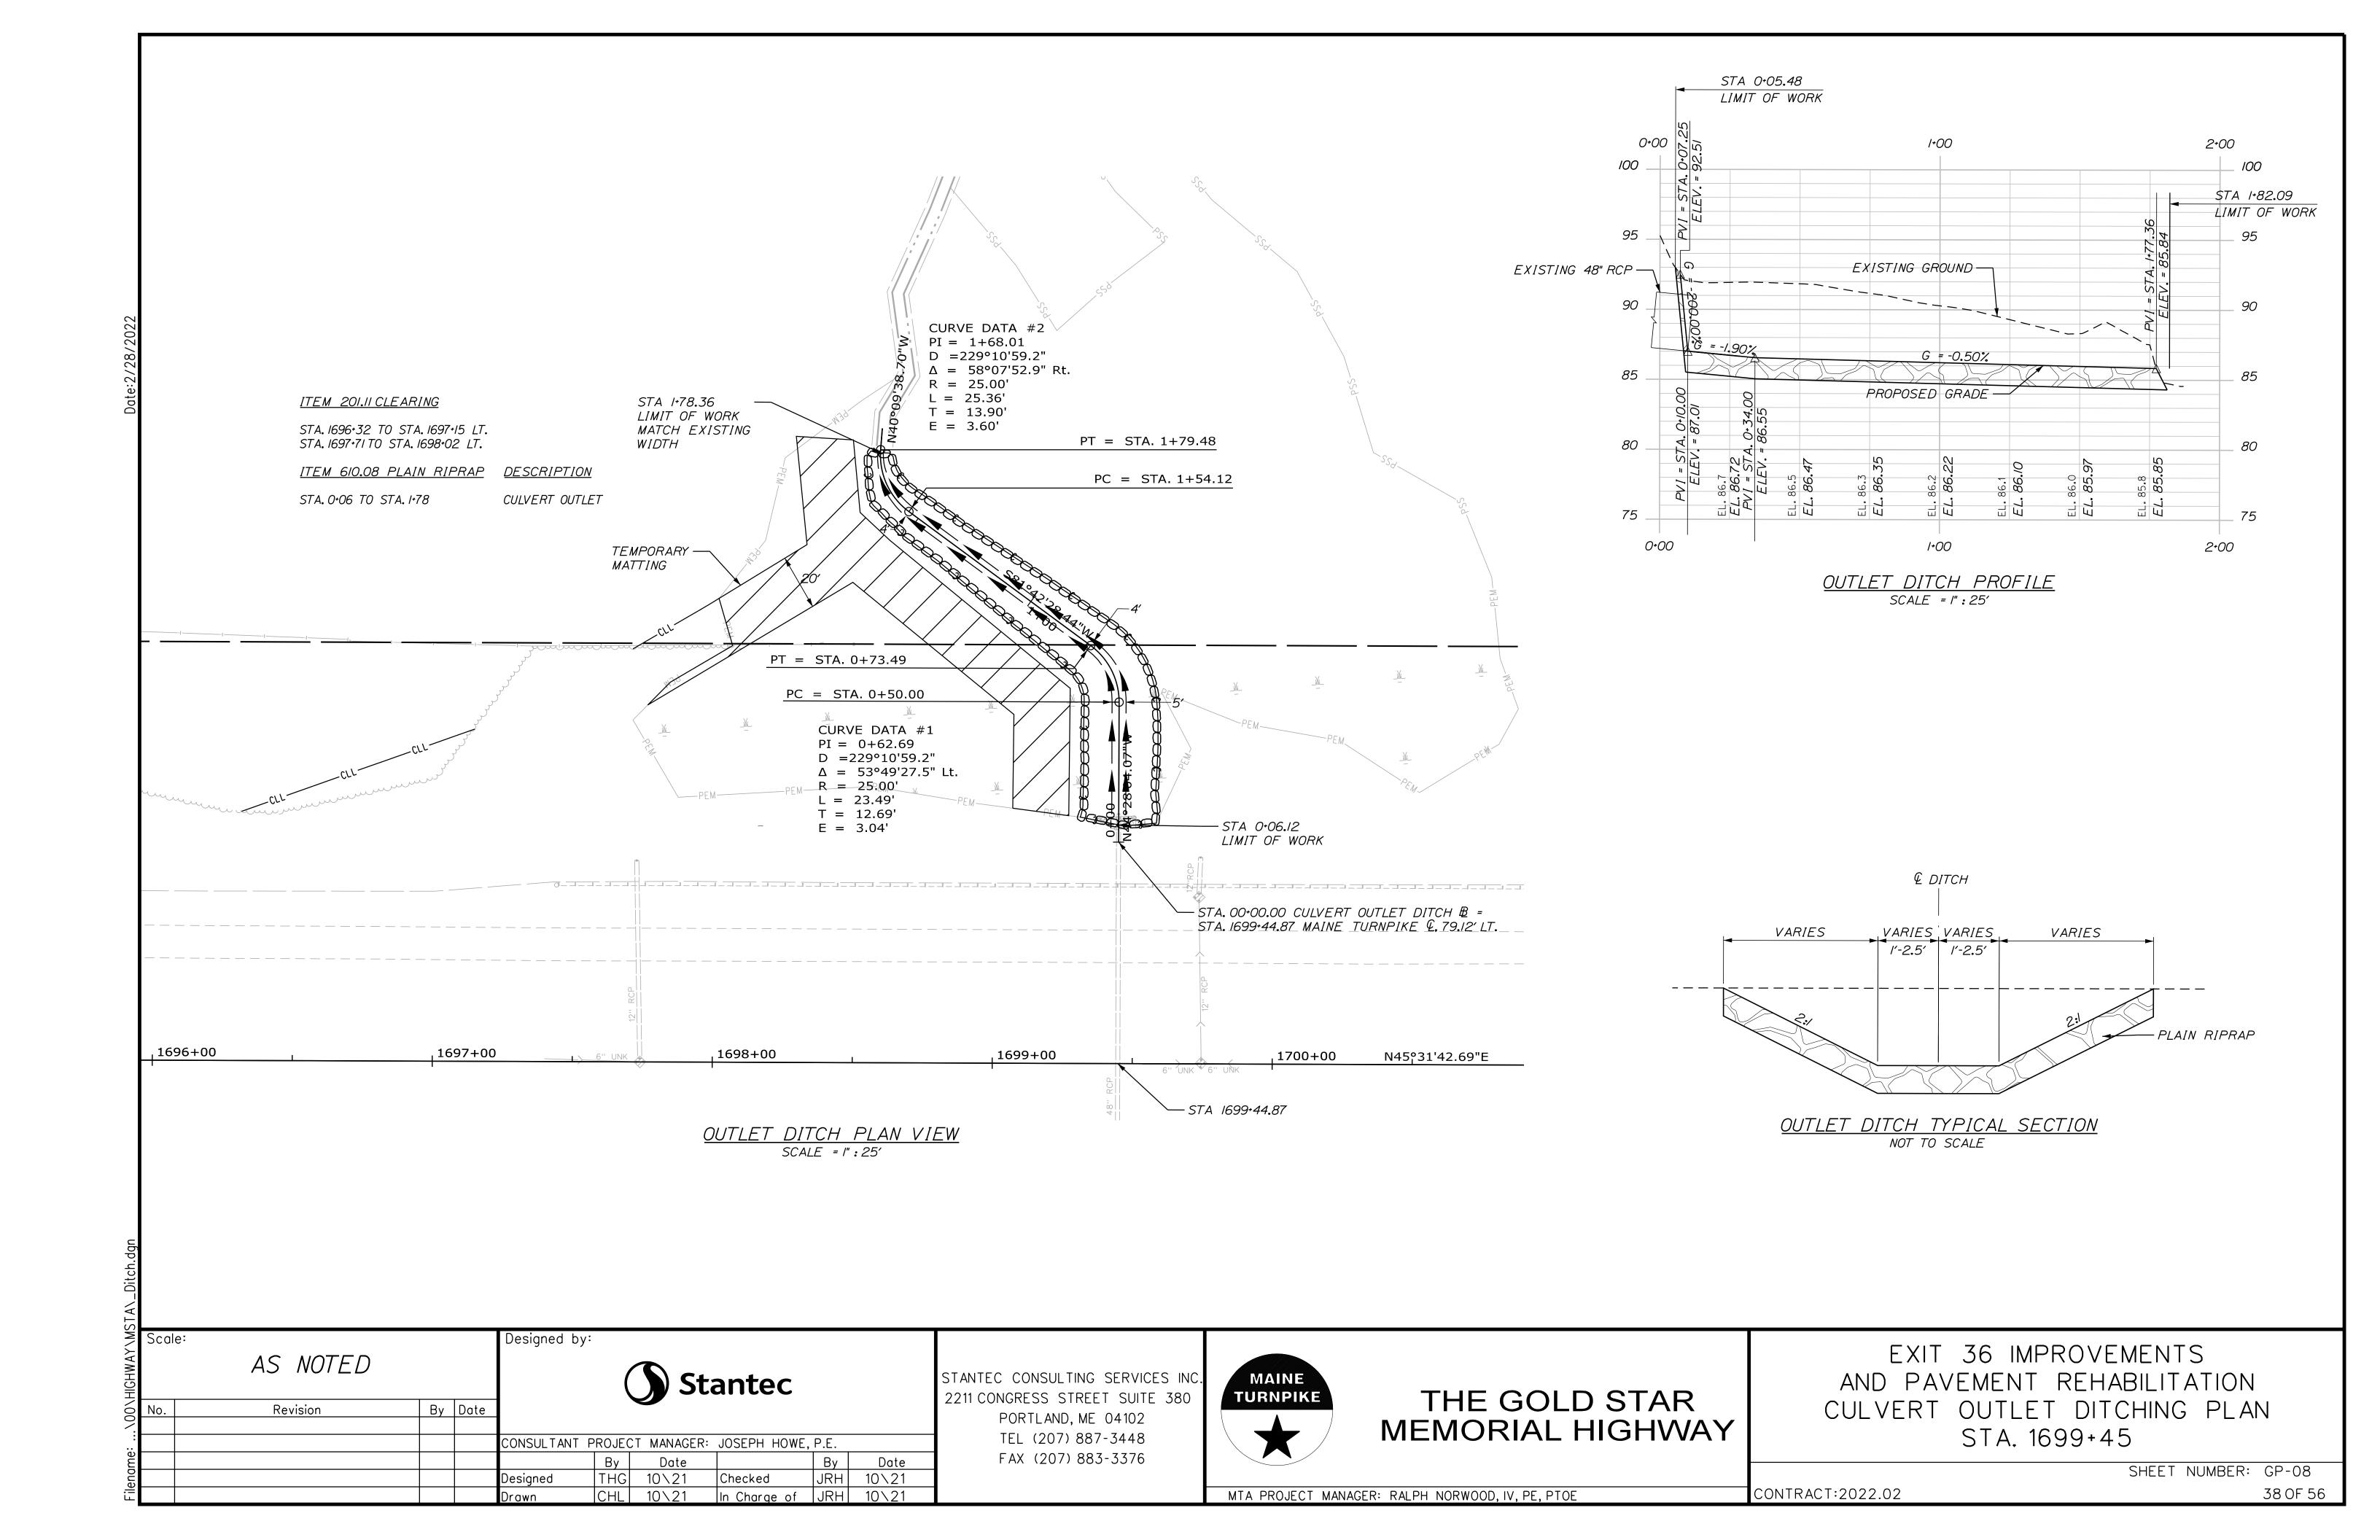

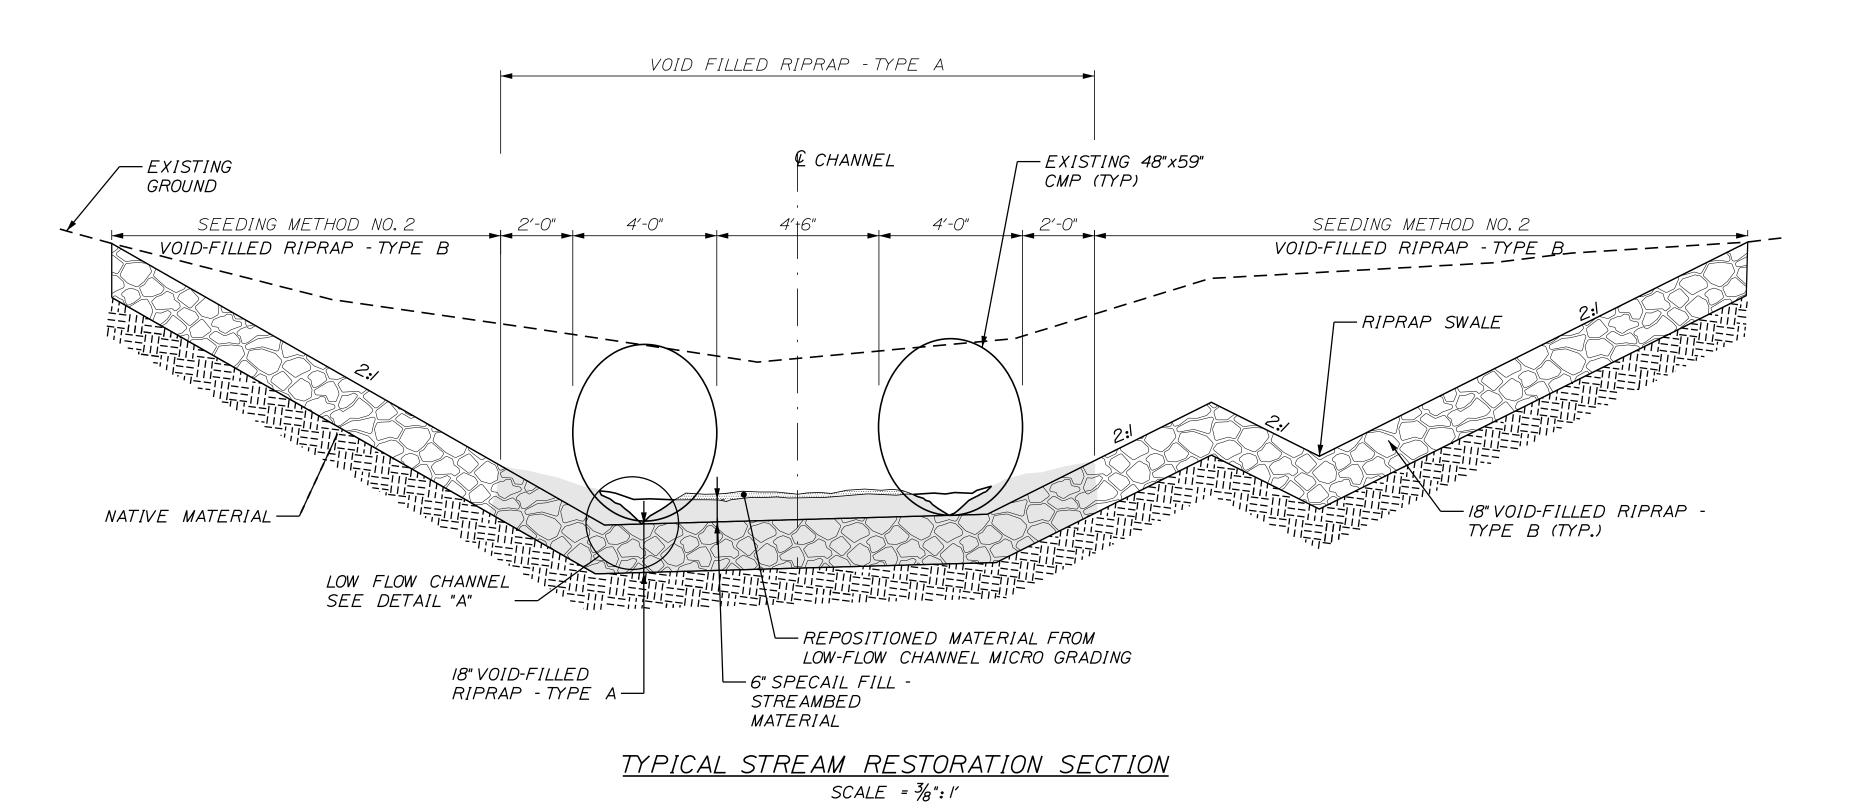

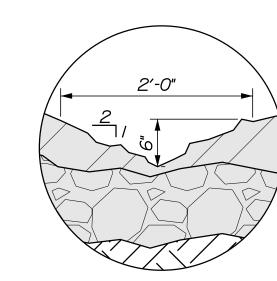


DETAIL "A" - LOW FLOW CHANNEL

SCALE: |" = |'-0"


NOTES:

- I. PRIOR TO INSTALLING THE SPECIAL FILL STREAMBED MATERIAL, THE VOID-FILLED RIPRAP TYPE "A" SHALL BE FLOODED AND OBSERVED TO ENSURE THAT THE TOP LAYER OF THE VOID-FILLED RIPRAP TYPE "A" WILL POND WATER ON THE SURFACE. ADDITIONAL MATERIAL WITH SIGNIFICANT PROPORTION OF FINES SHALL BE WASHED-IN TO FILL AND SEAL ANY REMAINING VOIDS UNTIL WATER PONDS ON THE SURFACE.
- 2. LOW-FLOW CHANNEL VARIES HORIZONTALLY FROM O'TO I'TO EITHER SIDE OF CHANNEL CENTERLINE. SEE PLAN FOR APPROXIMATE ALIGNMENT OF THE LOW-FLOW CHANNEL.

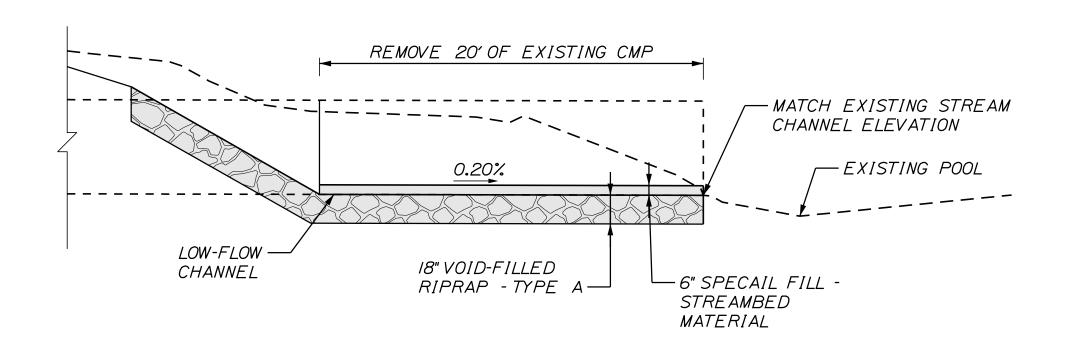

TYPICAL CULVERT REMOVAL AND CHANNEL PROFILE

SCALE = 1":5'

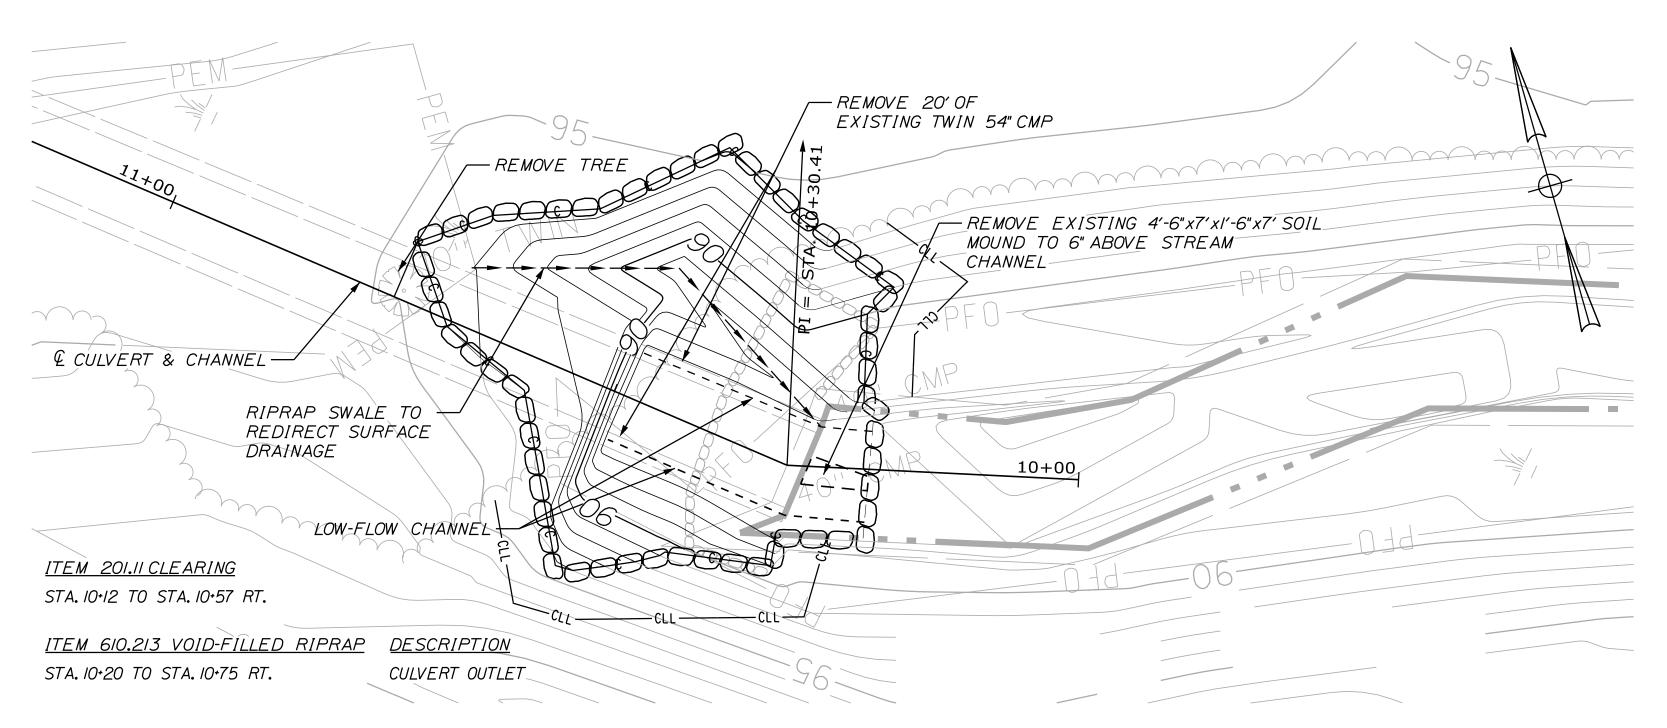

GOOSEFARE BROOK PLAN VIEW

SCALE = 1":10'

ert	Scale	:			Designed by	/ :					
A_Culvert		AS NOTED			Stantec						
\MST.	No.	Revision	Ву	Date	1						22
:					CONSULTANT	PROJEC	T MANAGER	: JOSEPH HOWE	, P.E.		1
me						Ву	Date		Ву	Date	
ilename					Designed	THG	10\21	Checked	JRH	10\21	
File					Drawn	CHL	10\21	In Charge of	JRH	10\21	

STANTEC CONSULTING SERVICES INC.

2211 CONGRESS STREET SUITE 380

PORTLAND, ME 04102

TEL (207) 887-3448

FAX (207) 883-3376



MTA PROJECT MANAGER: RALPH NORWOOD, IV, PE, PTOE

THE GOLD STAR MEMORIAL HIGHWAY


EXIT 36 IMPROVEMENTS


AND PAVEMENT REHABILITATION


GOOSEFARE BROOK


CULVERT REMOVAL PLAN


SHEET NUMBER: GP-09 CONTRACT:2022.02 39 OF 56

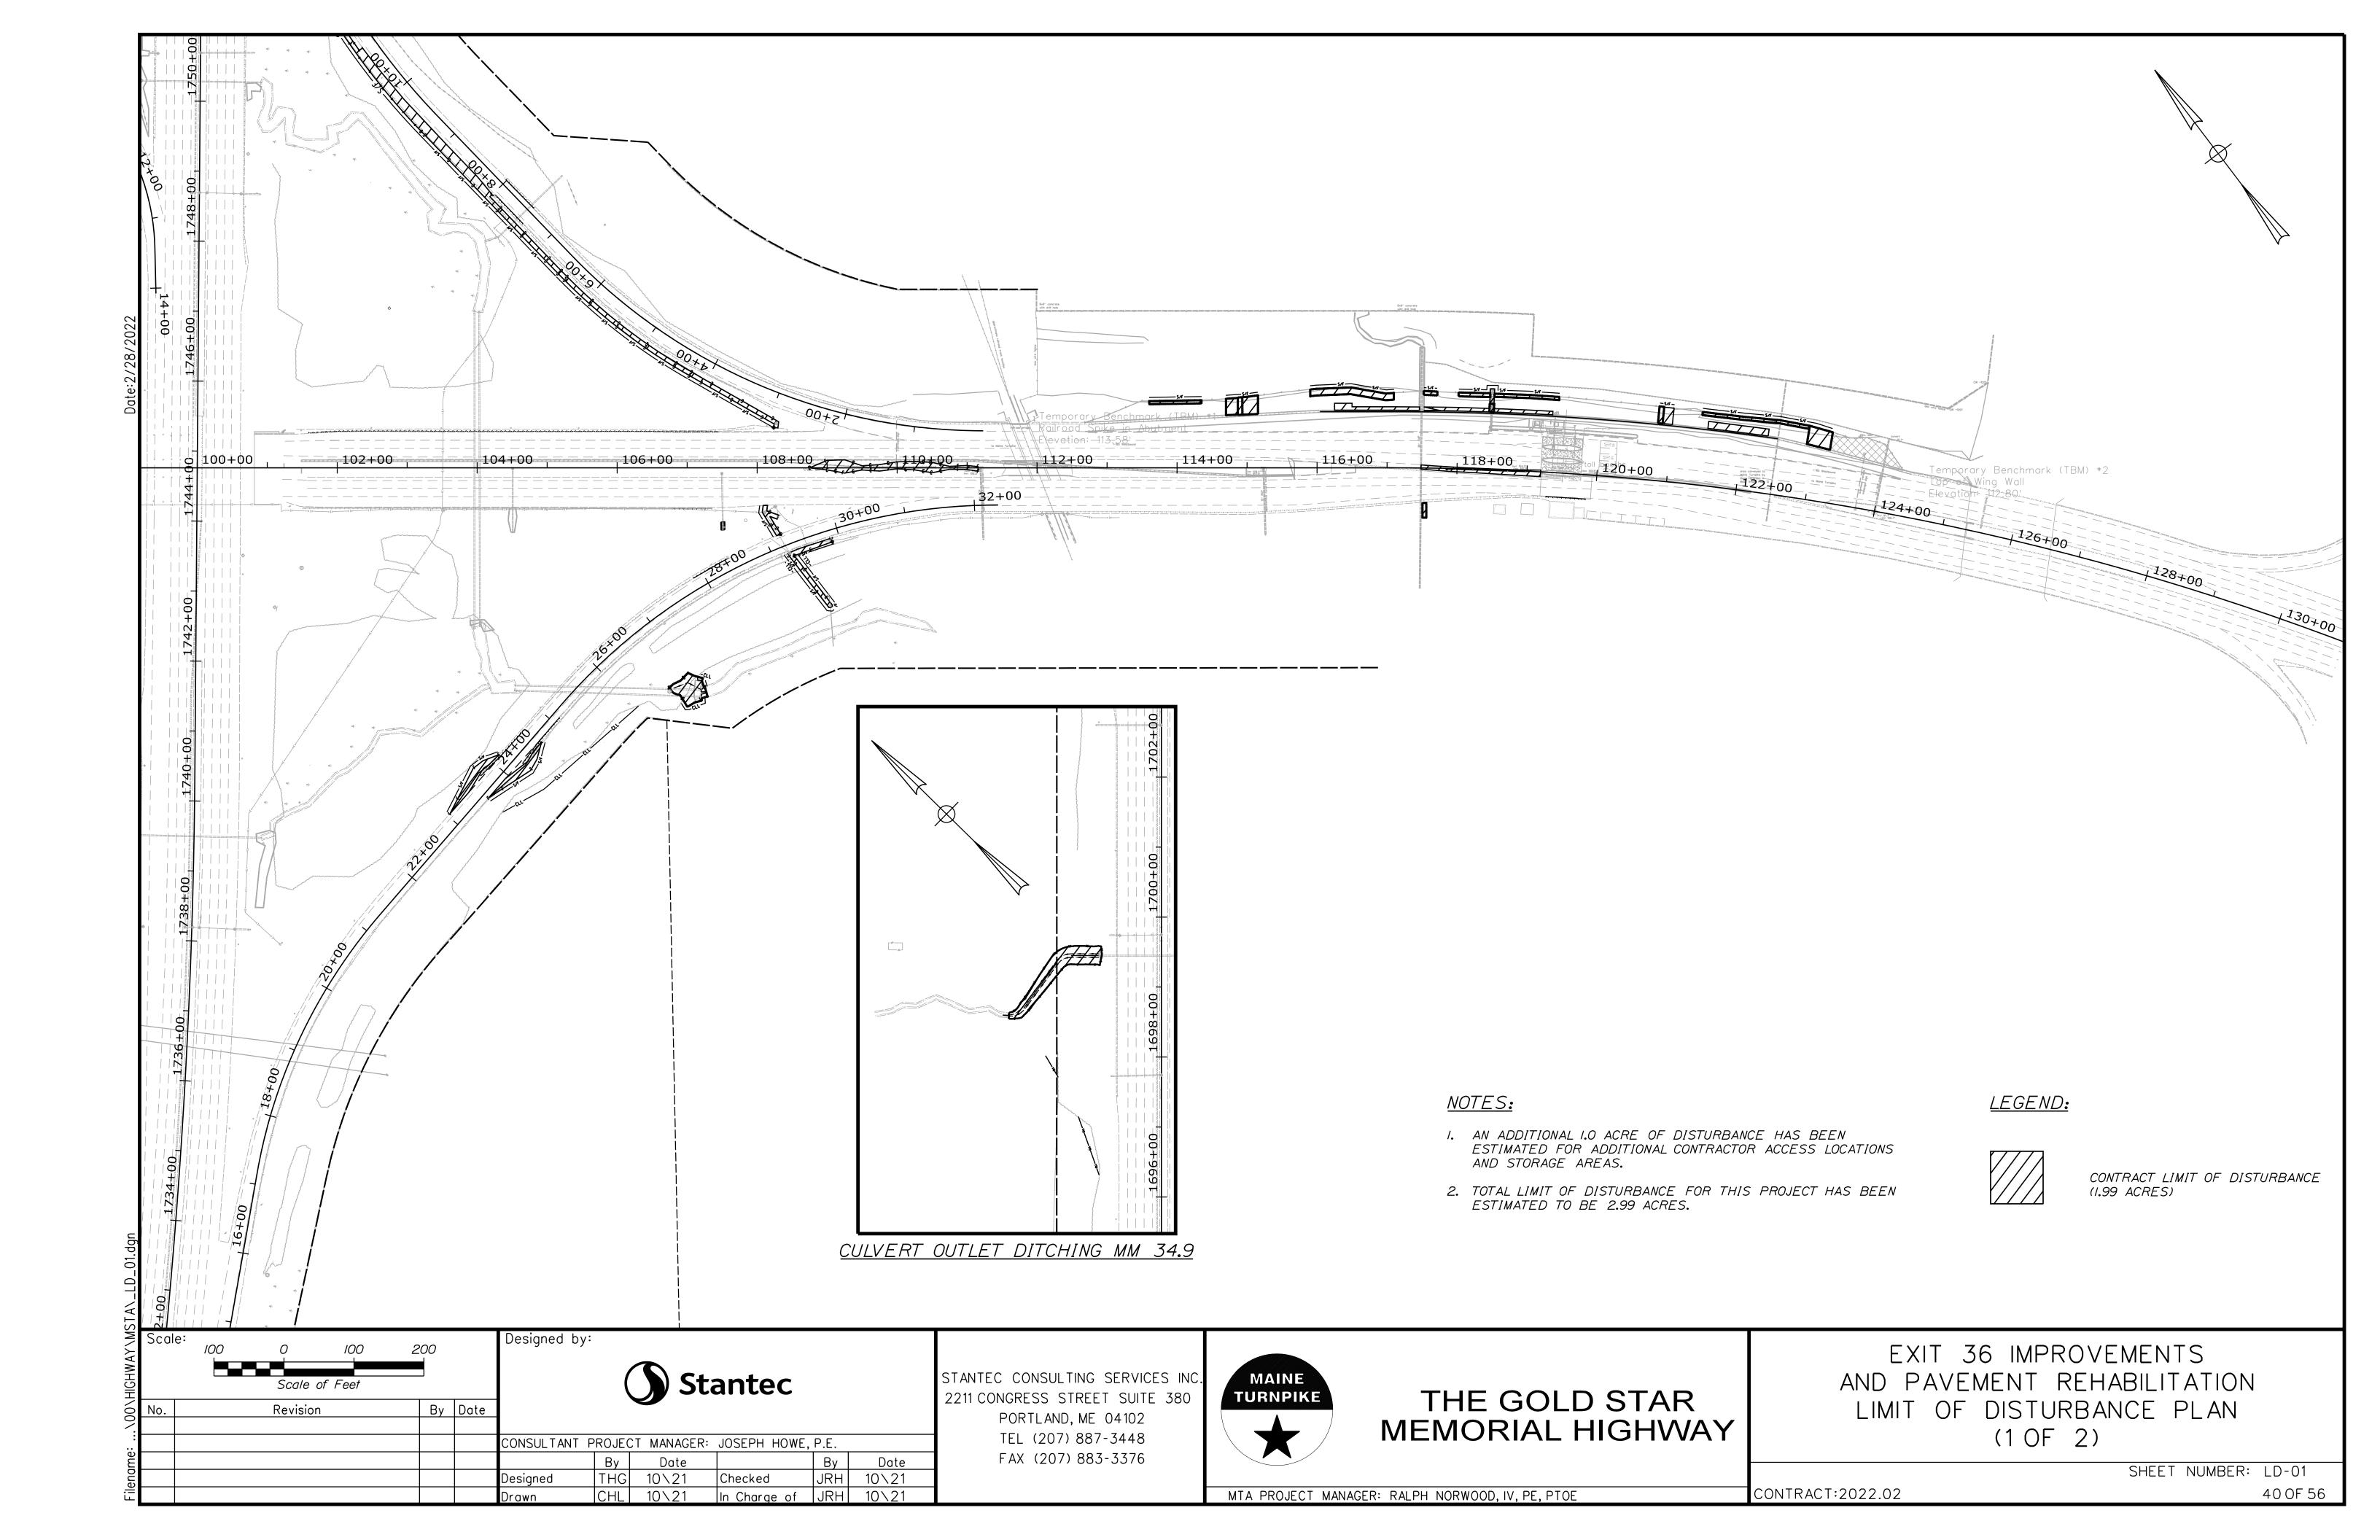


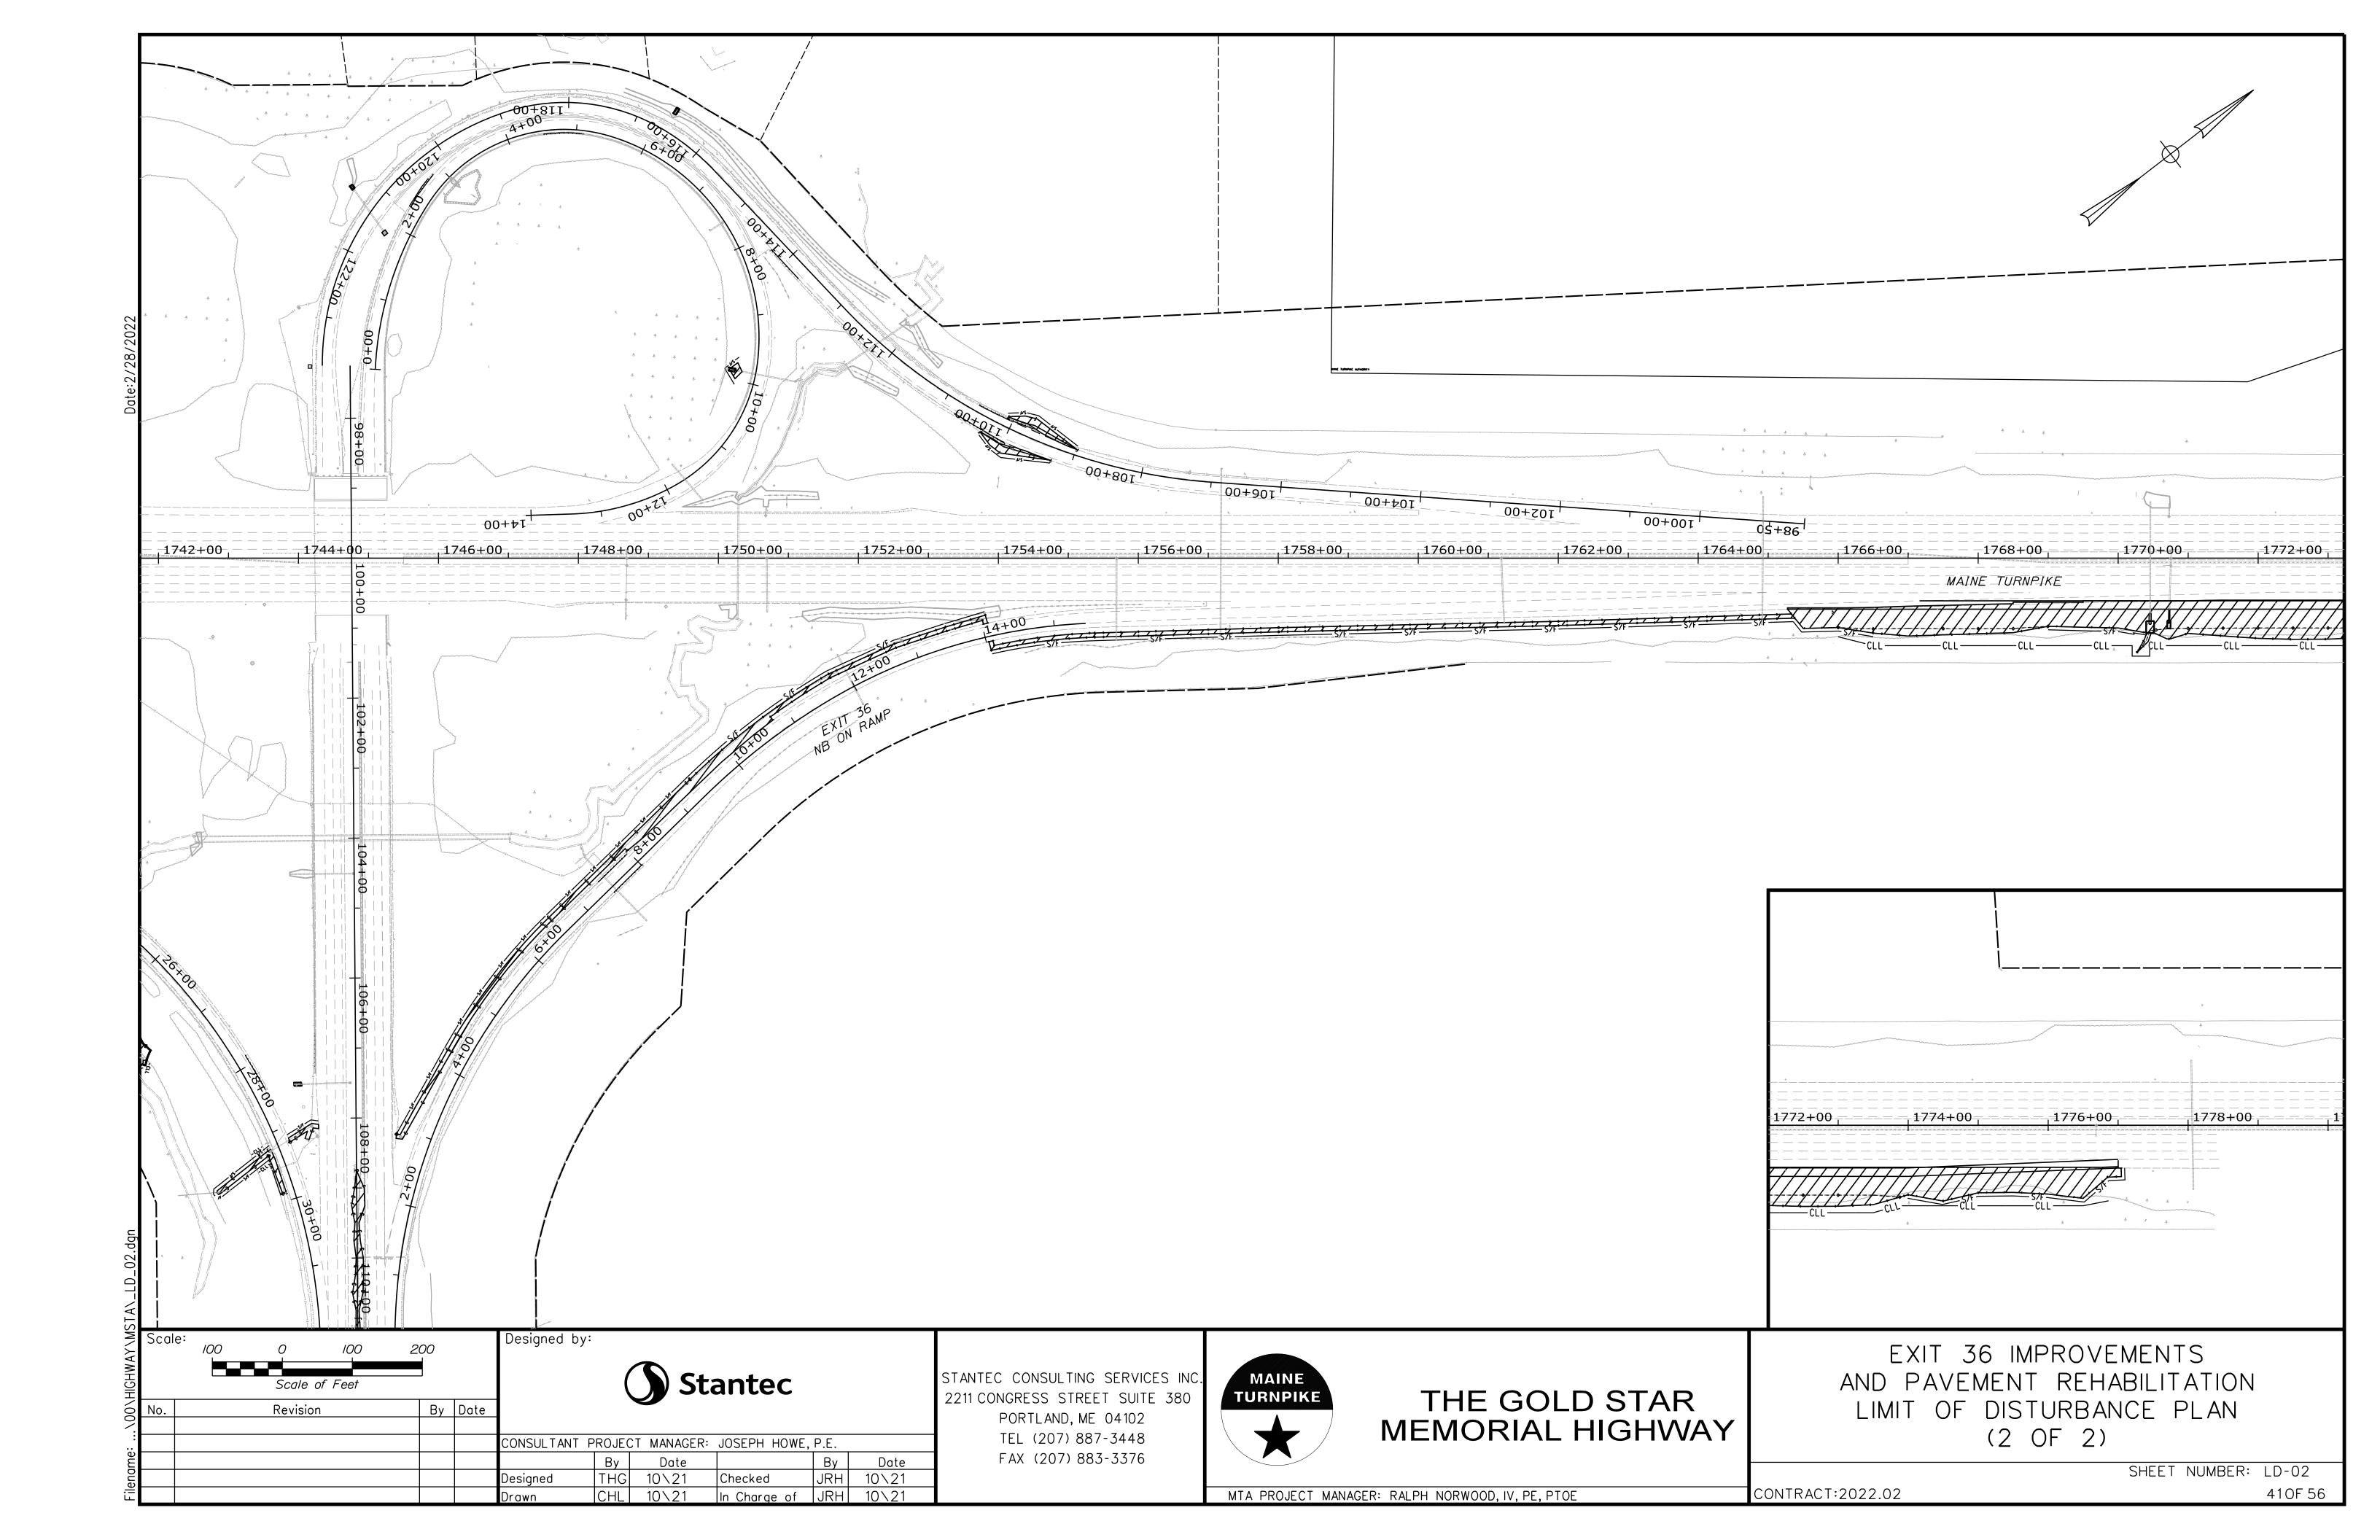


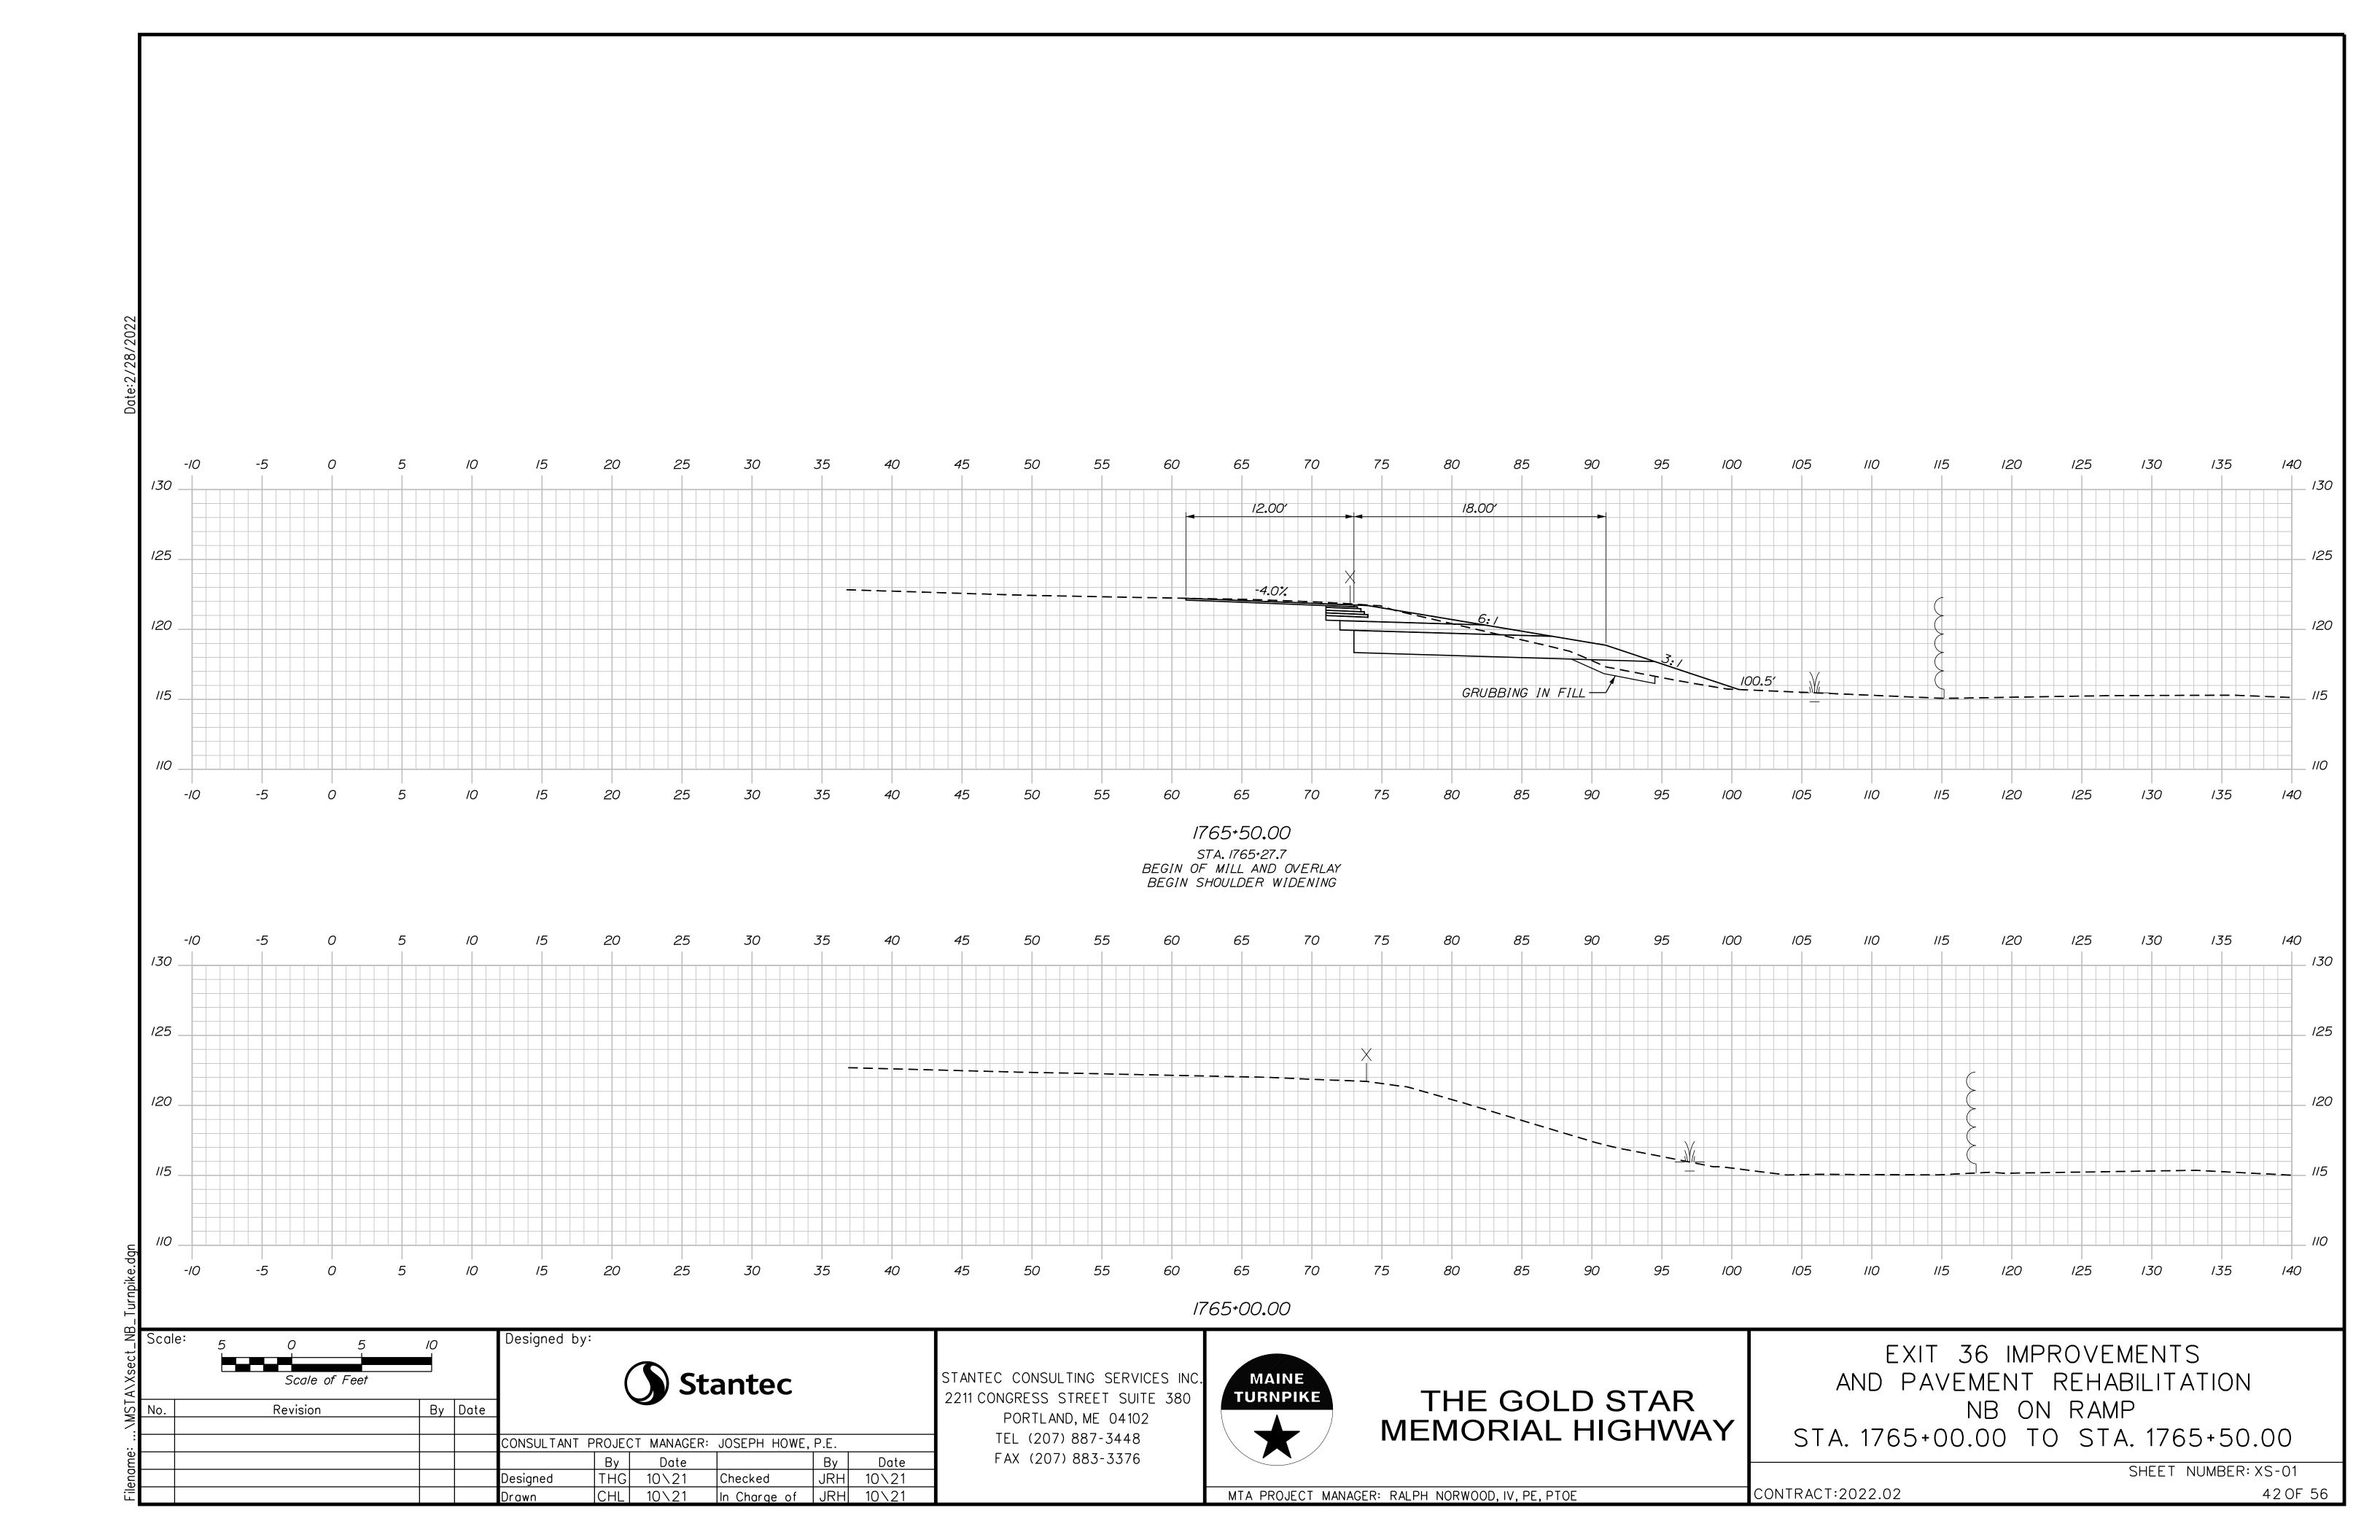


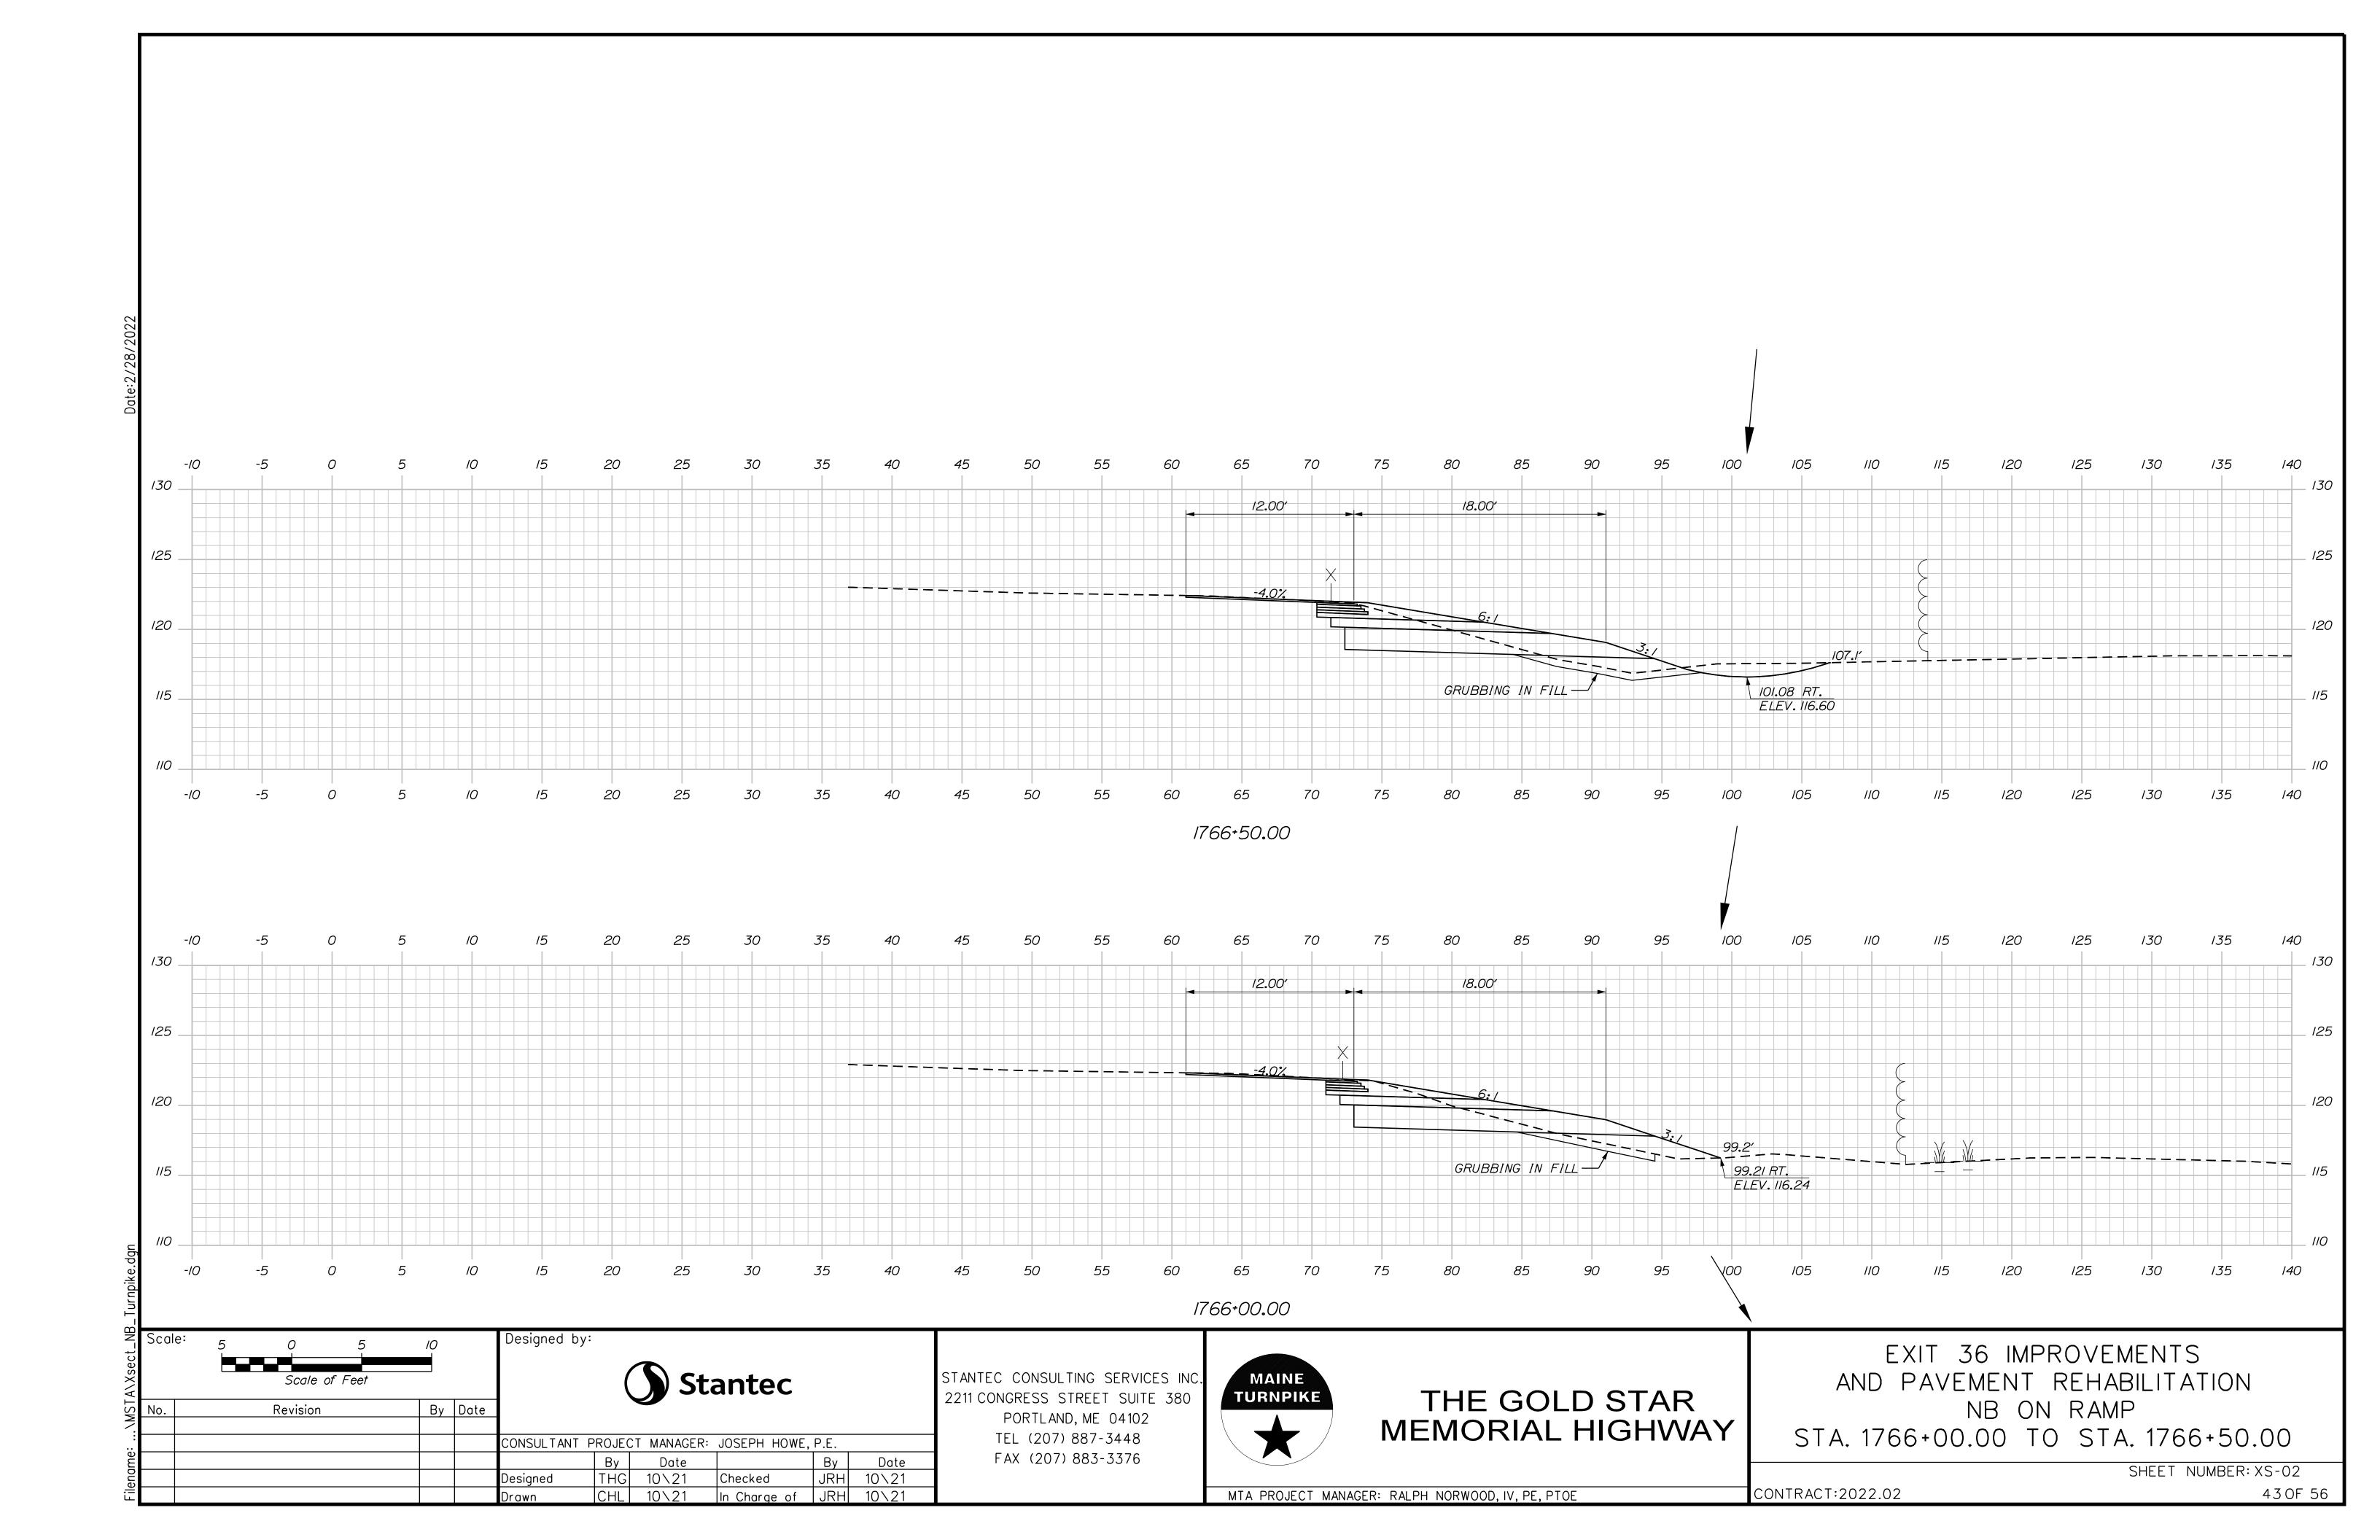


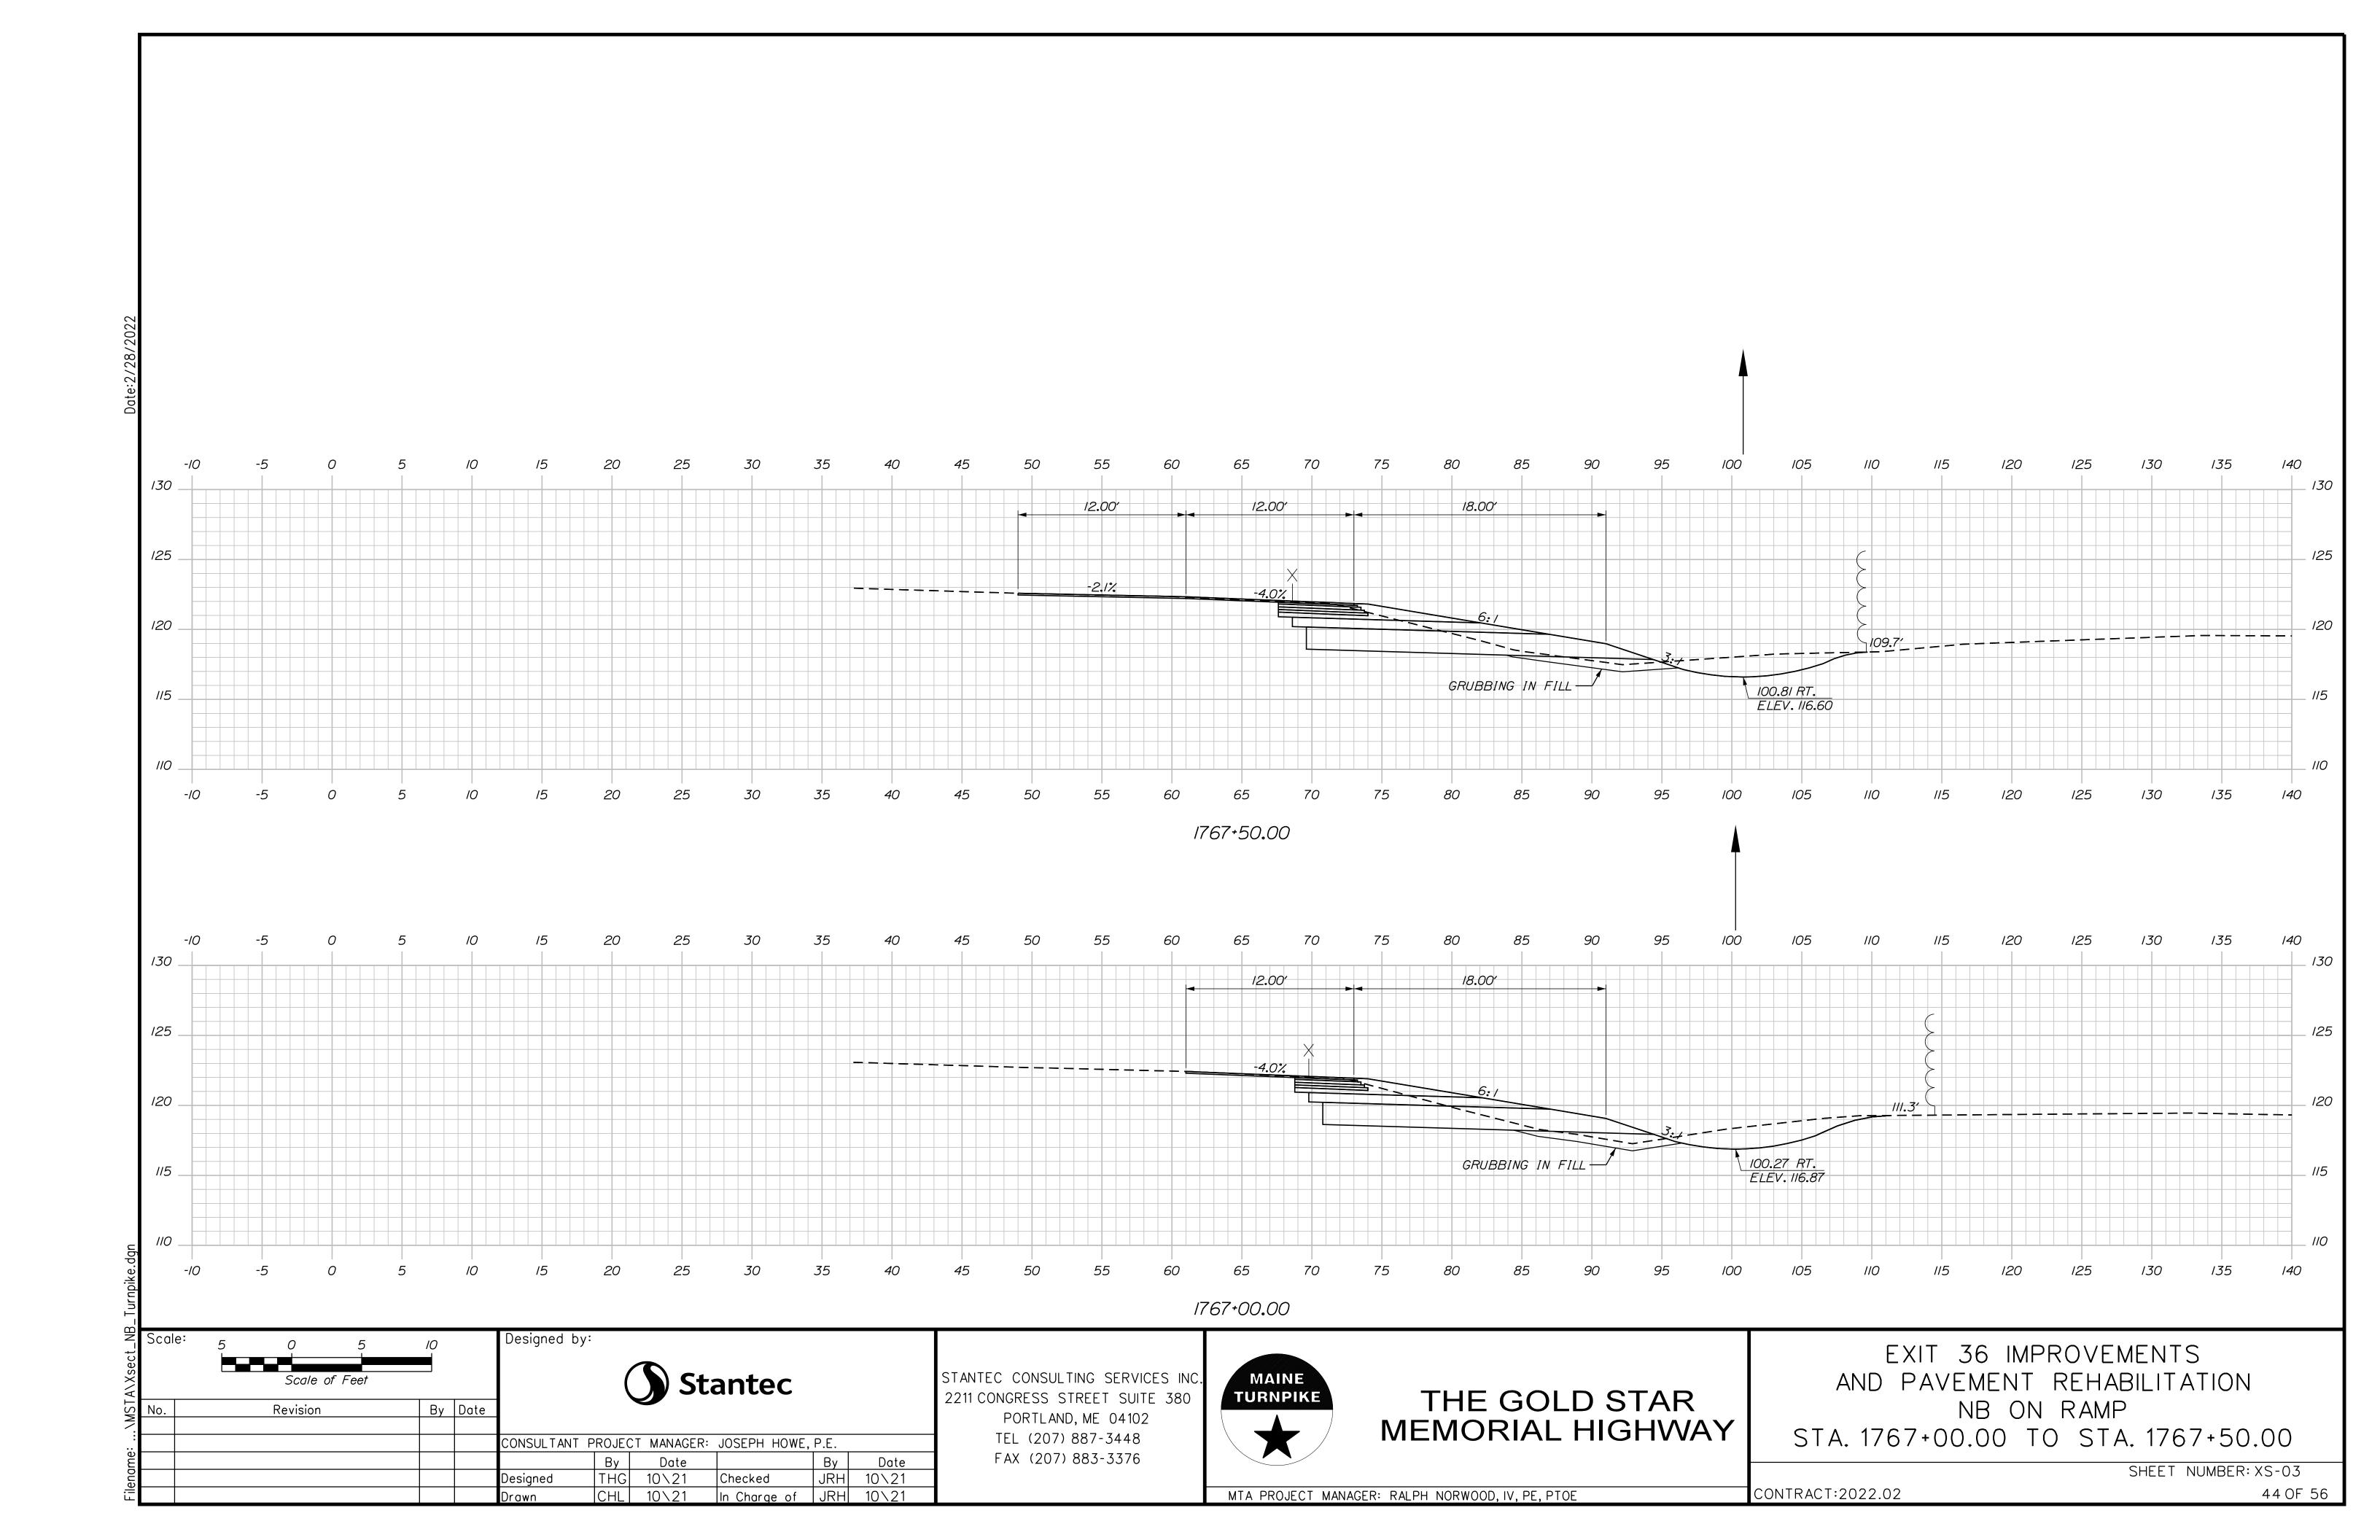


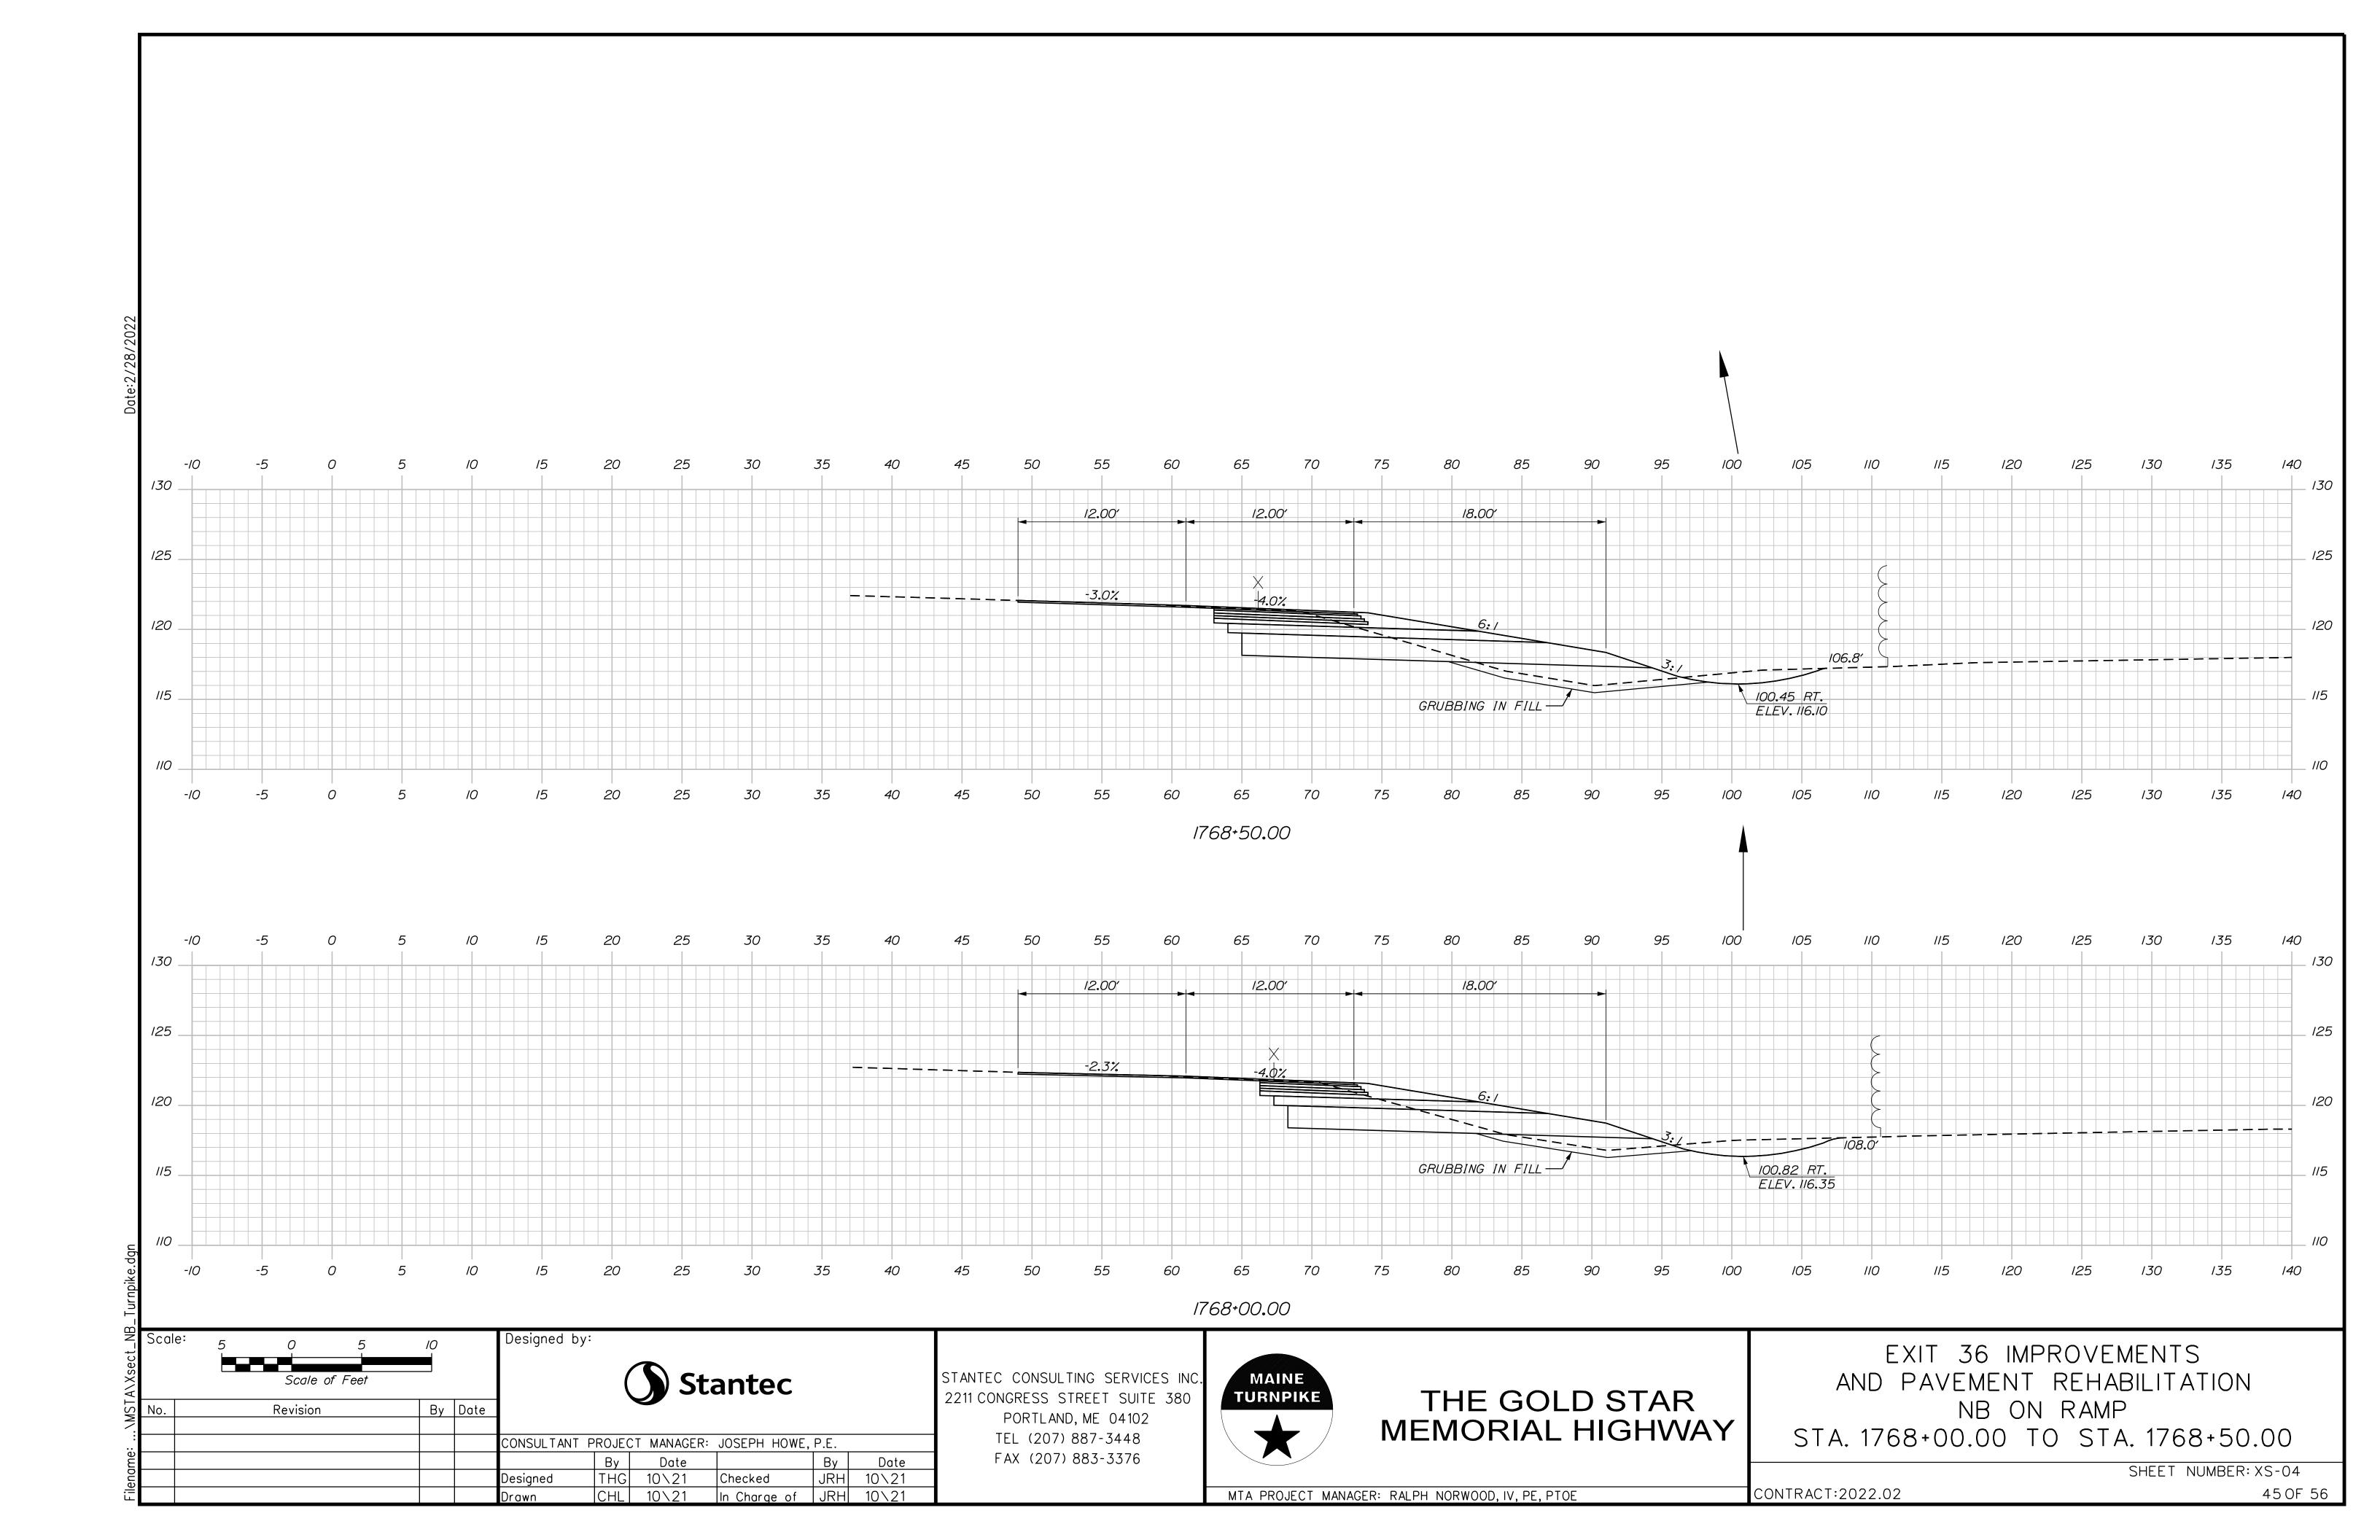


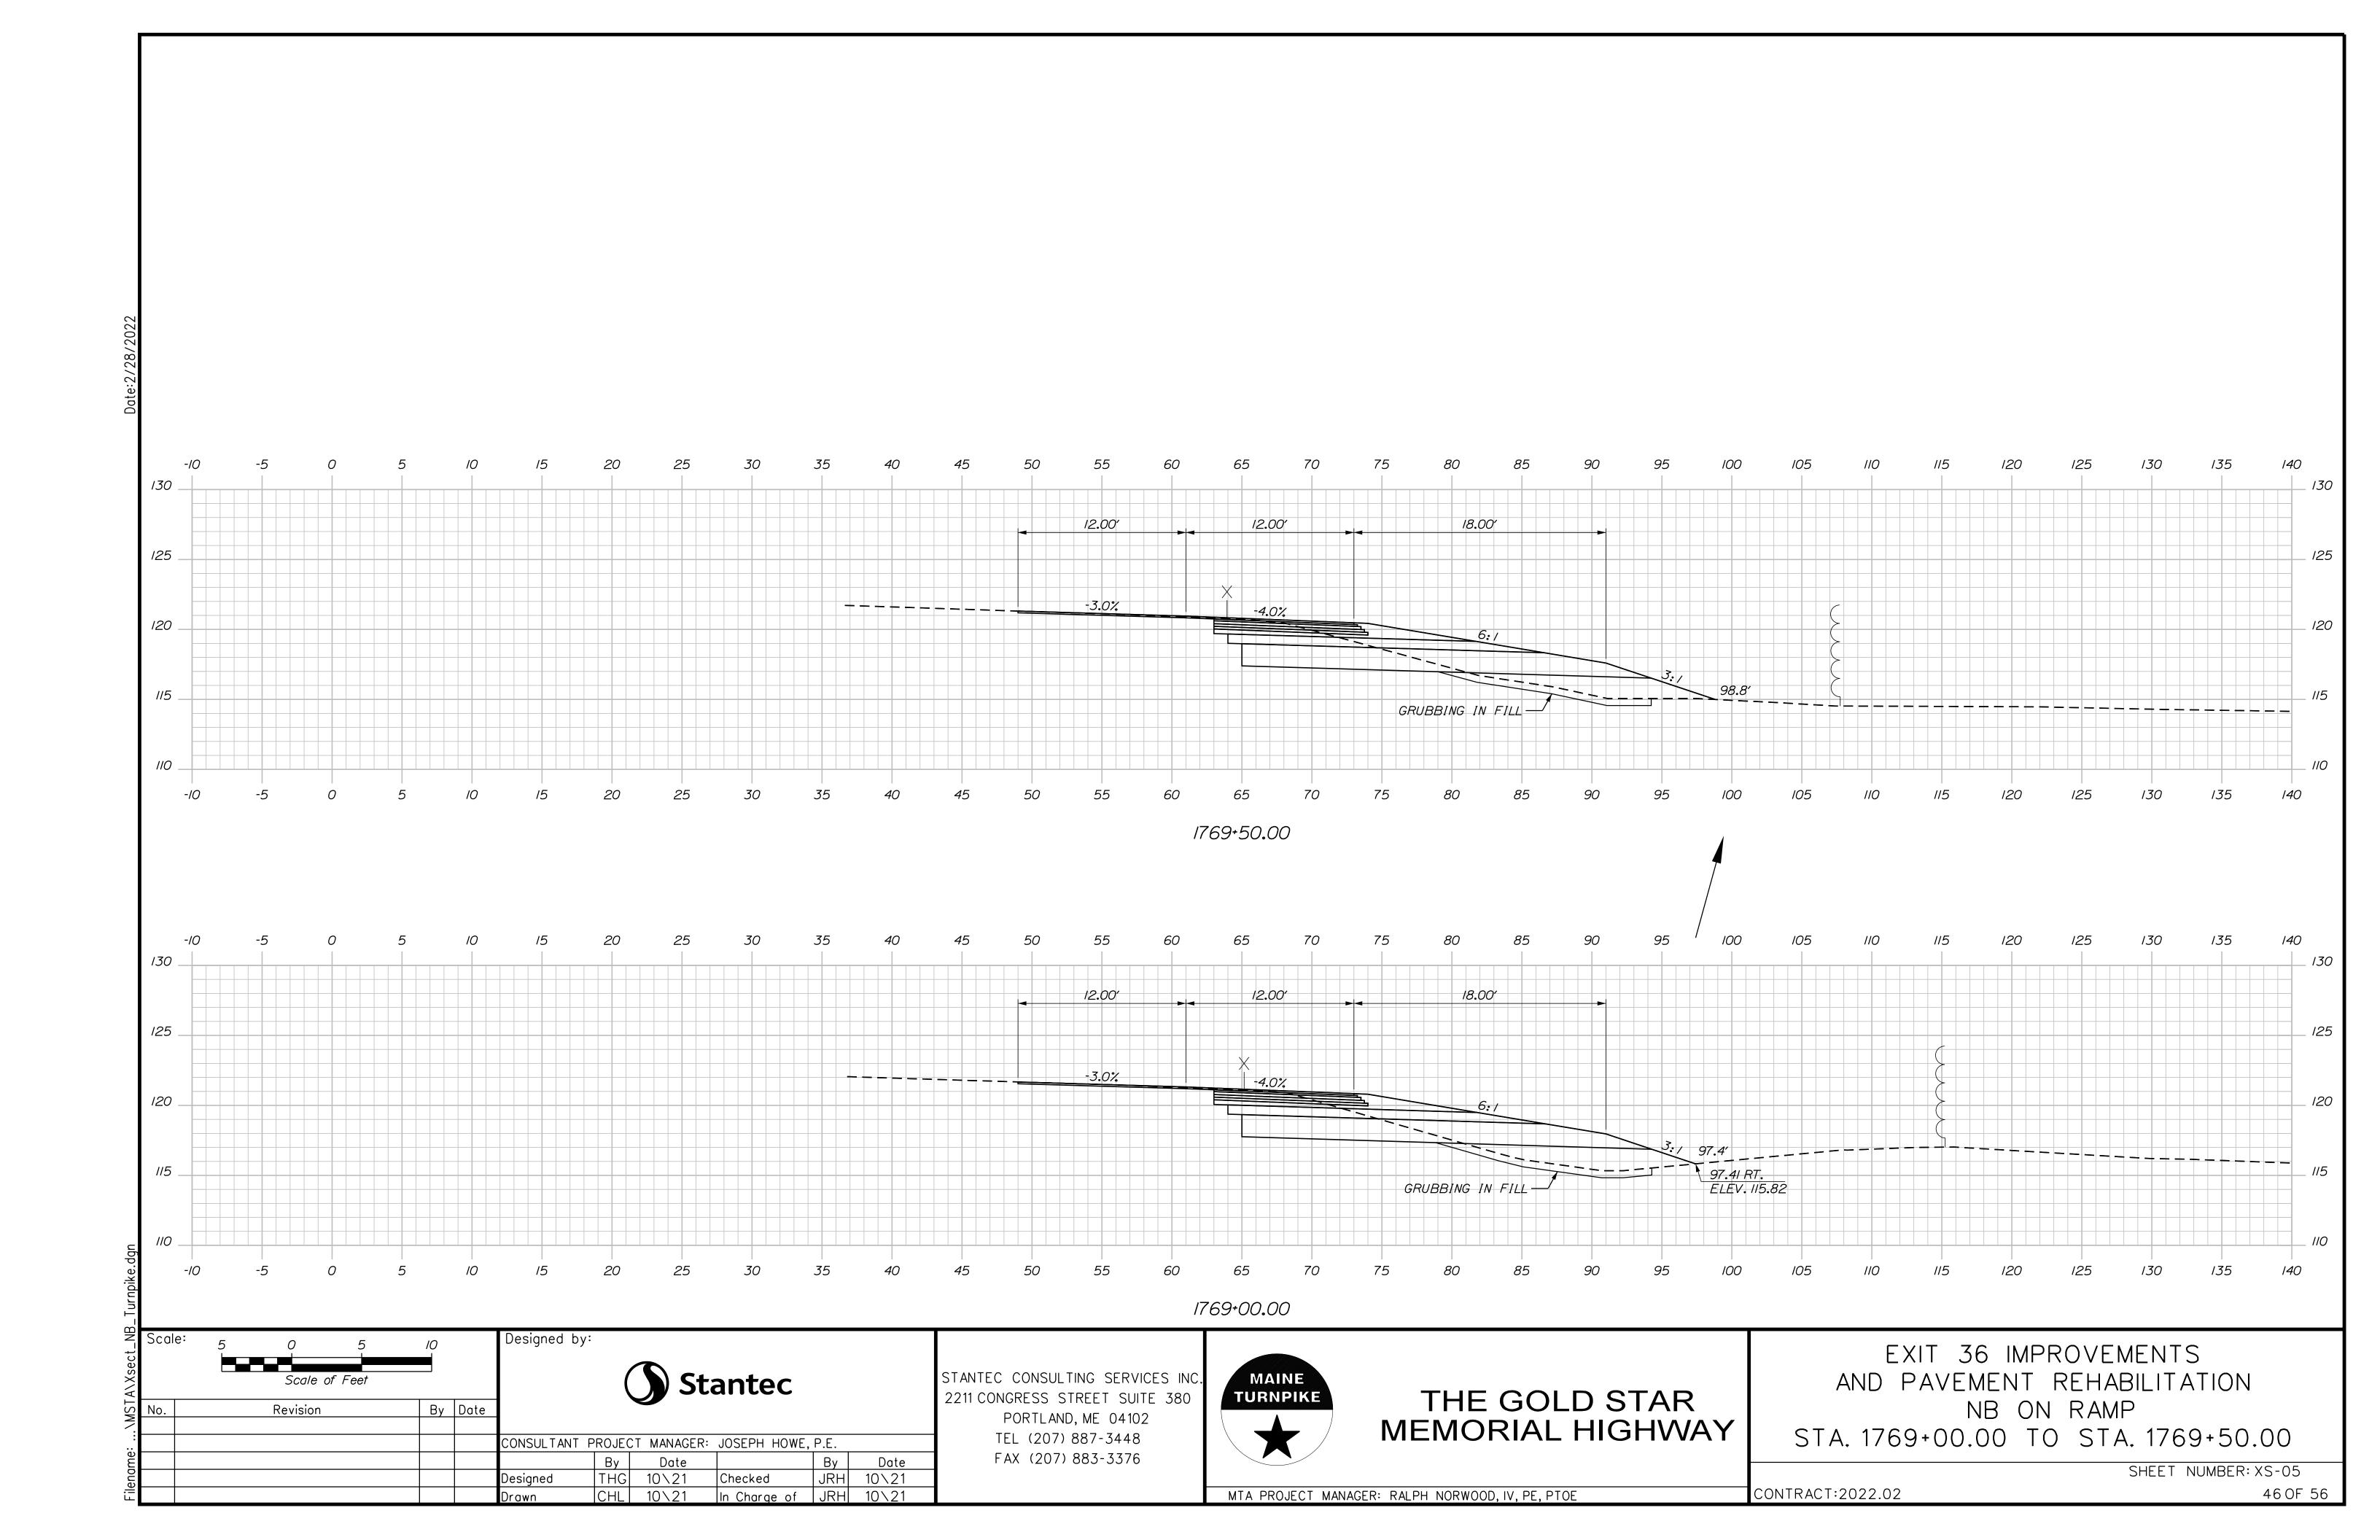


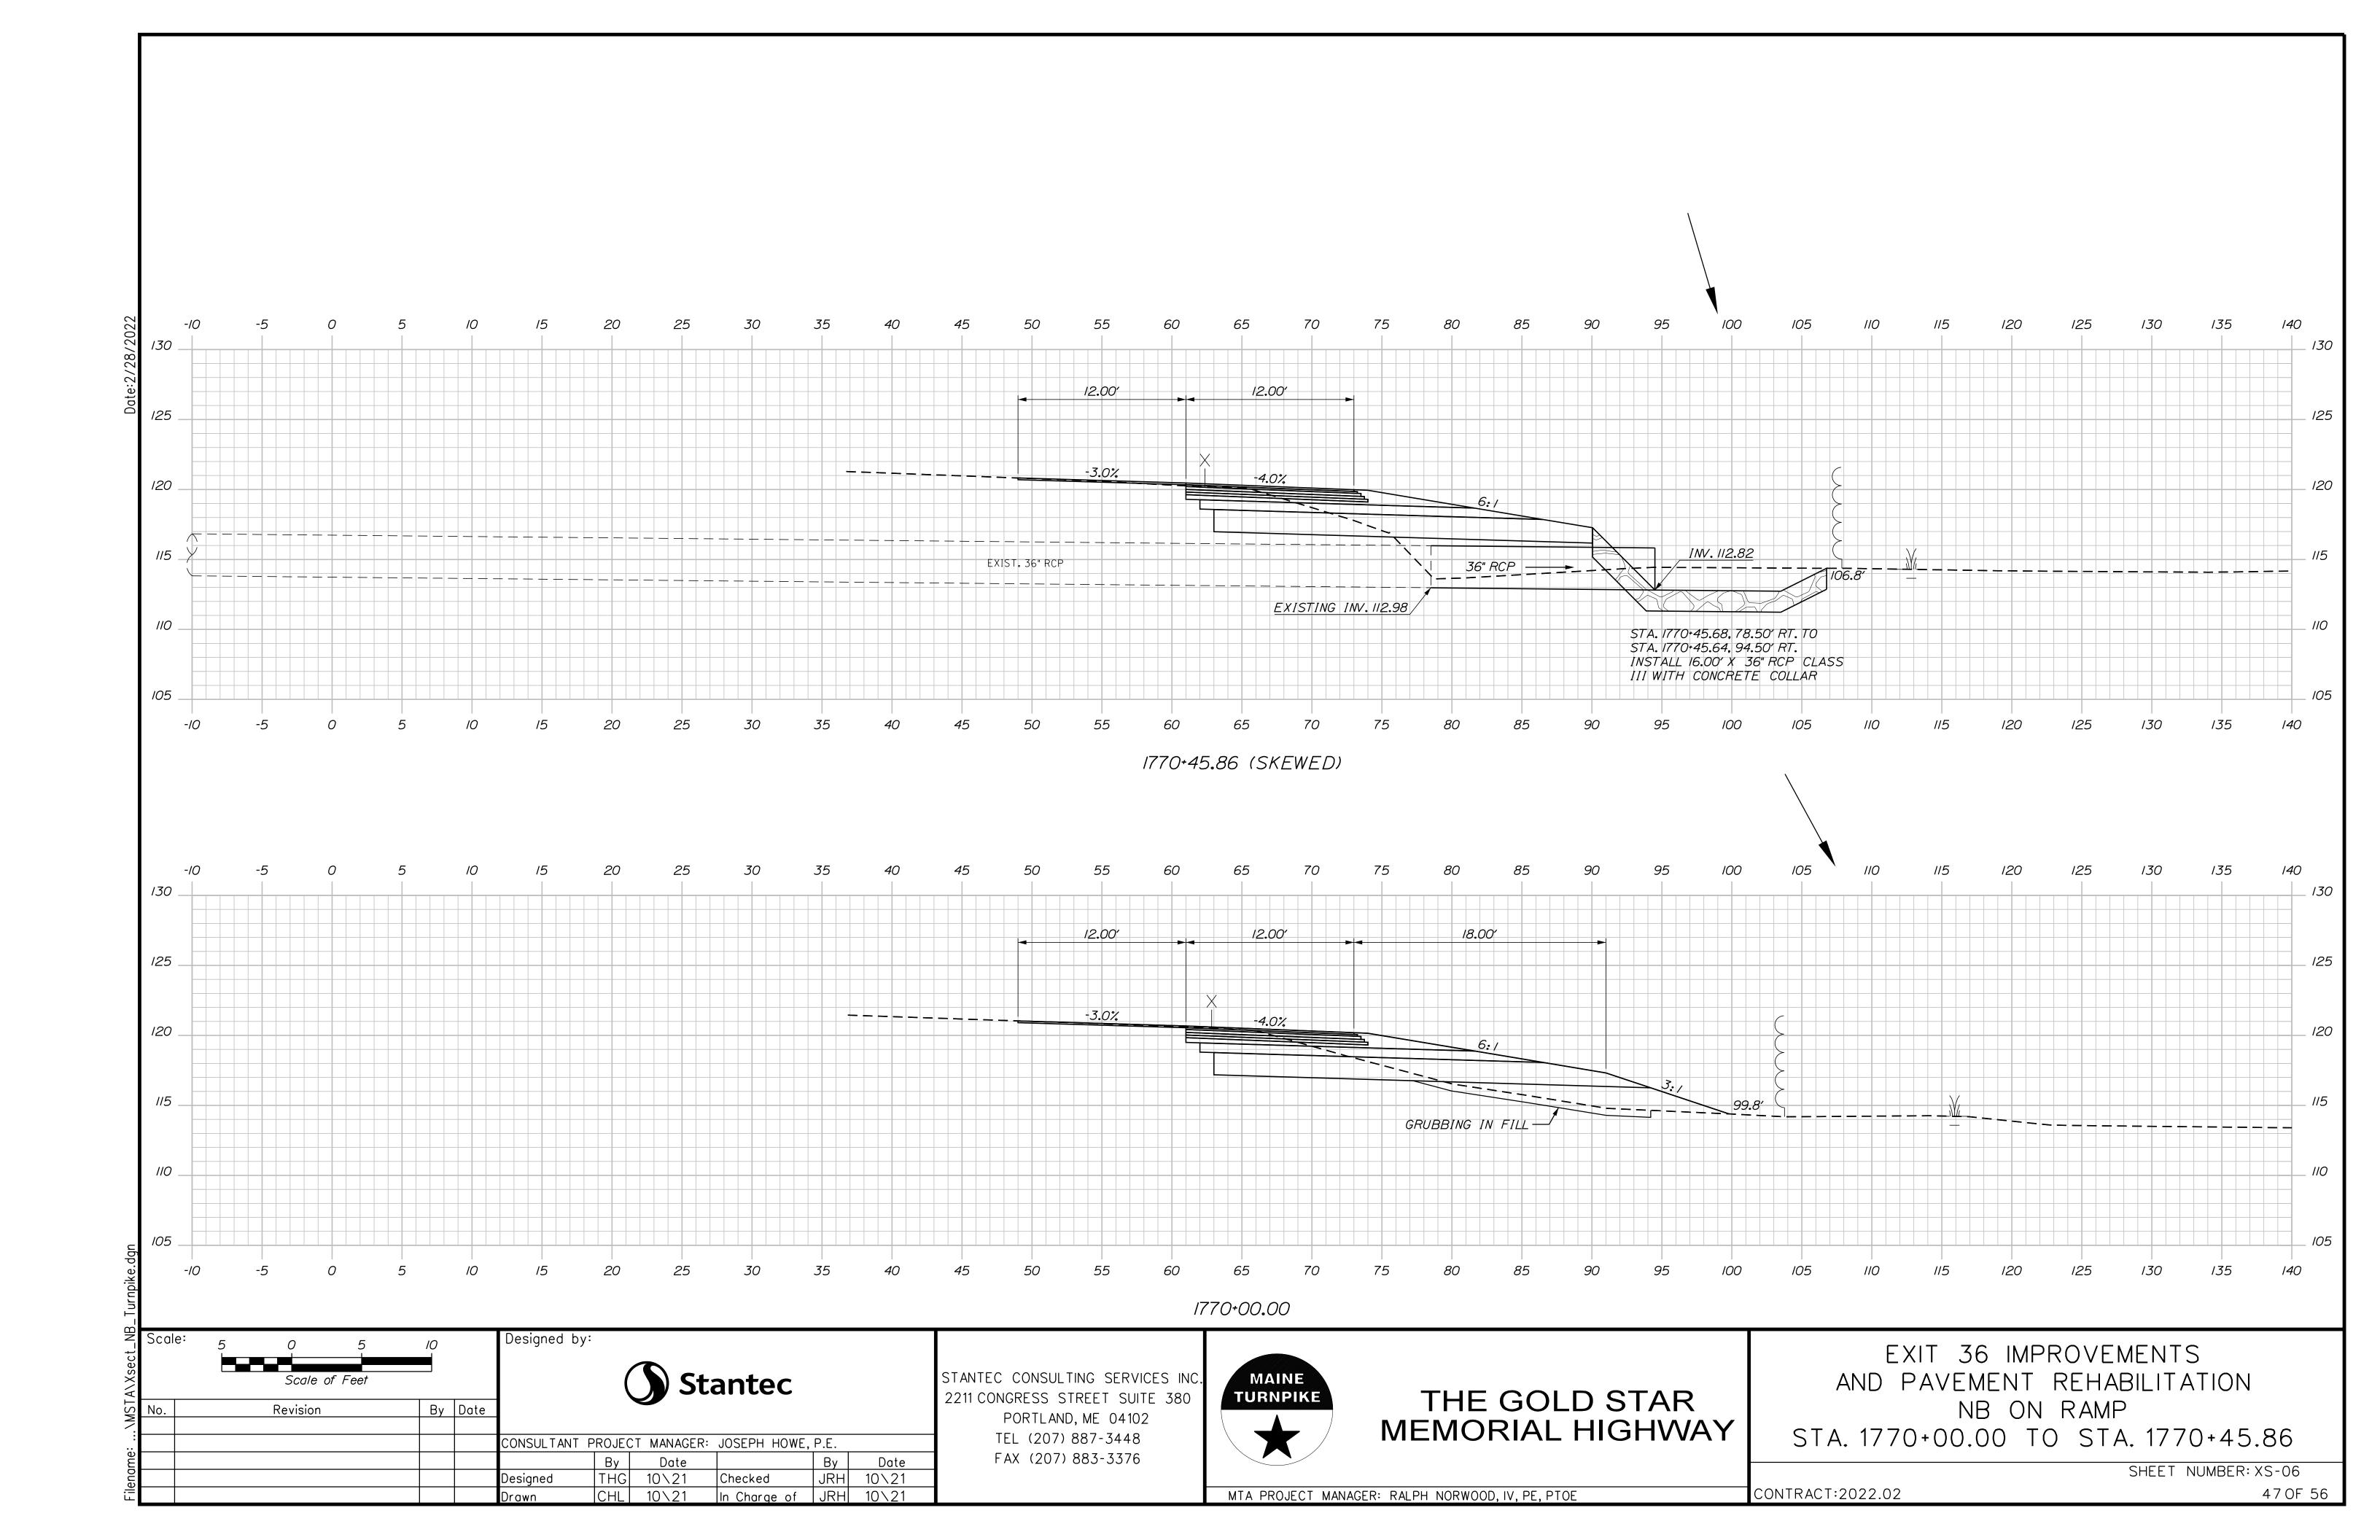


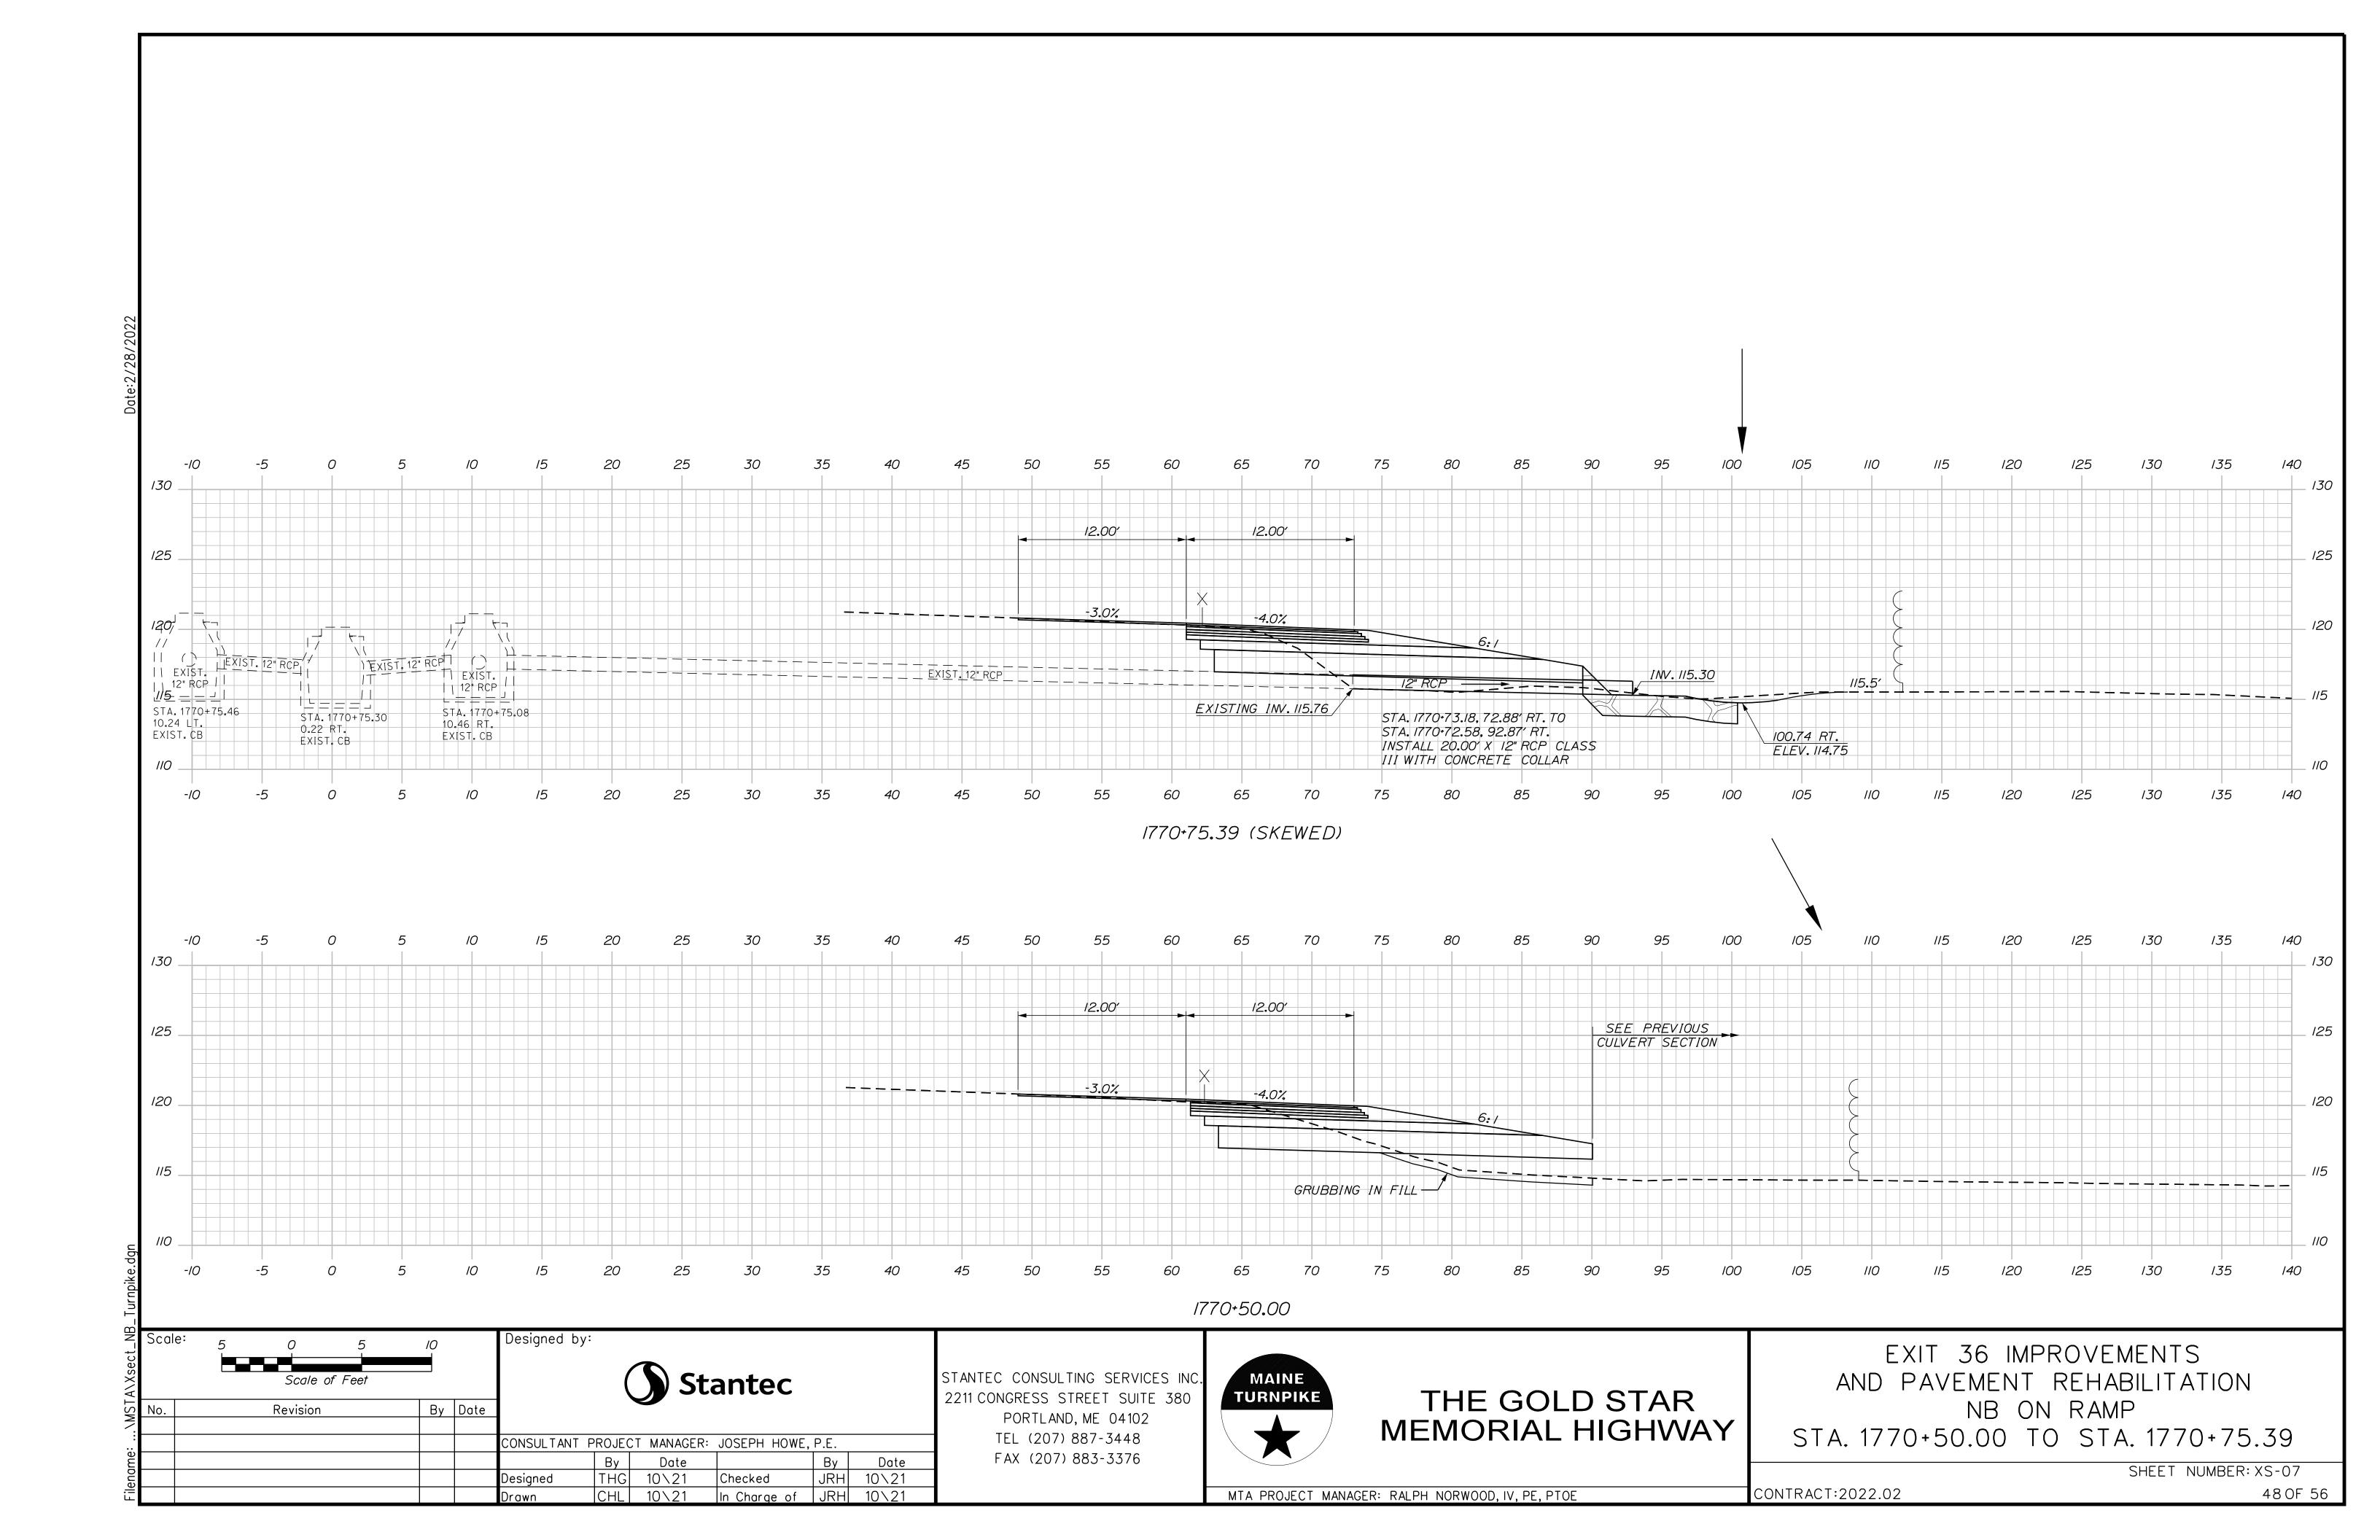


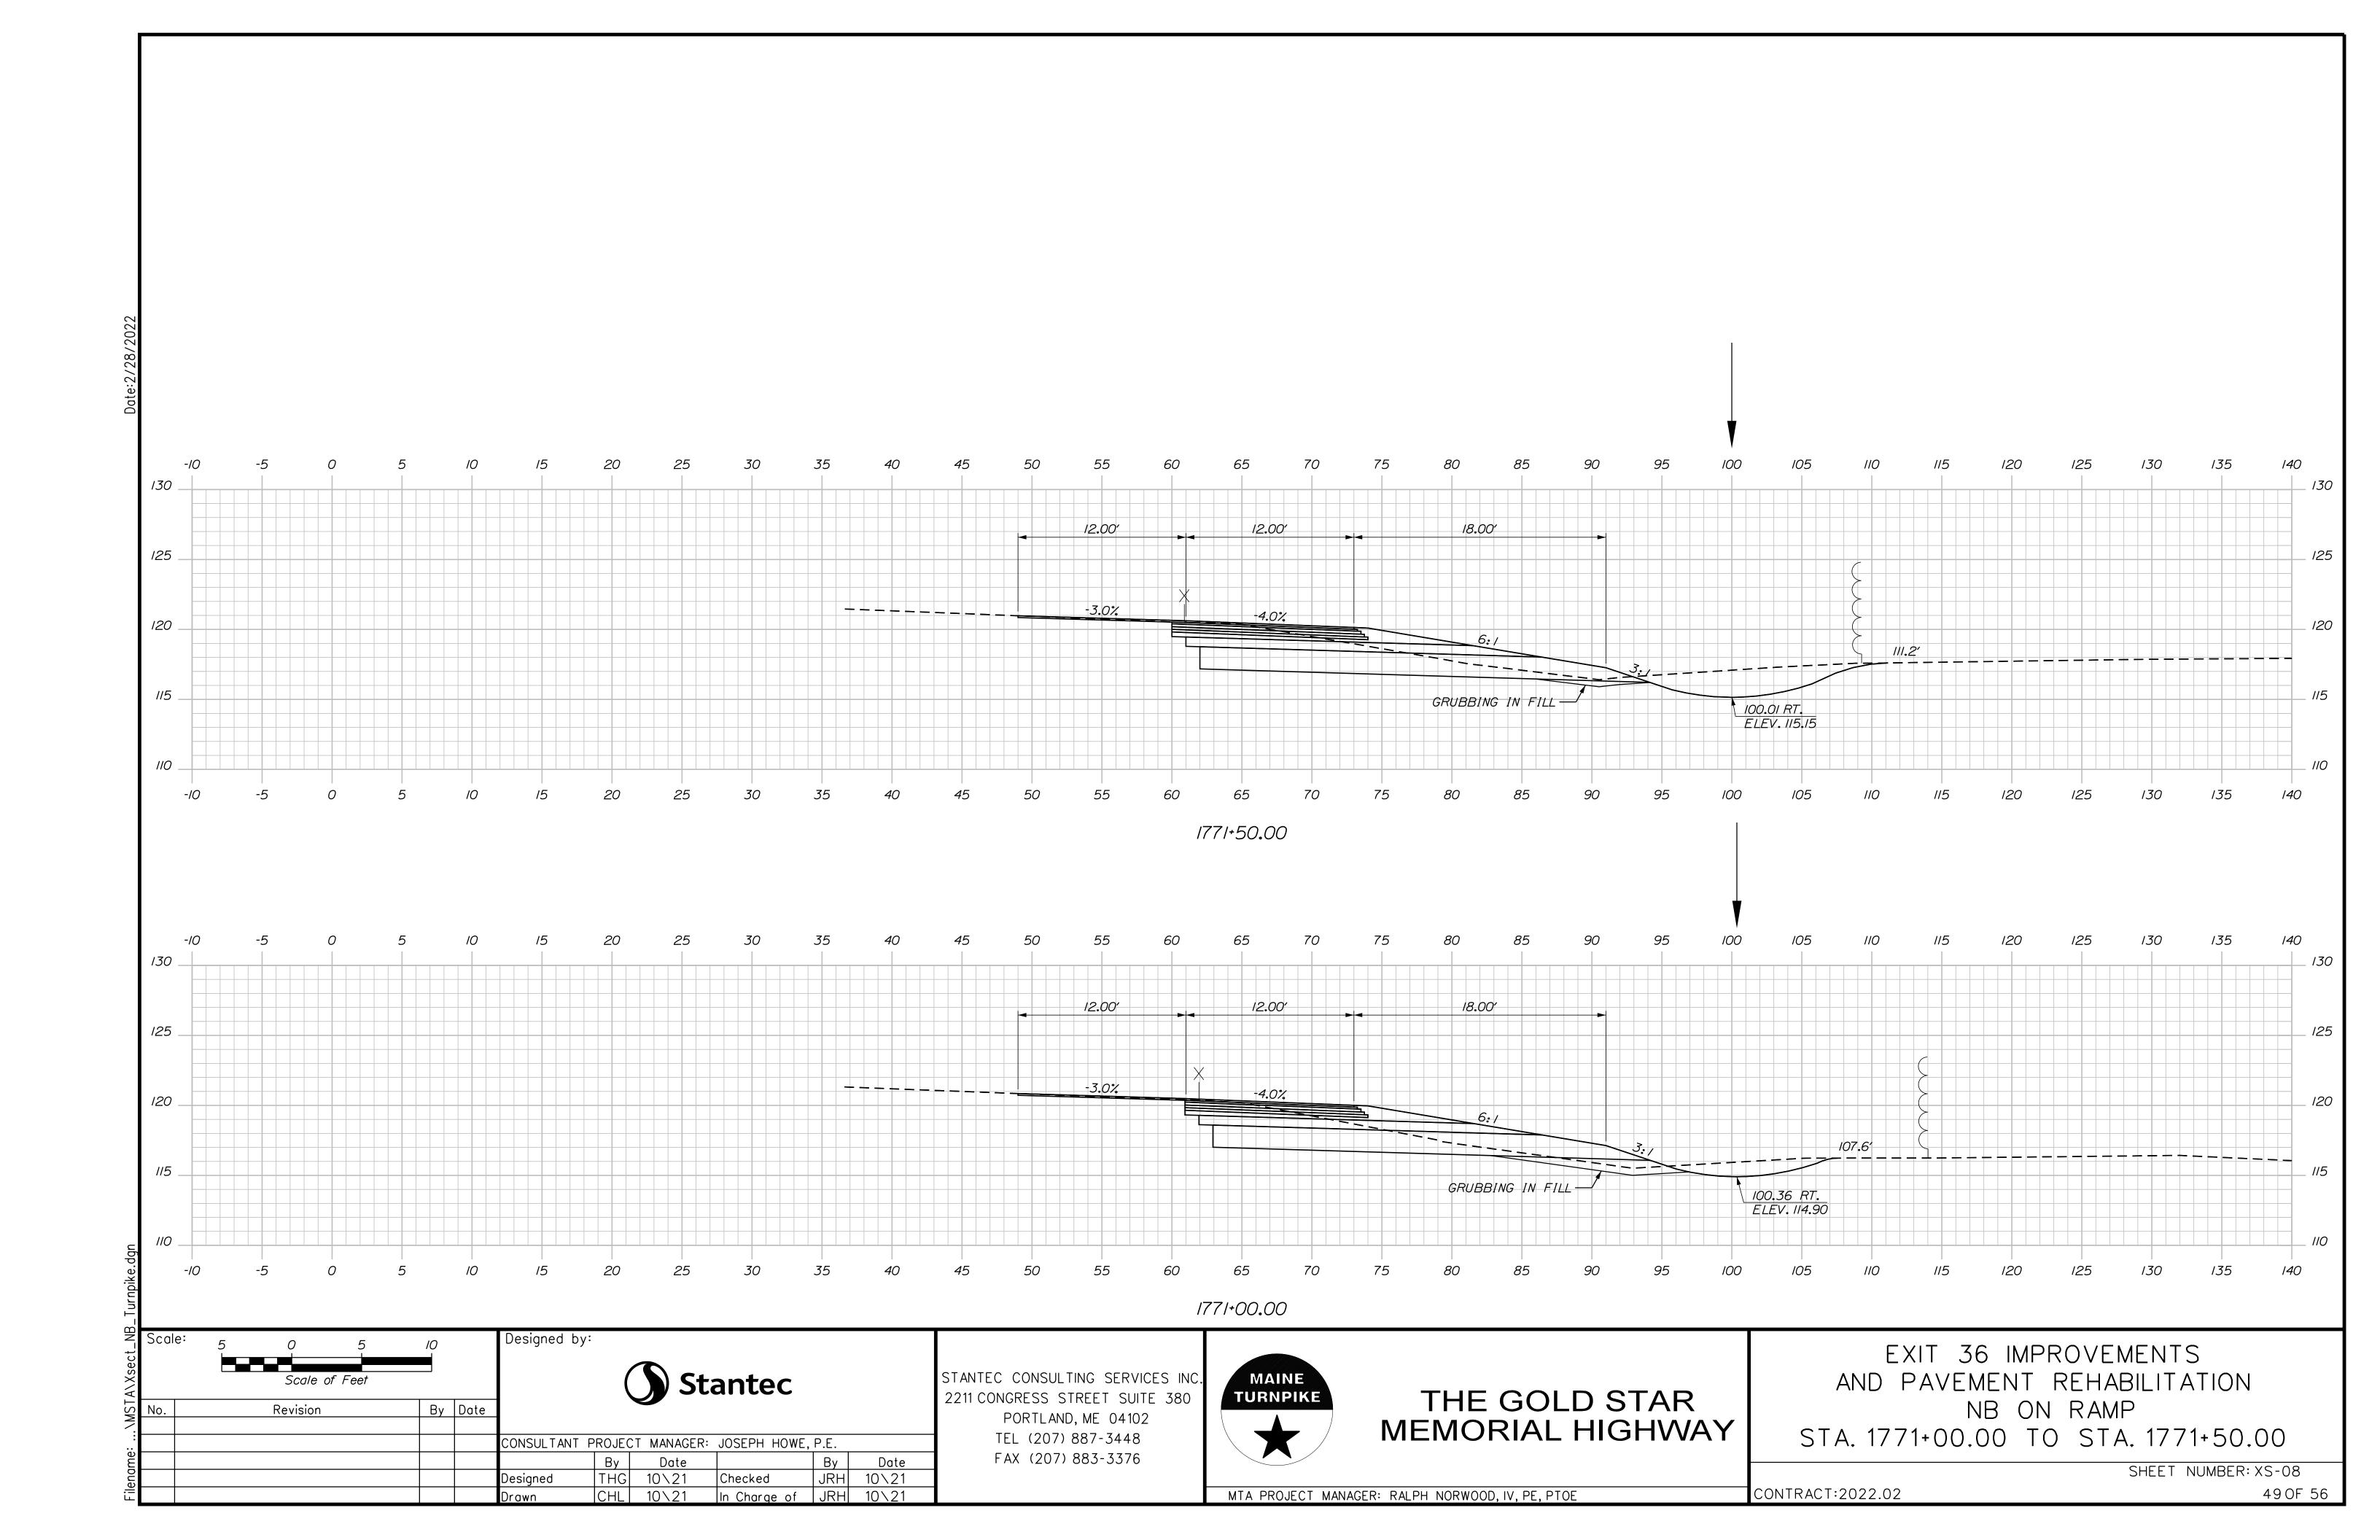


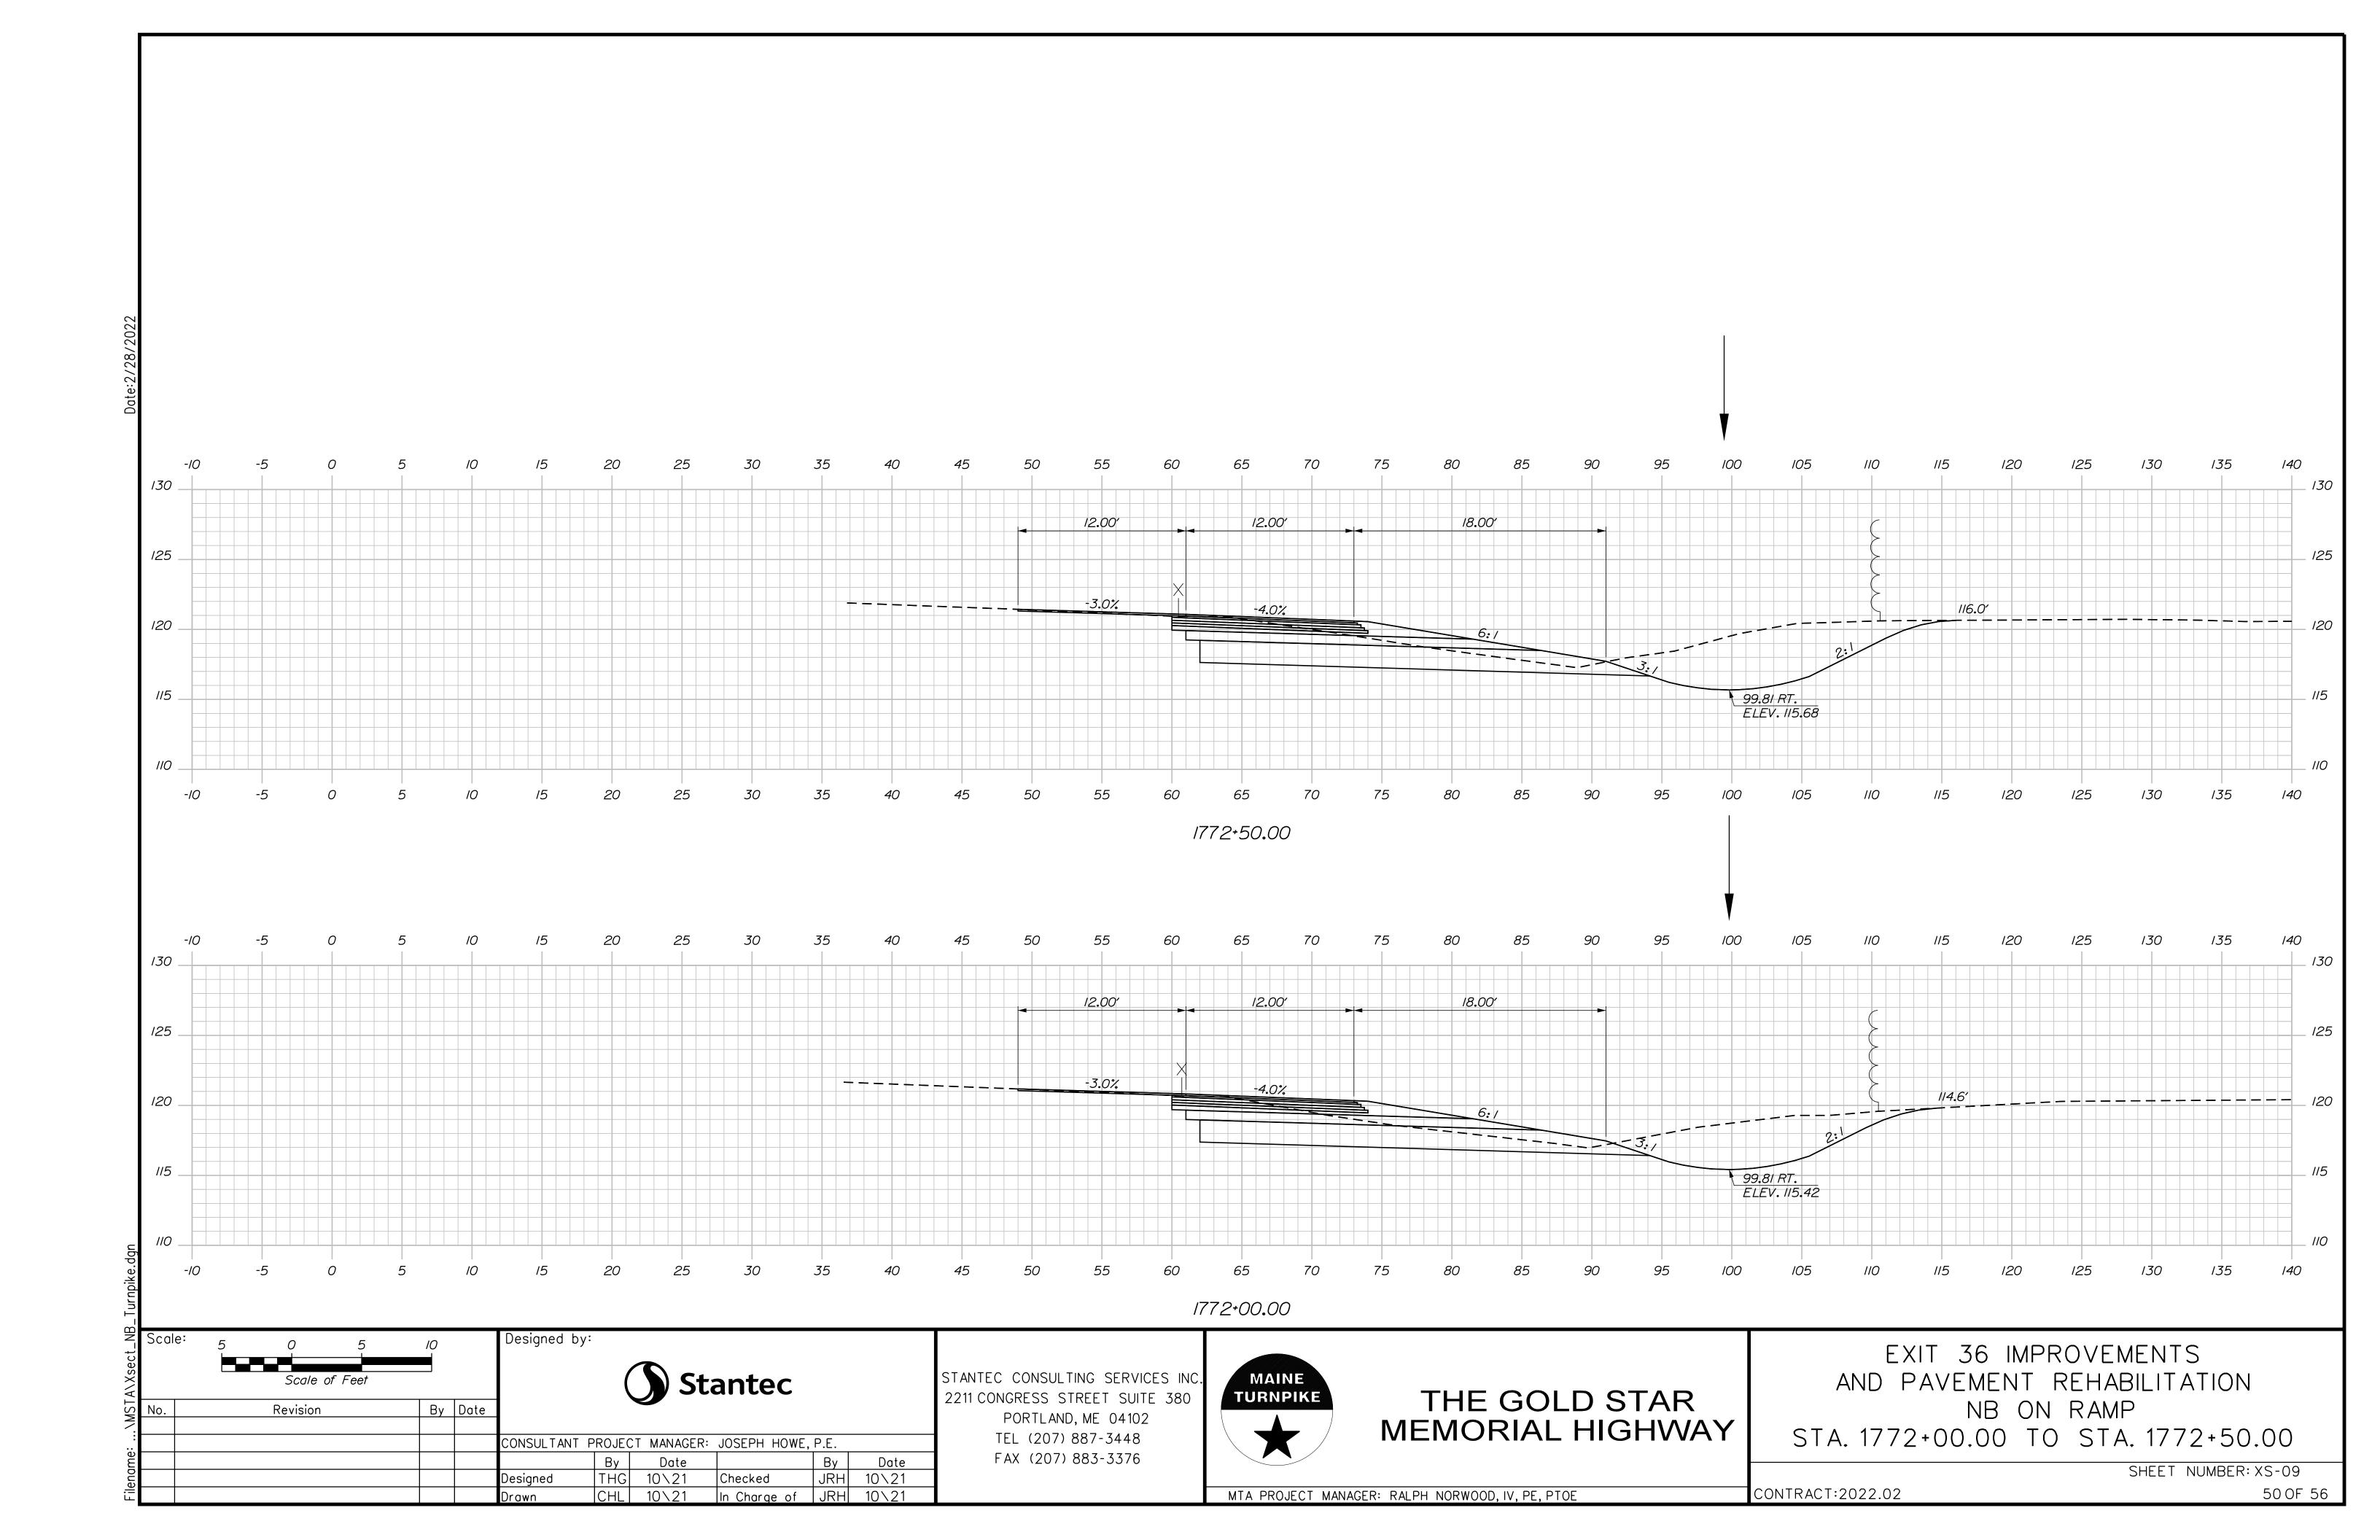

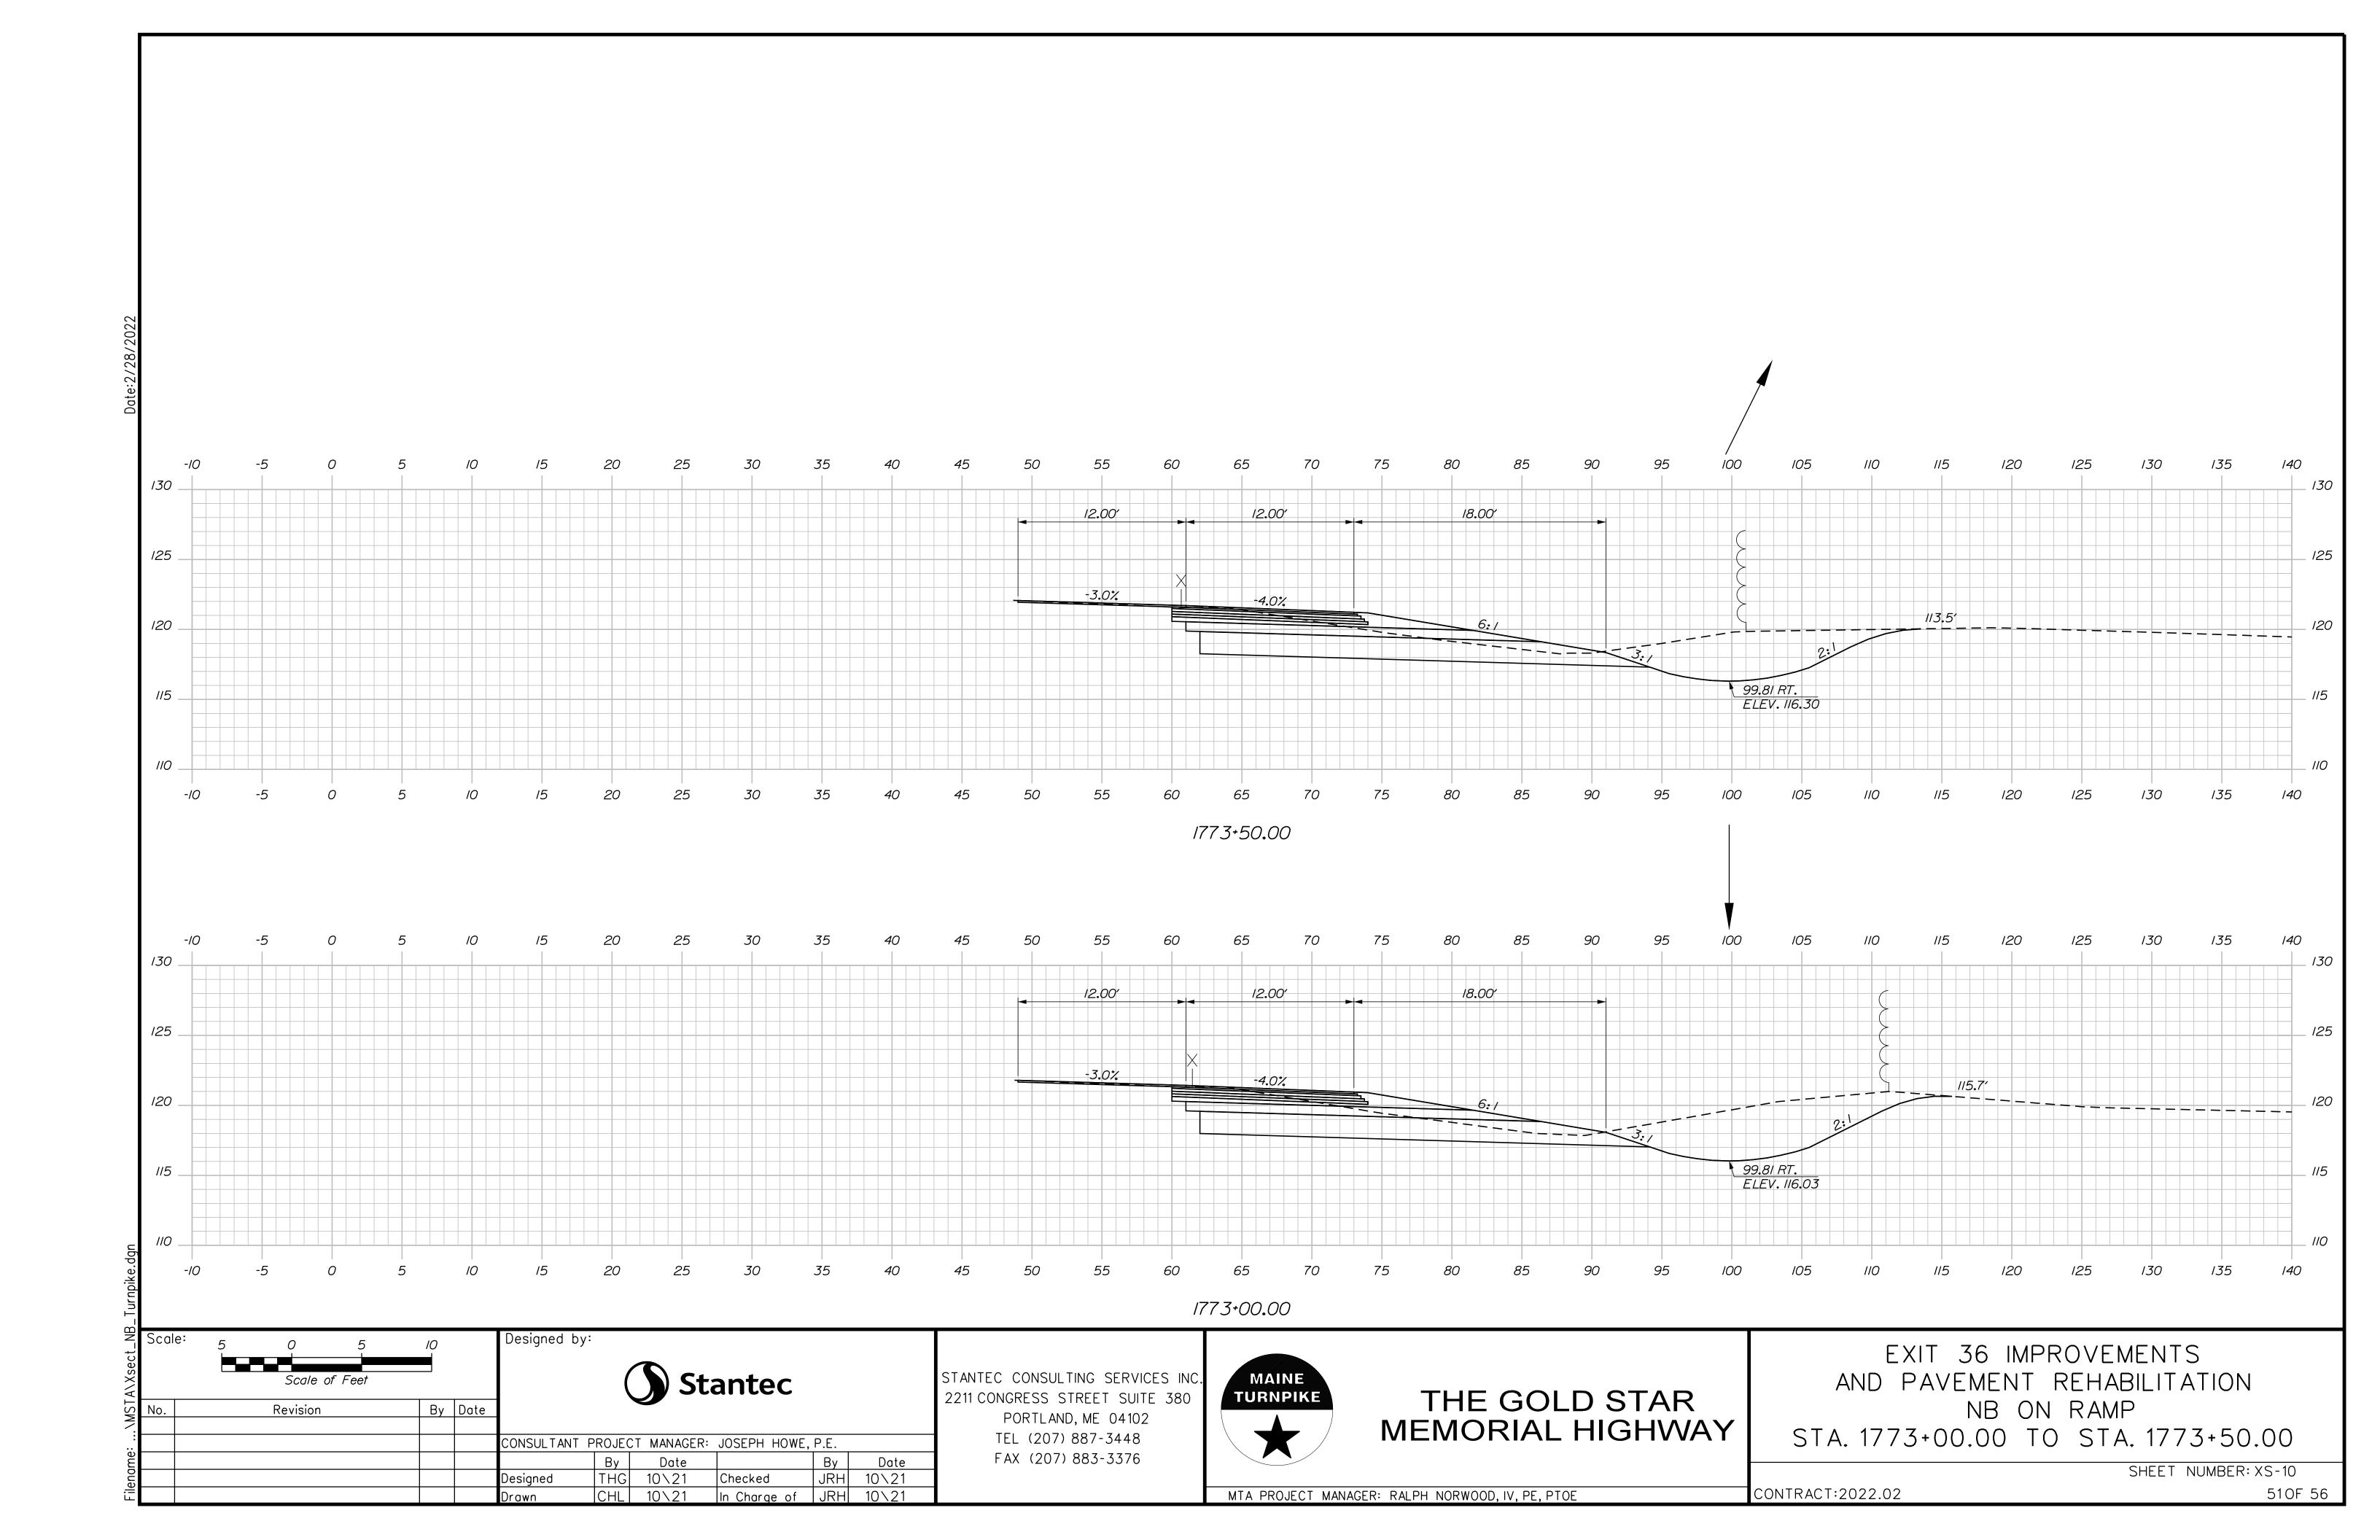

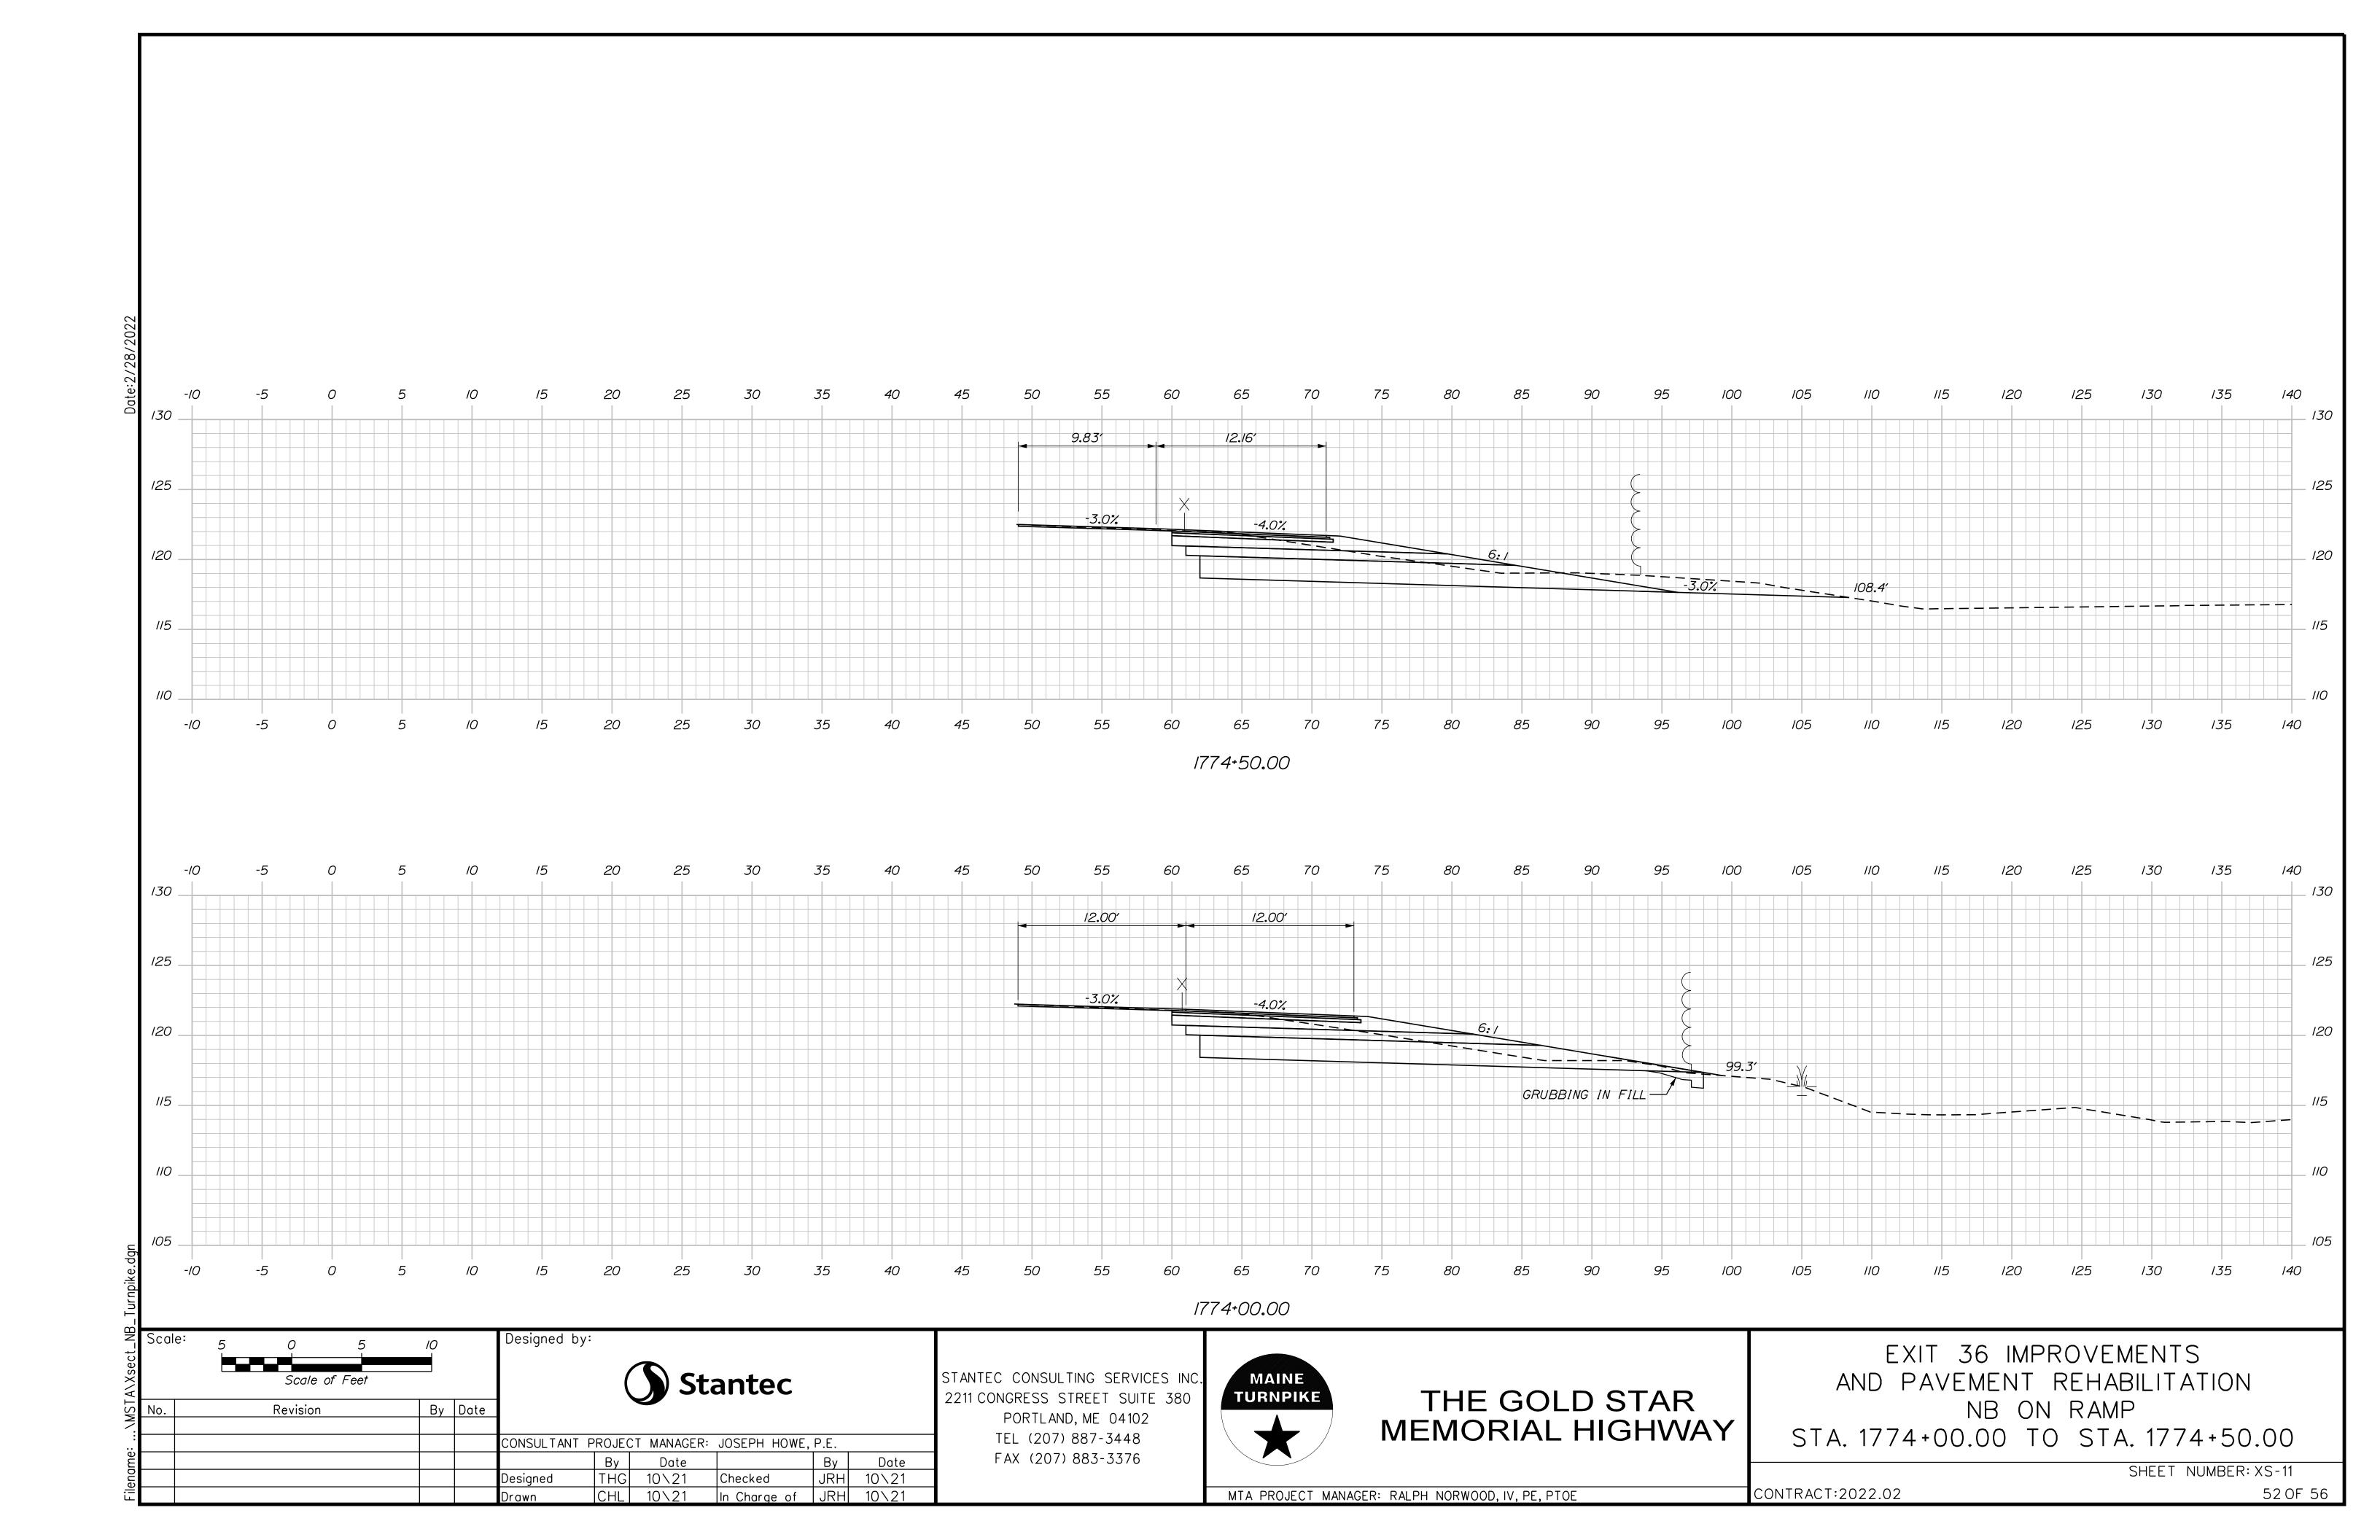

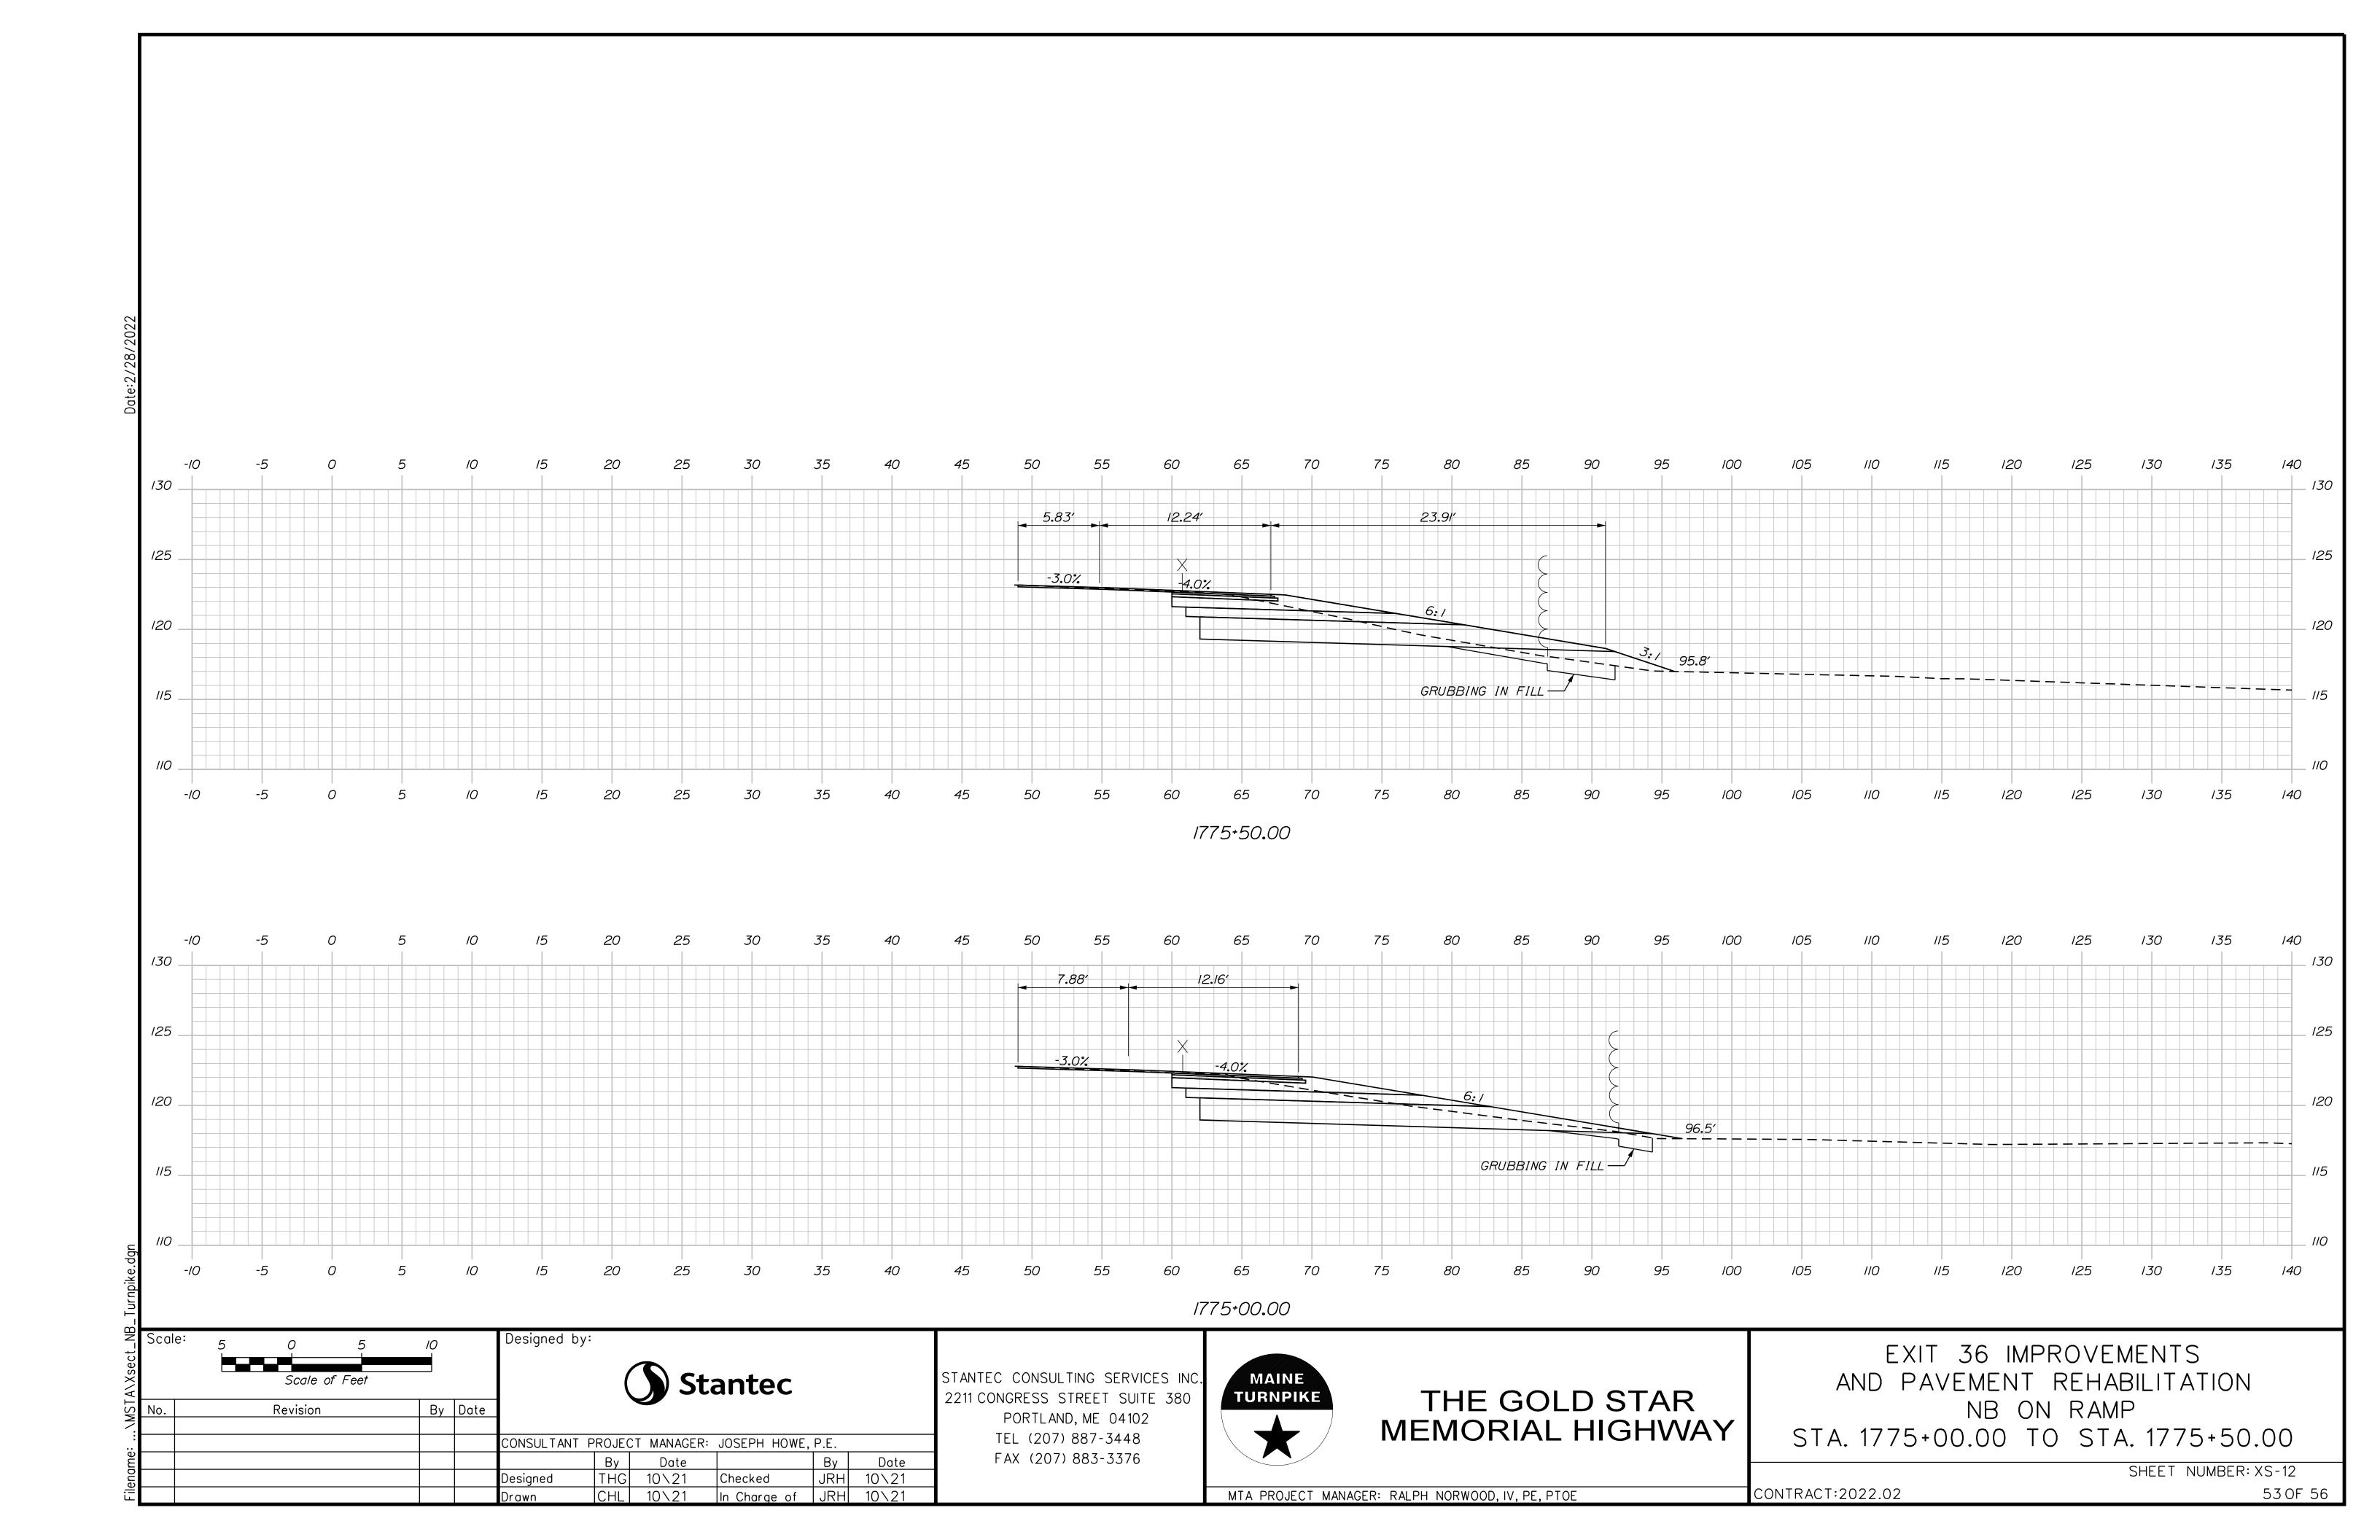

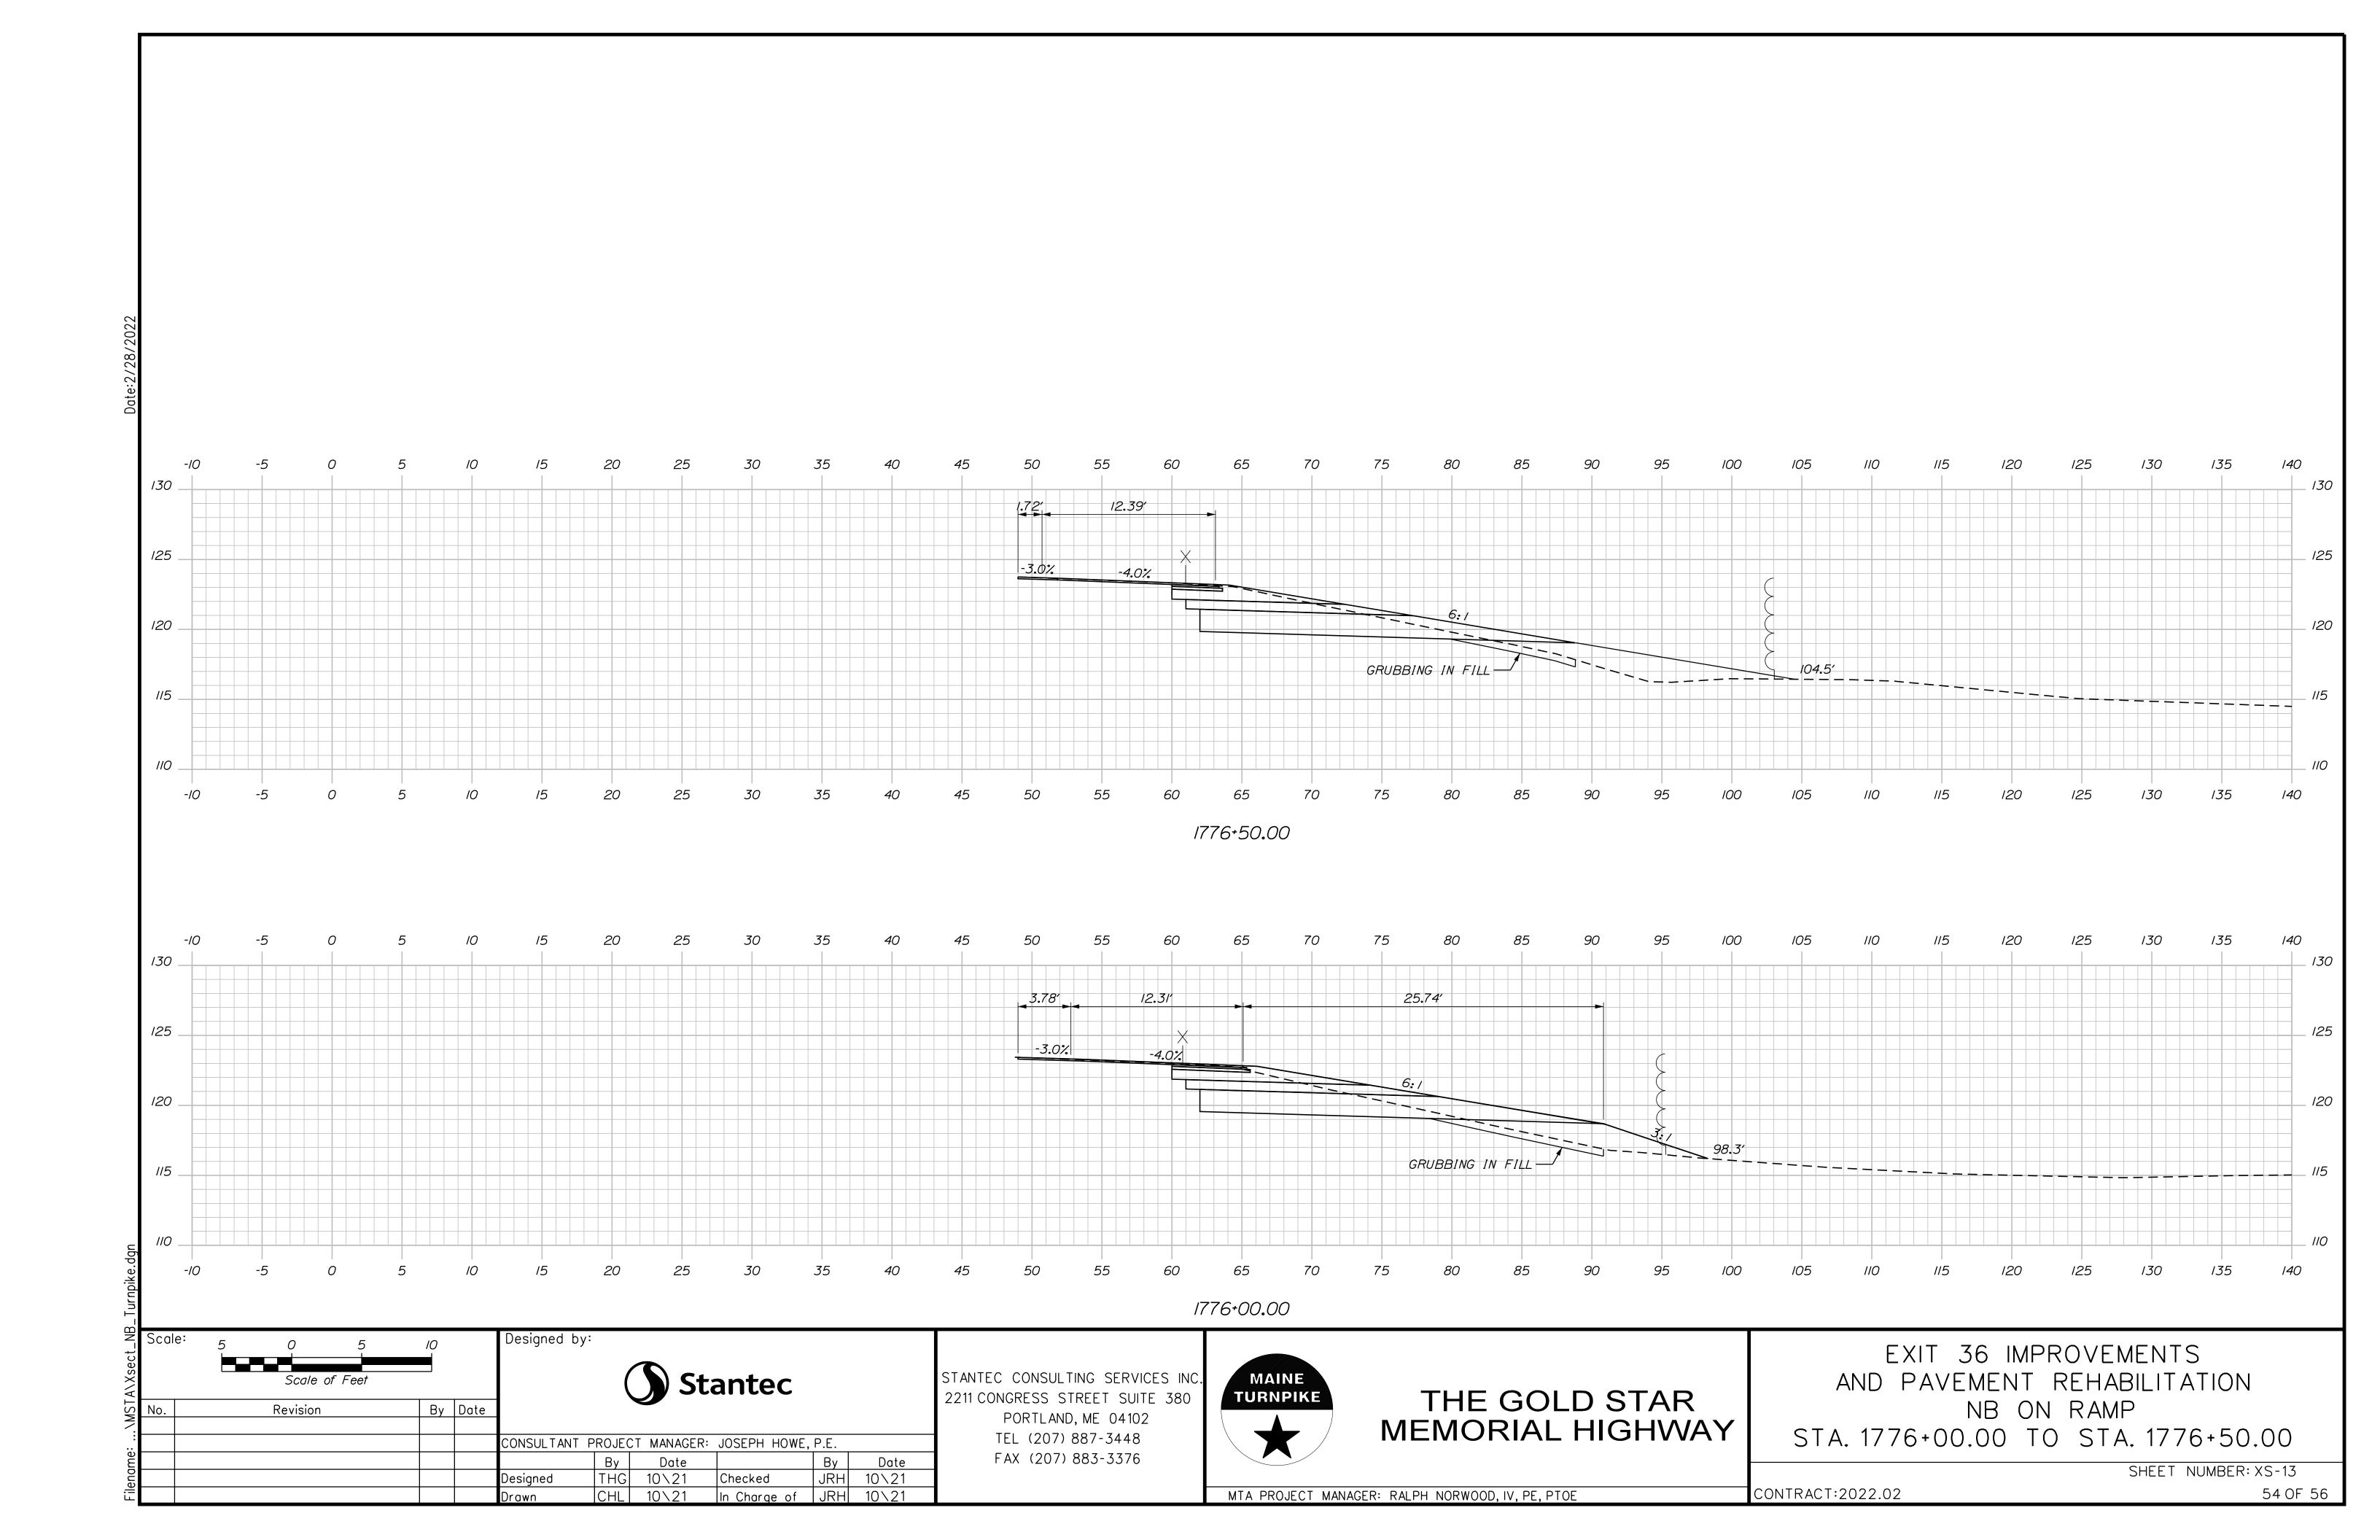

STA.1777+10 LIMIT OF WORK 115 130 1777+00.00 LIMIT OF SHOULDER WIDENING Designed by: EXIT 36 IMPROVEMENTS **Stantec** MAINE TURNPIKE STANTEC CONSULTING SERVICES INC. AND PAVEMENT REHABILITATION 2211 CONGRESS STREET SUITE 380 THE GOLD STAR NB ON RAMP By Date Revision

MEMORIAL HIGHWAY

MTA PROJECT MANAGER: RALPH NORWOOD, IV, PE, PTOE

STA. 1777+00.00 TO STA. 1777+00.00

CONTRACT:2022.02

SHEET NUMBER: XS-14

55 OF 56

PORTLAND, ME 04102

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CONSULTANT PROJECT MANAGER: JOSEPH HOWE, P.E.


Checked

By Date THG 10\21

Designed

By Date
JRH 10\21

In Charge of JRH 10\21

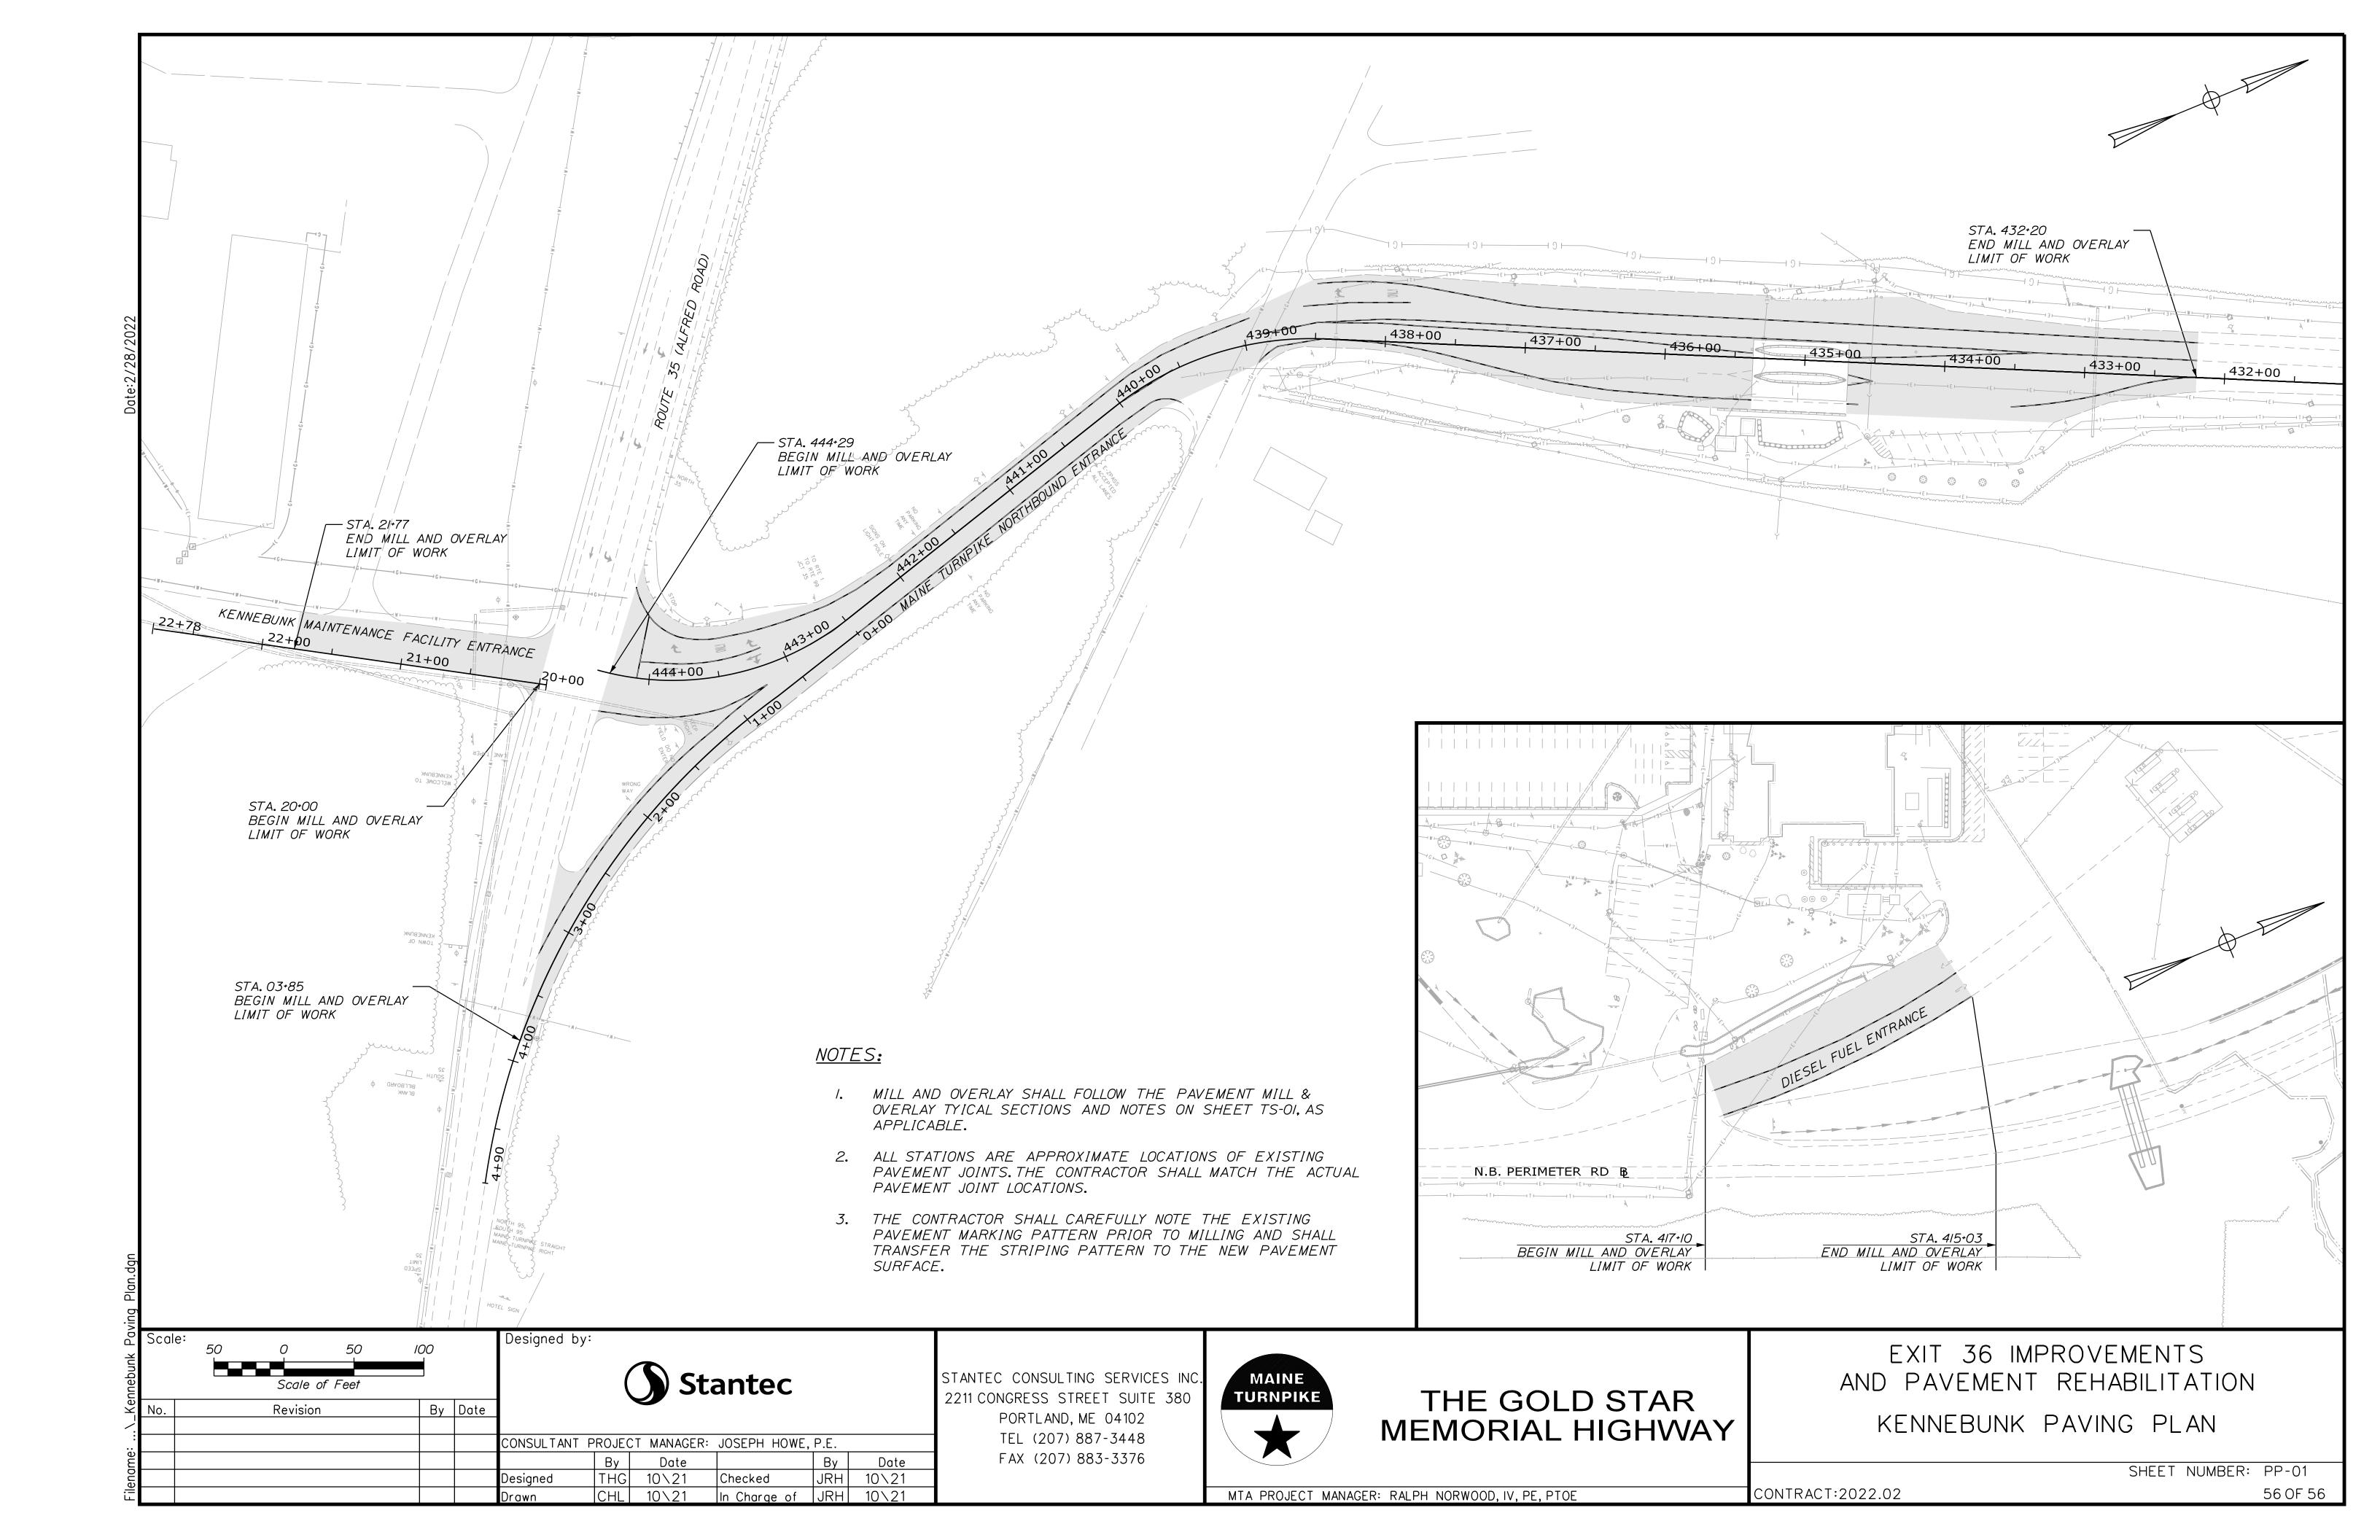

INDEX OF SHEETS

SHEET NO. DESCRIPTION

A1 INDEX OF SHEETS & ESTIMATED QUANTITIES

A2 GENERAL PLAN

A3 SIGNING & STRIPING PLAN

A4 SIGN SUMMARY


A5 MISCELLANEOUS DETAILS SIGNAL PLAN

A7 MAST ARM FOUNDATION DETAIL

*INFORMATION IN THE TABLE BELOW ARE NOT ITEM TOTALS.SEE EXIT 36 ESTIMATED QUANTITIES SHEETS (2 OF 56)

	ESTIMATED QUANTITIES*		
ITEM NO.	DESCRIPTION	TOTAL QUANTITY	UNIT
202.202	Removing Pavement Surface	20	SY
626.121	Quazite Junction Box (36X24)	4	EΑ
626.22	Non-Metallic Conduit	950	LF
626.32	24-Inch Diameter Foundation	1	EΑ
626.35	Controller Cabinet Foundation	1	EΑ
626.36	Remove or Modify Concrete Foundation	4	EΑ
626.48	60-Inch Diameter Foundation	48	LF
627.733	4" White or Yellow Painted Pavement Marking Line	340	LF
627.75	White or Yellow Pavement & Curb Marking	500	SF
627.77	Removing Existing Pavement Marking	2/50	SF
627.944	Pavement Markings - Recessed Tape - Words, Arrows, Stop Bars	60	SF
643.71	Traffic Signal Modification at: Exit 32 and Route III	1	LS
<i>643.9</i> ///	Reset Exisitng Mast Arm Poles: MA4 - Exit 32	1	LS
643.9112	Reset Existing Mast Arm Poles: MA3 - Exit 32	/	LS
643.9//3	Reset Existing Mast Arm Poles: Exit 42	/	LS
643.92	Pedestal Pole	1	LS
645.105	Remove and Stack Sign	5	EΑ
645.109	Remove and Reset Sign	3	EΑ
<i>645.271</i>	Regulatory Warning Confirmation Route Sign, Type I	35	SF
<i>652.33</i>	Drum	60	EΑ
<i>652.34</i>	Cone	60	EΑ
<i>652.35</i>	Construction Signs	190	SF
652.38	Flaggers	150	HR
<i>652.381</i>	Traffic Officers	33	HR
<i>652.45</i>	Truck Mounted Attenuator	/	CD



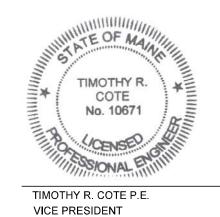

CONTRACT:2022.02

ਤੋਂ Scale: Designed by:

NOT TO SCALE HNTB By Date Revision CONSULTANT PROJECT MANAGER: PHIL KENDALL
 By
 Date

 DEB
 01/22

 DEB
 01/22
 By PEK Date 01/22 Checked Designed In Charge of TRC

HNTB CORPORATION 82 Running Hill Road, Suite 201 South Portland, ME 04106 TEL (207) 774-5155 FAX (207) 228-0909





THE GOLD STAR MEMORIAL HIGHWAY EXIT 32 INTERSECTION MODIFICATION INDEX OF SHEETS & ESTIMATED QUANTITIES

SHEET NUMBER: QT-1

MTA PROJECT MANAGER: STEPHEN R. TARTRE

A10F A7

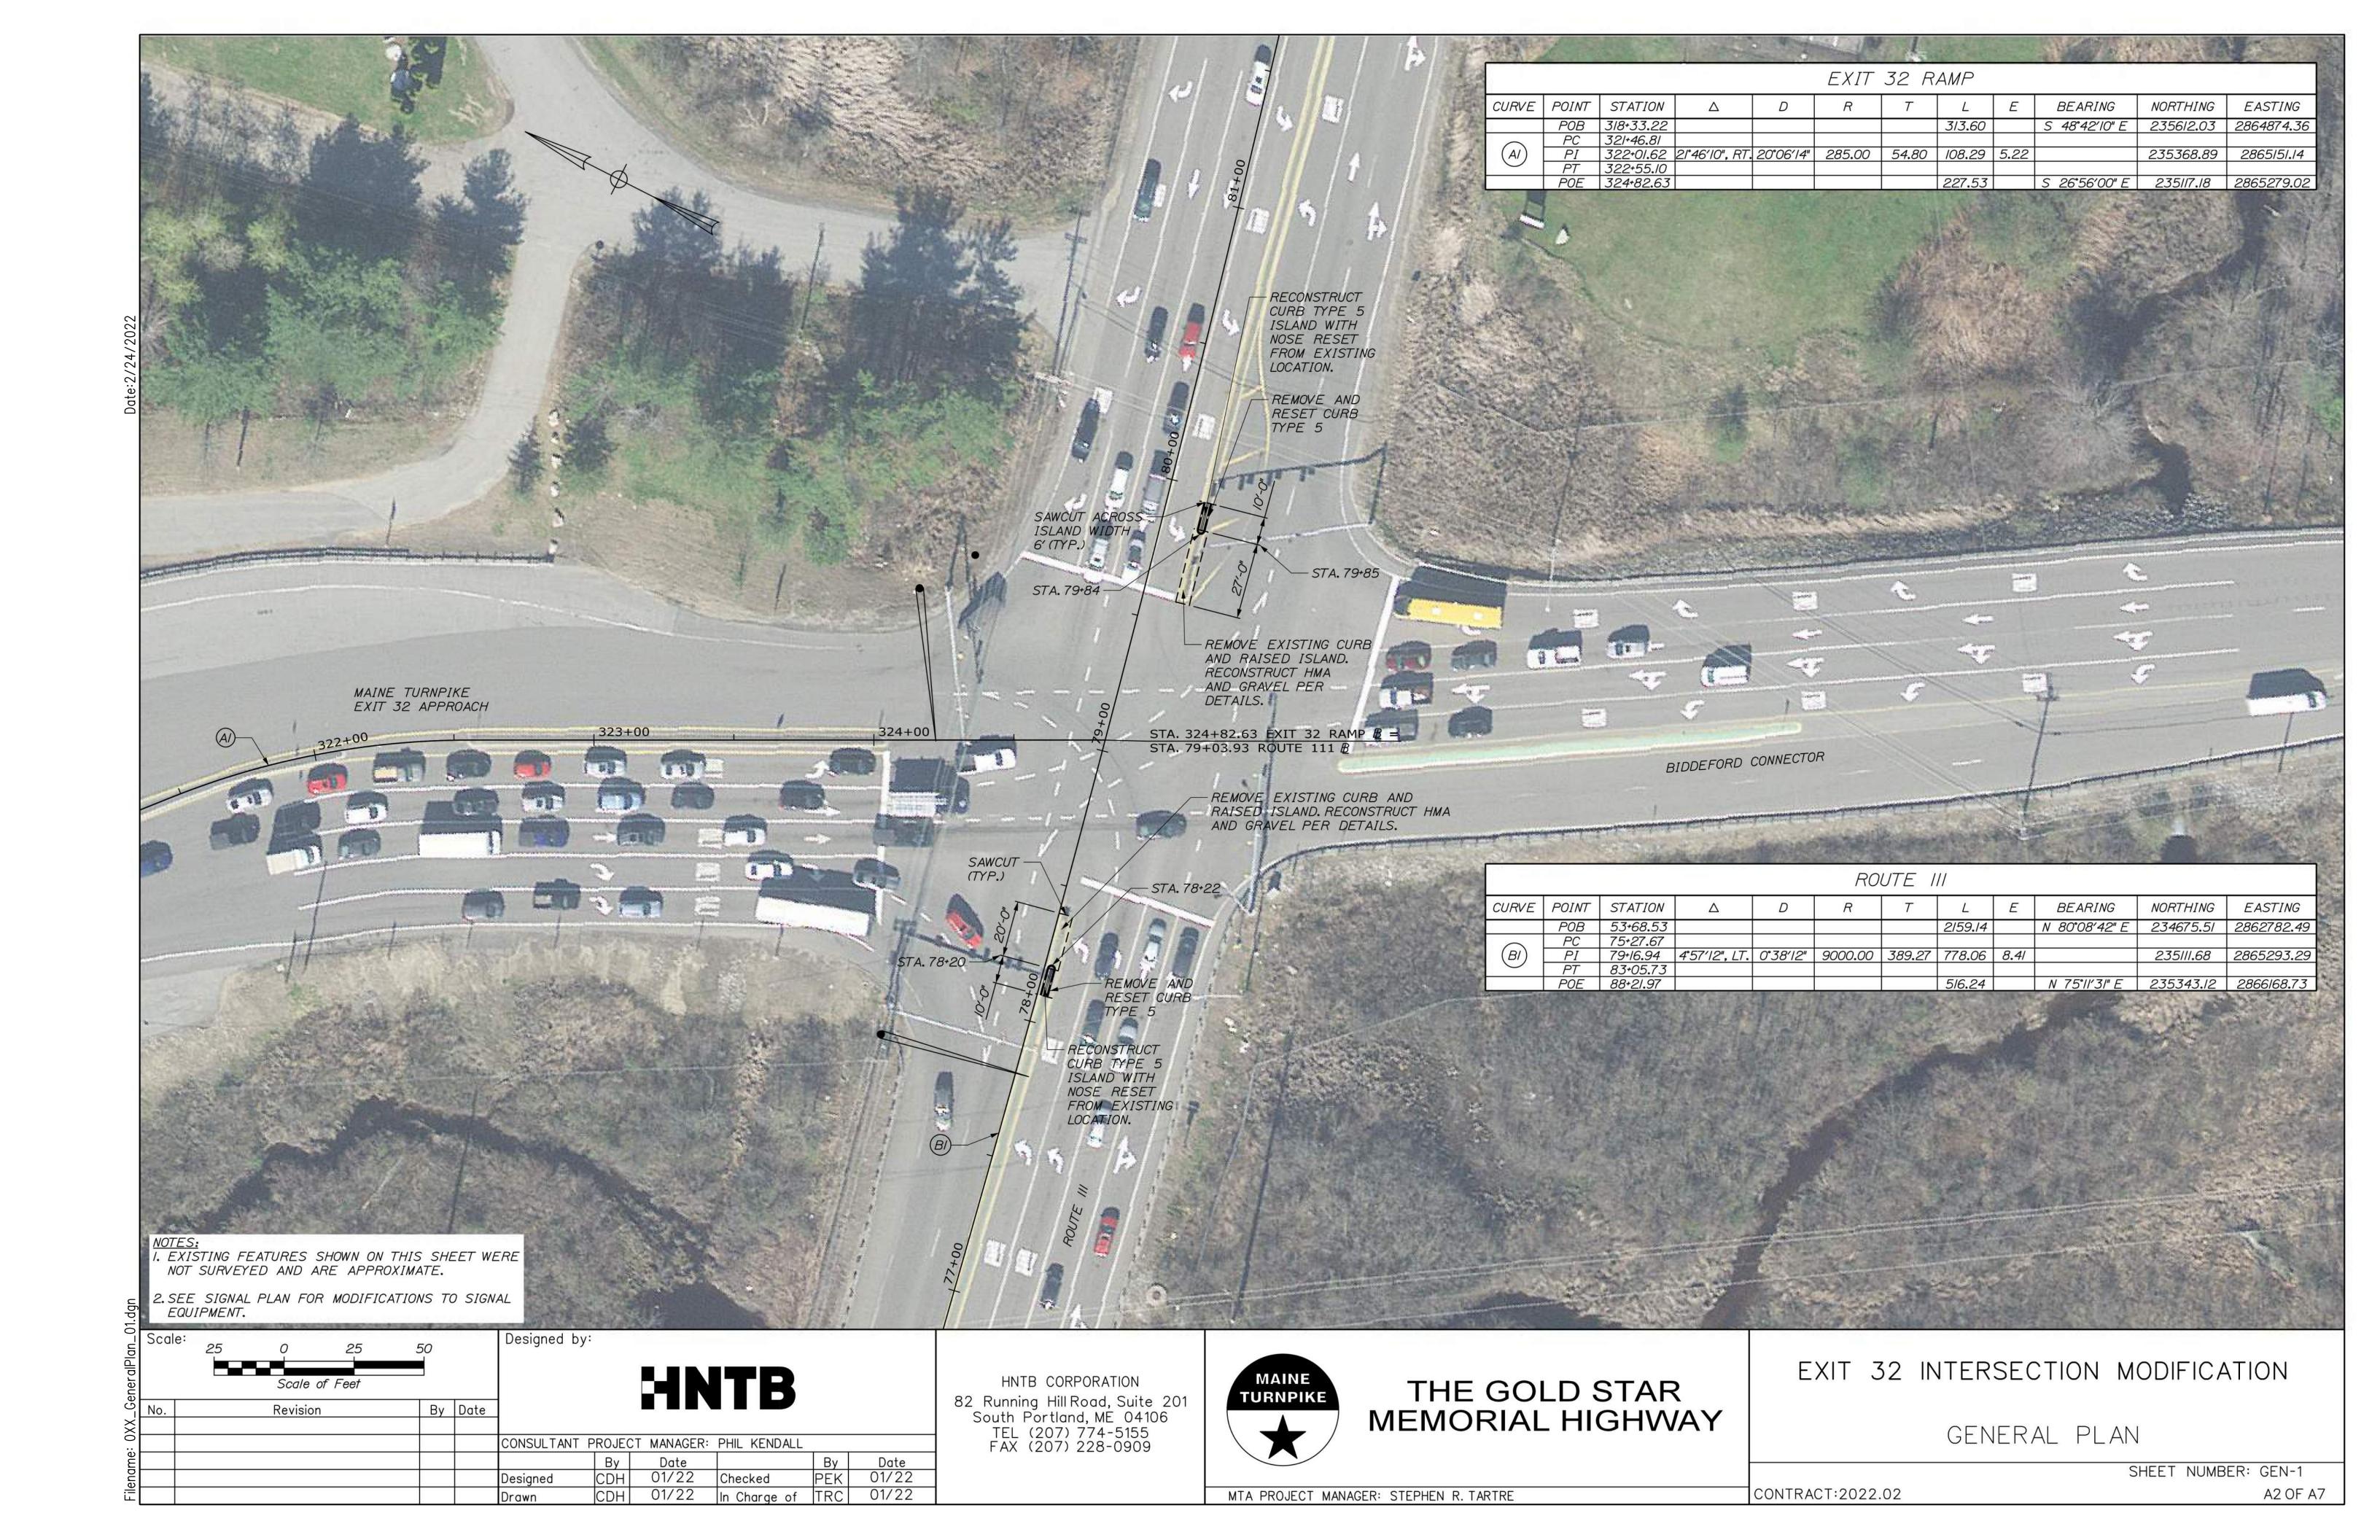

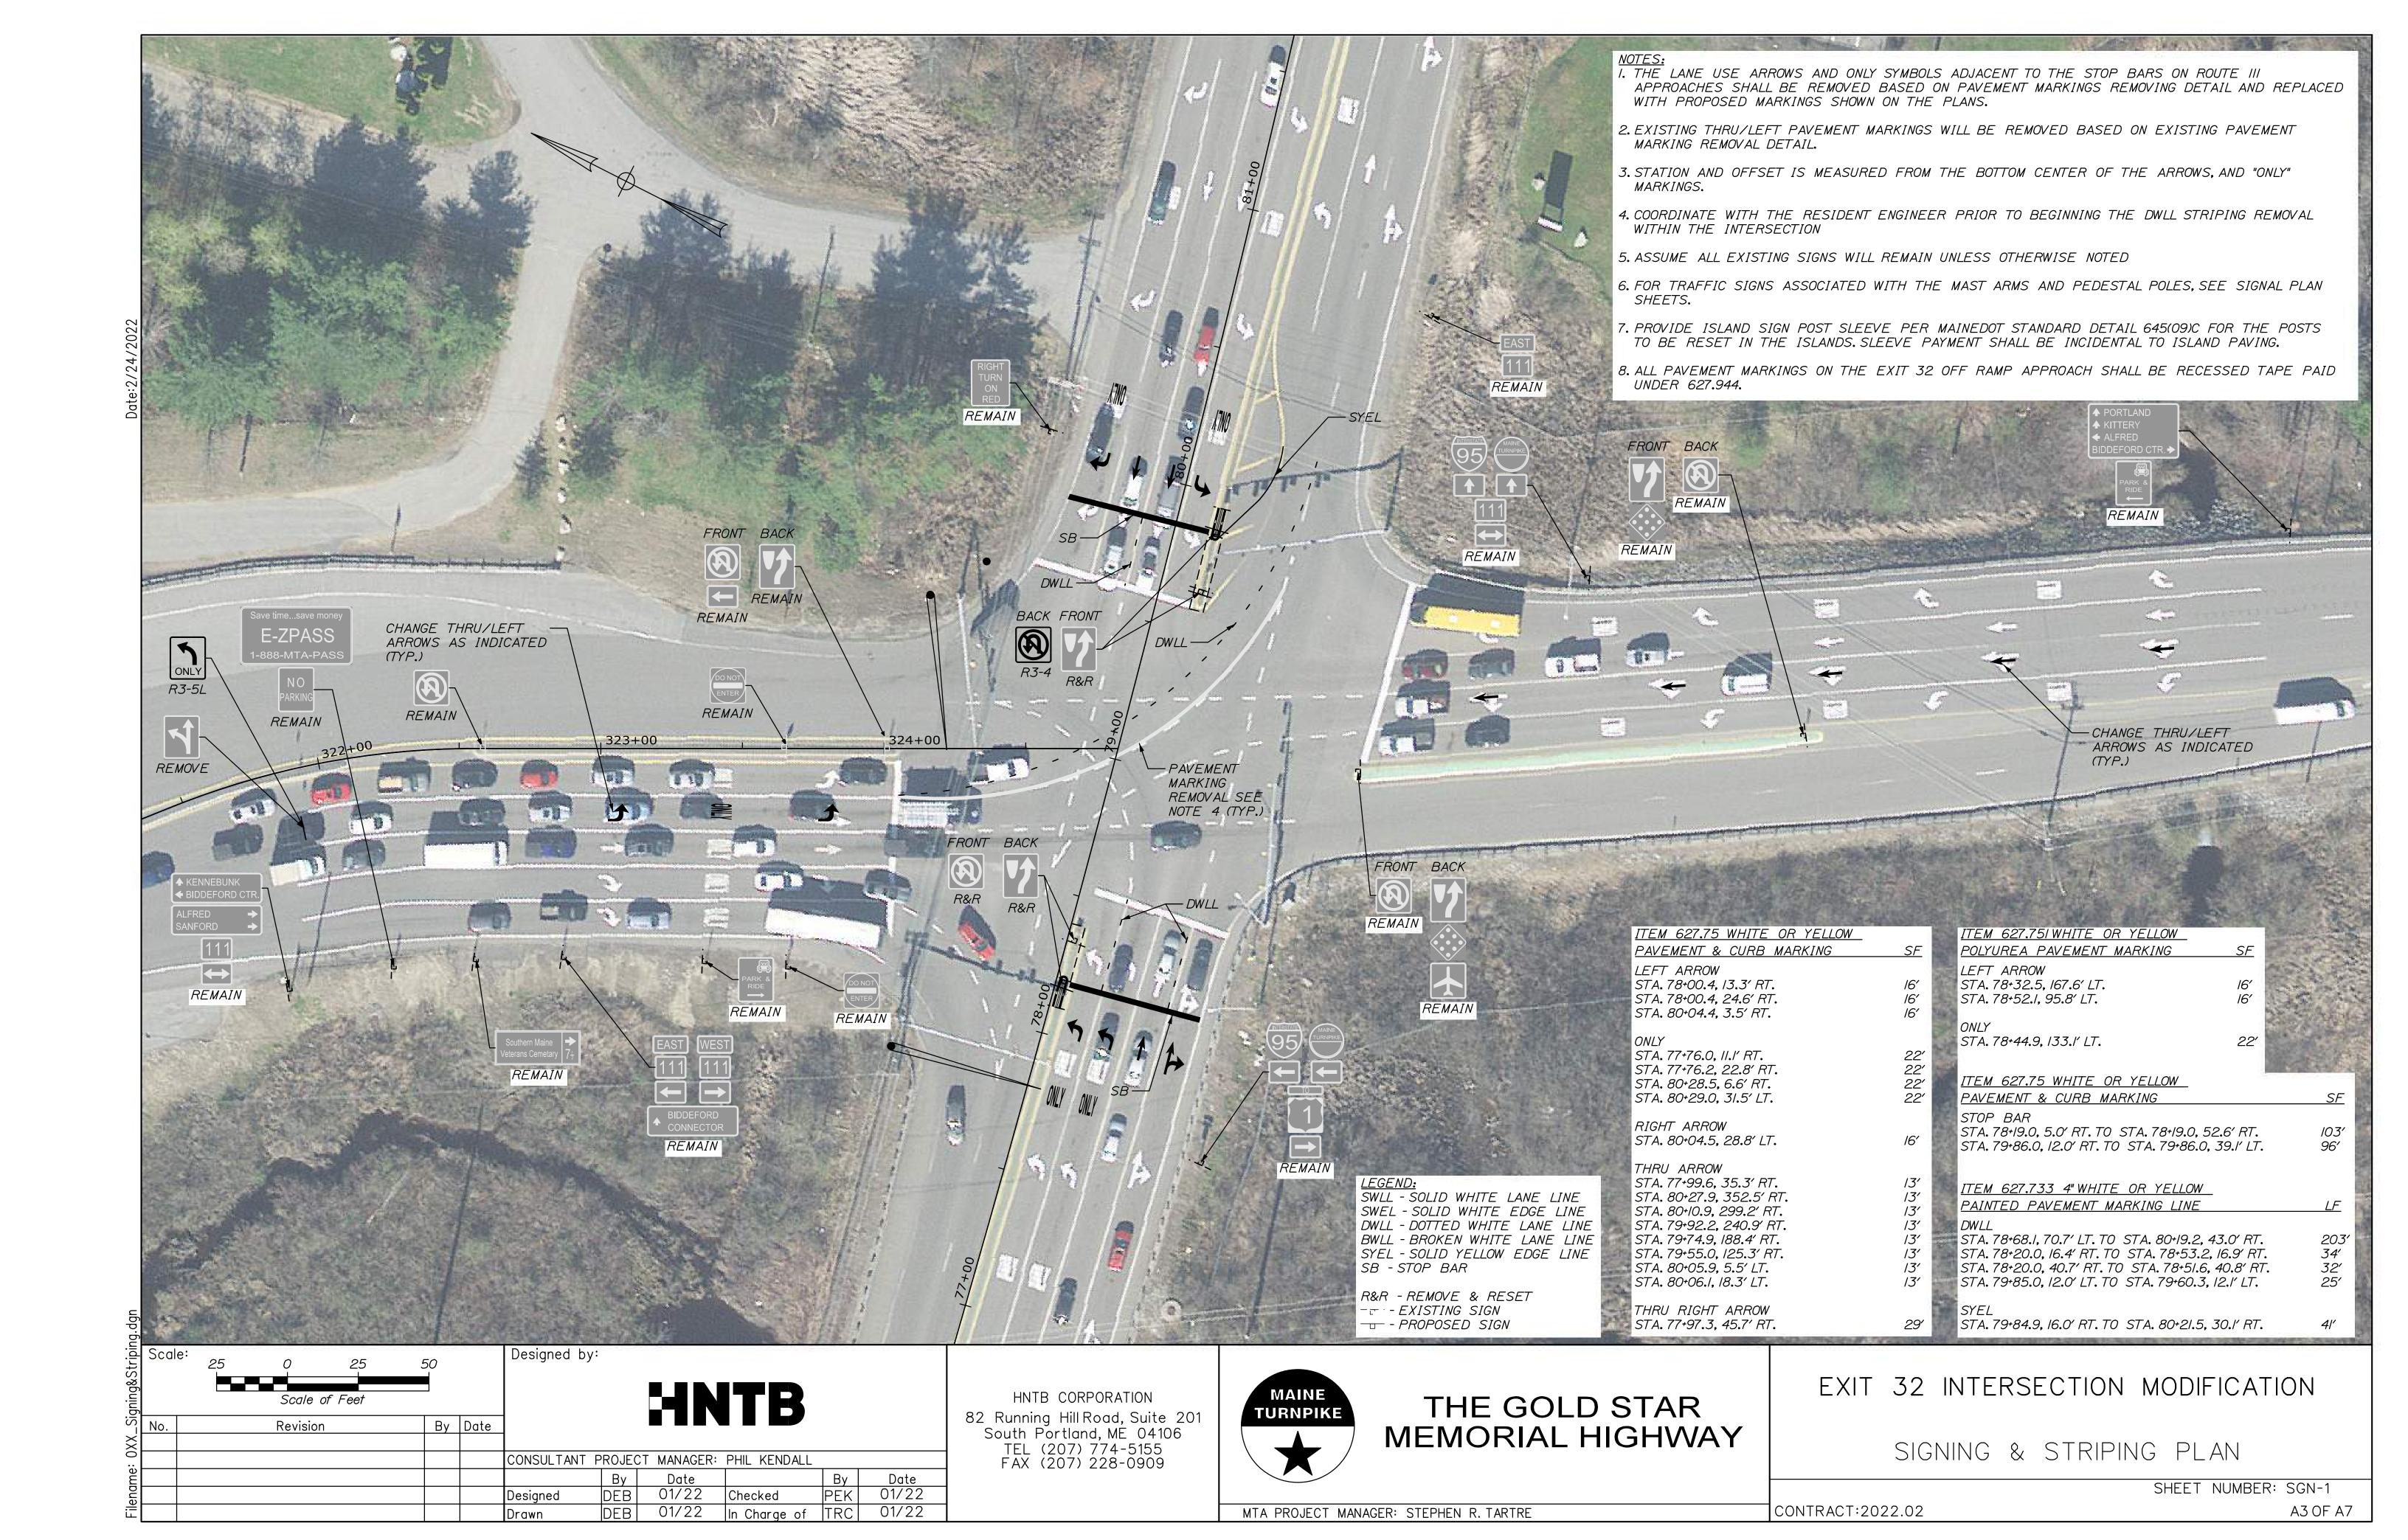

EXIT 32 REMOVE AND RESET SIGN SUMMARY

		EXISTING							PROPOSED											
DESCRIPTION	QUANTITY	HEIGHT (IN.)	SIGN SI WIDTH (IN.)			LEGEND	DIRECTION (EB-EASTBOUND) (WB-WESTBOUND)	LOCATION	OFFSET	NUMBER OF POSTS	POST SIZE	<i>L</i>	OF POST RIGHT (FEET)	FOUNDATION SIZE AND TYPE	BREAKAWAY DEVICE	DIRECTION (EB-EASTBOUND) (WB-WESTBOUND)	LOCATION	OFFSET (FROM BASELINE TO SIGN CENTER)	PAY ITEM NUMBER	COMMENTS
	/	30	24	5 (5)	WHITE	BLACK	EB	79+66	RT	/	U CHANNEL POST	POST HEIG SIZED 7 MUTCD M REQUIR	O MEET OUNTING	-	YES	EB	79+87	RT	645,109	
	/	30	24	5 (5)	WHITE	BLACK	WB	78+34	RT		U CHANNEL				VEC	WB	78+17	RT	645.109	
	/	24	24	4 (4)	WHITE	BLACK	EB	78+34	RT	l POST	•	•	-	YES	EB	78+17	RT	645.109		

EXIT 32 PROPOSED SIGN SUMMARY

IDENTIFICATION NUMBER	DESCRIPTION	QUANTITY	HEIGHT (IN.)	SIGN SI WIDTH (IN.)		BACK- GROUND	LEGEND	NUMBER OF POSTS	POST SIZE	HEIGHT OF POST LEFT CENTER RIGHT (FEET) (FEET)	FOUNDATION SIZE AND TYPE	BREAKAWAY DEVICE	DIRECTION (NB-NORTHBOUND) (SB-SOUTHBOUND)	LOCATION	OFFSET (FROM BASELINE TO SIGN CENTER)	PAY ITEM NUMBER	COMMENTS
R3-5a	ONLY	/	36	30	7.5 (7.5)	WHITE	BLACK	-	-	MOUNT TO OVERHEAD MAST ARM (MA3) FOR BIDDEFORD CONNECTOR	-	-	NB	79+50	LT	645.271	SEE SIGNAL PLANS FOR LOCATION
R3-5L	ONLY	/	36	30	7.5 (7.5)	WHITE	BLACK	-	-	MOUNT TO OVERHEAD MAST ARM FOR EXIT 32 OFF RAMP	-	-	SB	79+00	RT	645.27/	SEE SIGNAL PLANS FOR LOCATION
R3-5L*	ONLY	/	36	30	7.5 (7.5)	WHITE	BLACK	-	-	MOUNT TO OVERHEAD WIRE ON EXIT 32 OFF RAMP APPROACH	-	-	SB	78+00	LT	645.271	SEE SIGNING & STRIPING PLANS FOR LOCATION
R3-4		/	24	24	4 (4)	WHITE	BLACK	-	-	MOUNT TO EXISTING R&R SIGN R4-7	-	-	WB	79+87	RT	645.27/	SEE SIGNING & STRIPING PLANS FOR LOCATION
CS-3	TO 1	/	48	24	8 (8)	WHITE	BLACK	-	-	MOUNT TO OVERHEAD MAST ARM FOR EXIT 32 OFF RAMP	-	-	SB	78+75	RT	645.27/	SEE SIGNAL PLANS FOR LOCATION

*SPAN WIRE MOUNTED SIGNS SHALL HAVE WIND HOLES

EXIT 32 REMOVE AND STACK SIGN SUMMARY

DESCRIPTION	QUANTITY		SIGN SI			LOR	DIRECTION	LOCATION	OFFSET
DESCRITTION	QUANTITI	HEIGHT (IN.)	WIDTH (IN.)	AREA (SQ. FT.)	BACK- GROUND	LEGEND	(NB-NORTHBOUND) (SB-SOUTHBOUND)	LOCATION	OI I SLI
7	2	36	30	7 . 5 (/5)	WHITE	BLACK	NB SB	79+50 78+50	RT LT
1	/	36	30	7.5 (7.5)	WHITE	BLACK	NB	78+00	LT
s ^{TO}	/	42	24	7 (7)	WHITE	BLACK	SB	78+75	RT
TO N	/	42	24	7 (7)	WHITE	BLACK	SB	78+75	RT

Scale:

NOT TO SCALE

NO. Revision

By Date

CONSULTANT PROJECT MANAGER: PHIL KENDALL

By Date

Designed DEB 01/22 Checked PEK 01/22

Drawn DEB 01/22 In Charge of TRC 01/22

HNTB CORPORATION 82 Running Hill Road, Suite 201 South Portland, ME 04106 TEL (207) 774-5155 FAX (207) 228-0909



THE GOLD STAR MEMORIAL HIGHWAY

EXIT 32 INTERSECTION MODIFICATION

SIGN SUMMARY

SHEET NUMBER: SGN-2 A4 OF A7

MTA PROJECT MANAGER: STEPHEN R. TARTRE

CONTRACT:2022.02

REMOVAL OF EXISTING RAISED ISLAND N.T.S.


2'-0" APPROX. 4'-0" RAISED ISLAND ACRYLIC LATEX COLOR FINISH RESET CURB — (PER ITEM 658.20 TYPE 5 REQUIREMENTS) VARIES MATCH EXIST. SLOPE MATCH EXIST. SLOPE └─*3" MILL (TYP.)* ADD HOT RUBBERIZED ASPHALT — OR TACK FOR JOINT LIMIT OF EXCAVATION -REUSE EXISTING GRAVEL APPROXIMATE BOTTOM OF -(REGRADING SHALL BE CONSIDERED EXISTING PAVEMENT (TYP.) INCIDENTAL TO THE CONTRACT) -2" HOT MIX ASPHALT 9.5mm (SIDEWALKS, DRIVES, ISLANDS, & INCIDENTALS) (PER ITEM 403.213 REQUIREMENTS) — I/⁄2" HOT MIX ASPHALT I2.5mm (TYP.) (PER ITEM 403.213 REQUIREMENTS) (PER ITEM 403.213 REQUIREMENTS)

REMOVE AND RESET CURB TYPE 5

N.T.S.


RAISED ISLAND NOTES:

- I. ISLAND RECONSTRUCTION WORK WILL BE INCIDENTAL TO THE TRAFFIC SIGNAL MODIFICATION WORK (ITEM 643.71).
- 2. THE PAVEMENT, BASE, AND SUBBASE DEPTHS AS SHOWN ON THE PLANS ARE INTENDED TO BE NOMINAL.
- 3. ALL NECESSARY PAVEMENT CUTTING SHALL BE SAWCUT AND DONE IN SUCH A MANNER AS TO LEAVE A CLEAN, VERTICAL FACE.
- 4. ACRYLIC LATEX COLOR FINISH WILL SHALL BE APPLIED TO THE FINISHED SURFACE OF THE RECONSTRUCTED RAISED ISLAND IN ACCORDANCE WITH STANDARD SPECIFICATION SECTION 658.
- 5. EXCAVATION FOR ISLAND RECONSTRUCTION IS LIMITED TO THE INSIDE OF CURBING.
 ANY ADDITIONAL EXCAVATIONS FOR ISLAND RECONSTRUCTION WILL BE CONSIDERED INCIDENTAL.
- 6. ALL EXCAVATION COMPACTION NEEDS TO BE COMPLETED PRIOR TO RESETTING THE CURBING OR ADDING AN ADDITIONAL FILL MATERIAL.
- 7. PROVIDE ISLAND SIGN POST SLEEVE PER MAINEDOT STANDARD DETAIL 645(09)C FOR THE POSTS TO BE RESET IN THE ISLANDS.

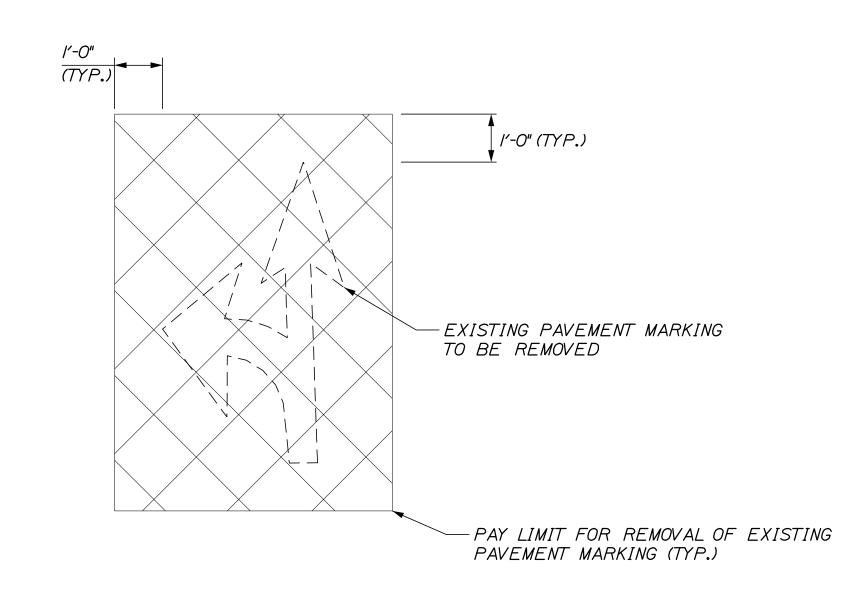

EXISTING PAVEMENT MARKING REMOVAL

N.T.S.

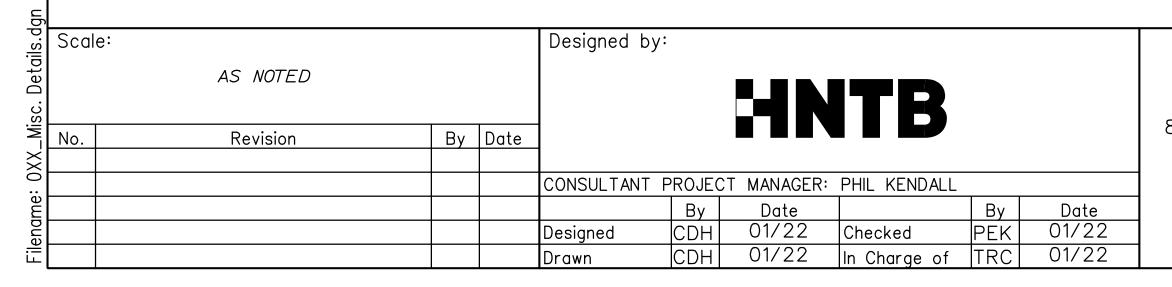

HNTB CORPORATION

82 Running Hill Road, Suite 201
South Portland, ME 04106
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FAX (207) 228-0909




THE GOLD STAR MEMORIAL HIGHWAY EXIT 32 INTERSECTION MODIFICATION

MISCELLANEOUS DETAILS

SHEET NUMBER: DTL-1
CONTRACT:2022.02
A5 OF A7

MTA PROJECT MANAGER: STEPHEN R. TARTRE

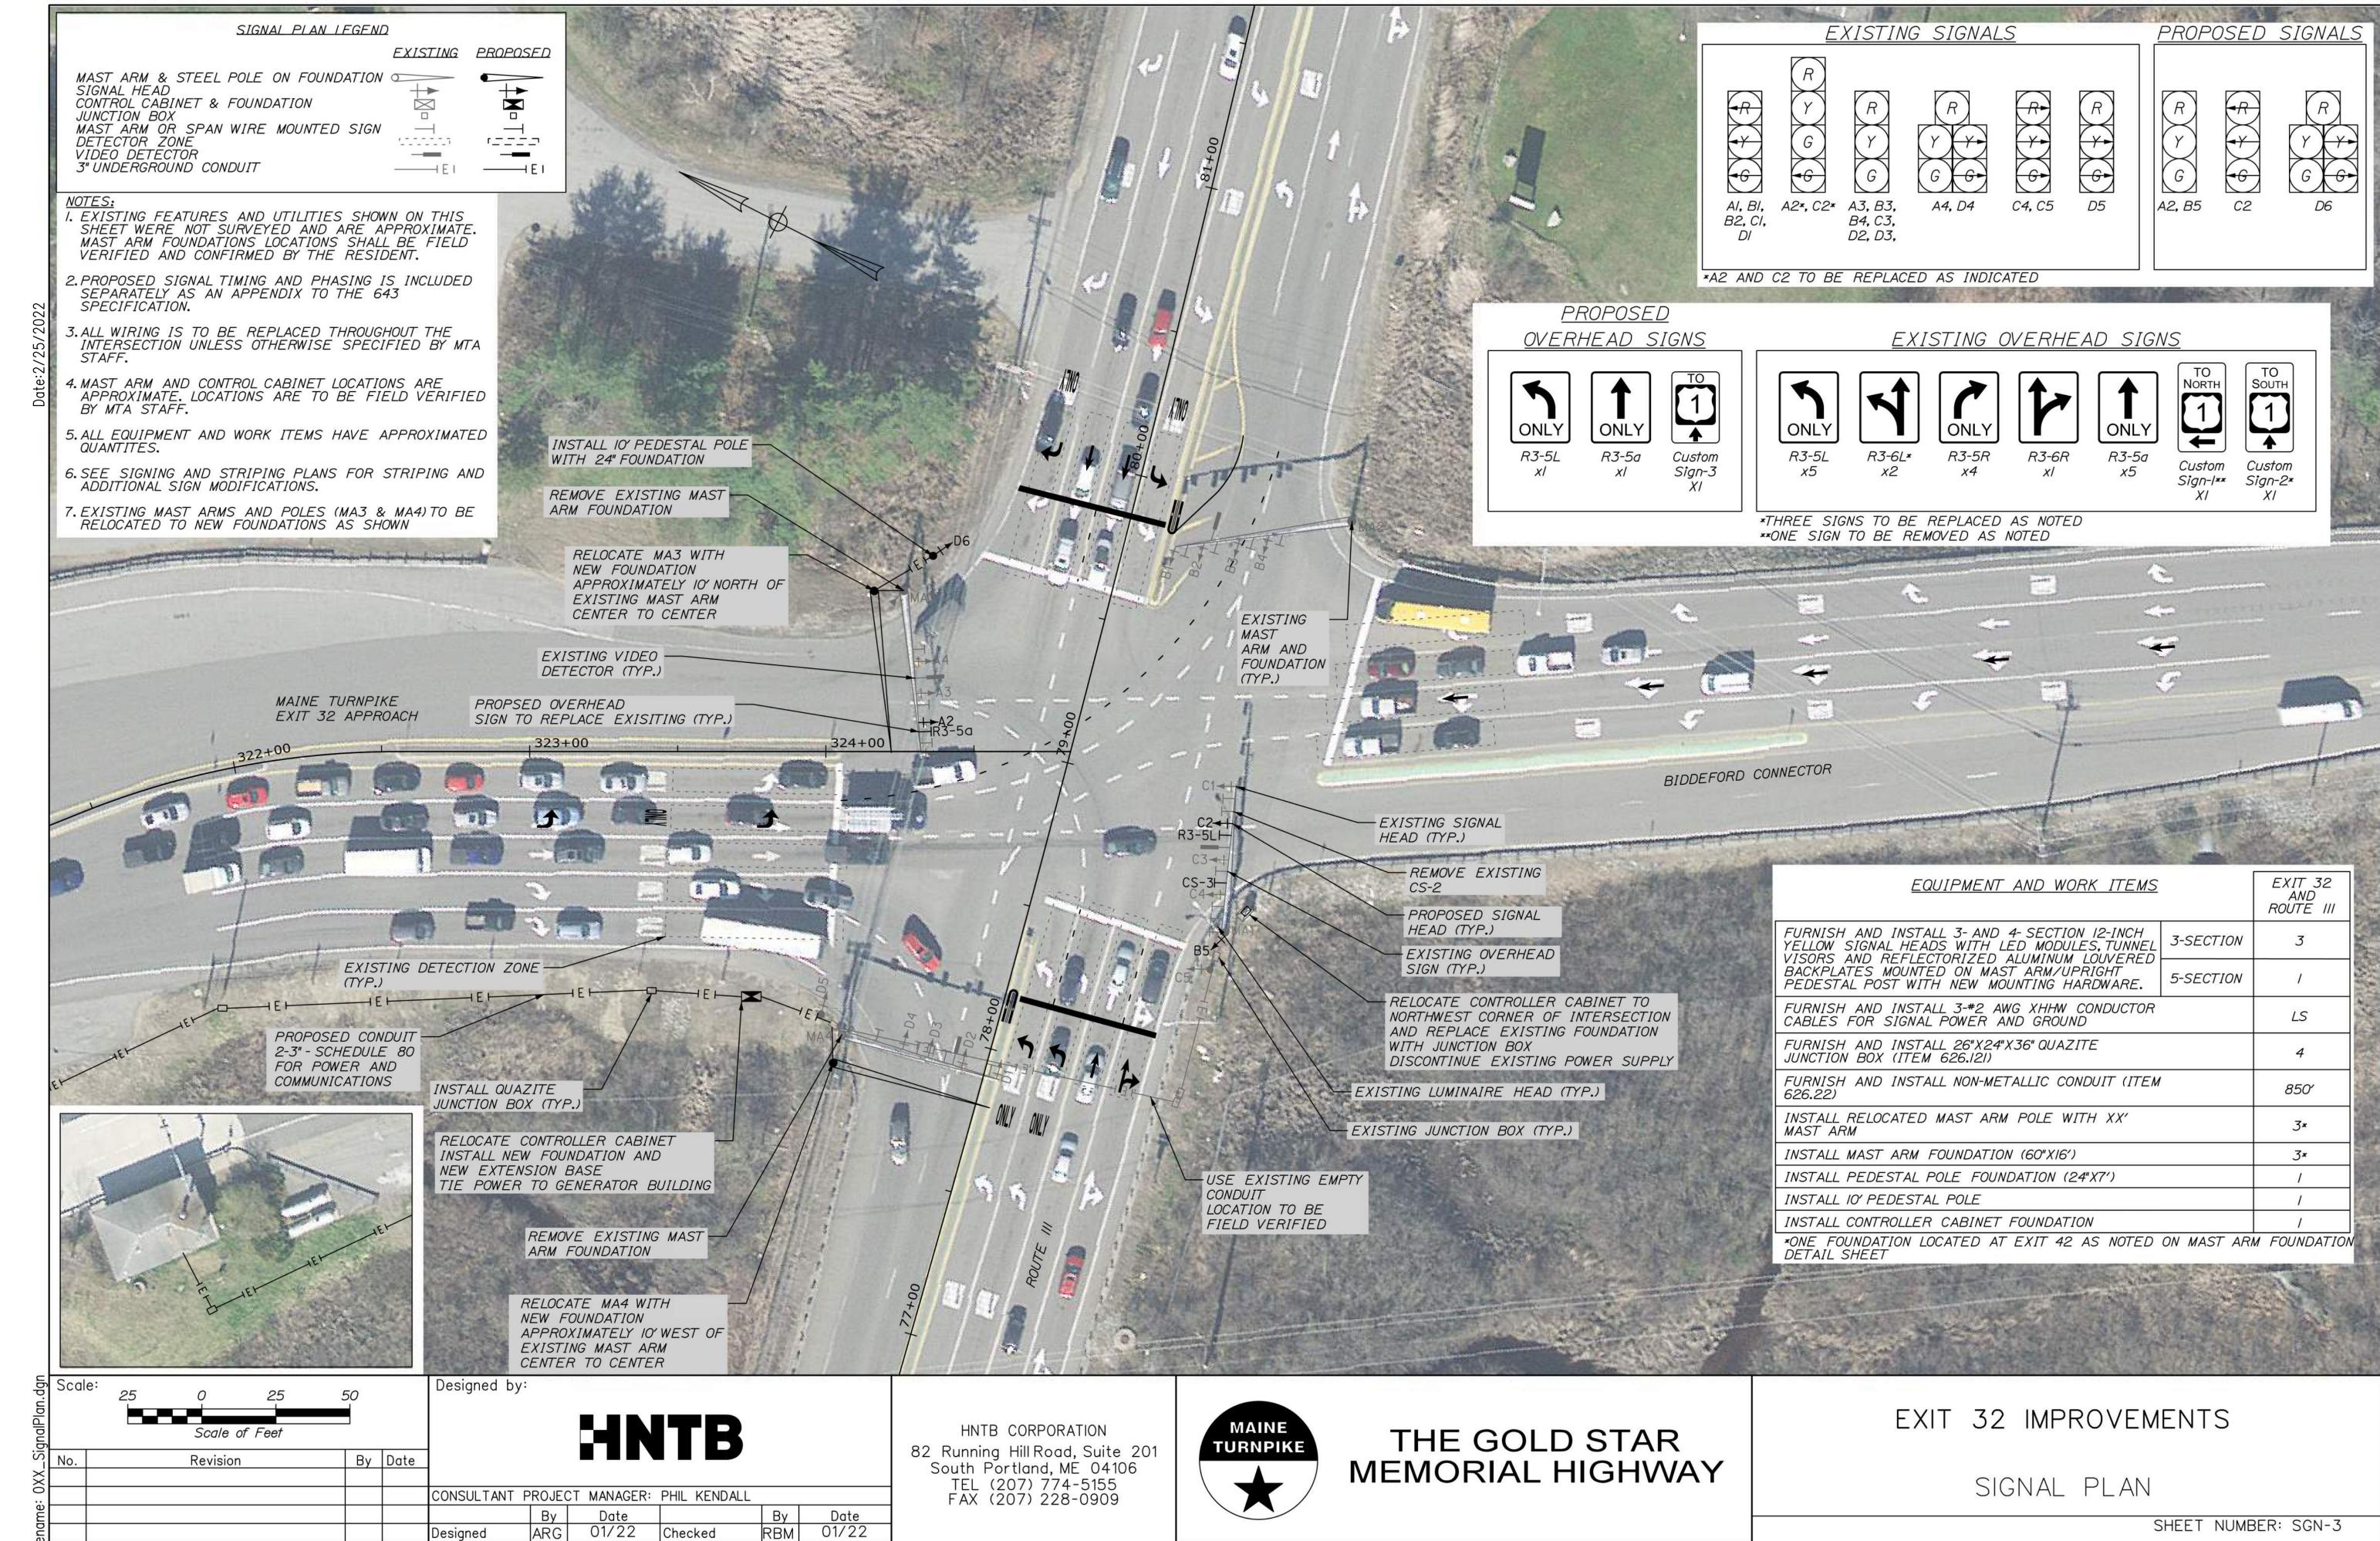

MTA PROJECT MANAGER: STEPHEN R. TARTRE


In Charge of

01/22

TRC


CONTRACT:2022.02

A6 OF A7

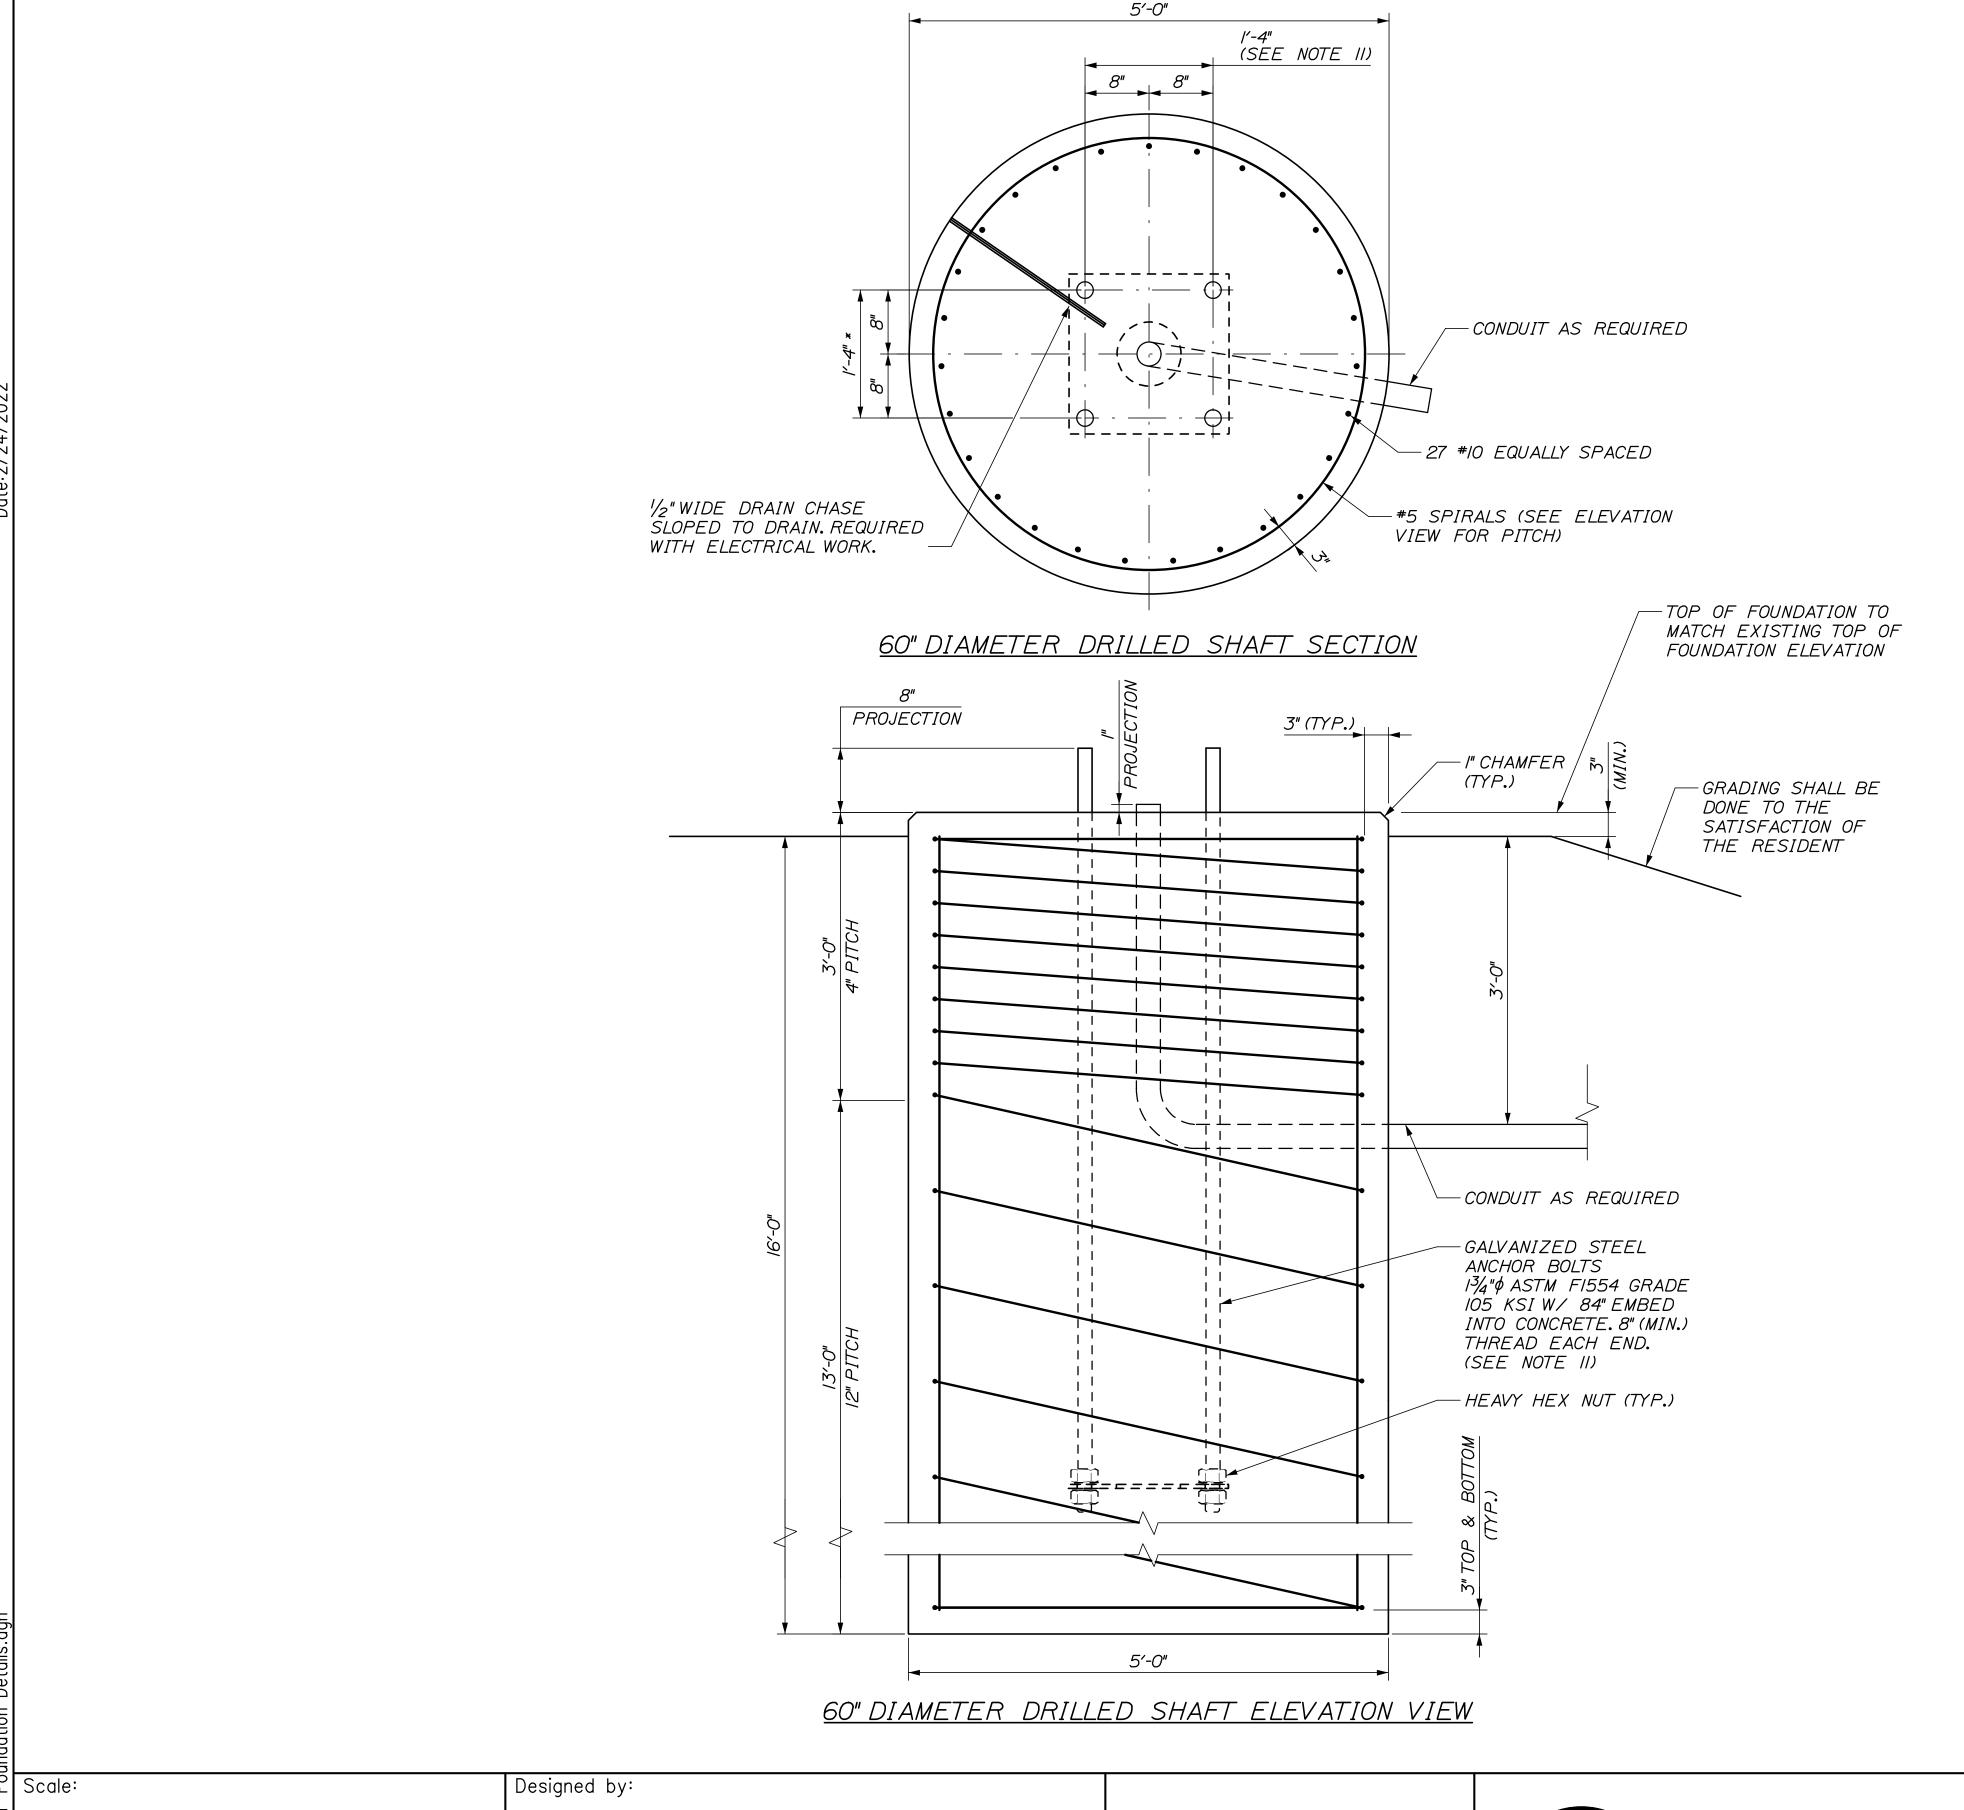

MAST ARM FOUNDATION NOTES

- I. ALL REINFORCING STEEL SHALL BE EPOXY COATED AND COMPLY WITH ASTM A615, GRADE 60.
- 2. CONCRETE FOR FOUNDATION SHALL CONFORM TO MAINEDOT CLASS LP.
- 3. STEEL ANCHOR BOLTS AND HARDWARE SHALL BE GALVANIZED IN ACCORDANCE WITH ASTM A153.
- 4. THE MAXIMUM GAP BETWEEN BOTTOM OF THE ANCHOR BOLT LEVELING NUT AND THE TOP OF CONCRETE SHALL BE 3/4".
- 5. IF THE CONTRACTOR ENCOUNTERS CLAY WHILE DRILLING FOR MAST ARM FOUNDATIONS, THEY ARE TO STOP WORK AND NOTIFY THE RESIDENT SO THAT SOIL CONDITIONS CAN BE EVALUATED PRIOR TO MOVING FORWARD WITH THE DRILLING OPERATIONS.
- 6. THE WORK AT EXIT 42 CONSISTS OF RELOCATING THE MAST ARM IN THE NORTHWEST QUADRANT OF THE INTERSECTION TO A NEW FOUNDATION. THE MAST ARM WILL MOVE APPROXIMATELY IO FEET AWAY FROM THE INTERSECTION, FINAL LOCATION TO BE DETERMINED IN FIELD AND APPROVED BY THE RESIDENT BEFORE RELOCATION.
- 7. THE TOP OF THE PROPOSED MAST ARM FOUNDATIONS SHALL MATCH THE ELEVATION OF THE EXISTING FOUNDATIONS. THE CONTRACTOR SHALL BE RESPONSIBLE FOR ESTABLISHING PROPOSED ELEVATIONS FOR APPROVAL BY THE RESIDENT. THE CONTRACTOR SHALL DETERMINE THE EXISTING ELEVATIONS PRIOR TO CONSTRUCTION OF PROPOSED FOUNDATIONS.
- 8. AT THE CONTRACTOR'S OPTION A GALVANIZED CORRUGATED METAL PIPE MAY BE USED AS A STAY-IN-PLACE FORM. THE TOP OF THE PIPE SHALL BE AT LEAST 2'-0" BELOW TOP OF GRADE.
- 9. CONCRETE SHALL BE PLACED VIA A PUMP TRUCK AND HARD PIPE TREMIE, AS THE CONCRETE WILL BE PLACED UNDERWATER. THE CONTRACTOR WILL BE RESPONSIBLE FOR COMPLETELY FILLING THE ANNULUS BETWEEN THE STAY-IN-PLACE FORM, IF USED, AND EXISTING SOIL USING FLOWABLE FILL OR OTHER METHODS APPROVED BY THE RESIDENT.
- 10.THE EXIT 32 MAST ARM FOUNDATION DESIGNS ARE BASED ON ASSUMED SOIL CONDITIONS. GEOTECHNICAL ANALYSIS AND FINAL MAST ARM FOUNDATION DESIGN WILL BE PROVIDED TO CONTRACTOR PRIOR TO CONSTRUCTION, THE FINAL MAST ARM DESIGN MAY DIFFER FROM THE DETAIL SHOWN ON THIS SHEET. THE CONTRACTOR WILL BE PAID FOR THE ACTUAL VOLUME OF CONCRETE USED TO COMPLETE THE WORK IN ACCORDANCE WITH STANDARD SPECIFICATION SECTION 626.
- II. THE CONTRACTOR IS RESPONSIBLE FOR VERIFYING THE DIAMETER AND LAYOUT OF THE EXISTING ANCHOR RODS AT THE EXIT 32 MAST ARMS PRIOR TO THE START OF THE WORK. THE CONTRACTOR'S FIELD MEASUREMENTS AND PROPOSED ANCHOR ROD LAYOUT SHALL BE SUBMITTED TO THE RESIDENT FOR REVIEW AND APPROVAL.

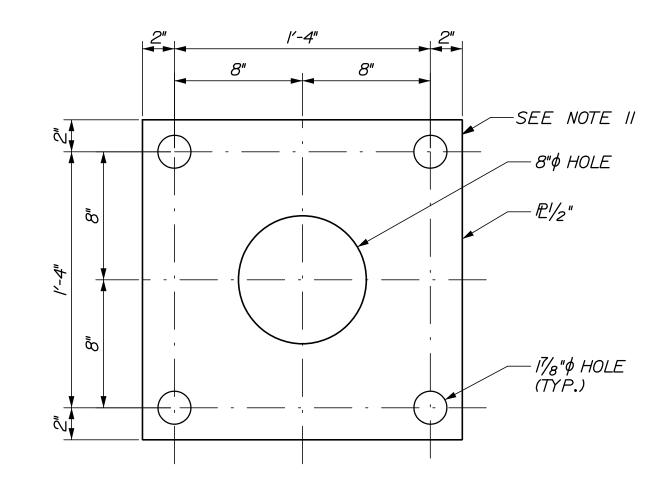

ANCHOR PLATE DETAIL

HNTB By Date Revision CONSULTANT PROJECT MANAGER: PHIL KENDALL Ву Date 01/22 01/22 HJW Checked Designed 01/22 01/22 In Charge of TRC

HNTB CORPORATION 82 Running Hill Road, Suite 201 South Portland, ME 04106 TEL (207) 774-5155 FAX (207) 228-0909



MTA PROJECT MANAGER: STEVE TATRE, P.E.

THE GOLD STAR MEMORIAL HIGHWAY

EXIT 32 AND EXIT 42 INTERSECTION MODIFICATION

MAST ARM FOUNDATION DETAIL

SHEET NUMBER: S-1

CONTRACT:2022.02

A7 OF A7