

MAINE TURNPIKE AUTHORITY


DANIEL E. WATHEN, CHAIR ROBERT D. STONE, VICE CHAIR MICHAEL J. CIANCHETTE, MEMBER JANE L. LINCOLN, MEMBER ANN R. ROBINSON, MEMEBER THOMAS J. ZUKE, MEMBER BRUCE A. VAN NOTE, EX-OFFICIO

S. PETER MILLS, EXECUTIVE DIRECTOR

CONTRACT 2022.01 DRAINAGE IMPROVEMENTS MM 102.6 TO MM 109.1


PAVEMENT REHABILITATION AND

	INDEX OF	SHEETS
SHEET NO.	SHEET NO.	DESCRIPTION
1 2 3 4 5 6-7 8 9 10-16 17-18 19-21 22-23 24	C-1 C-2 P-1 P-2 P-3-4 P-5 P-6 T 1-7 T 8-9 T 10-12 S 1-2 TR-1	SIGN SUMMARY

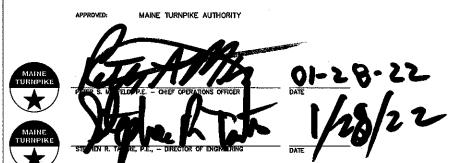

LOCATION MAP

SCARBOROUGH

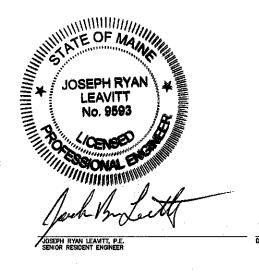

ITEM	DESCRIPTION	UNIT	Total	
NO.			Quantity	
202.202	Removing Pavement Surface - Mainline	SY	280,700	
202.2026	Remove Pavement Surface - Drainage Paths	SF	385	
202.205	Rumble Strips	EA	122,400	
403.2081	Hot Mix Asphalt, 12.5mm (Polymer Modified)- RAP	Ton	24,500	
402 2084	Hot Mix Asphalt, 12.5mm Nominal Maximum Size (sidewalks,	Топ	100	
403.2084	drives, islands & incidentals)	Ton	180	
403.211	Hot Mix Asphalt (shimming)	Ton	150	
409.15	Bituminous Tack Coat - Applied	GAL	17,590	
419.30	Full Depth Bituminous Sawcut	LF	900	
419.301	Saw Cutting and Sealing Bituminous Pavement	LF	156	
424.323	Asphalt Rubber Mastic Crack Sealant	LB	39,700	
459.06	Bituminous Concrete Waterway - Type I	EA	12	
470.08	Berm Dropoff Correction - Grindings	Ton	1,200	
470.081	Berm Correction	LF	21,000	
520.23	Asphaltic Plug Joint	LF	136	
603.199	24 inch Culvert Pipe - Option III	LF	58	
603.28	Concrete Collar	EA	3	
604.182	Clean Existing Catch Basin And Manhole	EA	60	
604.186	Rebuild Catch Basin to Grade - Type IV	EA	10	
610.08	Plain Rip Rap	CY	15	
613.319	Erosion Control Blanket	SY	1,150	
615.07	Loam	CY	90	
619.1202	Temporary Mulch	LS	1	
620.58	Erosion Control Geotextile	SY	75	
627.730	Temporary Pavement Marking Line Tape	LF	5,200	
627.780	Temporary Pavement Marking Line	LF	203,400	
627.812	Temporary Raised Pavement Markers	EA	13,500	
627.94	Pavement Marking Tape	LF	2,650	
627.941	Pavement Marking Tape - Dotted White Lane Line, 6-inch width	LF	300	
627.942	Pavement Marking Tape - Dotted White Lane Line, 12-inch width	LF	160	
629.05	Hand Labor, Straight Time	HR	20	
631.10	Air Compressor (including operator)	HR	20	
631.11	Air Tool (including operator)	HR	20	
631.12	All Purpose Excavator (including operator)	HR	30	
631.172	Truck - Large (including operator)	HR	30	
631.36	Foreman	HR	20	
652.30	Flashing Arrow	EA	4	
652.35	Construction Signs	SF	4,550	
652.3611	Maintenance of Traffic Control Devices	LS	1	
652.411	Portable - Changeable Message Sign	EA	4	
652.45	Truck Mounted Attenuator	CD	75	
652.452	Automated Trailer Mounted Speed Limit Sign	EA	2	
656.50	Baled Hay, in place	EA	70	
656.632	30 inch Temporary Silt Fence	LF	400	
659.100	Mobilization	LS	1	

GENERAL NOTES

- 1. THE CONTRACTOR IS REQUIRED TO CALL DIG SAFE AT 1-888-344-7233, OR WWW.DIGSAFE.COM IN CONFORMANCE WITH ALL SATE AND LOCAL LAWS, ORDINANCES AND STATUTES.
- 2. THE MAINE TURNPIKE AUTHORITY IS A NON-MEMBER UTILITY OPERATOR AND IS NOT REGISTERED WITH DIG SAFE SYSTEM. THE CONTRACTOR SHALL CONTACT ALL NON-MEMBERS THROUGH WWW.OKtoDIG.COM OR AS OTHERWISE REQUIRED BY THE MAINE PUBLIC UTILITIES COMMISSION. ALL PROPOSED EXCAVATION LOCATIONS SHALL BE MARKED AT THE TIME OF NOTIFICATION. NO EXCAVATION SHALL BE PERMITTED UNTIL THE AUTHORITY HAS LOCATED AND MARKED ITS' UNDERGROUND UTILITIES. THE RESIDENT ENGINEER SHALL BE PROVIDED AN ELECTRONIC COPY OF ALL DIG SAFE TICKETS WITHIN 24 HOURS OF THEIR RELEASE FOR PROJECT NOTIFICATIONS AND 3RD PARTY UTILITY LOCATOR COORDINATION.
- 3. THERE ARE NO ANTICIPATED UTILITIES INVOLVED IN THIS CONTRACT.
- 4. CONTRACTOR SHALL PROTECT ALL NEW AND EXISTING UTILITIES FROM DAMAGED DURING THE CONSTRUCTION AS APPROVED BY THE UTILITY OWNERS.
- 3. EXCAVATIONS ACCOMPLISHED AS PART OF THIS PROJECT SHALL BE CONSTRUCTED IN ACCORDANCE WITH OSHA SUBPART P OF 29 CFR PART 1926.650-652 (CONSTRUCTION STANDARDS FOR EXCAVATIONS).
- 4. ALL STANDARD DETAILS SHALL BE IN CONFORMANCE WITH MAINE DEPARTMENT OF TRANSPORTATION (MAINE DOT) STANDARD DETAILS HIGHWAY AND BRIDGES LATEST REVISIONS AND MAINE DOT BEST MANAGEMENT PRACTICES FOR EROSION AND SEDIMENT CONTROL LATEST REVISION UNLESS OTHERWISE INCLUDED IN THESE PLANS.

DRAINAGE NOTES

 NO EXISTING DRAINAGE SHALL BE ABANDONED, REMOVED OR PLUGGED WITHOUT APPROVAL OF THE RESIDENT.

EROSION CONTROL

- 1. ADDITIONAL MEASURES MAY BE PROPOSED BY THE CONTRACTOR DUE TO SITE OR WEATHER CONDITIONS. THE RESIDENT MAY DIRECT THE CONTRACTOR TO IMPLEMENT ADDITIONAL MEASURES, ANY ADDITIONAL MEASURES APPROVED BY THE RESIDENT WILL BE MEASURED FOR PAYMENT.
- 2. ALL TEMPORARY EROSION CONTROL DEVICES SHALL BE INSTALLED IN ACCORDANCE WITH THE MAINE DEPARTMENT OF TRANSPORTATION BEST MANAGEMENT PRACTICES.

Scal	le:			Designed b	y:	_			
	NOT TO SCALE						INE IPIKE		
No.	Revision	Ву	Date						
					By	Date		Ву	Date
				Designed	JRL	01/31/22	Checked	JED	01/31/22
				Drawn	BMB	01/31/22	In Charge of	SRT	01/31/22

MAINE TURNPIKE AUTHORITY
2360 Congress Street
Portland, ME 04102
TEL (207) 871-7771
FAX (207) 879-5567

THE GOLD STAR MEMORIAL HIGHWAY PAVEMENT REHABILITATION

ESTIMATED QUANTITIES AND GENERAL NOTES


SHEET NUMBER: C-1

CONTRACT: 2022.01

K:\Contracts\2022 Construction Project Files\2022.01 Powing 1

DRAINAGE SUMMARY 2022.01

LOCATION	RDWY	BIT. CONC. WATER- WAY TYPE I		PE PIPE - SS III	REBUILI	REBUILD CATCH BASIN TO GRADE - TYPE II TO GRADE		1	EROSION CONTROL BLANKET	BALED HAY IN PLACE	30 inch TEMP. SILT FENCE	CATCH BASIN OUTLETS ON RDWY SLOPE	REMARKS	
ITEM NO.		459.06	603	199		604	<u> </u> .184		604.186	613.319	656.50	656.632		
UNIT		EA	LF	LF	EA	EA	EA	EA	EA	SY	EA	LF.		
STATION			SB	NB	45' LT	9' LT	9' RT	45' RT	0'					
5268+00	SB	1							1	56	5	20	SB	
5286+50	NB	1							1	56	5	20	SB	
5294+07	SB	1							1	56	5	20	NB	
5321+00	NB	1							1	56	5	20	SB	
5354+00	NB/SB		16	16						270	5	60	NB/SB	Sta. 5354+00, 72.4' Lt. to 86.4' Lt. (Mirror NB)
5440+65	SB		16							135	5	60	SB	Sta. 5440+65, 69.6' Lt. to 83.6' Lt.
5429+00	SB	1							1	56	5	20	SB	
5436+50	SB	1							1	56	5	20	NB	
5444+00	SB	1								56	5	20	SB	
5451+00	SB	1							1	56	5	20	SB	
5486+00	NB	1							1	56	5	20	NB	
5507+80	SB	1							1	56	5	20	SB	
5571+00	NB	1								56	5	20	NB	
5577+00	NB	1							1	56	5	20	NB	
TOTALS		12	32	16	0	0	0	0	10	1077	70	360		

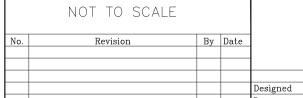

Designed by:

By Date JRL 01/31/22 Checked

BMB 01/31/22 In Charge of SRT 01/31/22

MAINE TURNPIKE AUTHORITY 2360 Congress Street Portland, ME 04102 TEL (207) 871-7771 FAX (207) 879-5567 By Date JED 01/31/22




THE GOLD STAR MEMORIAL HIGHWAY PAVEMENT REHABILITATION

DRAINAGE SUMMARY

SHEET NUMBER: C-2 CONTRACT: 2022.01 3 of 24

Scale:


MTA PROJECT MANAGER: Joseph R. Leavitt, P.E.

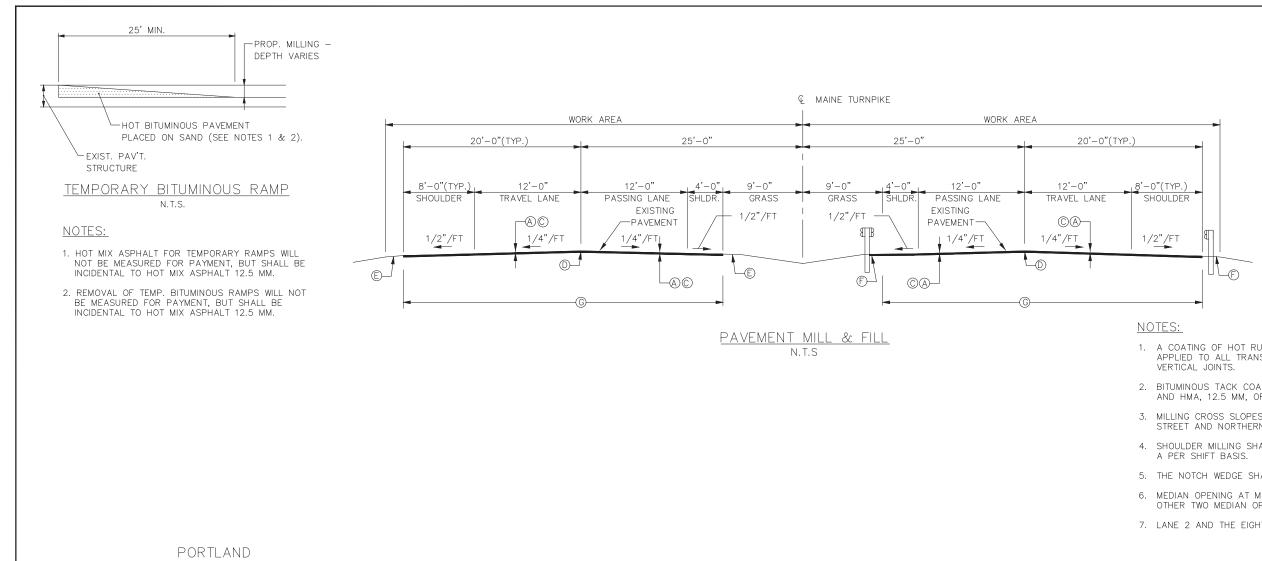





- \triangle = 1 1/2" HOT MIX ASPHALT, 12.5mm NOMIMAL MAXIMUM SIZE
- (B) = MILLING DEPTH ASSUMED TO BE 1" BUT WILL VARY DUE TO CROSS SLOPES
- (C) = MILLING DEPTH VARIES AS CONTROLLED BY CROSS SLOPE AND RUT DEPTHS
- (D) = NOTCHED WEDGE JOINT
- (E) = BERM DROPOFF CORRECTION GRINDINGS (SEE DETAIL A, SHEET P-2)
- \bigcirc = BERM DROPOFF CORRECTION GRINDINGS (SEE DETAIL B, SHEET P-2)
- (G) = LIMIT OF MILL AND FILL(36')

- 1. A COATING OF HOT RUBBERIZED ASPHALT SS-S-140IC SHALL BE APPLIED TO ALL TRANSVERSE BUTT JOINTS AND LONGITUDINAL
- 2. BITUMINOUS TACK COAT IS REQUIRED BETWEEN EXISTING PAVEMENT AND HMA, 12.5 MM, OR SHIM; AND BETWEEN SHIM AND HMA, 12.5 MM.
- 3. MILLING CROSS SLOPES WILL NEED TO TRANSITION TO MEET CENTRAL STREET AND NORTHERN AVENUE.
- 4. SHOULDER MILLING SHALL BE KEPT EVEN WITH THE LANE MILLING ON
- 5. THE NOTCH WEDGE SHALL BE DOUBLE TACKED.
- 6. MEDIAN OPENING AT MM 104.90 SHALL BE MILLED AND PAVED. THE OTHER TWO MEDIAN OPENINGS ARE NOT MILLED AND PAVED.
- 7. LANE 2 AND THE EIGHT FOOT SHOULDER SHALL BE PULLED AS ONE.

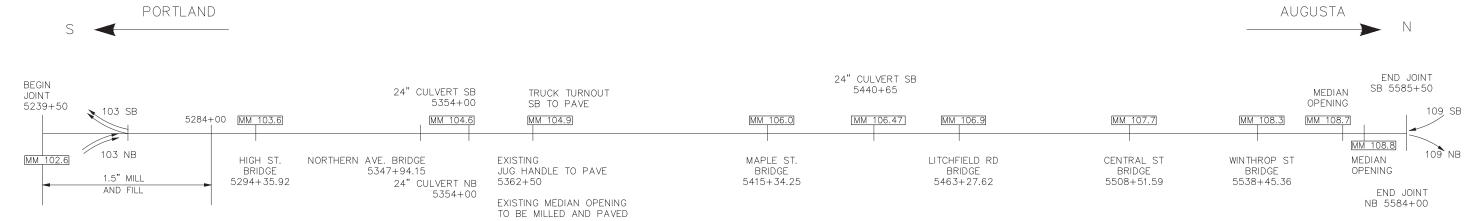

ONE LINE DIAGRAM N.T.S

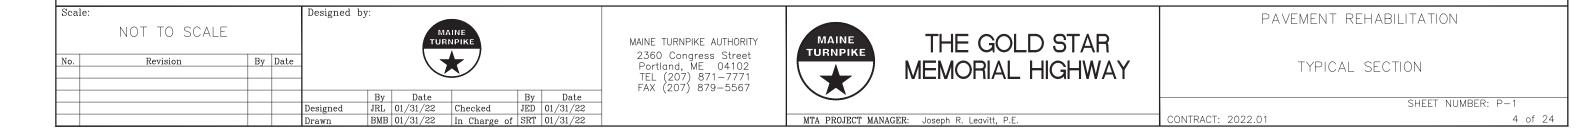

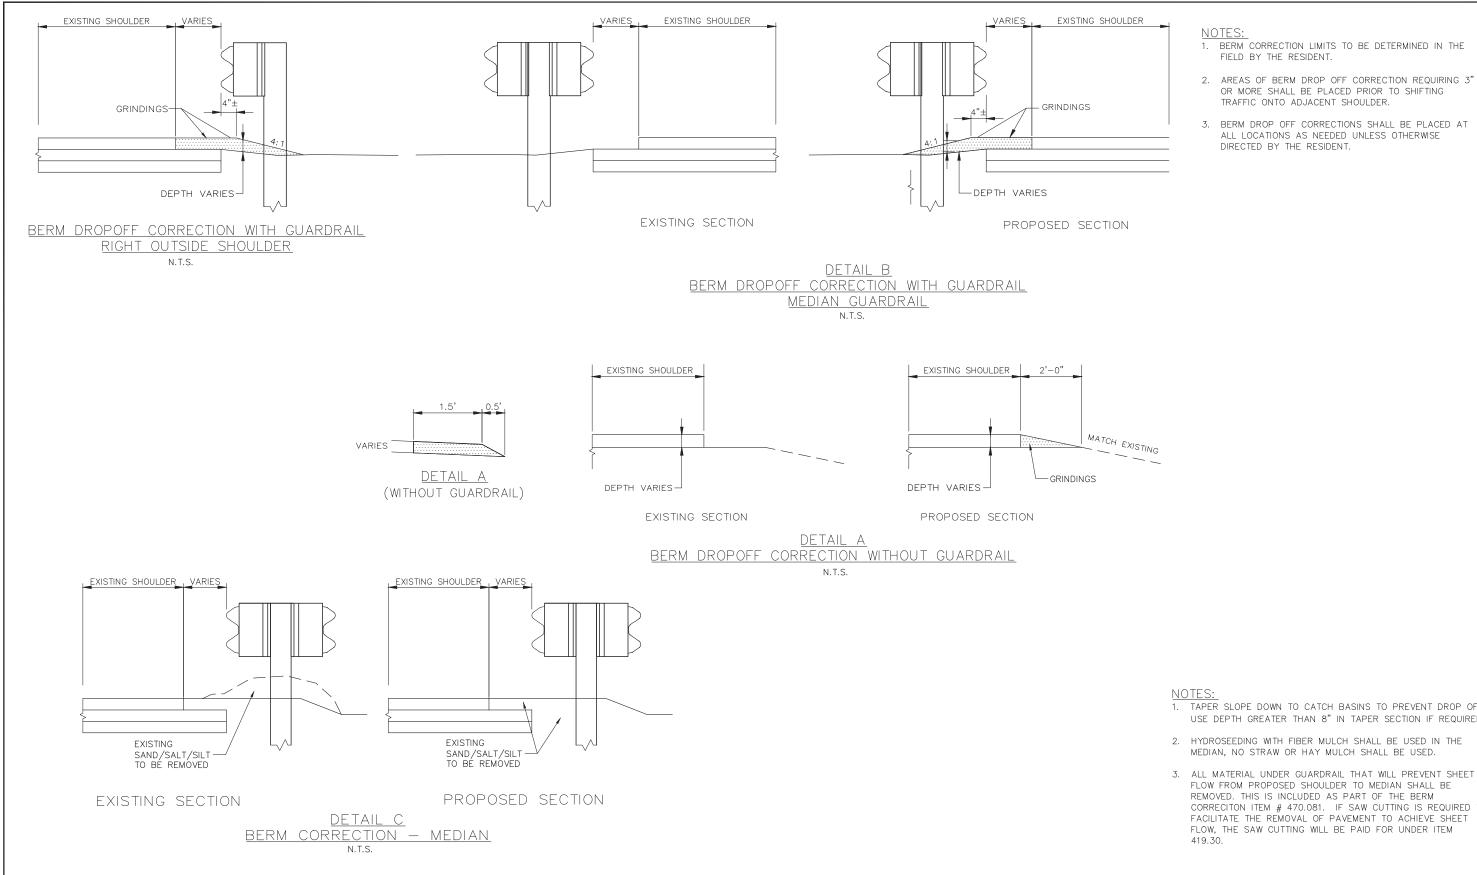

1. TAPER SLOPE DOWN TO CATCH BASINS TO PREVENT DROP OFF. USE DEPTH GREATER THAN 8" IN TAPER SECTION IF REQUIRED.

1. BERM CORRECTION LIMITS TO BE DETERMINED IN THE

OR MORE SHALL BE PLACED PRIOR TO SHIFTING

ALL LOCATIONS AS NEEDED UNLESS OTHERWISE

TRAFFIC ONTO ADJACENT SHOULDER.


FIELD BY THE RESIDENT.

DIRECTED BY THE RESIDENT.

- 2. HYDROSEEDING WITH FIBER MULCH SHALL BE USED IN THE MEDIAN, NO STRAW OR HAY MULCH SHALL BE USED.
- 3. ALL MATERIAL UNDER GUARDRAIL THAT WILL PREVENT SHEET FLOW FROM PROPOSED SHOULDER TO MEDIAN SHALL BE REMOVED. THIS IS INCLUDED AS PART OF THE BERM CORRECITON ITEM # 470.081. IF SAW CUTTING IS REQUIRED TO FACILITATE THE REMOVAL OF PAVEMENT TO ACHIEVE SHEET FLOW, THE SAW CUTTING WILL BE PAID FOR UNDER ITEM 419.30.

SHEET NUMBER: P-2




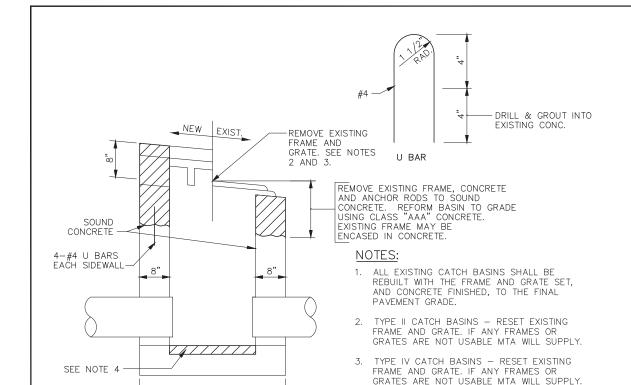


REBUILD CATCH BASIN TO GRADE - TYPE II N.T.S.

4. REMOVE UNSOUND CONCRETE (2" MIN.) AND REPLACE WITH NEW CONCRETE IF DIRECTED


BY THE RESIDENT.

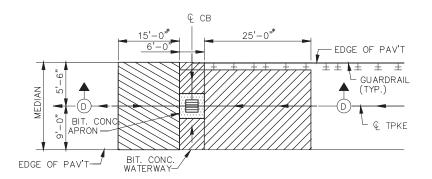


EXIST. CATCH BASIN

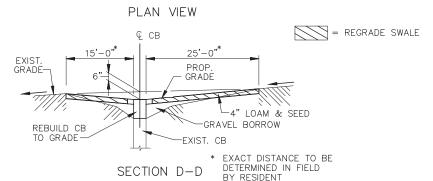


RIM ELEVATION FOR TYPE IV CATCH BASIN

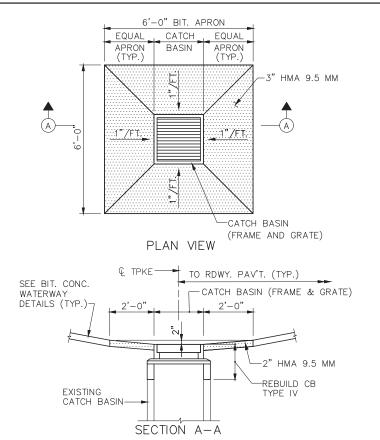


REBUILD CATCH BASIN IN MEDIAN N.T.S.

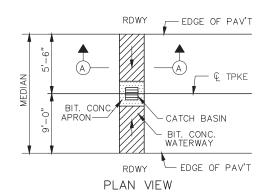

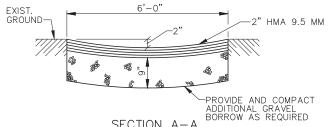

BITUMINOUS CONCRETE WATERWAY, TYPE I

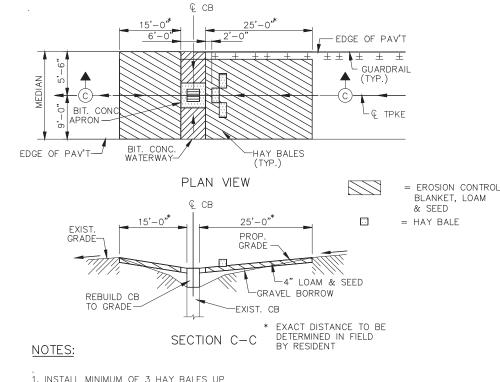

- 1. INSTALL MINIMUM OF 3 HAY BALES UP STREAM.
- 2. THE EXACT LOCATION AND NUMBER OF BALES SHALL BE AS DIRECTED BY THE RESIDENT.

PROPOSED EROSION CONTROL AT MEDIAN N.T.S.



Portland, ME 04102


TEL (207) 871-7771 FAX (207) 879-5567

THE GOLD STAR MEMORIAL HIGHWAY

DRAINAGE DETAILS I

CONTRACT: 2022.01 6 of 24

PAVEMENT REHABILITATION

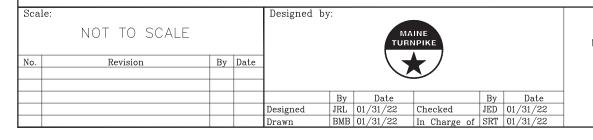

MTA PROJECT MANAGER: Joseph R. Leavitt, P.E.

SHEET NUMBER: P-3

DIMENSIONS FOR SLOPE OF 2:1


D	A (FT)	B (FT)	C (FT)	E (FT)	F (FT)	G (FT)	STONE DEPTH (FT)	STONE (CY)
12"	1.00	4.00	3.00	2.00	6.00	1.00	1.50	1.30
15"	1.00	4.50	3.37	2.25	6.75	1.63	1.50	1.70
18"	1.00	5.00	3.75	2.50	7.50	2.25	1.50	2.09
24"	1.00	6.00	4.50	3.00	9.00	3.50	1.50	3.12
30"	1.00	7.00	5.25	3.50	10.50	4.75	1.50	4.33


DIMENSIONS FOR SLOPE OF 4:1


D	A (FT)	B (FT)	C (FT)	E (FT)	F (FT)	G (FT)	STONE DEPTH (FT)	STONE (CY)
12"	1.00	8.00	6.00	2.00	6.00	0.00	1.50	2.20
15"	1.00	9.00	6.75	2.25	6.75	0.00	1.50	2.80
18"	1.00	10.00	7.50	2.50	7.50	0.00	1.50	3.40
24"	1.00	12.00	9.00	3.00	9.00	0.00	1.50	4.86
30"	1.00	14.00	10.50	3.50	10.50	0.00	1.50	6.58





D	A (FT)	B (FT)	C (FT)	E (FT)	F (FT)	G (FT)	STONE DEPTH (FT)	
12"	0.50	9.00	7.50	1.50	4.50	0.00	1.50	2.30
15"	0.50	10.50	8.75	1.75	5.50	0.00	1.50	2.93
18"	0.50	12.00	10.00	2.00	6.50	0.00	1.50	3.57
24"	0.50	15.00	12.50	2.50	8.00	0.00	1.50	5.44
30"	0.50	18.00	15.00	3.00	9.50	0.00	1.50	7.71

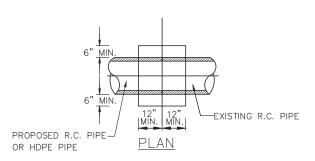

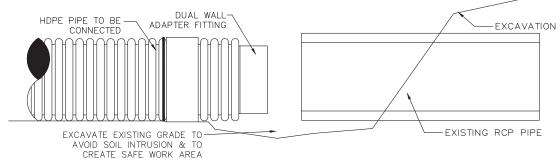


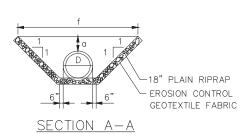


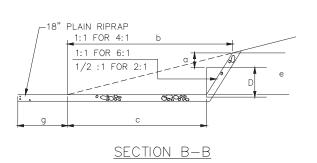

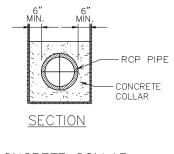



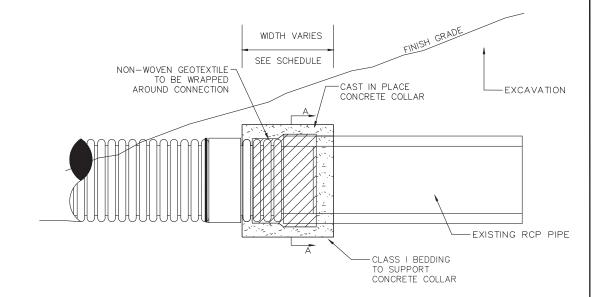

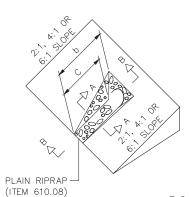

NOTES:

- 1. THE DIMESIONS SHOWN ARE APPROXIMATE AND MAY BE MODIFIED BY THE RESIDENT.
- 2. STONE QUANTITIES ARE FOR ONE END OF THE PIPE.

NOTES:

- 1. CONNECTION AND PIPE TO BE BACKFILLED PER ASTM D2321 (CRUSHED STONE).
- 2. CONCRETE SHALL BE CLASS A FIBER REINFORCED.
- 3. SEE CONCRETE COLLAR WIDTH SCHEDULE FOR DIMENSIONS.
- 4. CONCRETE COLLAR SHALL BE FORMED IN PLACE.

CONCRETE COLLAR WIDTH SCHEDULE	
PIPE DIA. (INCHES) WIDTH OF CONC. (INCHES)	
12 24	
15 24	
18 24	
24 24	
30 30	
36 36	
42 48	
48 48	

ROADWAY CULVERT END SLOPE TREATMENT

Scale:	Designed

	NOT TO SCALE			
No.	Revision	Ву	Date	
				Designe
				Designe Drawn

by:

JRL 01/31/22 Checked JED 01/31/22 BMB 01/31/22 In Charge of SRT 01/31/22 MAINE TURNPIKE AUTHORITY 2360 Congress Street Portland, ME 04102 TEL (207) 871-7771 FAX (207) 879-5567




THE GOLD STAR MEMORIAL HIGHWAY


PAVEMENT REHABILITATION

DRAINAGE DETAILS II

SHEET NUMBER: P-4


CONTRACT: 2022.01

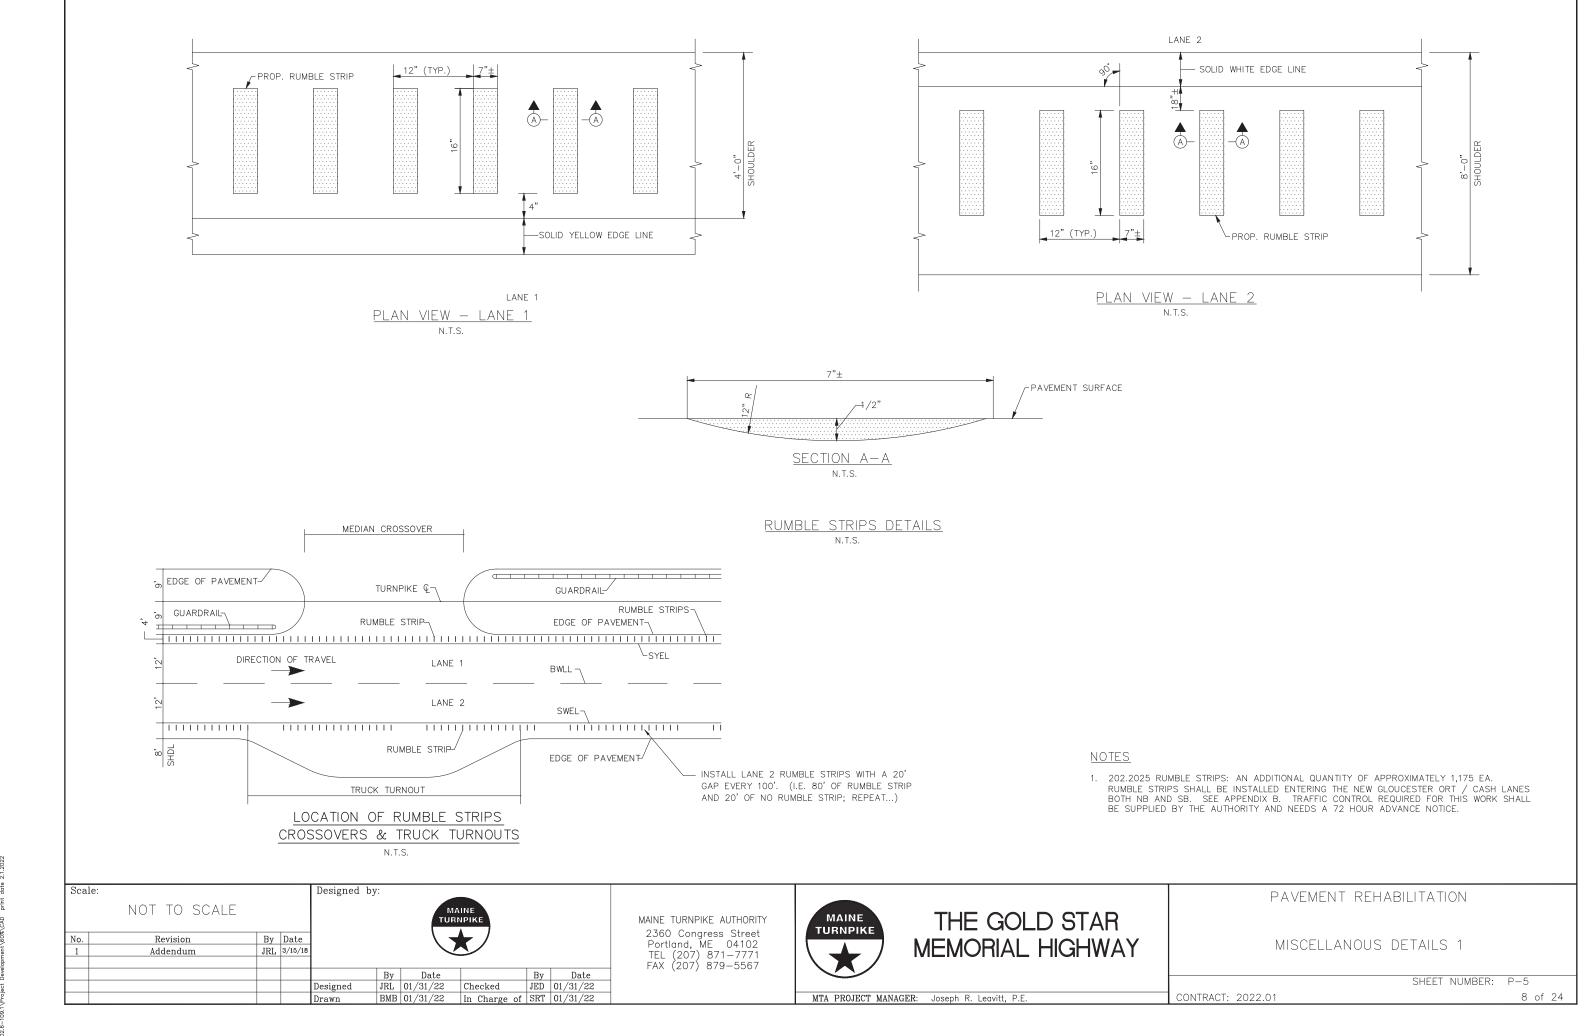

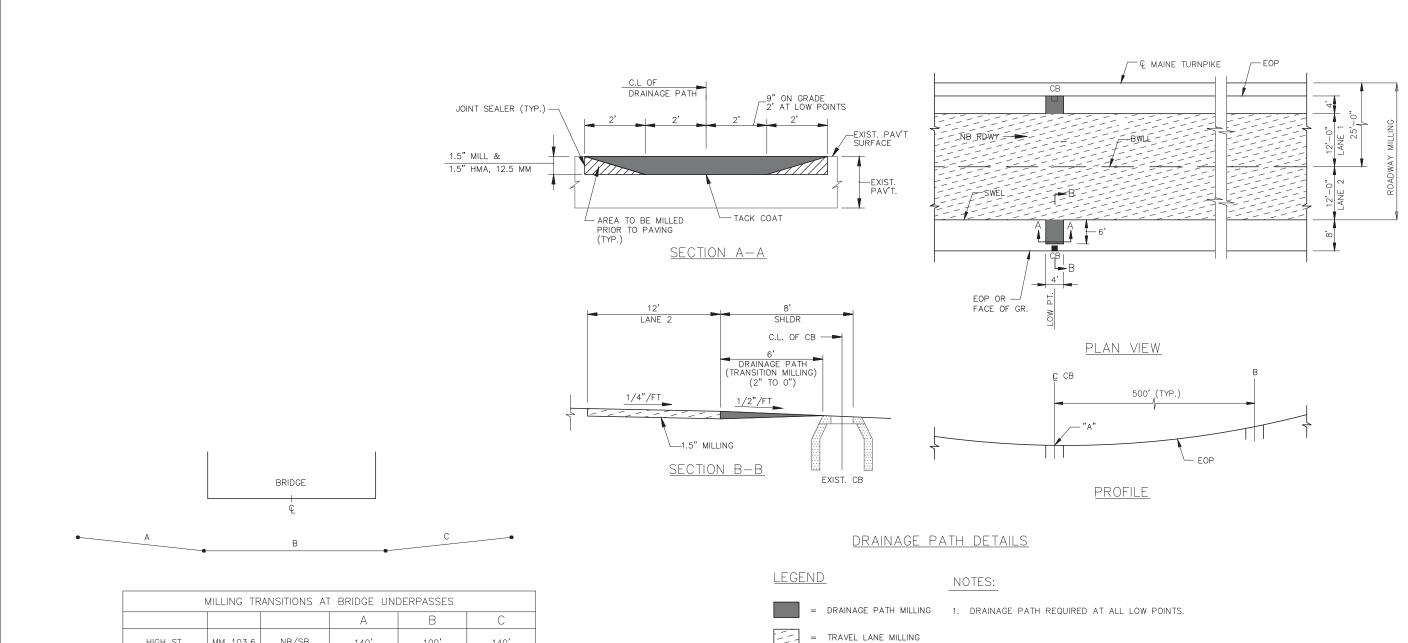

	MILLING TR	ANSITIONS AT	BRIDGE UNI	DERPASSES	
			Α	В	С
HIGH ST.	MM 103.6	NB/SB	140'	100'	140'
MAPLE ST.	MM 106.0	NB/SB	140'	100'	140'
LITCHFIELD RD.	MM 106.9	NB/SB	140'	100'	140'
WINTHROP ST.	MM 108.3	NB/SB	140'	100'	140'

1. PAVEMENT GRADES SHALL NOT CHANGE AT THESE FOUR BRIDGE UNDERPASSES.

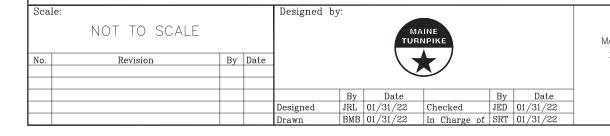


MAINE TURNPIKE MAINE TURNPIKE AUTHORITY 2360 Congress Street Portland, ME 04102 TEL (207) 871-7771 FAX (207) 879-5567

THE GOLD STAR MEMORIAL HIGHWAY PAVEMENT REHABILITATION

MISCELLANEOUS DETAILS II

SHEET NUMBER: P-6 CONTRACT: 2022.01


MTA PROJECT MANAGER: Joseph R. Leavitt, P.E.

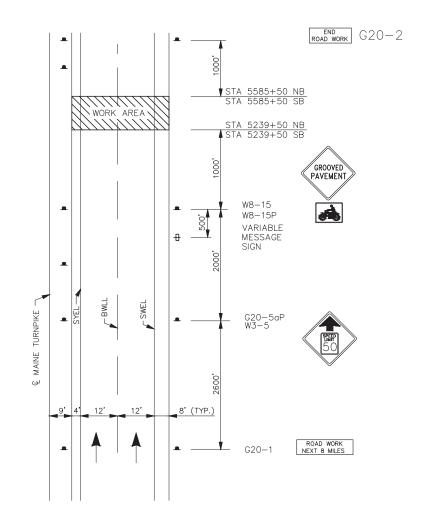

MAINLINE PAVING ADVANCED PROJECT SIGNING

NOTES:

- 1. FOR SIGN DETAILS, SEE SIGN SUMMARY SHEETS.
- 2. ALL SIGNS ARE TO BE MOUNTED ON NCHRP 350 APPROVED POSTS.
- 3. UNCOVER W8-15 AND W8-15P SIGNS WHEN PAVEMENT IS MILLED OR AS DIRECTED BY THE RESIDENT.
- 4. PROVIDE W8-15 AND W8-15P AT ALL MILLED LOCATIONS.

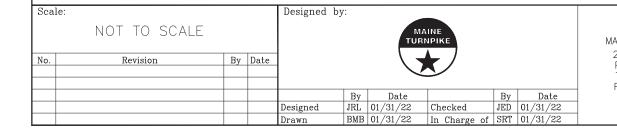

MAINE TURNPIKE MAINE TURNPIKE AUTHORITY 2360 Congress Street Portland, ME 04102 TEL (207) 871-7771 FAX (207) 879-5567





PAVEMENT REHABILITATION CLEAR ZONE IMPROVEMENTS

TRAFFIC CONTROL DETAILS I

SHEET NUMBER: T-1

CONTRACT: 2022.01

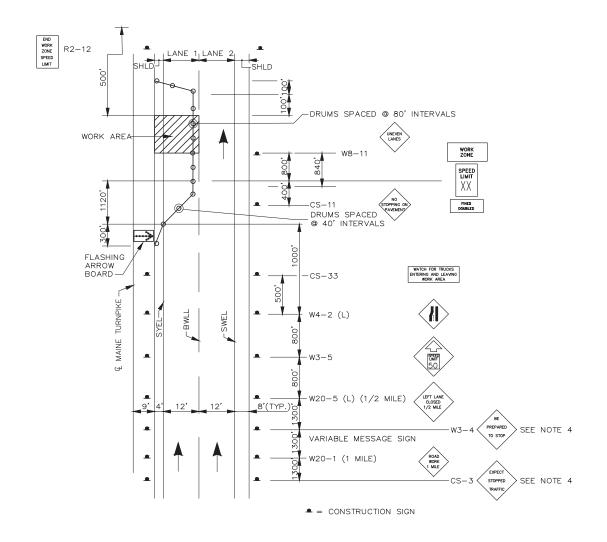

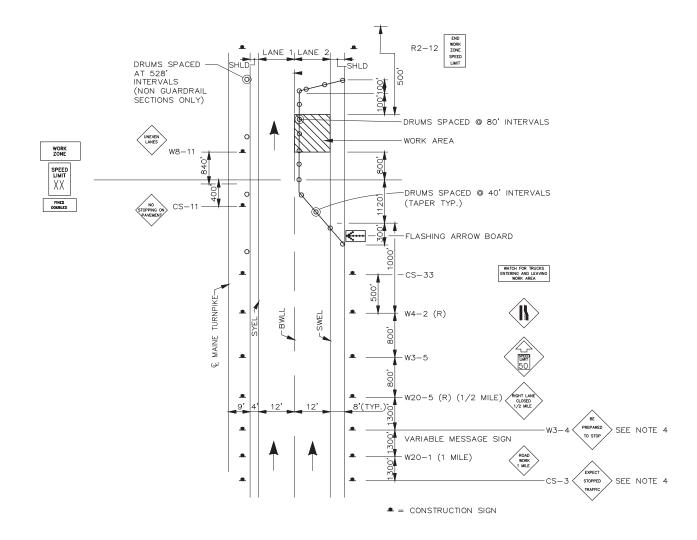

STANDARD SINGLE LANE CLOSURE LANE 2

NOTES:

- 1. FOR SIGN DETAILS, SEE SIGN SUMMARY SHEETS.
- 2. ALL TEMPORARY LANE CLOSURE SIGNS ARE TO BE MOUNTED ON NCHRP 350 APPROVED EASELS.
- 3. STANDARD SINGLE LANE CLOSURE SHALL BE USED FOR ALL OPERATIONS. FOR PAVING, MILLING AND PAVEMENT MARKINGS LANE SHIFT SHALL BE ADDED.
- 4. ERECT CS-3 AND W3-4 SIGNS IMMEDIATELY PRIOR TO SCHEDULED STOPPAGES FOR EQUIPMENT MOVES AND REMOVE THE CS-3 AND W3-4 SIGNS IMMEDIATELY AFTER THE SCHEDULED STOPPAGES ARE COMPLETE.

Scale:				Designed b	y:				
	NOT TO SCALE						INE NPIKE		
No.	Revision	Ву	Date			7			
					By	Date		By	Date
				Designed	JRL	01/31/22	Checked	JED	01/31/22
				Drawn	BMB	01/31/22	In Charge of	SRT	01/31/22

MAINE TURNPIKE AUTHORITY 2360 Congress Street Portland, ME 04102 TEL (207) 871-7771 FAX (207) 879-5567




PAVEMENT REHABILITATION CLEAR ZONE IMPROVEMENTS

TRAFFIC CONTROL LANE CLOSURE DETAILS II


11 of 24

SHEET NUMBER: T-2

CONTRACT: 2022.01

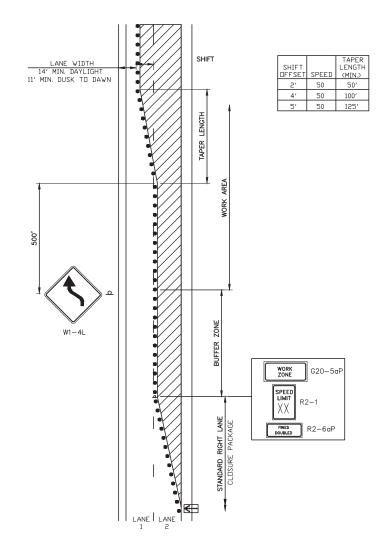



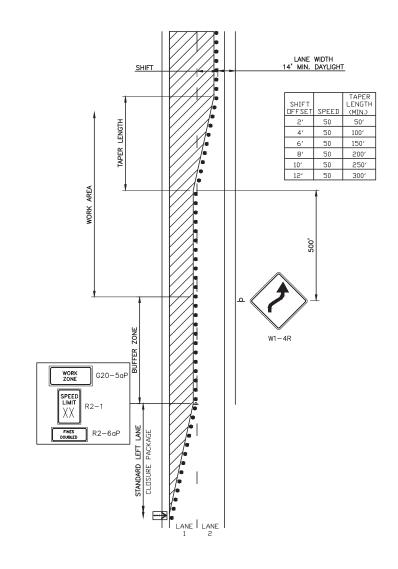

SINGLE LANE CLOUSURE WITH RIGHT LANE
SHIFT ON TO SHOULDER

MAINE TURNPIKE AUTHORITY 2360 Congress Street Portland, ME 04102 TEL (207) 871-7771 FAX (207) 879-5567



PAVEMENT REHABILITATION CLEAR ZONE IMPROVEMENTS

TRAFFIC CONTROL LANE CLOSURE DETAILS III


SHEET NUMBER: T-3


12 of 24

CONTRACT: 2022.01

) 8/9-556/

MTA PROJECT MANAGER: Joseph R. Leavitt, P.E.

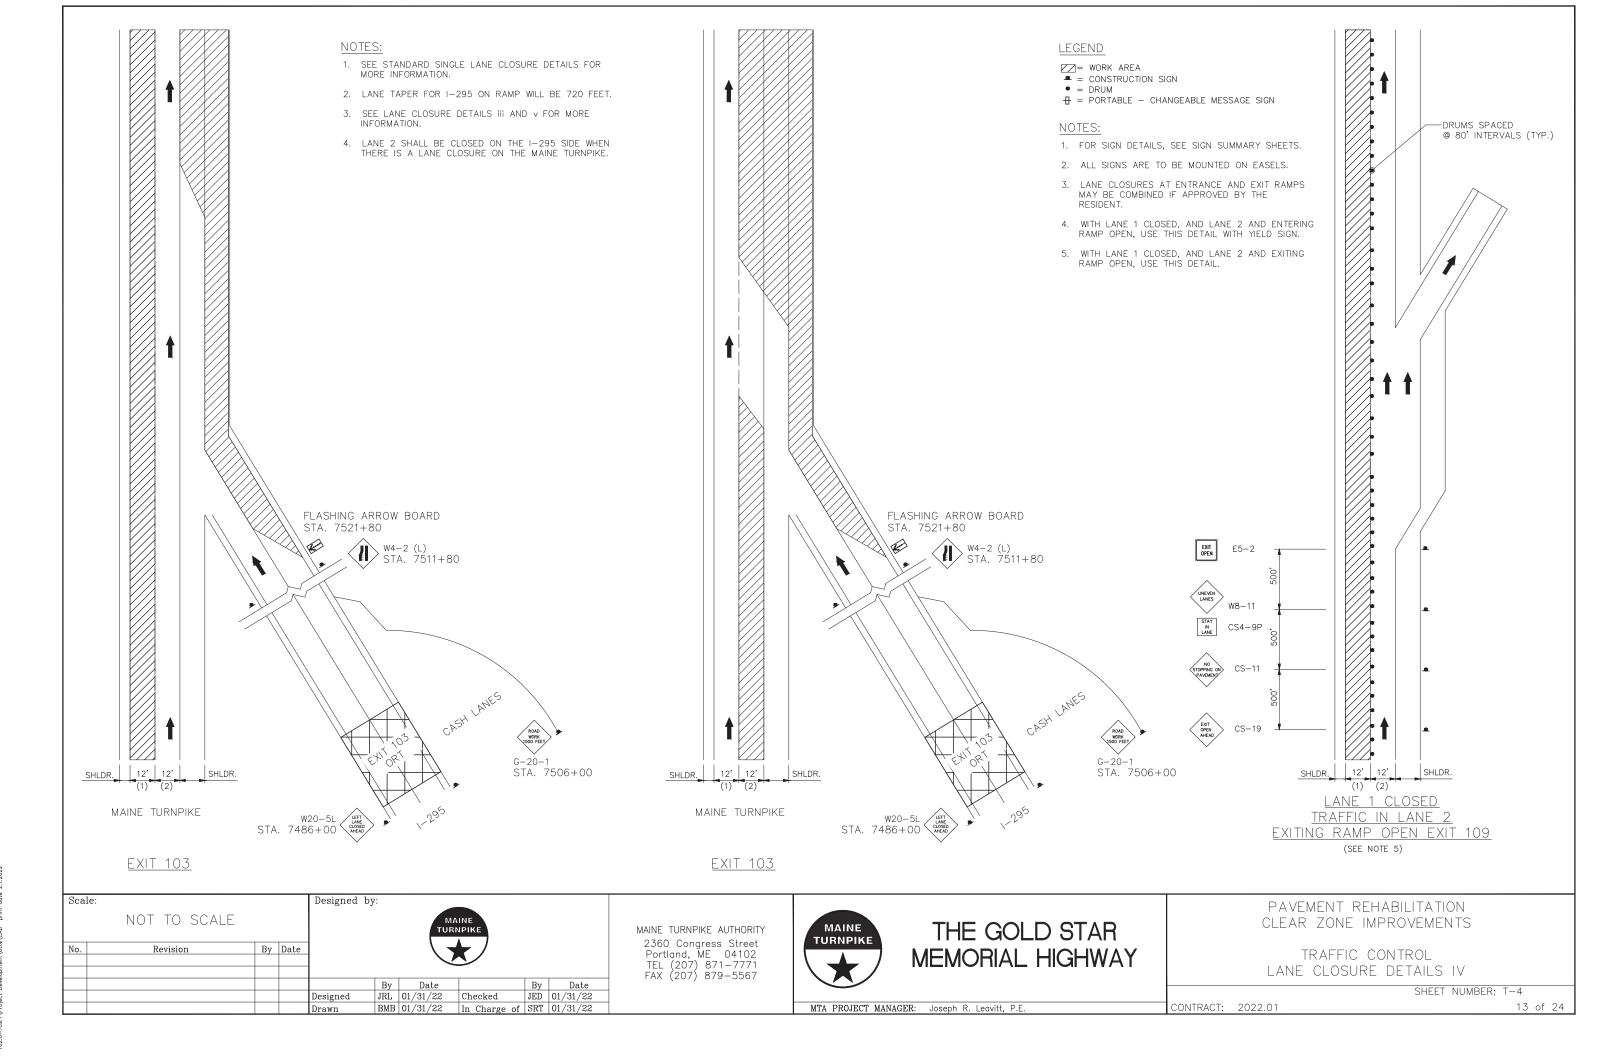

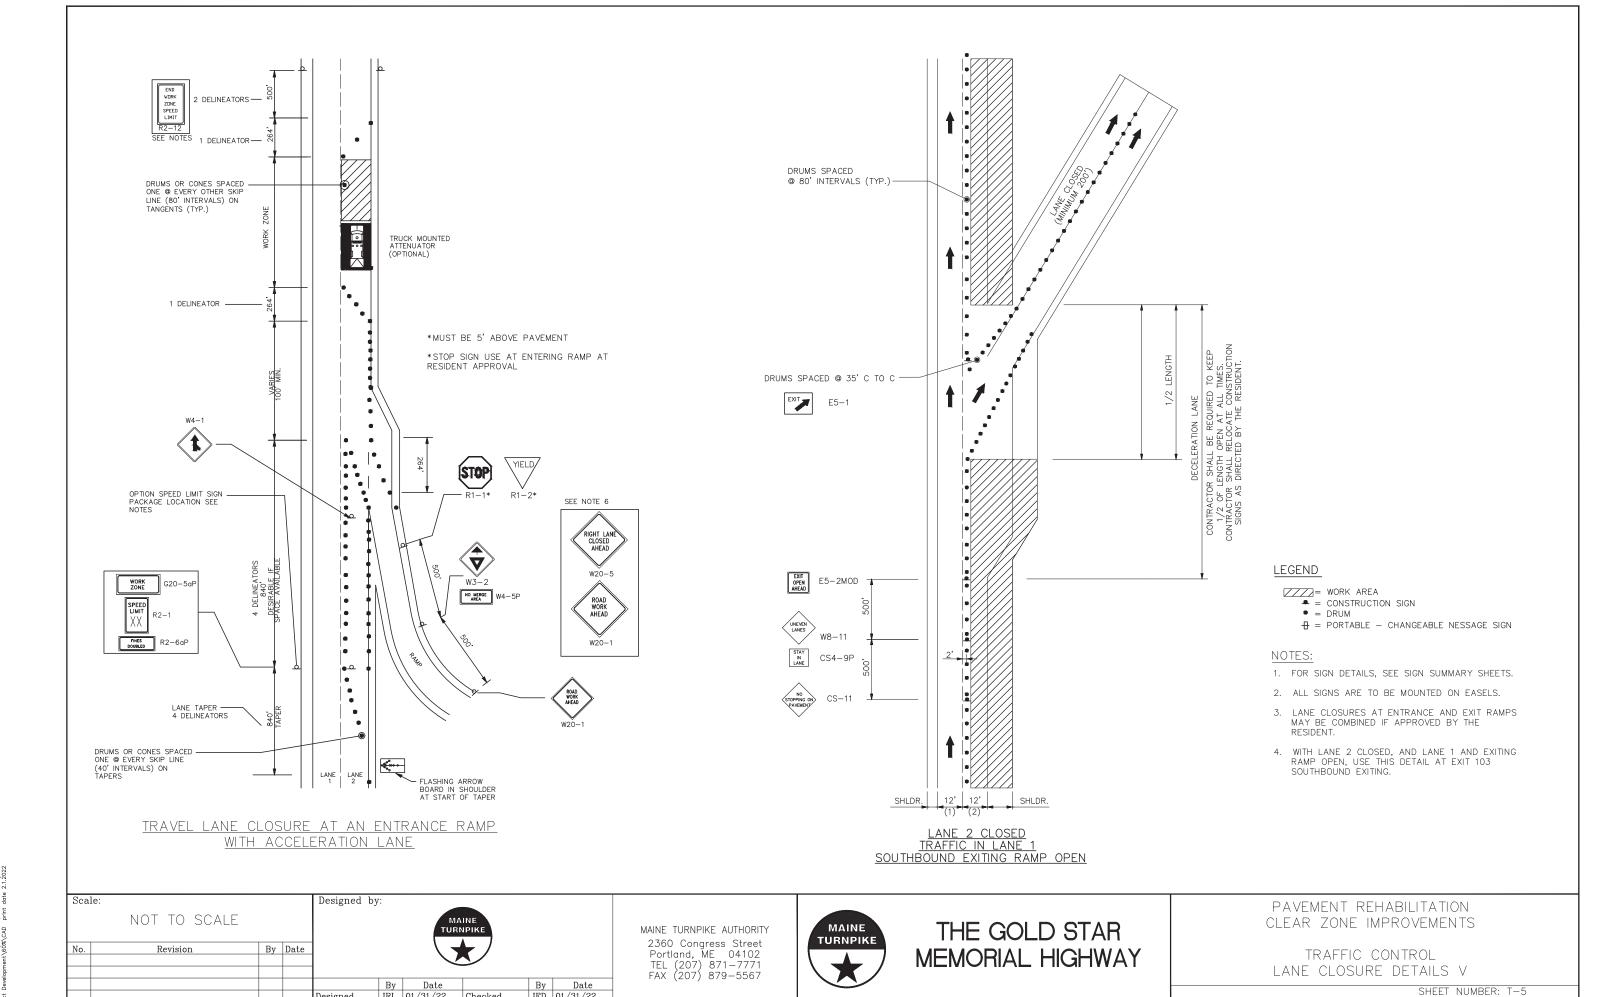

MTA PROJECT MANAGER: Joseph R. Leavitt, P.E.

CONTRACT: 2022.01


14 of 24

JRL 01/31/22 Checked

BMB 01/31/22 In Charge of SRT 01/31/22

Designed

JED 01/31/22

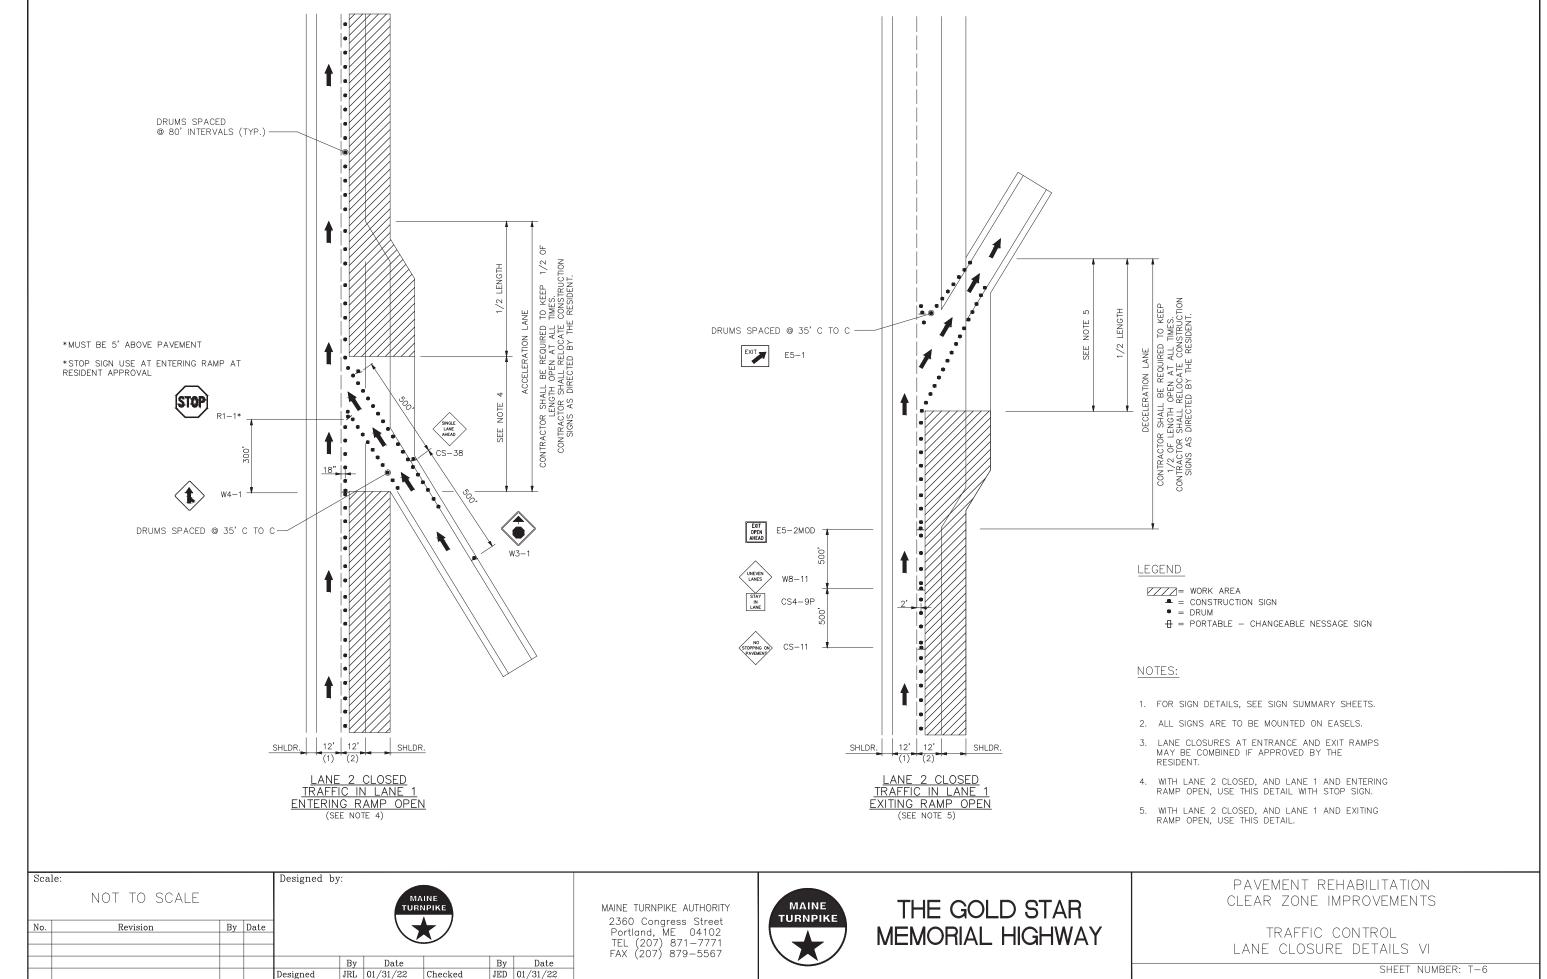

BMB 01/31/22 In Charge of SRT 01/31/22


K: \Contracts\2022 Construction Project Files\2022.01 Paving


CONTRACT: 2022.01

MTA PROJECT MANAGER: Joseph R. Leavitt, P.E.

GENERAL MAINTENANCE OF TRAFFIC NOTES:

- 1. ALL WORK TO CONFORM TO MAINE DEPARTMENT OF TRANSPORTATION STANDARD SPECIFICATIONS FOR HIGHWAY AND BRIDGES 2014 EDITION, EXCEPT AS MODIFIED BY THE MAINE TURNPIKE AUTHORITY'S GENERAL AND SPECIAL PROVISIONS.
- 2. ALL PAVEMENT STRIPING & SIGNING SHALL BE IN ACCORDANCE WITH THE "MANUAL ON UNIFORM TRAFFIC CONTROL DEVICES", U.S.D.O.T., F.H.W.A., LATEST EDITION.
- 3. THESE PLANS SHOW THE GENERAL CONDITION FOR TURNPIKE MAINLINE TRAFFIC CONTROL. DURING CONSTRUCTION, SLIGHT MODIFICATIONS IN CONSTRUCTION PROCEDURE MAY OCCUR AND MAY REQUIRE SOME MINOR ADJUSTMENTS TO BE MADE IN THE FIELD, ALL PROCEDURES MUST BE APPROVED BY THE
- 4. TEMPORARY PAVEMENT MARKINGS SHALL BE PAINTED, UNLESS OTHERWISE NOTED. PAYMENT FOR MARKINGS SHALL BE UNDER ITEM 627.761 TEMPORARY PAVEMENT MARKING LINE, YELLOW OR WHITE.

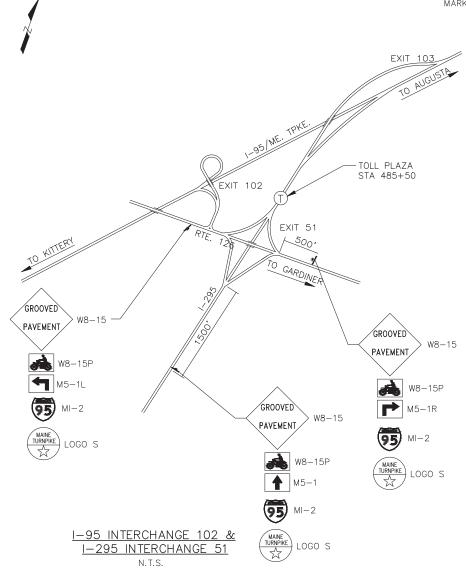

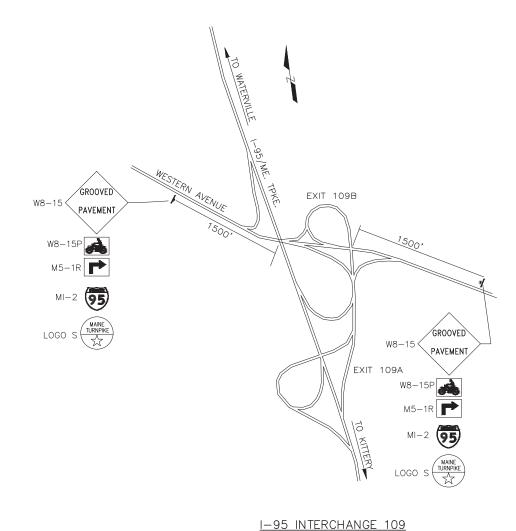

ADVANCED SIGNING LOCATIONS FOR OVERSIZED LOAD RESTRICTIONS

NOTE:

1. ALL SIGNS TO BE MOUNTED ON NCHRP 350 APPROVED POSTS UNLESS BEHIND GUARDRAIL

Scale: Designed by: NOT TO SCALE By Date Revision JRL 01/31/22 Checked JED 01/31/22 Designed BMB 01/31/22 In Charge of SRT 01/31/22

MAINE TURNPIKE AUTHORITY 2360 Congress Street Portland, ME 04102 TEL (207) 871-7771 FAX (207) 879-5567



AND MILLING AND PAVING OPERATIONS

THE GOLD STAR MEMORIAL HIGHWAY

MAINTENANCE OF TRAFFIC NOTES AND MISCELLANEOUS DETAILS VII

PAVEMENT REHABILITATION

CLEAR ZONE IMPROVEMENTS

SHEET NUMBER: T-7

CONTRACT: 2022.01

IDENTIFI- CATION	SIZE 0	F SIGN	TEXT		TEXT I	_				NUMBER OF SIGNS		COL			BOR		AREA IN SQUARE
NUMBER	WIDTH	HEIGHT			TTER GHT		TICAL		ROW MKR.	REQUIRED		CK- OUND	LEG BOR	END DER	RAD	105	FEET
G20-1	48"	24"	ROAD WORK NEXT 8 MILES	CON	TEXT [FORM NDARI 201	TO "2	:004 E HWAY	DITION SIGNS	۱ –	6		NFORM TANDA	N TO	S SHA "2004 IGHWA PPLEM	EDITION Y SIGN		8.00 (48)
G20-2	48"	24"	END ROAD WORK							7							8.00 (56)
G20-5aP	48"	24"	WORK ZONE							32							8.00 (256)
R2-1 (50) (60)	48"	60"	SPEED LIMIT XX							28 8							20.00 (480) (160)
R2-6aP	48"	24"	FINES DOUBLED		6" 6"	4	.5"			28							8.00 (224)
M5-1L	36"	24"		CON	TEXT D FORM ANDARI 201	TO "2	:004 E	DITION SIGNS	۱ –	1							6.00 (6)
M5-1R	36"	24"	P							3							6.00 (18)
M5-1	36"	24"	•							1							6.00 (6)
R1-1	48"	48"	STOP							1	RE	ĒD	w⊢	IITE			16.00 (16)
R1-2	60" 6	0" 60"	YIELD							2	WH	IITE	RE	ĒD			12.50 (25)
R2-12	36"	54"	END WORK ZONE SPEED LIMIT		6" 6" 6" 6" 6"	4. 4.	.5" .5" .5" .5"			8	,		,				13.50 (108)
E5-1	72"	60"	EXIT		NFORM FANDA		'2004 GHWAN	EDITION SIGN	DN - S -	2	GR	EEN	W⊦	HITE			30.00 (60)
CS5-2	60"	48"	EXIT OPEN							2	ORA	NGE	BL	ACK			12.00 (24)
W1 – 4L	48"	48"	(4							16.00 (64)

IDENTIFI- CATION	SIZE C	F SIGN	TEXT		TEXT	_		_		NUMBER OF		LOR		BOR		AREA SQUAF
NUMBER	WIDTH	HEIGHT			TTER IGHT		TICAL CING		ROW MKR.	SIGNS REQUIRED	BACK- GROUND		GEND RDER	RAD	105	FEET
W1-4R	48"	48"		CONF	ORM T NDARD 2012	0 "20	04 ED VAY S	ITION IGNS -		4	CONFORM -STAND	I TO ": ARD HIG		DITION SIGNS		16.00 (64)
W3-1	48"	48"								1	ORANGE	BL	.ACK			16.0 (16)
W3-2a	48"	48"								2	ORANGE	BL	.ACK		ı	16.0 (32)
W3-4	48"	48"	PREPARED TO STOP							8	CONFORM -STAND	I TO ": ARD HIG		DITION SIGNS		16.00 (128
W3-5 (50) (60)	48"	48"	SPEED LIMIT XX							8 4						16.00 (128) (64)
W4-2L	48"	48"								8						16.0 (128
W4-2R	48"	48"								8						16.0 (128
W5-4	48"	48"	LANES							4						16.00 (64)
W8-1	48"	48"	ВИМР							4						16.0 (64
W8-11	48"	48"	UNEVEN							30						16.00 (480


Scale:

NOT TO SCALE

No. Revision By Date

Designed

Designed by:

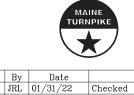

BMB 01/31/22 In Charge of SRT 01/31/22

By Date JED 01/31/22

MAINE TURNPIKE AUTHORITY 2360 Congress Street Portland, ME 04102 TEL (207) 871-7771 FAX (207) 879-5567



THE GOLD STAR MEMORIAL HIGHWAY

PAVEMENT REHABILITATION CLEAR ZONE IMPROVEMENTS

SIGN SUMMARY I

SHEET NUMBER: T-8


MTA PROJECT MANAGER: Joseph R. Leavitt, P.E.

K:\Contracts\2022 Construction Project Files\2022.01 Po 102.6-109.1\Project Development\60%\CAD print date 2

CONTRACT: 2022.01

IDENTIFI-	SIZE O	F SIGN			TEXT	DIMENS	IONS	(INCH	ES)	NUMBER OF		COL	OR		BOR	DER	AREA IN
CATION NUMBER	WIDTH	HEIGHT	TEXT	LET HEI		VERT SPAC	CING	RTE.	ROW MKR.	SIGNS REQUIRED		CK- JUND	BOF	SEND RDER	RAD		SQUARE FEET
W8-15	48"	48"	GROOVED		NFORN ANDA	DIMEN I TO ": RD HIG 012 SUI	2004 HWAY	EDITION SIGN	ON -	11		ONFOR STAND	M TO	RS SHA "2004 HIGHWA UPPLEN	EDIT		16.00 (176)
W8-15P	30"	24"	1							11							5.00 (55)
W20-1 (1 MILE) (AHEAD)	48"	48"	ROAD WORK XXX							18							16.00 (288)
W20-5L (1/2 MILE) (AHEAD)	48"	48"	LEFT LANE CLOSED XXX							8							16.00 (128) (16)
W20-5R 1/2 MILE) (AHEAD)	48"	48"	RIGHT LANE CLOSED XXX							8							16.00 (128) (16)
W21-5aR	48"	48"	RIGHT SHOULDER CLOSED							1							16.00 (16)
W21-5bR 1000 FT)	48"	48"	RIGHT SHOULDER CLOSED 1000 FT							1							16.00 (16)
CS4-9P	36"	48"	STAY IN LANE							30		NGE		ACK			12.00 (360)
W4-1	48"	48"								2	ORA	NGE	BL	ACK			16.00 (32)
CS-38	48"	48"	SINGLE LANE AHEAD							5	ORA	NGE	BL	ACK			16.00 (80)

IDENTIFI-	SIZE 0	F SIGN	TEVE	TEXT I	DIMENSIONS	(INCHES)	NUMBER OF	COL	OR	BORDER	AREA IN
CATION NUMBER	WIDTH	HEIGHT	TEXT	LETTER HEIGHT	VERTICAL SPACING	ARROW RTE. MKR.	SIGNS REQUIRED	BACK- GROUND	LEGEND BORDER	RADIUS	SQUARE FEET
CS-3	48"	48"	EXPECT STOPPED TRAFFIC	6" 6" 6"	4" 4"		8	ORANGE	BLACK		16.00 (128)
CS-11	48"	48"	NO STOPPING ON PAYEMENT	6" 6" 6"	4" 4"		4	ORANGE	BLACK		16.00 (64)
CS-33	96"	36"	WATCH FOR TRUCKS ENTERING AND LEAVING WORK AREA	6" 6" 6"	4" 4"		4	ORANGE	BLACK		24.00 (96)
CS-45	96"	48"	WIDE LOADS OVER 10 FEET PROHIBITED	8" C 8" C 8" C	6" 6" 6"		4	ORANGE	BLACK		32.00 (128)
CS-46	96"	48"	WIDE LOADS OVER 10 FEET MUST EXIT	8" C 8" C 8" C	6" 6" 6"		3	ORANGE	BLACK		32.00 (96)
CS-48	60"	36"	WIDE LOADS	8" D		9"×36" © 0*	3	ORANGE	BLACK		15.00 (45)
CS-52	96"	18"	NORTHBOUND SOUTHBOUND AT EXIT 109A AT EXIT 102 AT EXIT 51	8" C	5" 5"		2 2 1 1	ORANGE	BLACK		12.00 (24) 12.00 (24) 12.00 (12) 12.00 (12) 12.00 (12)
MI-2	24"	24"	95	CONFORM STANDAR	DIMENSIONS TO "2004 RD HIGHWAY 12 SUPPLEM	EDITION — SIGNS —	6	CONFOR -STAND	L COLORS SH/ M TO "2004 ARD HIGHW/ 012 SUPPLEM	EDITION AY SIGNS	4.00 (24)
LOGO S	24"	24"	MAINE TURNPIKE	s	EE DETAILS RIGHT		6	S	SEE DETAILS RIGHT		4.00 (24)
W16-9P	48"	24"	AHEAD	6" 6"	4.5"		2	ORANGE	BLACK		8.00 (16)
G-20-1	48"	48"	ROAD WORK 1500 FEET				1	ORANGE	BLACK		16.00 (16)

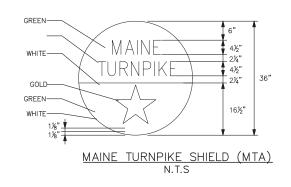

NOTE: FOR 24" SHIELD REDUCE ALL MEASUREMENTS BY 1/3.

Scale:

NOT TO SCALE

By Date Revision

Designed by:

MAINE TURNPIKE AUTHORITY 2360 Congress Street Portland, ME 04102 TEL (207) 871-7771 FAX (207) 879-5567



THE GOLD STAR MEMORIAL HIGHWAY

PAVEMENT REHABILITATION CLEAR ZONE IMPROVEMENTS


SIGN SUMMARY II

SHEET NUMBER: T-9 CONTRACT: 2022.01

By Date JED 01/31/22
 By
 Date

 JRL
 01/31/22
 Checked
 Designed BMB 01/31/22 In Charge of SRT 01/31/22

MTA PROJECT MANAGER: Joseph R. Leavitt, P.E.

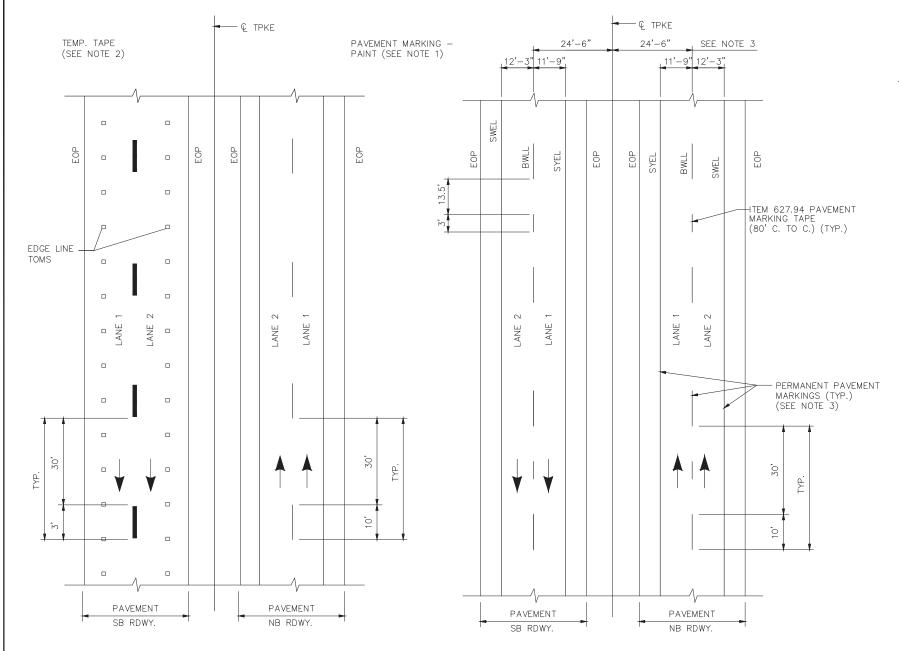

1'-0" BWLL 6" WIDTH

1'-0"

8"

BWLL 6" WIDTH

ITEM 627.94
PERMANENT PAVEMENT
MARKINGS WITH TAPE
GROOVING DETAIL
N.T.S.

NOTE:

 627.941 PAVEMENT MARKING TAPE: AN ADDITIONAL QUANTITY OF APPROXIMATELY 25 LF OF 6" DOTTED LANE LINE SHALL BE INSTALLED DEPARTING THE 103 SB TOLL AREA. LAYOUT DETERMINED BY RESIDENT. TRAFFIC CONTROL REQUIRED FOR THIS WORK SHALL BE SUPPLIED BY THE AUTHORITY AND REQUIRE A 72 HOUR NOTICE.

TEMP. PAVEMENT MARKINGS 2 LANE RDWY

NOTES:

- 1. TEMPORARY PAVEMENT MARKINGS ON MILLED PAVEMENT SHALL BE 6" SOLID WHITE, BROKEN WHITE, AND SOLID YELLOW PAINT LINES.
- 2. TEMPORARY PAVEMENT MARKINGS ON NEW HMA 12.5MM, OR SHIM MATERIAL, SHALL BE TEMPORARY RAISED PAVEMENT MARKERS. "SOLID" WHITE AND "SOLID" YELLOW LANE LINES SHALL BE TEMPORARY RAISED PAVEMENT MARKERS SPACED AT 10'-0" C. TO C. "BROKEN" WHITE LANE LINES SHALL BE PAVEMENT MARKING TAPE, 3' PIECES SHALL BE PLACED AT 40' O.C. AND OFFSET FROM FINAL STRIPING LOCATION.

PERMANENT PAVEMENT MARKINGS 2 LANE RDWY

NOTES:

- 1. PERMANENT PAVEMENT MARKINGS SHALL BE 6" WIDE LINES.
- 2. PERMANENT PAVEMENT MARKINGS SHALL BE INSTALLED ON BOTH ROADWAYS.
- 3. THE OFFSET DISTANCE SHOWN ARE MEASURED FROM THE CENTER OF THE 6" PAINT LINES.

<u>LEGEND</u>

SYEL = SOLID YELLOW EDGE LINE (6" PAINT)

SWEL = SOLID WHITE EDGE LINE (6" PAINT)

BWLL = BROKEN WHITE LANE LINE (6" PAINT)

EOP = EDGE OF PAVEMENT

Scal	le:			Designed by	y:	_			
	NOT TO SCALE						INE IPIKE		
No.	Revision	Ву	Date			7			
					By	Date		By	Date
				Designed	JRL	01/31/22	Checked	JED	01/31/22
				Drawn	BMB	01/31/22	In Charge of	SRT	01/31/22

MAINE TURNPIKE AUTHORITY 2360 Congress Street Portland, ME 04102 TEL (207) 871-7771 FAX (207) 879-5567




MTA PROJECT MANAGER: Joseph R. Leavitt, P.E.

PAVEMENT REHABILITATION CLEAR ZONE IMPROVEMENTS

PAVEMENT MARKING DETAILS I

SHEET NUMBER: T-10

CONTRACT: 2022.01

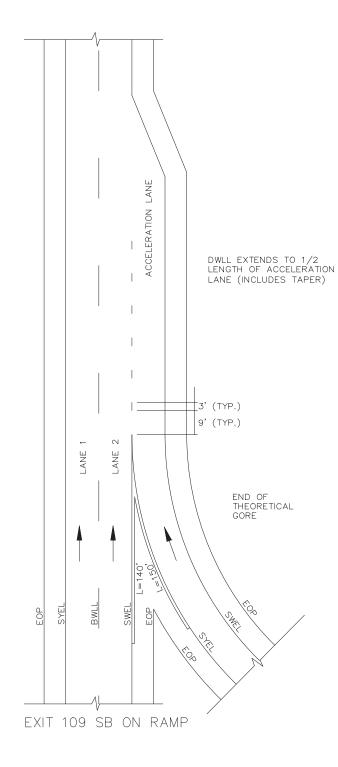

PERMANENT PAVEMENT MARKINGS WITH TAPE (ITEM 627.941 PAVEMENT MARKING TAPE)

LEGEND

SYEL = SOLID YELLOW EDGE LINE (6" PAINT)

SWEL = SOLID WHITE EDGE LINE (6" PAINT)

BWLL = BROKEN WHITE LANE LINE (6" PAINT)

EOP = EDGE OF PAVEMENT

DWLL = DOTTED WHITE LANE LINE (6" GROOVED IN TAPE)

NOTES:

- PERMANENT PAVEMENT MARKINGS SHALL BE 6" WIDE LINES, UNLESS OTHERWISE NOTED.
- 2. PERMANENT PAVEMENT MARKINGS SHALL BE INSTALLED ON BOTH ROADWAYS.
- 3. THE OFFSET DISTANCES SHOWN ARE MEASURED FROM THE CENTER OF THE 6" PAINT LINES.
- 4. ALL EXISTING PAINT MARKINGS SHALL BE REMOVED PRIOR TO INSTALLATION OF ITEM 627.941 PAVEMENT MARKING TAPE AND SHALL BE INCIDENTAL TO INSTALLATION OF THE TAPE.
- 5. ON DECELERATION RAMPS, THE DWLL SHALL BEGIN AT THE BEGINNING OF THE FULL WIDTH DECELERATION LANE AND EXTEND TO THE THEORETICAL GORE MARKINGS.
- 6. ON ACCELERATION RAMPS, THE DWLL SHALL EXTEND FROM THE THEORETICAL FORE MARKINGS TO A POINT ONE—HALF OF THE TOTAL LENGTH OF THE ACCELERATION RAMP. THE ACCELERATION RAMP LENGTH IS THE TOTAL LENGTH OF THE FULL WIDTH LANE AND THE LANE TAPER.

Sca.	le:			Designed by	y:	_			
	NOT TO SCALE						INE NPIKE		
No.	Revision	Ву	Date						
					By	Date		Ву	Date
				Designed	JRL	01/31/22	Checked	JED	01/31/22
				Drawn	BMB	01/31/22	In Charge of	SRT	01/31/22

THE GOLD STAR MEMORIAL HIGHWAY

PAVEMENT REHABILITATION CLEAR ZONE IMPROVEMENTS

PAVEMENT MARKING DETAILS II

SHEET NUMBER: T-11

CONTRACT: 2022.01

SHELL NOWIDEN


racts\2022 Construction Project Files\

MTA PROJECT MANAGER: Joseph R. Leavitt, P.E.


MAINE TURNPIKE AUTHORITY

2360 Congress Street

Portland, ME 04102 TEL (207) 871-7771 FAX (207) 879-5567

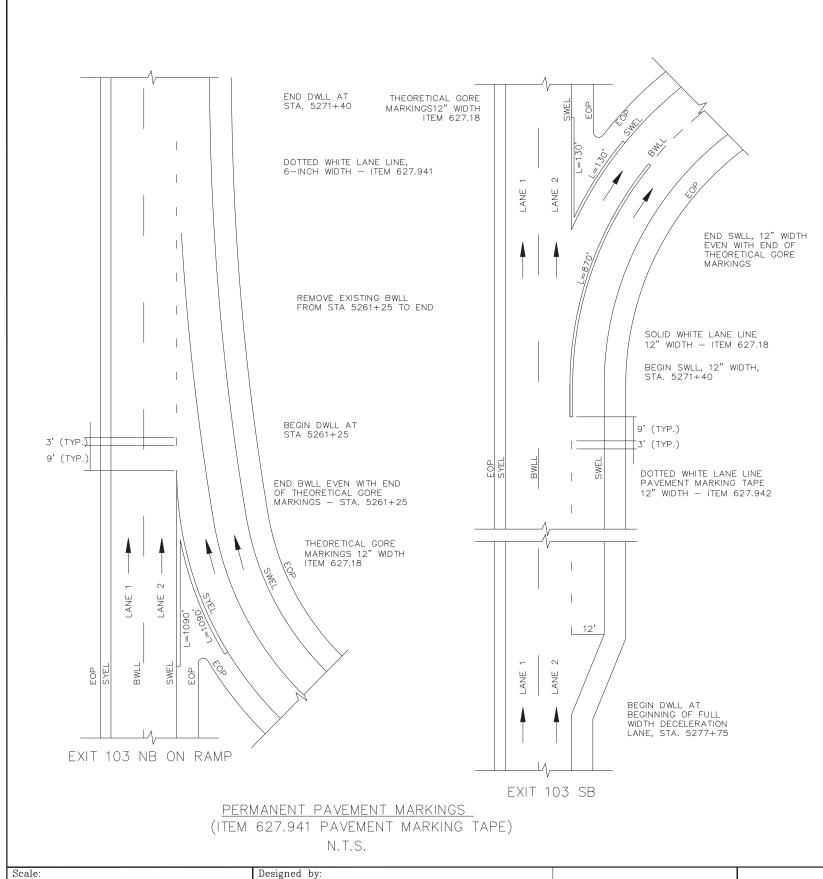



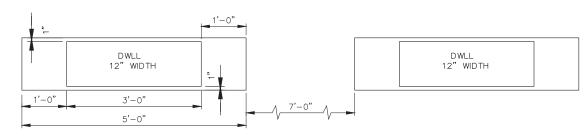

ITEM 627.94 PERMANENT PAVEMENT MARKINGS WITH TAPE GROOVING DETAIL N.T.S.

LEGEND

SYEL = SOLID YELLOW EDGE LINE (6" PAINT)

SWEL = SOLID WHITE EDGE LINE (6" PAINT)

BWLL = BROKEN WHITE LANE LINE (6" PAINT)

EOP = EDGE OF PAVEMENT

DWLL = DOTTED WHITE LANE LINE (6" GROOVED IN TAPE)

NOTES:

- 1. PERMANENT PAVEMENT MARKINGS SHALL BE 6" WIDE LINES, UNLESS OTHERWISE
- 2. PERMANENT PAVEMENT MARKINGS SHALL BE INSTALLED ON BOTH ROADWAYS.
- 3. THE OFFSET DISTANCES SHOWN ARE MEASURED FROM THE CENTER OF THE 6" PAINT LINES.
- 4. ALL EXISTING PAINT MARKINGS SHALL BE REMOVED PRIOR TO INSTALLATION OF ITEM 627.941 PAVEMENT MARKING TAPE AND SHALL BE INCIDENTAL TO INSTALLATION OF THE TAPE.
- 5. ON DECELERATION RAMPS, THE DWLL SHALL BEGIN AT THE BEGINNING OF THE FULL WIDTH DECELERATION LANE AND EXTEND TO THE THEORETICAL GORE MARKINGS.
- 6. ON ACCELERATION RAMPS, THE DWLL SHALL EXTEND FROM THE THEORETICAL GORE MARKINGS TO A POINT ONE—HALF OF THE TOTAL LENGTH OF THE ACCELERATION RAMP. THE ACCELERATION RAMP LENGTH IS THE TOTAL LENGTH OF THE FULL WIDTH LANE AND THE LANE TAPER.
- 7. ITME 627.941 PAVEMENT MARKING TAPE FOR DWLL SHALL BE INSTALLED IN AN "IN-AND-OUT" GROOVING PATTERN. SEE DETAIL THIS SHEET.

NOT TO SCALE No. Revision By Date JRL 01/31/22 Checked JED 01/31/22 Designed BMB 01/31/22 In Charge of SRT 01/31/22

MAINE TURNPIKE AUTHORITY 2360 Congress Street Portland, ME 04102 TEL (207) 871-7771 FAX (207) 879-5567




PAVEMENT REHABILITATION CLEAR ZONE IMPROVEMENTS


PAVEMENT MARKING DETAILS III

SHEET NUMBER: T-12

21 of 24

MTA PROJECT MANAGER: Joseph R. Leavitt, P.E.

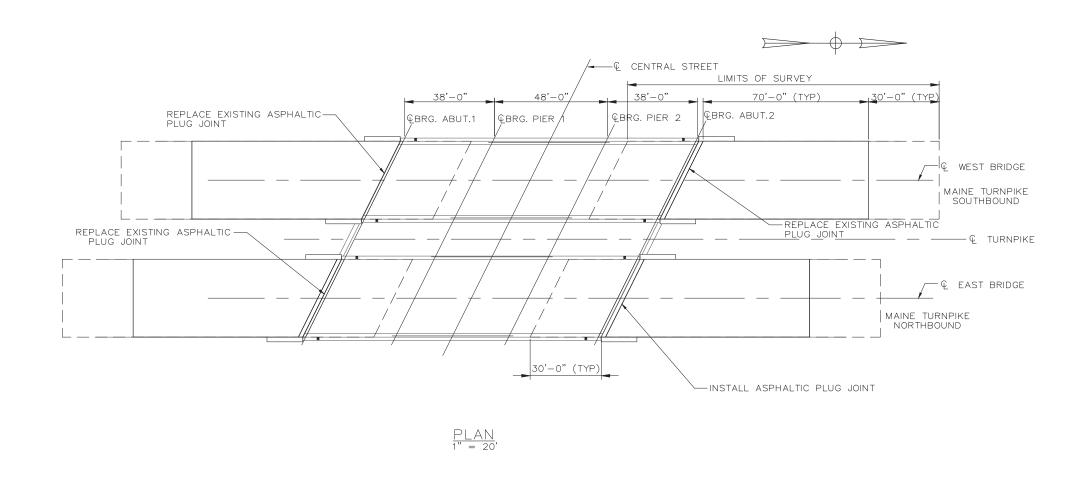

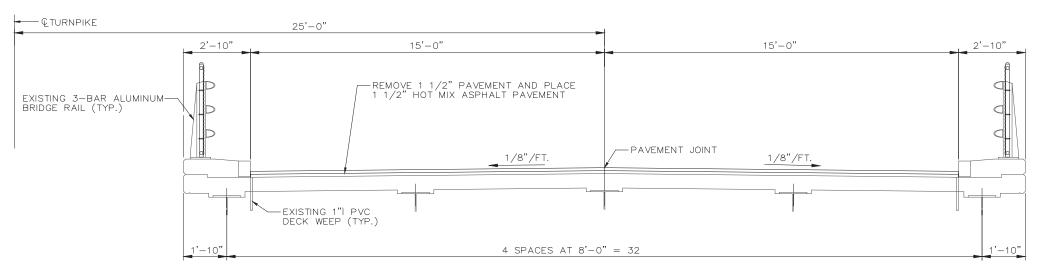

NOTES:

SEAL DECK SHOULDERS OF CENTRAL STREET AND NORTHERN AVENUE WITH TWO APPLICATIONS OF EMULSIFIED BITUMINOUS SEALER PER MDOT STANDARD SPECIFICATION 403.03 e. AFTER COMPLETING ALL DECK PAVING WORK INCIDENTAL

TRANSVERSE SECTION (NORTHBOUND DECK IS SHOWN, SOUTHBOUND DECK IS SIMILAR) 1/2" = 1'-0"

Scal	le:			Designed by	' :				
	NOT TO SCALE						INE IPIKE		
No.	Revision	Ву	Date			7			
					By	Date		Ву	Date
				Designed	JRL	01/31/22	Checked	JED	01/31/22
				Drawn	BMB	01/31/22	In Charge of	SRT	01/31/22

MAINE TURNPIKE AUTHORITY 2360 Congress Street Portland, ME 04102 TEL (207) 871-7771 FAX (207) 879-5567




THE GOLD STAR MEMORIAL HIGHWAY


CENTRAL STREET OVERPASS DECK PLAN AND TYPICAL SECTION

PAVEMENT REHABILITATION CLEAR ZONE IMPROVEMENTS

SHEET NUMBER: S-1

CONTRACT: 2022.01 22 of 24

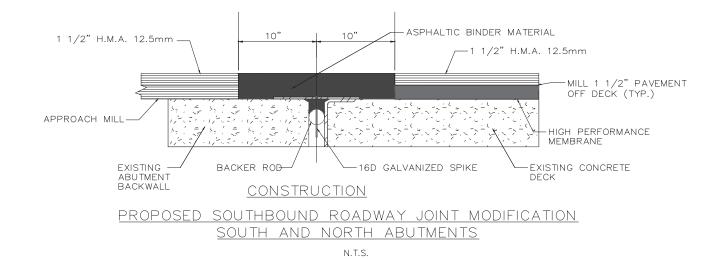

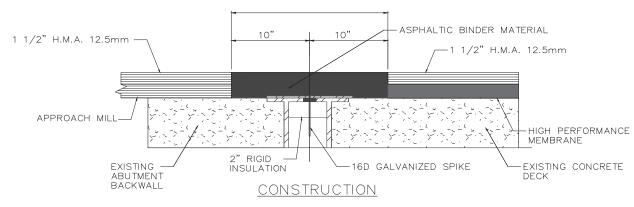

PROPOSED NORTHBOUND ROADWAY JOINT MODIFICATION
SOUTH AND NORTH ABUTMENTS

N.T.S.

NOTES:

- ASPHALTIC PLUG JOINT SYSTEM SHALL BE SUBMITTED FOR APPROVAL AND INSTALLED PER MANUFACTURER'S SPECIFICATIONS. EQUIVALENT JOINT SYSTEMS MAY BE USED WITH APPROVAL OF THE ENGINEER.
- 2. NORTHERN AVENUE BRIDGE JOINTS SHALL RECEIVE A 3/8" WIDE x 1.5" DEEP SAW AND SEAL PAID UNDER ITEM 419.301.

-13	Scale:				Designed by	' :	_	_		
		NOT TO SCALE						INE IPIKE		
	No.	Revision	Ву	Date			/ 4			
\vdash							V	ン		
H						Bv	Date		Bv	Date
Г					Designed	JRL		Checked	JED	01/31/22
					Drawn	BMB	01/31/22	In Charge of	SRT	01/31/22

MAINE TURNPIKE AUTHORITY
2360 Congress Street
Portland, ME 04102
TEL (207) 871-7771
FAX (207) 879-5567



PAVEMENT REHABILITATION
CLEAR ZONE IMPROVEMENTS
CENTRAL STREET OVERPASS
JOINT MODIFICATIONS
NORTHERN AVENUE JOINTS

SHEET NUMBER: S-2

MTA PROJECT MANAGER: Joseph R. Leavitt, P.E. CONTRACT: 2022.01

