# **MAINE TURNPIKE AUTHORITY**

# ADDENDUM NO. 1

# <u>CONTRACT</u> <u>2021.02</u>

WATER LINE AND UTILITY VAULTS MM 47.1, 47.6, AND 48.5

# The bid opening date is changed to June 22, 2021 at 11:00 am.

The following changes are made to the Proposal, Specifications and Plans.

# **GENERAL**

Intentionally left blank.

# **PROPOSAL**

Final Proposal P-sheets are updated and attached. The following Items have been revised based on the below Questions and Answers.

202.12 Remove Existing Structural Concrete; Quantity Increase

603.175 18 Inch Reinforced Concrete Pipe – Class III; Item added.

603.7424 Remove and Relay 24 inch Concrete Pipe: Item removed and made Incidental.

# **SPECIFICATIONS**

- Notice To Contractor
  - Page N-1 is revised to change Bid Opening date. See Attached.
- Special Provision 107.1 Contract Time and Contract Completion Date
  - Page SP-11 is revised to change Substantial Completion Date and All Work Complete Date. See Attached.
- Special Provision 107.4.7 Limitations of Operations
  - Page SP-13 is revised to add two additional notes, l., and m., respectively. See Attached.
- Special Provision 604 Manholes, Inlet, and Catch Basins (Utility Vault Extensions)
  - Page SP-41 is revised under Section 604.03 Construction Requirements to change work and completion date. See Attached.

# PLANS

- Plan sheet 1 Index of Sheets revised to include additional utility vault as-built plans. See attached.
- Plan sheet 2 Estimate of Quantities and General Notes is revised. See attached.
- Plan sheets 11 and 12, Highway Plans are revised for Notes and details of construction adjacent to the waterline at station 2360+02. See attached.
- Plan sheets 14-18, Cross Sections are revised to add dimensions of existing lanes and a construction note for waterline at station 2360+02.
- Plan sheets 19, 20, 23, and 26, Structural Plans are revised to include retaining wall demolition at the Station 2340+52 Utility vault and to remove retaining wall demolition from the Station 2360+02 utility vault. See attached.
- Plan sheets 34-40, As-built Plans, are added to include existing utility vault information. See attached.

# **OUESTIONS**

The following are questions asked at the pre-bid meeting held on June 03, 2021 or submitted to the Maine Turnpike Authority in writing. Answers to the questions are noted. Bidders shall utilize this information in preparing their bid.

- <u>Question 1:</u> There is a drainage manhole adjacent to the Utility Vault at station 2360+02. Does it need to be removed or can we work around it?
  - Answer: The existing 24" RCP and Manhole may be removed and reset to facilitate construction of vault extension. Payment shall be incidental to Utility Vault Extension. The existing 18" CMP over the waterline shall be replaced with 18" RCP if removed to facilitate construction of vault extension. Payment shall be made under Item 603.175.
- <u>Question 2:</u> The plans show a retaining wall to be removed at one utility vault extension but not the other. Do all existing retaining walls need to be removed?
  - <u>Answer:</u> There are retaining walls at the utility vault extension, station 2340+52 northbound and southbound, that shall be removed. See attached structural plans for removal details.

# **ATTACHMENTS**

•	Addendum No. 1	(3 pages)
•	Proposal Sheets	(6 pages)
•	Specifications	(4 pages)
•	Plans	(20 pages)
•	Pre-Bid Agenda	(7 pages)

**Notes:** The above items shall be considered as part of the bid submittal.

The total number of pages included with this addendum is forty pages (40).

All bidders are requested to acknowledge the receipt of the Addendum No. 1 by signing below and faxing this sheet to Nathaniel Carll, Purchasing Department, Maine Turnpike Authority at 207-871-7739. Bidders are also required to acknowledge receipt of this Addendum No. 1 on Page P-8 of the bid package.

**Business Name** 

Print Name and Title

Signature

Date

Very truly yours,

# MAINE TURNPIKE AUTHORITY

Nathaniel Carll Purchasing Department Maine Turnpike Authority

# SCHEDULE OF BID PRICES CONTRACT NO. 2021.02 WATER LINE AND UTILITY VAULTS MM 47.1, MM 47.6, AND MM 48.5

Item No	Item Description	Units	Approx. Quantities	Unit Price in Number		Bid Amount in Numbers	
		Onito	Quantitioo	Dollars	Cents	Dollars	Cents
202.12	Remove Existing Structural Concrete	Cubic Yard	50				†   
203.20	Common Excavation	Cubic Yard	980				   
203.25	Granular Borrow	Cubic Yard	280				   
304.14	Aggregate Base Course - Type A	Cubic Yard	850				   
403.213	Hot Mix Asphalt, 12.50 mm Nominal Maximum Size (Base and Intermediate Base Course)	Ton	80				
409.15	Bituminous Tack Coat RS1 or RS1h - Applied	Gallon	15				   
419.30	Sawing Bituminous Pavement	Linear Foot	450				   
501.231	Dynamic Load Test	Each	2				   
501.40	Steel H-beam Piles, 53 lb/ft, delivered	Linear Foot	865				   
501.401	Steel H-beam Piles, 53 lb/ft, in place	Linear Foot	865				   
501.90	Pile Tips	Each	10				   

	1	i			CONTR	ACT NO: 2021.	02
Item No	Item Description	Units	Approx. Quantities	Unit Prices in Numbers		Bid Amour in Number	
				Dollars	Cents	Dollars	Cents
			•	BROUGHT FOR	WARD:		
501.91	Pile Splices	Each	10				
501.92	Pile Driving Equipment Mobilization	Lump Sum	1				   
511.091	Temporary Earth Support Systems	Lump Sum	1				+
514.06	Curing Box for Concrete Cylinders	Each	1				+   
526.306	Temporary Concrete Barrier, Type I - Supplied by Authority (1,760 LF)	Lump Sum	1				
527.341	Work Zone Crash Cushions - TL-3	Unit	5				+   
603.175	18 inch Reinforced Concrete Pipe - Class III	Linear Foot	37				   
603.195	24 inch Reinforced Concrete Pipe - Class III	Linear Foot	20				   
603.28	Concrete Collar	Each	1				   
603.281	Concrete Collar for Watermain	Each	1				   
604.1581	Utility Vault Extension - STA 2360+02.55 NB	Lump Sum	1				   
604.1582	Utility Vault Extension - STA 2340+52.81 NB	Lump Sum	1				

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ltem No	Item Description	Units	Approx. Quantities	Unit Prices in Number		Bid Amount in Numbers	
				Dollars	Cents	Dollars	Cents
		·	·	BROUGHT FOR	WARD:		
604.1583	Utility Vault Extension - STA 2340+52.81 SB	Lump Sum	1				
606.366	Guardrail, Removed and Reset, Type 3c	Linear Foot	540				
610.08	Plain Riprap	Cubic Yard	11				
610.18	Stone Ditch Protection	Cubic Yard	5				
613.319	Erosion Control Blanket	Square Yard	200				   
615.07	Loam	Cubic Yard	170				   
618.14	Seeding Method Number 2	Unit	15				   
619.1201	Mulch - Plan Quantity	Unit	15				
619.1202	Temporary Mulch	Lump Sum	1				
620.58	Erosion Control Geotextile	Square Yard	54				   
627.712	White or Yellow Pavement Marking Line	Linear Foot	300				
627.73	Temporary 6 inch Pavement Marking Tape	Linear Foot	600				- <del> </del>

					CONTR	ACT NO: 2021.	02
Item No	Item Description	Units	Approx. Quantities	Unit Prices in Numbers		Bid Amour in Number	
				Dollars	Cents	Dollars	Cents
	•			BROUGHT FORW	ARD:		<u>.</u>
629.05	Hand Labor, Straight Time	Hour	15				
631.12	All Purpose Excavator (Including Operator)	Hour	15				
631.172	Truck-Large (Including Operator)	Hour	15				
631.22	Front End Loader (Including Operator)	Hour	15				   
631.36	Foreman	Hour	15				   
652.30	Flashing Arrow	Each	1				
652.312	Type III Barricades	Each	2				
652.33	Drum	Each	110				
652.35	Construction Signs	Square Foot	660				
652.361	Maintenance of Traffic Control Devices	Lump Sum	1				   
652.41	Portable-Changeable Message Sign	Each	2				   
652.45	Truck Mounted Attenuator	Calendar Day	15				   

					CONTR	ACT NO: 2021	.02
Item No	Item Description	Units	Approx. Quantities	Unit Price in Numbe		Bid Amou in Numbe	
				Dollars	Cents	Dollars	Cents
	·		· · · ·	BROUGHT FO	RWARD:		<u> </u>
656.50	Bailed Hay, In Place	Each	15				
656.632	30 Inch Temporary Silt Fence	Linear Foot	900				
659.10	Mobilization (Utility Vaults)	Lump Sum	1				
659.11	Mobilization (Waterline)	Lump Sum	1				
822.3405	8" Class 52 DI Pipe Push On Joint	Linear Foot	10				
822.3605	12" Class 52 DI Pipe Push on Joint	Linear Foot	160				
823.311	12" Gate Valve	Each	2				
823.333	1" Air Release Valve	Each	2				
825.60	12" DR 11 HDPE Pipe	Linear Foot	390				
827.303	Unsuitable Material Below Trench Grade	Cubic Yard	50				
845.211	Stone Pipe Support in Casing - NB, SB, & SB On Ramp	Lump Sum	1				
845.212	Stone Pipe Support in Casing - NB Off Ramp	Lump Sum	1				

ltem No	Item Description	Units	Approx. Quantities	Unit Prices in Numbers		Bid Amount in Numbers					
				Dollars	Cents	Dollars	Cents				
	BROUGHT FORWARD:										
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# MAINE TURNPIKE AUTHORITY

# NOTICE TO CONTRACTORS

Sealed Proposals will be received by the Maine Turnpike Authority for:

# CONTRACT 2021.02

# WATER LINE AND UTILITY VAULTS MM 47.1, MM 47.6, AND MM 48.5

at the office of the Maine Turnpike Authority, 2360 Congress Street, Portland, ME, until 11:00 a.m., prevailing time as determined by the Authority on June 22, 2021 at which time and place the Proposals will be publicly opened and read. Bids will be accepted from Contractors **prequalified** by the Maine Department of Transportation for Highway Construction Projects. All other bids may be rejected. This Project includes a wage determination developed by the State of Maine Department of Labor.

The work consists of constructing utility vault extensions and watermain replacement on the Maine Turnpike in the City of Portland, Maine. The work includes embankment excavation, shoulder gravels and pavement construction, utility vault extension, watermain replacement, guardrail and culvert removal and replacement, maintenance of traffic and all other work incidental thereto in accordance with the Plans and Specifications.

Plans and Contract Documents may be examined by prospective Bidders weekdays between 8:00 a.m. and 4:30 p.m. at the office of the Maine Turnpike Authority, 2360 Congress Street, Portland, Maine. **The half size Plans** and Contract Documents may be obtained from the Authority upon payment of Seventy-Five (\$75.00) Dollars for each set, which payment will not be returned. Checks shall be made payable to: Maine Turnpike Authority. The Plans and Contract Documents may also be downloaded from a link on our website at <a href="http://www.maineturnpike.com/project-and-planning/Construction-Contracts.aspx">http://www.maineturnpike.com/project-and-planning/Construction-Contracts.aspx</a>.

For general information regarding Bidding and Contracting procedures, contact Nate Carll, Purchasing Manager, at (207)482-8115. For information regarding Schedule of Items, plan holders list and bid results, visit our website at <u>http://www.maineturnpike.com/project-and-planning/Construction-Contracts.aspx</u>. For Project specific information, fax all questions to Nate Carll, Purchasing Manager, at (207) 871-7739 or email ncarll@maineturnpike.com. Responses will not be prepared for questions received by telephone. Bidders shall not contact any other Authority staff or Consultants for clarification of Contract provisions, and the Authority will not be responsible for any interpretations so obtained.

All work shall be governed by the Specifications entitled "State of Maine, Department of Transportation, Standard Specifications, Revision of November 2014", "Standard Details, Revision of November 2014" and "Best Management Practices for Erosion and Sediment Control", latest issue. Copies and recent updates to these publications can be downloaded at: <u>http://www.maine.gov/mdot/contractors/publications/</u>.

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maintained during and following construction in accordance with MTA's Supplemental Specification Section 656.

The Project is subject to all general, special, and project-specific conditions contained in the DEP and U.S. Army Corps of Engineers Permits. Copies of the permits will be provided to the Contractor. The Contractor shall comply with the conditions outlined in the U.S. Army Corps of Engineers and DEP permits. The Contractor shall indemnify and hold harmless the Maine Turnpike Authority or its agents, representatives and employees against any and all claims, liabilities or fines arising from or based on the violation of the above noted permits.

## 107.1 Contract Time and Contract Completion Date

This Subsection is amended by the addition of the following:

All work shall be complete on or before December 17, 2021. The construction shall be substantially complete by December 10, 2021.

# 107.1.1 Substantial Completion

This Subsection is amended by the addition of the following:

Substantially complete shall be defined by the Authority as the following:

- All utility vault extensions complete and normal operation of the contained watermain is restored.
- All watermain casing extension and watermain replacement complete and normal operation of the watermain is restored.
- All shoulder pavement is completed.
- All temporary traffic control, including temporary concrete barrier, is removed from the Turnpike.
- All culverts and stormwater drainage systems have been restored to their pre-construction operation.
- All disturbed slopes loamed, seeded, and mulched, and temporary erosion control installed where necessary.

Supplemental Liquidated damages on a calendar day basis in accordance with Subsection 107.8 shall be assessed for each calendar day that any substantial completion is not achieved and as outlined above in this Subsection and below in Subsection 107.4.6 Prosecution of Work.

# 107.4.6 Prosecution of Work

The following activities must be completed by or within the date(s) specified:

a. No tree cutting shall occur between June 1 and July 31.

they shall be removed prior to the material exiting the basin into a waterway. Removal shall be completed to the satisfaction of the Resident and payment shall be incidental to the Contract.

- i. There shall be no pile driving during non-daylight hours. Pile driving will not be allowed within 10 feet of traffic.
- j. Lane closures, ramp closures, shoulder closures, and stoppages of all kinds are prohibited during an Interstate 295 closure for MaineDOT project WIN 21745, Interstate 295 over Veranda Street. The planned I-295 Closure, and weather alternate, is tentatively scheduled for either: the period Noon October 22, 2021 thru Noon October 25, 2021 with an alternate weather period of Noon October 29, 2021 thru Noon November 1, 2021, OR Noon April 15, 2022 thru Noon April 18, 2022, with an alternate weather period of Noon April 25, 2022.
- k. The Contractor shall maintain existing drainage during construction as needed for temporary use and as identified on the plans. This includes, but not limited to, making temporary pipe connections, grading temporary ditch, or bypass pumping of stormwater. Payment for temporary stormwater and ditch drainage shall be incidental to the Contract and no additional payment will be made for required labor, fittings, seals, etc. Payment for final ditch grading shall be paid for under the applicable Bid Items.
- 1. On-site work shall not start until August 10, 2021
- m. The contractor is responsible for protecting the water lines from freezing and freezing temperatures of 32 degrees or lower.

# SPECIAL PROVISION

# SECTION 604

## MANHOLES, INLETS, AND CATCH BASINS

## (Utility Vault Extensions)

#### 604.01 Description

The following sentences are added:

This work shall also include the partial demolition of the existing utility vaults and manholes and construction of the utility vault extensions as shown on the Contract Plans. This work shall also include developing and submitting for approval, a construction procedure, temporary water main support system, and temporary earth support to protect the water main, and coordination with Portland Water District as described in the Contract Plans and these Specifications. This work also includes the installation of new manholes as Manufactured by Neenah Foundry Company, Catalog Number R-6660-NH.

#### 604.02 Materials

The following sentence is added:

Except as otherwise provided on the plans, reinforcing steel shall be epoxy coated reinforcing bars meeting the requirements of Section 503 – Reinforcing Steel. All concrete work shall be in accordance with the requirements of Section 502 – Structural Concrete.

#### 604.03 Construction Requirements


The following sentences are added:

The Contractor shall develop a construction procedure, temporary water main support, and temporary support systems that will protect, at all times, the 42" Cast Iron Pipe (1912, leaded joint) – at station 2360+02.55 and the 42" Reinforced Concrete Cylinder Pipe (1931, rubber and steel joint) – at station 2340+50.81, during construction of the tunnel extensions. Each water main will be removed from service by Portland Water District (PWD) during the work by closing valves on each side of the work area.

The Contractor is required to fully complete the work on one utility vault before work can begin on the other utility vault. Water mains can be removed from service between April 15<sup>th</sup> and December 10<sup>th</sup> and all work shall be completed within those dates. Winter shut offs are not permitted.

The maximum pipe support spacing shall be 6' along the pipeline. The temporary watermain support system and temporary earth support shall be designed by a professional engineer licensed in the State of Maine and reviewed by the Resident Engineer and PWD prior to the start of construction.

SP - 41 (Revised 6/11/2021)

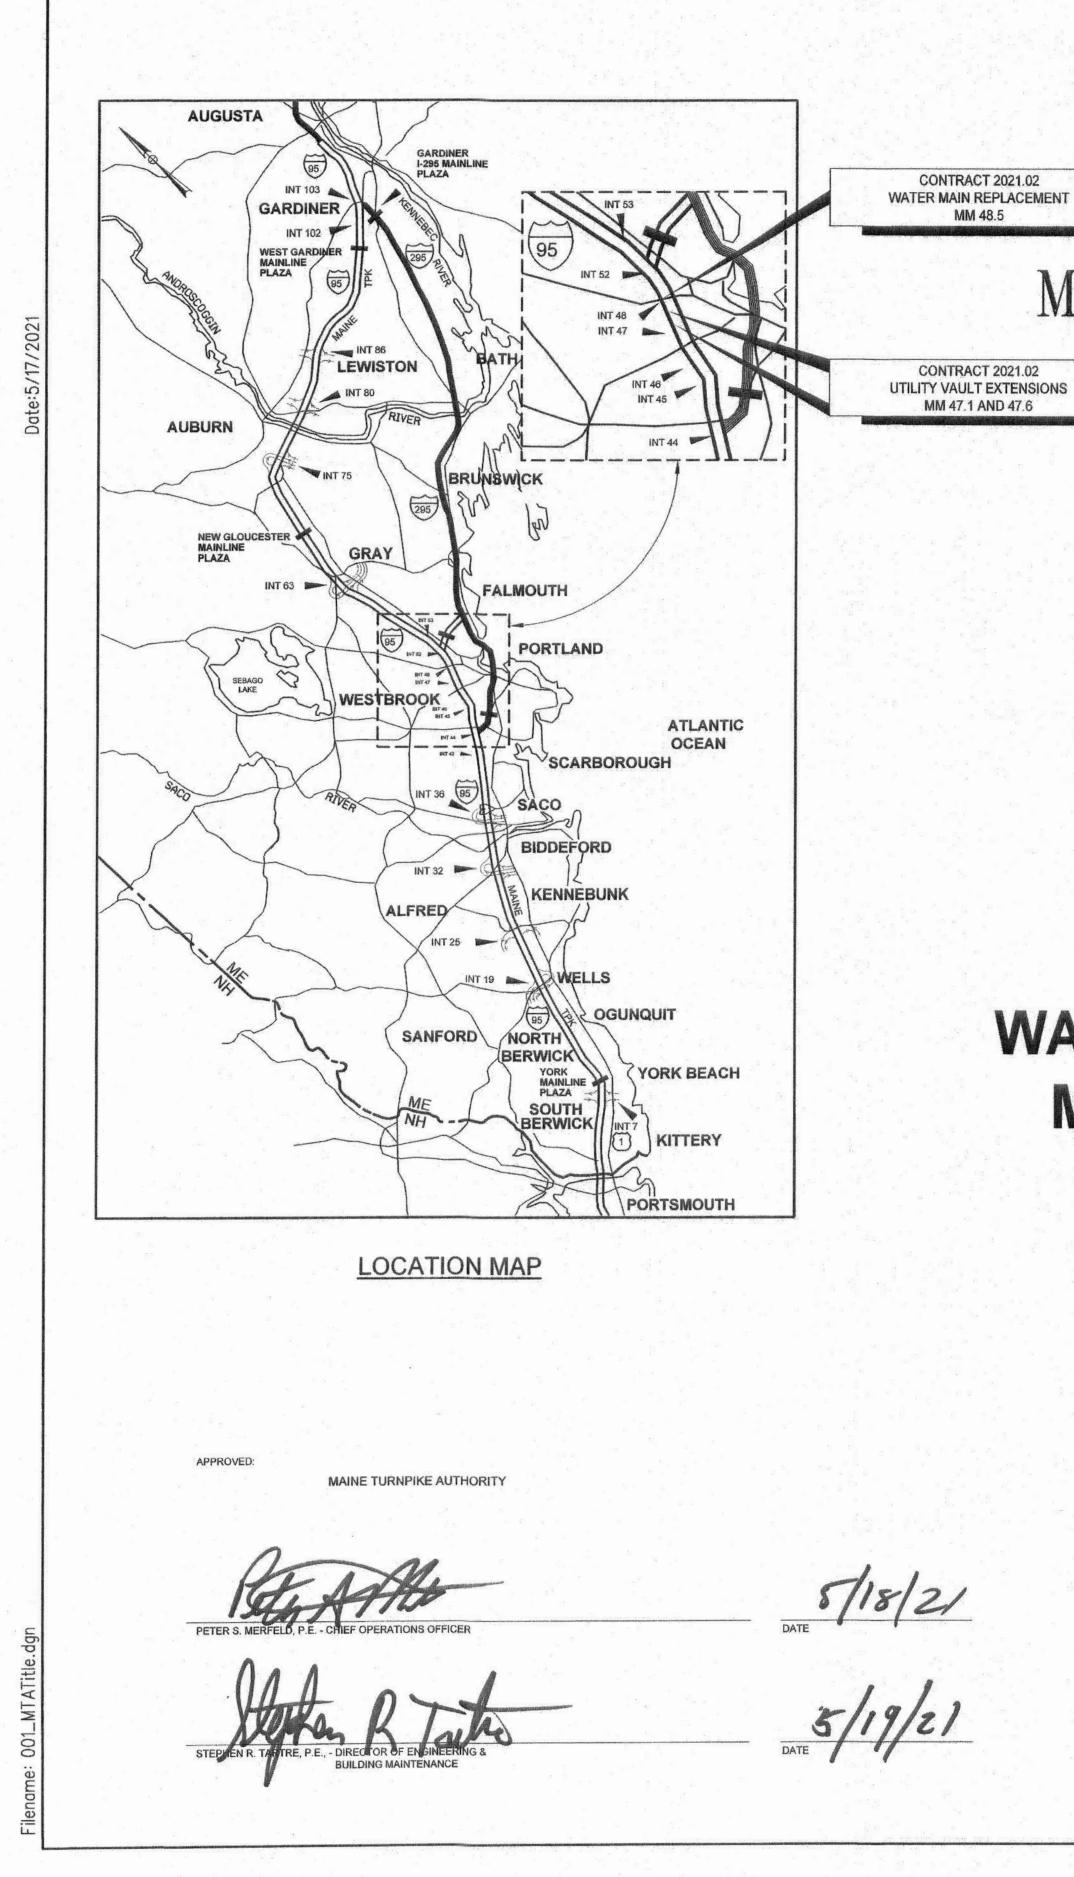



THE GOLD STAR **MEMORIAL HIGHWAY** 

# MAINE TURNPIKE AUTHORITY

DANIEL E. WATHEN, CHAIR ROBERT D. STONE, VICE CHAIR MICHAEL J. CIANCHETTE, MEMBER ANN R. ROBINSON, MEMBER THOMAS J. ZUKE, MEMBER JANE LINCOLN, MEMBER BRUCE VAN NOTE, MEMBER EX-OFFICIO

S. PETER MILLS, EXECUTIVE DIRECTOR

# **CONTRACT: 2021.02** WATER LINE AND UTILITY VAULTS MM 47.1, MM 47.6 AND MM 48.5

# **INDEX OF SHEETS**

#### **DESCRIPTION** SHEET NO.

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1 2 3 4-10 11-12	TITLE SHEET ESTIMATE OF QUANTITIES AND GENERAL NOTES TYPICAL SECTIONS MAINTENANCE OF TRAFFIC HIGHWAY PLANS
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4-10	MAINTENANCE OF TRAFFIC
11-12	HIGHWAY PLANS
13	LIMIT OF DISTURBANCE
14-18	CROSS SECTIONS
19-30	UTILITY VAULT EXTENSION STRUCTURAL PLANS
31-33_	WATER MAIN REPLACEMENT - PWD
( '34 <u>'</u> 40)	CONTRACT 2001.01 RAND ROAD RETAINING WALL
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# .02 2021 E 4 A R CON HNTB TIMOTHY R. COTE No. 10671 5/24/2021

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				CONSULTANT			Dale A. Mitchell, F			
				Designed	By DAM	Date 04/21	Checked F	By RWH	Da 047	

# GUARDRAIL NOTES:

- AT THE END OF EACH WORK DAY. THE CONTRACTOR IS REQUIRED TO HAVE AN APPROVED CRASHWORTHY END TREATMENT ON ALL GUARDRAIL ITEMS, UNLESS NOTED OTHERWISE.
- CONNECTIONS FOR PROPOSED GUARDRAIL TO EXISTING GUARDRAIL SHALL BE INCIDENTAL 2. TO THE PROPOSED GUARDRAIL ITEMS, UNLESS OTHERWISE NOTED.
- 3. ALL GUARDRAIL SHALL BE INSTALLED IN A MANNER TO AVOID DRAINAGE STRUCTURES AND ELECTRICAL CONDUITS.
- 4. HOLES CREATED BY GUARDRAIL REMOVAL WILL BE FILLED AND COMPACTED WITH APPROVED MATERIALS AS DIRECTED BY THE RESIDENT. PAYMENT TO BE INCIDENTAL TO THE GUARDRAIL ITEMS.

# DRAINAGE NOTES:

- INLETS AND OUTLETS OF ALL CULVERTS SHALL BE RIPRAPPED UNLESS OTHERWISE NOTED ON THE PLANS OR DIRECTED BY THE RESIDENT.
- 2. IF FOUNDATION MATERIAL IS REQUIRED UNDER CULVERTS, IT SHALL MEET THE REQUIREMENTS FOR GRANULAR BORROW - UNDERWATER BACKFILL.
- 3. ALL DITCH ELEVATIONS AND OFFSETS SHOWN ON THE CROSS SECTIONS ARE FOR THE FINISHED DITCH FLOW LINE.
- 4. THE CONTRACTOR SHALL MAINTAIN EXISTING DRAINAGE DURING CONSTRUCTION AS NEEDED FOR TEMPORARY USE. PRIOR TO PROPOSED DRAINAGE SYSTEMS BEING FUNCTIONAL AS IDENTIFIED ON PLANS.

# EROSION CONTROL NOTES:

- THE ANTICIPATED EROSION CONTROL DEVICES ARE SHOWN ON THE PLANS. THE CONTRACTOR SHALL PROPOSE ACTUAL TYPE AND LOCATION OF DEVICES FOR APPROVAL BY THE RESIDENT. ADDITIONAL MEASURES MAY BE PROPOSED BY THE CONTRACTOR DUE TO SITE OR WEATHER CONDITIONS. THE RESIDENT MAY DIRECT THE CONTRACTOR TO IMPLEMENT ADDITIONAL MEASURES. ANY ADDITIONAL MEASURES APPROVED BY THE RESIDENT WILL BE MEASURED FOR PAYMENT UNDER THE APPROPRIATE BID ITEMS.
- 2. EROSION CONTROL DEVICES USED AT EXIT 48 WATERLINE REPLACEMENT SHALL NOT BE MEASURED FOR PAYMENT AND SHALL BE CONSIDERED INCIDENTAL TO THE WATERLINE PAY ITEMS.
- 3. 4" LOAM HAS BEEN ESTIMATED FOR 100% OF THE DISTURBED SLOPE AREA UNLESS OTHERWISE SPECIFIED ON THE PLANS. ACTUAL PLACEMENT OF THE LOAM SHALL BE AS DESIGNATED BY THE RESIDENT.
- 4. ALL NON-ROCK SLOPES SHALL BE SEEDED WITH SEEDING METHOD NO. 2.
- 5. MULCH SHALL BE APPLIED IN SEEDED AREAS, EXCEPT WHERE EROSION CONTROL BLANKET IS SPECIFIED.
- 6. ALL TEMPORARY AND PERMANENT EROSION CONTROL DEVICES SHALL BE INSTALLED IN ACCORDANCE WITH THE MAINE DEPARTMENT OF TRANSPORTATION BEST MANAGEMENT PRACTICES.
- 7. TEMPORARY EROSION CONTROL BLANKET, ITEM 613.319 SHALL BE INSTALLED IN ALL DITCHES AND 2: SLOPES FROM TOP TO TOE OF SLOPE. LOAM AND SEED SHALL BE PLACED PRIOR TO THE INSTALLATION OF THE EROSION CONTROL BLANKET. LIMITS OF THE EROSION CONTROL BLANKET IN DITCHES SHALL BE 6'WIDE OR AS DESIGNATED BY THE RESIDENT.
- 8. TEMPORARY STABILIZATION WITH MULCH OR OTHER NON-ERODABLE COVER IS REQUIRED ON ALL EXPOSED SOILS THAT WILL NOT BE WORKED FOR MORE THAN 7 DAYS. AREAS WITHIN 75 FEET OF A WETLAND OR WATERBODY SHALL BE STABILIZED WITHIN 48 HOURS OF THE INITIAL DISTURBANCE OF THE SOIL OR PRIOR TO ANY STORM EVENT. WHICHEVER COMES FIRST. THE CONTRACTOR IS RESPONSIBLE FOR APPLYING TEMPORARY MULCH AS NECESSARY, IN ACCORDANCE WITH THE LATEST EDITION OF THE BMP'S, TO MINIMIZE SOIL EROSION PRIOR TO THE APPLICATION OF THE FINAL SLOPE TREATMENT.
- 9. TEMPORARY SEED SHALL BE APPLIED TO ALL DISTURBED AREAS THAT WILL NOT BE COMPLETED WITHIN 30 DAYS.
- IO. A DOUBLE ROW OF SILT FENCE PROTECTION SHALL BE INSTALLED AT ALL STREAM LOCATIONS AND OPEN WATER WETLANDS AS SHOWN ON THE PLANS, OR AS DIRECTED BY RESIDENT. AN ADDITIONAL QUANTITY IS INCLUDED FOR LOCATIONS NOT SPECIFICALLY SHOWN.
- II. STABILIZED CONSTRUCTION ENTRANCES MUST BE USED AND MAINTAINED. NO TRACKING OF SOIL ON THE MAINE TURNPIKE OR LOCAL ROADS WILL BE ALLOWED.

12. IF DIRECTED BY THE RESIDENT, EROSION CONTROL MIX SHALL BE USED IN PLACE OF LOAM AND SEED IN AREAS OF REGRADED TEMPORARY GRAVEL SHOULDER WIDENING.  $\square$ PAYMENT SHALL BE MADE PER THE CONTRACT UNIT PRICE OF THE LOAM PAY ITEM.

 $\begin{picture}{0.5mm} \begin{picture}{0.5mm} \end{picture}{0.5mm} \en$ 

HNTB CORPORATION 82 Running Hill Road, Suite 201 South Portland, ME 04106 TEL (207) 774-5155 FAX (207) 228-0909

04/21

04/21

EDD

Drawn

In Charge of TRC



MTA PROJECT MANAGER: Ralph C. Norwood, IV, P.E., P.T.O.E.

THE GOLD STAR

MEMORIAL HIGHWAY

	ESTIMATED QUANTITIES				
ITEM NO	DESCRIPTION	WATER MAIN	UTILITY VAULTS	TOTAL QUANTITY	UNIT
202.12	REMOVE EXISTING STRUCTURAL CONCRETE		(50)	50	СҮ
203.20	COMMON EXCAVATION	70	910	980	СҮ
203.25	GRANULAR BORROW	100	180	280	СҮ
304.14	AGGREGATE BASE COURSE - TYPE A	/50	700	850	СҮ
403.213	HOT MIX ASPHALT, 12.50 MM NOMINAL MAXIMUM SIZE		80	80	TON
	(BASE AND INTERMEDIATE BASE COURSE)				
409.15	BITUMINOUS TACK COAT RSI OR RSIH - APPLIED		/5	/5	GAL
419.30	SAWING BITUMINOUS PAVEMENT		450	450	LF
501.231	DYNAMIC LOAD TEST		2	2	ΕA
501.40	STEEL H-BEAM PILES, 53 LB/FT, DELIVERED		865	865	LF
501.401	STEEL H-BEAM PILES, 53 LB/FT, IN PLACE		865	865	LF
501.90	PILE TIPS		10	10	ΕA
501.91	PILE SPLICES		10	10	ΕA
501.92	PILE DRIVING EQUIPMENT MOBILIZATION			/	LS
5/1.09/	TEMPORARY EARTH SUPPORT SYSTEMS		1	/	LS
5/4.06	CURING BOX FOR CONCRETE CYLINDERS	1	1	/	EA
526.306	TEMPORARY CONCRETE BARRIER, TYPE I		. /	/	LS
	- SUPPLIED BY AUTHORITY (1,760 LF)				
527.34	WORK ZONE GRASH GUSHIDAS-TI-3		- 5 -	$\sim$ 5 $\sim$	UNIT
603.175	INCH REINFORCED CONCRETE PIPE - CLASS III	$\gamma \rightarrow \gamma$	37	37	I F
603.195	24 INCH REINFORCED CONCRETE PIPE - CLASS III	1 Jan			
603 <b>.</b> 28	CONCRETE COLLAR	20			EA
603 <b>.</b> 28	CONCRETE COLLAR FOR WATERMAIN	1	1	/	EA
604 <b>.</b> 1581	UTILITY VAULT EXTENSION - STA 2360+02.55 NB		1	/	LA
				/	
604.1582	UTILITY VAULT EXTENSION - STA 2340+52.81 NB		1	/	LS
604.1583	UTILITY VAULT EXTENSION - STA 2340+52.81 SB		/	/	LS
606.366	GUARDRAIL, REMOVED AND RESET, TYPE 3C		540	540	LF
610.08	PLAIN RIPRAP		//	//	CY
610.18	STONE DITCH PROTECTION		5	5	CY
613.319	EROSION CONTROL BLANKET		200	200	SY
615.07			170	170	CY
6/8./4	SEEDING METHOD NUMBER 2		/5	/5	UNIT
619.1201	MULCH - PLAN QUANTITY		/5	15	UNIT
619.1202	TEMPORARY MULCH		/	/	LS
620.58	EROSION CONTROL GEOTEXTILE		54	54	SY
627.712	WHITE OR YELLOW PAVEMENT MARKING LINE		300	300	LF
627.73	TEMPORARY 6 INCH PAVEMENT MARKING TAPE		600	600	LF
629.05	HAND LABOR, STRAIGHT TIME	10	5		HR
631.12	ALL PURPOSE EXCAVATOR (INCLUDING OPERATOR)	10	5		HR
63I <b>.</b> I72	TRUCK-LARGE (INCLUDING OPERATOR)	10	5	15	HR
631.22	FRONT END LOADER (INCLUDING OPERATOR)	10	5	/5	HR
631.36	FOREMAN	10	5	/5	HR
652 <b>.</b> 30	FLASHING ARROW		/	/	ΕA
652.3/2	TYPE III BARRICADES		2	2	ΕA
652.33	DRUM		110	110	ΕA
652 <b>.</b> 35	CONSTRUCTION SIGNS		660	660	SF
652.361	MAINTENANCE OF TRAFFIC CONTROL DEVICES			/	LS
652.41	PORTABLE-CHANGEABLE MESSAGE SIGN		2	2	ΕA
652.45	TRUCK MOUNTED ATTENUATOR		/5	/5	CD
656.50	BAILED HAY, IN PLACE		/5	15	ΕA
656.632	30 INCH TEMPORARY SILT FENCE		900	900	LF
659,10	MOBILIZATION (UTILITY VAULTS)		/	/	LS
659 <b>.</b> //	MOBILIZATION (WATERLINE)	/		/	LS
	8" CLASS 52 DI PIPE PUSH ON JOINT	10		10	LF
	IZ" CLASS 52 DI PIPE PUSH ON JOINT	160		160	LF
	I2" GATE VALVE	2		2	EA
823 <b>.</b> 333	I" AIR RELEASE VALVE	2		2	EA
825.60	I2" DR II HDPE PIPE	390		<u> </u>	LA
827 <b>.</b> 303	UNSUITABLE MATERIAL BELOW TRENCH GRADE	50		50	CY
845 <b>.</b> 211	STONE PIPE SUPPORT IN CASING - NB, SB, & SB ON RAMP	1		1	LS
				/	
845.212	STONE PIPE SUPPORT IN CASING - NB OFF RAMP	/		/	LS

WATER LINE AND UTILITY VAULTS

ESTIMATE OF QUANTITIES


AND GENERAL NOTES

CONTRACT: 2021.02

SHEET NUMBER: GN-01



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	Scale of Feet						ITB		
No.	Revision	By	Date						
$\land$	ADDENDUM #I	DAM	06/21						
				CONSULTANT F	PROJEC	T MANAGER:	Dale A. Mitchell,	, P.E.	
					By	Date		By	[
				Designed	DAM	04/21	Checked	RWH	0
				Drawn	EDD	04/21	In Charge of	TRC	0
	₩. 10.	lo. Revision	lo. Revision By	No. Revision By Date ADDENDUM #1 DAM 06/21	No. Revision By Date ADDENDUM #1 DAM 06/21 CONSULTANT F	No. Revision By Date ADDENDUM #/ CONSULTANT PROJEC By Designed DAM	No.     Revision     By     Date       ADDENDUM #I     DAM     06/2I       CONSULTANT PROJECT MANAGER:       By     Date       By     Date       Designed     DAM       04/21	No.     Revision     By     Date       ADDENDUM #I     DAM     O6/2I       CONSULTANT PROJECT MANAGER: Dale A. Mitchell,       By     Date       Date       Date       Designed     DAM       O4/21	No.     Revision     By     Date       ADDENDUM #I     DAM     06/2I       CONSULTANT PROJECT MANAGER:     Dale     A. Mitchell, P.E.       By     Date     By     Date     By       Designed     DAM     04/21     Checked     RWH

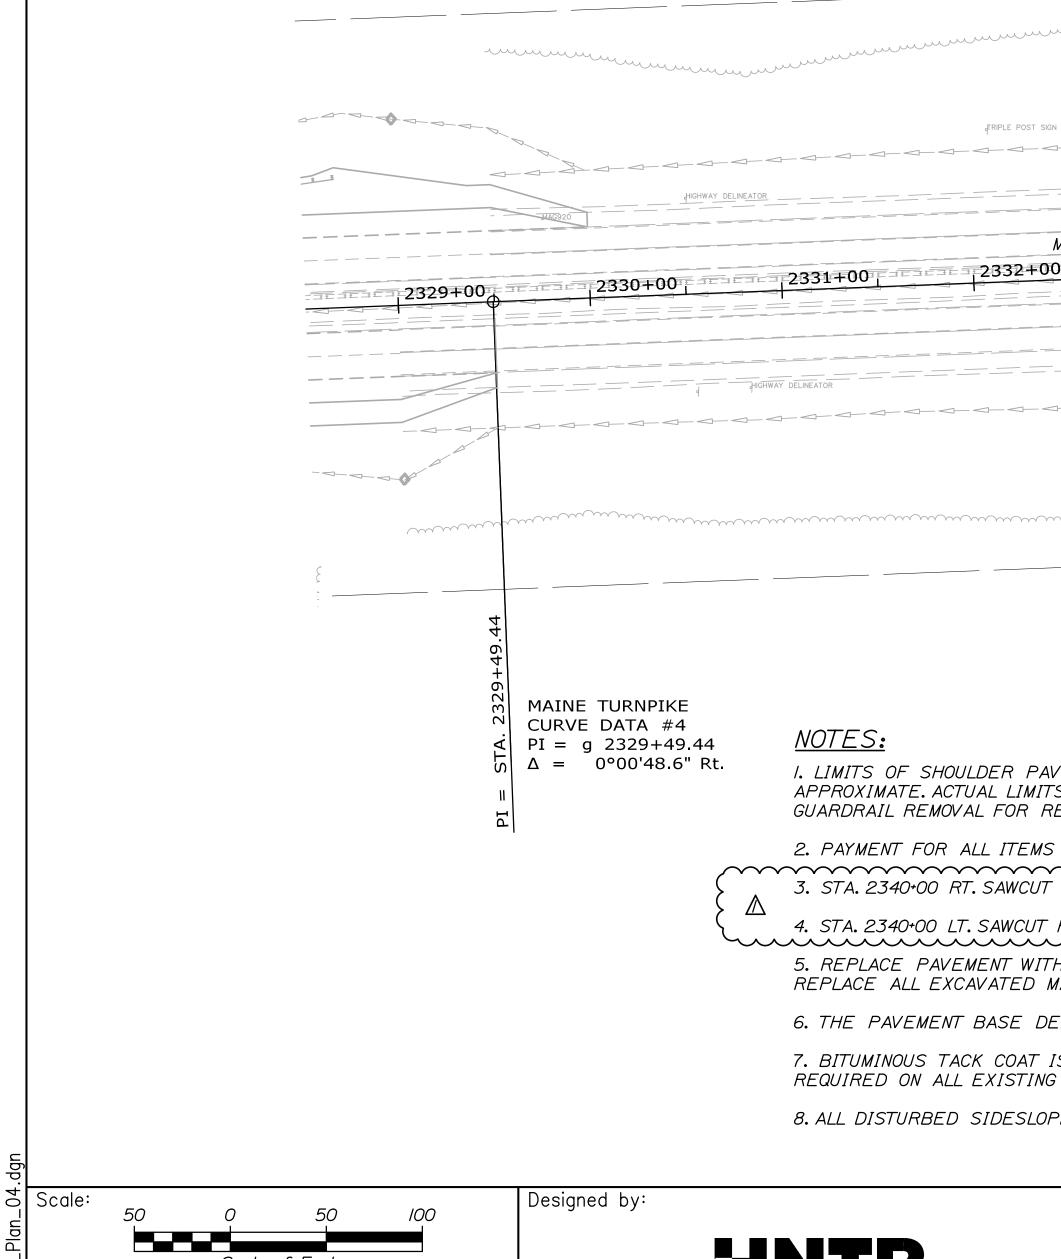						/
						1
———— I P F———— I P F———— I P F———		—— I P I——— I P I———	——————————————————————————————————————	P		
					<del></del>	
	WOOD			ELEC PEDESTAL	BAS PI	PIPELINE MARKER POST GAS PIPELINE MARKER
			ELEC PEDESTAL, SOLAR PANEL	ELEC PEDESTAL		FAS SIGN
				SPEED LIMIT		2
				HIGHWAY DELINEATOR	нісн	
	HIGHWAY DELINEATOR			←		
MAINE	TURNPIKE	MAINE TURNPIKE SOUTHBOUND		← 2336 ±00 (reg i i i i	2337+00 BOGASIGN = 23	338+00 /=
2331+00			5+00			
		MAINE TURNPIKE NORTHBOUND				-//////////
		₩9HWAR DEL	WEATOR	METAL POST	GÅS MARKER POST	*//*/*/*/ <sub>CUL</sub>
	BURIED METAL POST		4-4-4-4-	LARGE TRUSS SIGN	PENT	
				G AS	Marker Post	
				munut	MC ST	+
		( * .	PEN	PE 3		
						/
						/
					K 2337+67.25	,' / UTI
				EQNB EQNA	HD 2337+70.89	/ SE
NOTES:				/	·	,
I. LIMITS OF SHOULDER PAVEMENT APPROXIMATE. ACTUAL LIMITS MAY V						
GUARDRAIL REMOVAL FOR REVIEW						
2. PAYMENT FOR ALL ITEMS SHALL	BE BASED ON ACTUAL W	ORK. COMPLETED. MEASU	RED. AND ACCE	PTED.		
					$\sim\sim\sim\sim\sim\sim$	

ITEM 606.366 GUARDRAIL, REMOVE AND RESET

STA. 2339+50.00, 53.45' RT. TO STA. 2340+83.37, 54.10' RT. (ADJUST LIMITS IN THE FIELD)

STA. 2338+07.80, 48.38' LT. TO STA. 234I+00.00, 53.19' LT. (ADJUST LIMITS IN THE FIELD)

<u>LF</u>

133 293


4. STA. 2340+00 LT. SAWCUT PARALLEL TO RAMP STRIPING OFFSET VARIES. TEMPORARY EARTH SUPPORT MAY BE REQUIRED.

5. REPLACE PAVEMENT WITH 4" H.M.A. REPLACE MINIMUM 81/2" AGGREGATE BASE COURSE - TYPE A BENEATH ALL REMOVED PAVEMENT. REPLACE ALL EXCAVATED MATERIAL WITHIN 36" OF PAVED SURFACE WITH TYPE A GRAVEL. TYPE A GRAVEL SHALL BE DAYLIGHTED.

6. THE PAVEMENT BASE DEPTHS AND CROSS SLOPES AS SHOWN ON THE PLANS ARE INTENDED TO BE NOMINAL.

7. BITUMINOUS TACK COAT IS REQUIRED BETWEEN ALL LIFTS OF PAVEMENT, OR AS DIRECTED BY RESIDENT. BITUMINOUS TACK COAT IS REQUIRED ON ALL EXISTING PAVED OR MILLED SURFACES PRIOR TO PLACING PROPOSED PAVEMENT.

8. ALL DISTURBED SIDESLOPE AREAS SHALL BE TREATED WITH 4" LOAM, SEED, AND MULCH.

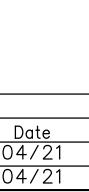


HNTB CORPORATION 82 Running HillRoad, Suite 201 South Portland, ME 04106 TEL (207) 774-5155 FAX (207) 228-0909





MTA PROJECT MANAGER: Ralph C. Norwood, IV, P.E., P.T.O.E.


THE GOLD STAR


MEMORIAL HIGHWAY

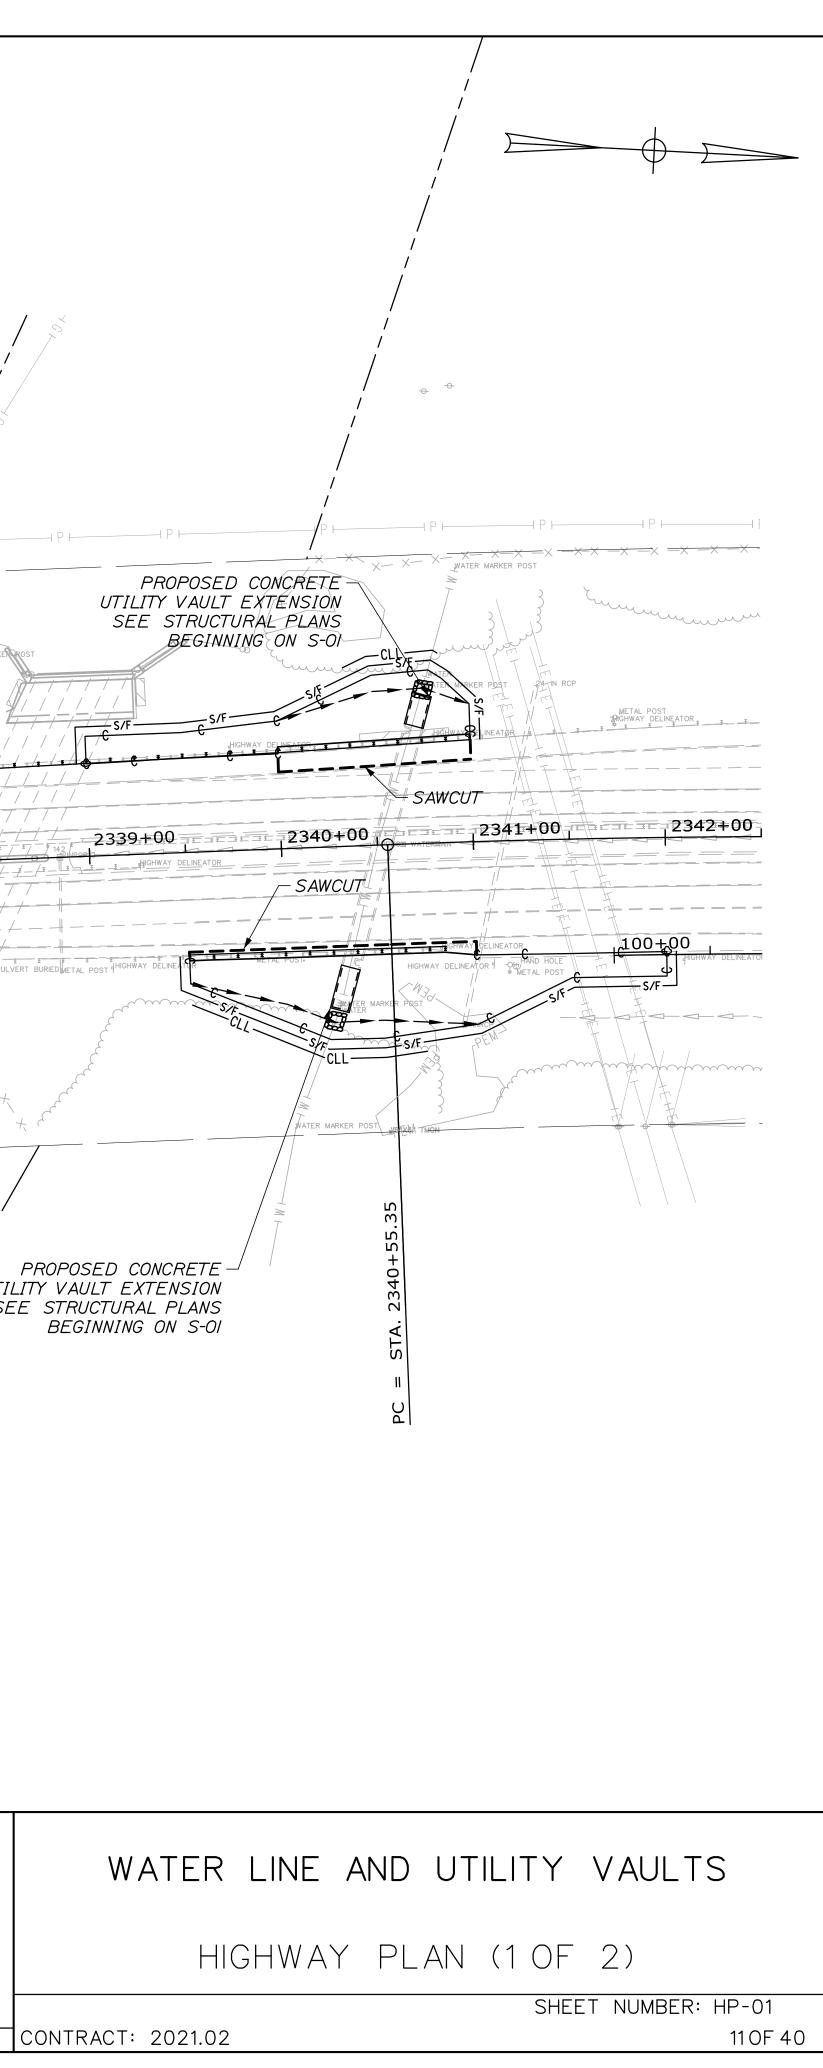


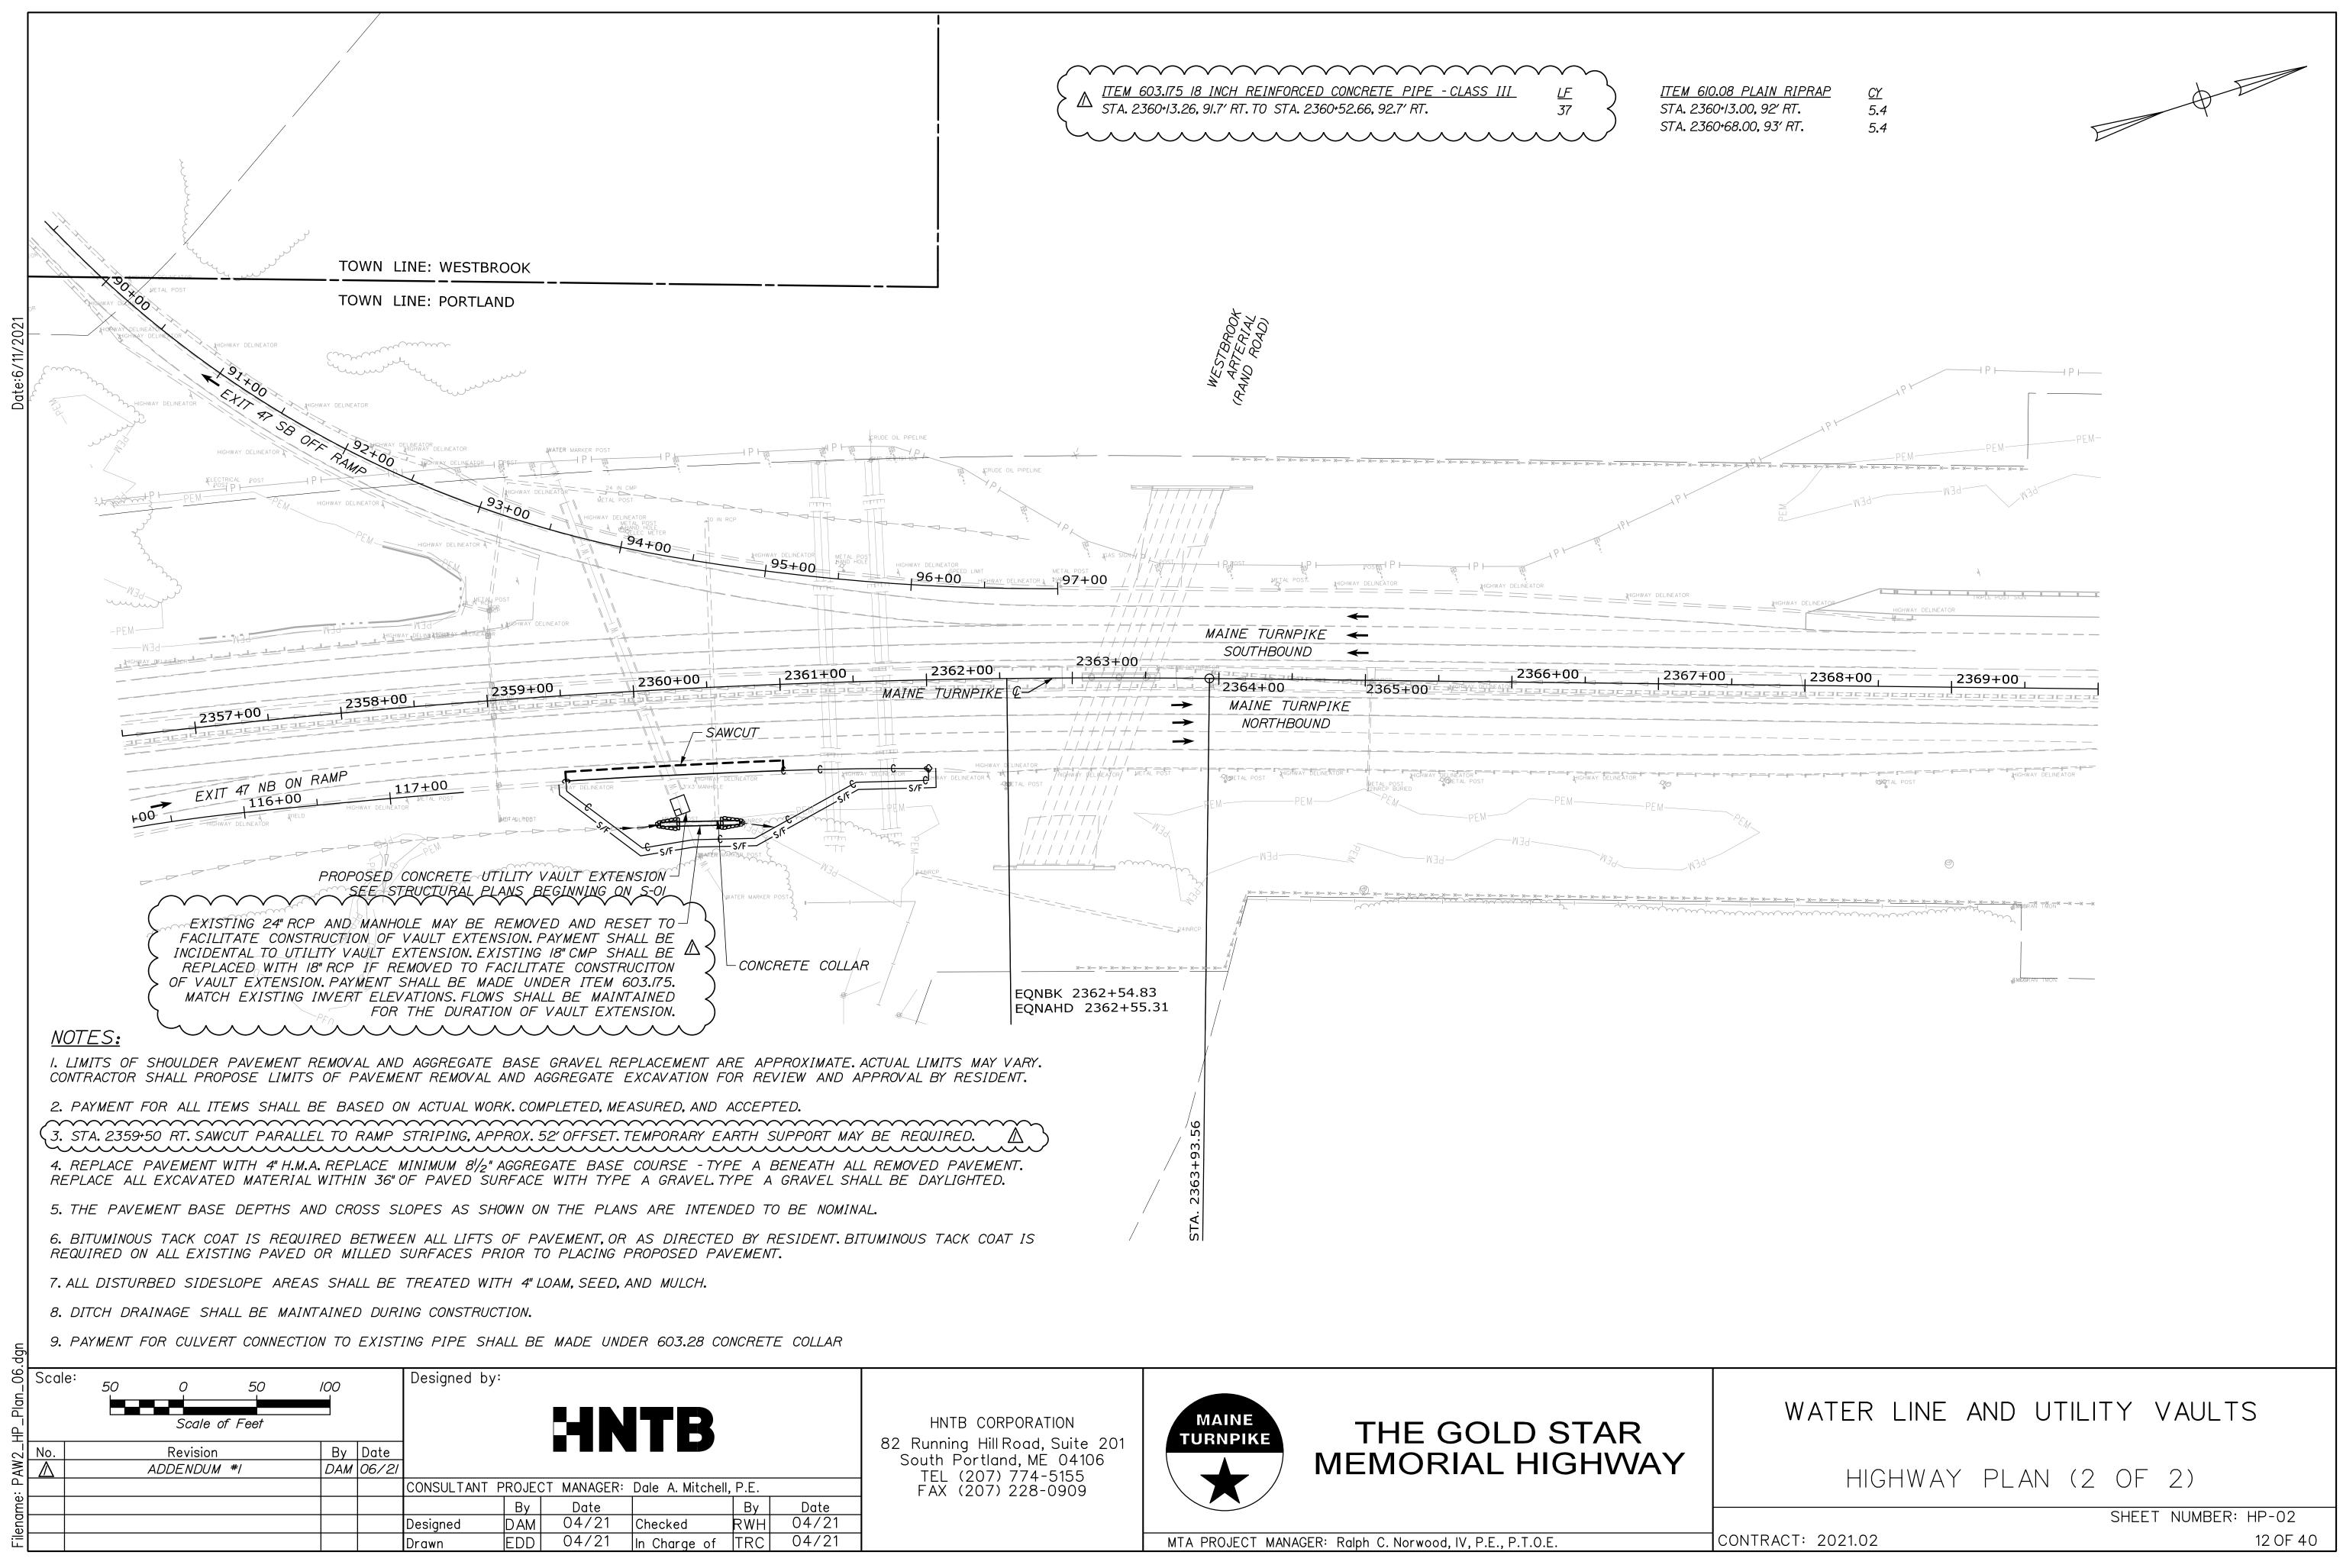


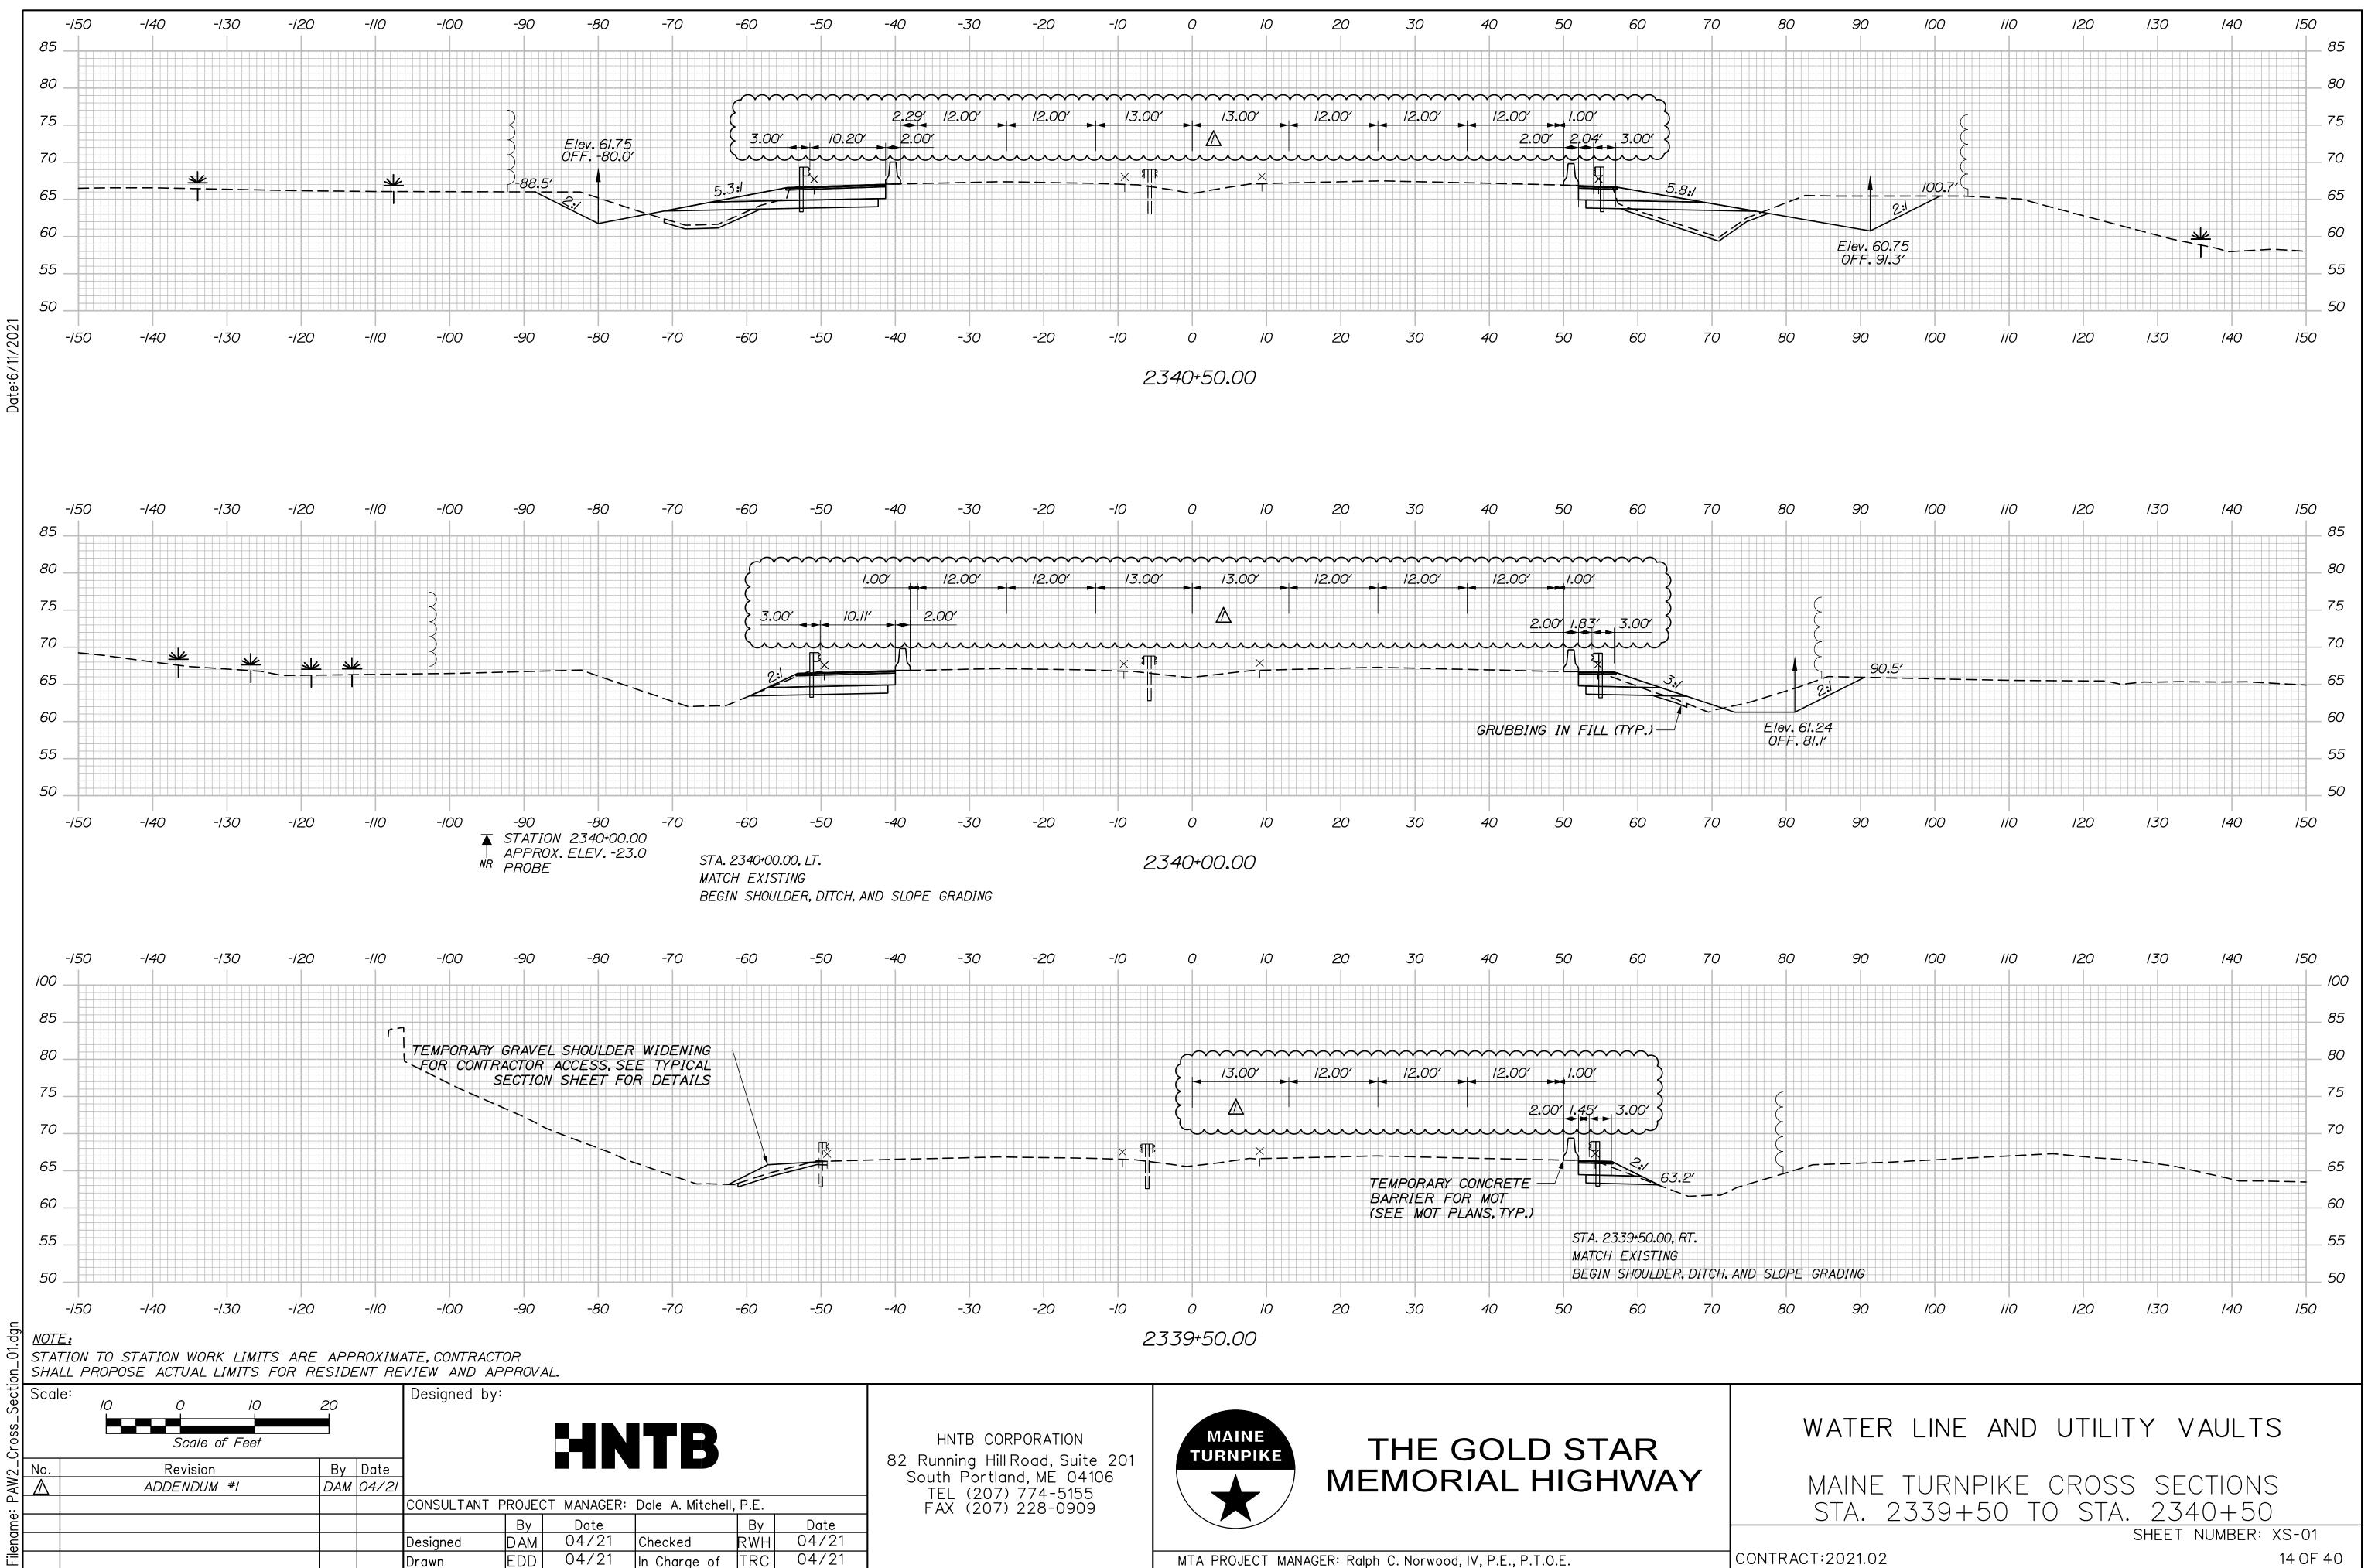

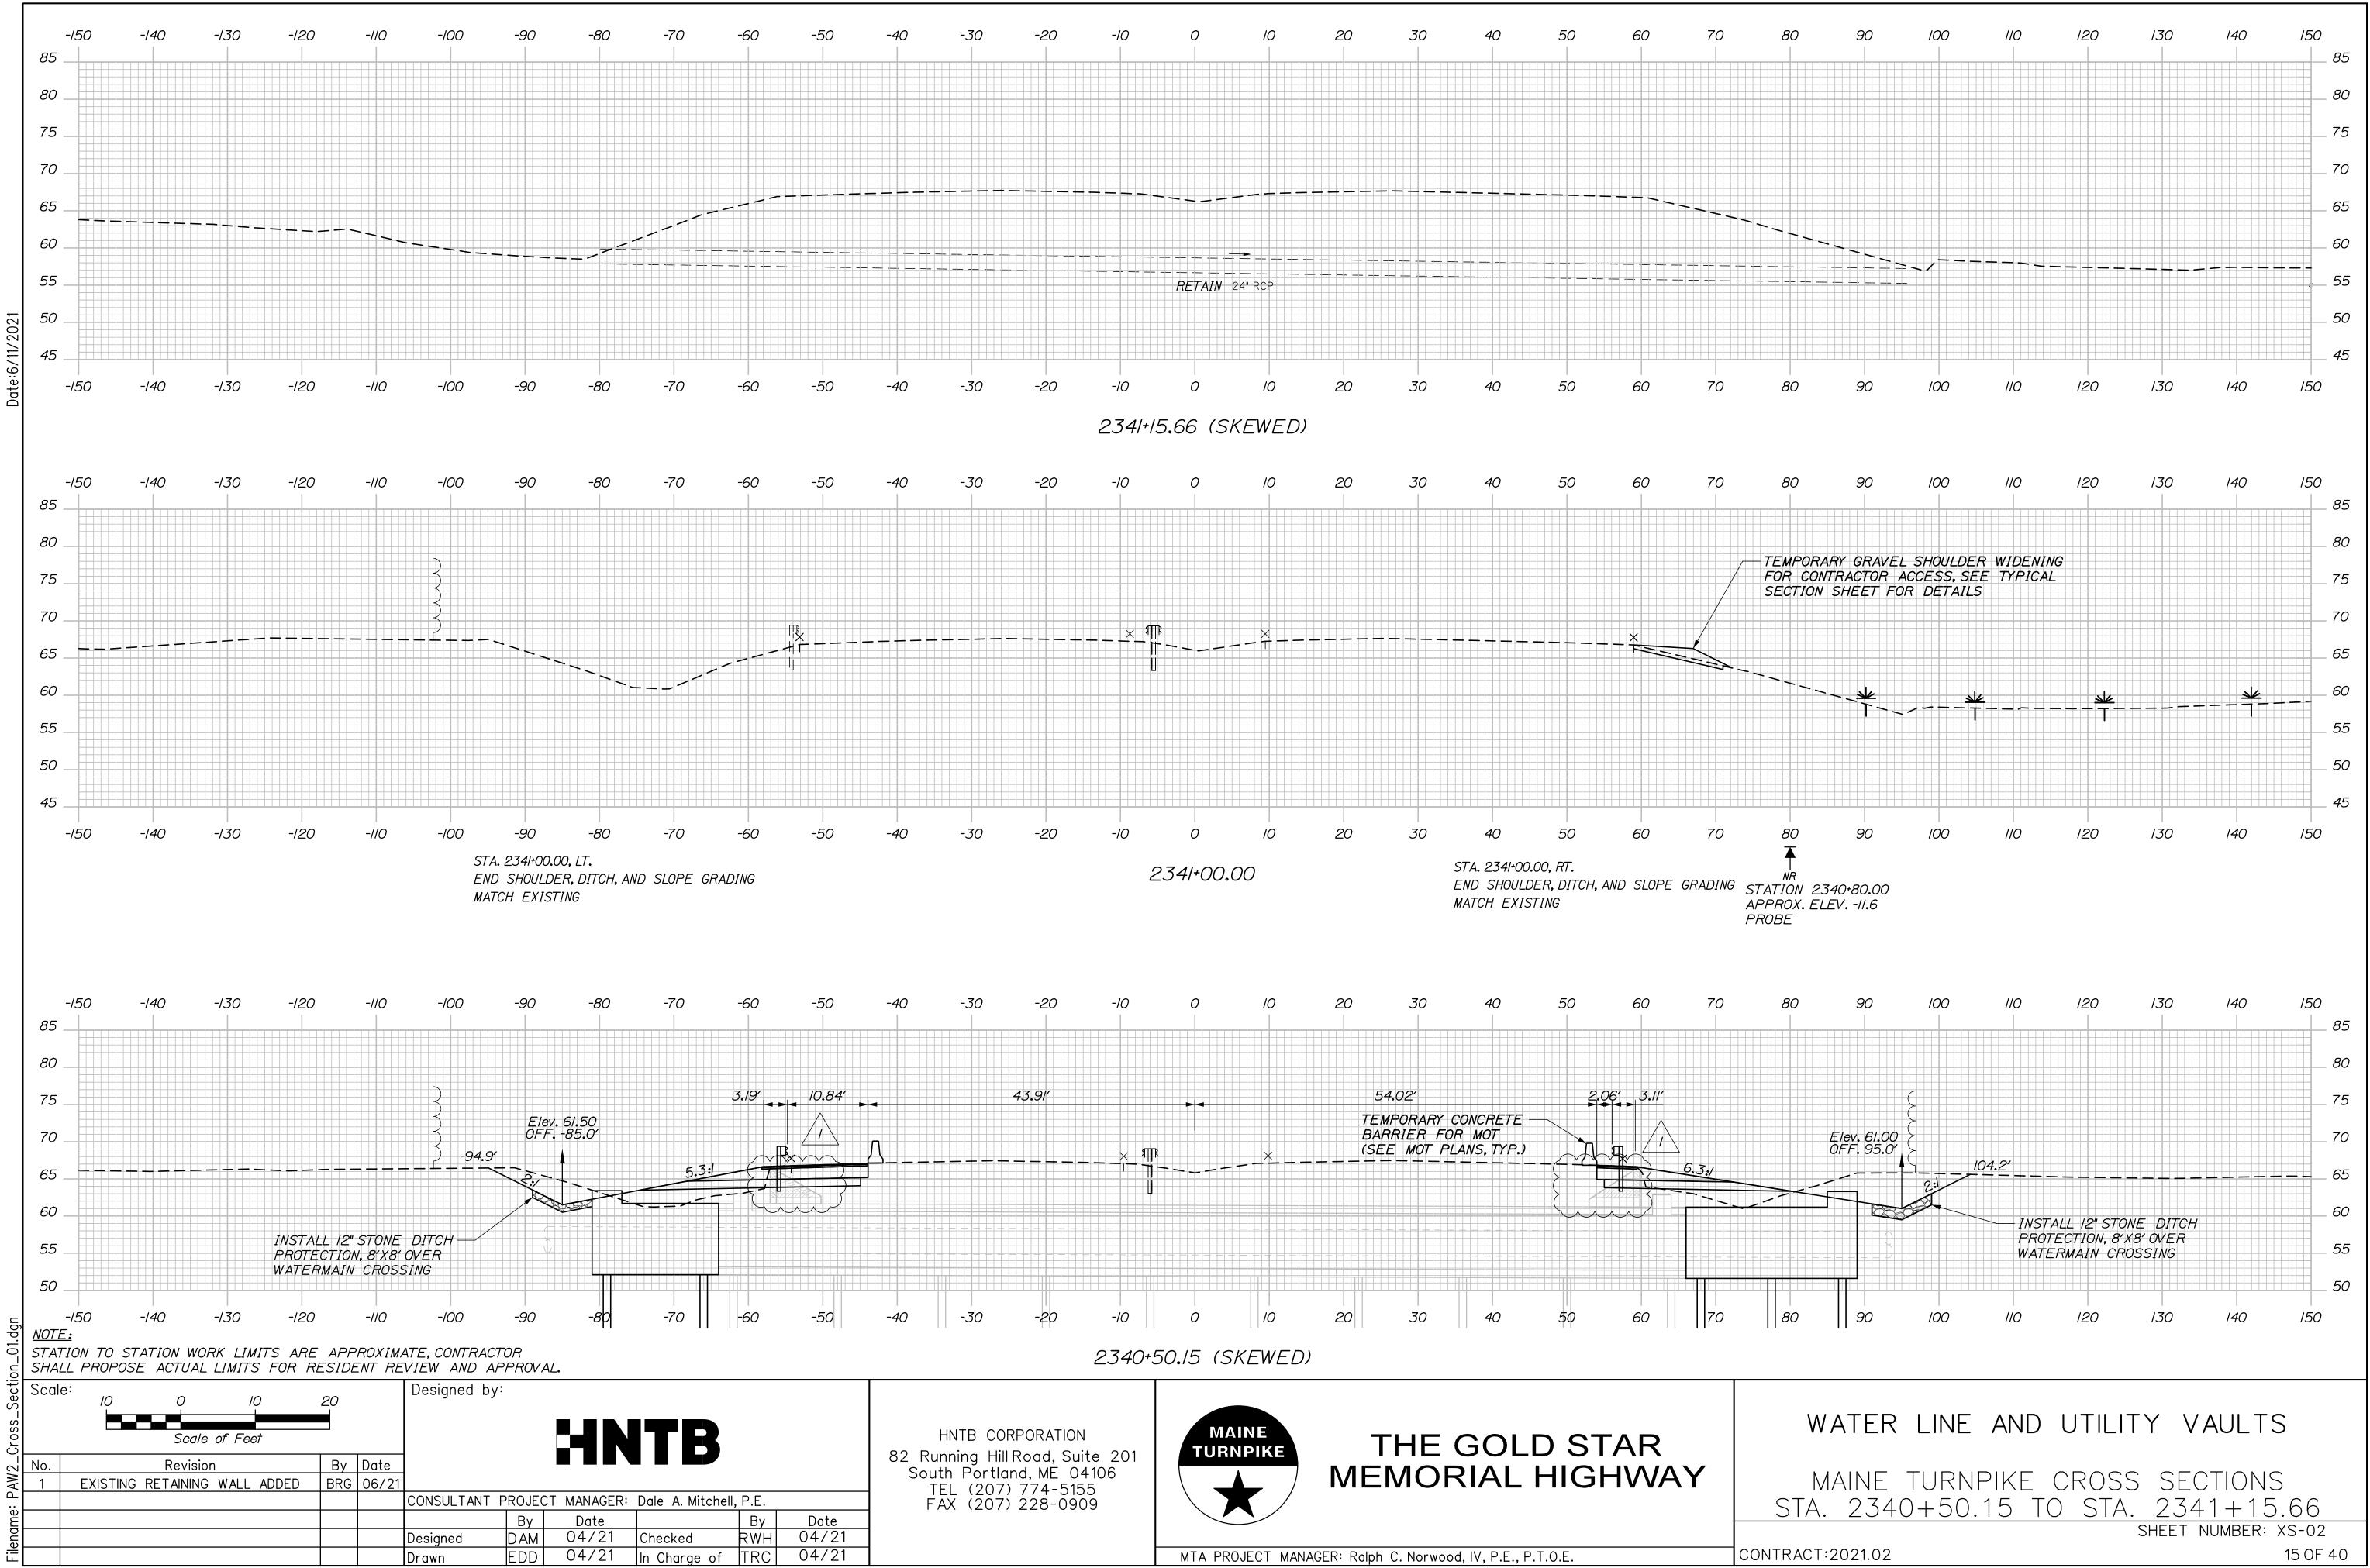

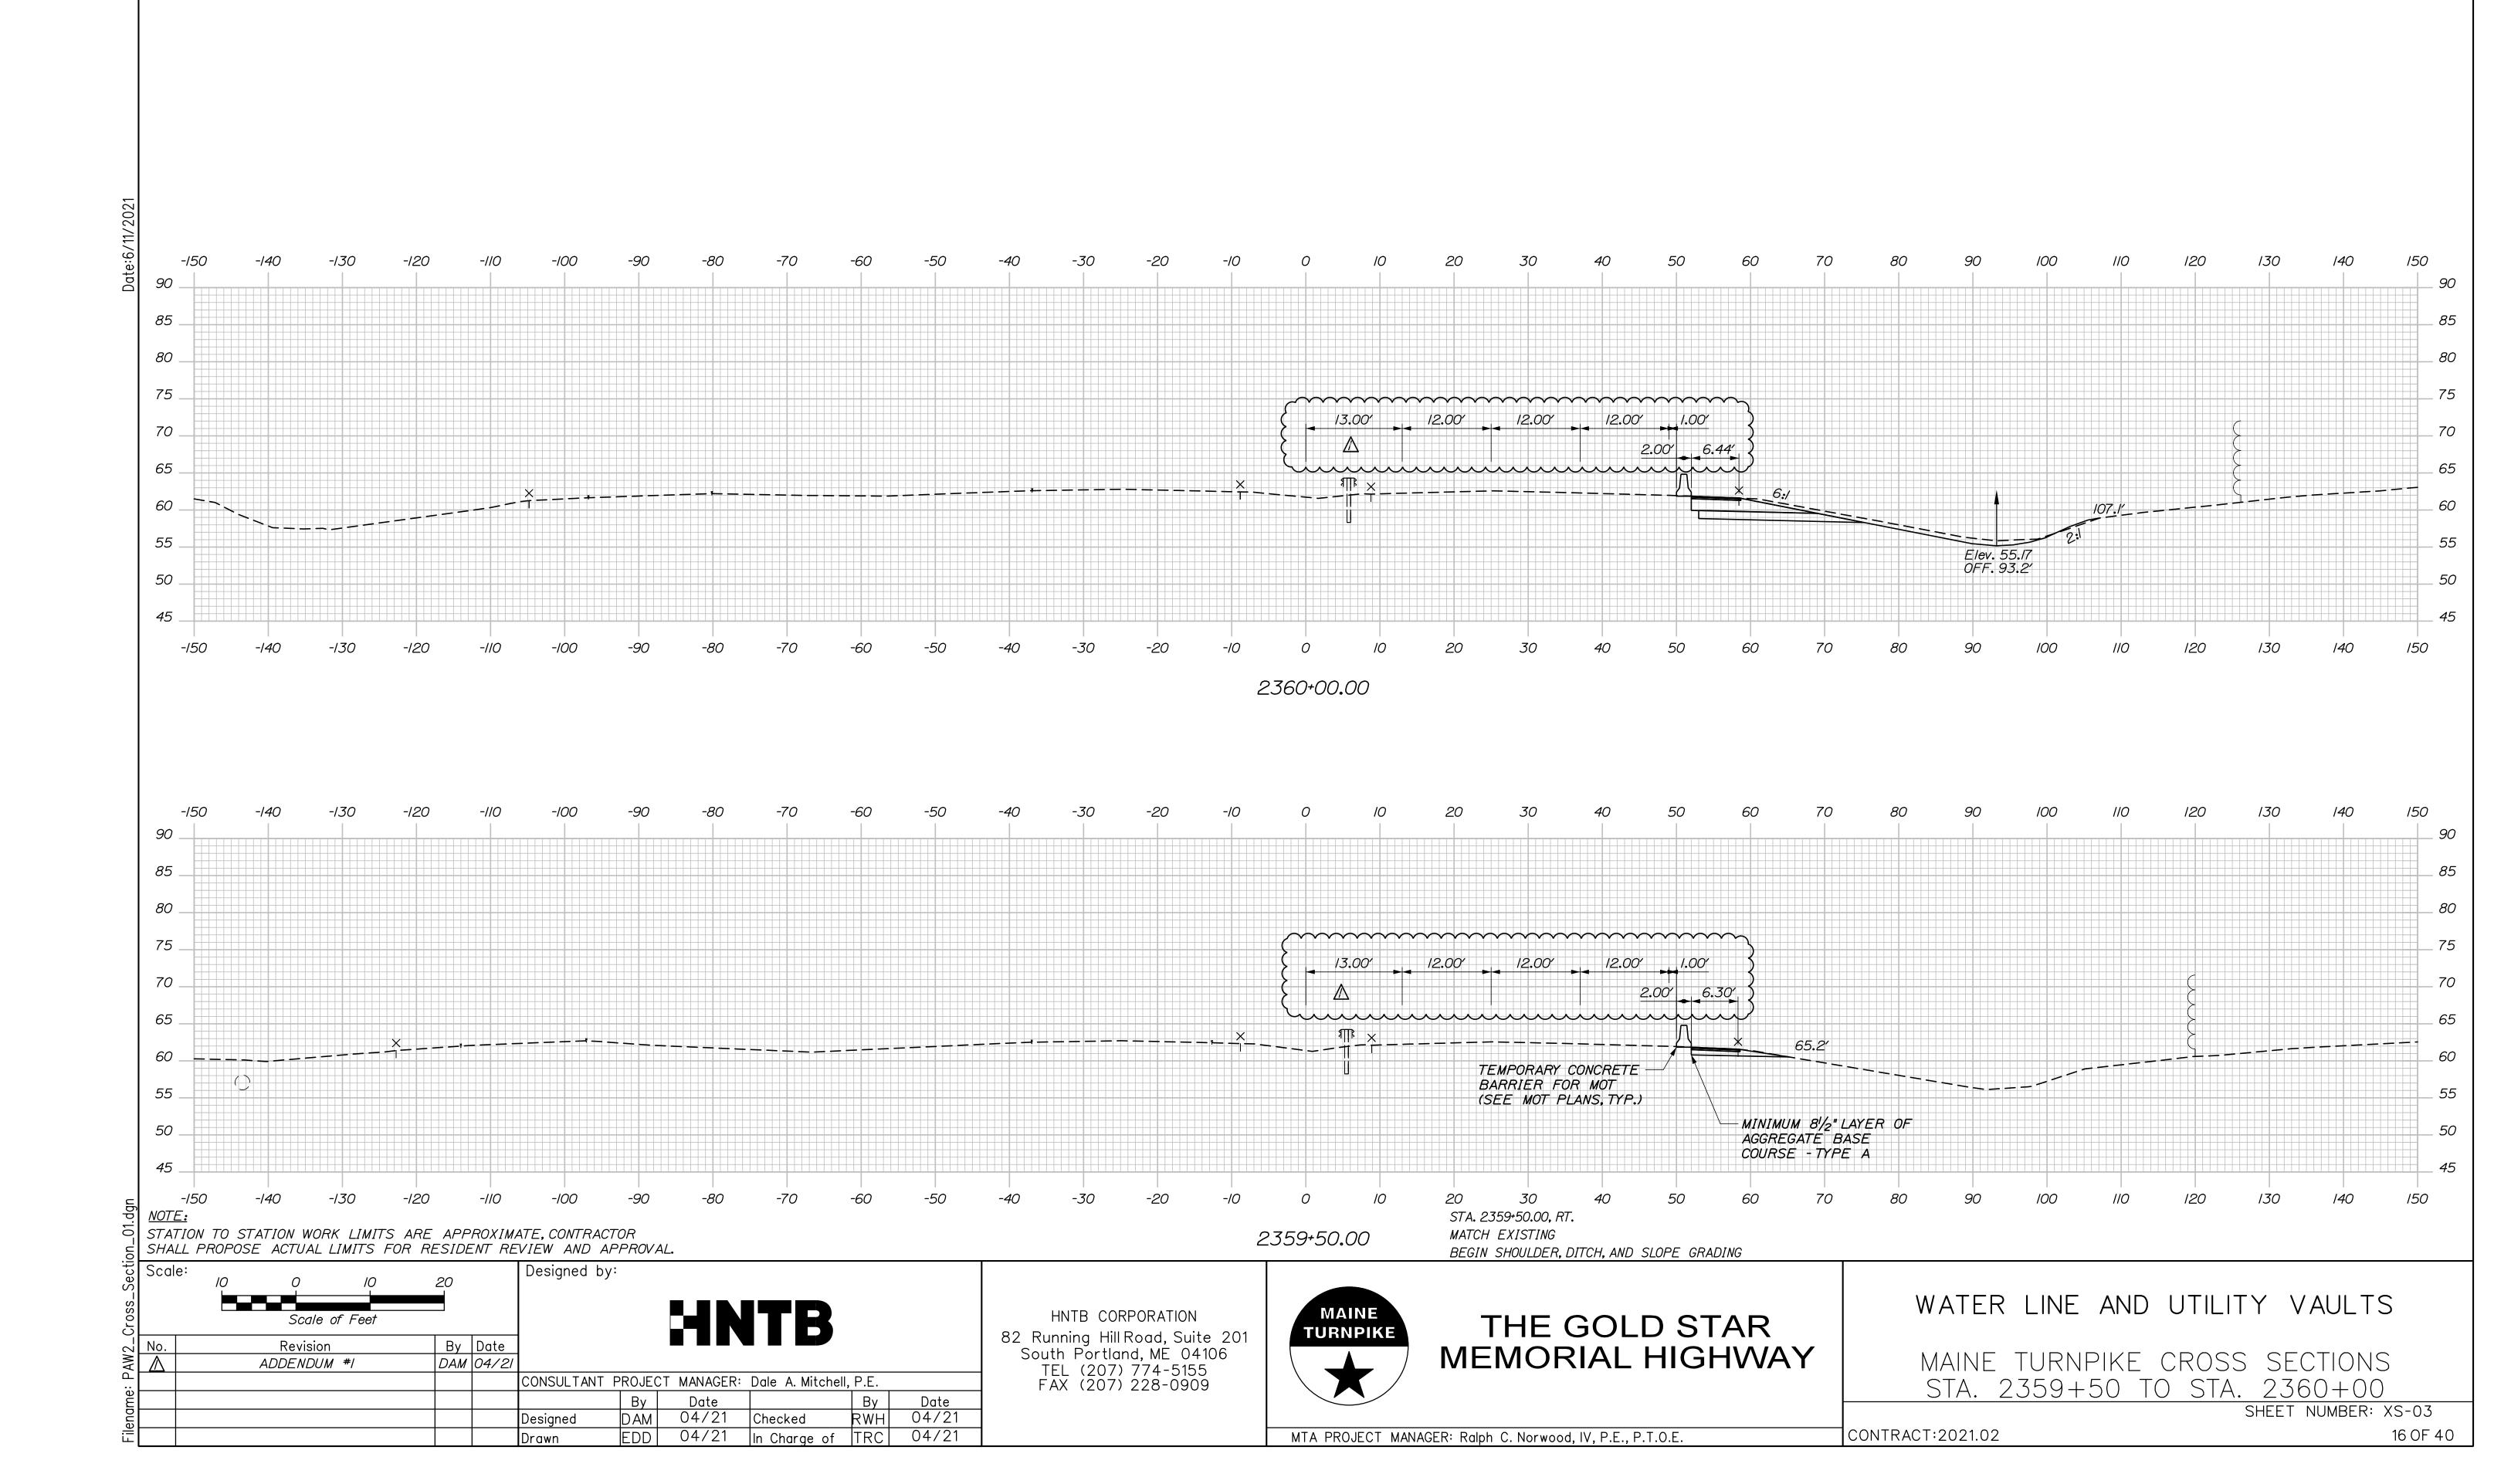

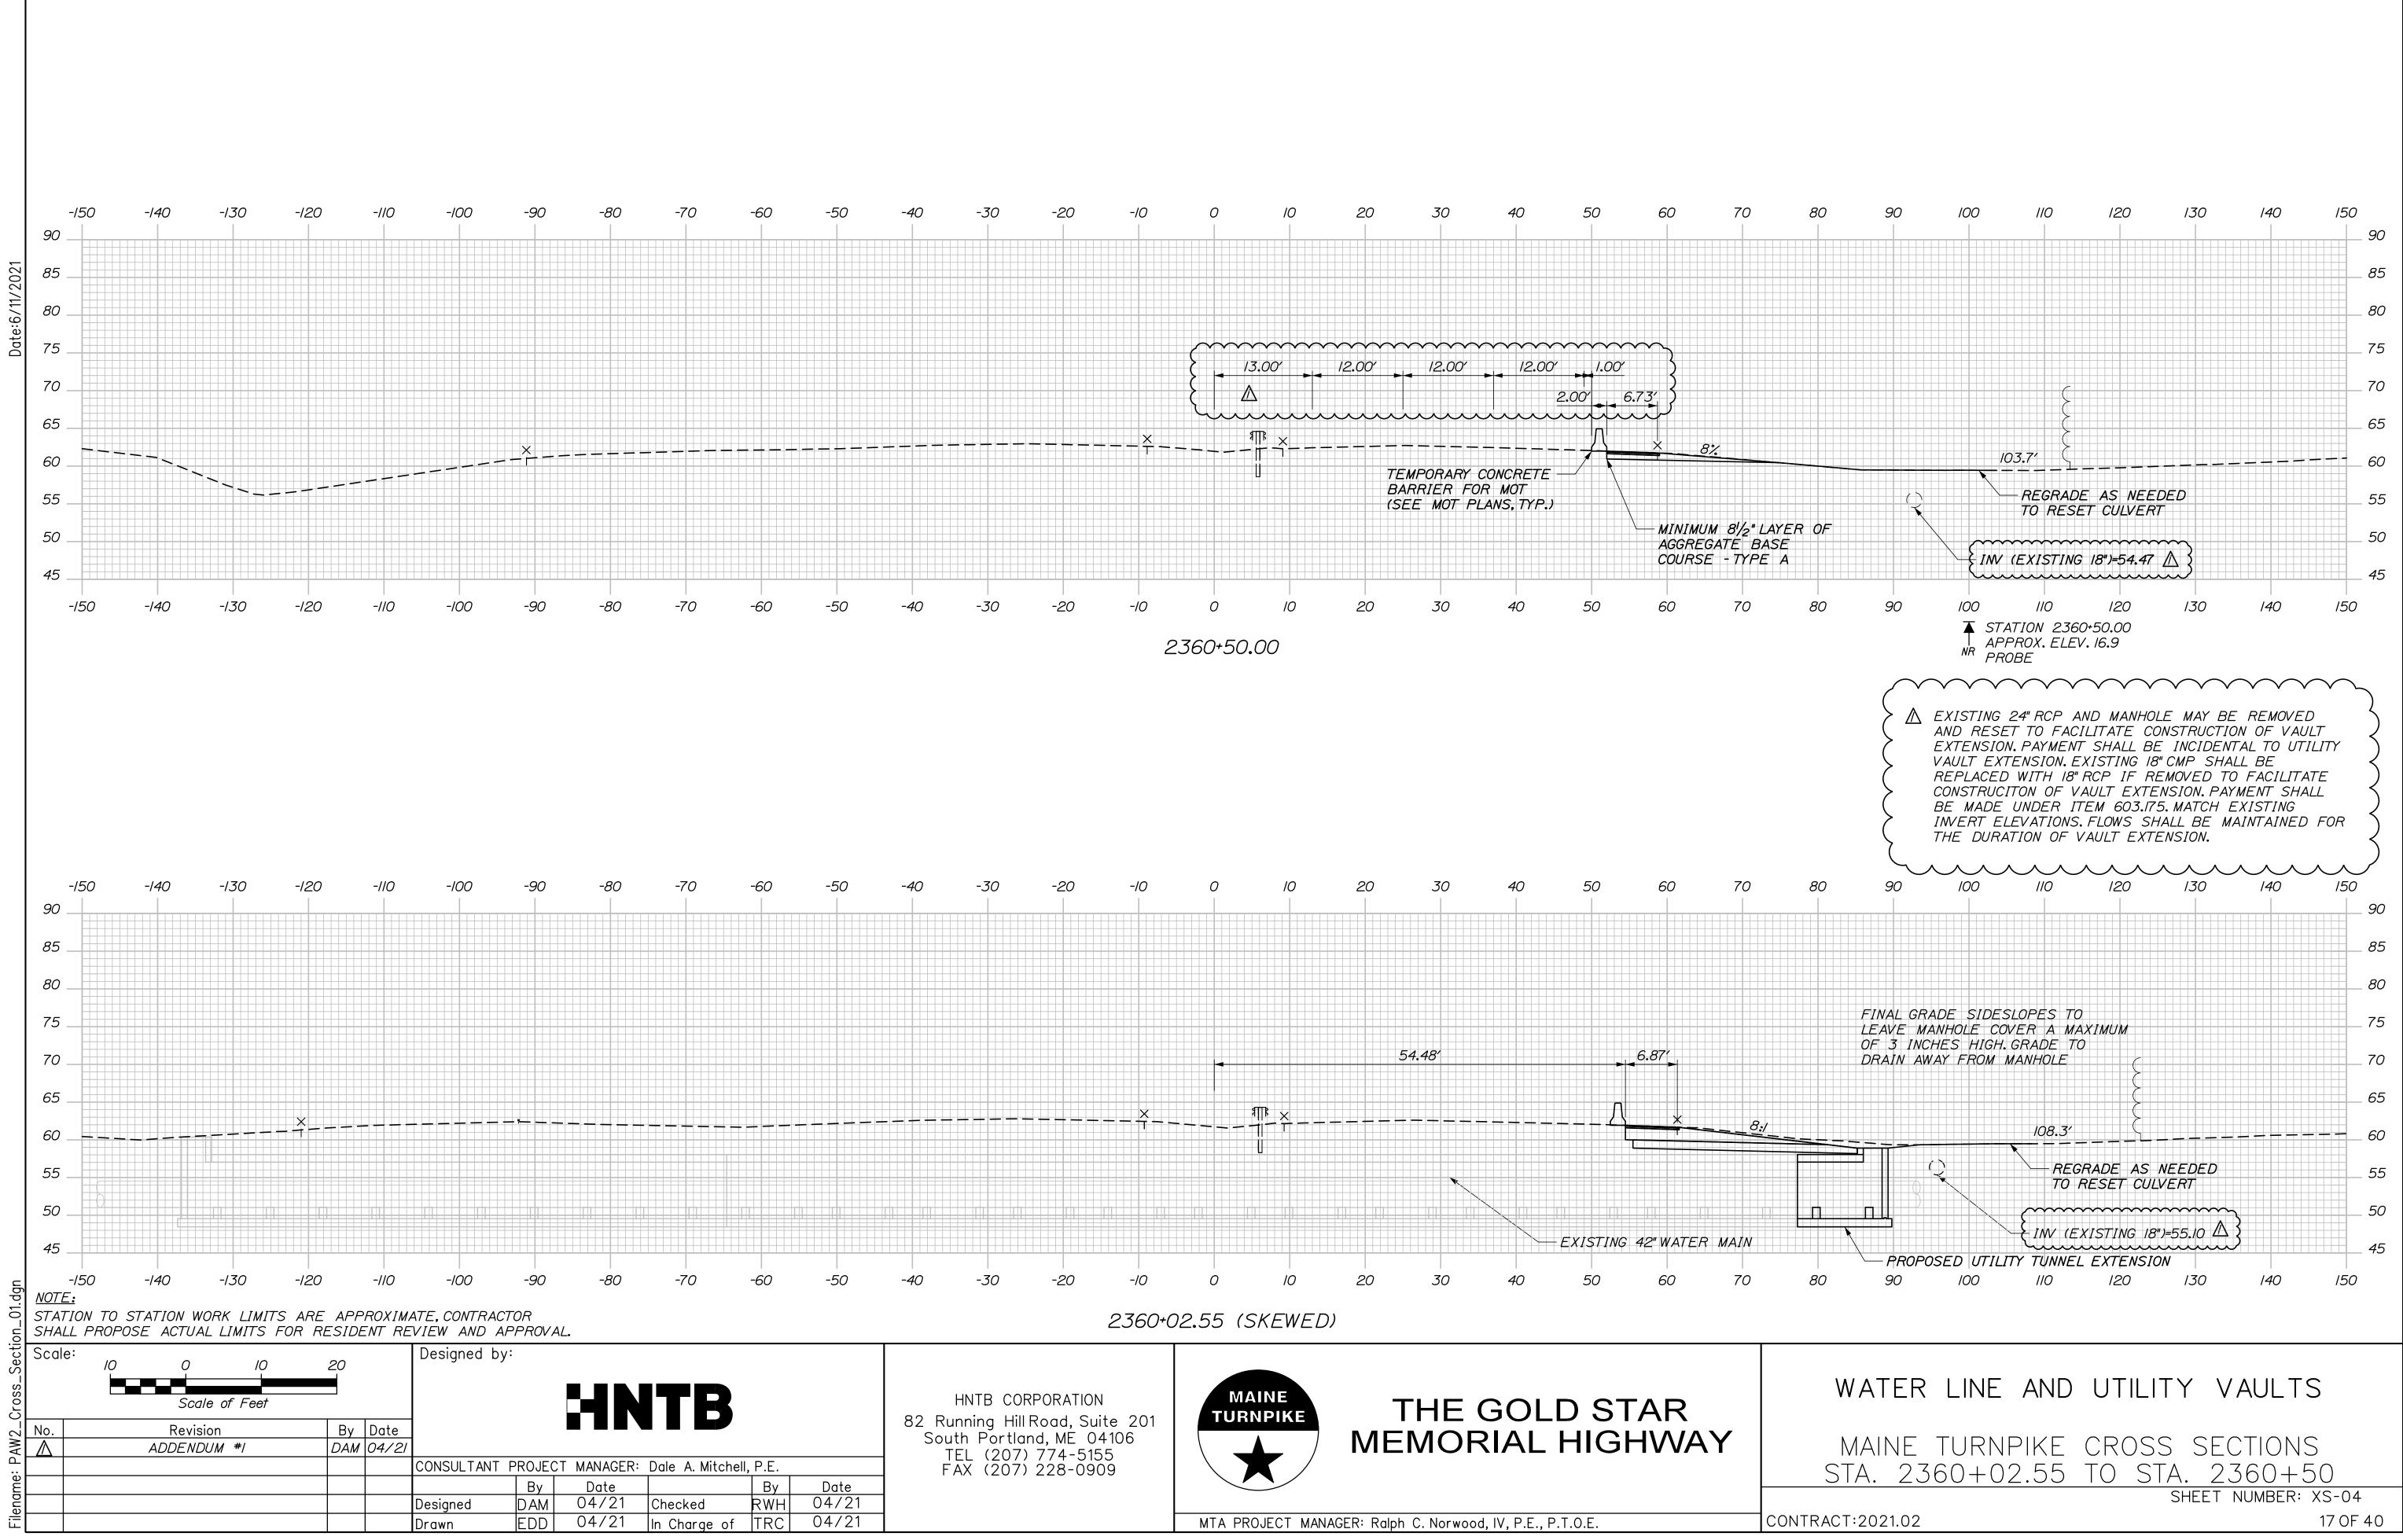

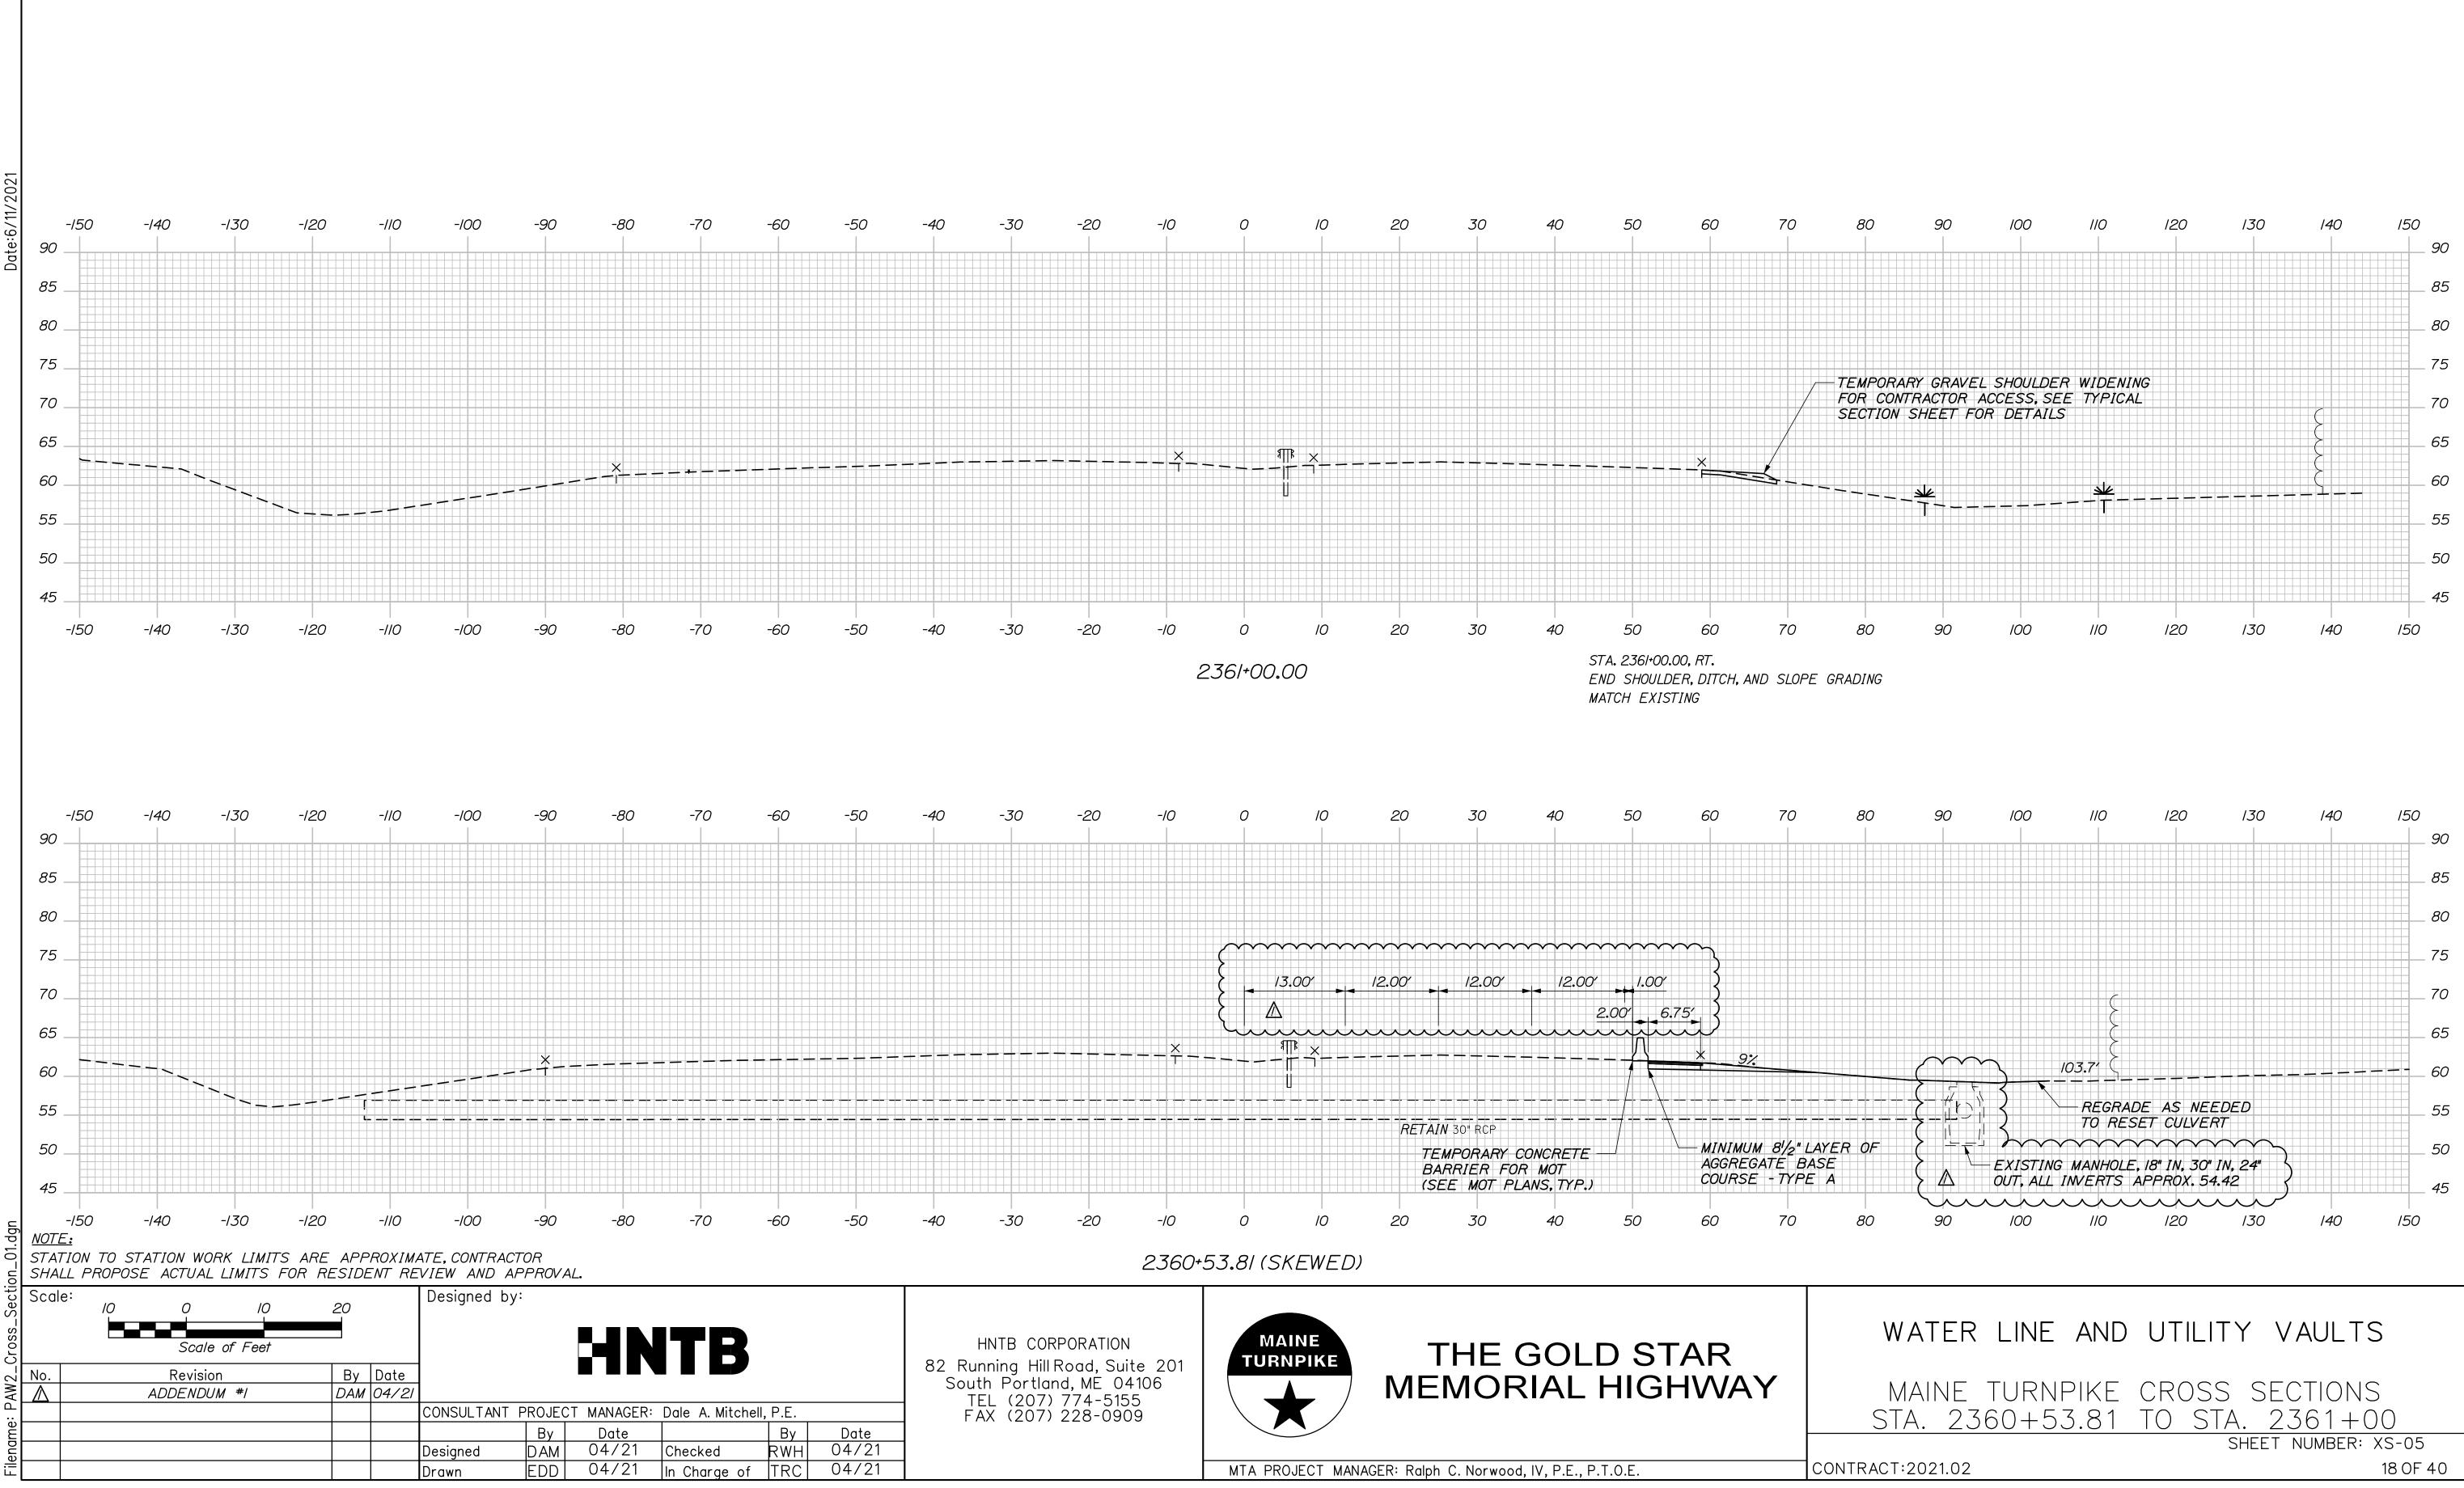

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	<u>SPECIFICATIONS</u> DESIGN			
	AASHTO LRFD BRIDGE DESIGN SPECIFICATIONS, 8TH EDITION.			
	CONSTRUCTION		ITEM NO.	
	STATE OF MAINE, DEPARTMENT OF TRANSPORTATION STANDARD SPECIFICATIONS, HIGHWAYS AND BRIDGES, REVISION OF NOVEMBER 2014.		202.12	REM
	STATE OF MAINE DEPARTMENT OF TRANSPORTATION STANDARD DETAILS FOR		501.231 501.40	DYN, STE
	HIGHWAYS AND BRIDGES, NOVEMBER 2014 WITH LATEST REVISIONS.		501.40	STE
	AASHTO LRFD BRIDGE CONSTRUCTION SPECIFICATIONS, 4TH EDITION.		501.90	PILE
			501.91 501.92	PILE PILE
	<u>DESIGN LOADING</u> <u>LIVE LOAD</u> -HL-93		5//.09/	ТЕМ
	$\frac{LIVL}{LOAD} = 112-35$		5/4 <b>.</b> 06 604 <b>.</b> /58/	CUR UTIL
	MATERIALS		604 <b>.</b> /582	UTIL
021	<u>CONCRETE</u>	6	604.1583	UTIL
Date:6/11/2021	CLASS AAA			
e:6/	REINFORCING STEEL			
Dat				
	ANCHOR BOLTS ASTM F1554, GRADE 55			<u>L</u>
	<u>STRUCTURAL STEEL</u>			Ι <b>.</b> Γ
	STEEL H-PILES, ASTM A572, GRADE 50			S r
	ALL OTHER STRUCTURAL STEEL SHALL CONFORM TO ASTM A709, GRADE 50			L M
	BASIC DESIGN STRESSES			2
	<u>CONCRETE</u> - CLASS AAA - f'c = 4,500 P.S.I.			C F
				S T
	<u>REINFORCING STEEL</u> - GRADE 60 fy = 60,000 P.S.I.			3
	<u>STRUCTURAL STEEL</u> - ASTM 572, GRADE 50; fy = 50,000 P.S.I. - ASTM 709, GRADE 50; fy = 50,000 P.S.I.			F A
				4
	<u>GENERAL NOTES:</u>			4 T T
	I. THE PROPOSED ELEVATIONS ARE BASED ON THE NAVD 88 DATUM. SOME AS-BUILT			M C
	PLANS ARE BASED ON NGVD 29 DATUM.			S
	2. COPIES OF THE AS-BUILT PLANS ARE ON FILE AT THE MAINE TURNPIKE AUTHOR. THE ACCURACY OF THESE PLANS IS NOT GUARANTEED.	ITY <b>.</b>		5 T
	3. REINFORCING STEEL SHALL HAVE A CLEAR COVER OF 2", UNLESS OTHERWISE NOTE	ED.		
	4. CHAMFER ALL EXPOSED CONCRETE EDGES $\frac{3}{4}$ " UNLESS OTHERWISE NOTED.			6 C
	5. WHERE DRILLING AND ANCHORING OF REINFORCING STEEL IS SPECIFIED THE			T E
	CONTRACTOR SHALL USE A MATERIAL LISTED ON THE MAINEDOT PREQUALIFIED LIST			7
	EPOXY AND RESIN BASED ADHESIVE BONDING SYSTEMS. THE DEPTH OF EMBEDMENT SHALL BE SUFFICIENT TO DEVELOP 125% OF THE YIELD STRENGTH OF THE BAR, BUT			S
	SHALL BE NO LESS THAN THE MINIMUM DEPTH OF EMBEDMENT WHEN SPECIFIED.			T
	6. DIMENSIONS WITH RESPECT TO EXISTING STRUCTURES ARE APPROXIMATE AND AR PROVIDED FOR REFERENCE, IF FIELD CONDITIONS VARY BY MORE THAN I" FROM	Έ		0
	DIMENSIONS SHOWN ON THE PLANS, THE ENGINEER SHALL BE NOTIFIED.			อ F
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<del>~</del>				
Rev.				
General Notes	NO SCALE			
sner		B		
11	No.     Revision     By     Date       1     CONCRETE REMOVAL QUANTITY     BRG     06/21			
e: 019	CONSULTANT PROJECT MANAGER: Dale	A. Mitchell,	P.E.	
Filename:	By     Date       Designed     BRG     03/21	cked	By JDW	Date 03/21
Filer	Designed BRG 03/21 Che Drawn ERB 03/21 In C			03/21
L		•	I	

011				]		INDEX OF DRAWINGS	
QUA	ANTITY TABLE				PAGE NO.	TITLE	SHEET NO.
DF	SCRIPTION	UNIT	STRUCTURAL		19	STRUCTURAL PLANS GENERAL NOTES	
			QUANTITY		20	UTILITY VAULT DETAILS STA. 2340+52.8/	S-02
REMOVE EXISTING STRUCTURAL CONCRETE		CY	( 50 )	//	21	UTILITY VAULT DETAILS STA. 2340+52.8/ - DETAILS I	S-03
DYNAMIC LOAD TEST		EA	2		22	UTILITY VAULT DETAILS STA. 2340+52.8/ - DETAILS II	S-04
STEEL H-BEAM PILES, 53 LB/FT, DELIVEREL	)	LF	865		23	UTILITY VAULT DETAILS STA. 2340+52.8/ - DETAILS III	S-05
STEEL H-BEAM PILES, 53 LB/FT, IN PLACE		LF	865		24	UTILITY VAULT DETAILS STA. 2340+52.81 - DETAILS IV	S-06
PILE TIPS		EA	10		25	UTILITY VAULT DETAILS STA. 2340+52.81 - REINFORCING SCHEDULE	S-07
PILE SPLICES		EA	10		26	UTILITY VAULT DETAILS STA. 2360+02.55	S-08
PILE DRIVING EQUIPMENT MOBILIZATION		LS	1		27	UTILITY VAULT DETAILS STA. 2360+02.55 - DETAILS I	S-09
TEMPORARY EARTH SUPPORT SYSTEMS		LS	/		28	UTILITY VAULT DETAILS STA. 2360+02.55 - DETAILS II	S-10
CURING BOX FOR CONCRETE CYLINDERS		EA	1		29	UTILITY VAULT DETAILS STA. 2360+02.55 - DETAILS III	S-11
UTILITY VAULT EXTENSION - STA 2360+02.55	NB	LS	1		30	UTILITY VAULT DETAILS STA. 2360+02.55 - REINFORCING SCHEDULE	S-12
2 UTILITY VAULT EXTENSION - STA 2340+52.8/	NB	LS	1	1			
UTILITY VAULT EXTENSION - STA 2340+52.8/	SB	LS	/	1			

# UTILITY VAULT NOTES:

I. ALL EXISTING DIMENSIONS AND DETAILS ARE TAKEN FROM ORIGINAL DESIGN DRAWINGS AND ARE NOT GUARANTEED. THE CONTRACTOR SHALL DETERMINE AND ESTABLISH ALL DIMENSIONS AND EXISTING DETAILS NECESSARY FOR COMPLETION OF ALL WORK BY FIELD MEASUREMENT AND SURVEY.

2. PAYMENT FOR REMOVAL OF EXISTING CONCRETE AND SAW CUTTING CONCRETE IS INCIDENTAL TO THE RELATED UTILITY VAULT EXTENSION PAY ITEMS. BEFORE REMOVAL OF CONCRETE, THE DEMOLITION LIMIT SHALL BE SAW CUT TO A DEPTH OF I" MINIMUM. CARE SHALL BE TAKEN NOT TO DAMAGE ANY REINFORCING STEEL THAT IS TO REMAIN.

3. BARS BROKEN DURING REMOVAL OF EXISTING CONCRETE SHALL BE REPLACED AT THE CONTRACTOR'S EXPENSE BY DRILLING AND ANCHORING AN EQUIVALENT SIZED BAR.

4. THE CONTRACTOR SHALL DEVELOP A CONSTRUCITON PROCEDURE, TEMPORARY WATER MAIN SUPPORT, AND TEMPORARY SUPPORT SYSTEMS THAT WILL PROTECT, AT ALL TIMES, THE 42" WATER MAINS. EACH WATER MAIN WILL BE REMOVED FROM SERVICE DURING THE WORK BY CLOSING THE VALVES ON EACH SIDE OF THE WORK AREA. SEE SPECIAL PROVISION 604 FOR ADDITIONAL INFORMATION.

5. THE UTILITY VAULTS SHALL FOLLOW THE HORIZONTAL ALIGNMENT OF THE EXISTING WATER MAIN.

6. MANHOLES SHALL BE NEENAH FOUNDRY COMPANY, R-6660-NH SERIES CATALOG NUMBER R-6660-NH, OR APPROVED EQUIVALENT. PAYMENT FOR THE MANHOLES ARE INCIDENTAL TO THE RELATED 604 UTILITY VAULT EXTENSION PAY ITEMS.

7. PREPARATION OF THE EXISTING CONCRETE SHALL PRODUCE A SOUND, CLEAN SURFACE FREE OF BOND INHIBITING MATERIALS. ANY CONCRETE AREAS FOUND TO BE UNSOUND SHALL BE RE-CHIPPED BY THE CONTRACTOR. PAYMENT SHALL BE INCIDENTAL TO THE RELATED UTILITY VAULT EXTENSION PAY ITEMS.

8. APPLY A BONDING AGENT TO THE EXISTING CONCRETE SURFACES PRIOR TO PLACING NEW CONCRETE. THE MANUFACTURER'S INSTRUCTIONS FOR THE SELECTED BONDING AGENT MUST BE FOLLOWED AND APPROVED BY THE ENGINEER. PAYMENT SHALL BE INCIDENTAL TO THE RELATED UTILITY VAULT EXTENSION PAY ITEMS.

9. FOR MANHOLE STEP DETAILS SEE MAINE DEPARTMENT OF TRANSPORTATION STANDARD DETAILS, PAGE 604(03). PAYMENT SHALL BE INCIDENTAL TO THE RELATED UTILITY VAULT EXTENSION PAY ITEMS.

IO. FOR DETAILS OF EXISTING CONCRETE RETAINING WALL TO BE DEMOLISHED, SEE AS-BUILT PLANS FOR CONTRACT 2001.01.

HNTB CORPORATION

82 Running Hill Road, Suite 201

South Portland, ME 04106

TEL (207) 774-5155 FAX (207) 228-0909

II. STRUCTURAL EXCAVATION AND BACKFILL SHALL BE IN ACCORDANCE WITH MAINEDOT STANDARD SPECIFICATION 206 AND INCIDENTAL TO RELATED 604 PAY ITEMS.

LIST OF ABBREVIATIONS ABUT. - ABUTMENT ADDL. - ADDITIONAL ALT. - ALTERNATE APPROX. - APPROXIMATELY BOT. - BOTTOM BRG. - BEARING CB - CATCH BASIN CIP - CAST IN PLACE CL. - CLEAR/CLASS *Q* - CENTERLINE CONC. - CONCRETE CONSTR. - CONSTRUCTION CY - CUBIC YARD DEMO. - DEMOLITION DIA. - DIAMETER EA. - EACH EB - EASTBOUND E.F. - EACH FACE EL - ELEVATION EQ. - EQUAL



THE GOLD STAR MEMORIAL HIGHWAY

EXIST. - EXISTING EXP. - EXPANSION F.F. - FAR FACE JT. - JOINT LF - LINEAR FOOT LT. - LEFT MAX. - MAXIMUM MEDOT - MAINE DEPARTMENT OF TRANSPORTATION MIN. - MINIMUM MTA - MAINE TURNPIKE AUTHORITY NB - NORTHBOUND N.F. - NEAR FACE N.T.S. - NOT TO SCALE OC - ON CENTER OHSS - OVERHEAD SIGN STRUCTURE OPT - OPTION PED. - PEDESTAL PGL - PROFILE GRADE LINE P - PLATE


PROP. - PROPOSED P.S.I. - POUNDS per SQUARE INCH RCP - REINFORCED CONCRETE PIPE RDWY. - ROADWAY RT. - RIGHT SHLDR. - SHOULDER SB - SOUTHBOUND SF - SQUARE FEET SP. - SPACES STA. - STATION TEMP. - TEMPORARY T.&B. - TOP & BOTTOM TPKE. - TURNPIKE TYP. - TYPICAL U.O.N. - UNLESS OTHERWISE NOTED VERT. - VERTICAL V.I.F. - VERIFY IN FIELD WB - WESTBOUND W.P. - WORKING POINT WW - WINGWALL


WATER LINE AND UTILITY VAULTS

# STRUCTURAL PLANS GENERAL NOTES


CONTRACT:2021.02

SHEET NUMBER: S-01

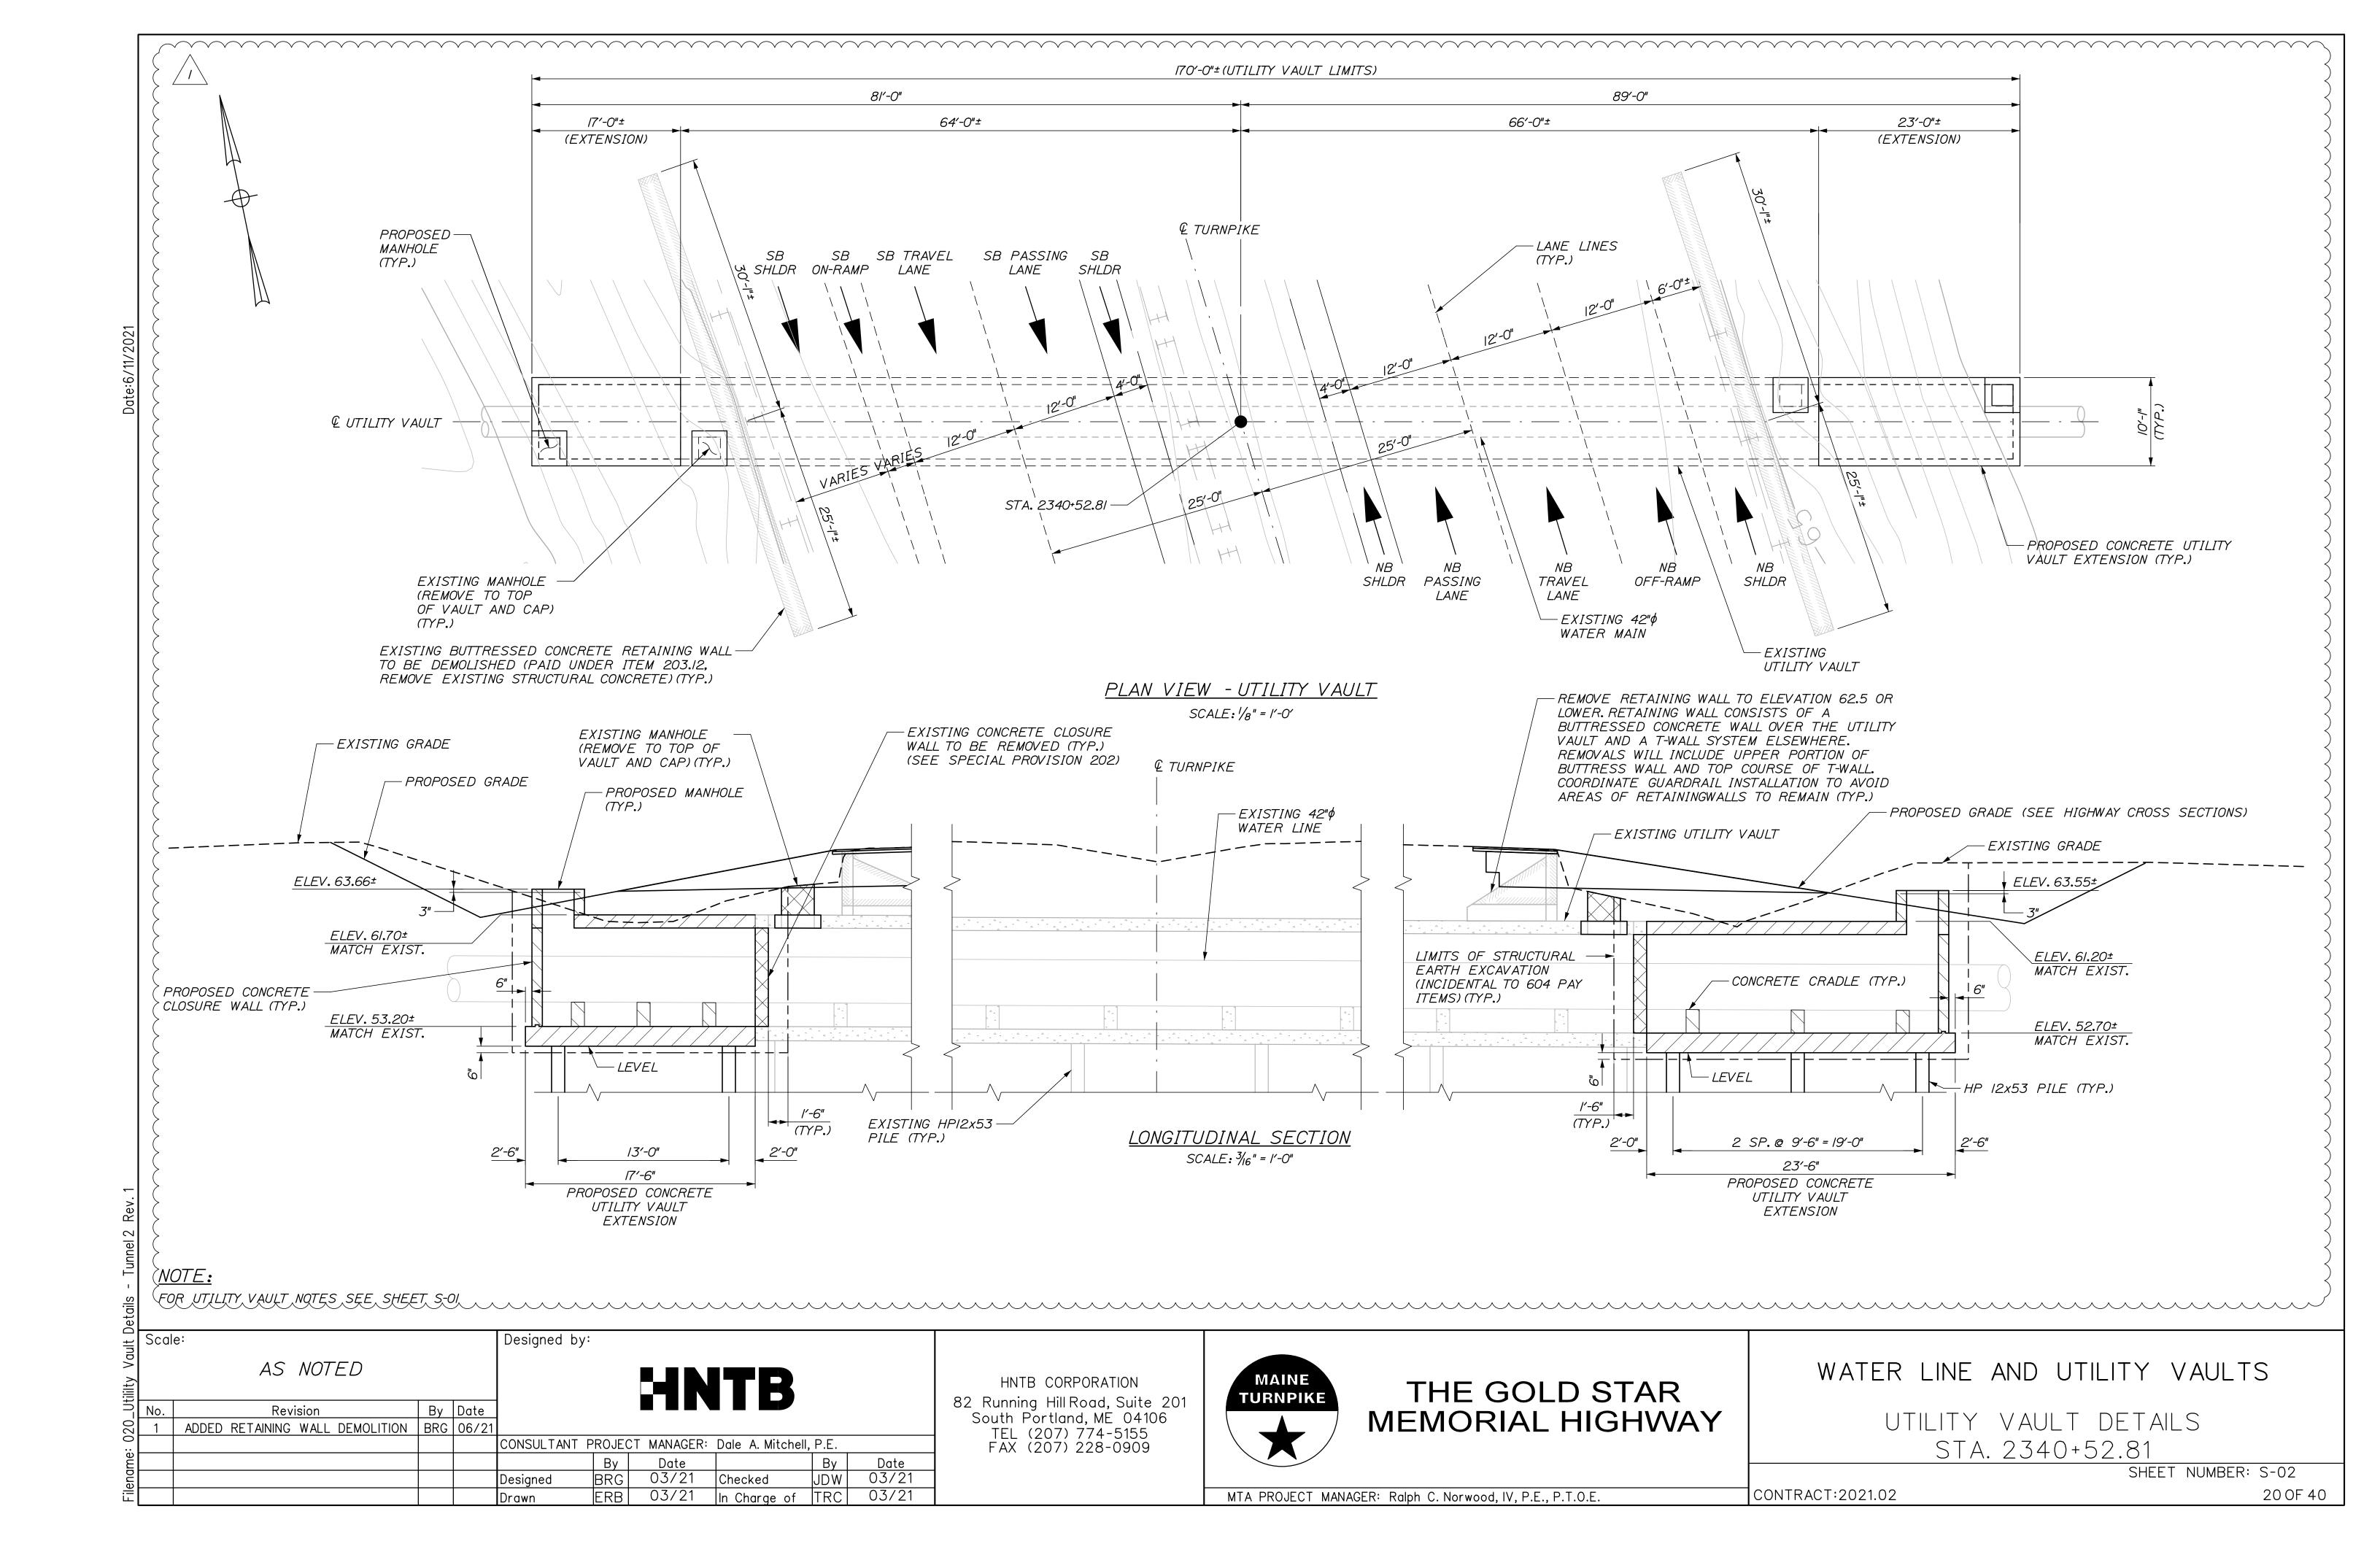

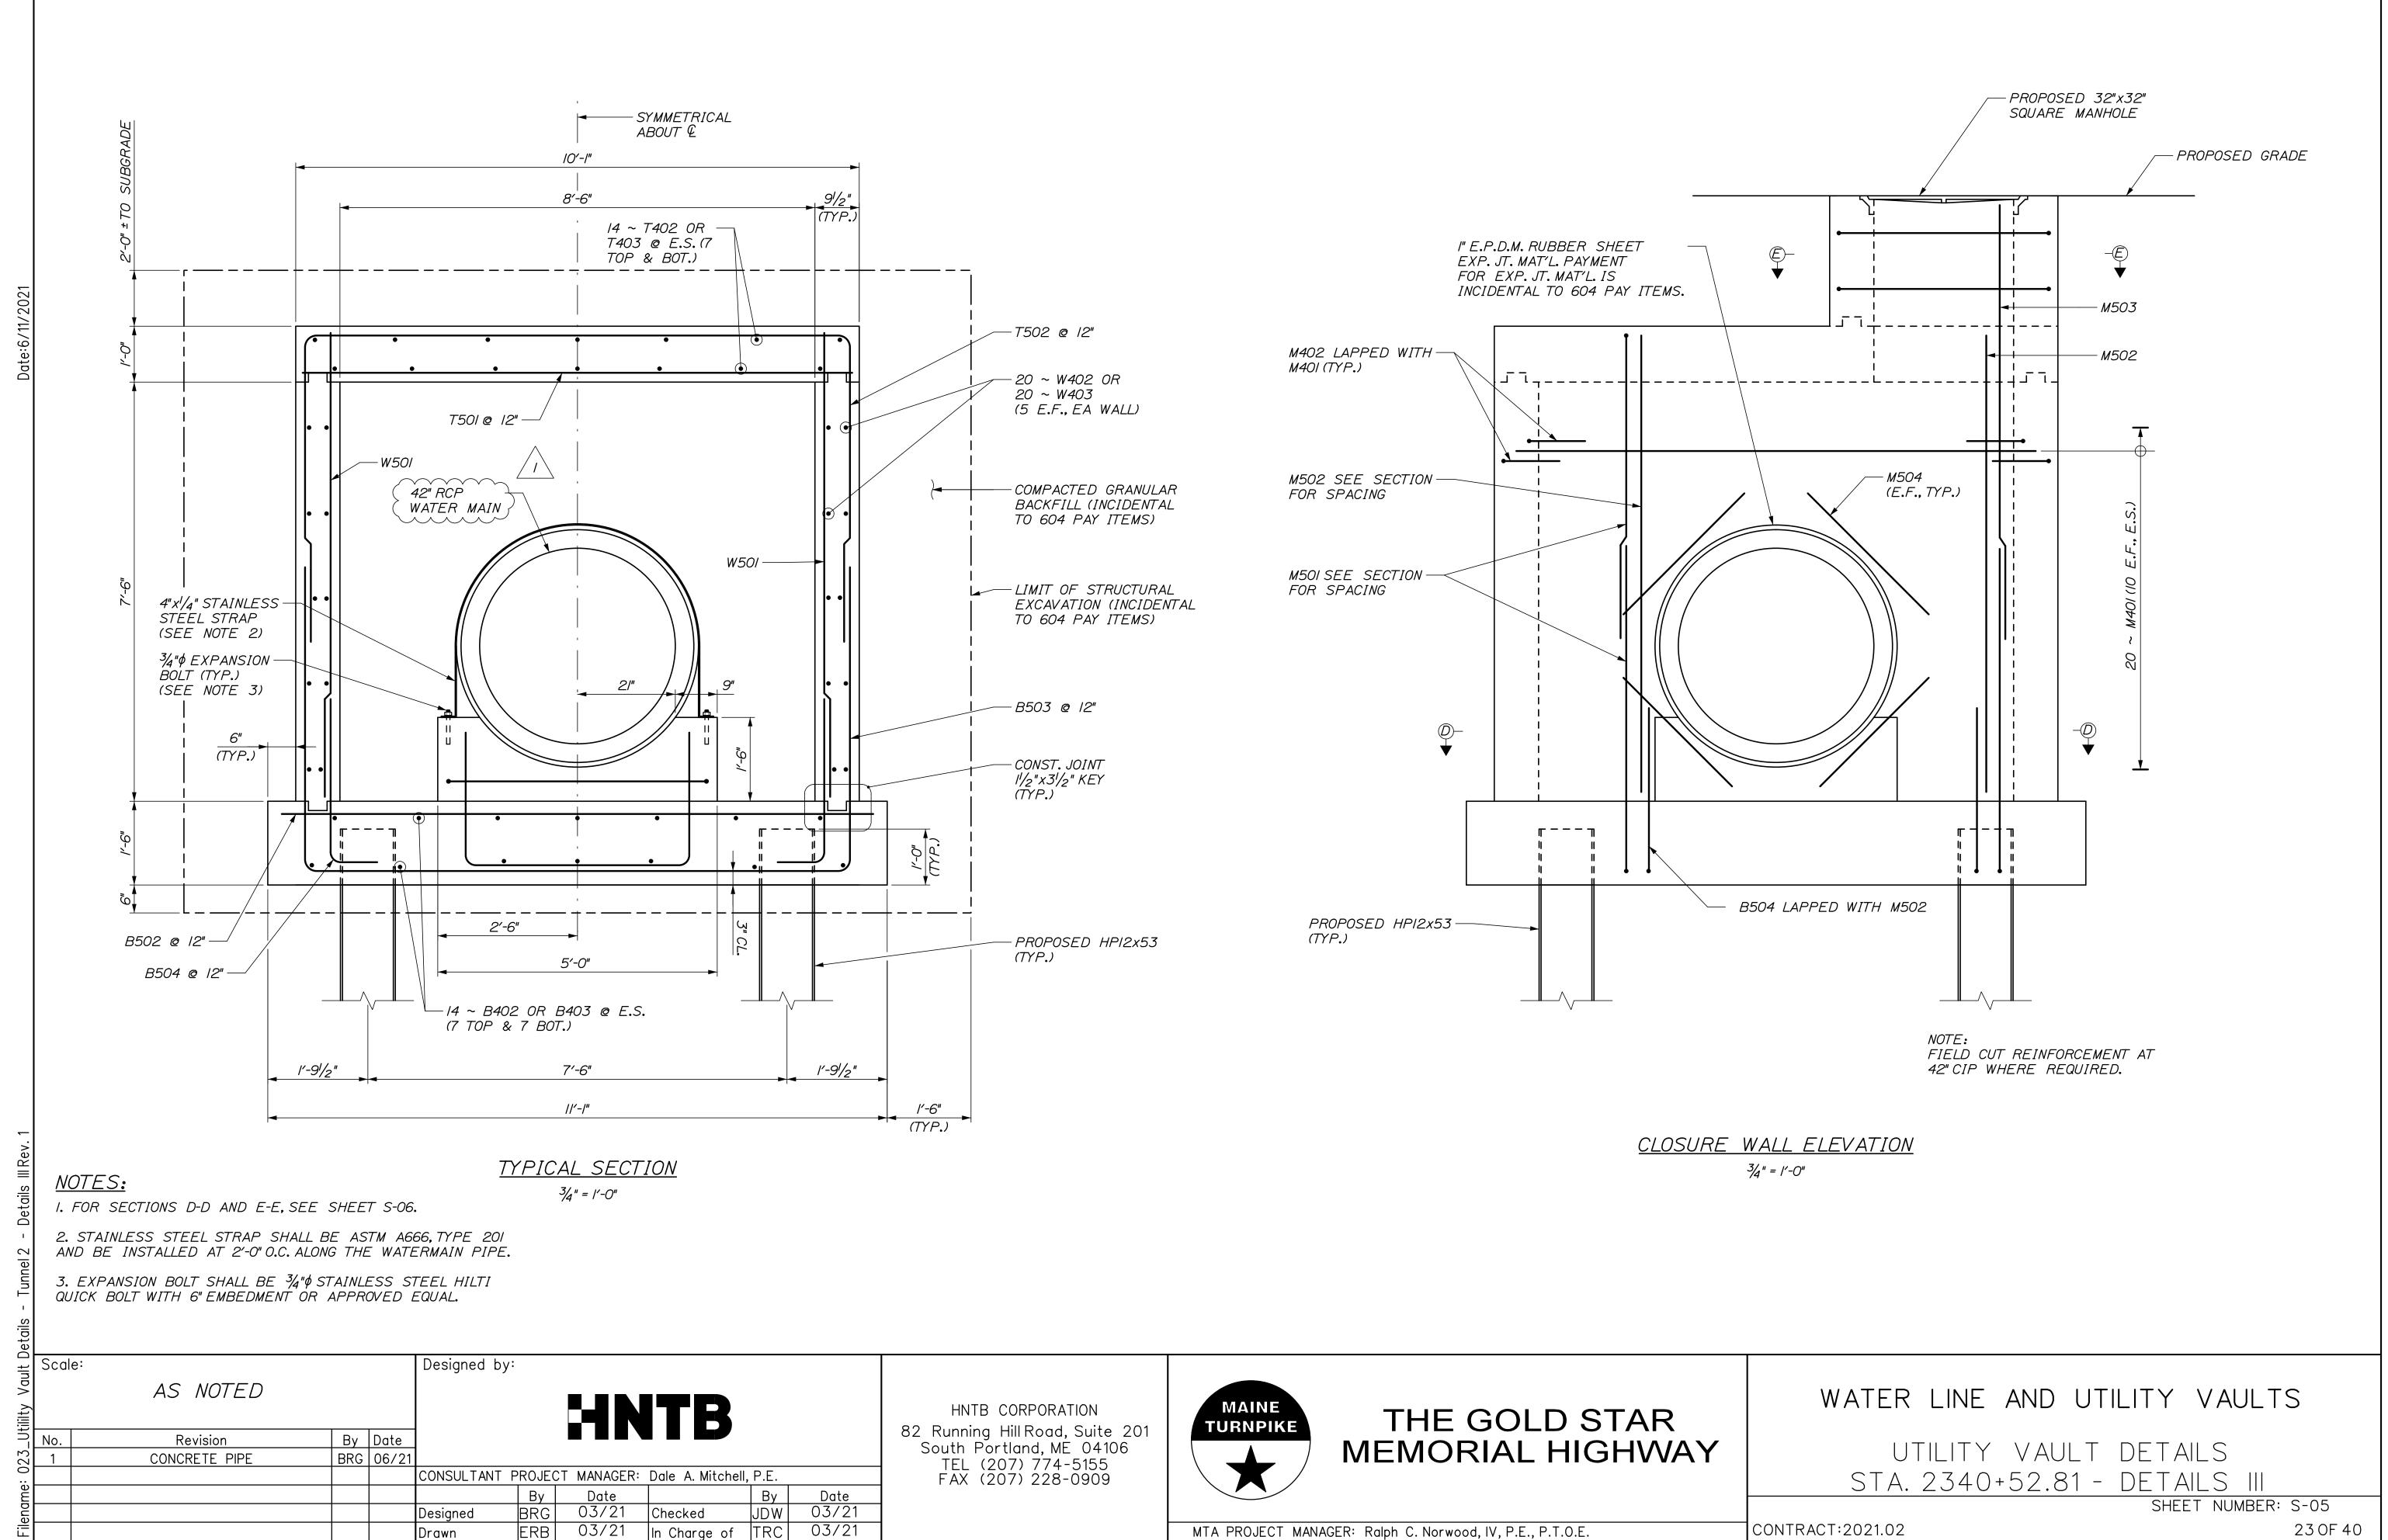

MTA PROJECT MANAGER: Ralph C. Norwood, IV, P.E., P.T.O.E.

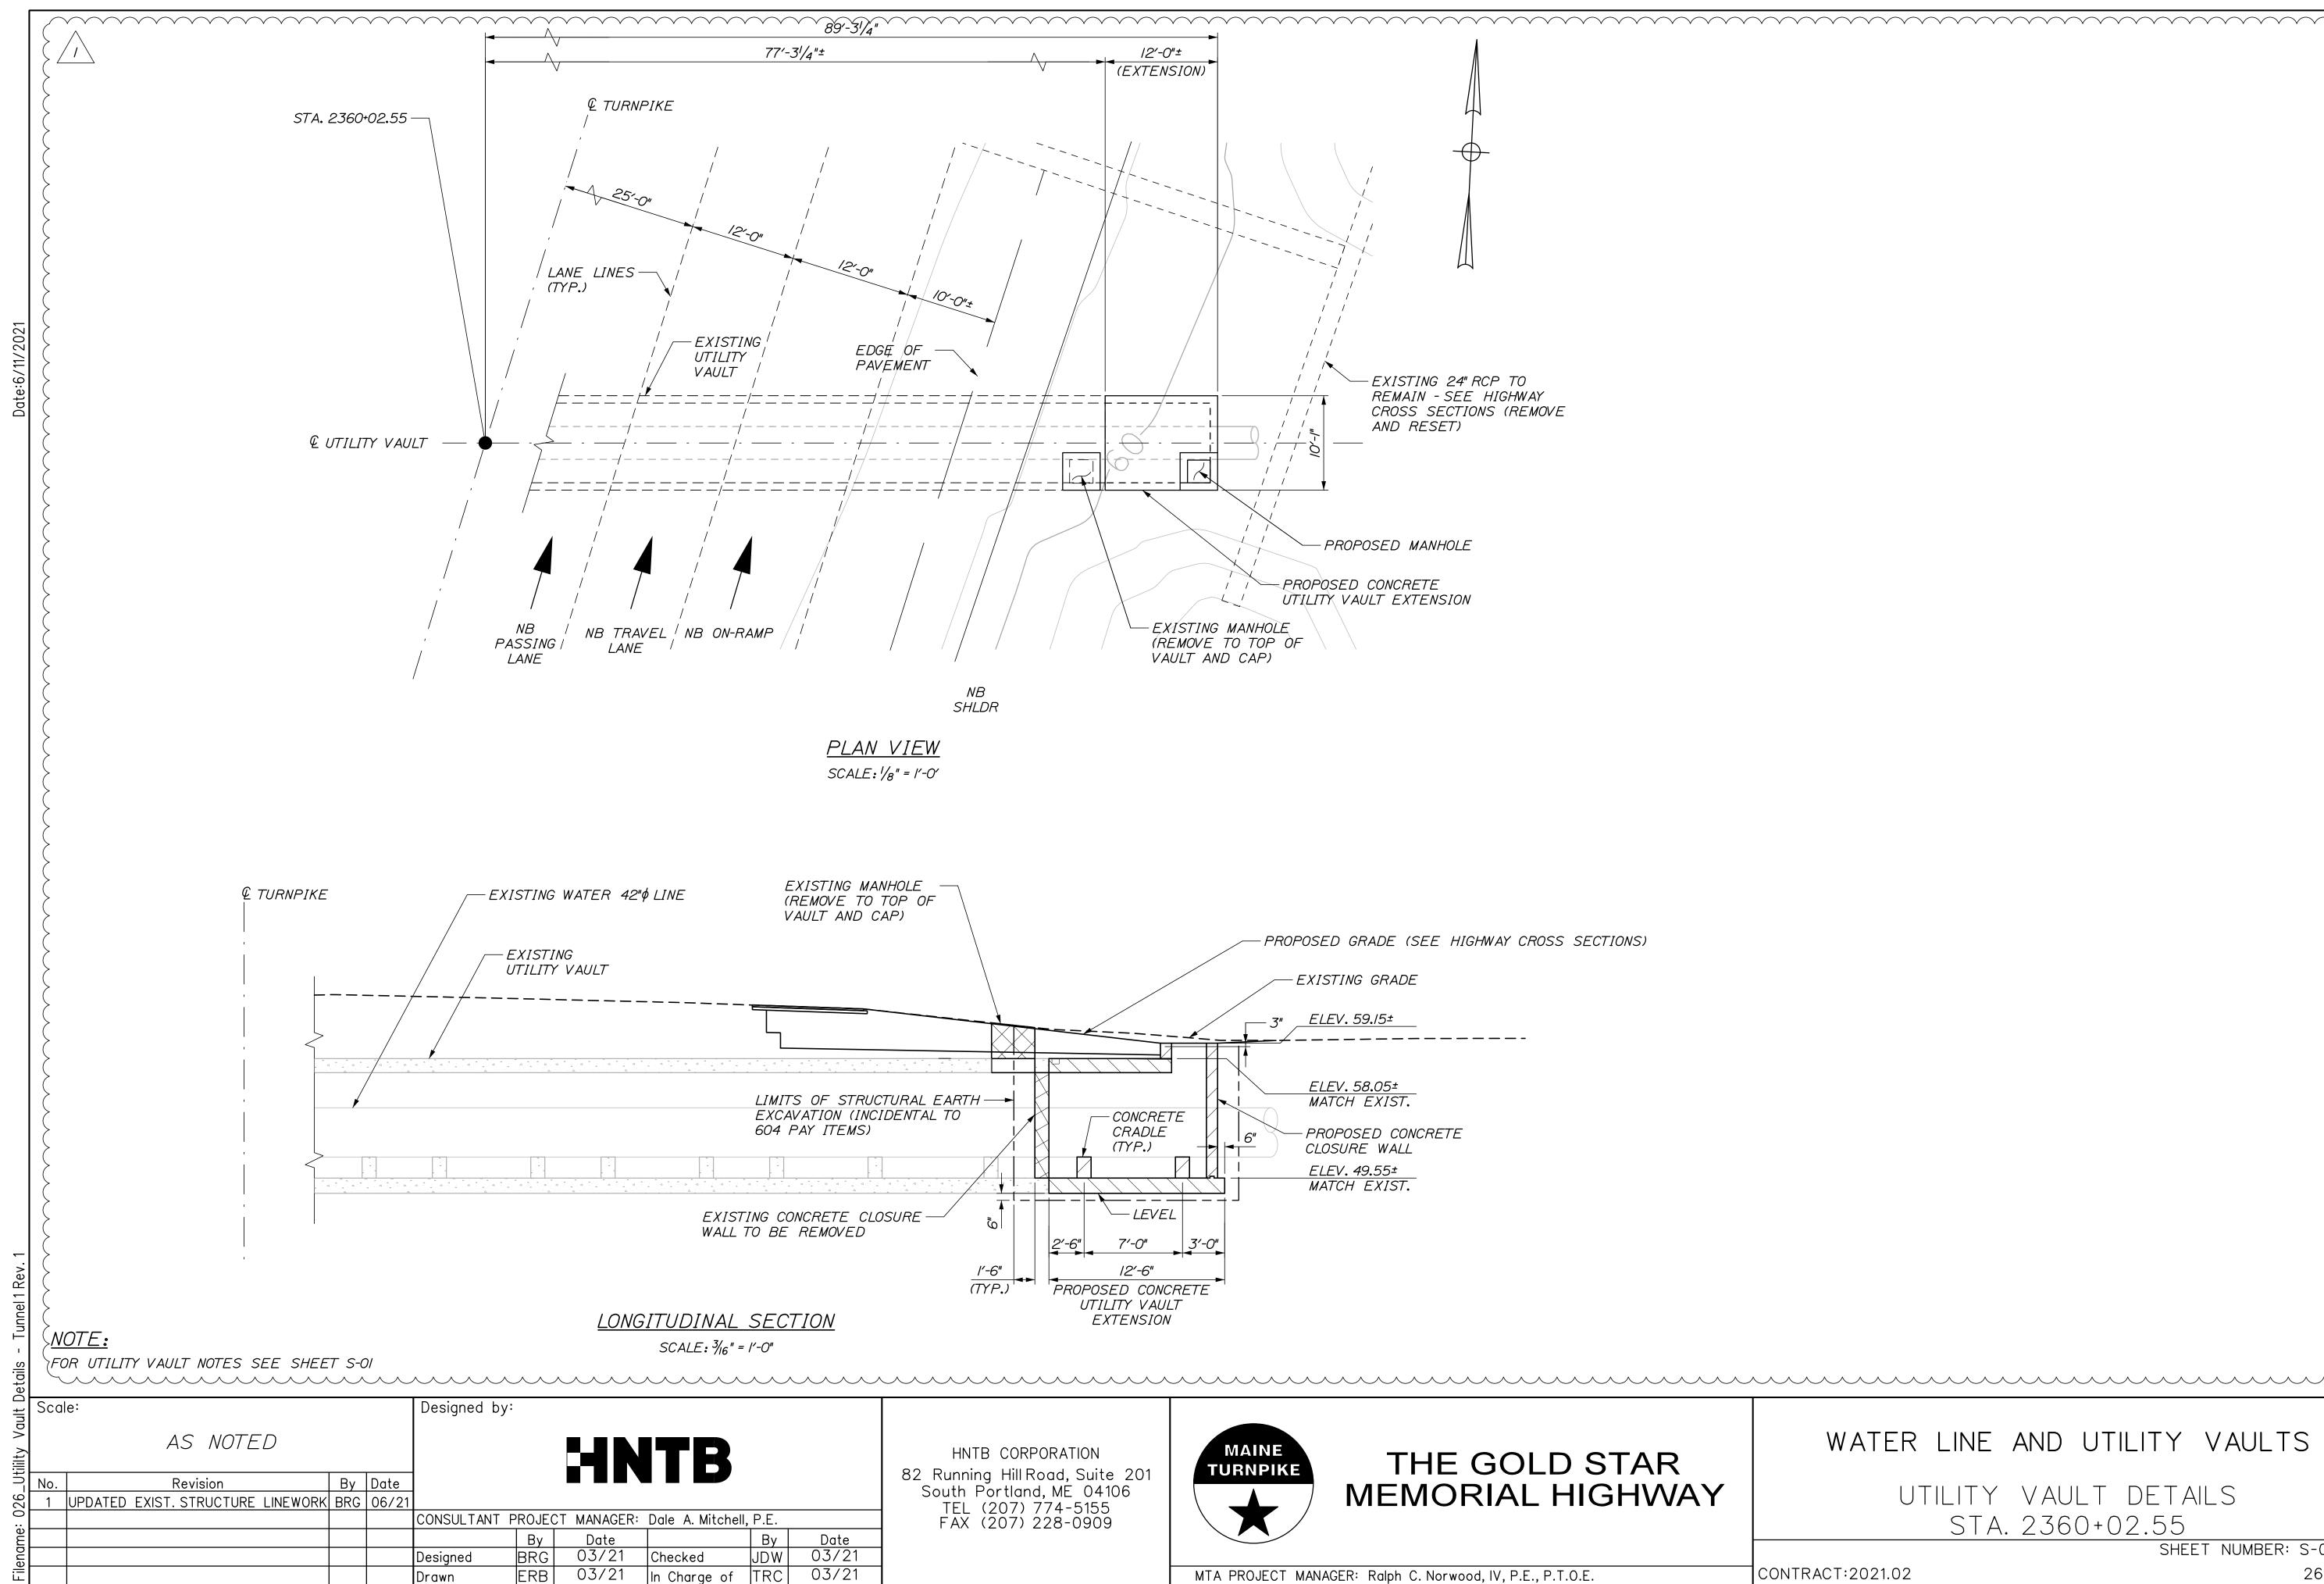

MTA PROJECT MANAGER: Ralph C. Norwood, IV, P.E., P.T.O.E.

SHEET NUMBER: S-08


STA. 2360+02.55

WATER LINE AND UTILITY VAULTS

UTILITY VAULT DETAILS


26 OF 40

B PROPOSED				
SOUTHBOUND OFF RAMP			INDEX OF DRAWINGS	
			SHEET NO.TITLEPWD-S1GENERAL PLAN	
		B PROPOSED	PWD-S2 PLAN & ELEVATION	
		ON RAMP	PWD-S3 DETAILS PWD-S4 REINFORCING SCHEDULE	
EXISITING 42" CIP WATER MAIN PROPOSED TOE OF SLOPE	INE TPKE.	BORTLAND WATER DISTRICT	AS-BUILT PLANSSHEET NO.TITLEN/APROPOSED BOX CULVERT FOR 42" C.I. WATERMAIN STA. 2360+08.	
SHOULDER 10			QUANTITIES	
		/   ,	QUANTITES       TEM NO.     DESCRIPTION       QUANTITY	
EXISTING			206.061 STRUCTURAL EARTH EXCAVATION – DRAINAGE 390	C.Y.
NOADWAY	12'0		MINOR STRUCTURES, BELOW GRADE 170	C.Y.
	EXISTING = SHOUTSTING		502.30STRUCTURAL CONCRETE BOX CULVERT (100 CY)1	L.S.
	12 PROPOS		503.12REINFORCING STEEL, FABRICATED AND DELIVERED9640503.13REINFORCING STEEL, PLACING9640	LBS. LBS.
	LANE		514.06 CURING BOX FOR CONCRETE CYLINDERS 1	EACH
$\frac{PROPOSED TOE}{OF SLOPE}$ $\frac{PLAN}{1" = 20'}$	MAINE TURI NORTHBOUI		DESIGN AASHTO STANDARD SPECIFICATIONS FOR HIGHWAY BRIDGES SIXTEENTH EE 1996 WITH LATEST INTERIM REVISIONS. CONSTRUCTION STATE OF MAINE, DEPARTMENT OF TRANSPORTATION, STANDARD SPECIFIC HIGHWAYS AND BRIDGES, REVISION OF APRIL 1995.	
			<u>DESIGN LIVE LOAD</u> AASHTO HS 25–44	
GENERAL NOTES			<u>DESIGN METHOD</u> LOAD FACTOR DESIGN	
			MATERIALS	
A COPY OF AS-BUILT PLAN IS INCLUDED IN THIS CONTRACT FOR THE CONTRACTOR'S CONVENIENCE. THE COMPLETENESS AND ACCURACY	ABBR	EVIATIONS	<u>CONCRETE</u> f'c = 4,000 P.S.I. (CLASS A)	
OF THIS PLAN IS NOT GUARANTEED.	N.F.	NEAR FACE	REINFORCING STEEL	
BORING LOGS ARE INCLUDED IN APPENDIX G OF THE SPECIFICATIONS.	F.F. E.F.	FAR FACE EACH FACE	AASHTO M31 GRADE 60 (UNCOATED BARS)	
ALL PROPOSED ELEVATIONS REFERENCE THE NORTH AMERICAN 3. VERTICAL DATUM (NAVD) 1988. THE ELEVATIONS REFERENCED ON THE AS-BUILT PLAN MAY DIFFER.	E.S. CL. T B	EQUALLY SPACED CLEAR TOP BOTTOM	fy = 60,000 P.S.I.	
FOR ADDITIONAL DETAILS REFERENCED OR NOT SHOWN IN THESE 4. DRAWINGS, SEE THE STATE OF MAINE, DEPARTMENT OF TRANSPORTATION, STANDARD DETAILS, HIGHWAYS AND BRIDGES, APRIL 1997.	& TYP. EXIST. PROP.	AND TYPICAL EXISTING PROPOSED		
Scale: AS NOTED			MESTRROOKUNTERCHANG	Furin
	HNTB CORPORATION	MODERNIZATION AND WIDENING PROJECT		_
			42" C.I. WATER MAIN VAUI	ΙT
No.     Revision     By     Date       ARCHITECTS     ENGINEERS     PLANNERS	2 Thomas Drive Westbrook, ME 04092 TEL (207) 774–5155 FAX (207) 772–7410	MAINE TRANS	GENERAL PLAN	
By Date By Date	FAX (207) 772-7410	<b>pass</b>		
Image: style			SHEET NUM	MBER: <b>PWD-S1</b> 34 OF 40

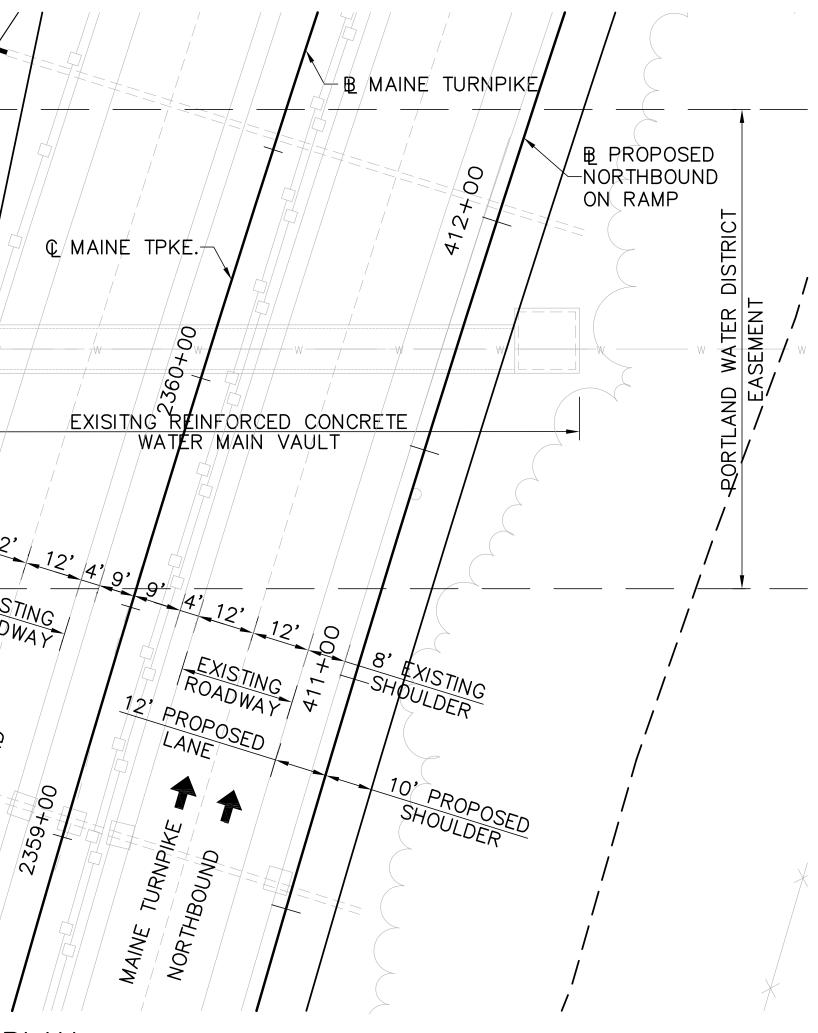

ABBREVIATIONS		
N.F.	NEAR FACE	
F.F.	FAR FACE	
E.F.	EACH FACE	
E.S.	EQUALLY SPACED	
CL.	CLEAR	
Т	TOP	
В	BOTTOM	
&	AND	
TYP.	TYPICAL	
EXIST.	EXISTING	
PROP.	PROPOSED	

	HNTB CORPORATION	MAINE TURNPIKE AUTHORITY MODERNIZATION AND WIDENING PROJECT
	2 Thomas Drive Westbrook, ME 04092 TEL (207) 774-5155 FAX (207) 772-7410	MAINE TURNPIKE TPANS
Date <b>7/01</b>		\ <b>≢</b> ≣pass
7/01		

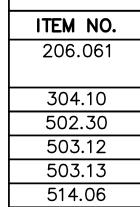




INDEX OF DRAWINGS			
SHEET NO.	TITLE		
PWD-S1	GENERAL PLAN		
PWD-S2	PLAN & ELEVATION		
PWD-S3	DETAILS		
PWD-S4	REINFORCING SCHEDULE		

AS-BUILT PLANS			
SHEET NO.	TITLE		
N/A	PROPOSED BOX CULVERT FOR WATERMAIN STA. 2360+08.	42" C.I.	

# QUANTITIES

DECODIDITION		
DESCRIPTION	QUANTITY	UNIT
STRUCTURAL EARTH EXCAVATION - DRAINAGE	390	C.Y.
MINOR STRUCTURES, BELOW GRADE		
AGGREGATE BASE COURSE – GRAVEL	170	C.Y.
STRUCTURAL CONCRETE BOX CULVERT (100 CY)	1	L.S.
REINFORCING STEEL, FABRICATED AND DELIVERED	9640	LBS.
REINFORCING STEEL, PLACING	9640	LBS.
CURING BOX FOR CONCRETE CYLINDERS	1	EACH


# **SPECIFICATIONS**

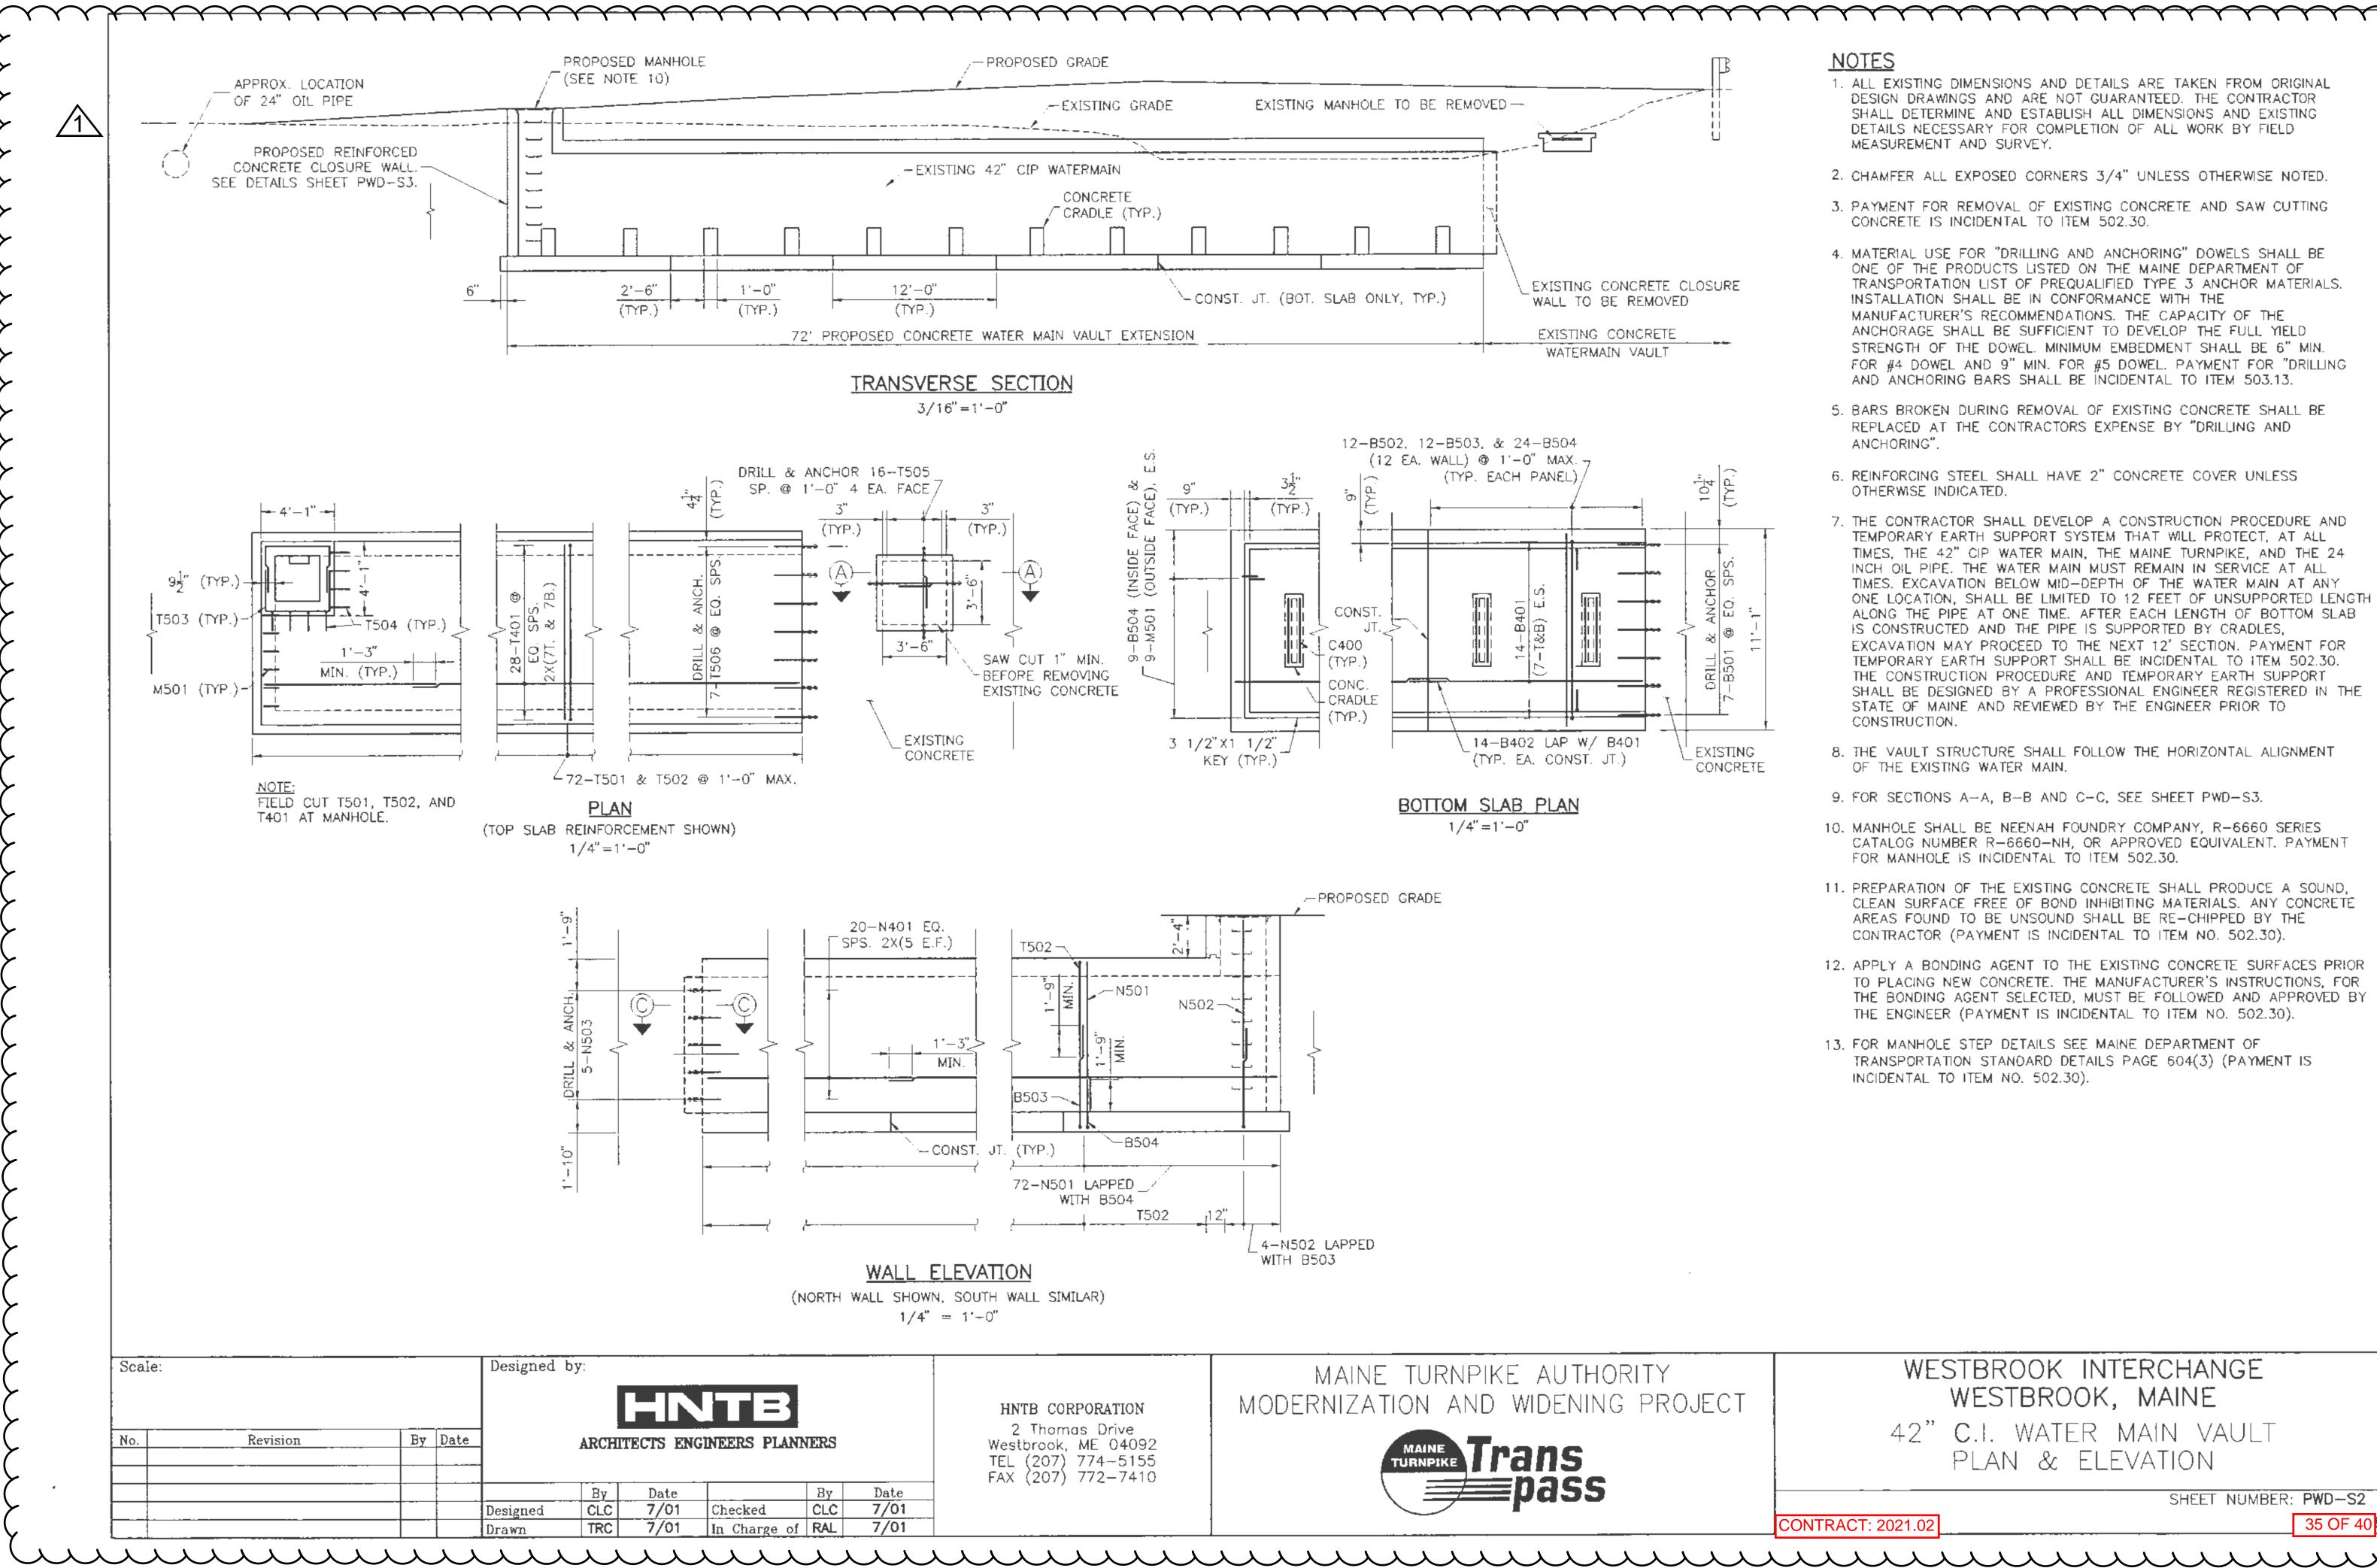


# **NOTES**


- 1. ALL EXISTING DIMENSIONS AND DETAILS ARE TAKEN FROM ORIGINAL DESIGN DRAWINGS AND ARE NOT GUARANTEED. THE CONTRACTOR SHALL DETERMINE AND ESTABLISH ALL DIMENSIONS AND EXISTING DETAILS NECESSARY FOR COMPLETION OF ALL WORK BY FIELD MEASUREMENT AND SURVEY.
- CHAMFER ALL EXPOSED CORNERS 3/4" UNLESS OTHERWISE NOTED.
- 3. PAYMENT FOR REMOVAL OF EXISTING CONCRETE AND SAW CUTTING CONCRETE IS INCIDENTAL TO ITEM 502.30.
- 4. MATERIAL USE FOR "DRILLING AND ANCHORING" DOWELS SHALL BE ONE OF THE PRODUCTS LISTED ON THE MAINE DEPARTMENT OF TRANSPORTATION LIST OF PREQUALIFIED TYPE 3 ANCHOR MATERIALS. INSTALLATION SHALL BE IN CONFORMANCE WITH THE MANUFACTURER'S RECOMMENDATIONS. THE CAPACITY OF THE ANCHORAGE SHALL BE SUFFICIENT TO DEVELOP THE FULL YIELD STRENGTH OF THE DOWEL. MINIMUM EMBEDMENT SHALL BE 6" MIN. FOR #4 DOWEL AND 9" MIN. FOR #5 DOWEL. PAYMENT FOR "DRILLING AND ANCHORING BARS SHALL BE INCIDENTAL TO ITEM 503.13.
- 5. BARS BROKEN DURING REMOVAL OF EXISTING CONCRETE SHALL BE REPLACED AT THE CONTRACTORS EXPENSE BY "DRILLING AND ANCHORING"
- 6. REINFORCING STEEL SHALL HAVE 2" CONCRETE COVER UNLESS OTHERWISE INDICATED.
- 7. THE CONTRACTOR SHALL DEVELOP A CONSTRUCTION PROCEDURE AND TEMPORARY EARTH SUPPORT SYSTEM THAT WILL PROTECT. AT ALL TIMES, THE 42" CIP WATER MAIN, THE MAINE TURNPIKE, AND THE 24 INCH OIL PIPE. THE WATER MAIN MUST REMAIN IN SERVICE AT ALL TIMES, EXCAVATION BELOW MID-DEPTH OF THE WATER MAIN AT ANY ONE LOCATION, SHALL BE LIMITED TO 12 FEET OF UNSUPPORTED LENGTH ALONG THE PIPE AT ONE TIME. AFTER EACH LENGTH OF BOTTOM SLAB IS CONSTRUCTED AND THE PIPE IS SUPPORTED BY CRADLES. EXCAVATION MAY PROCEED TO THE NEXT 12' SECTION. PAYMENT FOR TEMPORARY EARTH SUPPORT SHALL BE INCIDENTAL TO ITEM 502.30. THE CONSTRUCTION PROCEDURE AND TEMPORARY EARTH SUPPORT SHALL BE DESIGNED BY A PROFESSIONAL ENGINEER REGISTERED IN THE STATE OF MAINE AND REVIEWED BY THE ENGINEER PRIOR TO CONSTRUCTION.
- 8. THE VAULT STRUCTURE SHALL FOLLOW THE HORIZONTAL ALIGNMENT OF THE EXISTING WATER MAIN.
- 9. FOR SECTIONS A-A, B-B AND C-C, SEE SHEET PWD-S3.
- 10. MANHOLE SHALL BE NEENAH FOUNDRY COMPANY. R-6660 SERIES CATALOG NUMBER R-6660-NH. OR APPROVED EQUIVALENT. PAYMENT FOR MANHOLE IS INCIDENTAL TO ITEM 502.30.
- 11. PREPARATION OF THE EXISTING CONCRETE SHALL PRODUCE A SOUND, CLEAN SURFACE FREE OF BOND INHIBITING MATERIALS. ANY CONCRETE AREAS FOUND TO BE UNSOUND SHALL BE RE-CHIPPED BY THE CONTRACTOR (PAYMENT IS INCIDENTAL TO ITEM NO. 502.30).
- 12. APPLY A BONDING AGENT TO THE EXISTING CONCRETE SURFACES PRIOR TO PLACING NEW CONCRETE. THE MANUFACTURER'S INSTRUCTIONS, FOR THE BONDING AGENT SELECTED, MUST BE FOLLOWED AND APPROVED BY THE ENGINEER (PAYMENT IS INCIDENTAL TO ITEM NO. 502.30).
- 13. FOR MANHOLE STEP DETAILS SEE MAINE DEPARTMENT OF TRANSPORTATION STANDARD DETAILS PAGE 604(3) (PAYMENT IS INCIDENTAL TO ITEM NO. 502.30).


WESTBROOK INTERCHANGE
WESTBROOK, MAINE
42" C.I. WATER MAIN VAULT
PLAN & ELEVATION
SHEET NUMBER: PWD-S2
CONTRACT: 2021.02 35 OF 40 B

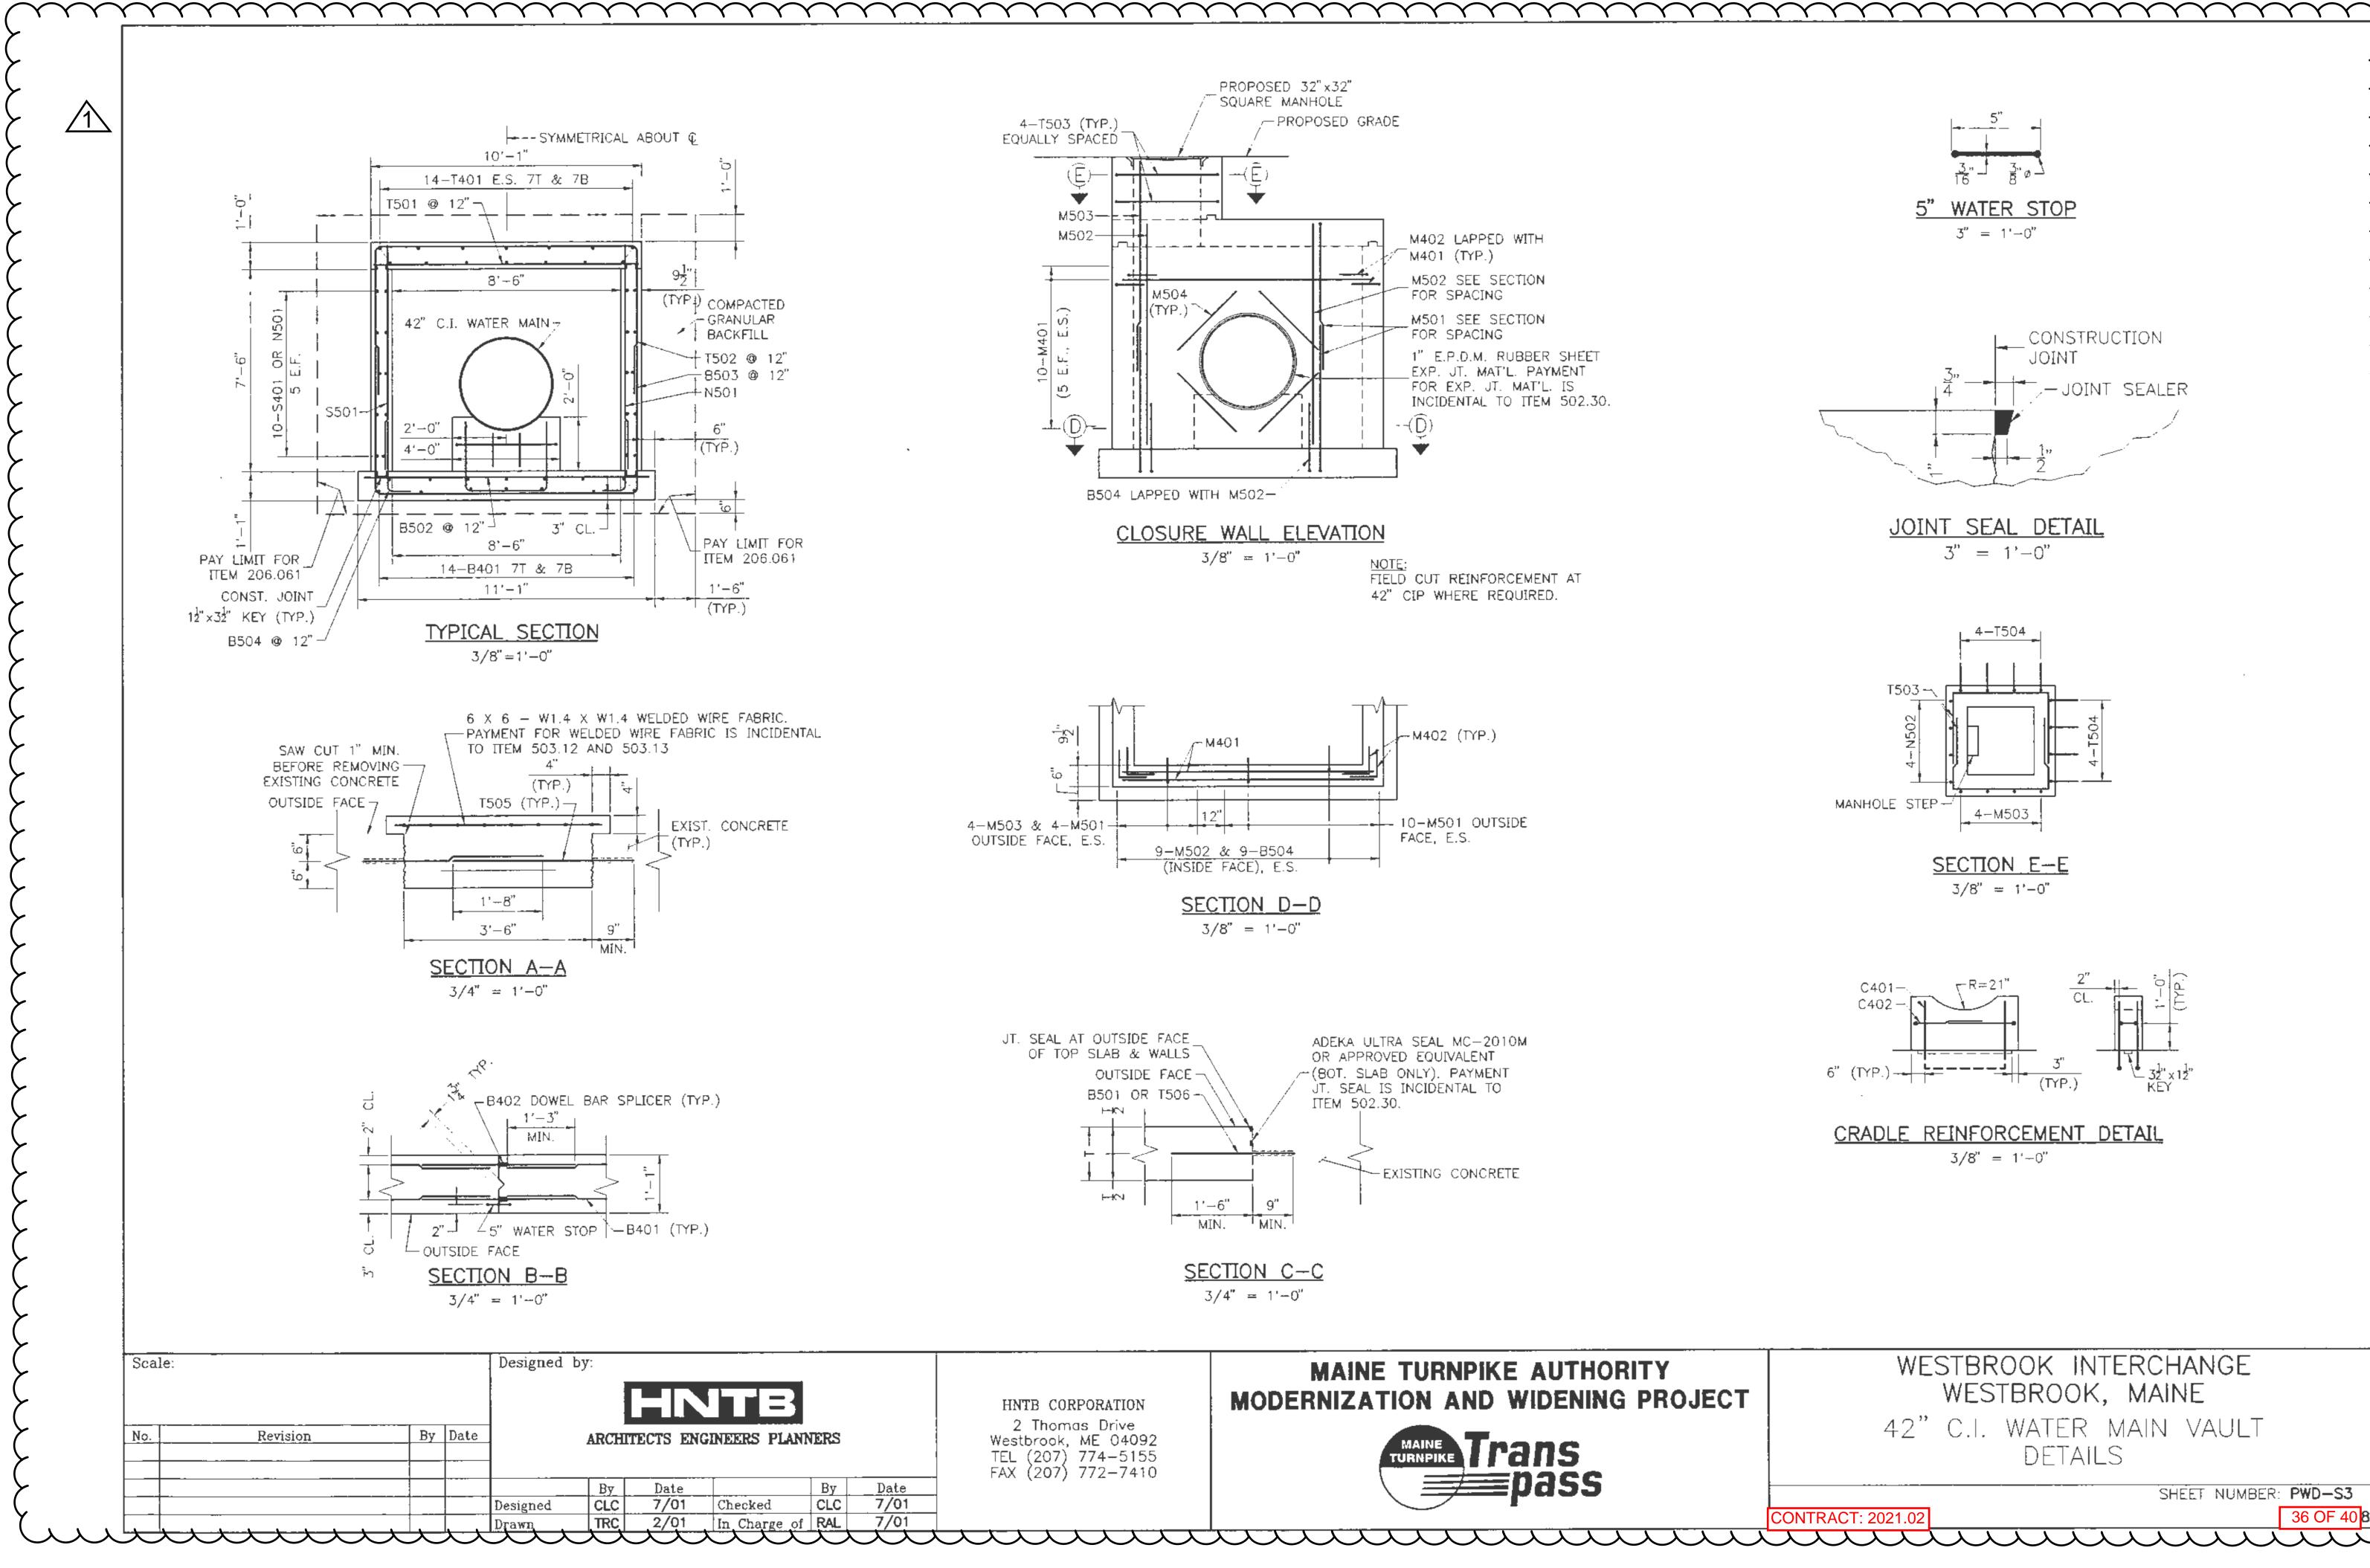

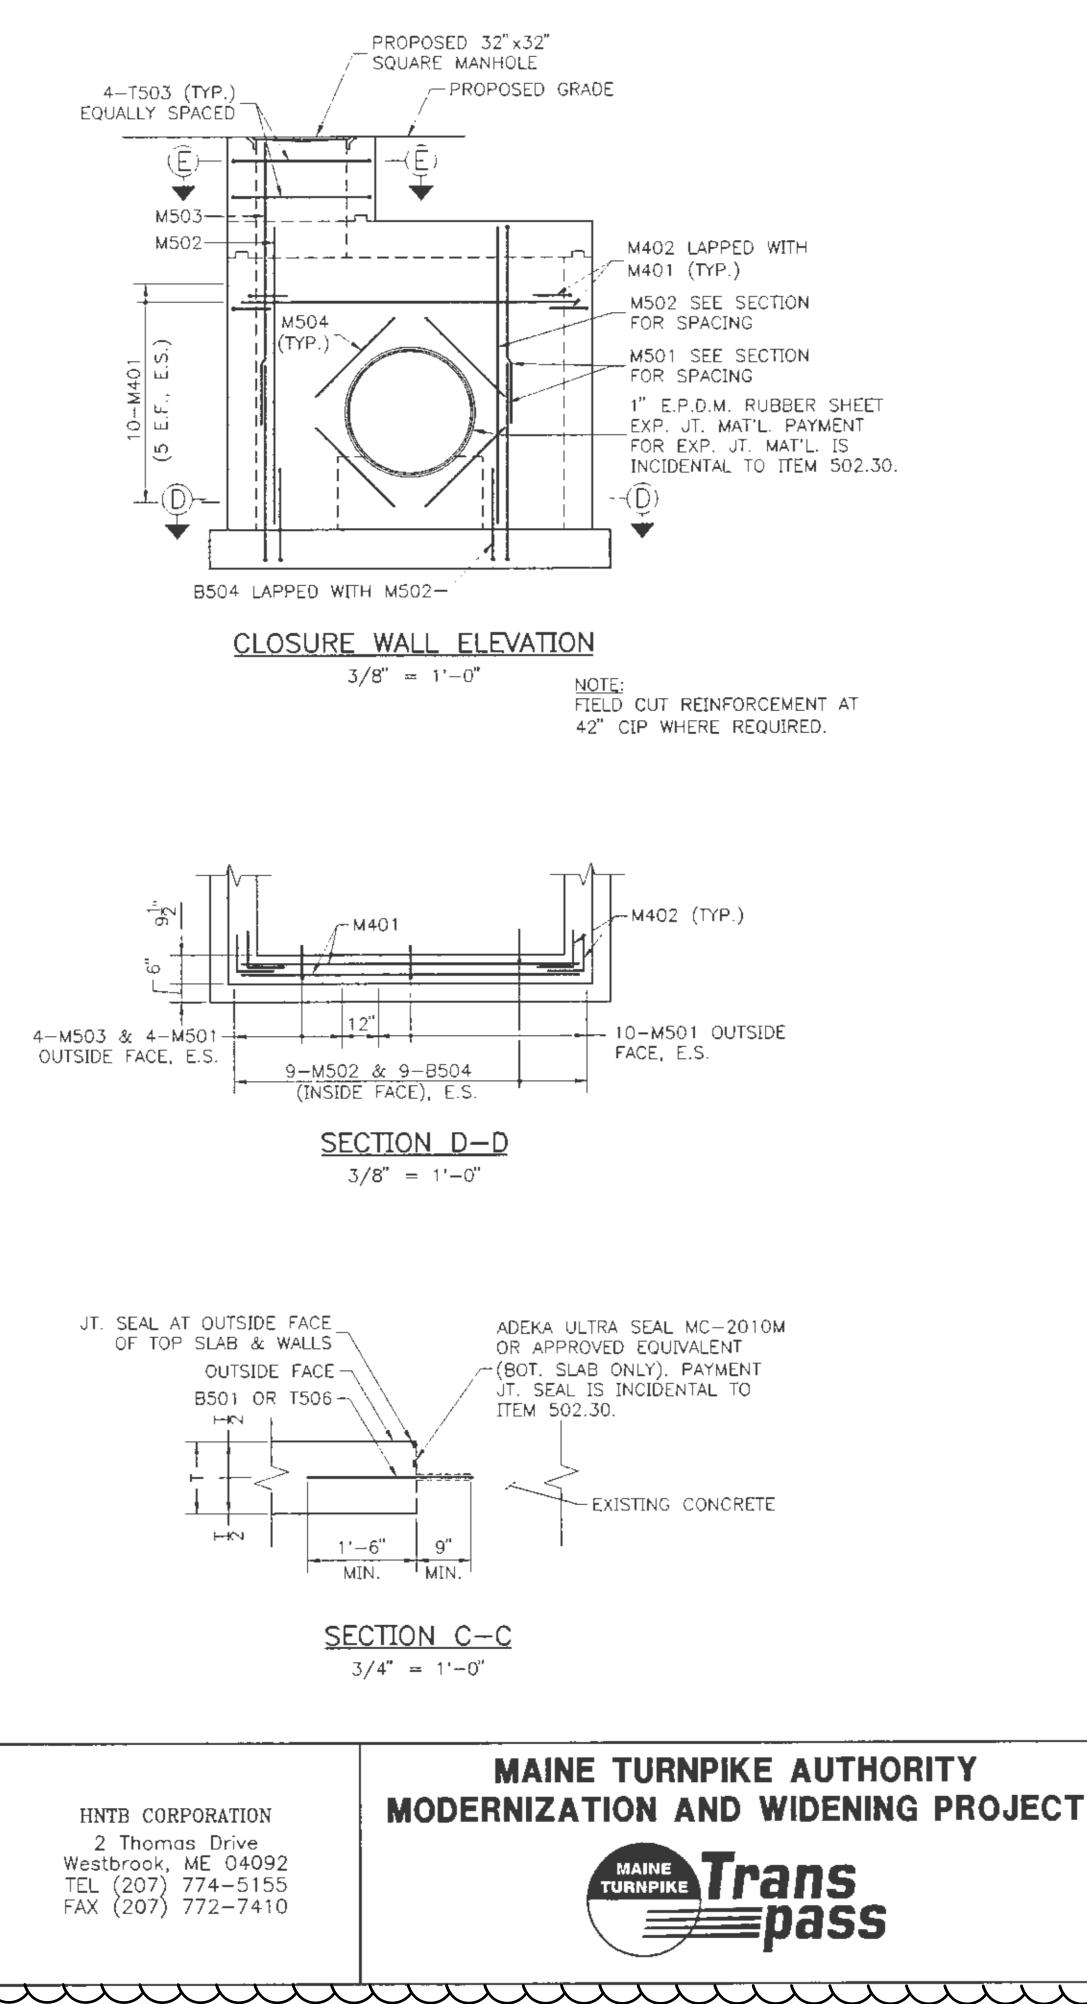


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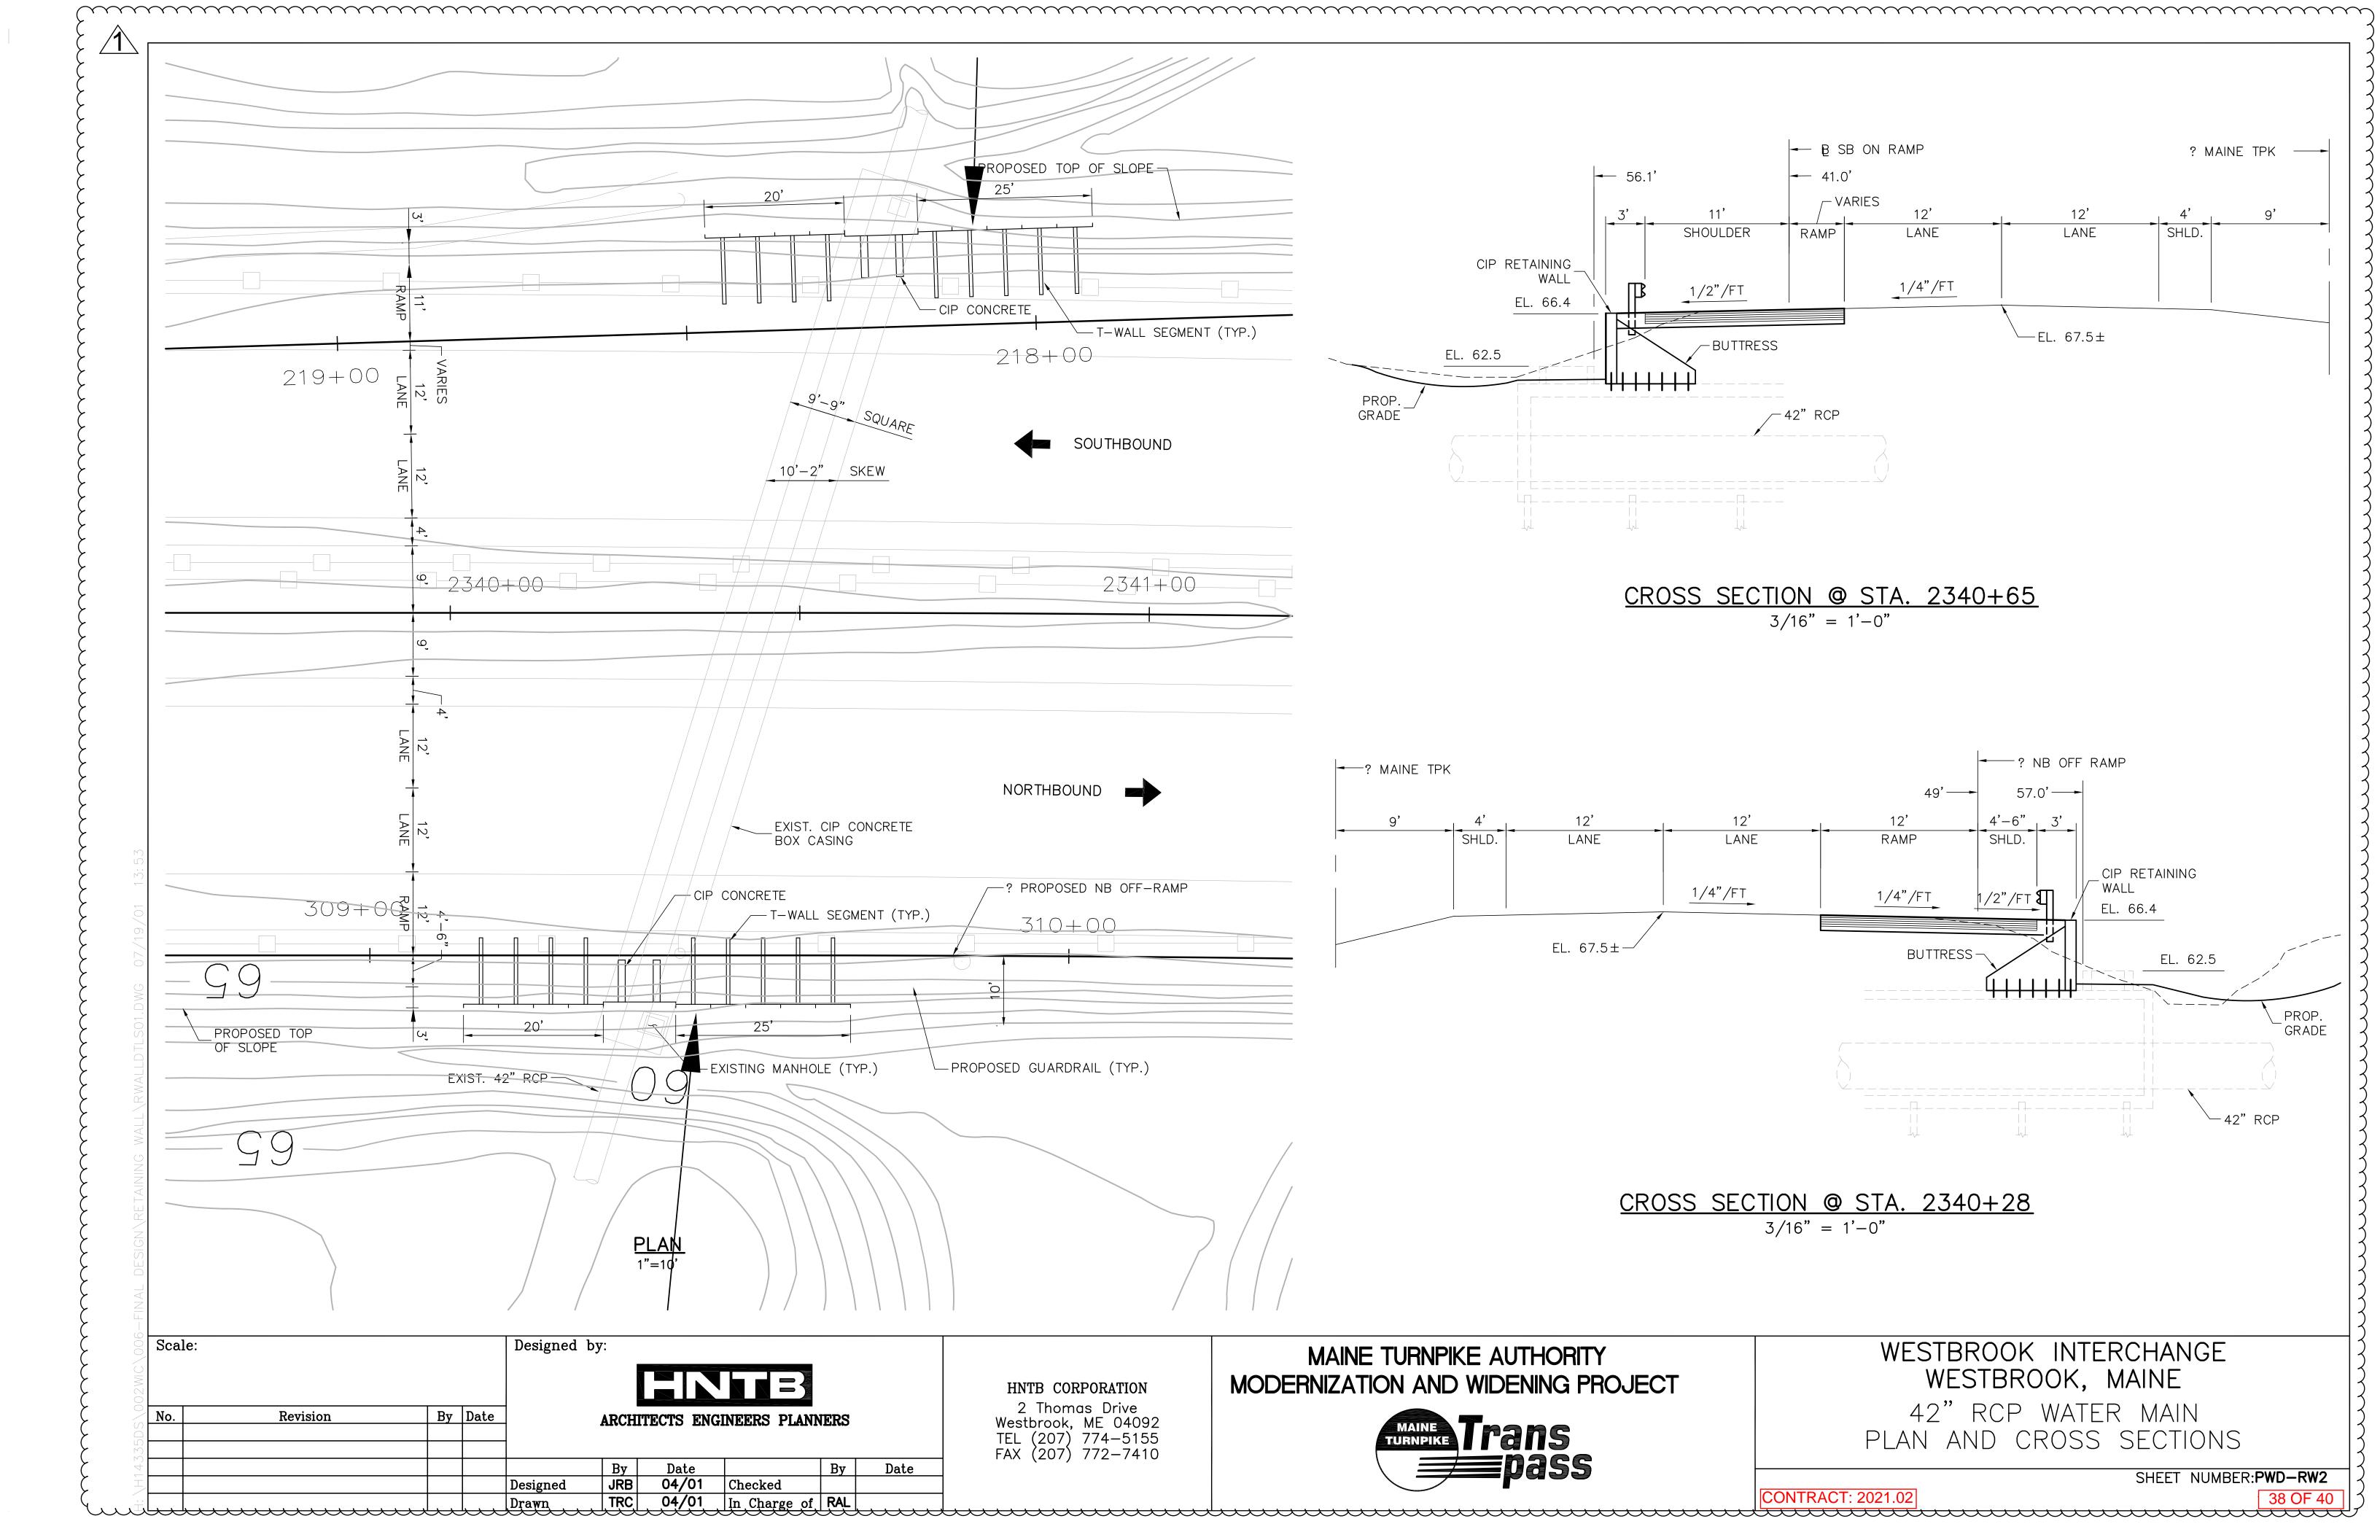


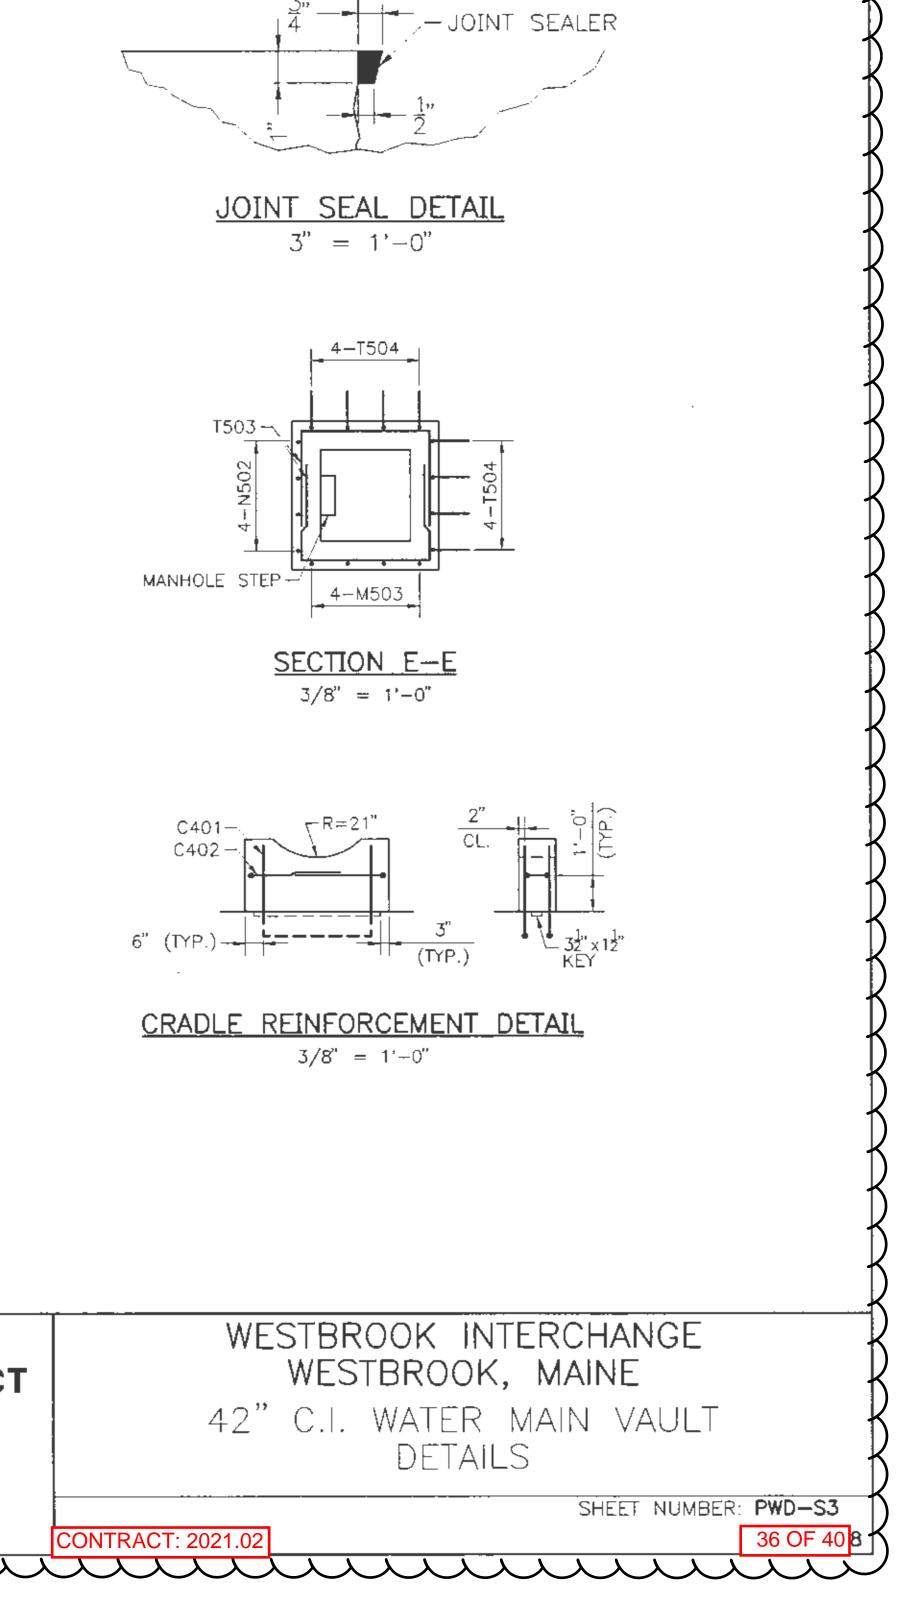


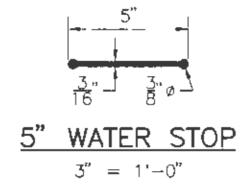
CONSTRUCTION

JOINT



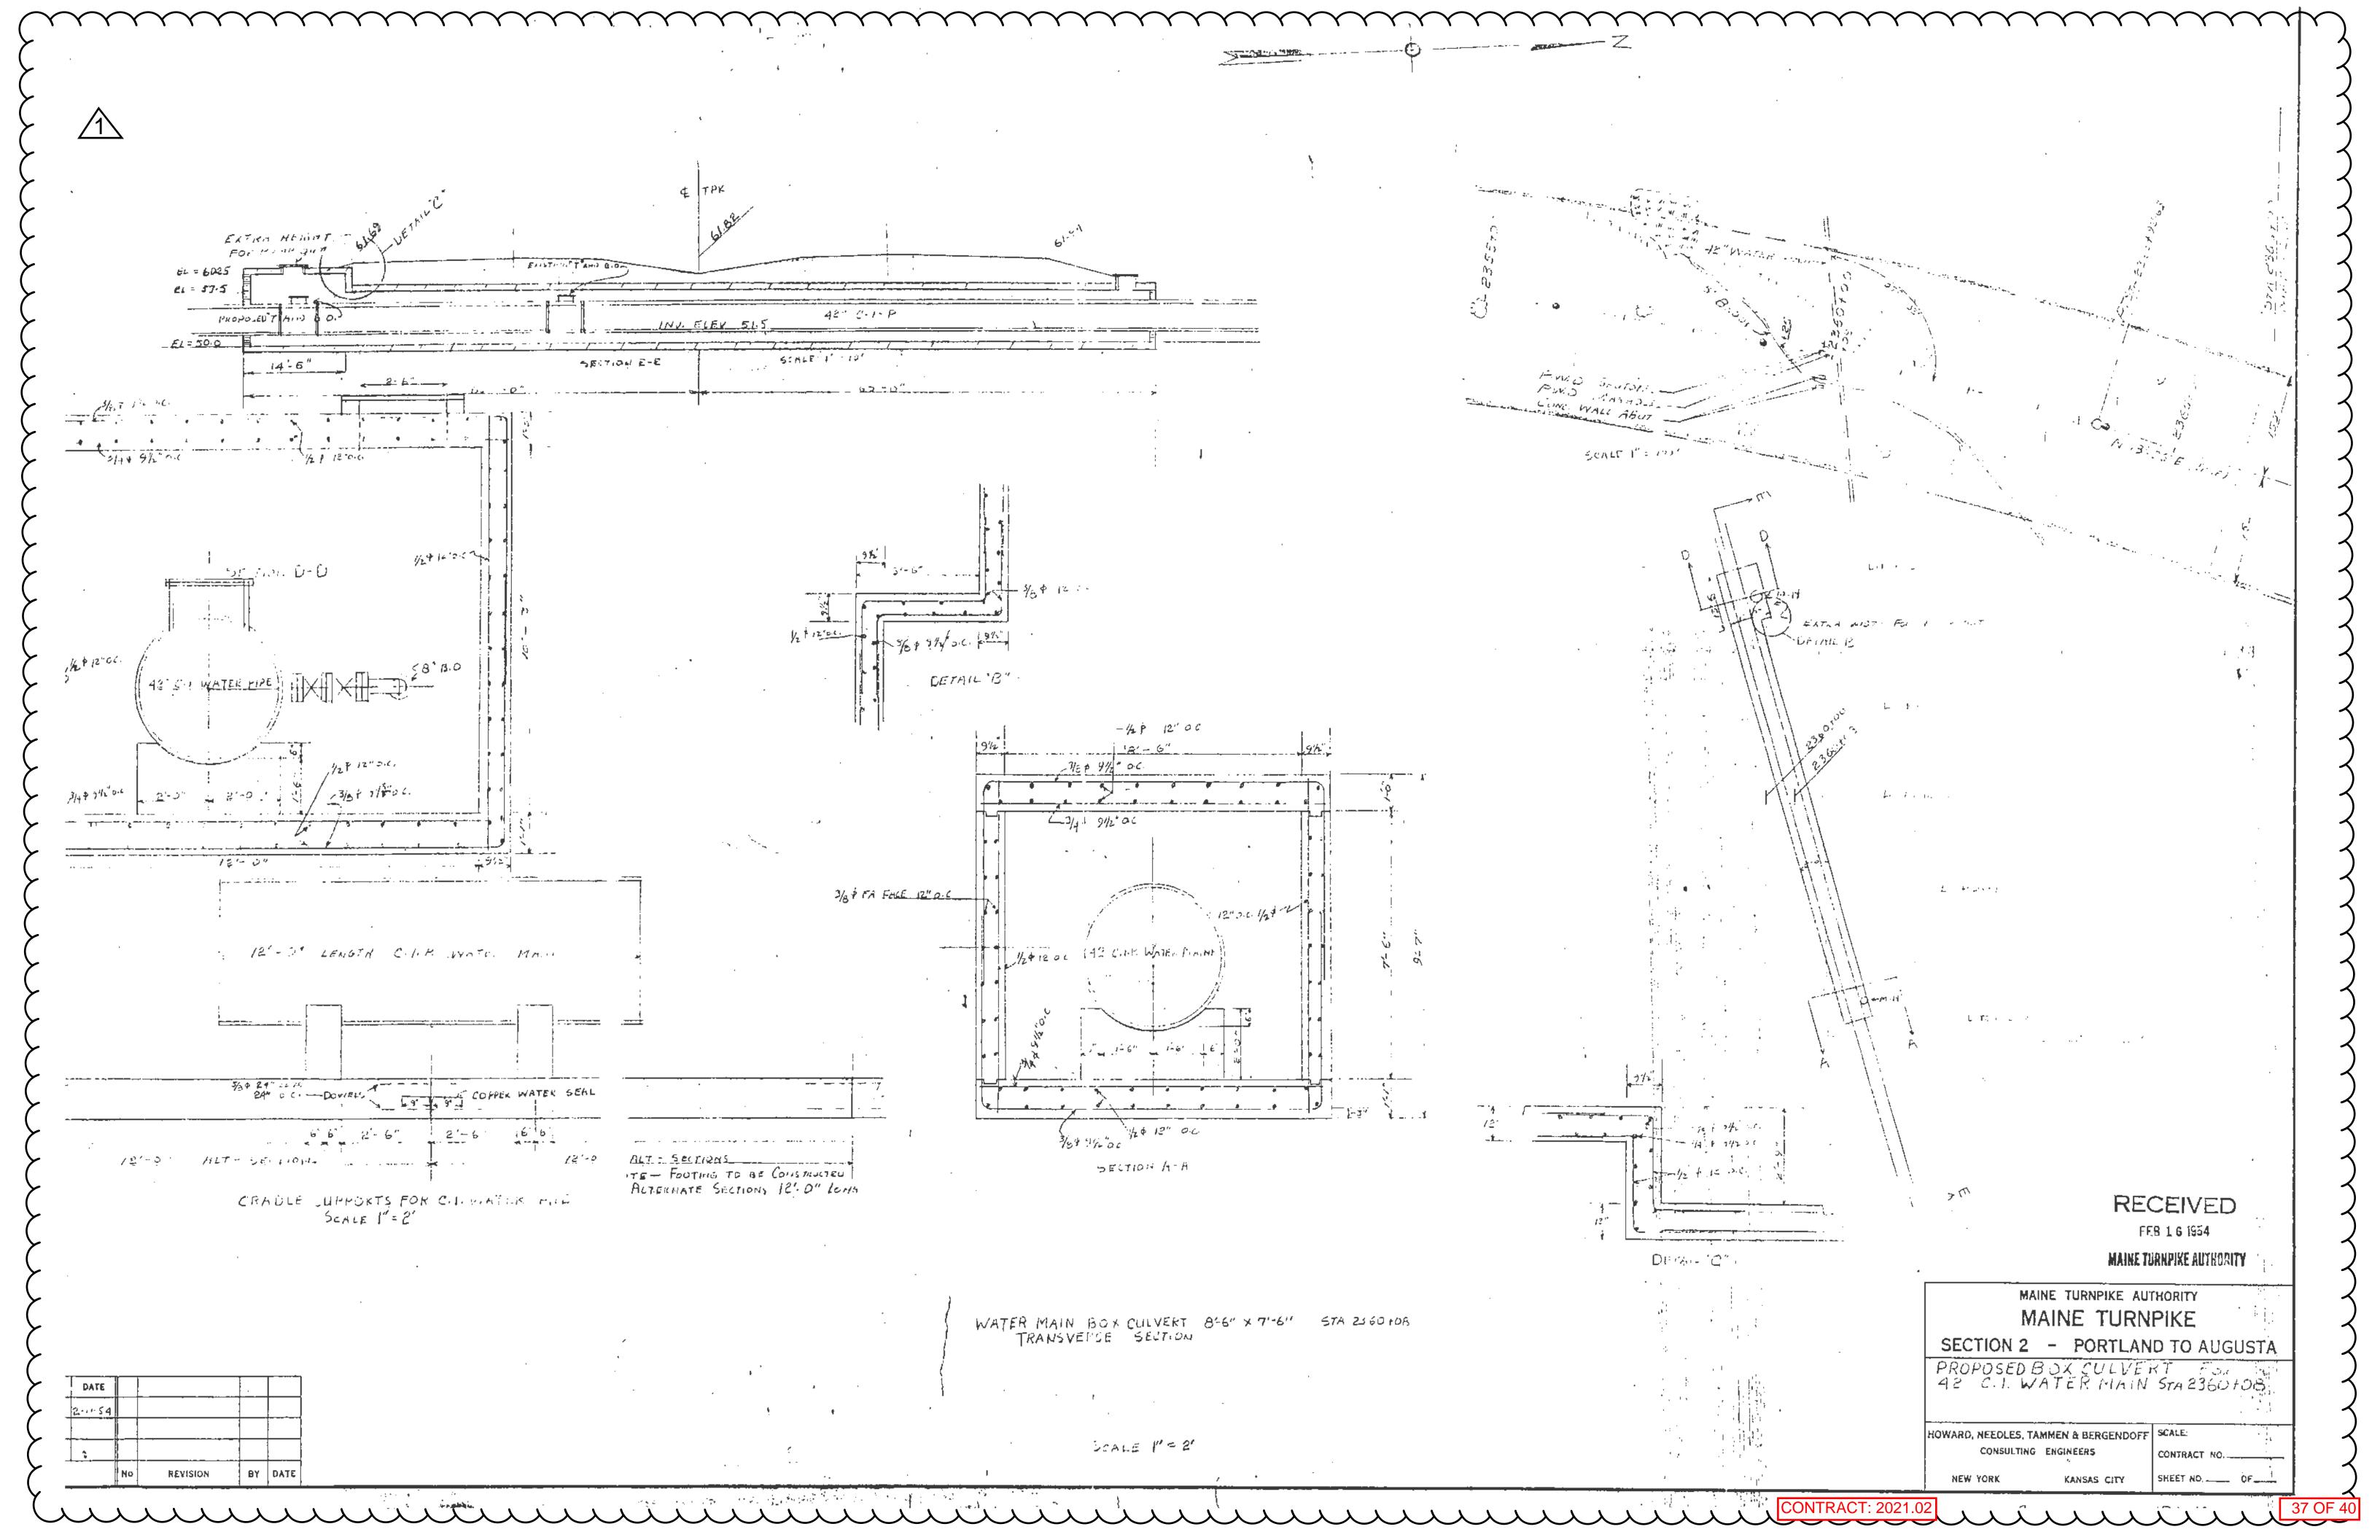

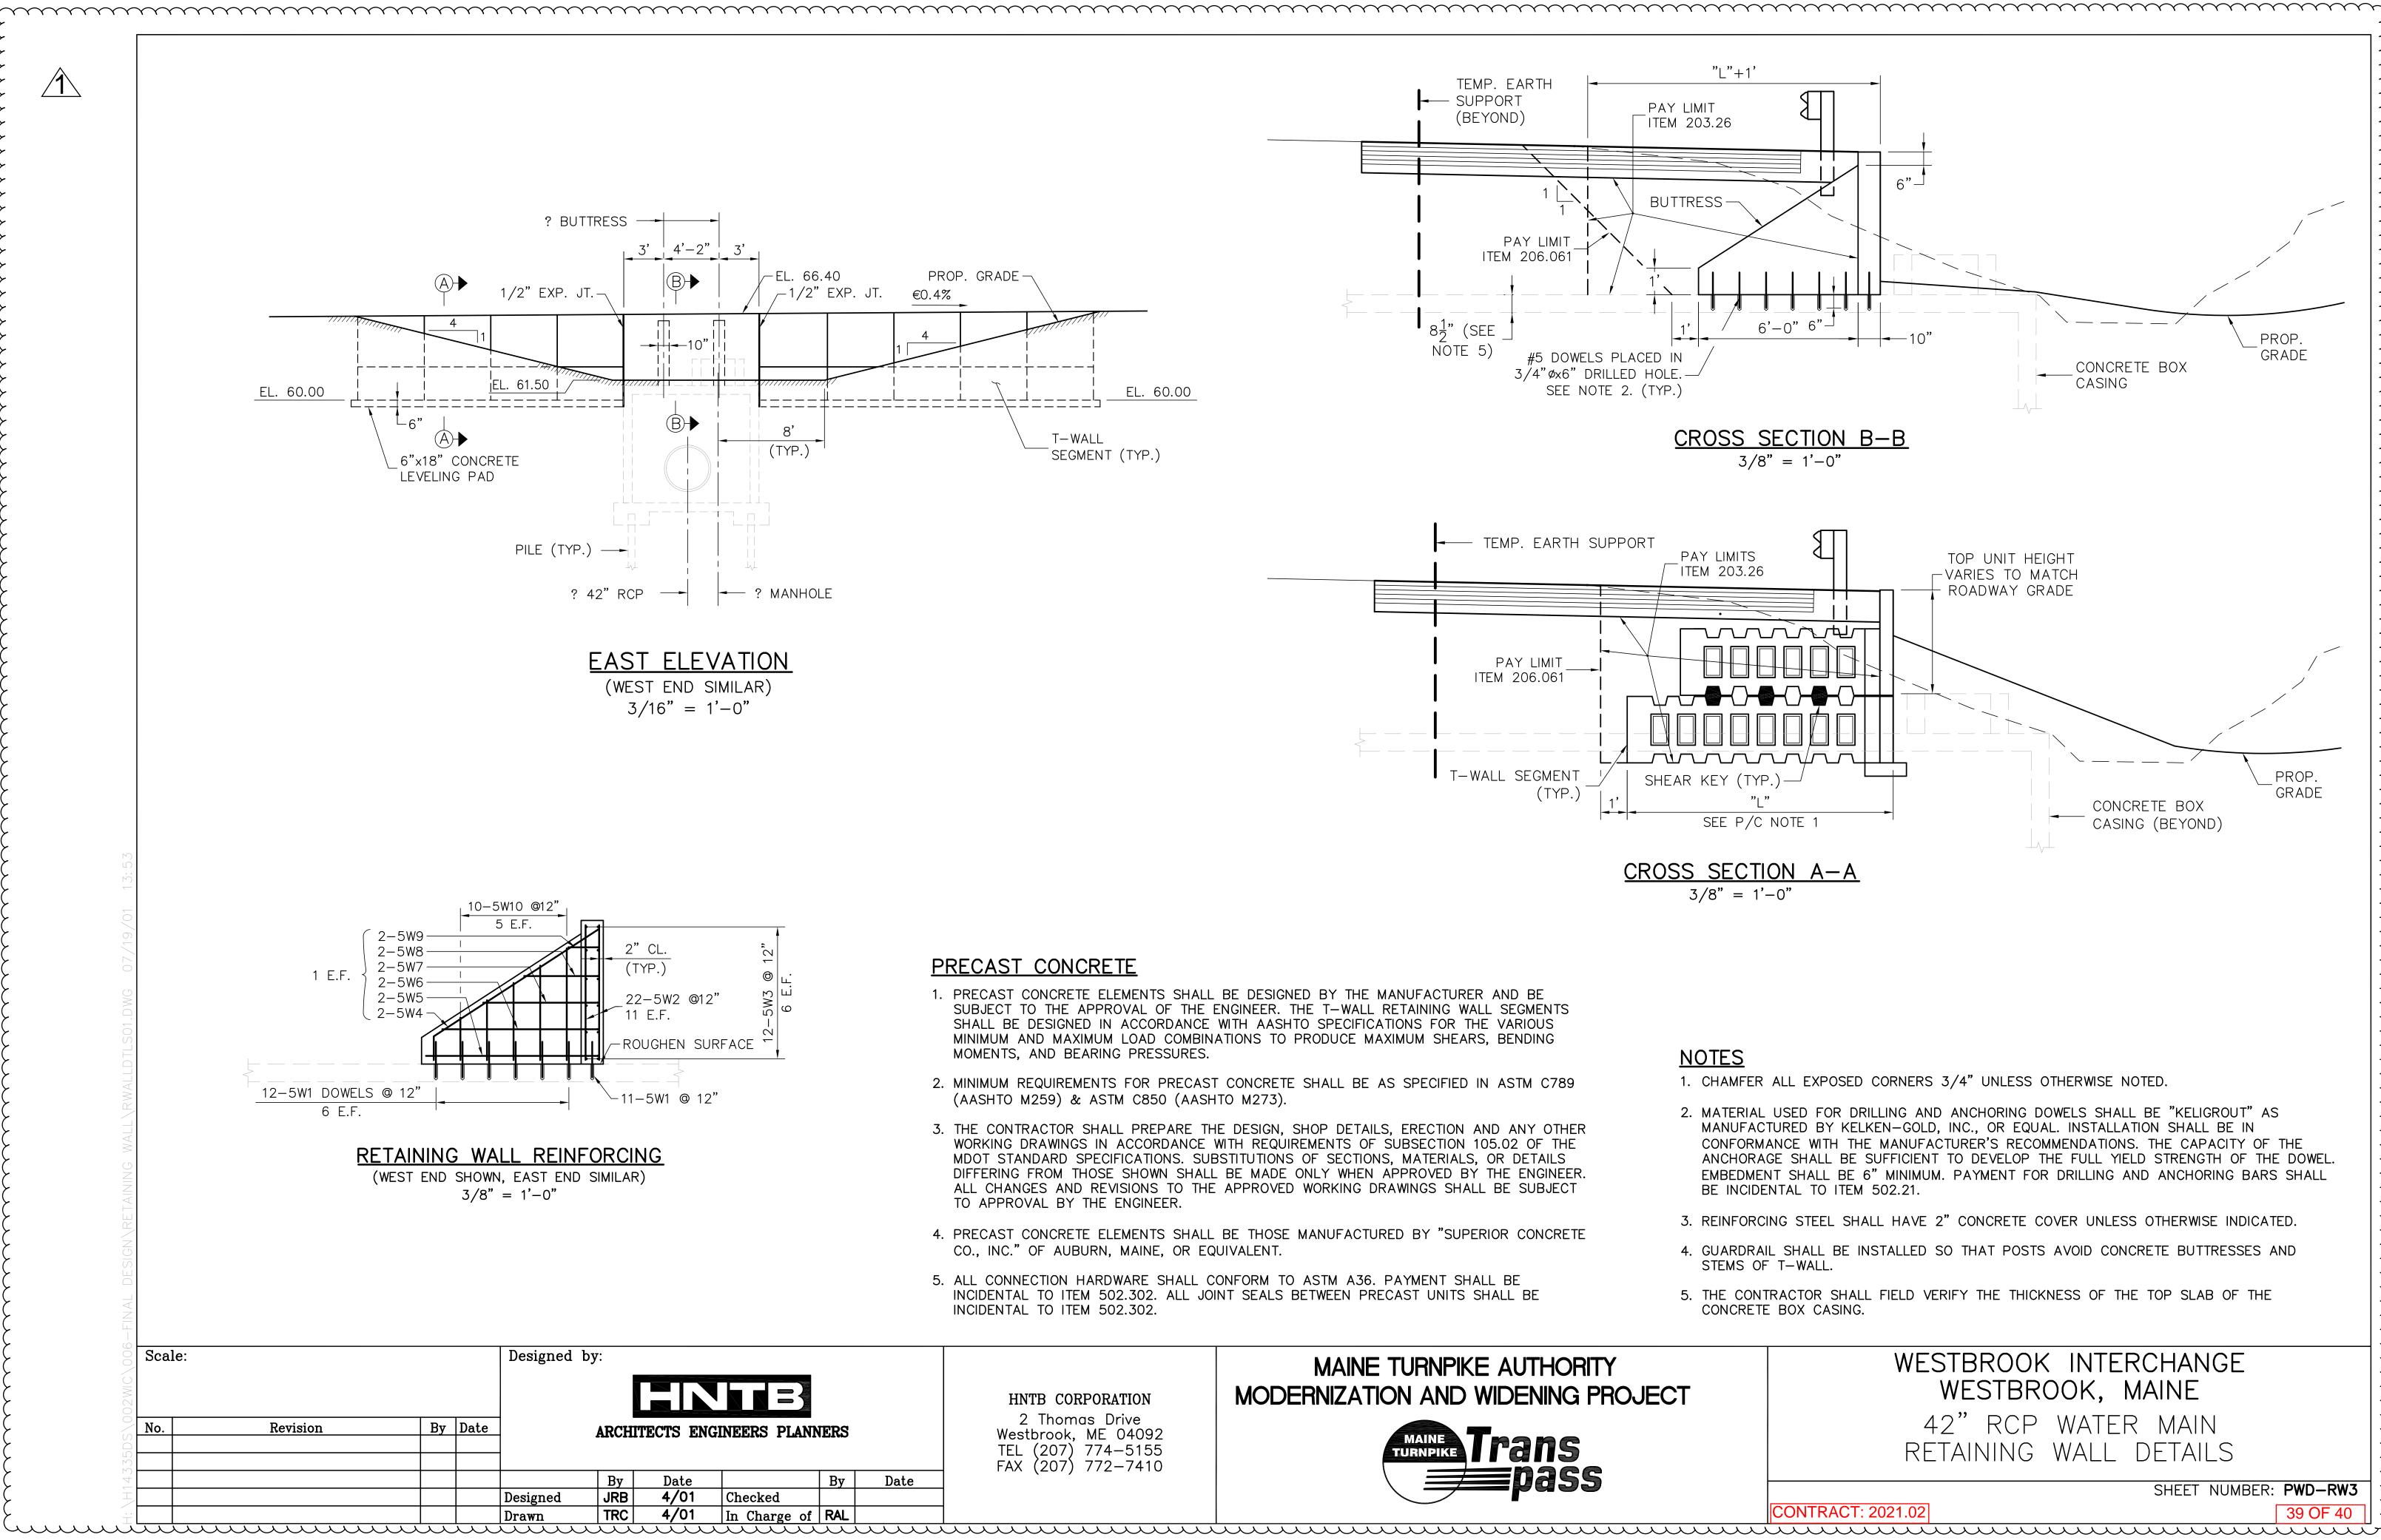

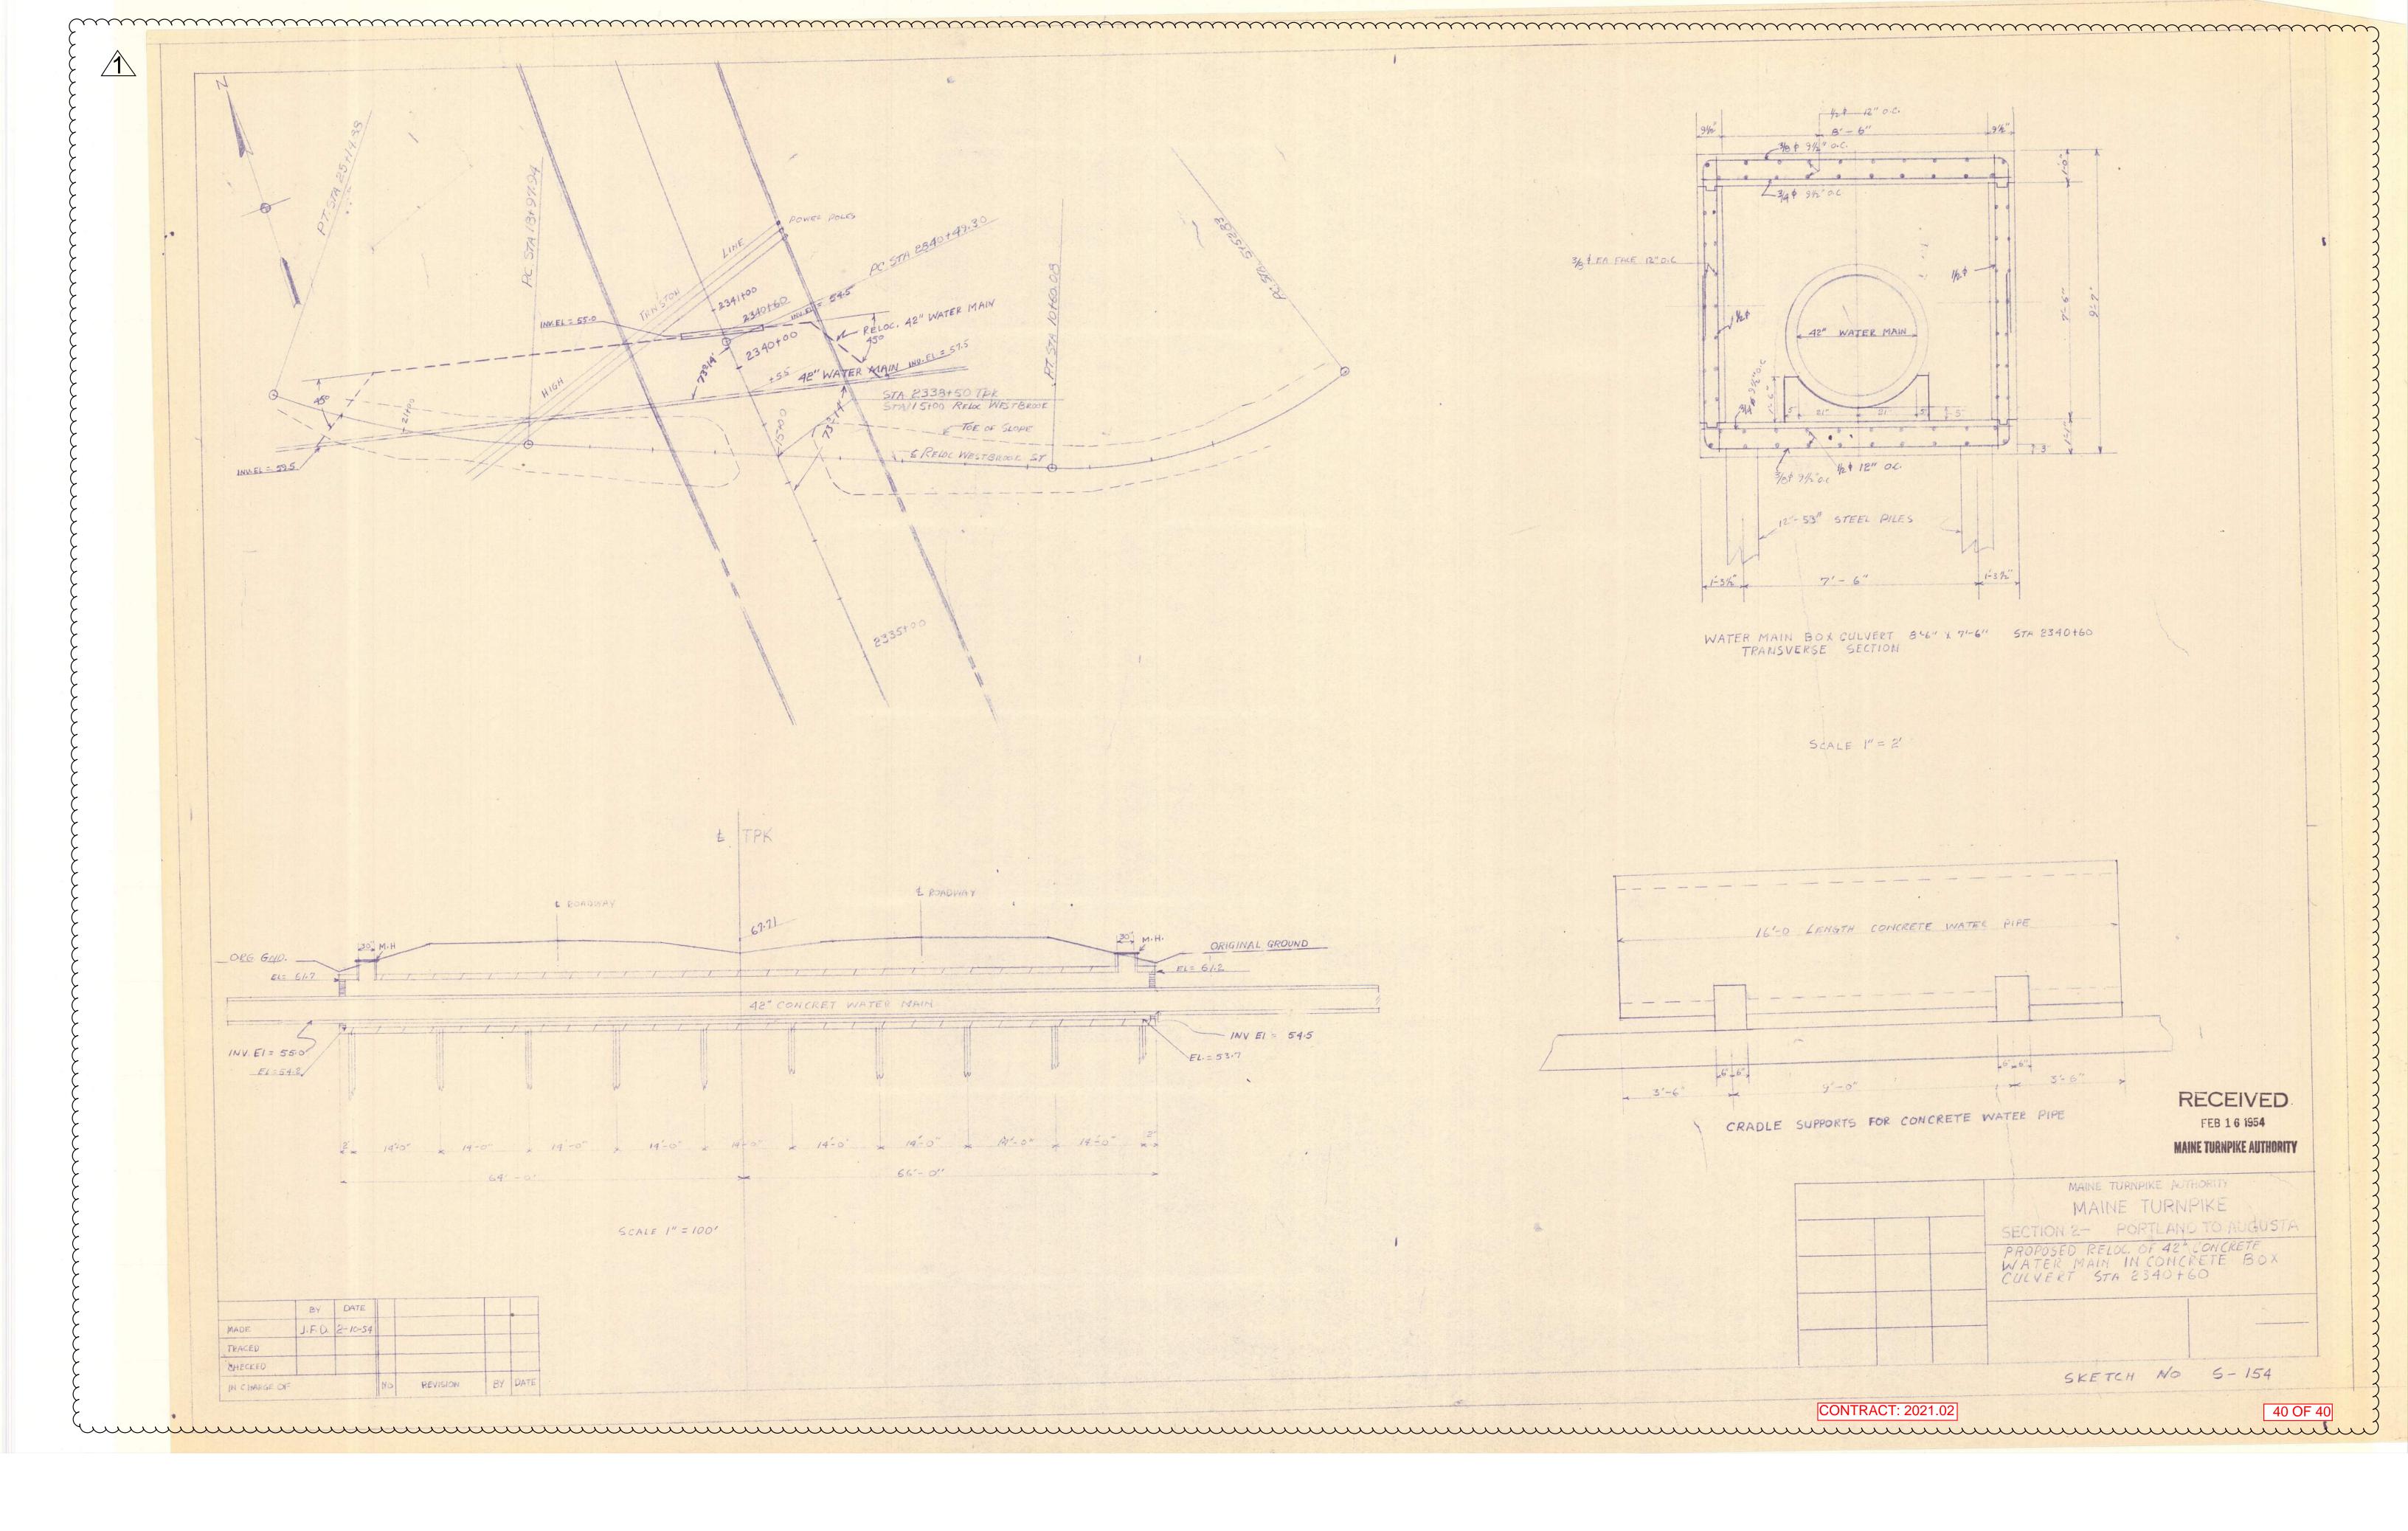

# MAINE TURNPIKE AUTHORITY

# Pre-Bid Conference

# **CONTRACT 2021.02**

# WATER LINE AND UTILITY VAULTS MM 47.1, MM 47.6, AND MM 48.5

# JUNE 3, 2021, 10:00 A.M.

# 1) Location:

The general limits of work are as shown on the Contract Plans at Miles: 47.1, 47.6, and 48.5.

# 2) <u>General Description:</u>

The work consists of constructing utility vault extensions and watermain replacement on the Maine Turnpike in the City of Portland, Maine. The work includes embankment excavation, shoulder gravels and pavement construction, utility vault extension, watermain replacement, guardrail and culvert removal and replacement, maintenance of traffic and all other work incidental thereto in accordance with the Plans and Specifications.

# 3) <u>Bid:</u>

- a) Opening: June 15 at 11:00 A.M. at MTA Headquarters 2360 Congress Street, Portland.
- b) All bid and contractual questions shall be directed to Nate Carll. Phone No.: (207) 482-8115. E-Mail: ncarll@maineturnpike.com.
- c) All questions on plans and specifications shall be in writing and shall be directed to Nate Carll, Purchasing Manager, of the Maine Turnpike Authority. Fax No. (207) 871-7739. Email ncarll@maineturnpike.com
- d) Bids will be accepted from Contractors **prequalified** by the Maine Department of Transportation for Highway Construction Projects. All other bids may be rejected. This Project includes a wage determination developed by the State of Maine Department of Labor.

# 4) <u>Notification:</u>

- a) Contractor shall notify and obtain approval from the Authority prior to visiting the Project sites for field inspection. The contact person is Mr. Steve Tartre at <u>startre@maineturnpike.com</u>
- 5) Contract Specifications
  - a) The Specifications are divided into three parts: Part I, Supplemental Specifications, Part II, Special Provisions, and Part III, Appendices.
  - b) The Maine Turnpike Supplemental Specifications are additions and alterations to the 2014 Maine Department of Transportation Standard Specifications and are available on MTA's website.

- 6) <u>Maine Department of Labor Fair Hourly Wages (Special Provision 104.3.8)</u> Wage rates for Highway and Earth, and Heavy and Bridge are in effect for this contract.
- 7) <u>Utility Coordination (Special Provision 104.4.6)</u>
  - a) Central Maine Power
    - i) CMP has aerial crossings of the Turnpike: south of and along Congress St, north of Westbrook St, south of Rand Rd/Westbrook Arterial, and north of and along Brighton Ave
    - ii) The Contractor shall prepare and submit for approval, a crane layout plan depicting the working area of all components of the crane and infrastructure being installed as well as the poles, guys, and conductors. The plan shall be submitted a minimum of 30 days prior to planned work adjacent to the conductors. Written approval must be received prior to work commencing.
    - iii) A Utility Pre-Construction meeting is required and shall be completed prior to construction
    - iv) The Contractor shall be responsible for complying with M.R.S.A. Title35-A, Chapter 7-A Sections 751 -761 Overhead High-Voltage Line Safety Act. Prior to commencing any work that may come within ten (10) feet of any aerial electrical line the Contractor shall notify the aerial utilities as per section 757 of the aforementioned act. Any work within 25 feet of CMPCo's facilities will require advance coordination with CMPCo to have a CMPCo representative onsite to provide a safety watch. The CMPCo representative may stop work within the CMPCo right-of-way if they believe the work activities are unsafe or may cause damage to CMPCo's facilities.
  - b) Federal Aviation Administration
    - i) Contractor shall review and comply with the Special Conditions contained in Aeronautical Studies: No. 2021-ANE-18-OE, No. 2021-ANE-19-OE, No. 2021-ANE-29-OE, and FAA Advisory Circular AC No. 70/7460-1 M, Obstruction Marking and Lighting. These documents are contained in the Appendix. FAA has determined equipment that is 100 feet tall or less (above ground level at the waterline crossings) may be used on this project with special marking and/or lighting; see documents noted in this paragraph. Any equipment or part of equipment that exceeds 100 feet above ground level will require an additional application process, review, and approval of the FAA before the equipment can be used.
    - ii) Contractor shall contact the FAA (Portland International Jetport), including PWM Air Traffic Control Tower at 207-552-1415, and PWM Manager at 207-756-8310, as noted in these documents, at least 3 business days prior to use of construction equipment at the three waterline crossings AND when the construction is complete.
  - c) Maine Turnpike
    - i) Maine Turnpike Authority owns highway lighting facilities within the project limits along each interchange ramp. The utility vault extensions and watermain replacement will require excavation around/near electrical conduits supplying power to the interchange lightings.
    - ii) The Contractor shall coordinate with MTA at least 10-days prior to excavation around lighting facilities. Interchange lighting must remain operational at all times.
  - d) Portland Pipe Line Corporation

- i) Portland Pipe Line Corporation (PPLC) has a 24-inch oil pipeline approximately 80 feet from the construction of a utility vault, station 2340+50 left.
- ii) Special coordination is required for waterline replacement and grading in the Exit 48 interchange between the Turnpike mainline and the northbound off ramp. PPLC maintains pipe vents and a cathodic protection test station at this location which must be maintained. Cover requirements shall also be maintained in this area over the pipelines. The contractor shall provide a 30-day notice of construction in this area.
- iii) PPLC requires a Pre-Construction meeting to finalize all construction details and schedule including details of heavy and vibratory equipment to be operated near and over the pipelines. In addition, the contractor must follow a set of construction guidelines, labeled Portland Pipe Line Corporation Construction Practices for work within 1,000 feet of their facility; see Appendix.
- 8) <u>Cooperation With Other Contractors (Special Provision 104.4.7):</u>
  - a) MTA Contract 2018.19 Cummings Road Underpass Bridge Replacement, MM 44.6
  - b) MTA Contract 2020.02 Exit 45 Interchange Reconstruction, MM 44.9
  - c) MTA Contract 2020.03 Portland Area Widening & Safety Improvements, MM 43.0 to 46.4
  - d) MTA Contract 2019.10 Warren Avenue Overpass Bridge Replacement, MM 49.0
  - e) MaineDOT WIN 21745 Interstate 295 Over Veranda Street in Portland (for purposes of traffic management during planned I-295 closures)
- 9) <u>Permit Requirements (Special Provision 105.8.2)</u>
  - a) The Project is being constructed under multiple environmental permits, including: the Maine Department of Environmental Protection (DEP) Natural Resources Protection Act Permit and Water Quality Certification L-27726-TG-A-N; U.S. Army Corps of Engineers Individual Permit NAE-2019-00701 under Section 404 of the Clean Water Act; and Self-Verification Notice authorization NAE-2021-01318 under the U.S. Army Corps of Engineers General Permits for the State of Maine.
  - b) These permits authorize temporary or permanent construction disturbance within wetlands located within the limits of disturbance (LOD) shown on the site plans. Any alterations to the LOD proposed by the contractor requires review and approval by MTA's Resident Engineer and environmental staff before being implemented. The permits require that no tree cutting shall occur in wetlands or uplands between June 1 and July 31. Erosion and sediment controls must be maintained during and following construction in accordance with MTA's Supplemental Specification Section 656.
  - c) The Project is subject to all general, special, and project-specific conditions contained in the DEP and U.S. Army Corps of Engineers Permits. Copies of the permits will be provided to the Contractor. The Contractor shall comply with the conditions outlined in the U.S. Army Corps of Engineers and DEP permits. The Contractor shall indemnify and hold harmless the Maine Turnpike Authority or its agents, representatives and employees against any and all claims, liabilities or fines arising from or based on the violation of the above noted permits.
- 10) <u>Construction Schedule/Substantial Completion:</u>

- a) June 24, 2021 Anticipated Contract Award Date
- b) November 15, 2021 Substantial Completion.
- c) December 3, 2021 Contract Completion Date.
- 12) Prosecution of Work (107.4.6) & Limits of Operations (Special Provision 107.4.7)
  - a) No tree cutting shall occur between June 1 and July 31.
  - b) The Contractor may have only one watermain shut down at a time. The work must be complete, with the watermain brought back into service, at one watermain crossing before the other watermain is shut down to begin work on the other watermain crossing. The watermain replacement at Exit 48 may be completed anytime within the contract time, including overlapping with the utility vault work.
  - c) Multiple temporary ramp closures within an interchange are not allowed; only one ramp may be closed at a time.
  - d) The Contractor shall be responsible for coordinating and scheduling work activities with adjacent contracts in overlapping work zones.
  - e) The Contractor shall complete the work as shown on the maintenance of traffic plans and in accordance with Section 652 of the Specifications. The MOT layouts as shown in the Plans and described in the Special Provisions provide guidance for construction sequencing. All Contractor MOT layouts, including any and all changes to the Plan MOT Layouts, or changes to the Special Provisions, shall be submitted to the Resident for review and approval prior to implementation. These will be considered a Shop Drawing Review and are required to be submitted at least 20 days prior to proposed implementation.
  - f) There shall be no pile driving during non-daylight hours. Pile driving will not be allowed within 10 feet of traffic.
  - g) Lane closures, ramp closures, shoulder closures, and stoppages of all kinds are prohibited during an Interstate 295 closure for MaineDOT project WIN 21745, Interstate 295 over Veranda Street. The planned I-295 Closure, and weather alternate, is tentatively scheduled for either: the period Noon October 22, 2021 thru Noon October 25, 2021 with an alternate weather period of Noon October 29, 2021 thru Noon November 1, 2021, OR Noon April 15, 2022 thru Noon April 18, 2022, with an alternate weather period of Noon April 22, 2022 thru Noon April 25, 2022.
  - h) The Contractor shall maintain existing drainage during construction as needed for temporary use and as identified on the plans. This includes, but not limited to, making temporary pipe connections, grading temporary ditch, or bypass pumping of stormwater. Payment for temporary stormwater and ditch drainage shall be incidental to the Contract and no additional payment will be made for required labor, fittings, seals, etc. Payment for final ditch grading shall be paid for under the applicable Bid Items.
- 13) Specific Contract Items

- a) Section 203.20, 304.14, 403.213, 419.30, and 606.366
  - i) Limits of shoulder pavement removal, aggregate base gravel replacement, and guardrail remove and rest are approximate. Contractor shall propose limits of pavement removal, aggregate excavation and guardrail removal for review and approval by Resident
  - ii) Payment for all items shall be based on actual work complete, measured, and accepted.

b) Section 511 Cofferdams

- i) This work shall consist of the complete design, construction, maintenance and removal of temporary earth support systems and other related work, including dewatering and inspection, required to allow for the excavation required to construct the concrete utility vault extensions, and to protect adjacent roadways, adjacent public or private rights-of-way, embankments, or other structural units, in accordance with the Contract.
- ii) Temporary earth support structures may require pumping or dewatering to complete the Project work. The locations of temporary earth support structures may, or may not, be shown on the Plans whether required for the completion of the Contract or not. Section 502 Asphaltic Plug Joint

# c) <u>Section 526 - Concrete Barrier</u>

- i) Work Zones will require use of Temporary Concrete Barrier Type I Supplied By Authority.
- ii) The contractor shall review the Plans and Specifications for anticipated use of temporary barrier and the requirements for such use.
- d) Section 604 Manholes, Inlets, and Catch Basins Utility Vault Extensions
  - i) This work shall include the partial demolition of the existing utility vaults and manholes and construction of the utility vault extensions as shown on the Contract Plans. This work shall also include developing and submitting for approval, a construction procedure, temporary water main support system, and temporary earth support to protect the water main, and coordination with Portland Water District as described in the Contract Plans and these Specifications.
  - ii) The Contractor shall develop a construction procedure, temporary water main support, and temporary support systems that will protect, at all times, the 42" Cast Iron Pipe (1912, leaded joint) at station 2360+02.55 and the 42" Reinforced Concrete Cylinder Pipe (1931, rubber and steel joint) at station 2340+50.81, during construction of the tunnel extensions. Each water main will be removed from service by Portland Water District (PWD) during the work by closing valves on each side of the work area.
  - iii) The Contractor is required to fully complete the work on one utility vault before work can begin on the other utility vault. Water mains can be removed from service between April 15th and October 15th and all work shall be completed within those dates. Winter shut offs are not permitted.
  - iv) The maximum pipe support spacing shall be 6' along the pipeline. The temporary watermain support system and temporary earth support shall be designed by a professional engineer licensed in the State of Maine and reviewed by the Resident Engineer and PWD prior to the start of construction.

- v) PWD shall receive at least 30-days advance notice of work to be performed within the PWD's easements or Rights-of-Way. No work shall be performed within the PWD pipeline easements or Rights-of-Way without prior approval of PWD and a PWD representative being on-site for inspection purposes
- e) Section 652 Maintenance of Traffic
  - i) Special Provision 652 was recently updated; updates are bolded to aid in recognition.
  - ii) Contractor shall submit phasing sequence layouts and work elements for each construction location, including lane and shoulder widths and sawcut locations for approval prior to construction.
  - iii) Ramp closures are only allowed at the Exit 48 interchange as single night closures and intended to give the Contractor time to setup the work zones, including installing temporary traffic control signage and temporary concrete barrier.
  - iv) Maintenance of traffic plans have been developed for the work on the mainline and ramps. Minimum main line width for a single travel lane shall be 14 ft and minimum ramp widths of 16 ft (12 ft lane and two 2 ft shoulders) must be maintained at all times, unless otherwise noted. Shoulder closures, lane closures, and lane shifts meeting the MUTCD guidelines, other than those shown in the plans, must be submitted for approval from the MTA prior to use in the construction operations. Requests for all closures shall be submitted to the MTA for approval before proceeding.
  - v) Sawcutting and paving of mainline shoulders shall be done between 9:00 p.m. and 5:00 AM, unless otherwise shown on the Maintenance of Traffic Phasing Plans or as directed by the MTA.
  - vi) Access to, and egress from, the construction area shall be with the direction of travel without crossing traffic. Construction vehicles are prohibited from merging with mainline traffic between 6:00 a.m. and 10:00 a.m. and between 3:00 p.m. and 7:00 p.m. unless approved in writing from the MTA.
  - vii)Lane and Shoulder Closure tables are included in Special Provision 652.
- f) Section 659 Mobilization
  - i) There are two Mobilization pay items for this contract, one for the Utility Vaults and one for the Waterline.
- g) <u>Part III Appendix D Portland Water District Construction Specifications for Water Main</u> <u>Replacement at Exit 48</u>
  - i) Contractor shall note that special provisions for the Water Main Replacement at Exit 48 are contained in Appendix D, versus the main body of special provisions.
  - ii) Section 01250 Measurement and Payment
    - (1) Incidental Work is detailed in subsection 1.02. This incidental work is for the Water Main Replacement work only and NOT for the Utility Vault Extension Work.
    - (2) Pay Items are detailed in subsection 2.01.
  - iii) Section 01300 Submittals

- All submittals for Water Main Replacement shall be made to the MTA Resident. Subsequent coordination with the Portland Water District will be initiated by the MTA Resident.
- iv) Maintenance of Traffic for Water Main Replacement at Exit 48 will be as detailed in the Plans and Specification or as approved by MTA Resident.
- 14) Questions
  - a) <u>Please submit any questions that you may have by noon on Thursday June 10, 2021</u>