**INDEX OF SHEETS** 

Title Sheet

**Estimated Quantities** 

Maintenance of Traffic Details (3 Sheets)

Wilson Road Phase 1 Traffic Control Plans (3 Sheets)

Littlefield Road Maintenance of Traffic Details (5 Sheets)

Ramp J Detour Plan (1 Sheet)

Concrete Repair Typical Details

Bridge Typical Section

Abutment No. 2 Repairs

Pier No. 2 Repairs

Bridge Joint Modifications (1 of 2)

Bridge Joint Modifications (2 of 2)

General Plan and Elevation


**Bridge Joint Modifications** Slope Protection Repairs

Structure 3 Littlefield Road Underpass Bridge

Wilson Road Detour Plan (1 Sheet)

Structure 1 Ramp J Underpass Bridge

Structure 2 Wilson Road Underpass Bridge

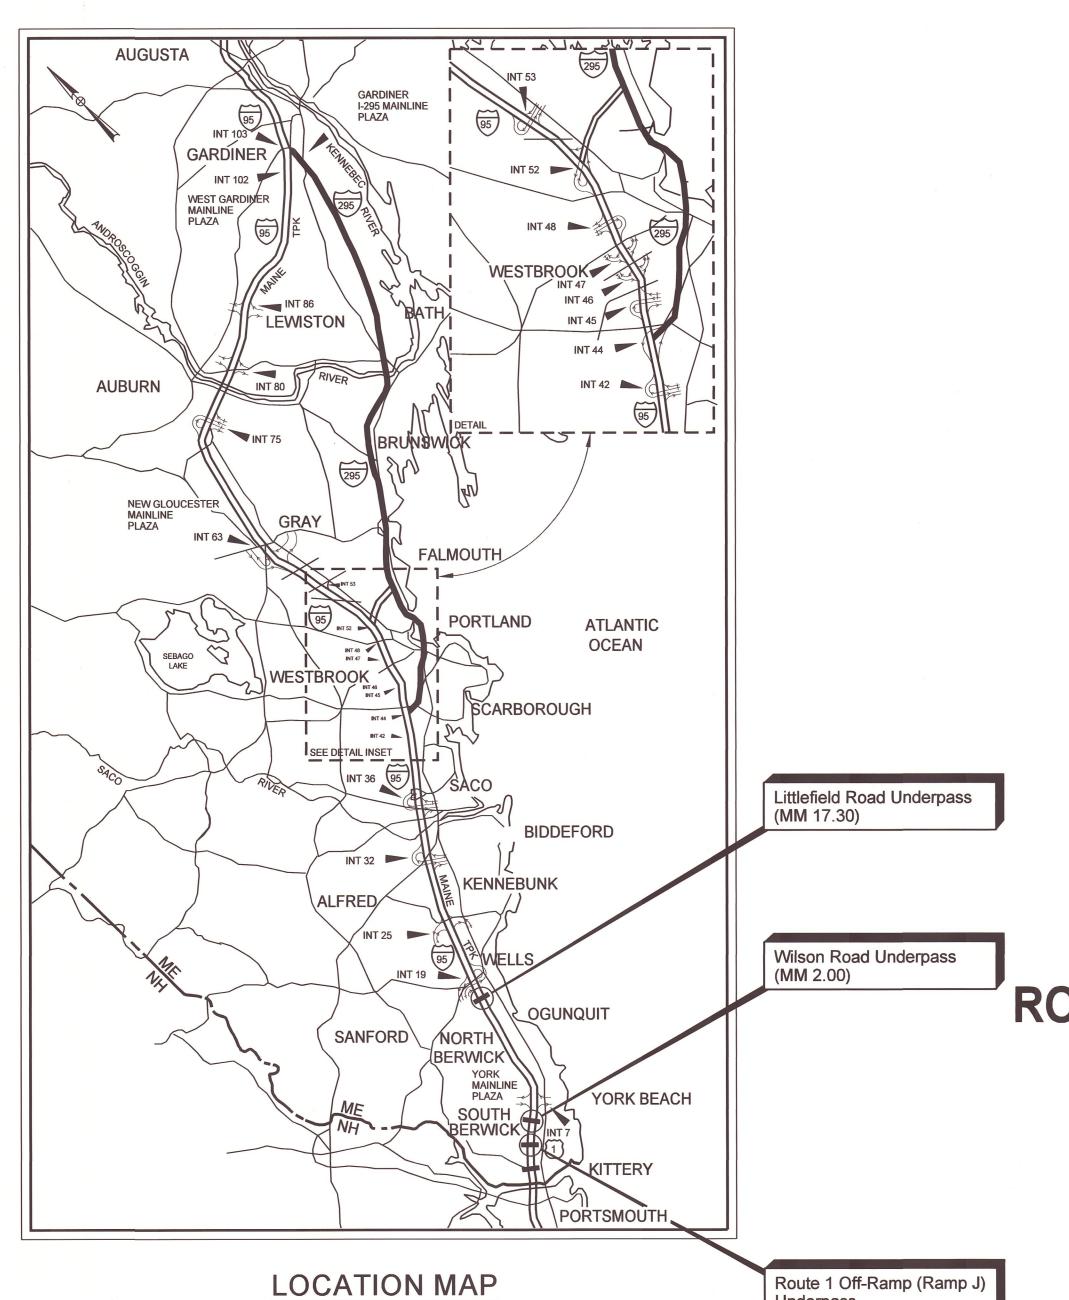

Underpass (MM 1.50)



# MAINE TURNPIKE AUTHORITY

DANIEL E. WATHEN, CHAIR ROBERT D. STONE, VICE CHAIR MICHAEL J. CIANCHETTE, MEMBER ANDREW MCLEAN, MEMBER JANE L. LINCOLN, MEMBER THOMAS J. ZUKE, MEMBER BRUCE A. VAN NOTE, EX-OFFICIO MEMBER

S. PETER MILLS, EXECUTIVE DIRECTOR

**CONTRACT 2022.12** 

**BRIDGE REPAIRS** ROUTE 1 OFF-RAMP (RAMP J) UNDERPASS (MM 1.50) WILSON ROAD UNDERPASS (MM 2.00) LITTLEFIELD ROAD UNDERPASS (MM 17.30)

MAINE TURNPIKE AUTHORITY

APPROVED:



Consultant Project Manager

4/27/2022 DATE

403.208 H 409.15 B 502.702 R 508.14 H 508.14 H 515.201 P 515.202 C	DESCRIPTION  Removing Pavement Surface  Hot Mix Asphalt, 12.5 mm Nominal Maximum Size (Surface)  Bituminous Tack Coat RS-I or RSIh - Applied  Replace Bridge Drain (Type AI)	UNIT SY TON	Route 1 Off-Ramp (Ramp J)	Wilson Road	Littlefield Road	Quantity Total
403.208 H 409.15 B 502.702 R 508.14 H 508.14 H 515.201 P 515.202 C	Hot Mix Asphalt, 12.5 mm Nominal Maximum Size (Surface) Bituminous Tack Coat RS-I or RSIh - Applied		1 710			I
409.15 B 502.702 R 508.14 H 508.14 H 515.201 P 515.202 C	Bituminous Tack Coat RS-I or RSIh - Applied	TON	1,310	I <b>,</b> 150	850	3,310
502.702 R 508.14 H 508.14 H 515.201 P 515.202 C	<u> </u>	_	140	120	71	331
508.14 H 508.14 H 515.201 P 515.202 C	Renlace Bridge Drain (Type AI)	GAL	53	45	34	132
508.14 H 515.201 P 515.202 C	<u> </u>	EA	5	6	0	//
515 <b>.</b> 201 P 515 <b>.</b> 202 C	High Performance Waterproofing Membrane (Ramp J) (994 SY) *	LS	/	0	0	/
515 <b>.</b> 202 C	High Performance Waterproofing Membrane (Wilson Rd) (927 SY) *	LS	0	/	0	/
	Pigmented Protective Coating for Concrete Surfaces	SY	260	390	380	1,030
	Clear Protective Coating for Concrete Surfaces	SY	310	360	350	1,020
	Abutment Repairs	SF	680	30	20	730
	Pier Repairs	SF	0	20	0	20
	Repairing Granite Curb Joint and Bedding Mortar	LF	790	690	0	1,480
	Epoxy Injection Crack Repair	<u>LF</u>	0	90	0	90
	Reseal Joints	<u>LF</u>	0	0	125	125
	Repair of Overhead Surfaces < 8 inches	SF	0	5	0	5
	Fascia and Overhang Repairs	SF	12	130	5	147
	Partial Concrete Curb Reconstruction	LF CF	0	280	0	280
	Partial Depth Concrete Deck Repairs	SF	180	335	0	<i>515</i>
	Full Depth Concrete Deck Repairs	SF	90	85	0	175
	Elastomeric Concrete Header Repair	CF	0	0	10	10
	Slope Protection Repairs	LF CF	0	170	0	170
	Slope Protection Concrete Repairs	SF	0	0	80	80
	Parapet Repairs	SF	0	0	110	110
	Parapet Surface Repairs	LF	0	0	361	361
	Expansion Device - Silicone Coated and Pre-Compressed Seal	<u>LF</u>	0	0	36	36
	Bridge Joint Steel Modification	EA	0	4	0	4
	Remove and Replace Gland Seal (Wilson Rd)	EA	0	2	0	2
	Reset Steel Bearings	EA	5	0	0	5
	Protective Shielding - Steel Girders	SY	0	360	0	360
	Jacking Existing Superstructure (Ramp J)	LS	/	0	0	7
	Temporary Concrete Barrier, Type I	LF		750		750
	Nork Zone Crash Cushion - TL-3	UNIT		4		4
	Resetting Existing Work Zone Crash Cushion	UNIT	000	4	0.750	4
	White or Yellow Pavement Marking Line	<u>LF</u>	900	7 <b>,</b> 890	<b>2,750</b>	11,540
	Temporary 6" Pavement Marking Tape	LF CF		72		72
	Removing Existing Pavement Markings	SF		3,135		3,135
	Hand Labor, Straight Time	HR		100		100
	Air Compressor (including operator)	HR		100		100
	Air Tool (including operator)	HR		100		100
	All Purpose Excavator (including operator)	HR		100		100
	Truck - small (including operator)	HR		100		100
	Foreman Fine D	HR		100		100
	Field Office, Type B	EA				<i>I</i>
	Temporary Traffic Signal	LS		1		1
	Flashing Arrow	EA		4		4
	Type III Barricade	EA		14		14
	Orum Cono	EA		230		230
	Cone Construction Signs	EA		50		50
	Construction Signs	SF		2,040		2,040
	Maintenance of Traffic Control Devices	LS		700		700
	Flaggers Portable Changeshie Massage Sign	HR		300		300
	Portable Changeable Message Sign	EA		3		3
	Truck Mounted Attenuator	CD		50		50
	Automated Trailer Mounted Speed Limit Sign	CD		35		<i>35</i>
	Sequential Flashing Warning Lights	EA		90		90
	Temporary Soil Erosion and Water Pollution Control	LS				1
	Mobilization	LS			,	/
830 <b>.</b> 17 U	Itility Conduit Hanger System Hardware	LS	0	0	/	/

<sup>\*</sup> Quantities are Estimated Only

-qnty.dgn	cale: AS NOTED			Designed by:	:			L	
N002	D. Revision	Ву	Date	1			VII	U	
				CONSULTANT	PROJEC	CT MANAGER:	G. Edington		
ilename:					Ву	Date		Ву	Date
Bug				Designed	MEB	4/29/22	Checked	GME	4/29/22
				Drawn	DPD	4/29/22	In Charge of	TSB	4/29/22

VANASSE HANGEN BRUSTLIN, INC.
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Suite 105B
South Portland, ME 04106

South Portland, ME 04106 TEL (207) 889-3150 FAX (207) 253-5596



# THE GOLD STAR MEMORIAL HIGHWAY

MTA PROJECT NO. 2022.12

ESTIMATED QUANTITIES

 VHB: 55345.00
 SHEET NUMBER:
 2

 CONTRACT: 2022.12
 2 OF 38

# 1/29/2022

## **SPECIFICATIONS**

Design: AASHTO LRFD Bridge Design Specifications, 2018.

Construction: State of Maine Department of Transportation Standard Specifications, 2014 Edition, with all revisions thereto.

State of Maine Department of Transportation Standard Details for Highways and Bridges, 2020 Edition, with all revisions thereto.

AASHTO LRFD Bridge Construction Specifications, Fourth Edition

#### NEW MATERIALS

NEW WATENIALS
Concrete (Unless noted otherwise)
Structural Steel:  All Material (except as noted) ASTM A709/A709M, Grade 36  High Strength Bolts (except as noted) ASTM A325, Type I
BASIC DESIGN STRESSES (NEW MATERIALS)
Concrete f'c = 4,500 psi
Reinforcing Steel fy = 60,000 psi
Structural Steel: ASTM A 709/A 709M, Grade 36

ASTM A 325..... Fu = 120,000 psi

# TRAFFIC AND DESIGN LOADING DATA

# ROUTE | OFF-RAMP (RAMP J) UNDERPASS BRIDGE

Design Live Load (for existing components)  AADT.  Design Speed (MPH) (for existing)  Functional Class	
WILSON ROAD UNDERPASS BRIDGE	
DESIGN LIVE LOAD (for existing components)  AADT.  Design Speed (MPH) (for existing)  Functional Class	
LITTLEFIELD ROAD UNDERPASS BRIDGE	
DESIGN LIVE LOAD (for existing components)  AADT  Design Speed (MPH) (for existing)  Functional Class	

# GENERAL CONSTRUCTION NOTES

- I. All details shall be in conformance with Maine Department of Transportation (MaineDOT) 2014 Standard Details for Highways and Bridges with all updates and MaineDOT Best Management Practices for Erosion and Sediment Control, latest revision unless otherwise noted in these plans.
- 2. All work must be completed within the limits shown in these Plans.
- 3. The Contractor shall submit proposed staging area(s) and field trailer location to the Resident for approval prior to starting work.
- 4. Any portions of the existing bridges removed by the Contractor shall become the property of the Contractor. The steel portions of the existing bridges may be coated with a lead-based paint system. The Contractor is responsible for the containment, proper management and disposal of all lead-contaminated hazardous waste generated by the work of this project.
- 5. Copies of the As-Built plans are posted on the Maine Turnpike Authority website at www.maineturnpike.com/projects/construction-contracts. The completeness and accuracy of these plans is not guaranteed.
- 6. Chamfer all exposed new concrete edges  $\frac{3}{4}$ " unless otherwise noted.
- 7. For all structures pigmented protective coating for concrete surfaces shall be applied to the following areas:
  - All exposed concrete surfaces of the piers, unless otherwise noted. - Exposed concrete surfaces of the abutments as shown in these plans.
  - Exposed concrete surraces of the abuilherits as shown in these plans.
- 8. For all structures clear protective coating for concrete surfaces shall be applied to the following areas:
  - All exposed bridge curbs, parapet and transition barriers.
  - All exposed median concrete.
  - All overhang and fascia concrete as shown in these plans.
- 9. For all structures the bridge seat shall be cleaned before applying pigmented protective coating.
- IO. The Contractor shall place approach pavement at all locations to achieve a smooth transition between existing and proposed pavement.

# EROSION CONTROL NOTES

I. All temporary and permanent erosion control devices shall be installed in accordance with the Maine Department of Transportation Best Management Practices.

# UTILITIES NOTES

- I. Existing utilities on these plans were compiled from existing plans and various other sources. Locations are not guaranteed to be accurate nor is it guaranteed that all utilities are shown. No separate or additional compensation will be allowed to the Contractor due to any variance between the data shown on the plans and the actual field conditions encountered. No work shall be started until the owners of the various utilities are notified by the Contractor of the proposed construction. The Contractor is also required to call Dig Safe at I-888-344-7233 at least 72 hours prior to the start of the work.
- 2. The Maine Turnpike Authority is a non-member utility operator and is not registered with the Dig Safe system. The contractor shall contact all non-members through www.OKtoDIG.com or as otherwise required by the Maine Public Utilities Commission. All proposed excavation locations shall be marked at the time of notification. No excavation shall be permitted until the authority has located and marked it's underground utilities. The Resident Engineer shall be provided an electronic copy of all Dig Safe tickets within 24 hours of their release for project notifications and 3rd party utility locater coordination.
- 3. The anticipated utilities involved in this contract are:
  Central Maine Power Company
  Charter Communications, Inc.
  Consolidated Communications
  Kennebunk, Kennebunkport & Wells Water District

CONTRACT: 2022.12

4. Contractor shall protect all new and existing utilities from damage during the construction as approved by the utility owners.

Sca	le: AS NOTED			Designed by:	:			h	
No.	Revision	Ву	Date				VII	U	
•				CONSULTANT (	PROJEC	CT MANAGER:	G. Edington		
					Ву	Date		Ву	Date
				Designed	MEB	4/29/22	Checked	GME	4/29/22
				Drawn	DPD	4/29/22	In Charge of	TSB	4/29/22

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THE GOLD STAR MEMORIAL HIGHWAY MTA PROJECT NO. 2022.12

GENERAL NOTES

VHB: 55345.00 SHEET NUMBER:

MTA PROJECT MANAGER: Kristi Van Ooyen, P.E.

- I. These traffic control plans and details apply to all of the project sites included in this Project. Where typical traffic control layouts may be appropriate, the Contractor is directed to use a typical layout from this project's Maintenance of Traffic Details or from the Maine Turnpike Authority Traffic Control Plans located on the MTA website at www.maineturnpike.com/Projects/Construction-Related-Documents.aspx. Where site-specific traffic control plans are required, see the applicable traffic control plans within the Plans. See also the Special Provisions for more details on site specific temporary traffic controls with time and date restrictions.
- 2. All orange construction signs shall be fluorescent orange with Type VIII, IX or XI sheeting. Placement of signs shall be adjusted to avoid obstructing existing signs and to ensure proper sight lines to the construction signs as determined by the Resident and shall be new or in like new condition.
- 3. Temporary lane closures will be required, with advanced approval, whenever work will occur within four feet of the I-95 traveled way. Temporary lane closures shall be removed if no work is occurring. See Special Provisions for more information.
- 4. All lane closures shall require approval from the Maine Turnpike Authority through the Resident. The Resident is required to submit a request for lane closures by noon on Thursday for any lane closures needed for the following week. The Contractor shall plan the work and requests for lane closures accordingly.
- 5. Approach ends of temporary concrete barrier shall be placed outside of the highway clear zone (minimum 34 feet from the traveled way along I-95) or protected by temporary impact attenuators or with guardrail overlaps as approved by the Resident.
- 6. Maximum spacing for channelizing devices (drums) shall be: 80' on center along tangents

40' on center along tapers

7. Work Zone Speed Limits shall only be permitted when temporary lane closures are in place.

# LOCAL ROAD SINGLE LANE CLOSURE/SHOULDER CLOSURE

	CON		ION SIC	GN SUMM	ARY
S	Sign		(Inches)  Letter Vertical Height Spacing		Quantity and Color
G20-2	END ROAD WORK	Shall C	nensions `onform andard way	36"x18"	2 - Black on Orange
W20-I	ROAD WORK AHEAD		- 2012 	36"x36"	2 - Black on Orange
W20-4	ONE LANE ROAD AHEAD				2 - Black on Orange
W20-7		,		36" x 36"	2 - Black on Orange

# STABILIZED CONSTRUCTION ENTRANCE

CON.	CONSTRUCTION SIGN SUMMARY												
Cias	Text Dimensions (Inches)		C:	Overatity and Color									
Sign	Letter Vertical Height Spacing		Size	Quantity and Color									
G20-2 END ROAD WORK	Shall C	mensions Conform andard way	48"x24"	I - Black on Orange									
W7-3aP NEXT NEXT X FEET OF X MILES	Signs"	- 2012   	36"x30"	I - Black on Orange									
W20-1 (AHEAD)			48"×48"	2 - Black on Orange									
W21-5 SHOULDER WORK			48"×48"	I - Black on Orange									
CS-10 TRUCKS ENTERING			48"×48"	I - Black on Orange									

# ABBREVIATIONS FOR ALL WORK ZONE PLANS

BWLL = BROKEN WHITE LANE LINE SWEL = SOLID WHITE EDGE LINE SYEL = SOLID YELLOW EDGE LINE

# Scale: NOT TO SCALE No. Revision By Date CONSULTANT PROJECT MANAGER: G. Edington By Date By Date Designed MLG 4/29/22 Checked MDS 4/29/22 Drawn JAR 4/29/22 In Charge of TSB 4/29/22

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# THE GOLD STAR MEMORIAL HIGHWAY

MTA PROJECT NO. 2022.12

MAINTENANCE OF TRAFFIC DETAILS (1 OF 3)

VHB: 55345.00

CONTRACT: 2022.12

SHEET NUMBER: 4
4 OF 38

# TURNPIKE SHOULDER CLOSURES

		TIOOLDL		
CON	STRUCT	ION SIC	ON SUMN	1ARY
Sign	Text Din (Inc		Size	Quantity and Color
31911	Letter Vertical Height Spacing		3.20	addminy and admin
G20-2 END ROAD WORK	Text Dim Shall C to "Sto High	onform indard	48"x24"	4 - Black on Orange
W20-I (AHEAD)	Signs"	- 2012	48" x 48"	4 - Black on Orange
W21-5aL LEFT SHOULDER CLOSED 1000 FT			48"×48"	2 - Black on Orange
W21-5aR RIGHT SHOULDER CLOSED 1000 FT			48"×48"	I - Black on Orange
W21-5bL LEFT SHOULDER CLOSED			48"×48"	2 - Black on Orange
W21-5bR RIGHT SHOULDER CLOSED			48"×48"	I - Black on Orange

# TEMPORARY SINGLE AND DOUBLE LANE CLOSURES

	CON	STRUCT	ION SIC	GN SUMN	IARY
S	Sign		mensions hes) Vertical	Size	Quantity and Color
CS-3	EXPECT STOPPED TRAFFIC	Height Spacing  7" 7" 4" 48"x48"		48"×48"	4 - Black on Orange
G20-2	END ROAD WORK	Shall C	 mensions `onform andard way	48"x24"	4 - Black on Orange
G20-5aP	WORK ZONE		- 2012 	36"x24"	4 - Black on Orange
R2-I(60)	SPEED LIMIT 60			48"x60"	4 - Black on White
R2-6aP	FINES DOUBLE			36"x24"	4 - Black on White
R2-12	END WORK ZONE SPEED LIMIT			36"x54"	4 - Black on White
W 3-4	BE PREPARED TO STOP			48" x 48"	4 - Black on Orange
W3-5(60)	SPEED LIMIT 60			48"×48"	4 - Black on Orange
W4-2L				48" x 48"	8 - Black on Orange
W4-2R				48" x 48"	4 - Black on Orange

# TEMPORARY SINGLE AND DOUBLE LANE CLOSURES CONTINUED

	CON	STRUCT	ION SIC	GN SUMM	IARY
S	ign		mensions hes) Vertical Spacing	Size	Quantity and Color
W8-I	BUMP	Text Dimensions Shall Conform to "Standard Highway Signs" - 2012		48"x48"	8 - Black on Orange
W8-24a	RUMBLE STRIP AHEAD	Signs	- 2012	48" x 48"	4 - Black on Orange
W20-I	ROAD WORK 1 MILE			48" x 48"	4 - Black on Orange
W20-5a	2 LEFT LANES CLOSED 1/2 MILE			48" x 48"	4 - Black on Orange
W20-5L	LEFT LANE CLOSED 1/2 MILE			48"x48"	4 - Black on Orange
W20-5R	RIGHT LANE CLOSED 1/2 MILE			48" x 48"	4 - Black on Orange

Scale: NOT TO SCALE

No. Revision

By Date

CONSULTANT PROJECT MANAGER: G. Edington

By Date

By Date

Designed MLG 4/29/22 Checked MDS 4/29/22

Drawn

JAR 4/29/22 In Charge of TSB 4/29/22

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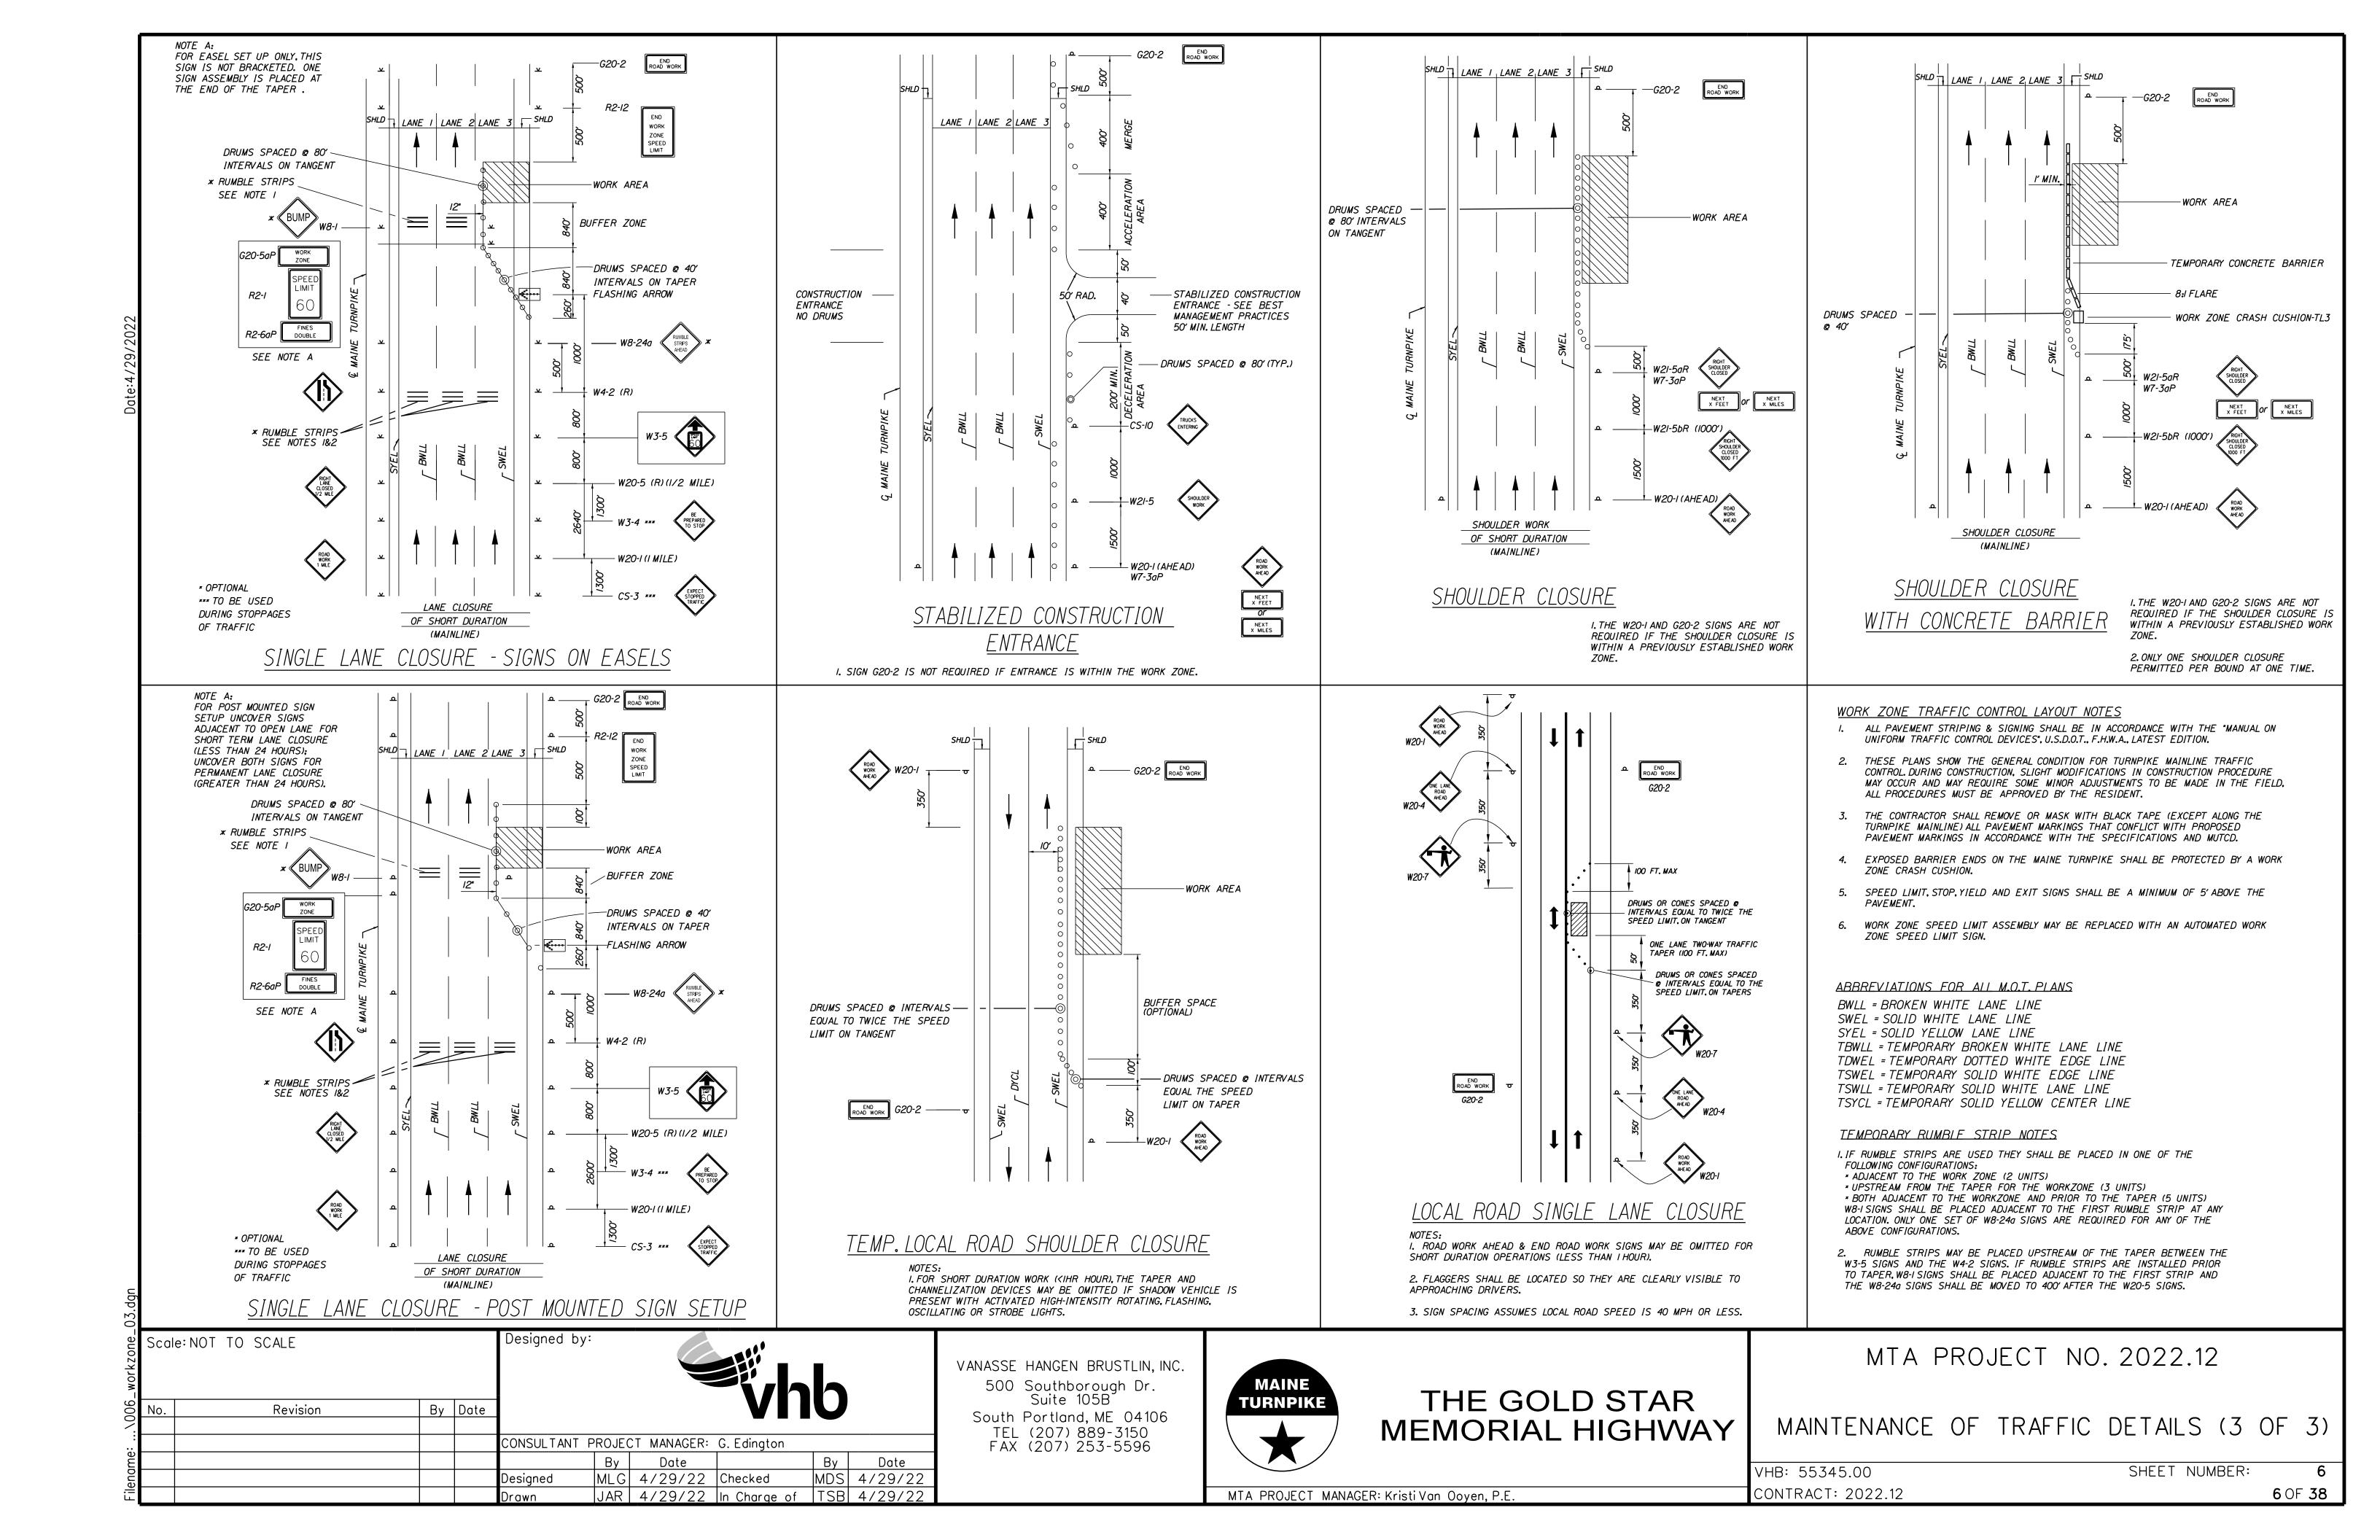


# THE GOLD STAR MEMORIAL HIGHWAY

MTA PROJECT NO. 2022.12

MAINTENANCE OF TRAFFIC DETAILS (2 OF 3)

VHB: 55345.00 CONTRACT: 2022.12 SHEET NUMBER: 5
5 OF 38




DETOUR FOR ROUTE I (RAMP J) UNDERPASS CLOSURE


	DETOUR SIGN SUMMARY											
	Sign		nensions hes)	Size	Quantity and Color							
		Letter Height	Vertical Spacing									
MI-4(I)		SH	/SB	36" x 36"	5 - Black on White							
M3-1	NORTH			36"x18"	5 - Black on White							
M4-8	DETOUR			30"x15"	5 - Black on Orange							
M4-IOR	DETOUR			48" x   8"	I - Black on Orange on Black							
M5-I(L)				30"x2I"	I - Black on White							
M5-3				30"x2I"	I - Black on White							
M6-I(R)				30"x2I"	I - Black on White							
M6-2(R)				30"x2I"	I - Black on White							
M6-3				30"x2I"	I - Black on White							
E5-2aM	RAMP CLOSED			48" x 36"	I - Black on Orange							

SHSB - Text Dimensions Shall Conform to "Standard Highway Signs Book" - 2012 Edition.

## CONSTRUCTION NOTE:

Detour signs shall not be installed more than two weeks prior to the start of the detour and all detour and other traffic control materials shall be removed within two weeks of the end of the detour.

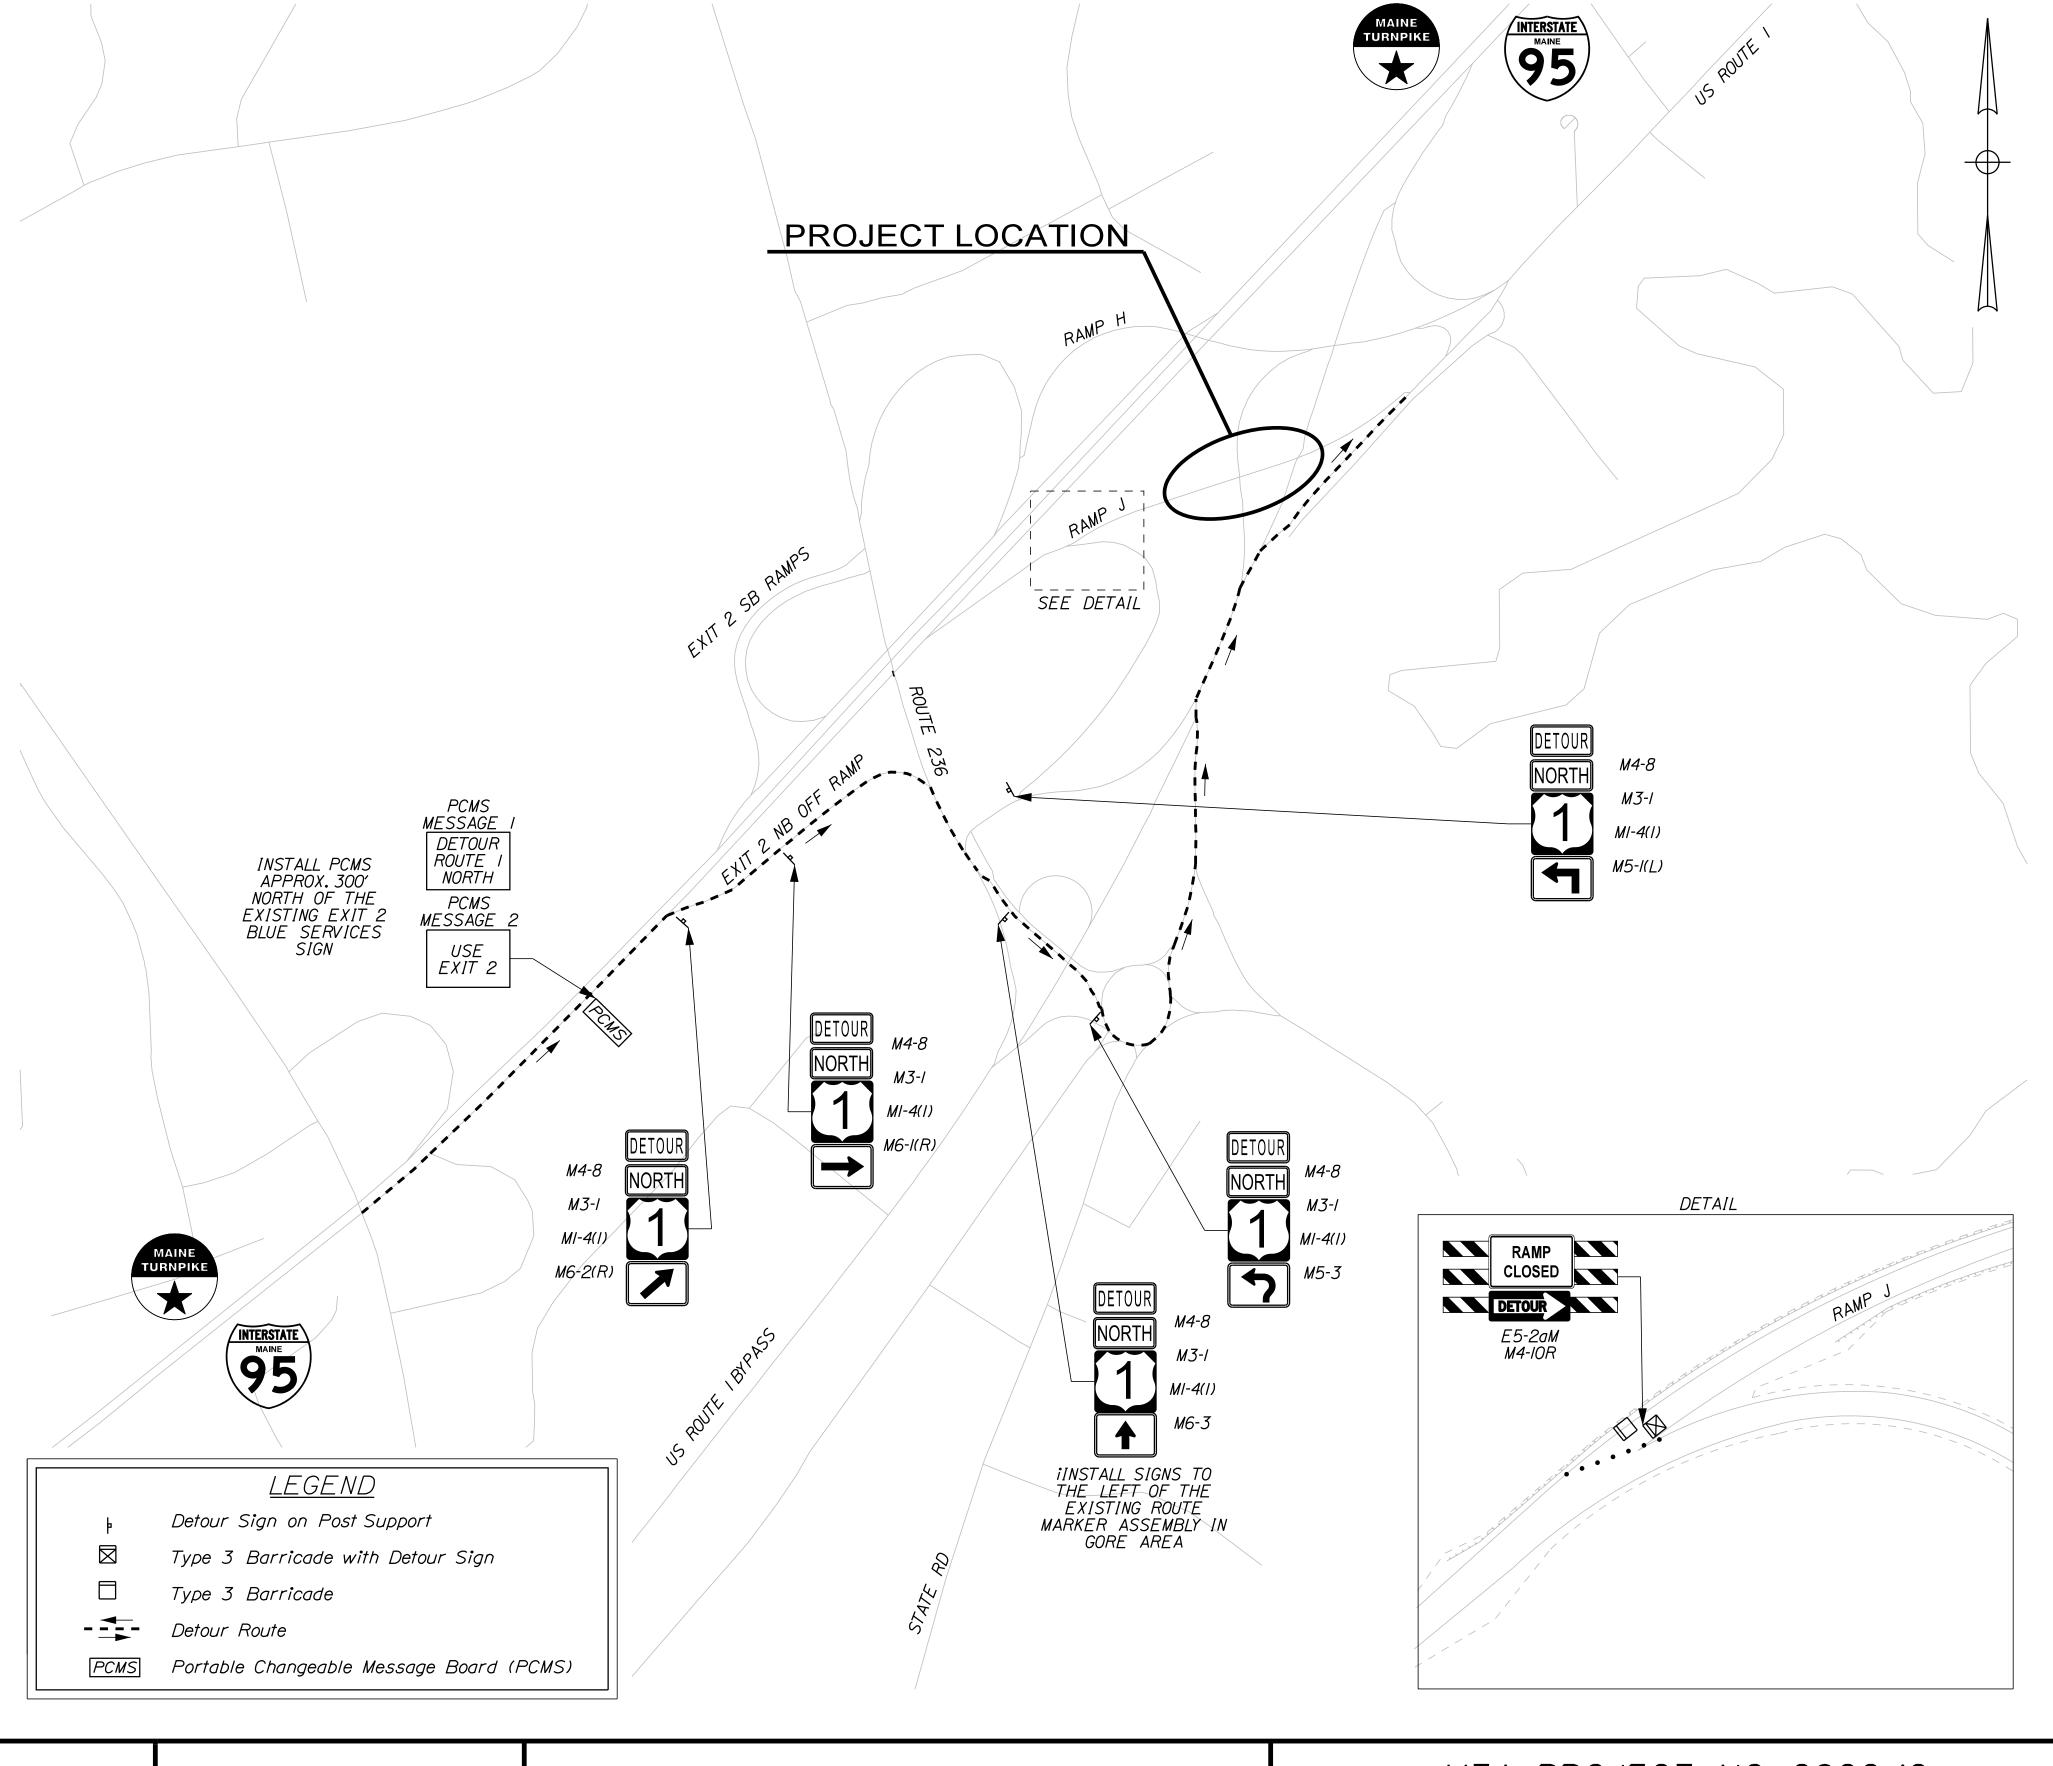

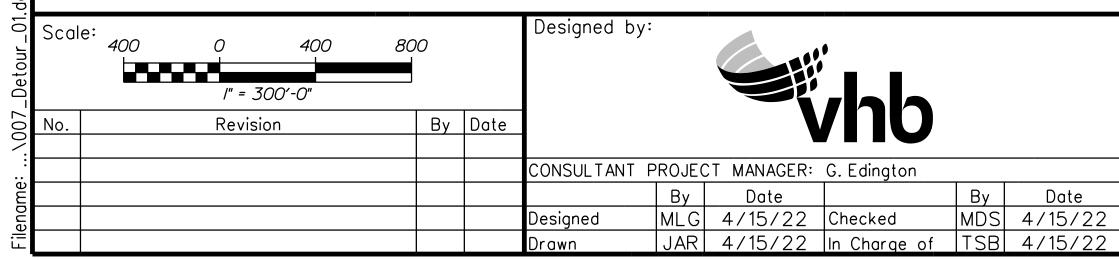

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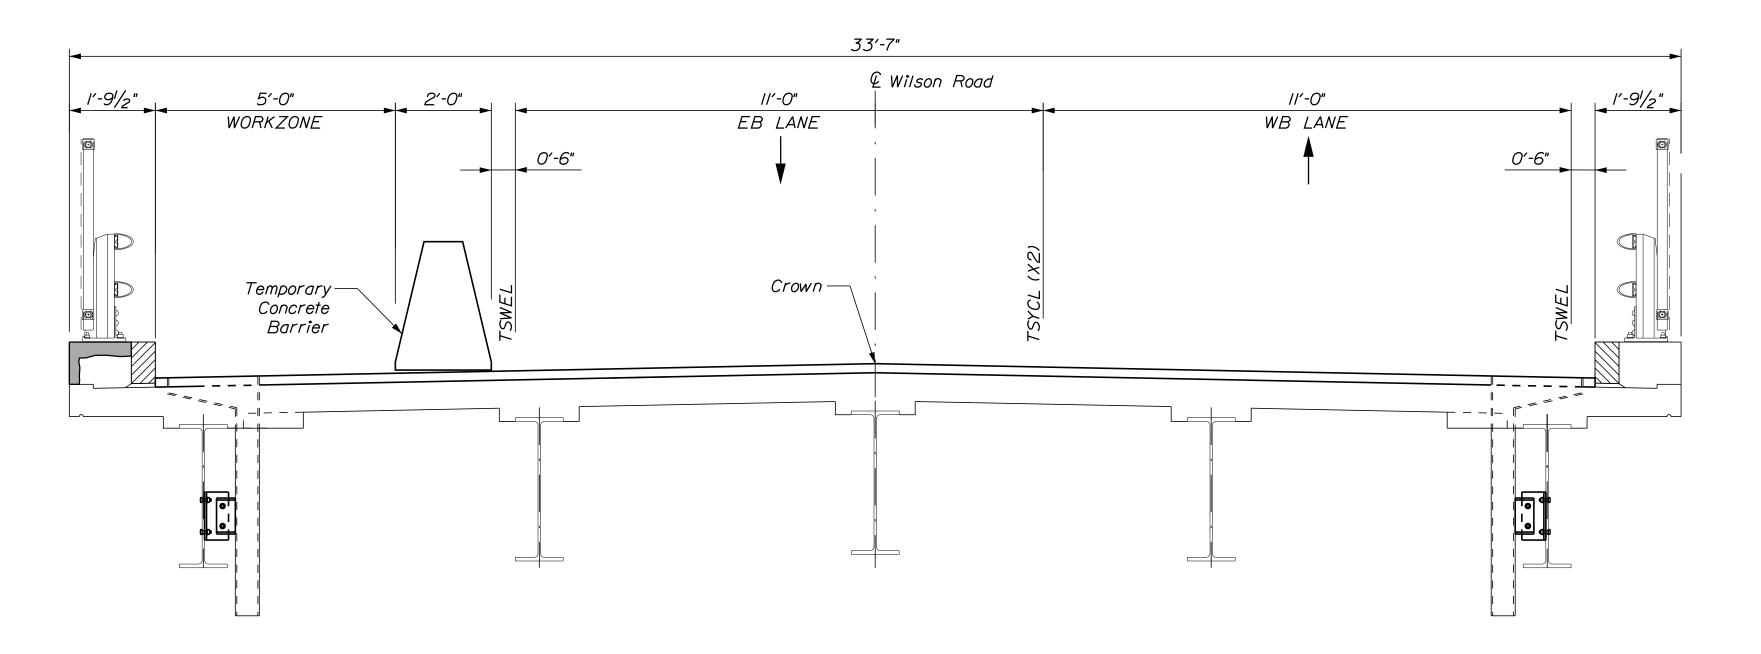


THE GOLD STAR MEMORIAL HIGHWAY


MTA PROJECT NO. 2022.12 RAMP "J" UNDERPASS AT MM 1.50 IN YORK, ME DETOUR PLAN

 VHB: 55345.00
 SHEET NUMBER:
 7

 CONTRACT: 2022.12
 7 OF 38



# SOUTH SIDE CURB REPAIR CRITICAL SECTION Scale: 1/2" = 1'-0"

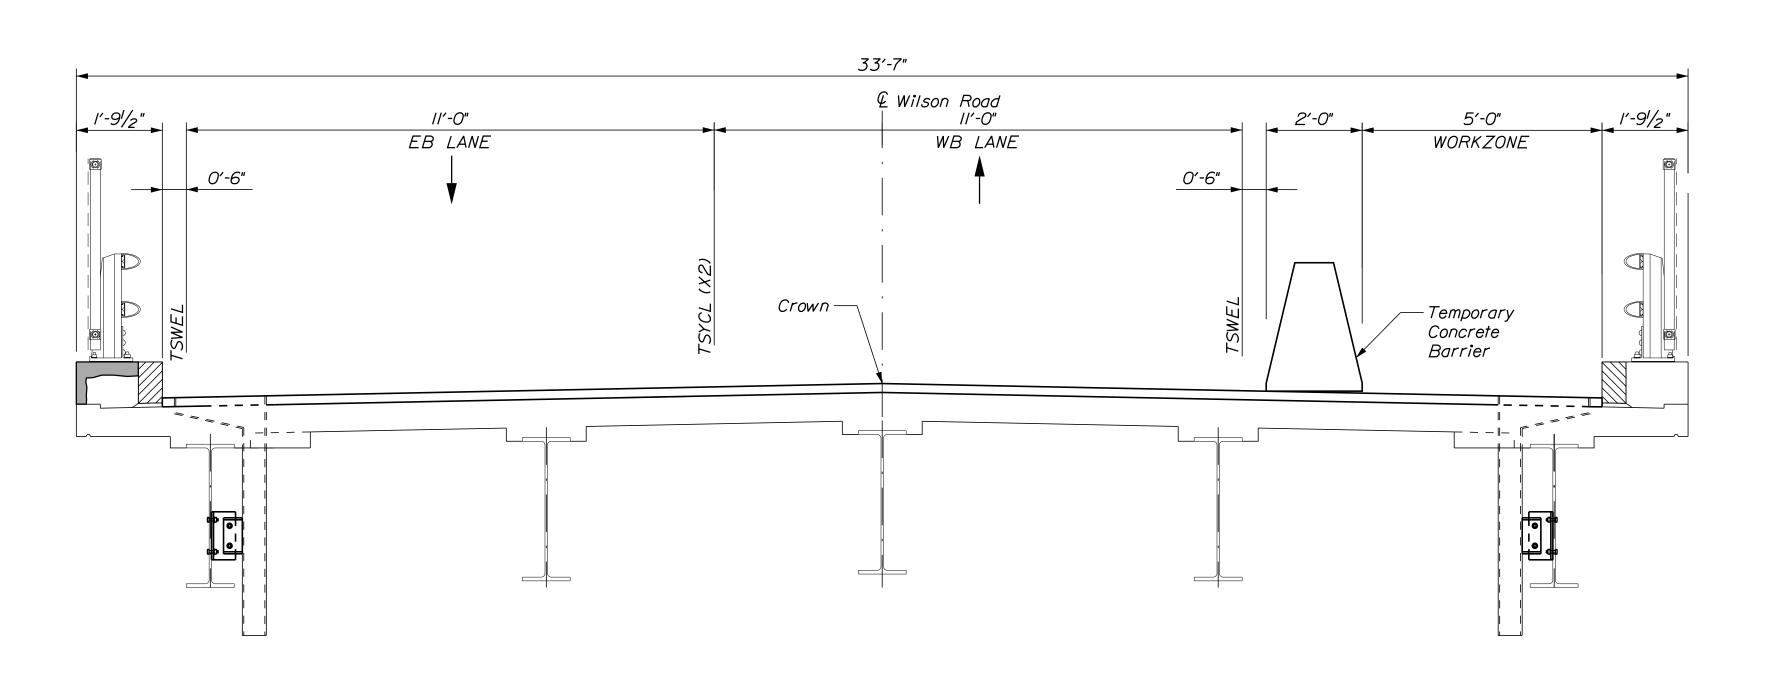

# NORTH SIDE CURB REPAIR CRITICAL SECTION

Scale: 1/2" = 1'-0"

Sca	e: AS NOTED			Designed b	y:		, 		
No.	Revision	Ву	Date	- -			/no		
				CONSULTANT	PROJEC	CT MANAGER:	G. Edington		
					Ву	Date		Ву	Date
				Designed	MÉB	4/15/22	Checked	GME	4/15/22
				Drawn	DPD	4/15/22	In Charge of	TSB	4/15/22

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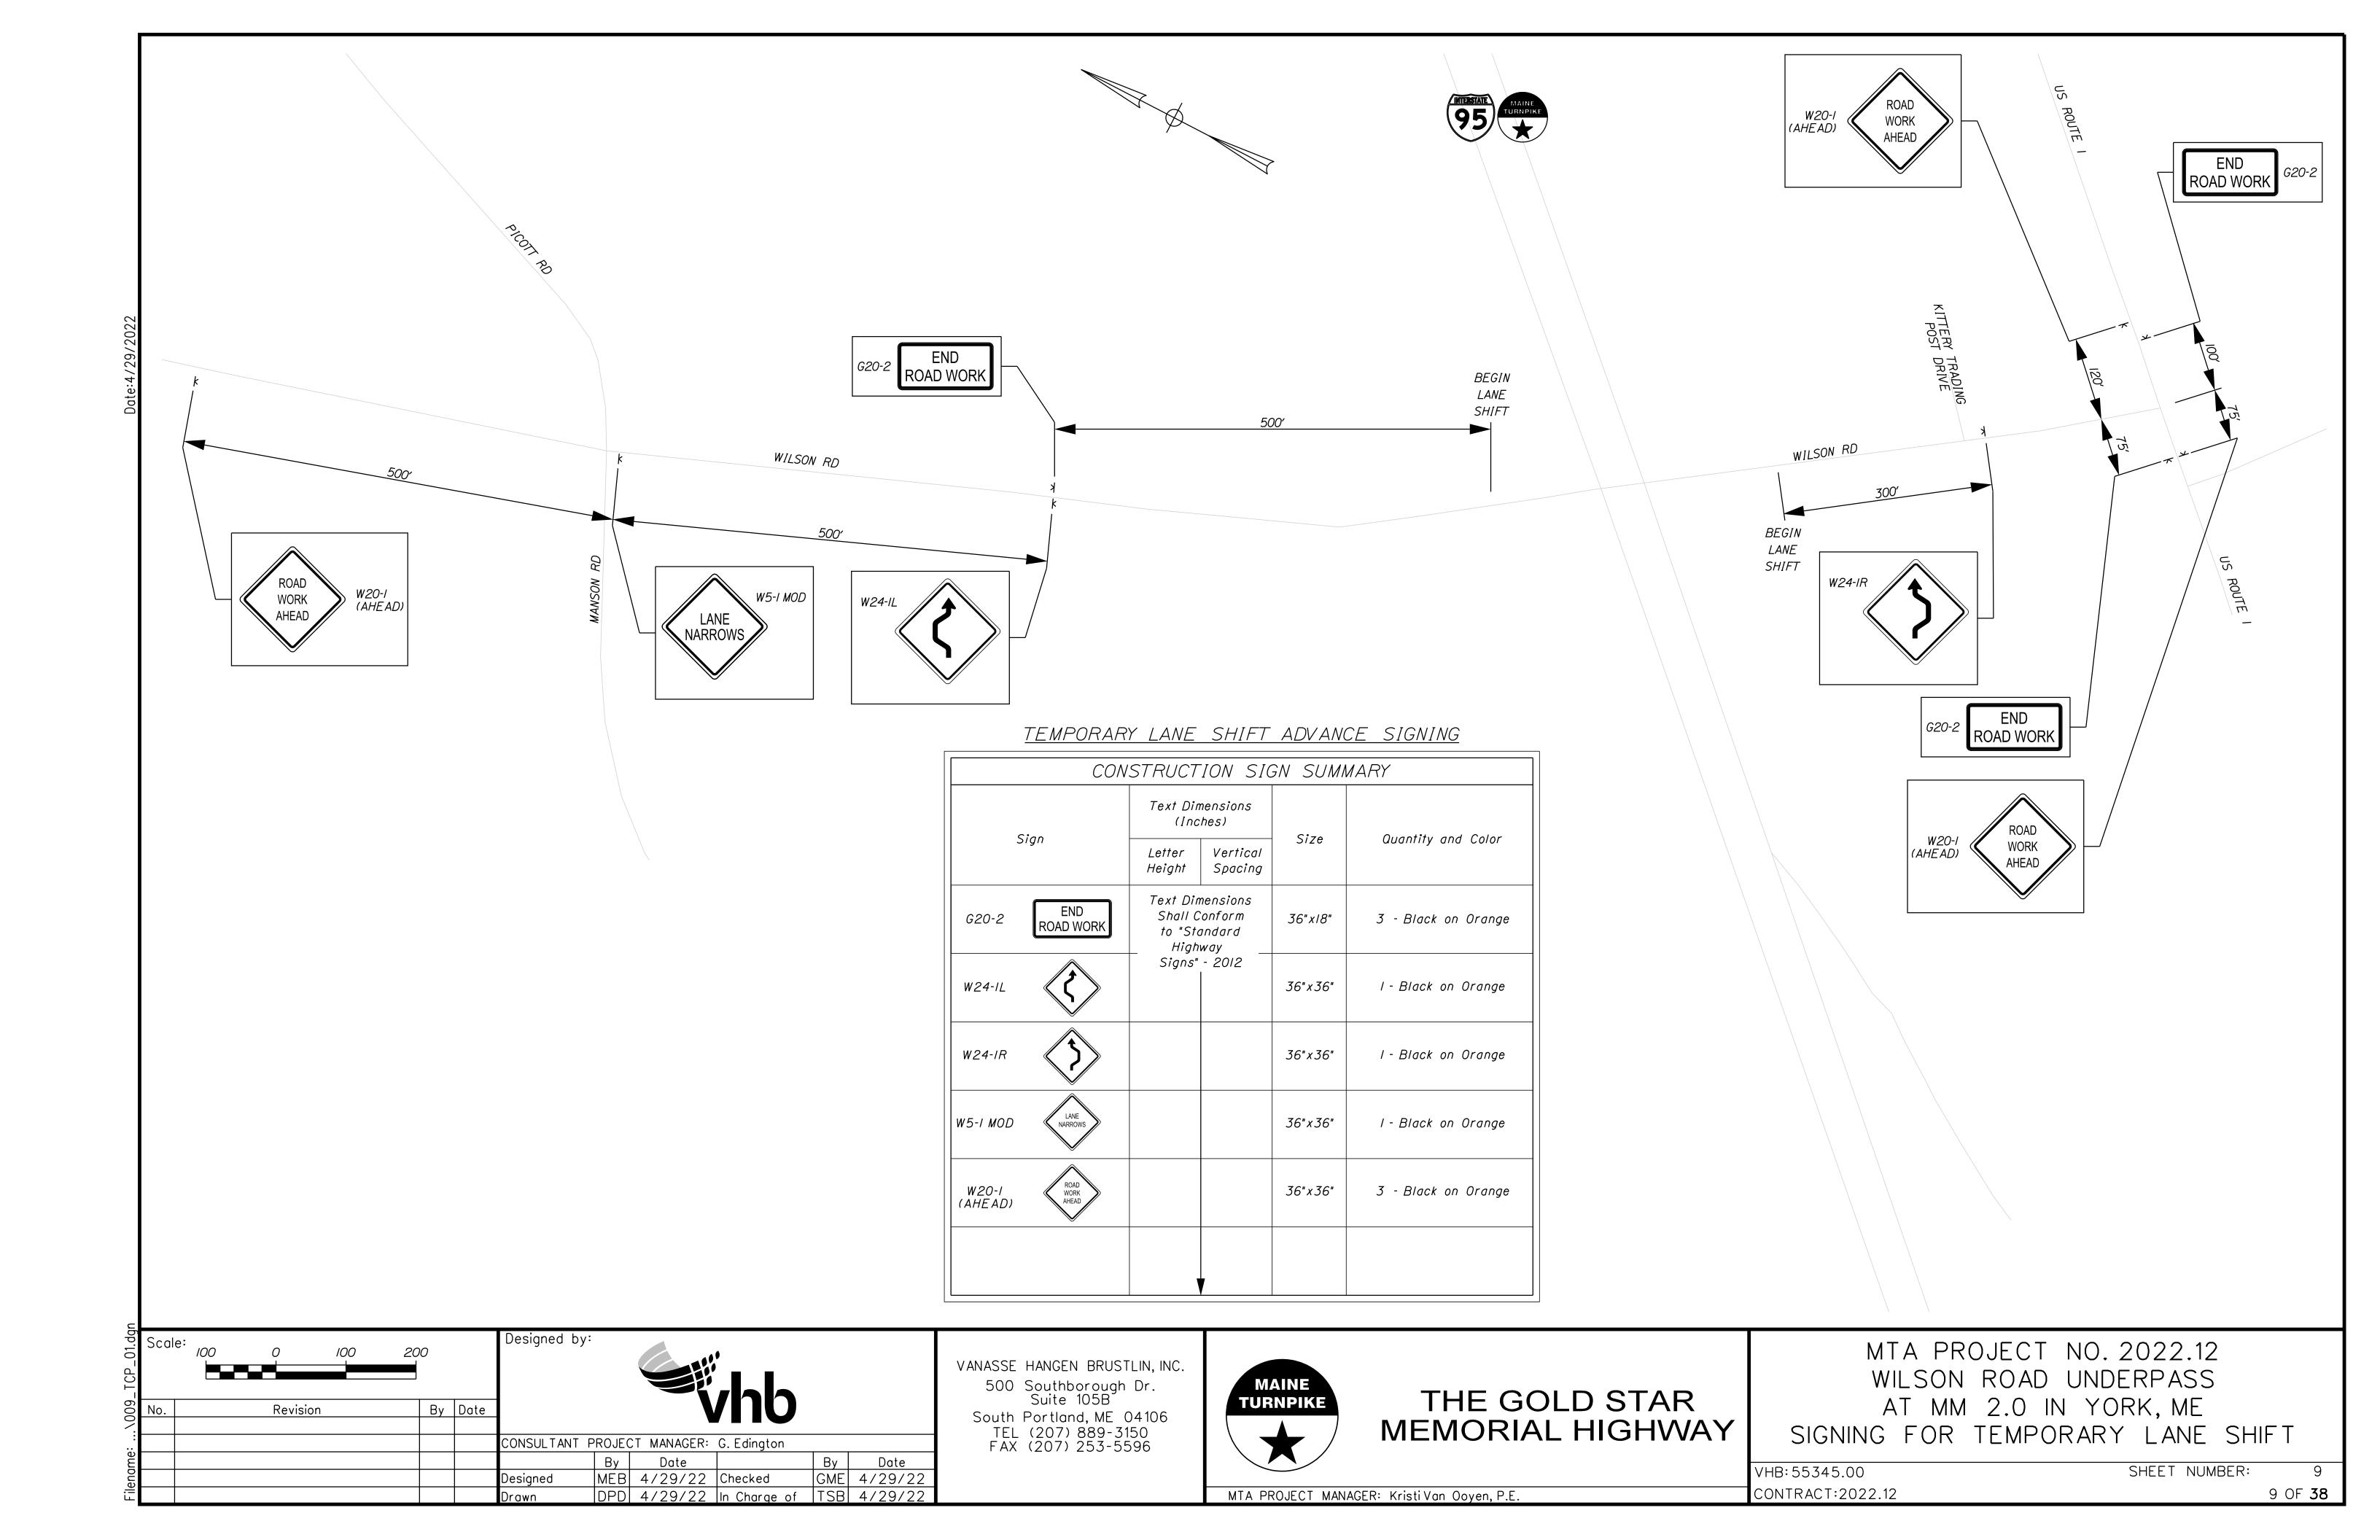



# THE GOLD STAR MEMORIAL HIGHWAY


MTA PROJECT NO. 2022.12
WILSON ROAD UNDERPASS
AT MM 2.0 IN YORK, ME
CURB REPAIR CRITICAL SECTIONS


 VHB: 55345.00
 SHEET NUMBER:
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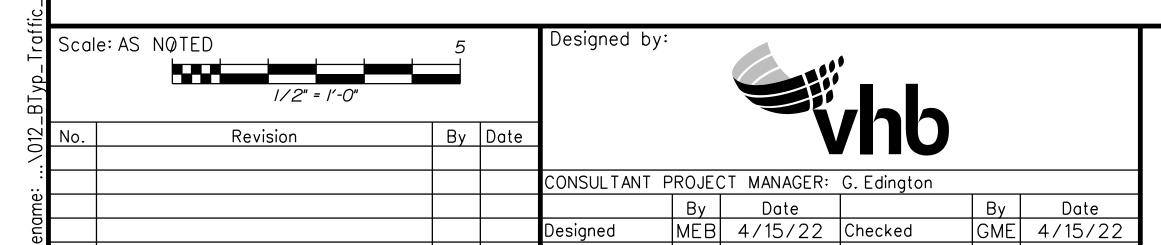
 CONTRACT: 2022.12
 8 OF 38





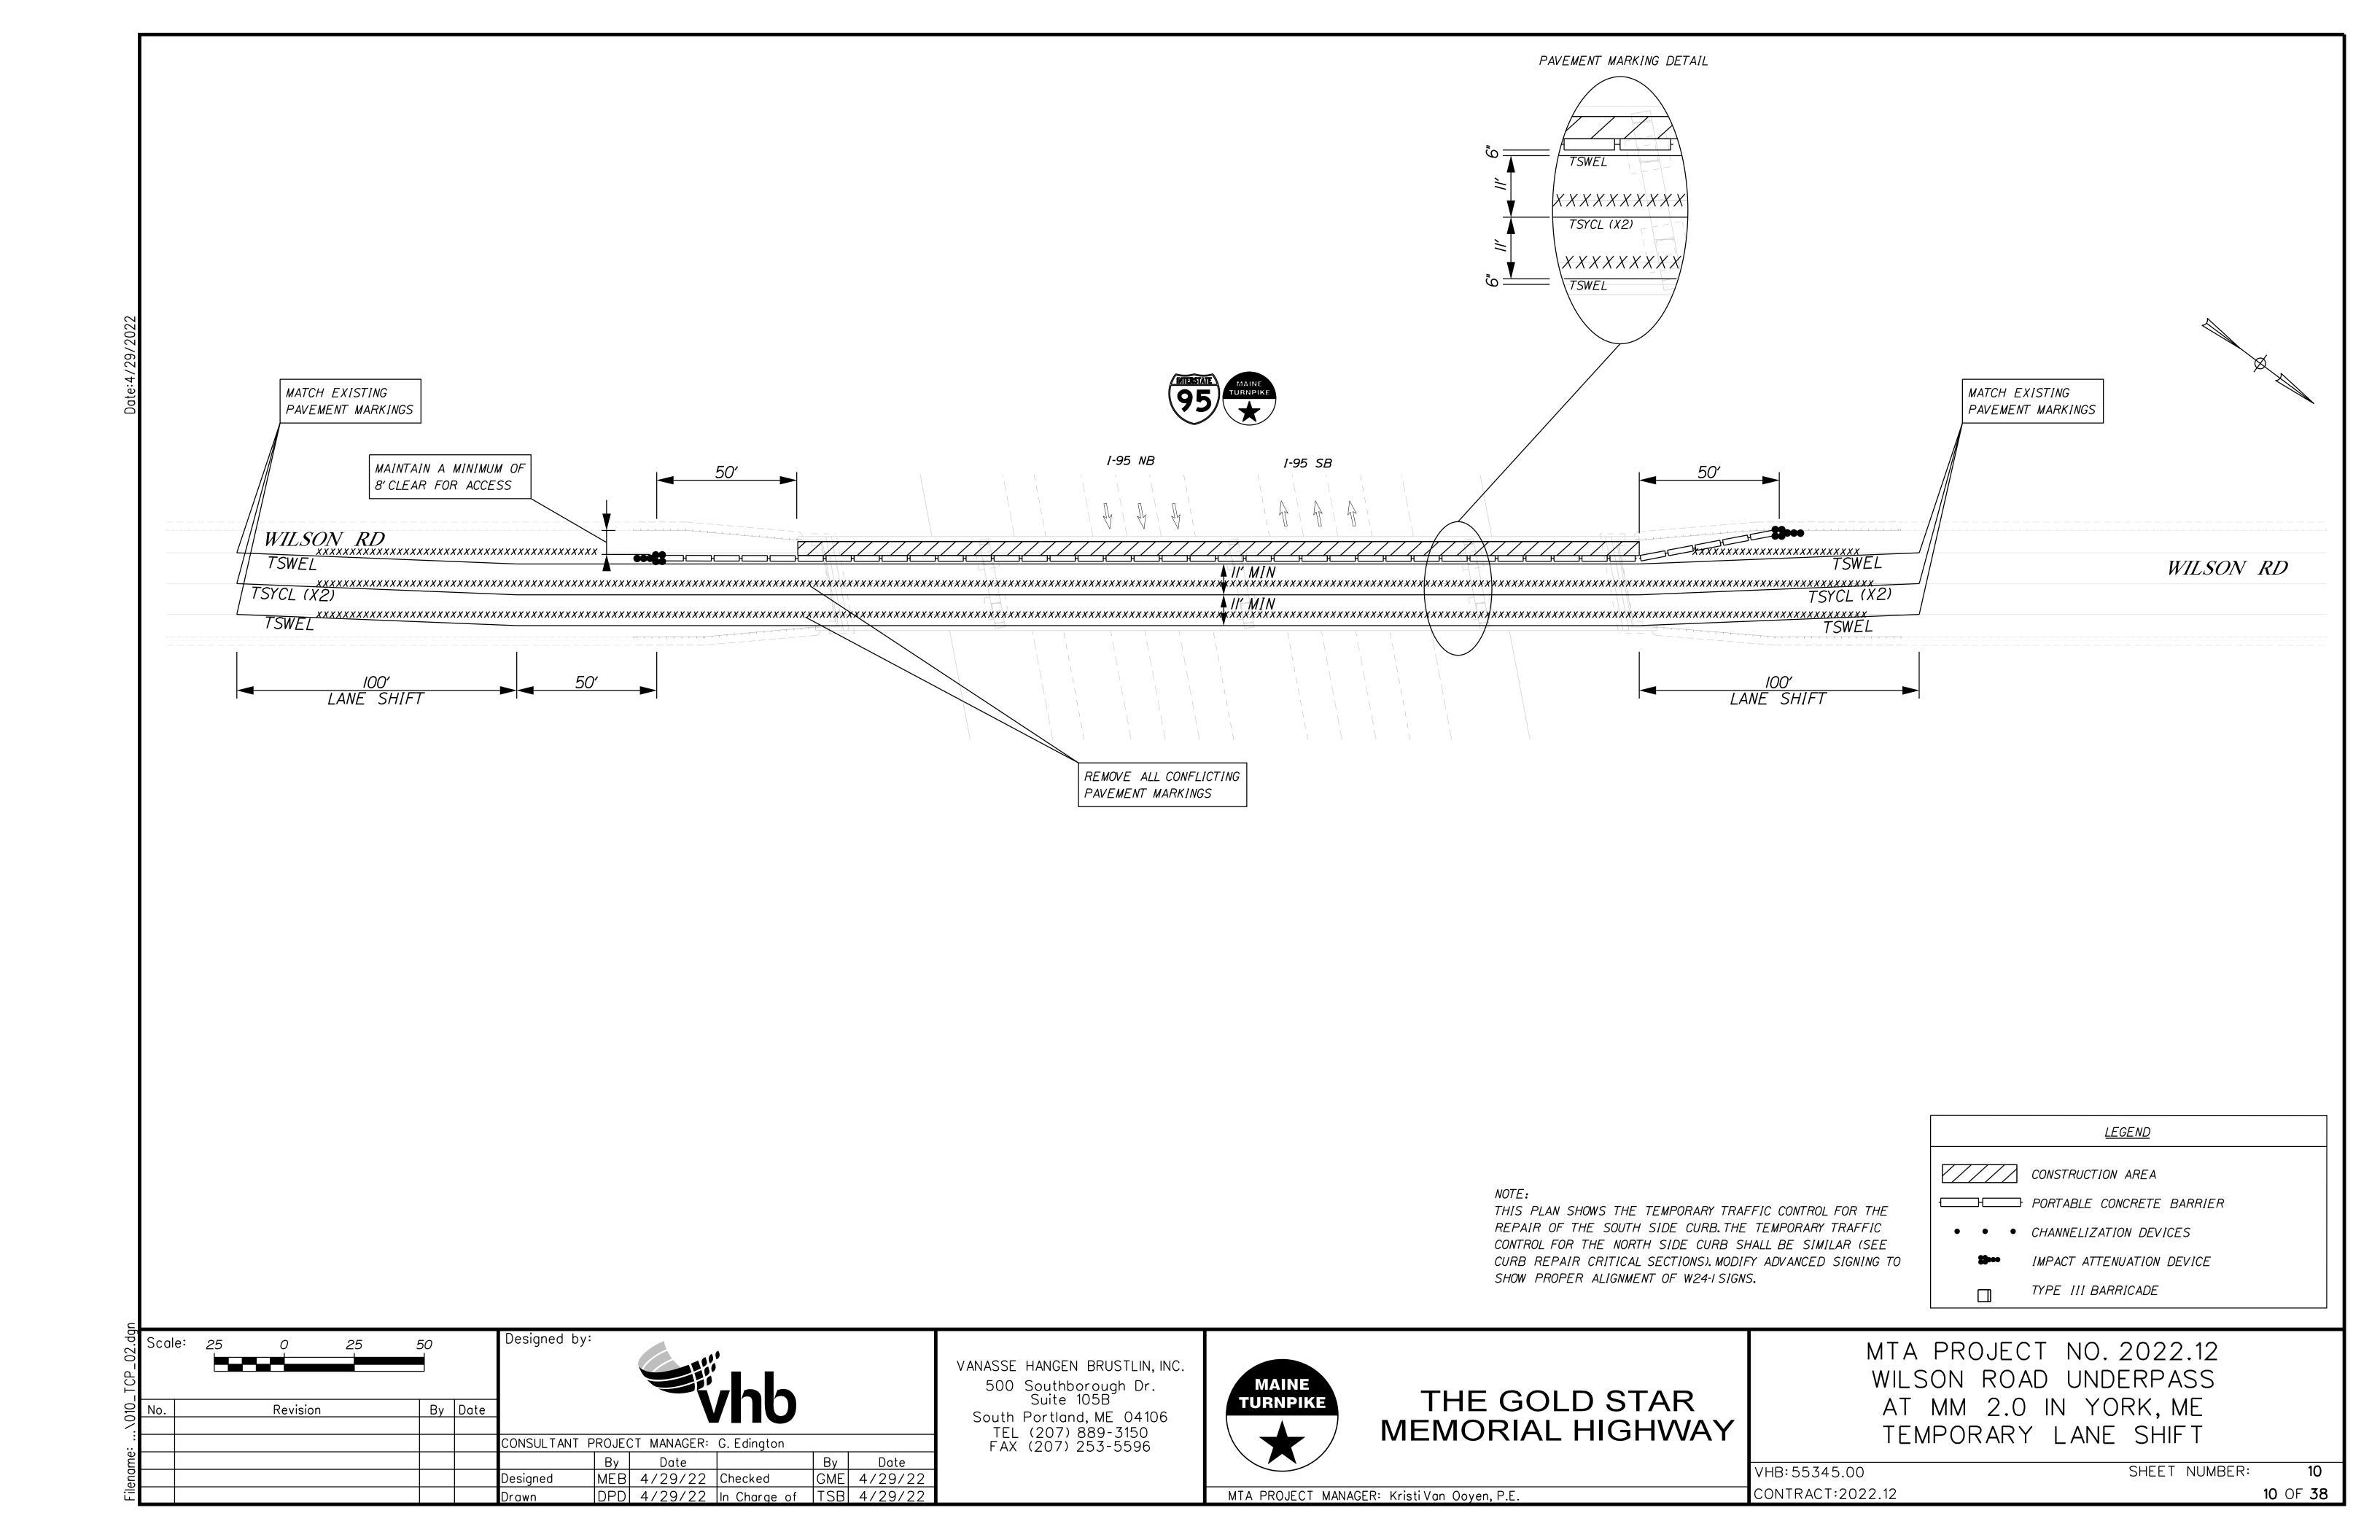

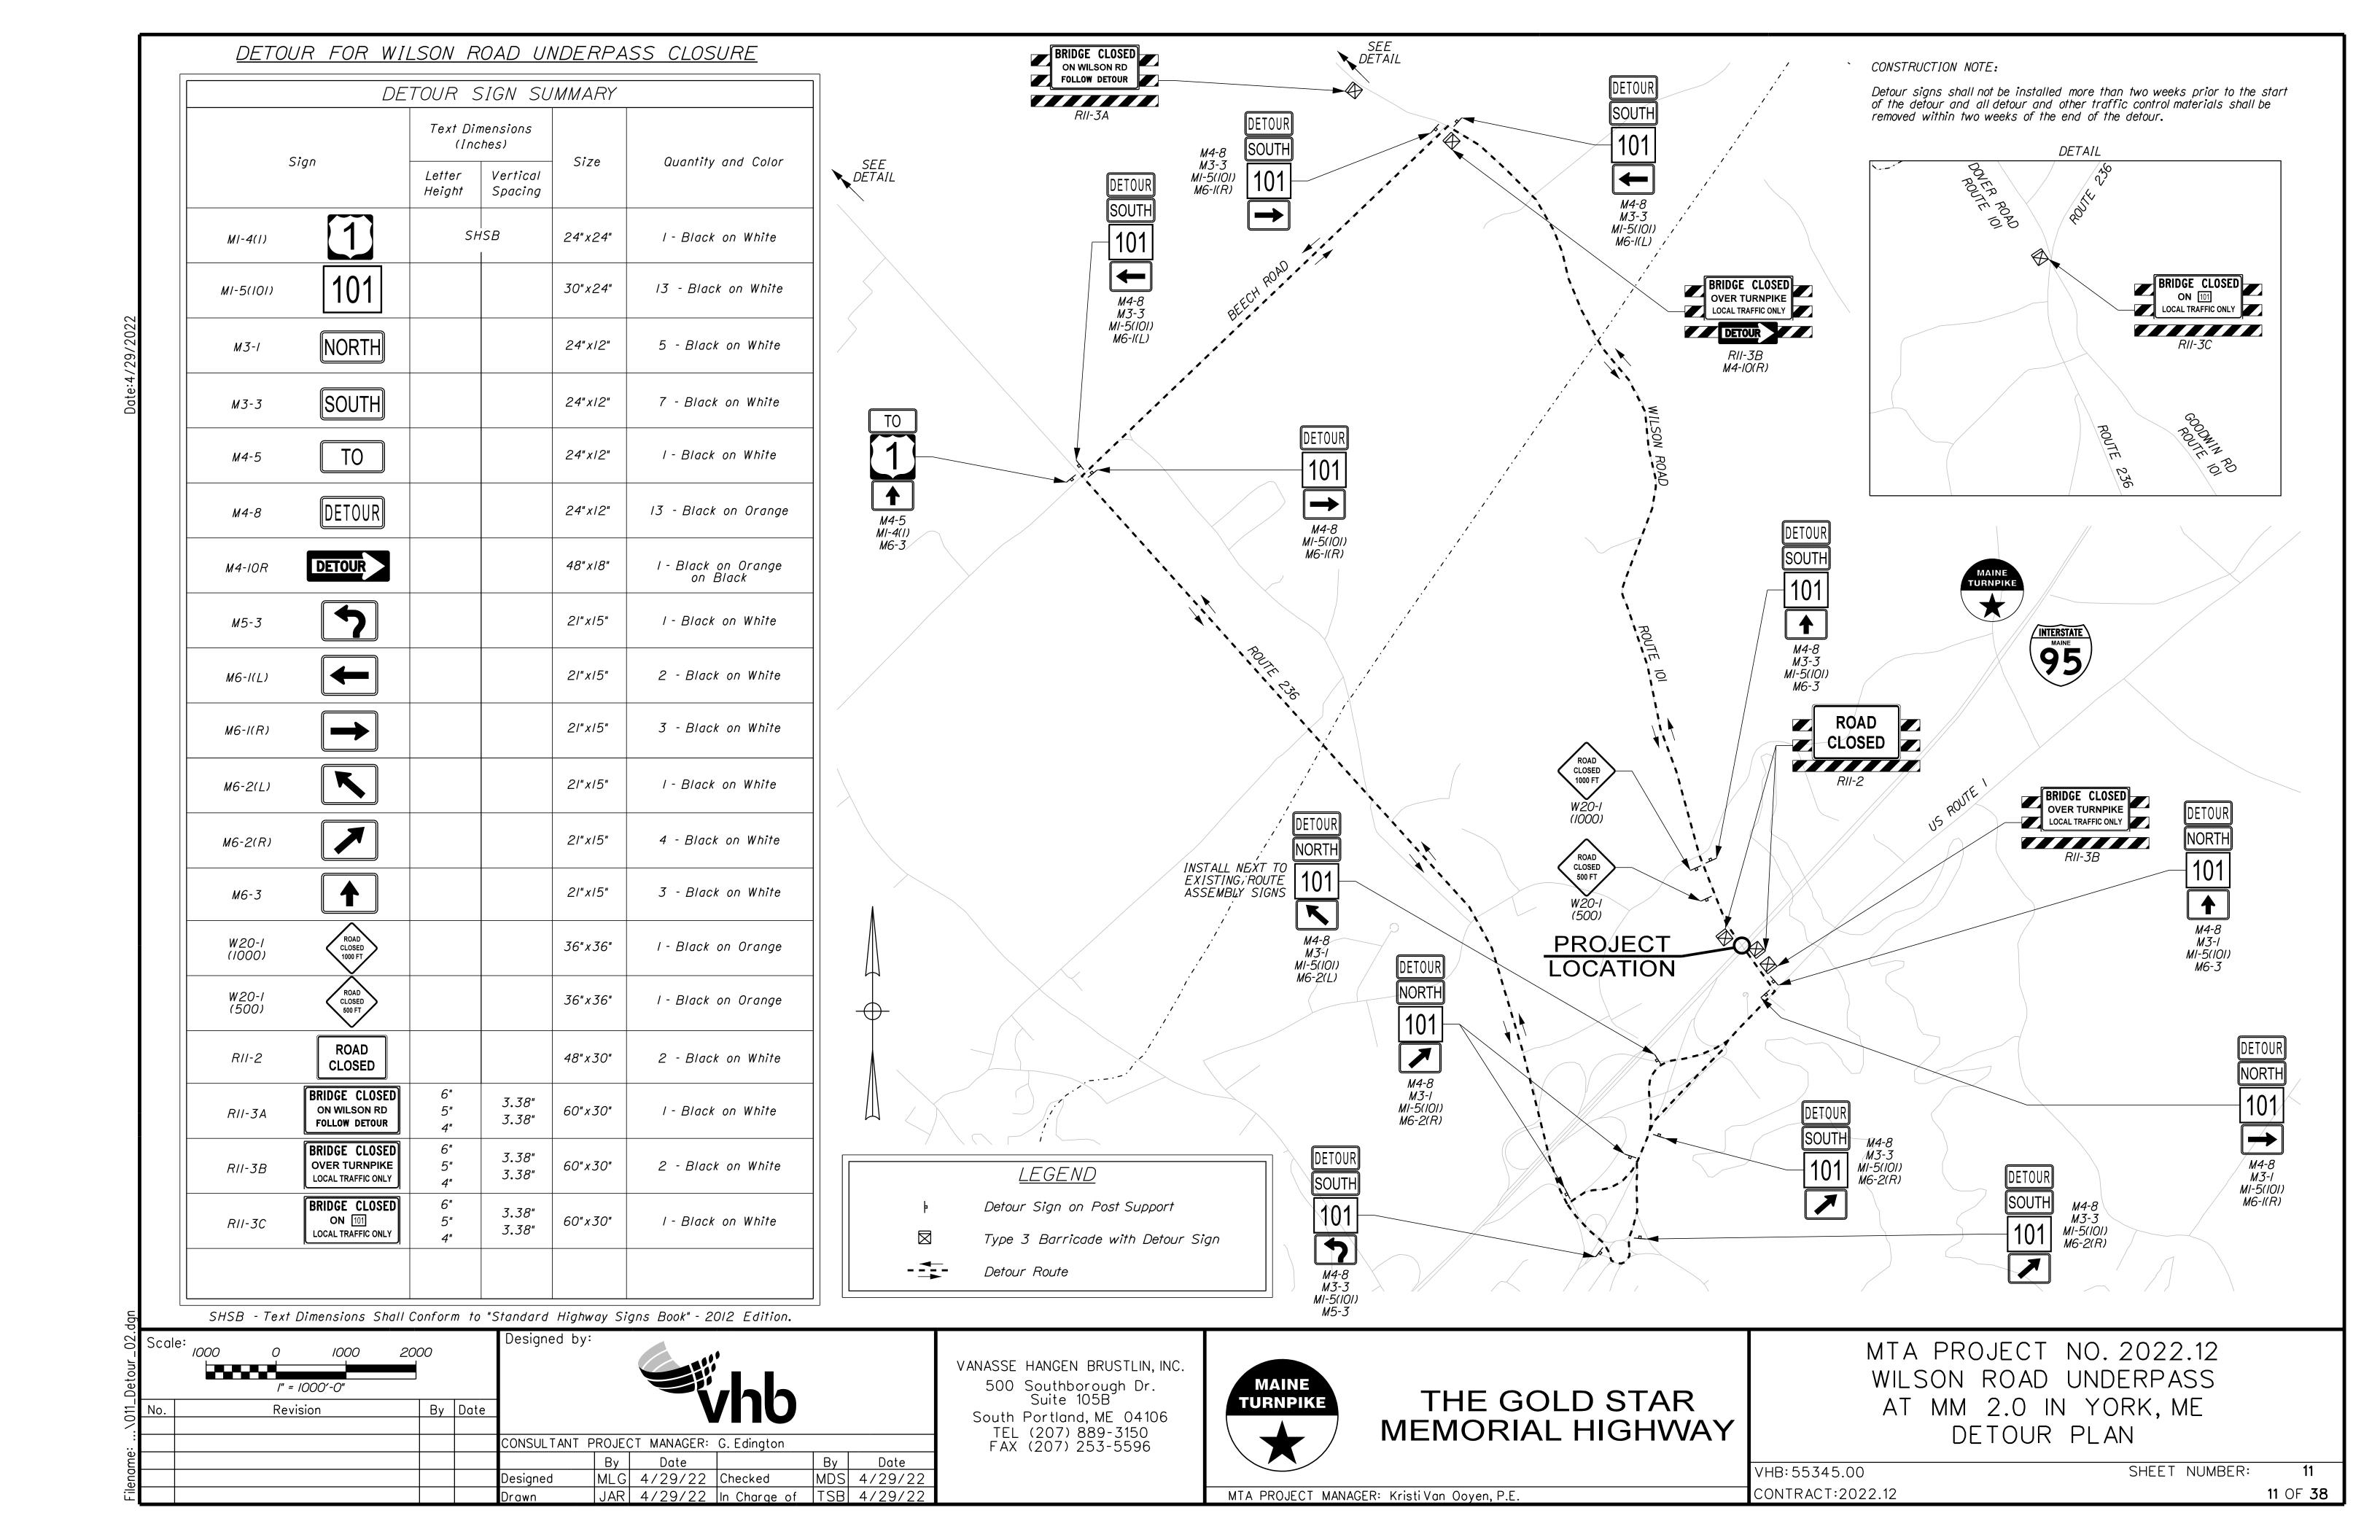

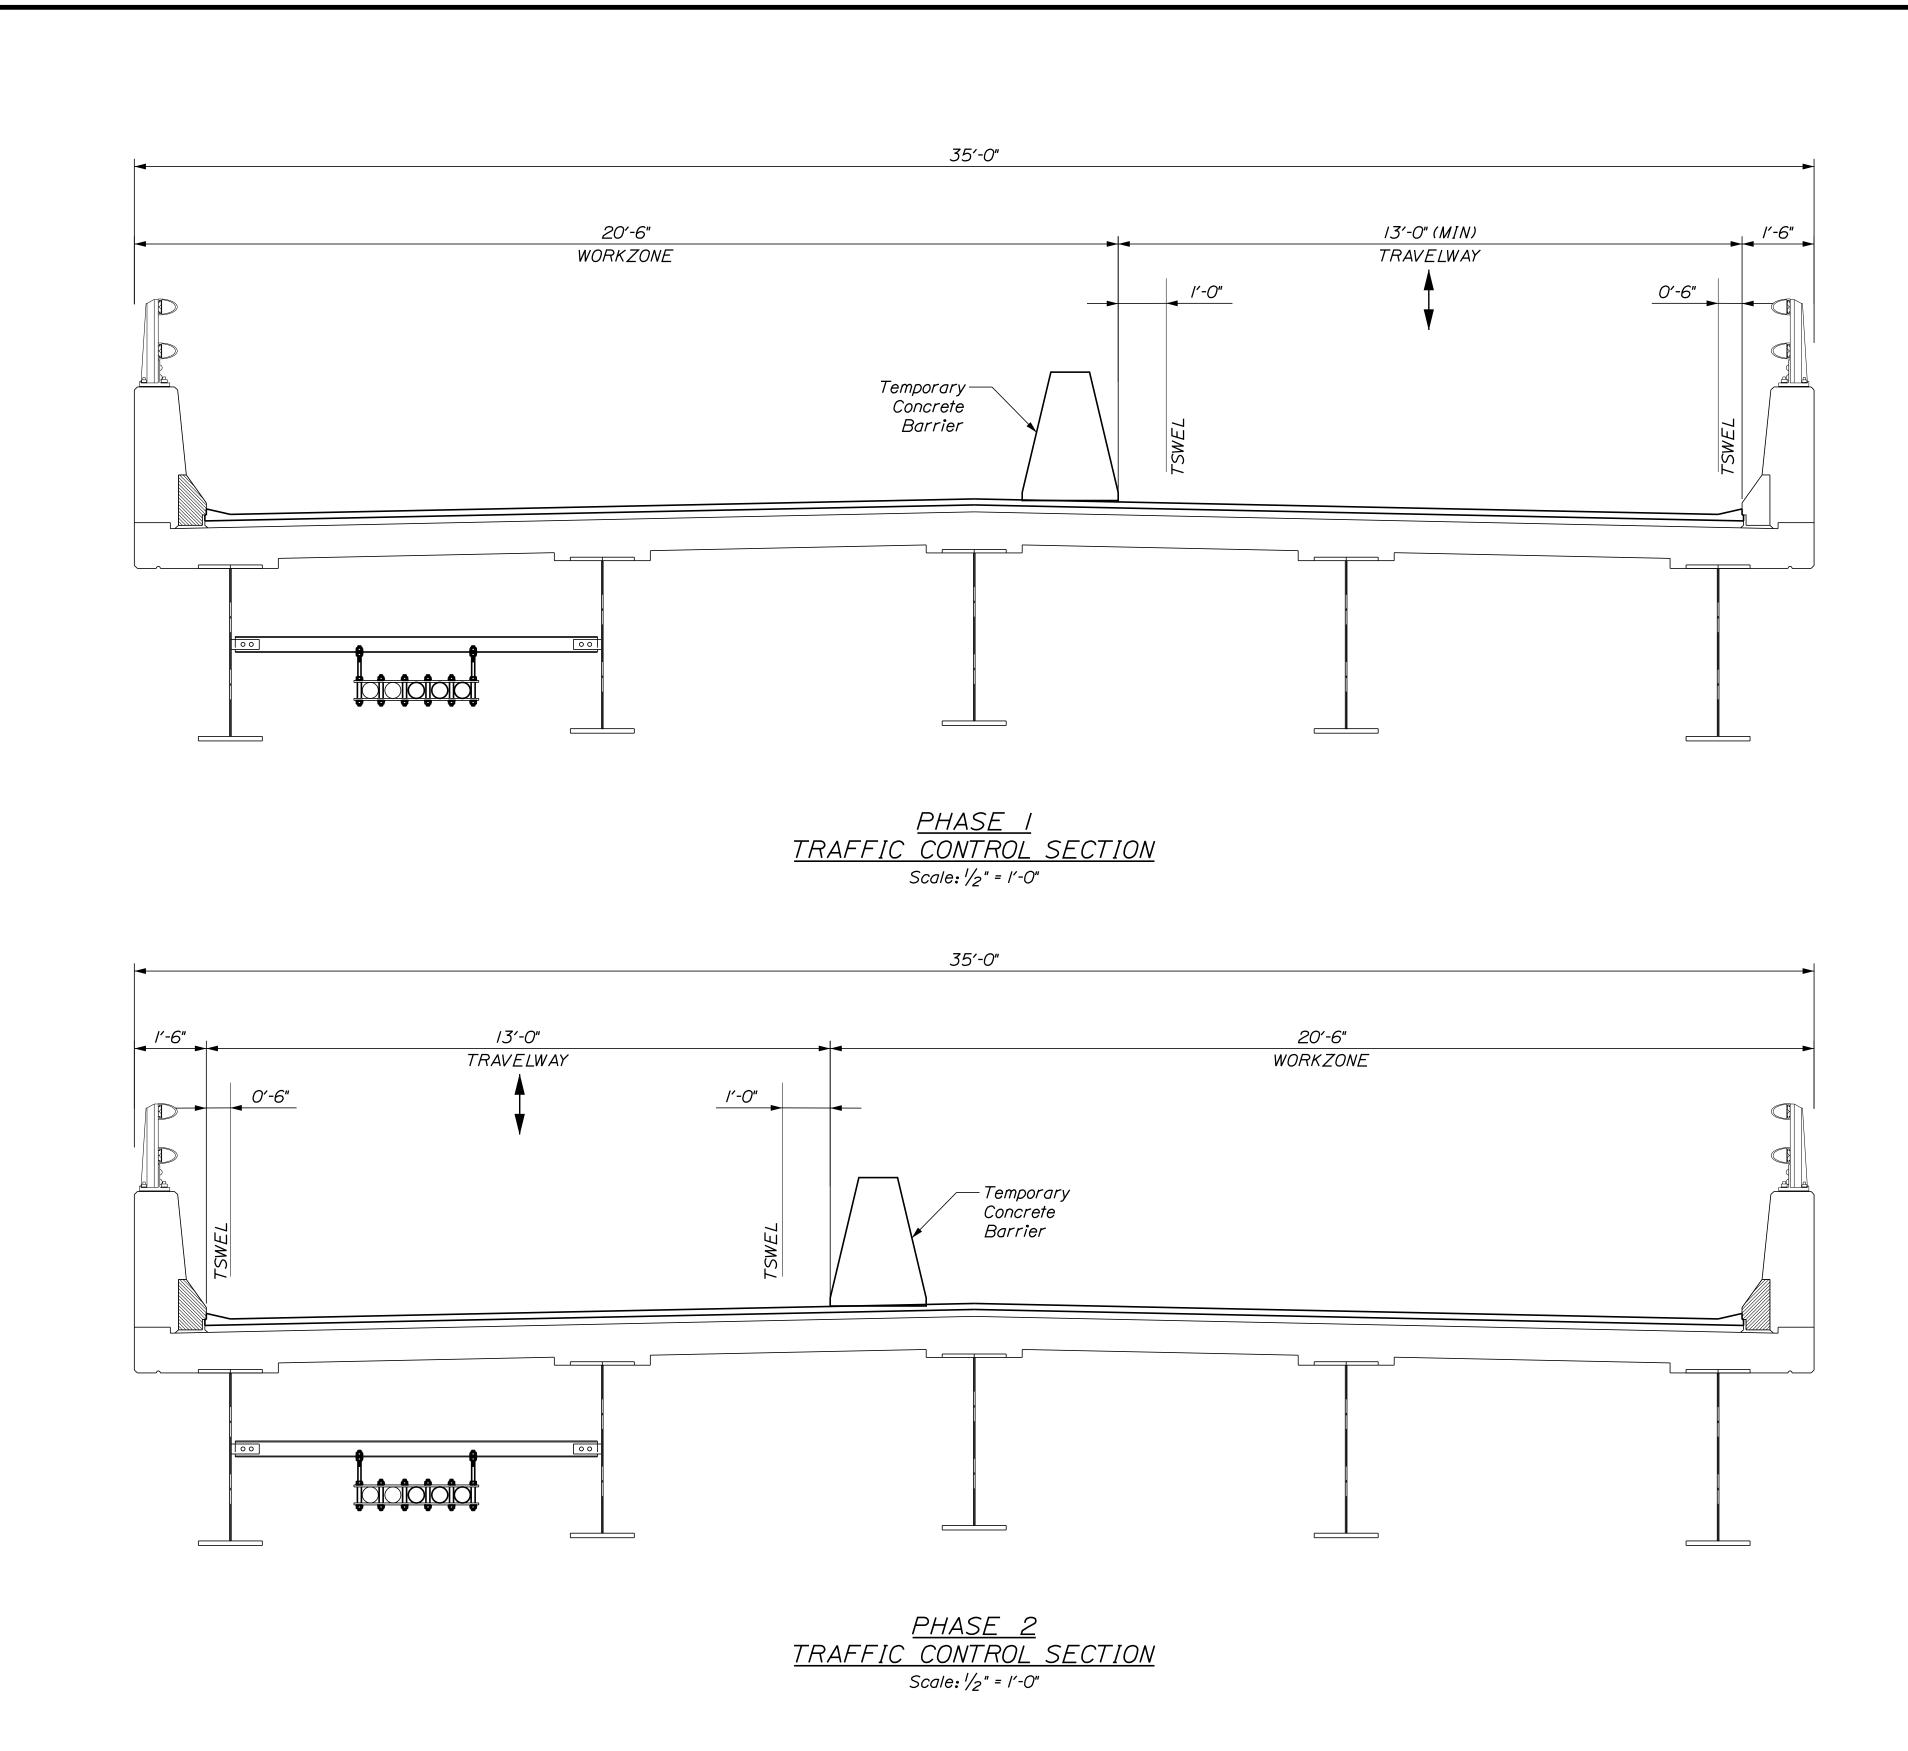

DPD 4/15/22 In Charge of TSB 4/15/22

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MAINE TURNPIKE

# THE GOLD STAR MEMORIAL HIGHWAY

MTA PROJECT NO. 2022.12 LITTLEFIELD ROAD UNDERPASS AT MM 17.3 IN WELLS, ME LANE CLOSURE CRITICAL SECTION

12 SHEET NUMBER: VHB: 55345.00 CONTRACT:2022.12 12 OF 38

#### OVERSIZED VEHICLE DETOUR FOR LITTLEFIELD ROAD UNDERPASS CLOSURE DETOUR SIGN SUMMARY Text Dimensions (Inches) Size Quantity and Color Vertical Spacing Height 96"x18" 4 - Black on Orange CS-4 VEHICLES OVER 12FT WIDE 96" x 36" 4 - Black on White CS-5 LITTLEFIELD RD **4.**5 AT TURNPIKE BRIDGE **4.**5 Text Dimensions Shall Conform G20-2 36"x18" 2 - Black on Orange **ROAD WORK** to "Standard Highway

Signs" - 2012

24" x 36"

36" x 36"

36" x 36"

36" x 36"

2 - Black on White

2 - Black on Orange (Red/Yellow/Green)

2 - Black on Orange

2 - Black on Orange

# TRAFFIC CONTROL NOTES:

HERE ON RED

ONE LANE BRIDGE

R10-6

W3-3


W5-3

W20-1

(AHEAD)

I. Advanced signing for the temporary signal system shall not be installed more than 2 days prior to the activation of the temporary signal system and shall be removed immediately after the removal of the temporary signal system.

2. The wide vehicle prohibition signs shall be in place anytime the available roadway width is less than 14'-0".

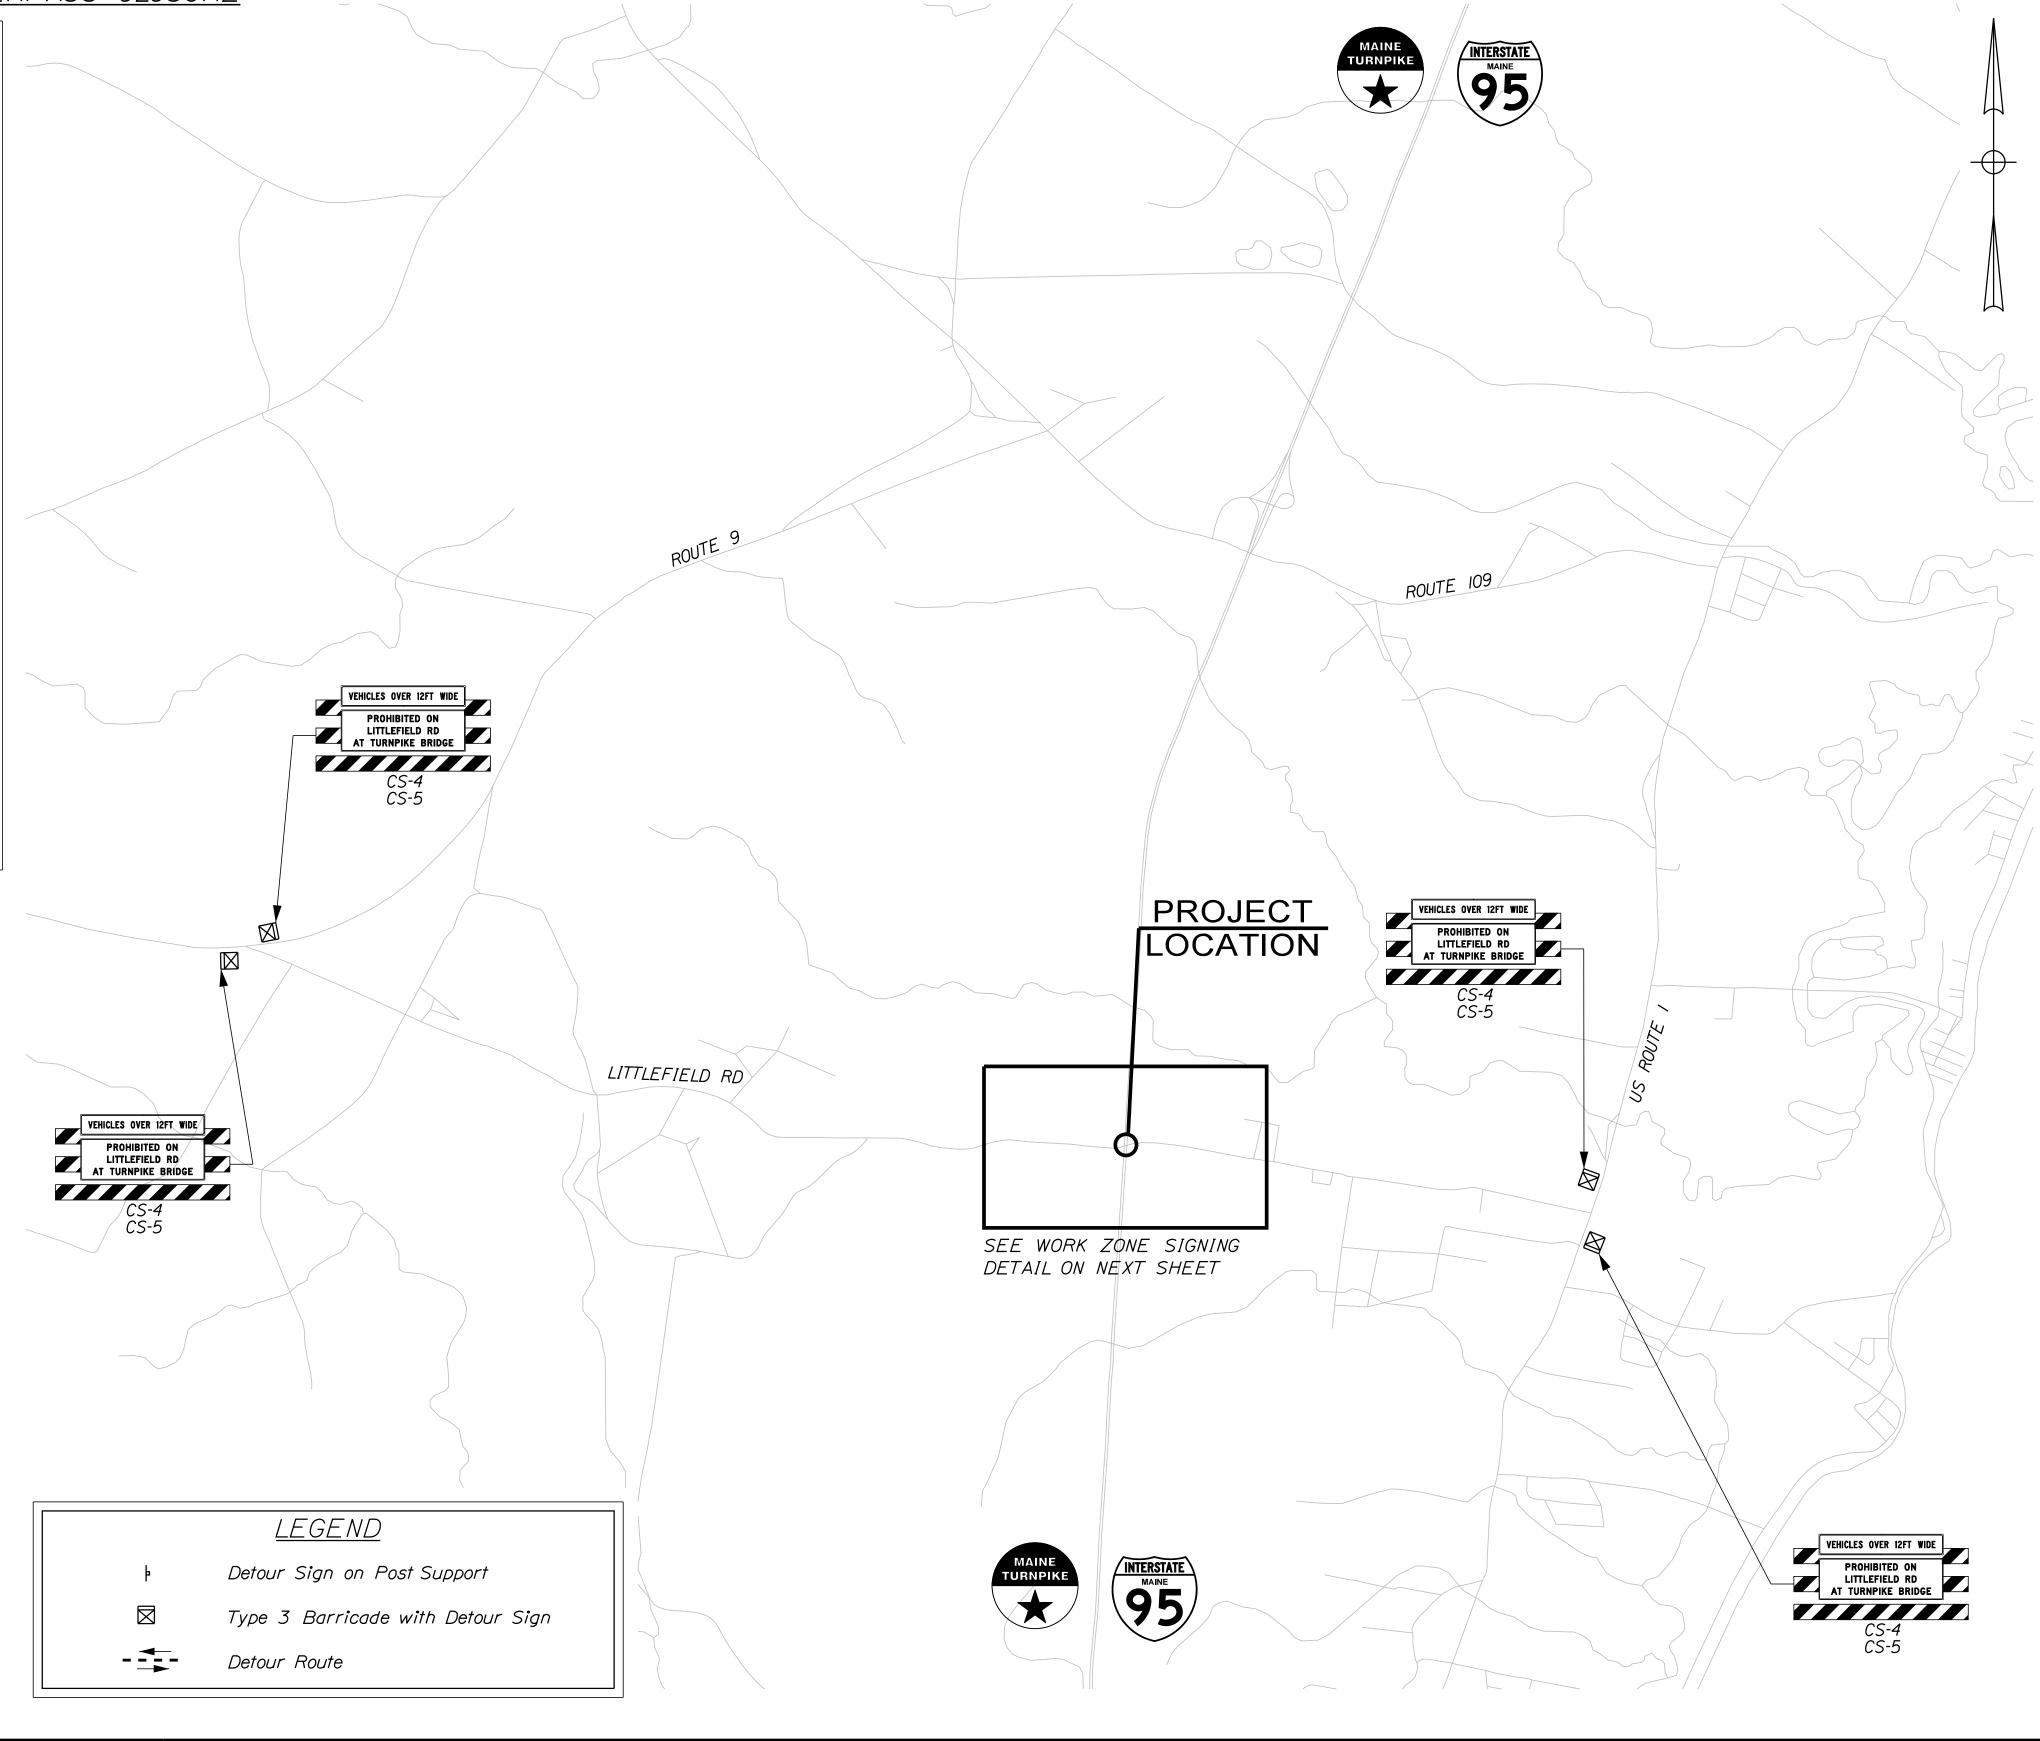

SHSB - Text Dimensions Shall Conform to "Standard Highway Signs Book" - 2012 Edition.

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South Portland, ME 04106

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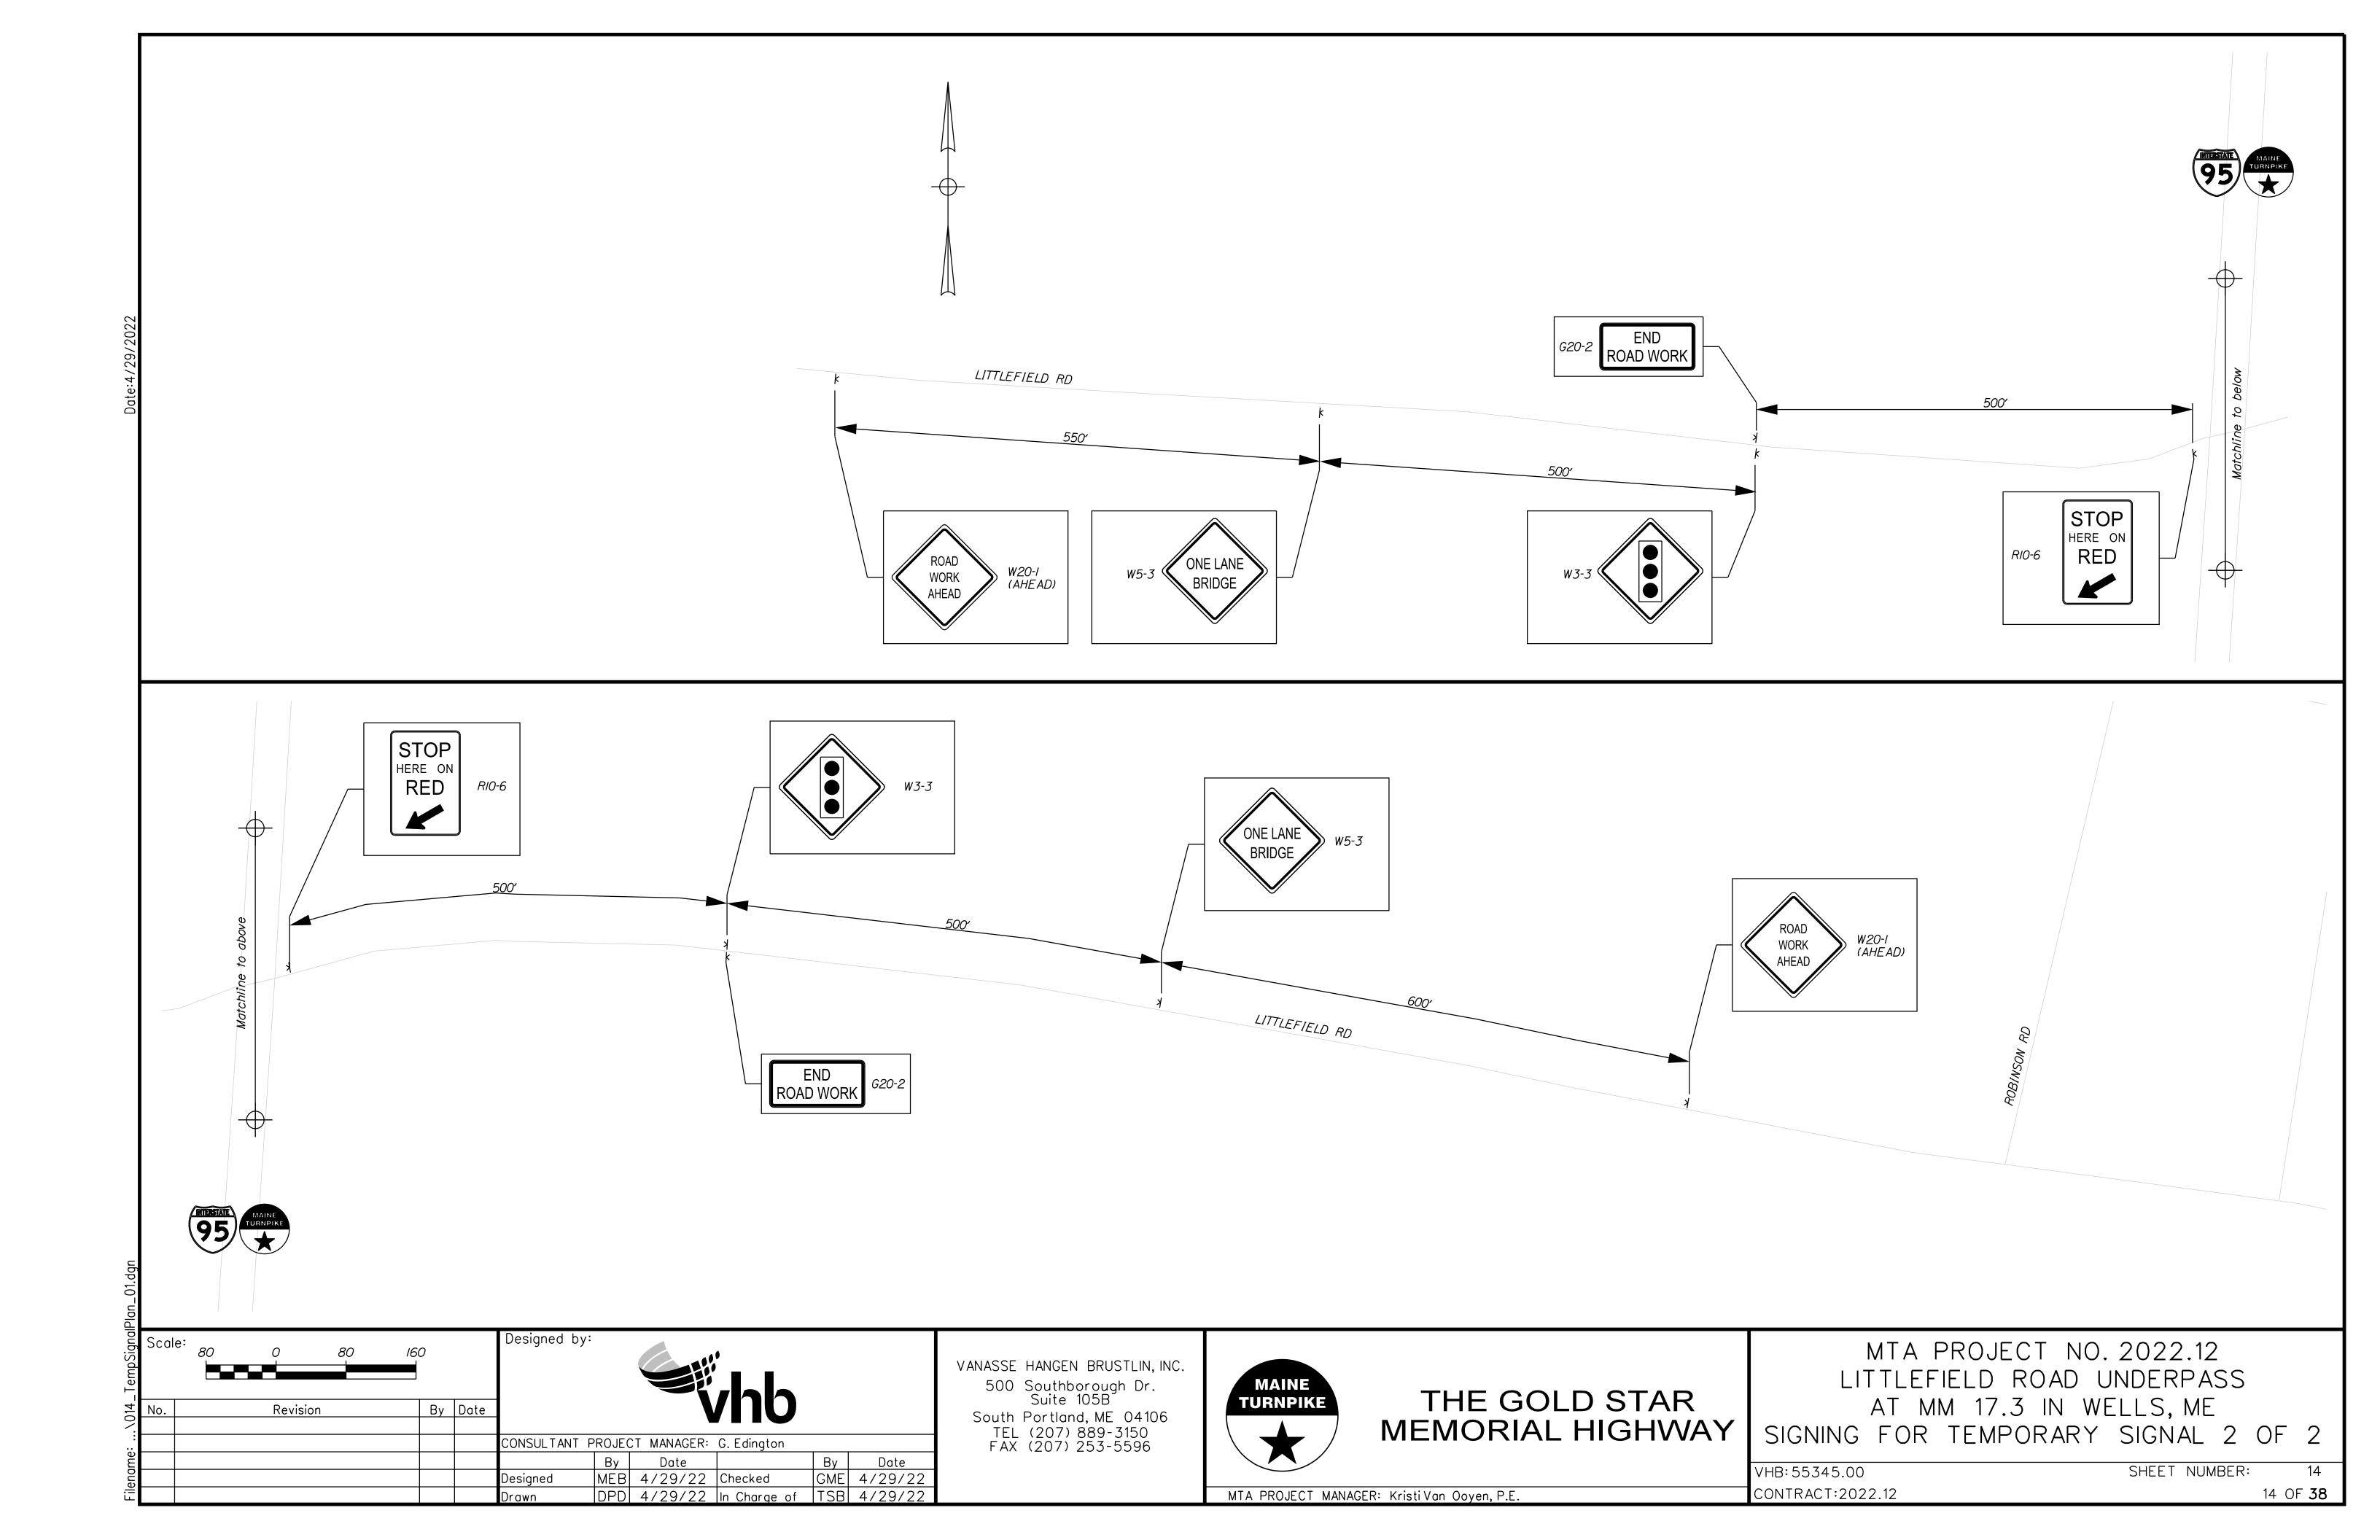



# THE GOLD STAR MEMORIAL HIGHWAY

MTA PROJECT NO. 2022.12
LITTLEFIELD ROAD UNDERPASS
AT MM 17.3 IN WELLS, ME
SIGNING FOR TEMPORARY SIGNAL 1 OF 2


VHB: 55345.00 CONTRACT: 2022.12

SHEET NUMBER: 13 OF 38



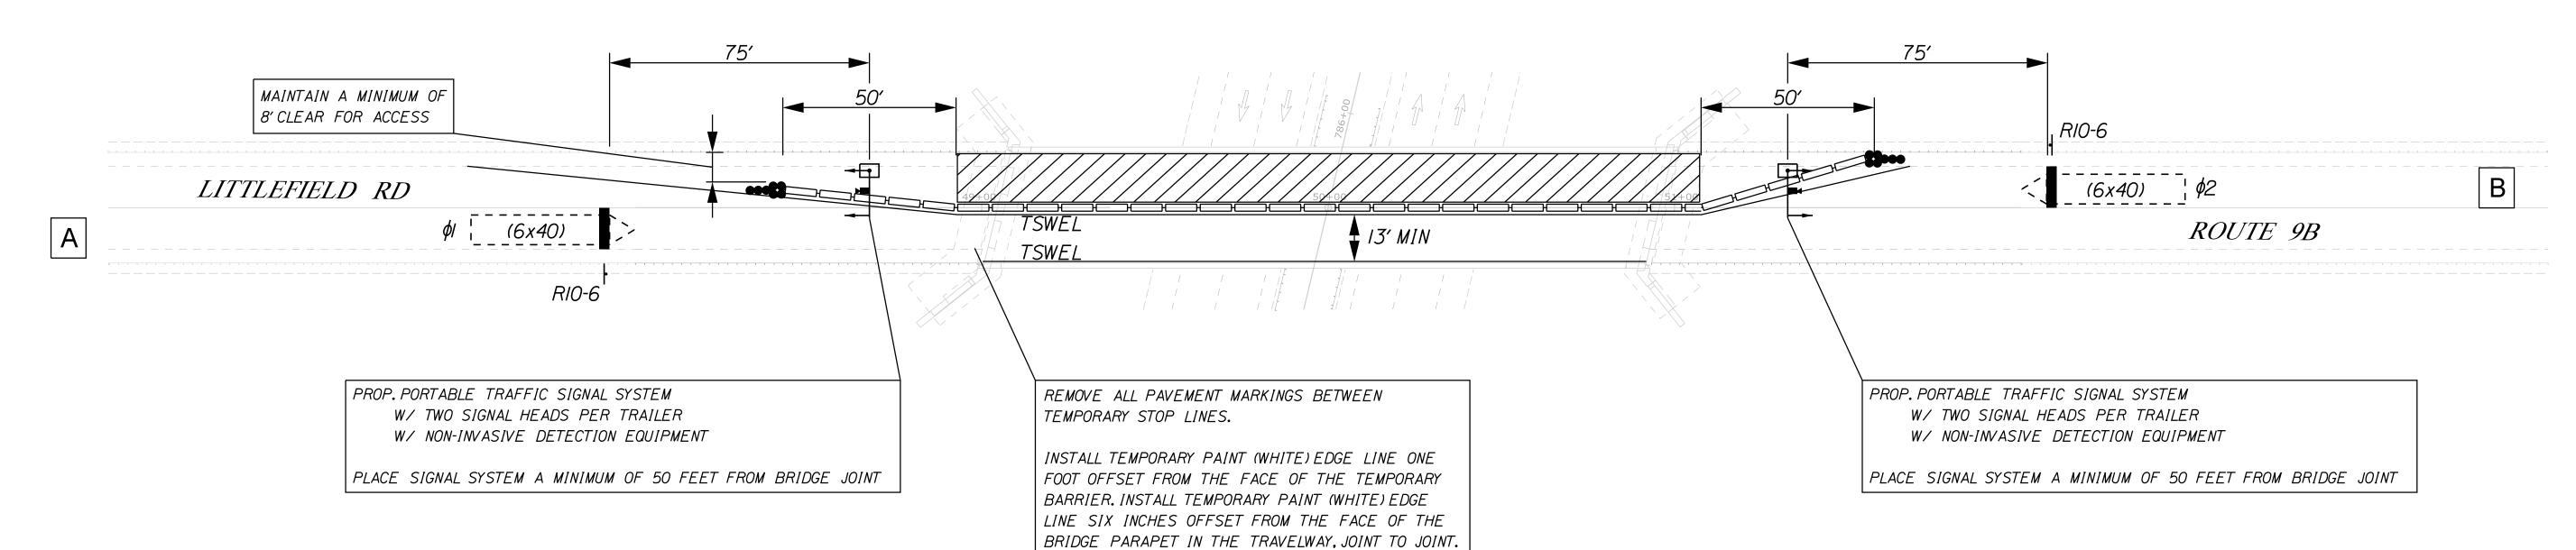

#### PROPOSED INDICATIONS

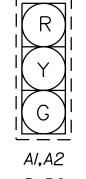


ALL INDICATIONS SHALL BE 12" LIGHT EMITTING DIODES (LED'S) WITH 5" LOUVERED BACKPLATES

#### PROPOSED POST MOUNTED SIGNS



RIO-6 24" x 36" 2-PROPOSED

#### PHASE DIAGRAM

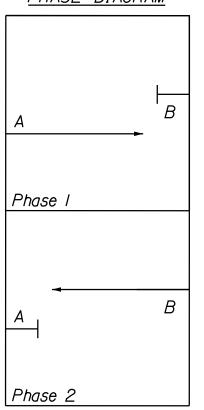

2022 EST. CONSTRUCTION DESIGN VOLUMES **←**210

*145* →

#### PROPOSED TEMPORARY NEMA 4 PHASE CONTROLLER SIGNAL PHASING & TIMING

	PHASE I	PHASE 2
MIN GREEN	10	10
EXTENSION	4	4
MAX /	30	30
MAX 2	-	-
VEH CLEAR	4	4
RED CLEAR	13	13
WALK	-	-
PED CLEAR	-	-
FLASH	FR	FR
RECALL	0FF	0FF
DETECTOR	NL	NL
PRE-EMPT PRIORITY	-	-
I - LOCKING		

L = LOCKING NL = NON-LOCKING

THE CONTRACTOR SHALL SET TIMING OF THE TEMPORARY TRAFFIC SIGNAL PER TIMING DATA PROVIDED. SIGNAL TIMING ADJUSTMENTS SHALL BE APPROVED BY THE RESIDENT AND ACCOMPLISHED AS DIRECTED BY THE RESIDENT. PAYMENT FOR ALL SIGNAL TIMING ADJUSTMENTS SHALL BE INCIDENTAL TO THE TRAFFIC SIGNAL SYSTEM.

# <u>NOTES:</u>

- I. SEE LITTLEFIELD ROAD UNDERPASS TEMPORARY SIGNAL PLAN ADVANCE SIGNING FOR APPROACH SIGNS.
- 2. ADJUSTMENTS TO THE LOCATIONS OF THE STOP LINES RELATIVE TO THE BRIDGE JOINTS SHALL BE APPROVED BY THE RESIDENT AND MAY AFFECT THE PROPOSED SIGNAL TIMING.
- 3. THE TEMPORARY TRAILER MOUNTED SIGNAL SYSTEM IS SHOWN AS A FEASIBLE OPTION FOR TRAFFIC CONTROL. THE CONTRACTOR MAY PROPOSE AN ALTERNATIVE METHOD FOR MAINTAINING TRAFFIC DURING BRIDGE REPAIRS. ALL COSTS FOR MAINTENANCE OF TRAFFIC AT THE LITTLEFIELD ROAD BRIDGE SHALL BE INCIDENTAL TO ITEM 643.72.

# <u>LEGEND</u> CONSTRUCTION AREA PORTABLE CONCRETE BARRIER CHANNELIZATION DEVICES IMPACT ATTENUATION DEVICE VEHICLE DETECTION ZONE PORTABLE TRAFFIC SIGNAL TRAILER TYPE III BARRICADE

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≝						Drawn	DPD	4/29/22	In Charge of	TSB	4/29/22

VANASSE HANGEN BRUSTLIN, INC. 500 Southborough Dr. Suite 105B

South Portland, ME 04106 TEL (207) 889-3150 FAX (207) 253-5596




# THE GOLD STAR MEMORIAL HIGHWAY

MTA PROJECT NO. 2022.12 LITTLEFIELD ROAD UNDERPASS AT MM 17.3 IN WELLS, ME TEMPORARY SIGNAL PLAN - PHASE 1

VHB: 55345.00 CONTRACT:2022.12 SHEET NUMBER:

MTA PROJECT MANAGER: Kristi Van Ooyen, P.E.

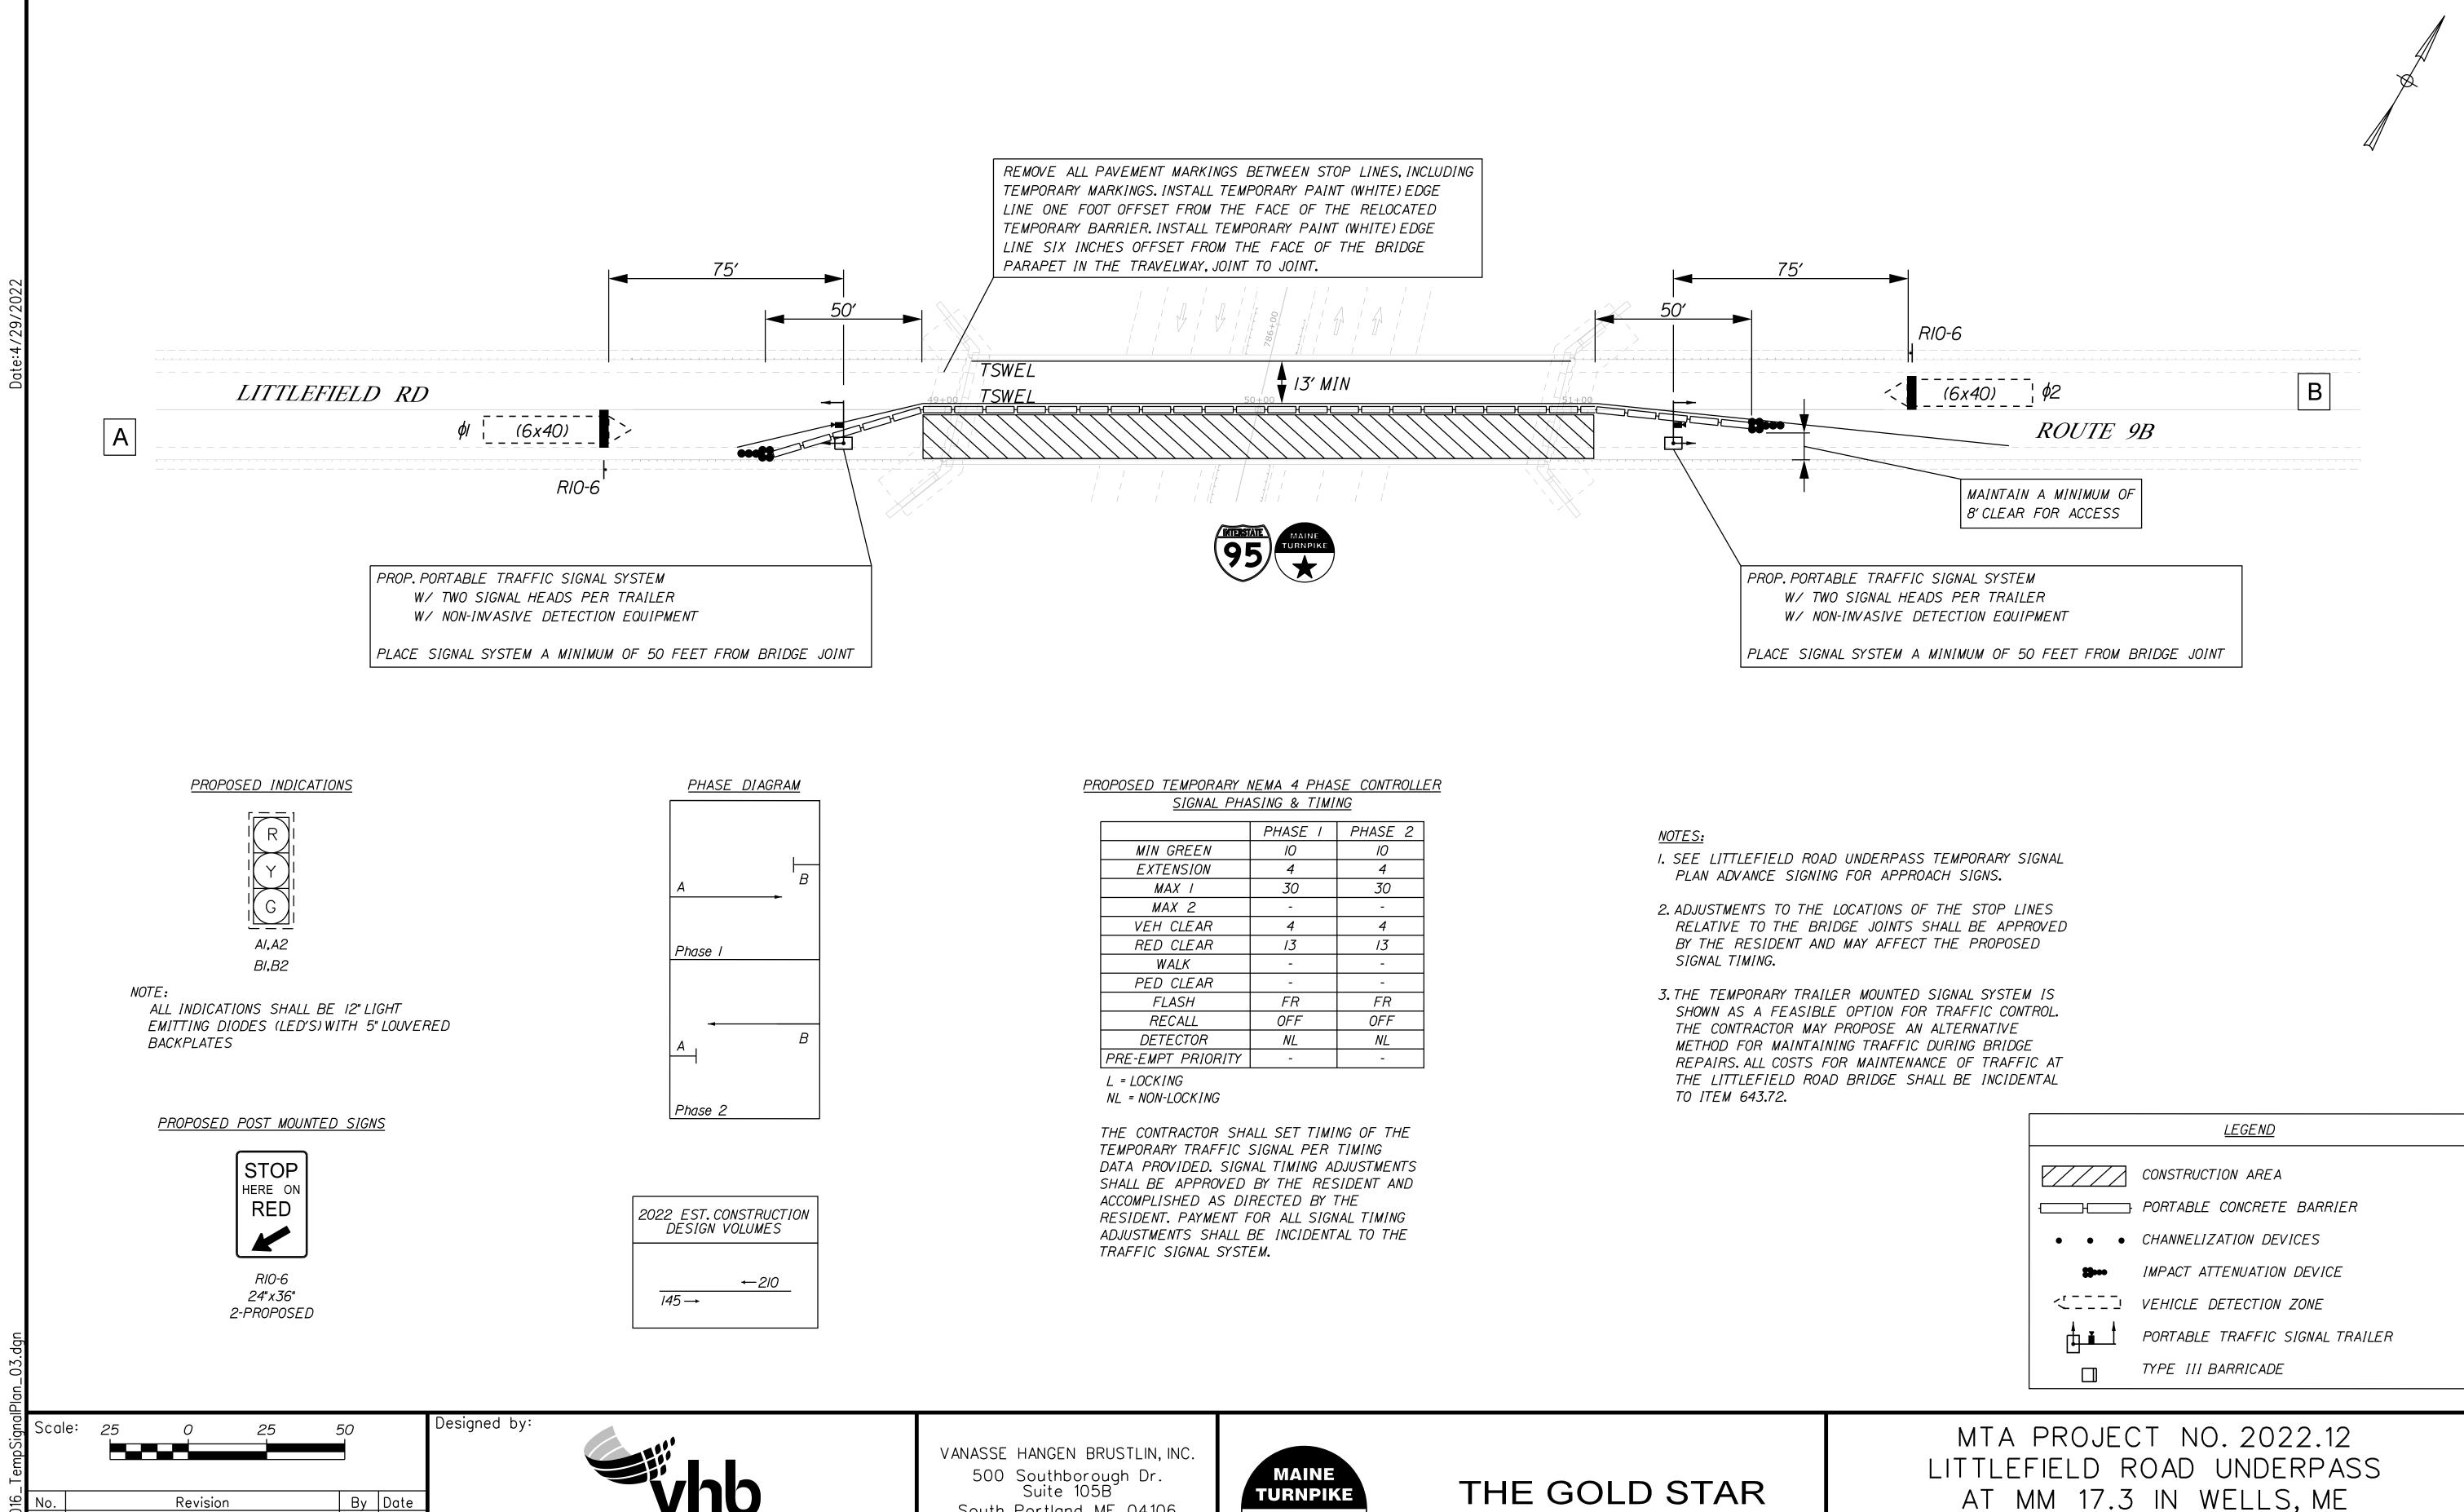

Revision

CONSULTANT PROJECT MANAGER: G. Edington

Designed

Date

MEB 4/29/22 Checked

DPD 4/29/22 In Charge of TSB 4/29/22

By Date

GME 4/29/22

South Portland, ME 04106

TEL (207) 889-3150

FAX (207) 253-5596

MTA PROJECT MANAGER: Kristi Van Ooyen, P.E.

AT MM 17.3 IN WELLS, ME MEMORIAL HIGHWAY TEMPORARY SIGNAL PLAN - PHASE 2

SHEET NUMBER: VHB: 55345.00 CONTRACT:2022.12

- Face of Concrete

— I" Min. Sawcut (Typ.)

Existing

(Typ.)

Reinforcement


-Limits of Surface Concrete Repair to Consist of Removal and Placement.

Existing Reinforcement to Remain (Typ.)

# TYPICAL HORIZONTAL SURFACE CONCRETE REPAIR DETAILS

Per Supplemental ...

Specification ≥ 518 (Typ.)-

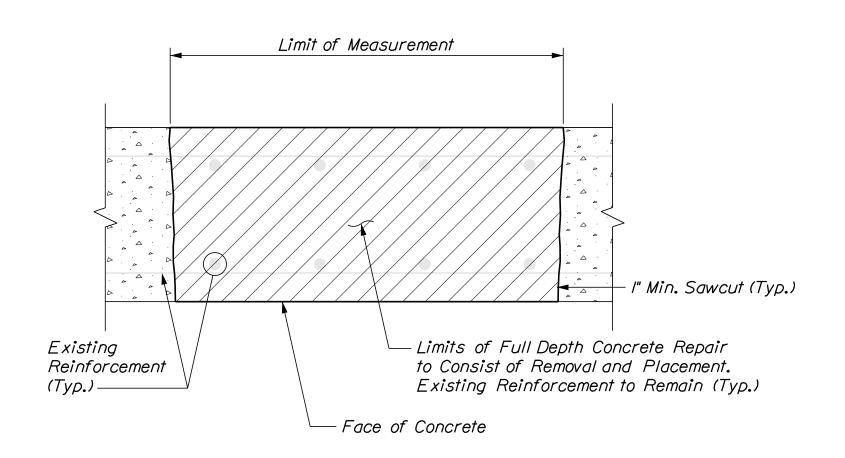

# TYPICAL FULL DEPTH CONCRETE REPAIR DETAILS

# CONCRETE REPAIR NOTES

- I. Repair work shall include: surface concrete repairs, epoxy in jection crack repair and providing access for inspection.
- 2. Where surface concrete repairs are specified the work shall include removal of unsound concrete and placement and curing of repair materials. Repairs shall be measured for payment under, 518.10 Abutment Repairs, 518.20 Pier Repairs, 518.75 Fascia and Overhang Repairs, 518.70 Repair of Overhead Surfaces <8 inches, and 518.80 Partial Depth Concrete Deck Repair, and 518.81 Full Depth Concrete Deck Repair.
- 3. Prior to the start of any concrete repairs the Resident and the Contractor shall sound all concrete surfaces and agree on the repair limits. Estimated repair quantities may increase at the Resident's discretion.
- 4. The estimated repair quantities are based on inspections completed in April -December 2020.

## CONCRETE REPAIR PROCEDURE


- I. Perform I" deep saw cuts along limits of removal.
- 2. Chip concrete to the depth specified in Supplemental Specification 518. If the removal limits change during the demolition process the Contractor shall notify the Resident. The Resident and Contractor shall agree on the revised pay limits prior to the Contractor continuing the removal.
- 3. Prepare and patch repair areas with Class AAA modified concrete or other materials selected from the applicable non-emergency list of materials in Supplemental Specification 518.
- 4. Perform general finishing.

CONTRACT: 2022.12

# EPOXY INJECTION CRACK REPAIR NOTES

- I. All crack repairs shall be completed by an individual qualified and experienced in the type of repairs proposed.
- 2. All crack repairs shall be completed in accordance with Supplemental Specification 518.
- 3. Where epoxy injection crack repair is specified the work shall include pressure injection of cracks I/I6" or more in width. Work shall be paid under Item 518.4 Epoxy Injection Crack Repair.

# TYPICAL VERTICAL SURFACE CONCRETE REPAIR DETAILS

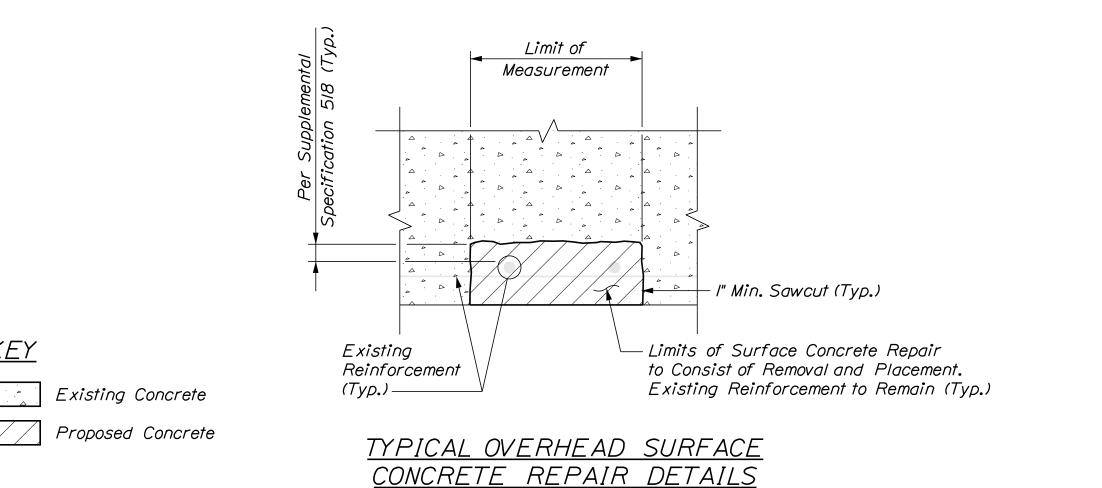

Designed by: Scale: NOT TO SCALE By Date Revision CONSULTANT PROJECT MANAGER: G. Edington By Date GME 4/29/22 MEB 4/29/22 | Checked Designed DPD 4/29/22 In Charge of TSB 4/29/22

<u>KEY</u>

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MAINE TEL (207) 889-3150 FAX (207) 253-5596




MTA PROJECT NO. 2022.12

CONCRETE REPAIR TYPICAL DETAILS

SHEET NUMBER: VHB: 55345.00

MTA PROJECT MANAGER: Kristi Van Ooyen, P.E.

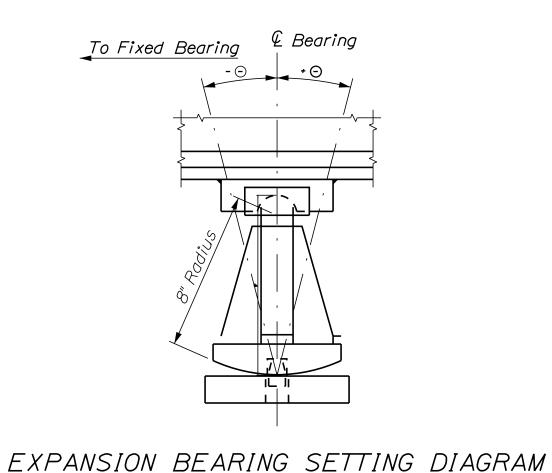


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80	4.46
90	5 <b>.</b> 72

# RAMP J BEARINGS TABLE


# BEARING REPAIR NOTES

- I. Resetting the bearings shall be paid for under Item 523.1201, Reset Steel Bearings and all labor, equipment, and materials necessary to raise the existing bridge to accommodate this work shall be paid for under Item 524.7212, Jacking Existing Superstructure.
- 2. All existing dimensions and information shown on the plans are based on as-built and standard detail drawings. The Contractor shall field verify all relevant dimensions prior to submission of Jacking Plan.
- 3. See Special Provisions for lead paint removal requirements.
- 4. Bearings shall be reset prior to modifications of bridge
- 5. The temporary support and jacking system shall be designed by the Contractor. See Special Provision 524 for additional requirements.

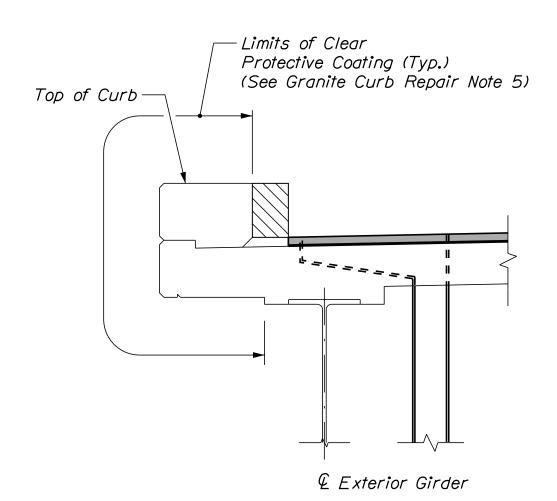

Not to Scale

CURB DETAIL (Bridge Rail not Shown for Clarity) Scale: 3/4" = 1'-0"

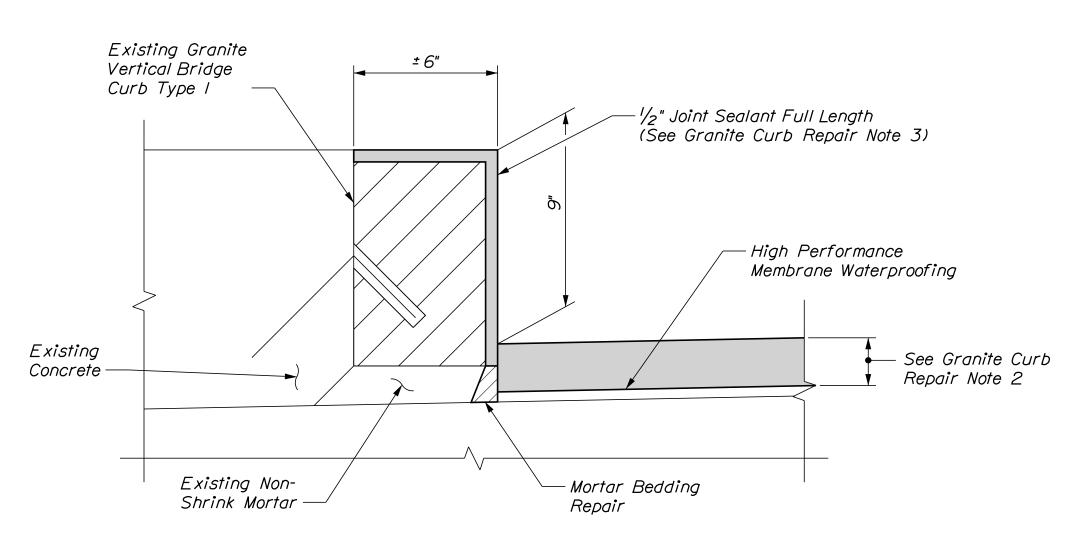

EXISTING GRANITE CURB DETAIL Scale: 3" = I'-0"

# GRANITE CURB REPAIR NOTES

- I. A bead of Hot-Applied Rubberized asphalt sealer shall be applied along curb lines after installation of base course. Payment shall not be made directly but shall be considered incidental to related contract items.
- 2. The Contractor shall treat corners and the vertical face of curbing in accordance with Special Provision section 508.
- 3. Joint sealant shall be a material from the MaineDOT approved products list as approved by the Resident. Joint sealant shall be incidental to item 518.391, Repairing Granite Curb Joint and Bedding Mortar.
- 4. Mortar for bedding and for joints in granite curb on bridges where required shall be an approved non-shrink mortar in accordance with Supplemental Specification 518.
- 5. Limits of clear protective coating shall be paid for under Item 515.202, Clear Protective Coating for Concrete Surfaces.

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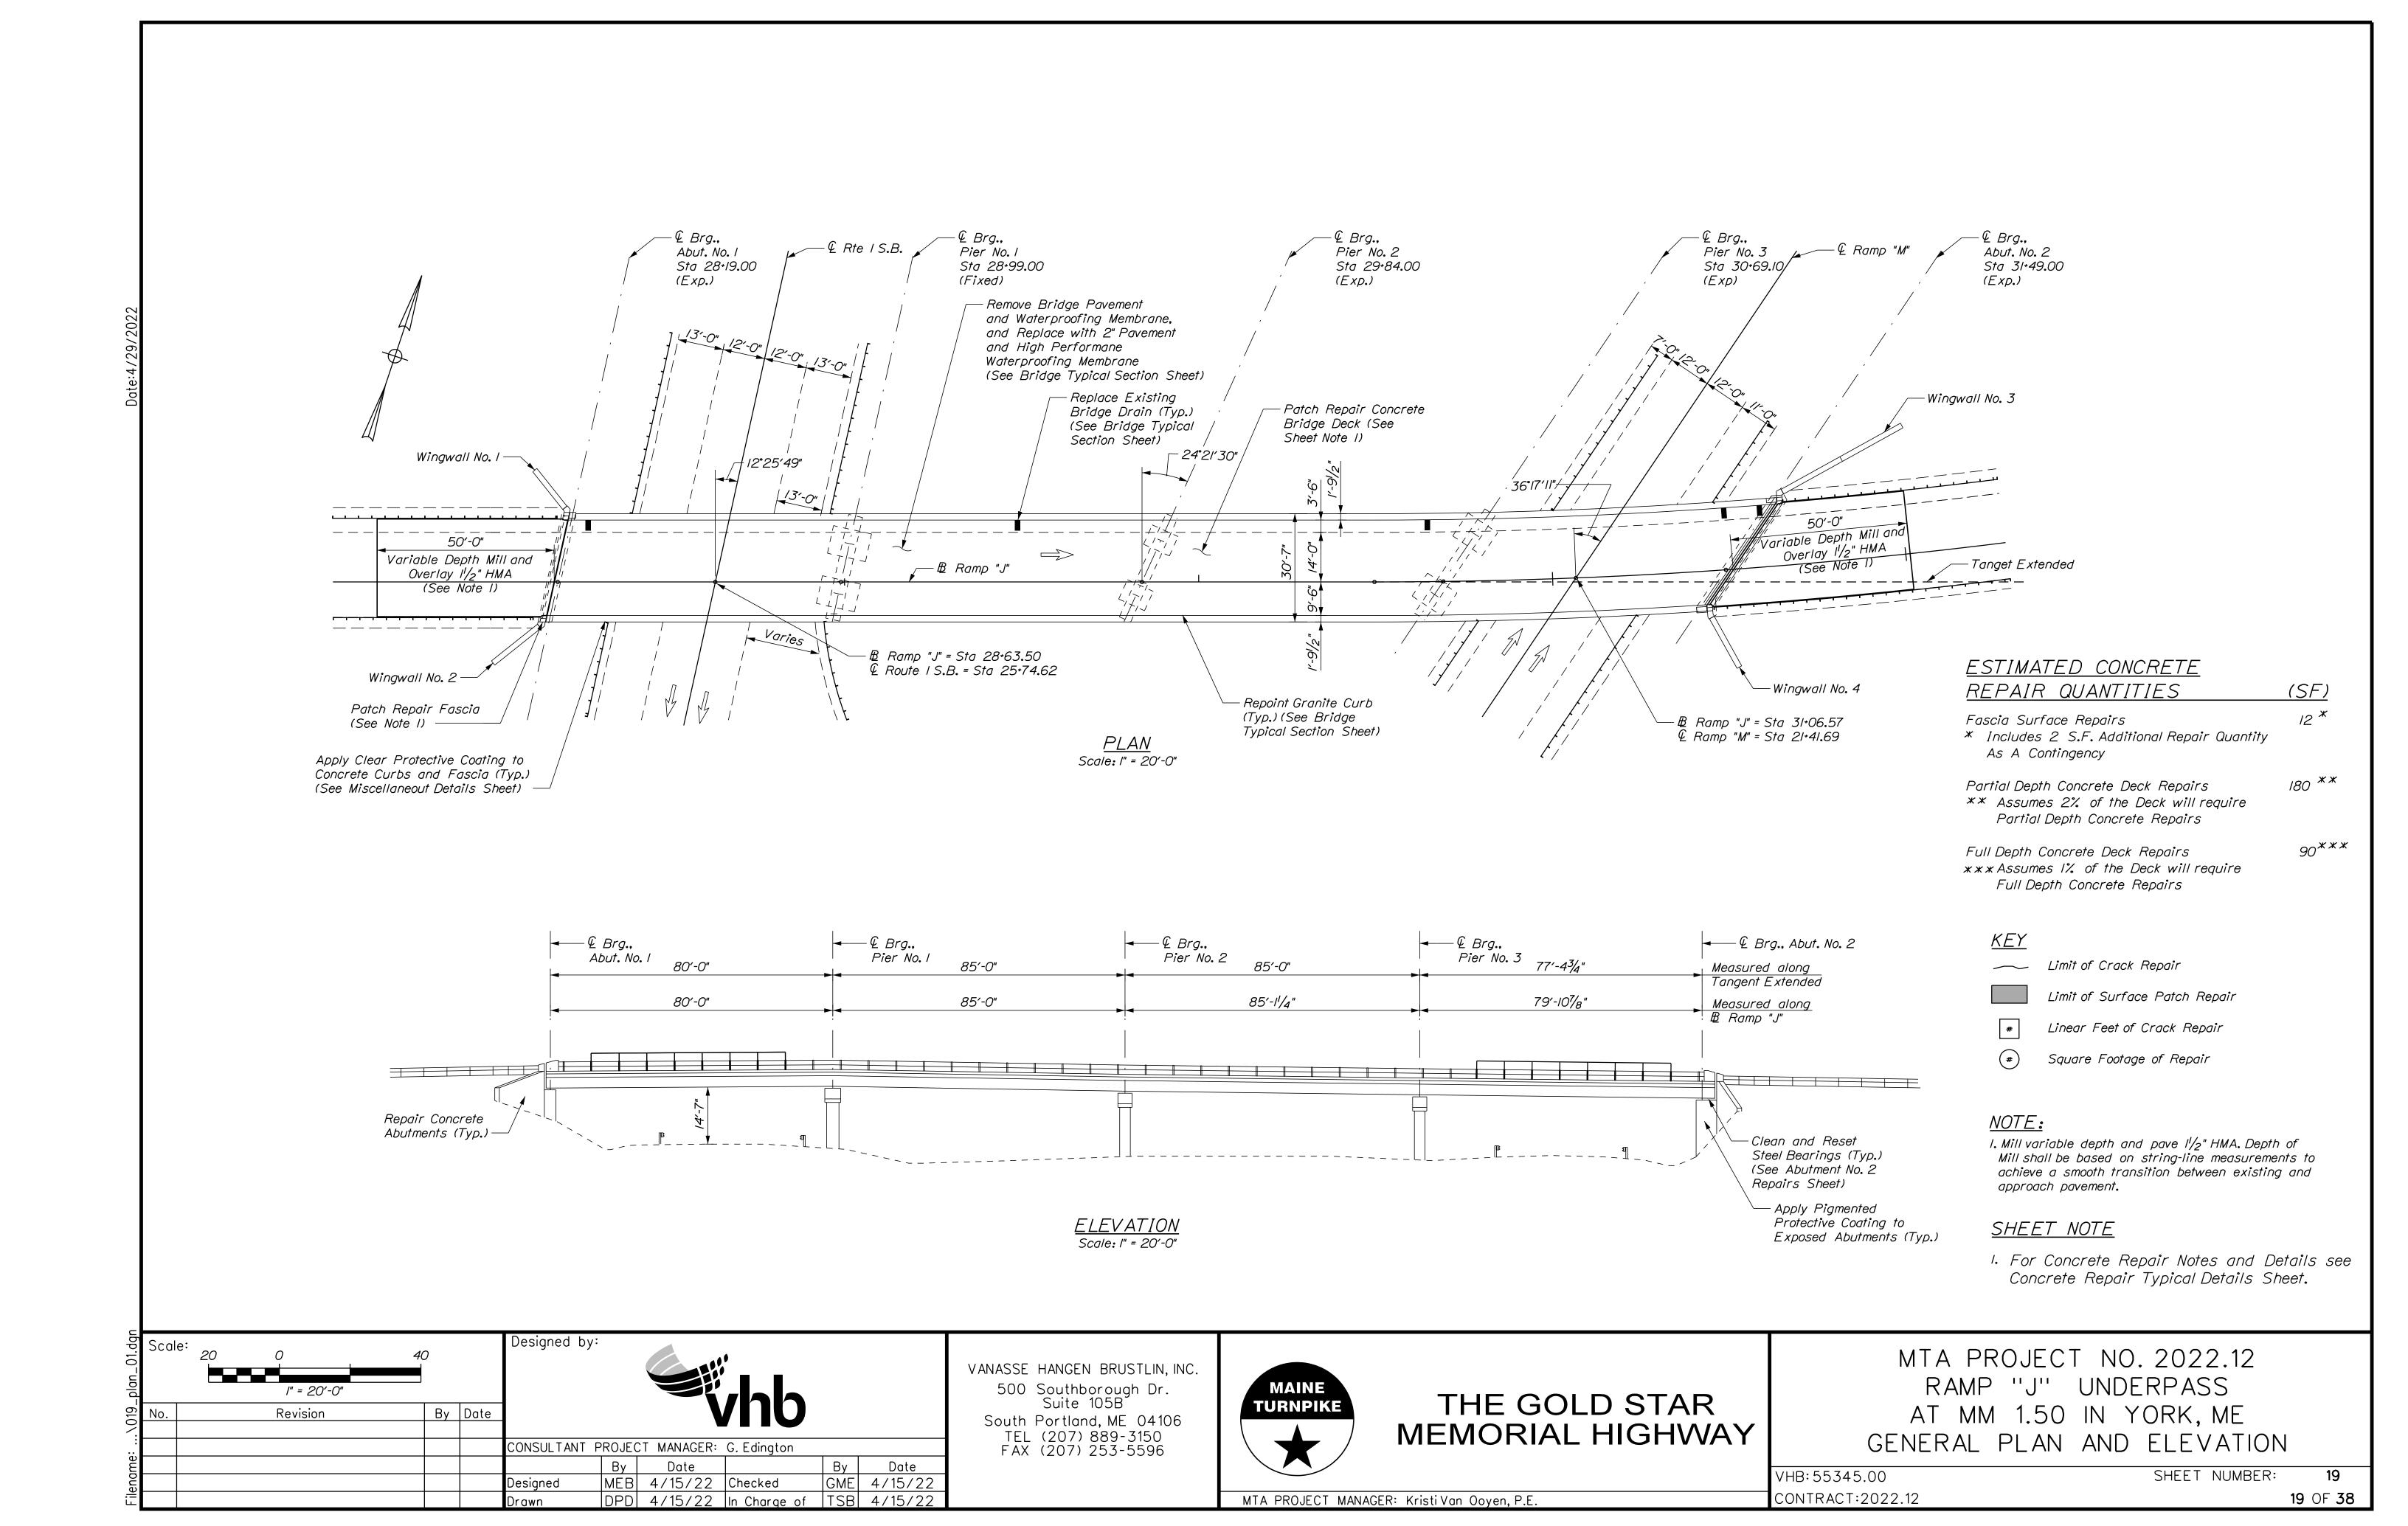



THE GOLD STAR MEMORIAL HIGHWAY MTA PROJECT NO. 2022.12

MISCELLANEOUS DETAILS

18

SHEET NUMBER: VHB: 55345.00 CONTRACT: 2022.12 18 OF **38** 



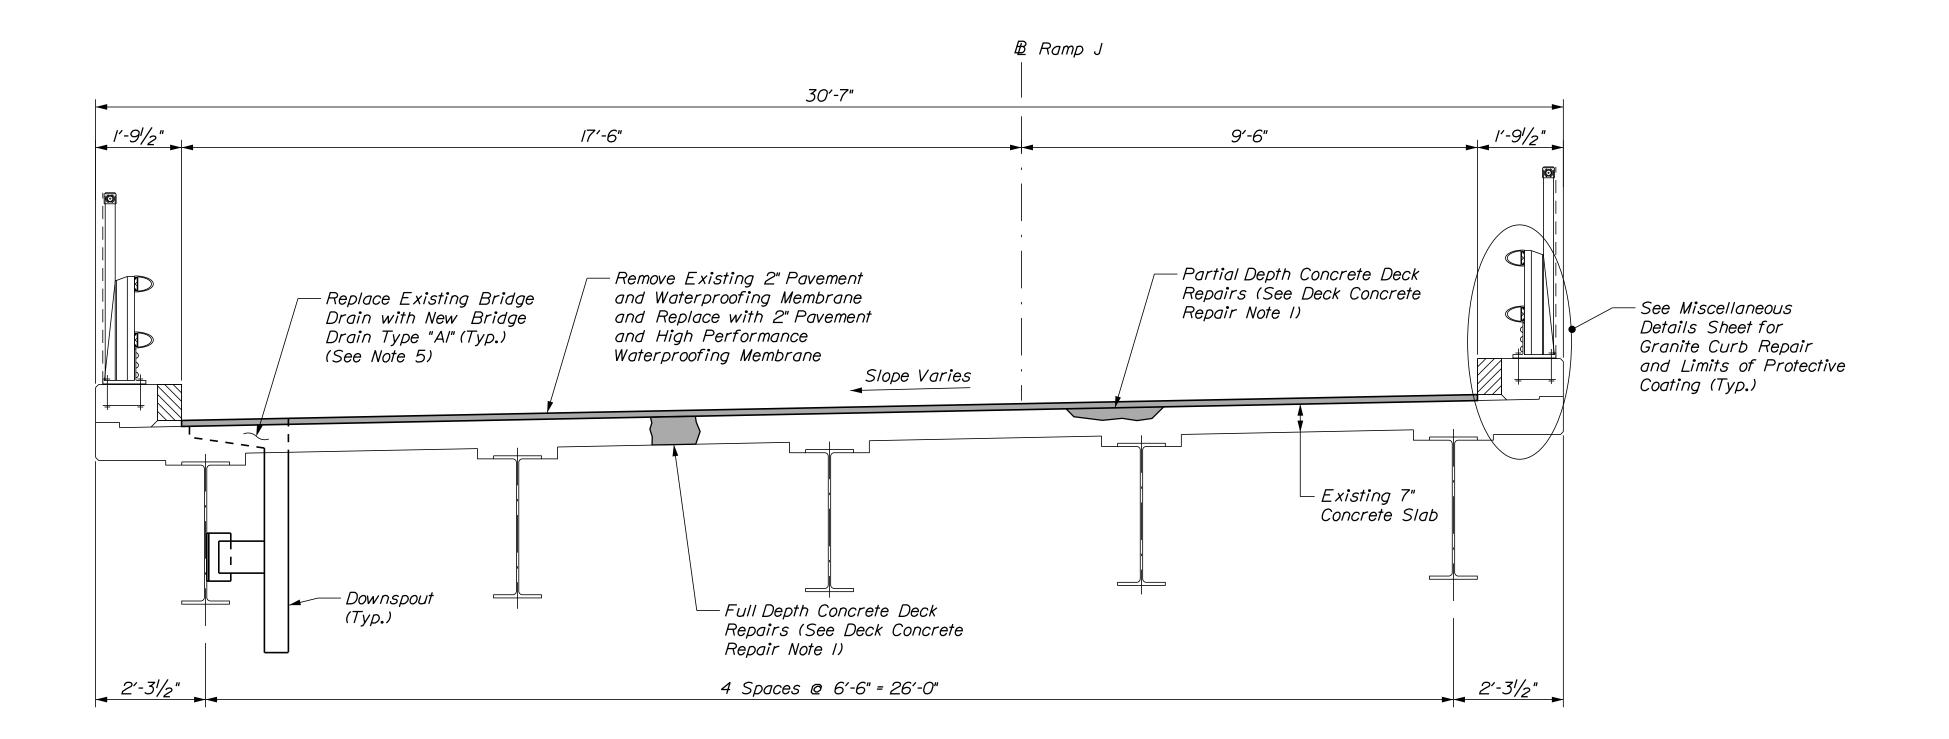


SUPERSTRUCTURE TYPICAL SECTION

# DECK CONCRETE REPAIR NOTES

- I. Prior to the start of deck concrete repairs, the Resident and the Contractor shall sound all deck concrete using a chain drag or other method approved by the Resident to determine the required repair limits. All costs for sounding the existing deck concrete shall be incidental to Item 518.80 Partial Depth Concrete Deck Repair and Item 518.81 Full Depth Concrete Deck Repairs.
- 2. Sawcut I" deep along all limits of removal.
- 3. Prepare and patch repair deteriorated areas. Install new reinforcing steel, as required. See Supplemental Specification 518.
- 4. Replacing the bridge drains shall be paid for under Item 502.702, Replace Bridge Drain (Type AI).

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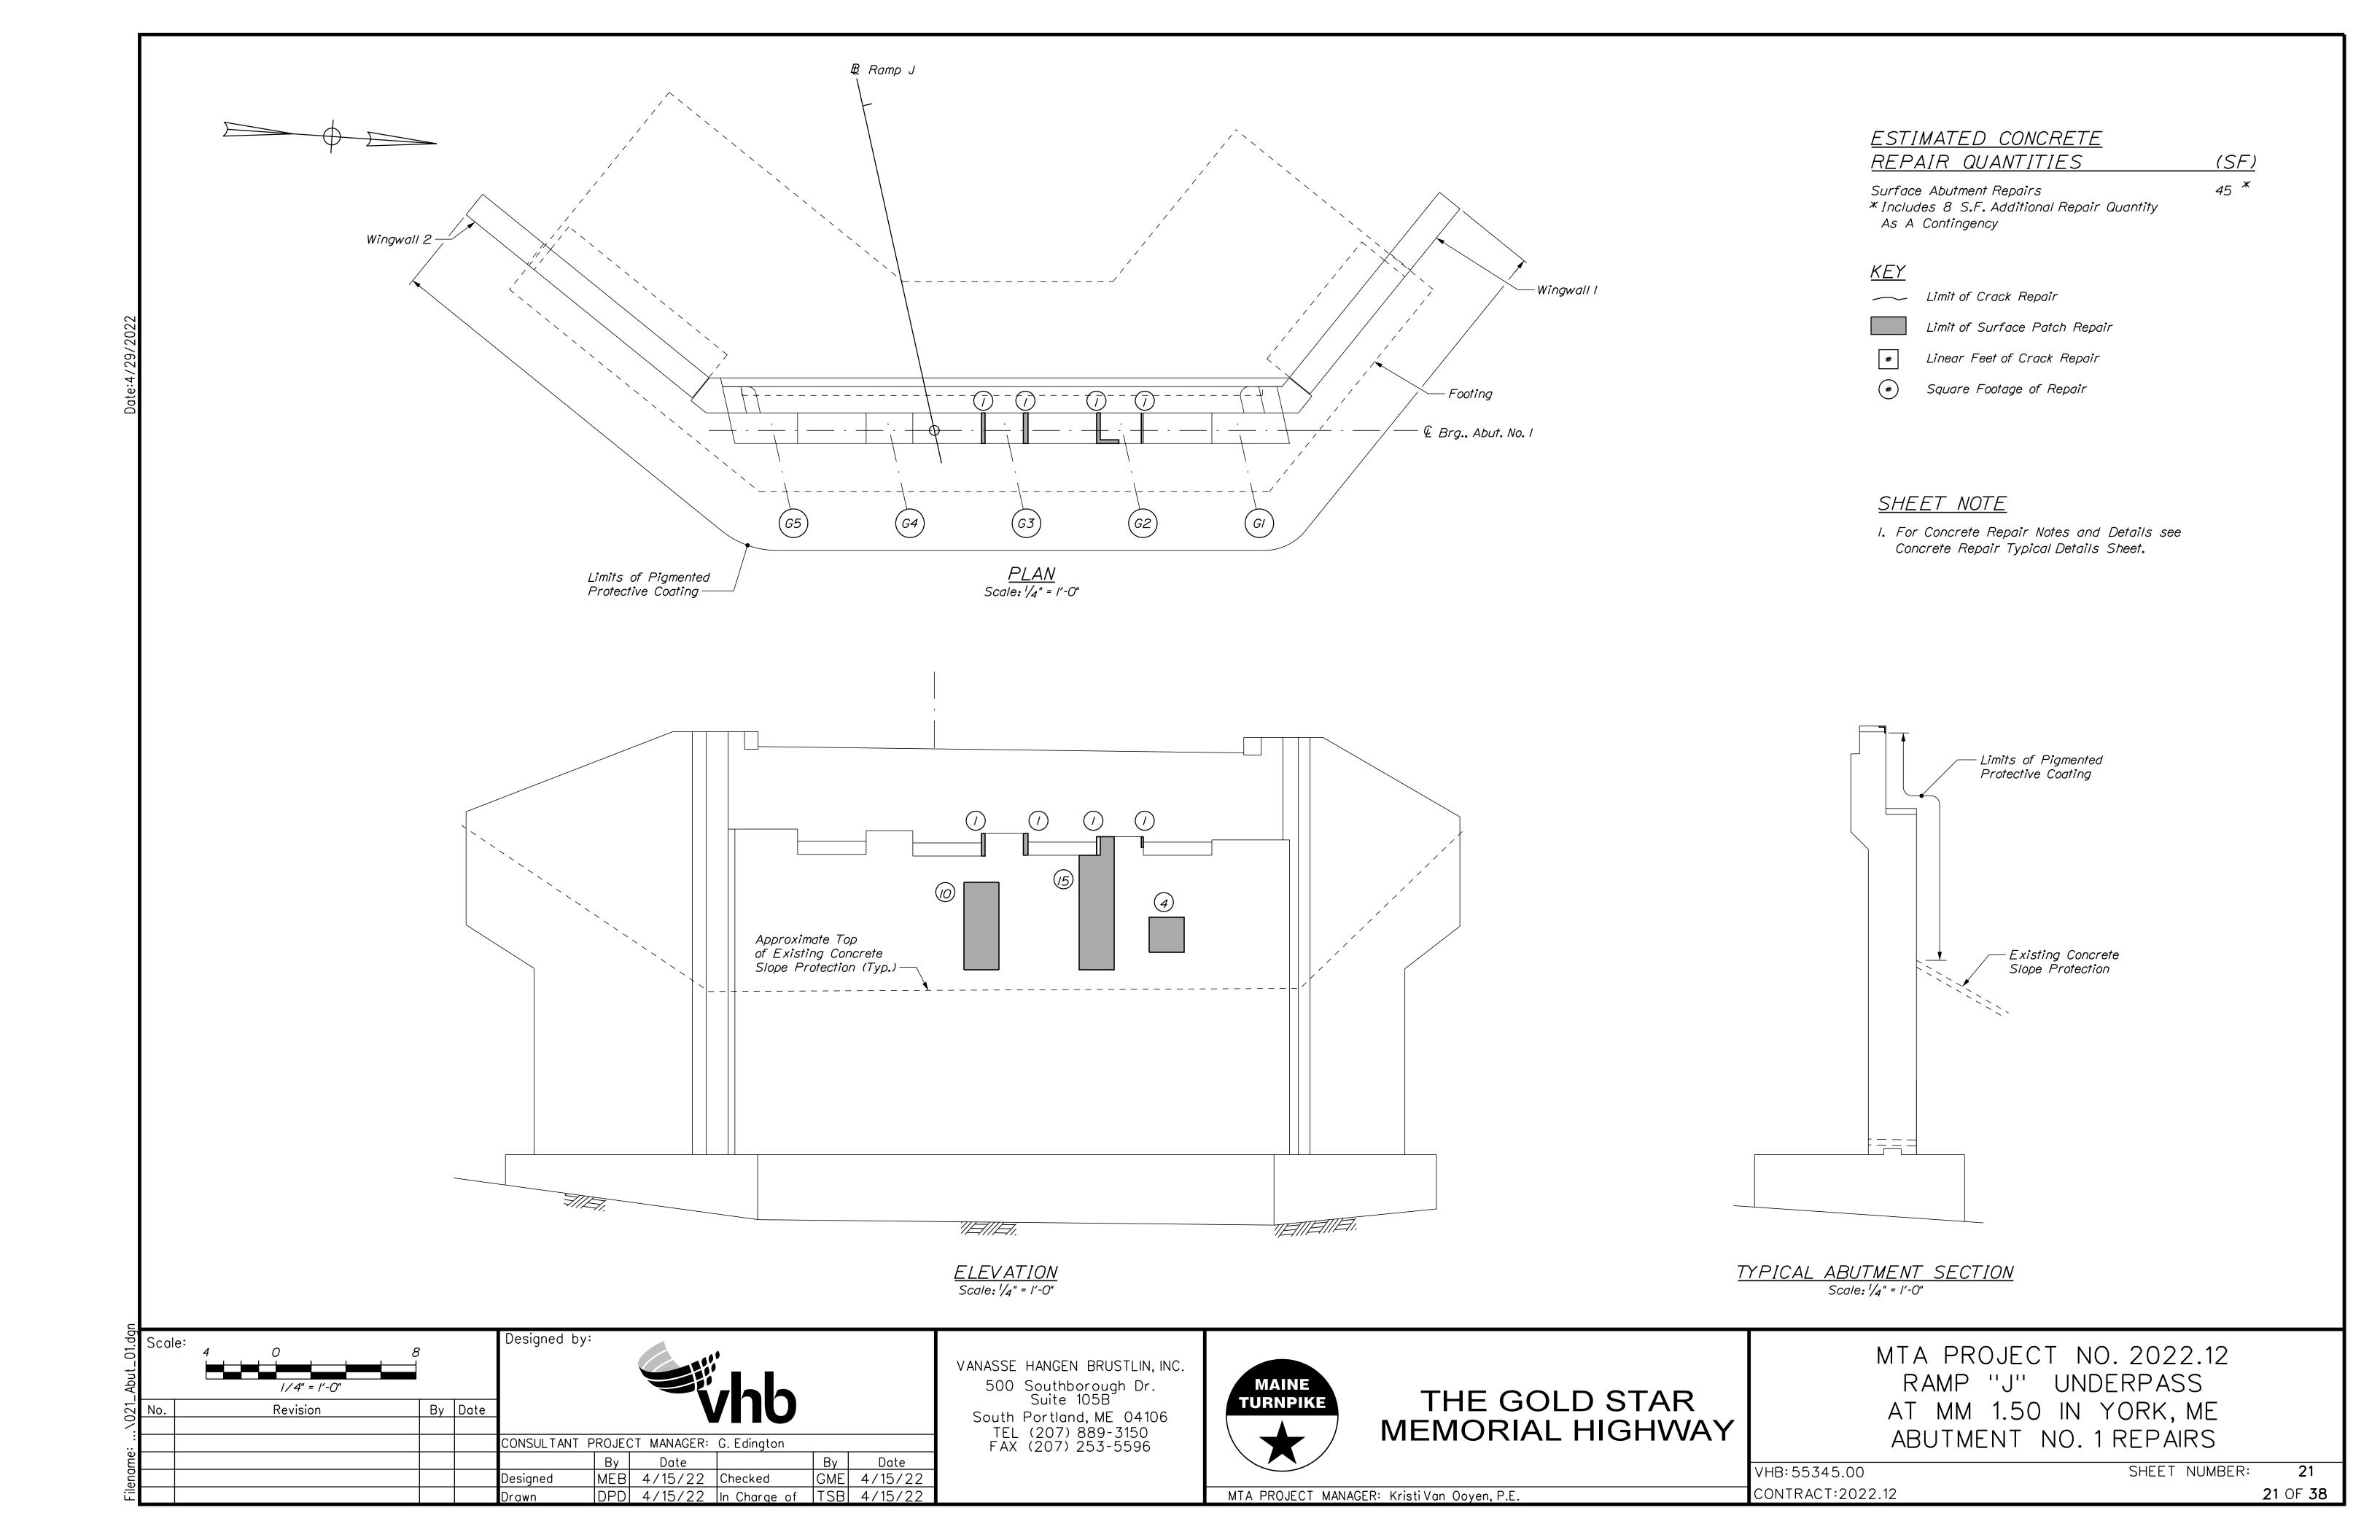
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500 Southborough Dr.
Suite 105B
South Portland, ME 04106
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FAX (207) 253-5596

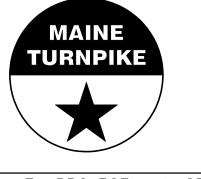



THE GOLD STAR MEMORIAL HIGHWAY MTA PROJECT NO. 2022.12
RAMP ''J'' UNDERPASS
AT MM 1.50 IN YORK, ME
BRIDGE TYPICAL SECTION


VHB: 55345.00 CONTRACT: 2022.12

SHEET NUMBER: 20 20 OF **38** 




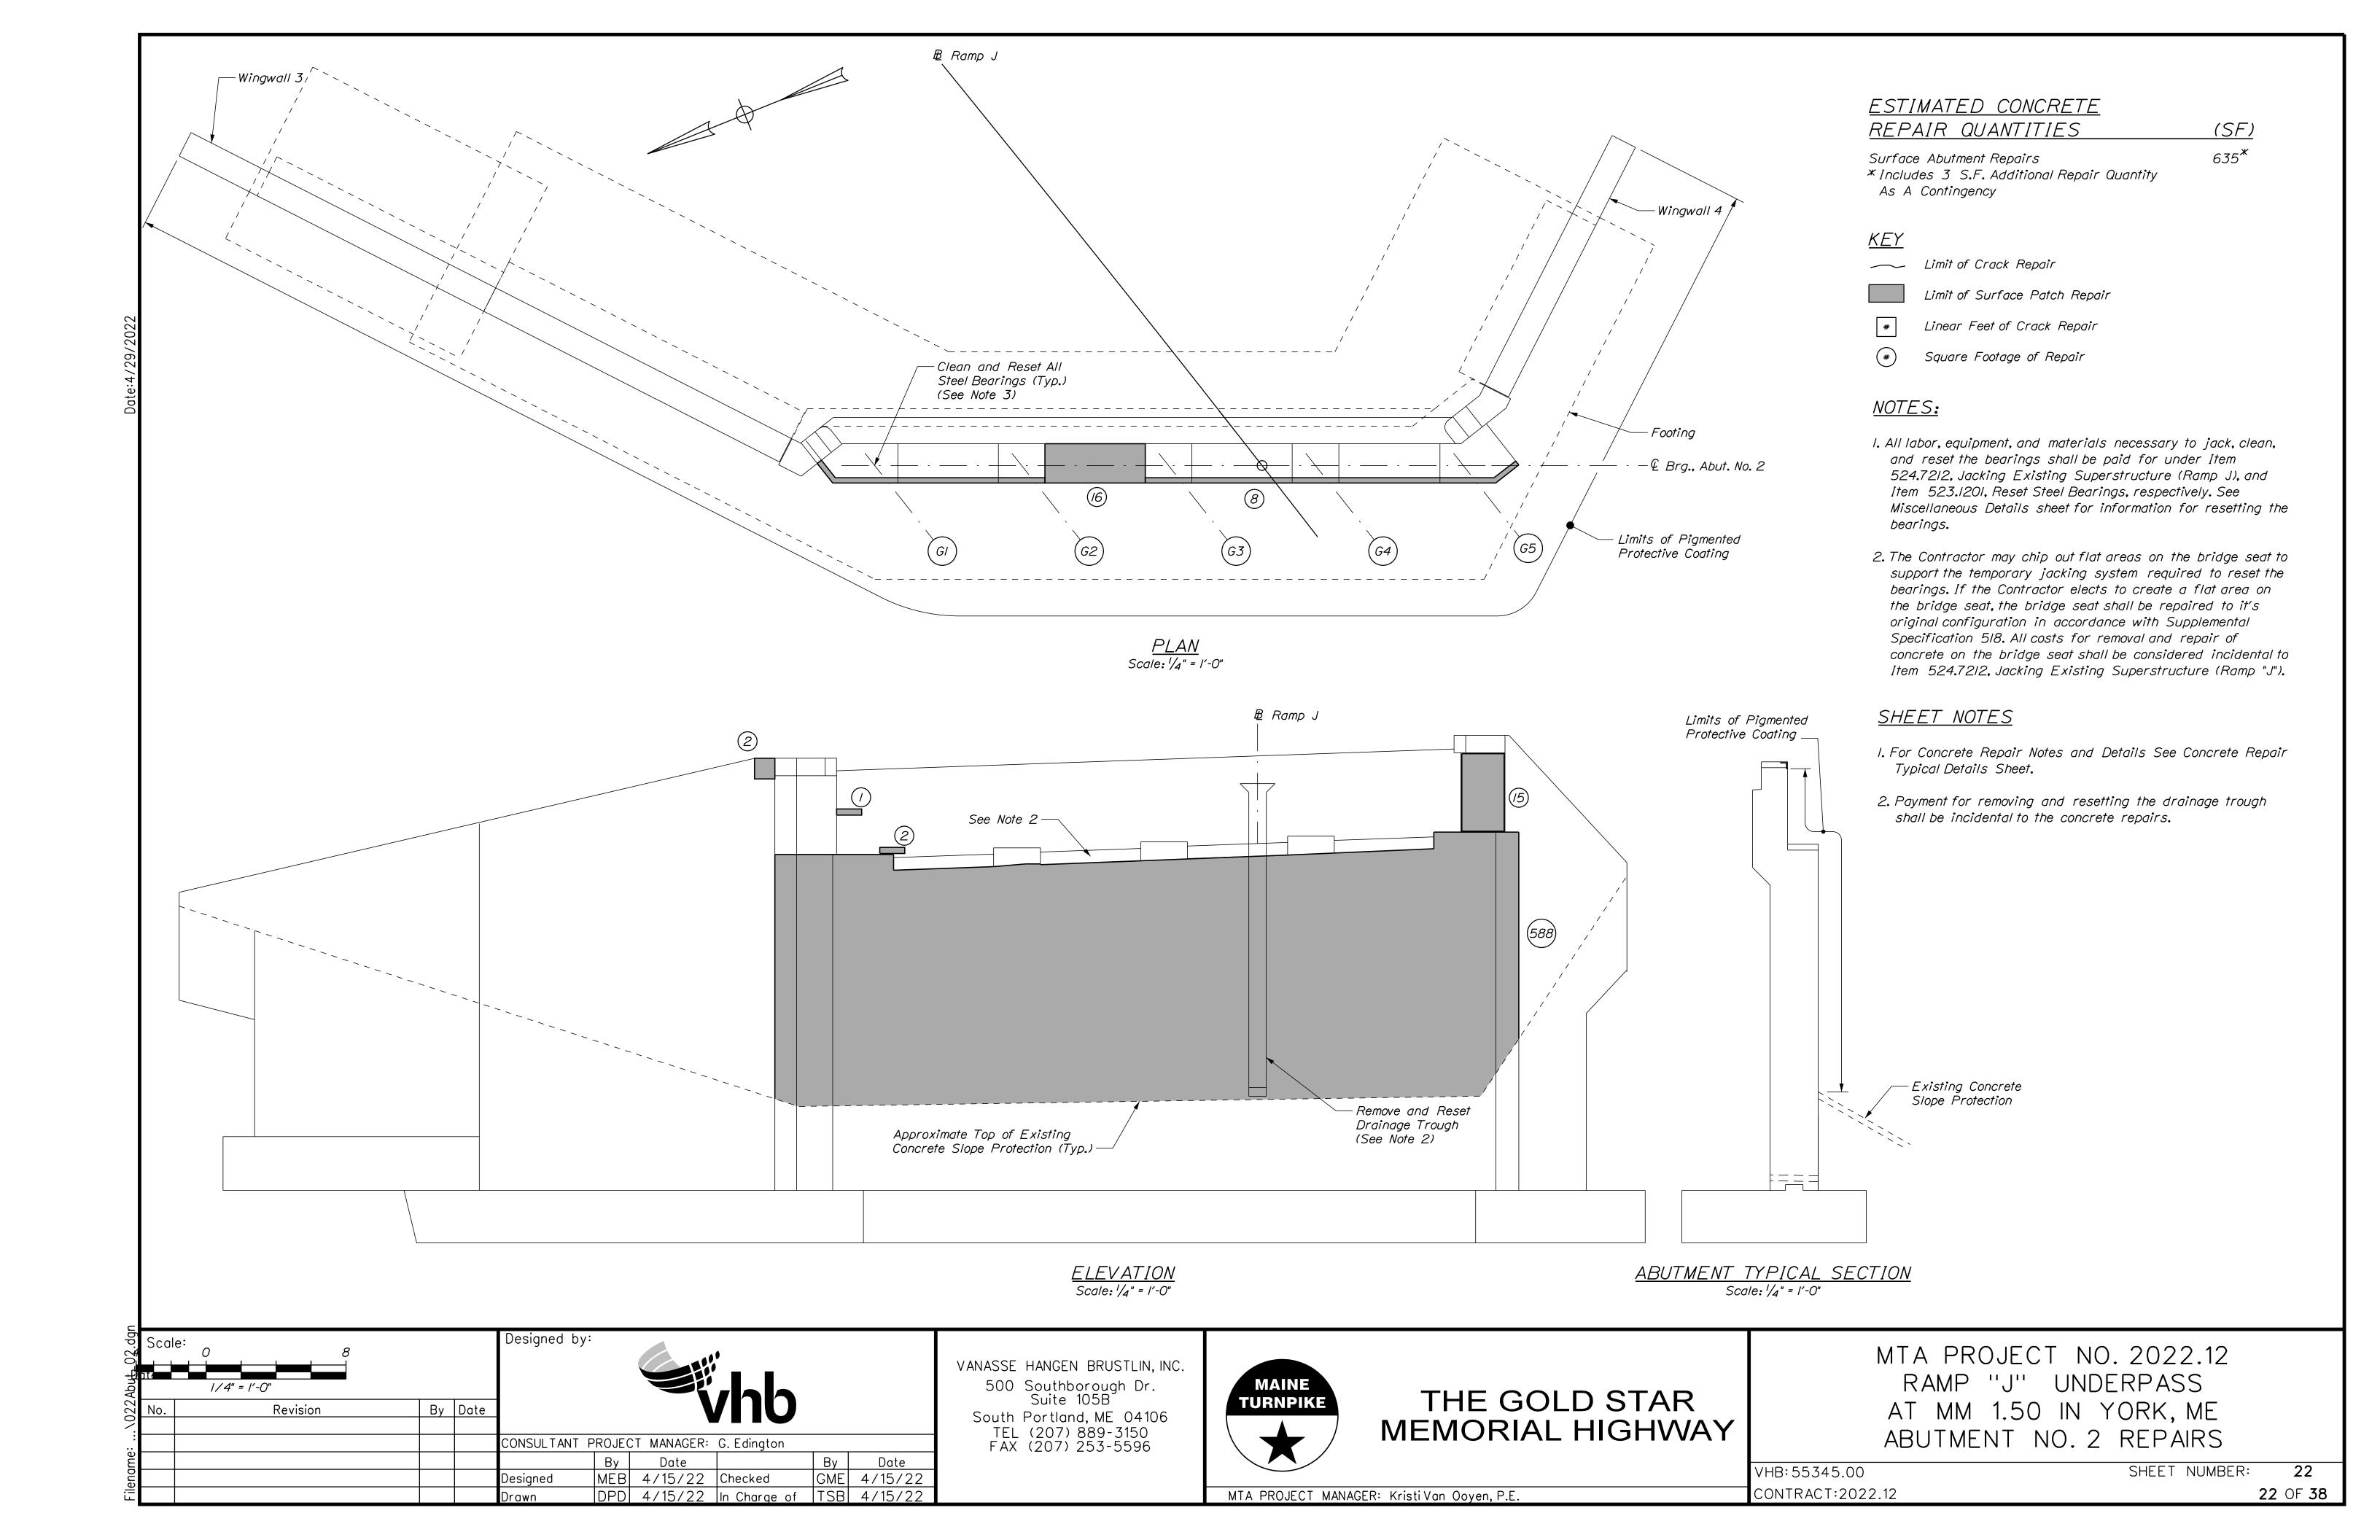

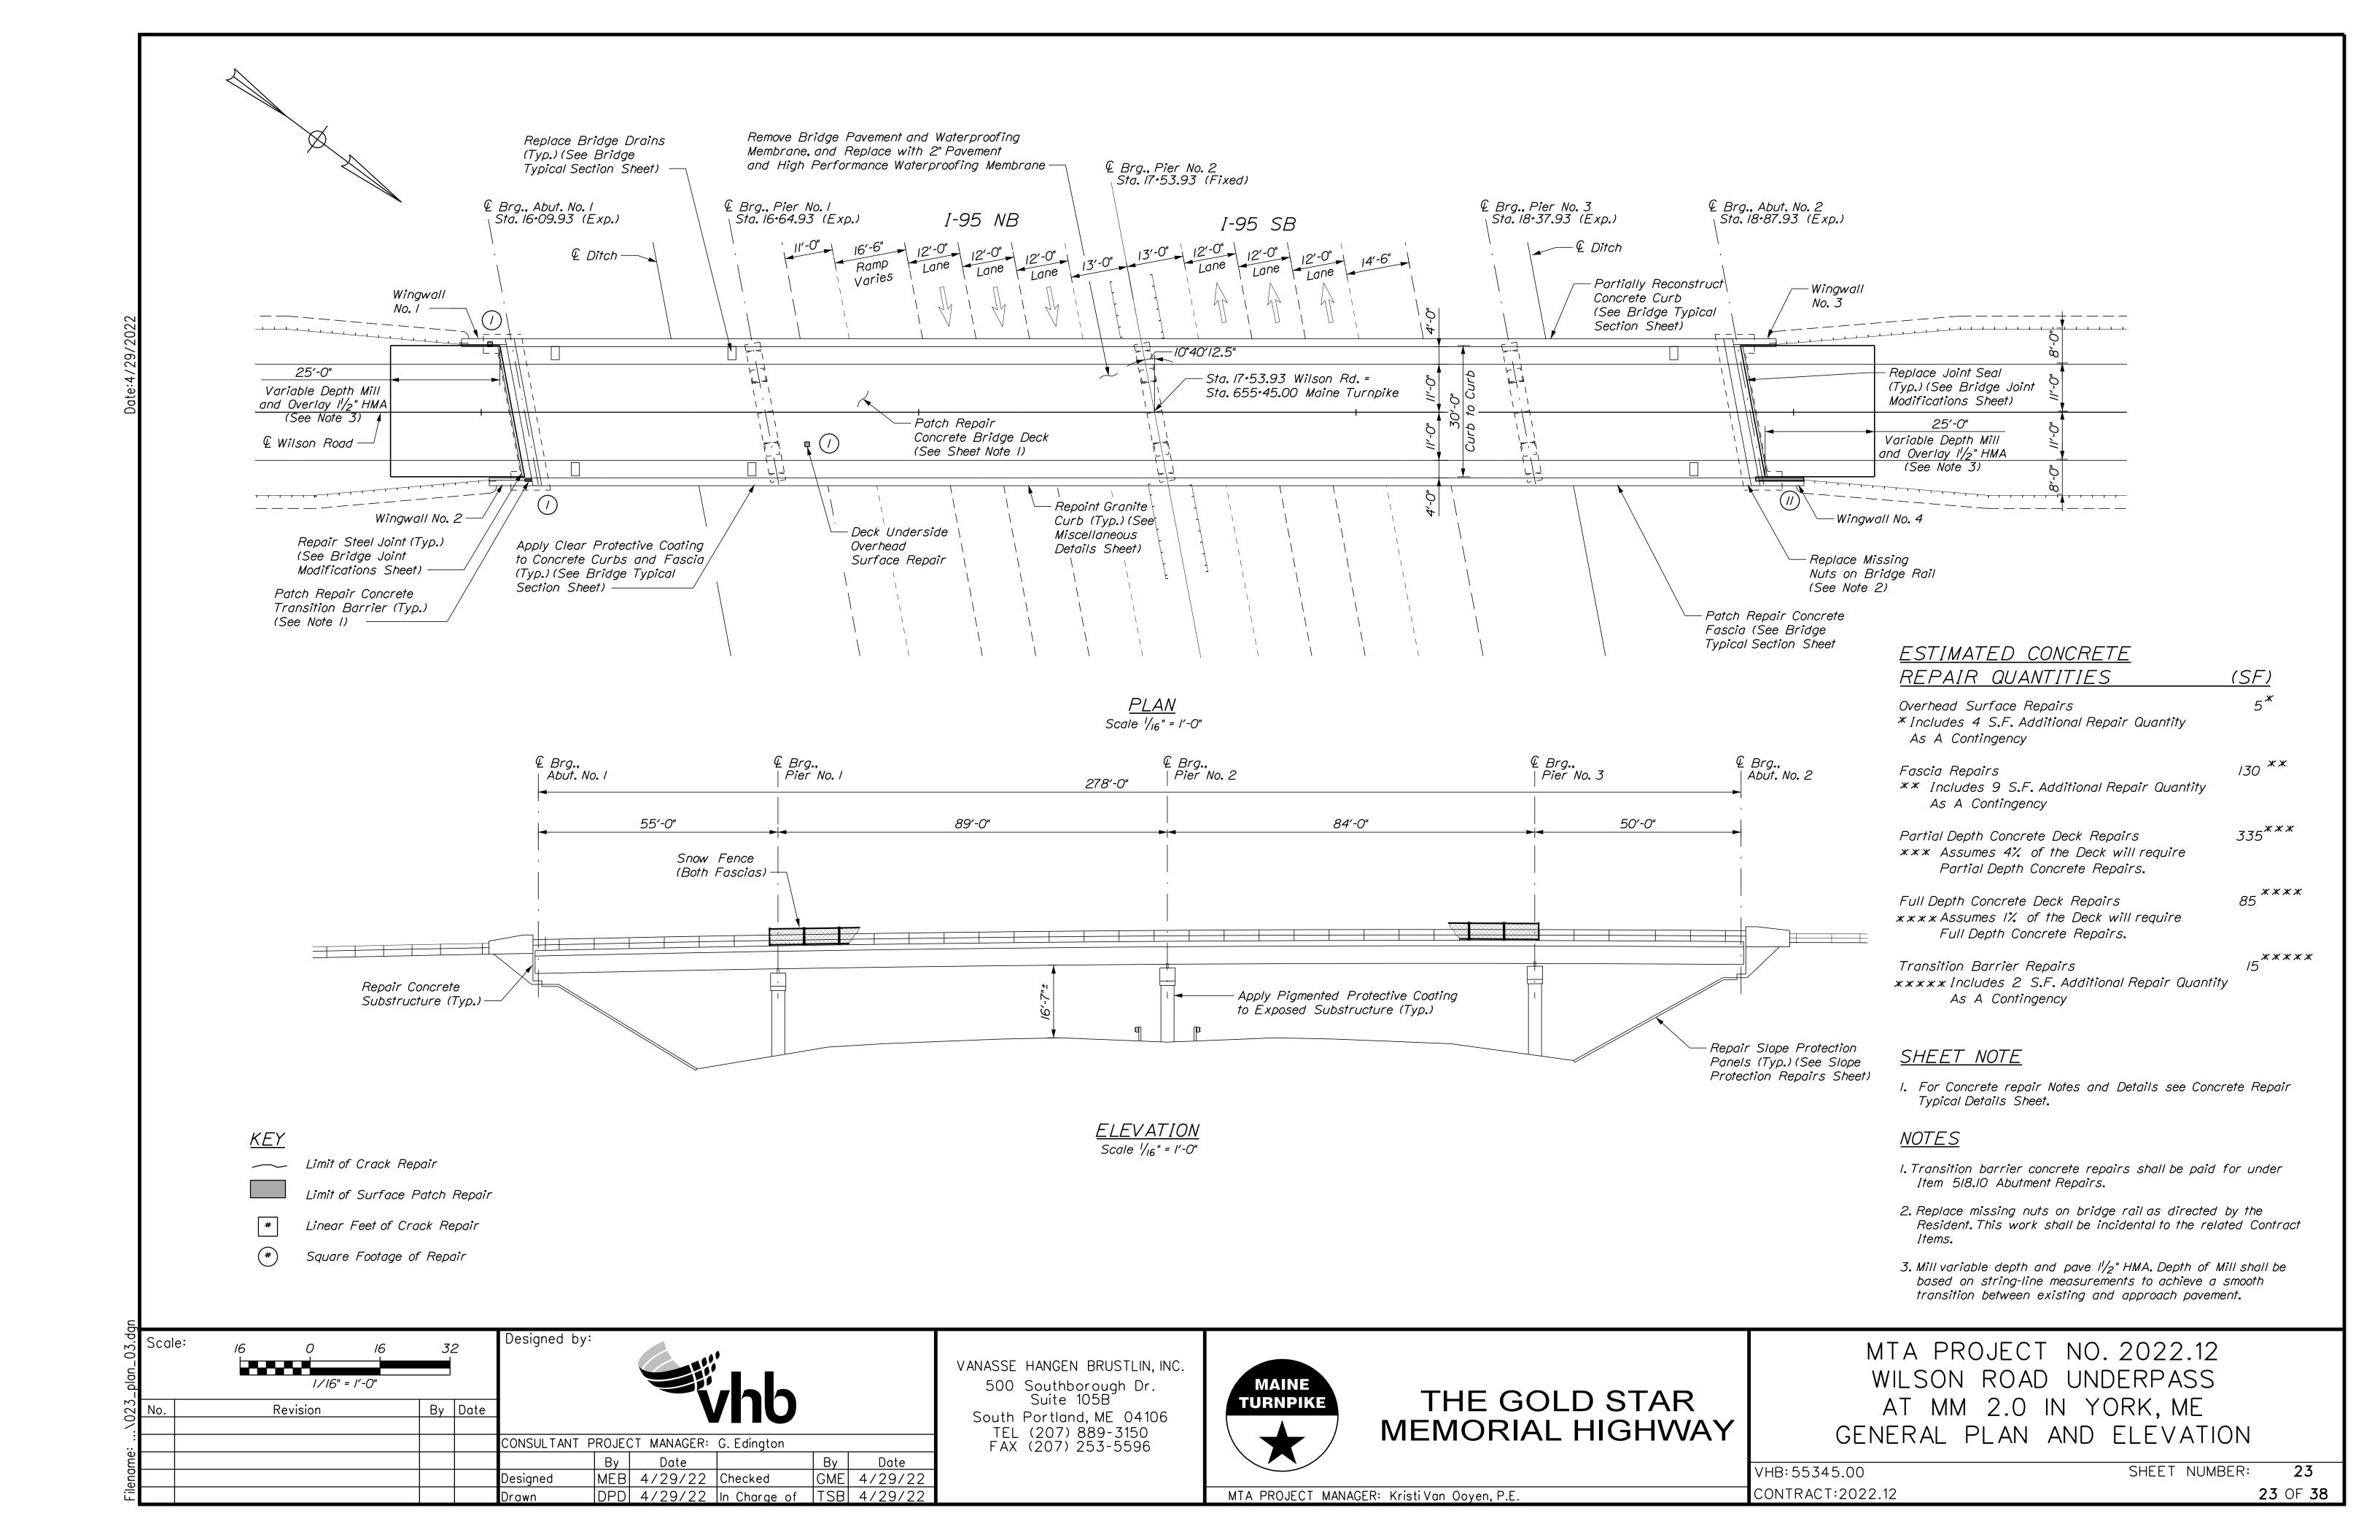

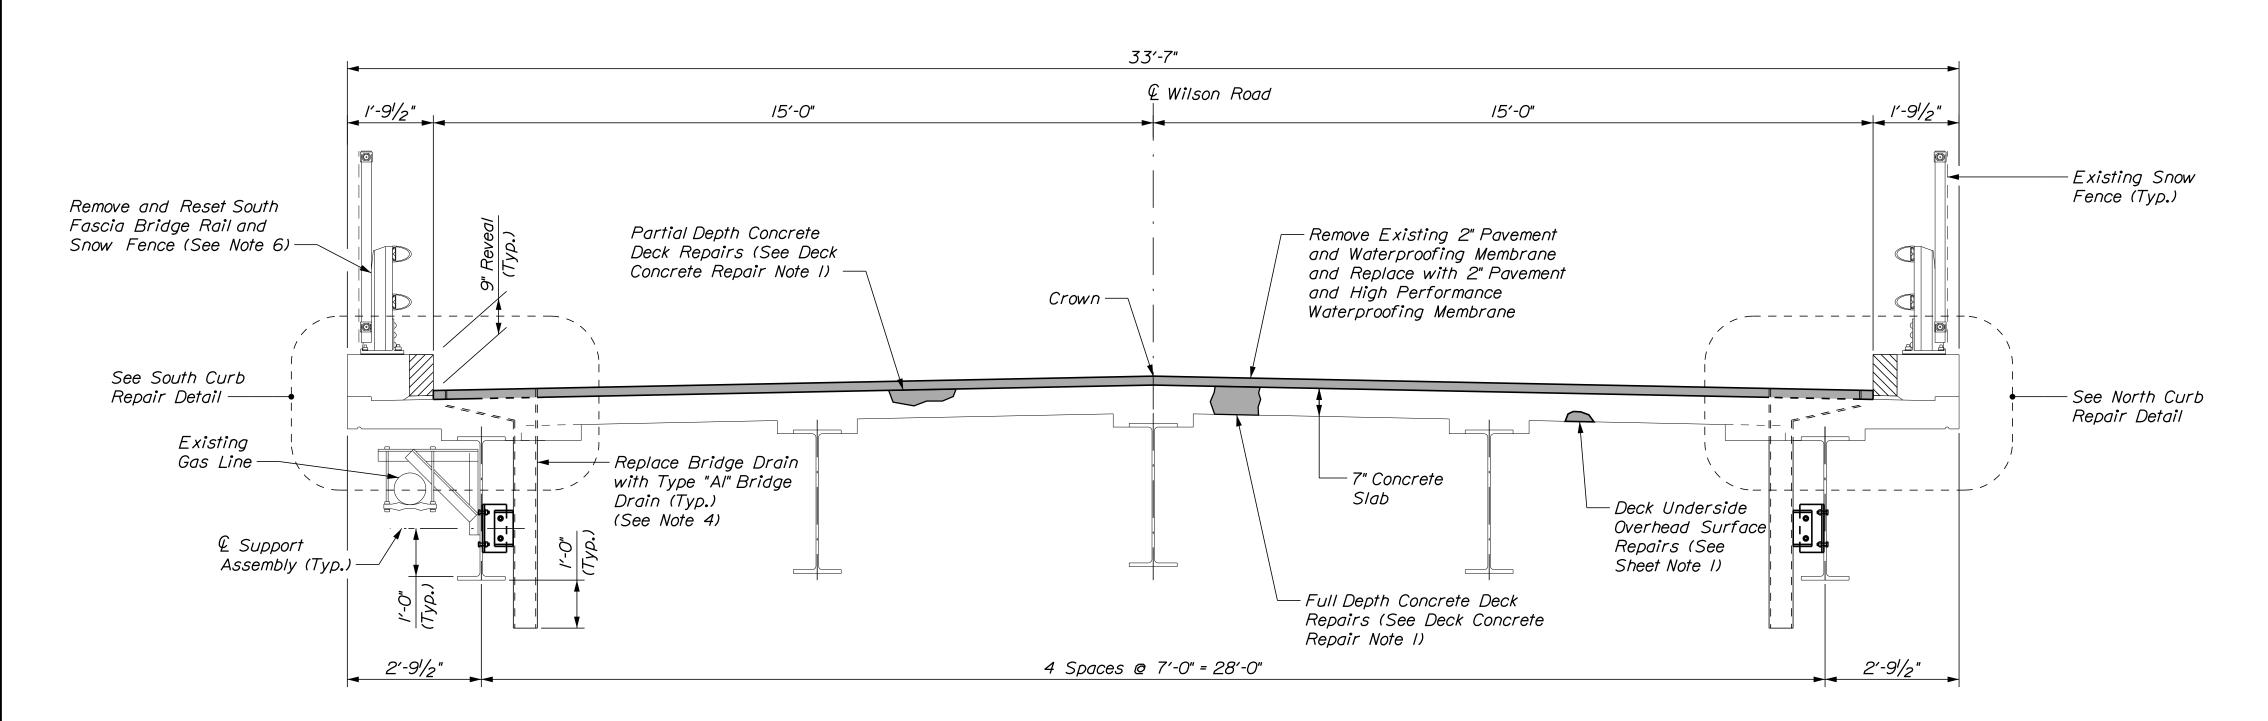


# Scale: 1/2" = 1'-0"

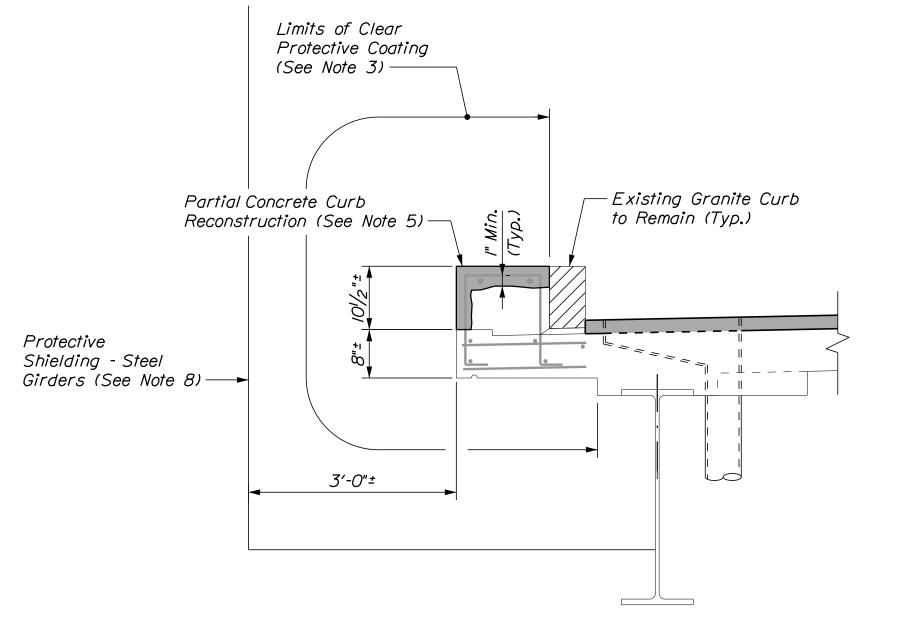

SOUTH CURB REPAIR DETAIL

(Bridge Rail not Shown for Clarity)

Scale: 3/4" = 1'-0"

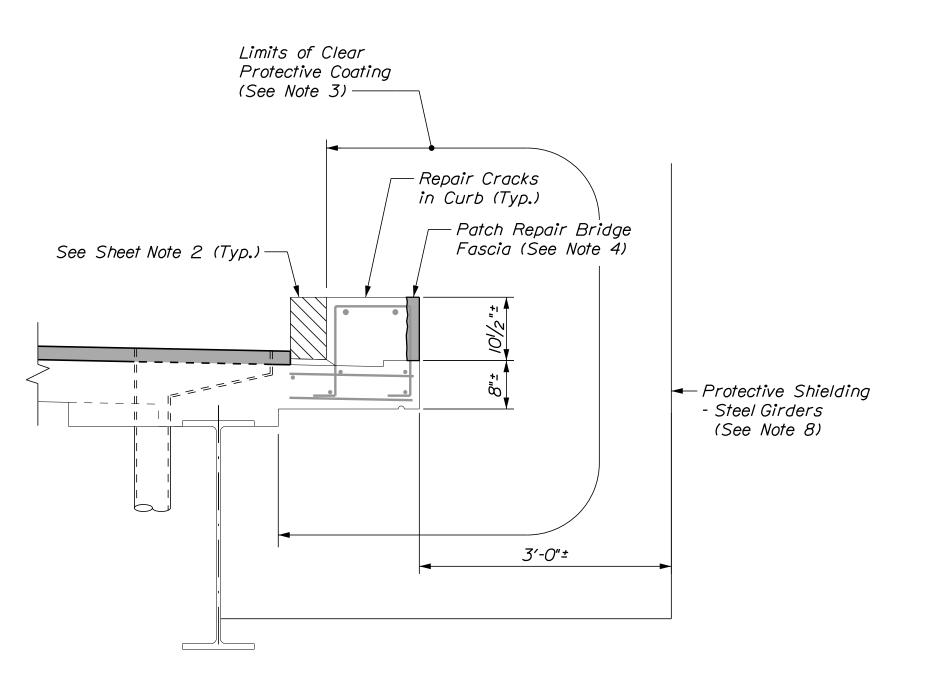

NORTH CURB REPAIR DETAIL

(Bridge Rail not Shown for Clarity)

Scale: 3/4" = 1'-0"

# <u>ESTIMATED CONCRETE</u> REPAIR QUANTITIES

\_\_\_\_\_\_

85 \*

(LF)

Epoxy Injection Crack Repair
\*\* Includes 2 L.F. Additional Repair Quantity
As A Contingency

# DECK CONCRETE REPAIR NOTES

- I. Prior to the start of the deck concrete repairs, the Resident and the Contractor shall sound all deck concrete using a chain drag or other method approved by the Resident to determine the required repair limits. All costs for sounding the existing deck concrete shall be incidental to Item 518.80 Partial Depth Concrete Deck Repair and Item 518.81 Full Depth Concrete Deck Repairs.
- 2. Sawcut I" deep along all limits of removal.
- 3. Prepare and patch repair deteriorated areas. Install new reinforcing steel, as required. See Supplemental Specifications 518.
- 4. Selectively patch repair the north bridge fascia as directed by the Resident. Patch repair of the north fascia shall be paid for under Item 518.75 Fascia and Overhang Repairs.
- 5. Reconstruct the south concrete bridge curb as shown in the South Curb Repair Detail. All labor, equipment, and materials necessary to partially reconstruct the south concrete bridge curb, including removing and resetting the existing bridge rail and snow fence, shall be paid for under Item 518.76, Partial Concrete Curb Reconstruction. See Special Provision Section 518 for additional requirements.
- 6. Limits of clear protective coating shall be paid for under Item 515,202, Clear Protective Coating for Concrete Surfaces.
- 7. Replacing the bridge drains shall be paid under Item 502.702, Replace Bridge Drain (Type AI).
- 8. The Contractor shall install Protective Shielding Steel Girders prior to the start of the repairs at the north and south curbs. All access for the curb repairs shall be from the Protective Shielding Steel Girders.

## SHEET NOTES

- I. For Concrete repair Notes and Details see Concrete Repair Typical Details Sheet.
- 2. For Existing Granite Curb Detail see Miscellaneous Details Sheet.

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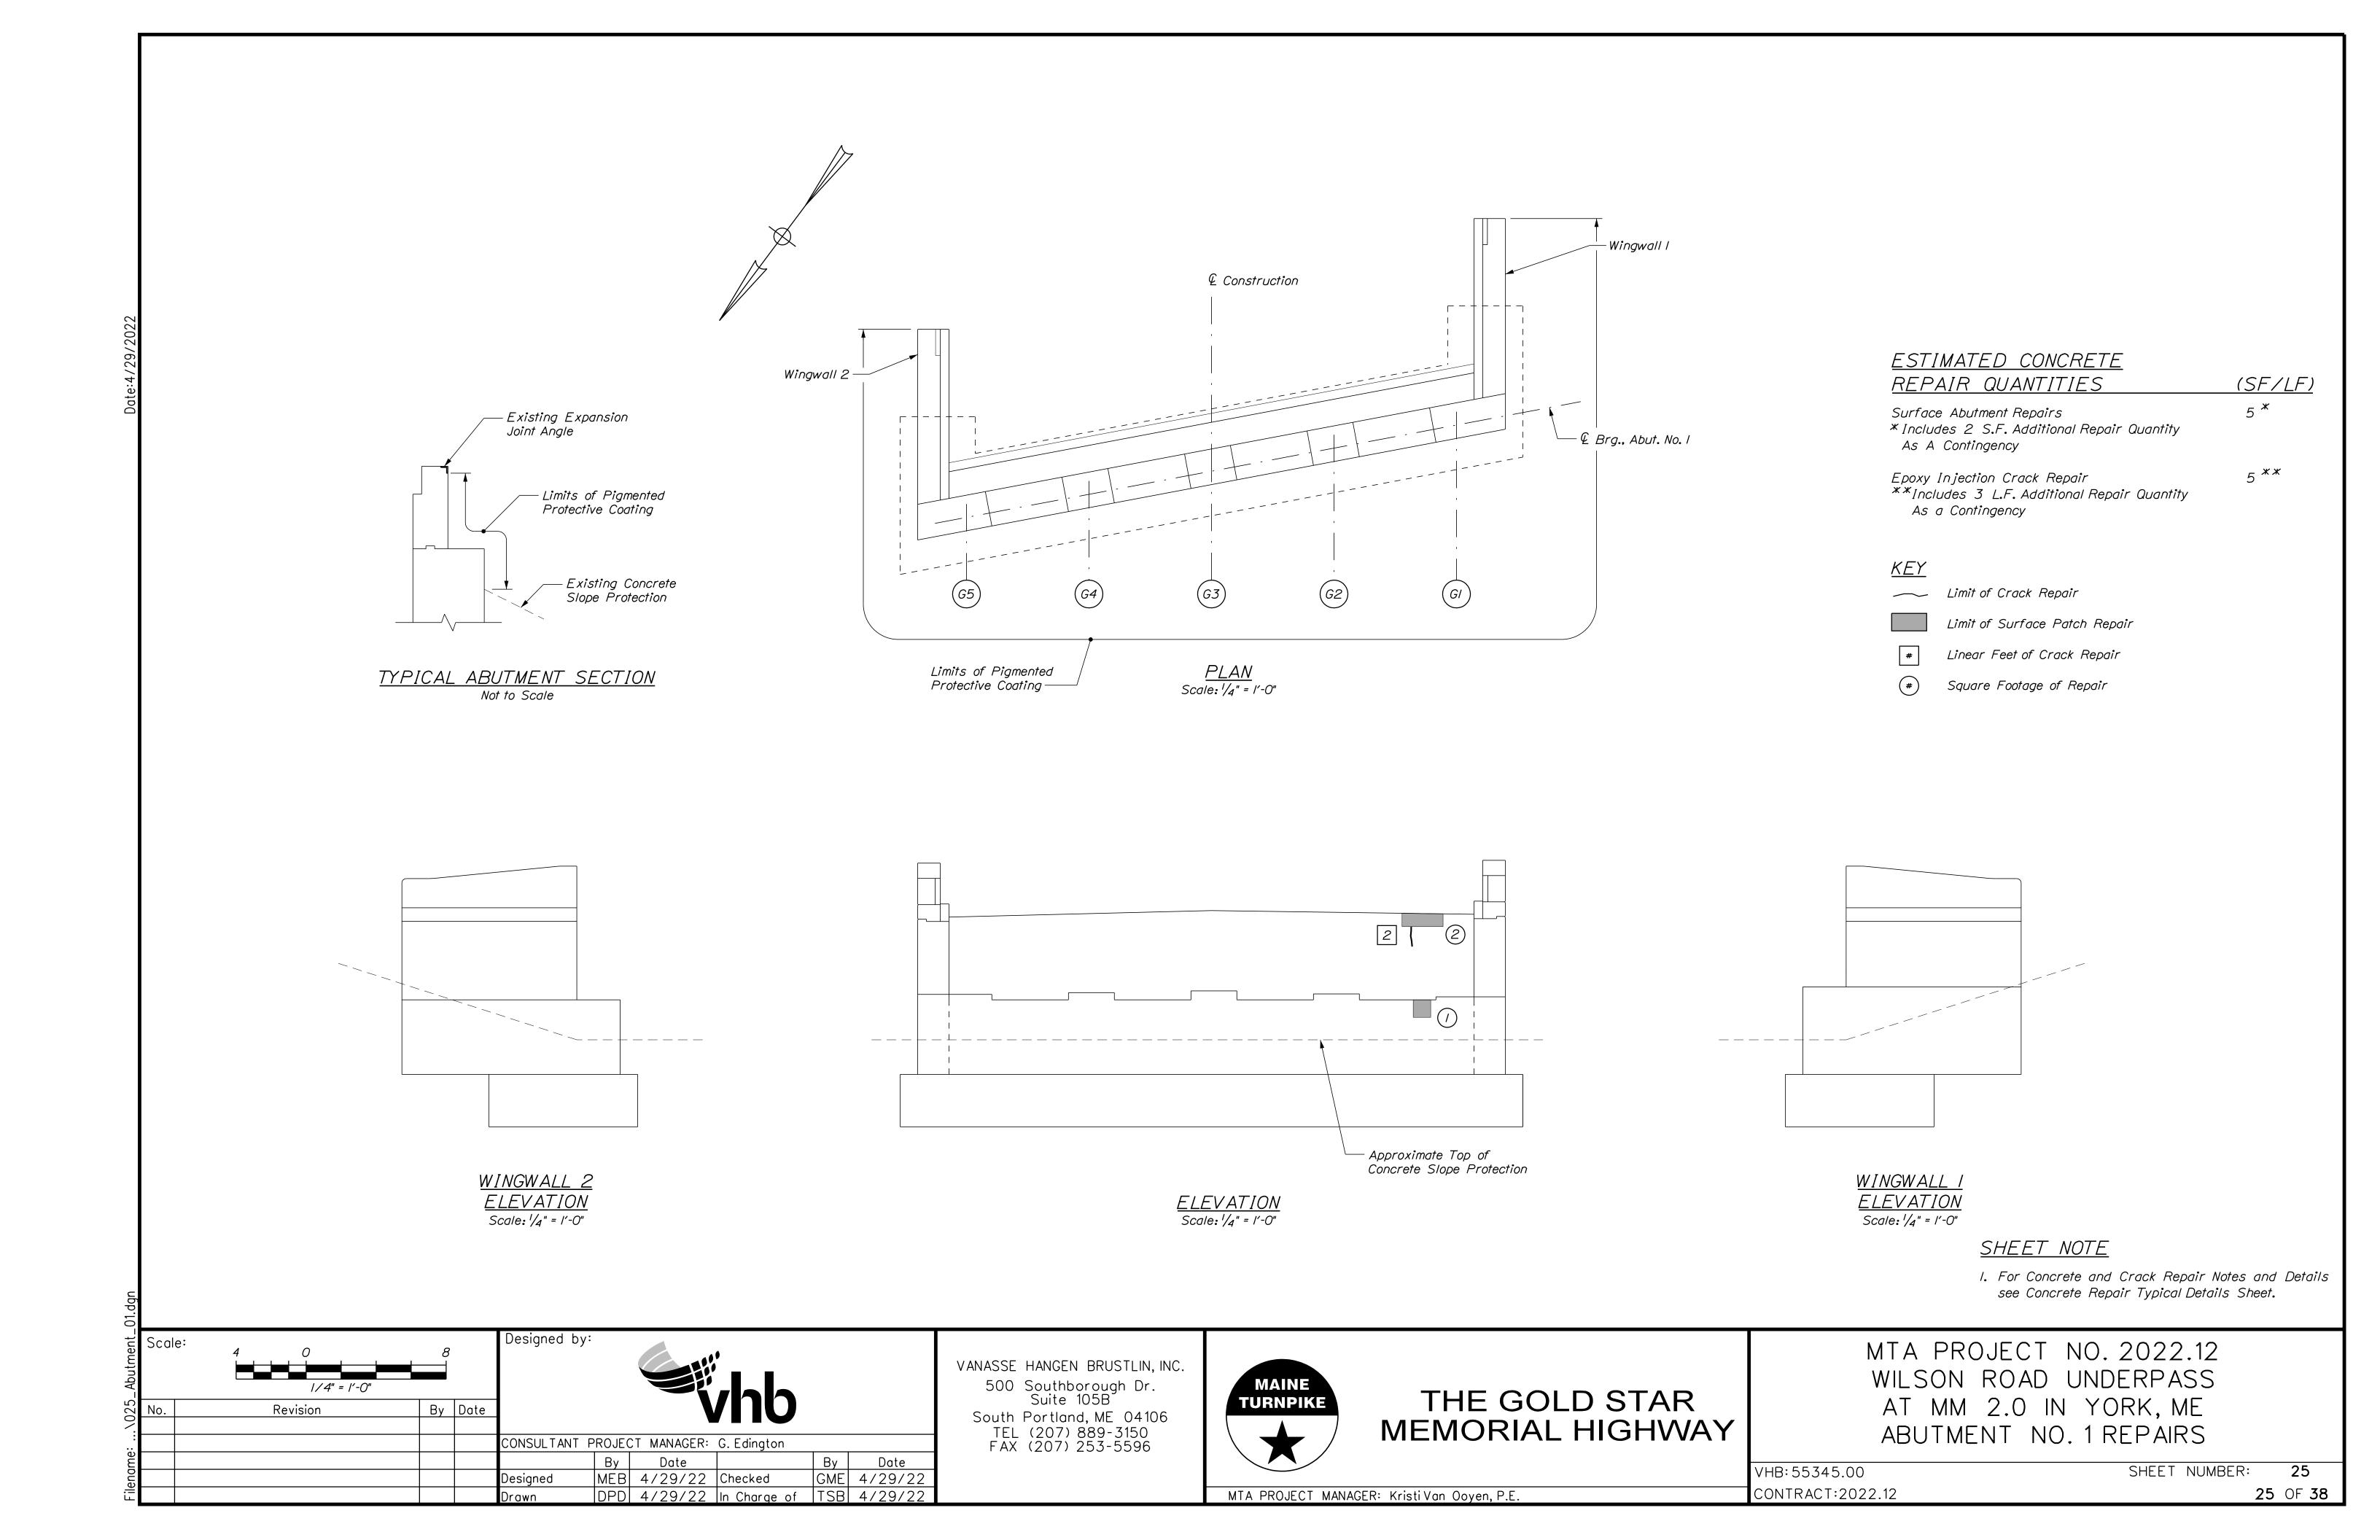



THE GOLD STAR
MEMORIAL HIGHWAY

MTA PROJECT NO. 2022.12
WILSON ROAD UNDERPASS
AT MM 2.0 IN YORK, ME
BRIDGE TYPICAL SECTION

VHB:55345.00 CONTRACT:2022.12

SHEET NUMBER: 24
24 OF 38



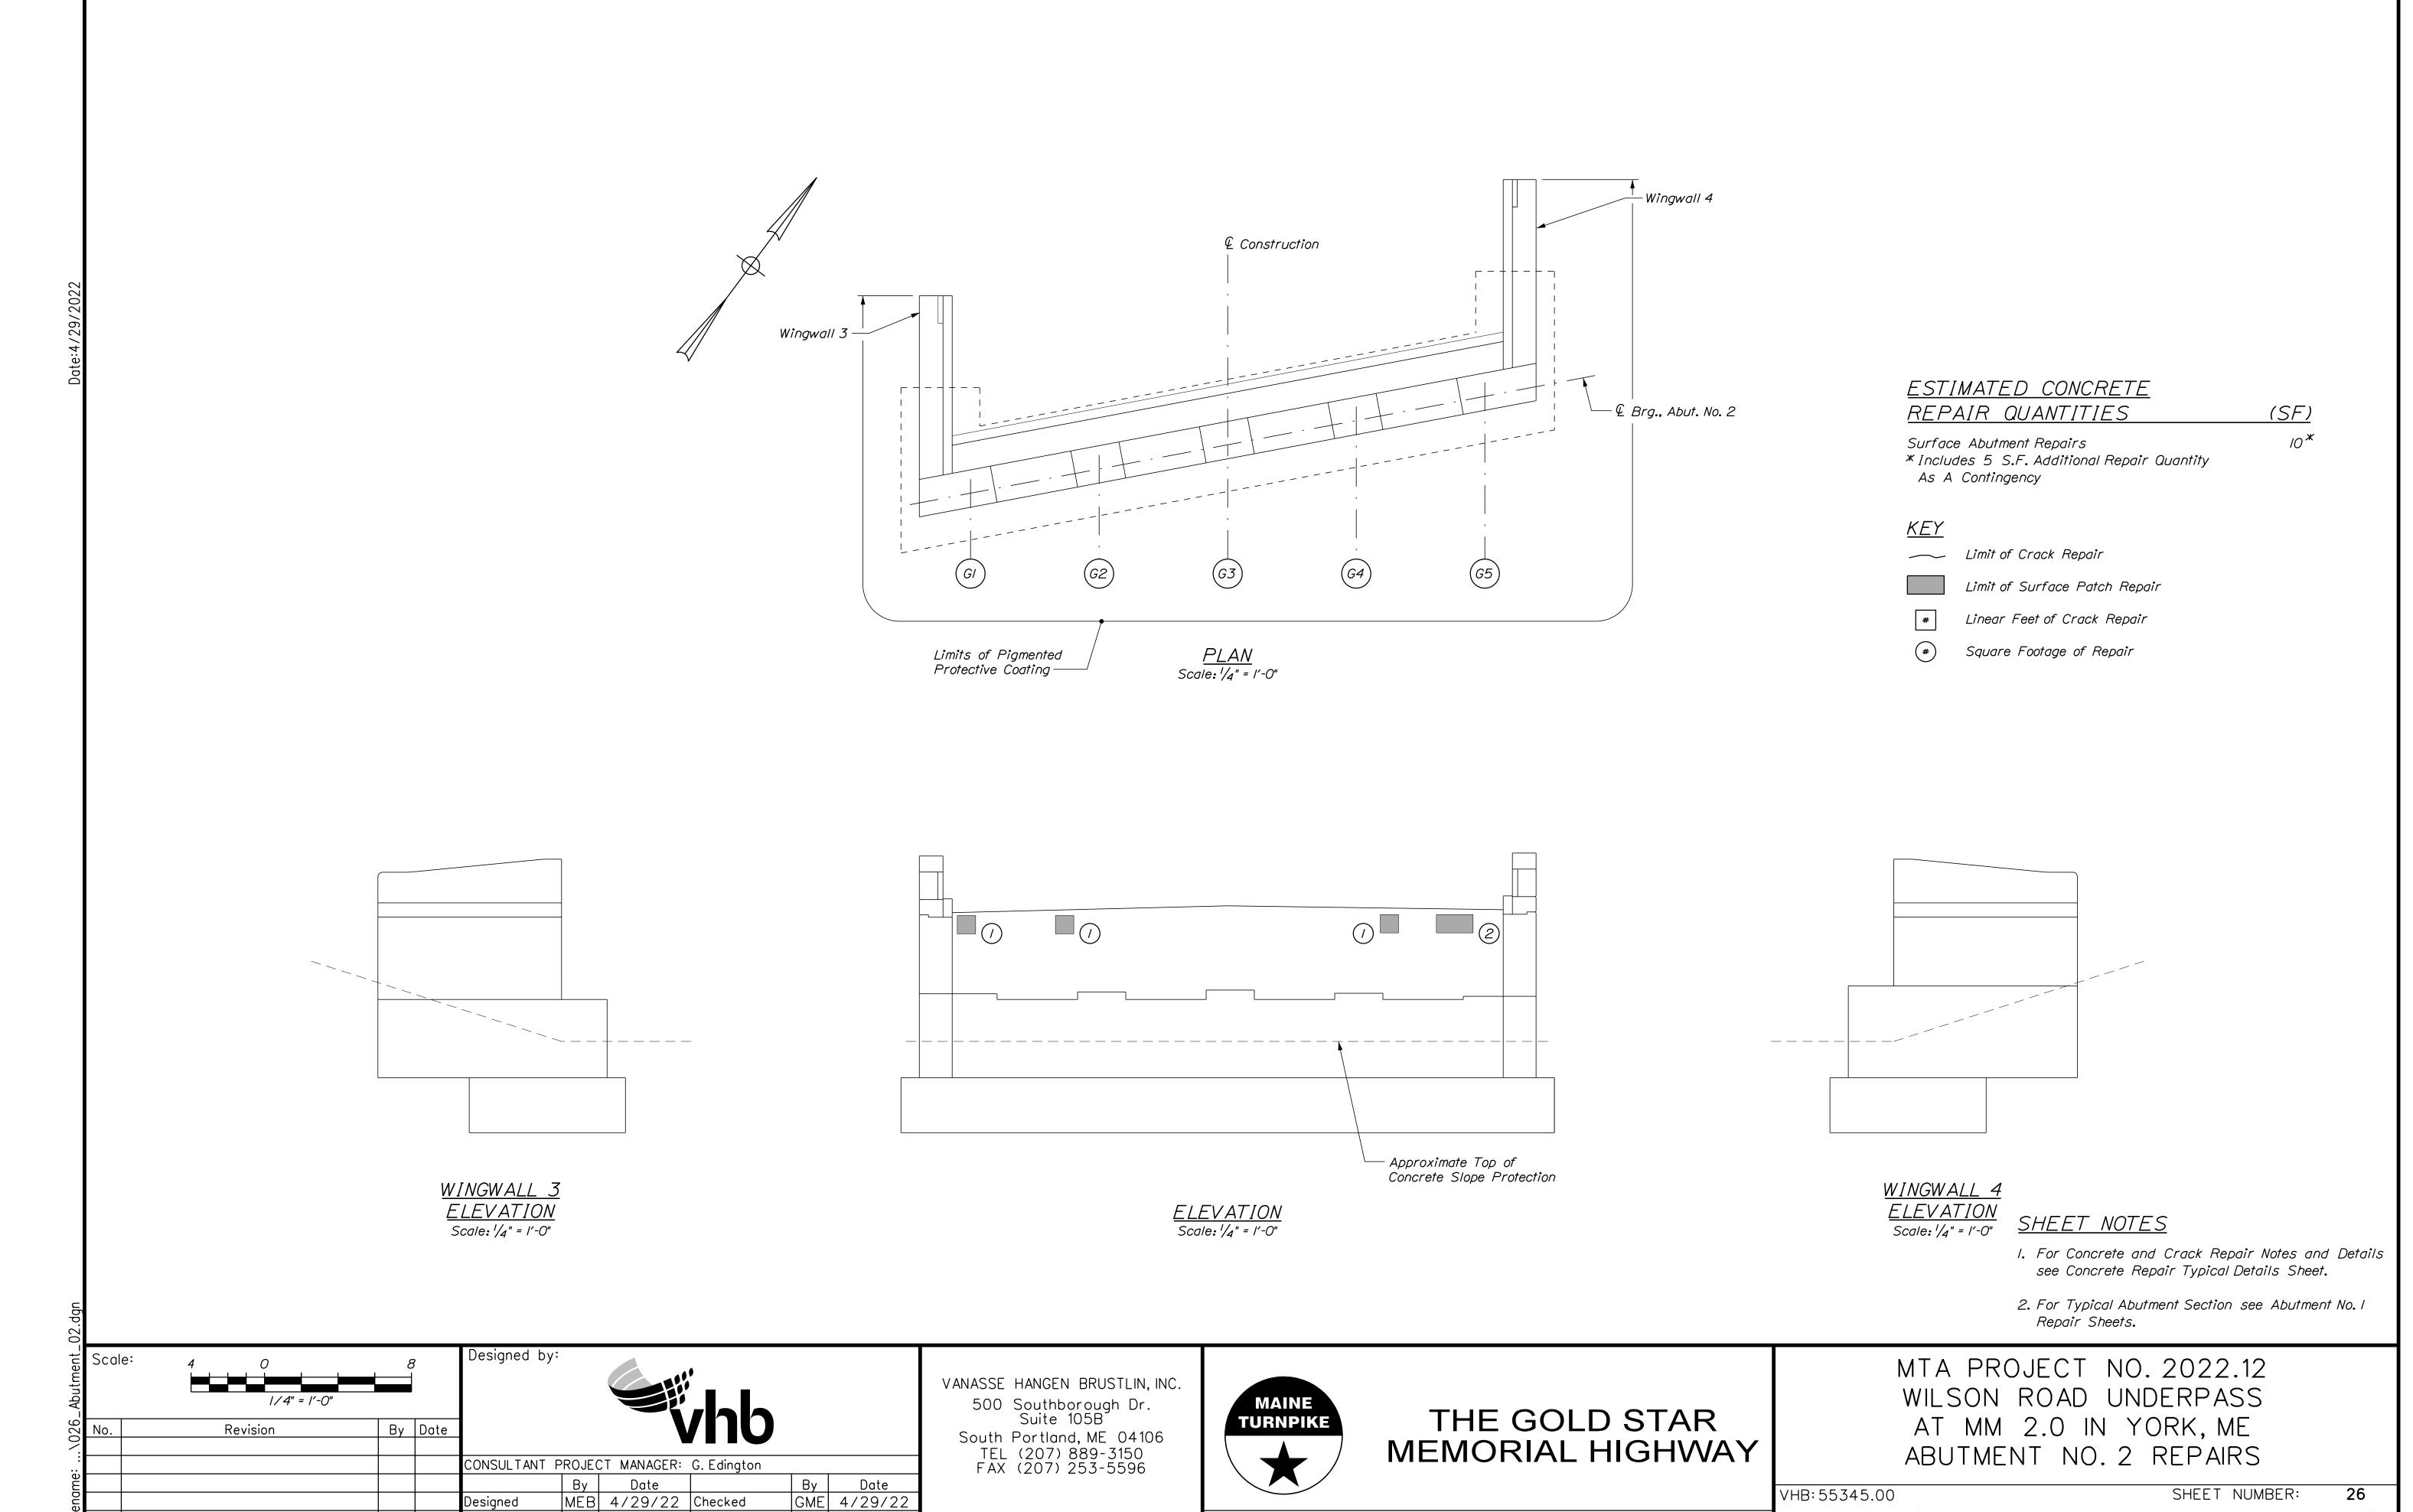


MEB 4/29/22 Checked

DPD 4/29/22 In Charge of TSB 4/29/22

Designed

26 SHEET NUMBER: VHB: 55345.00 CONTRACT:2022.12 **26** OF **38** MTA PROJECT MANAGER: Kristi Van Ooyen, P.E.

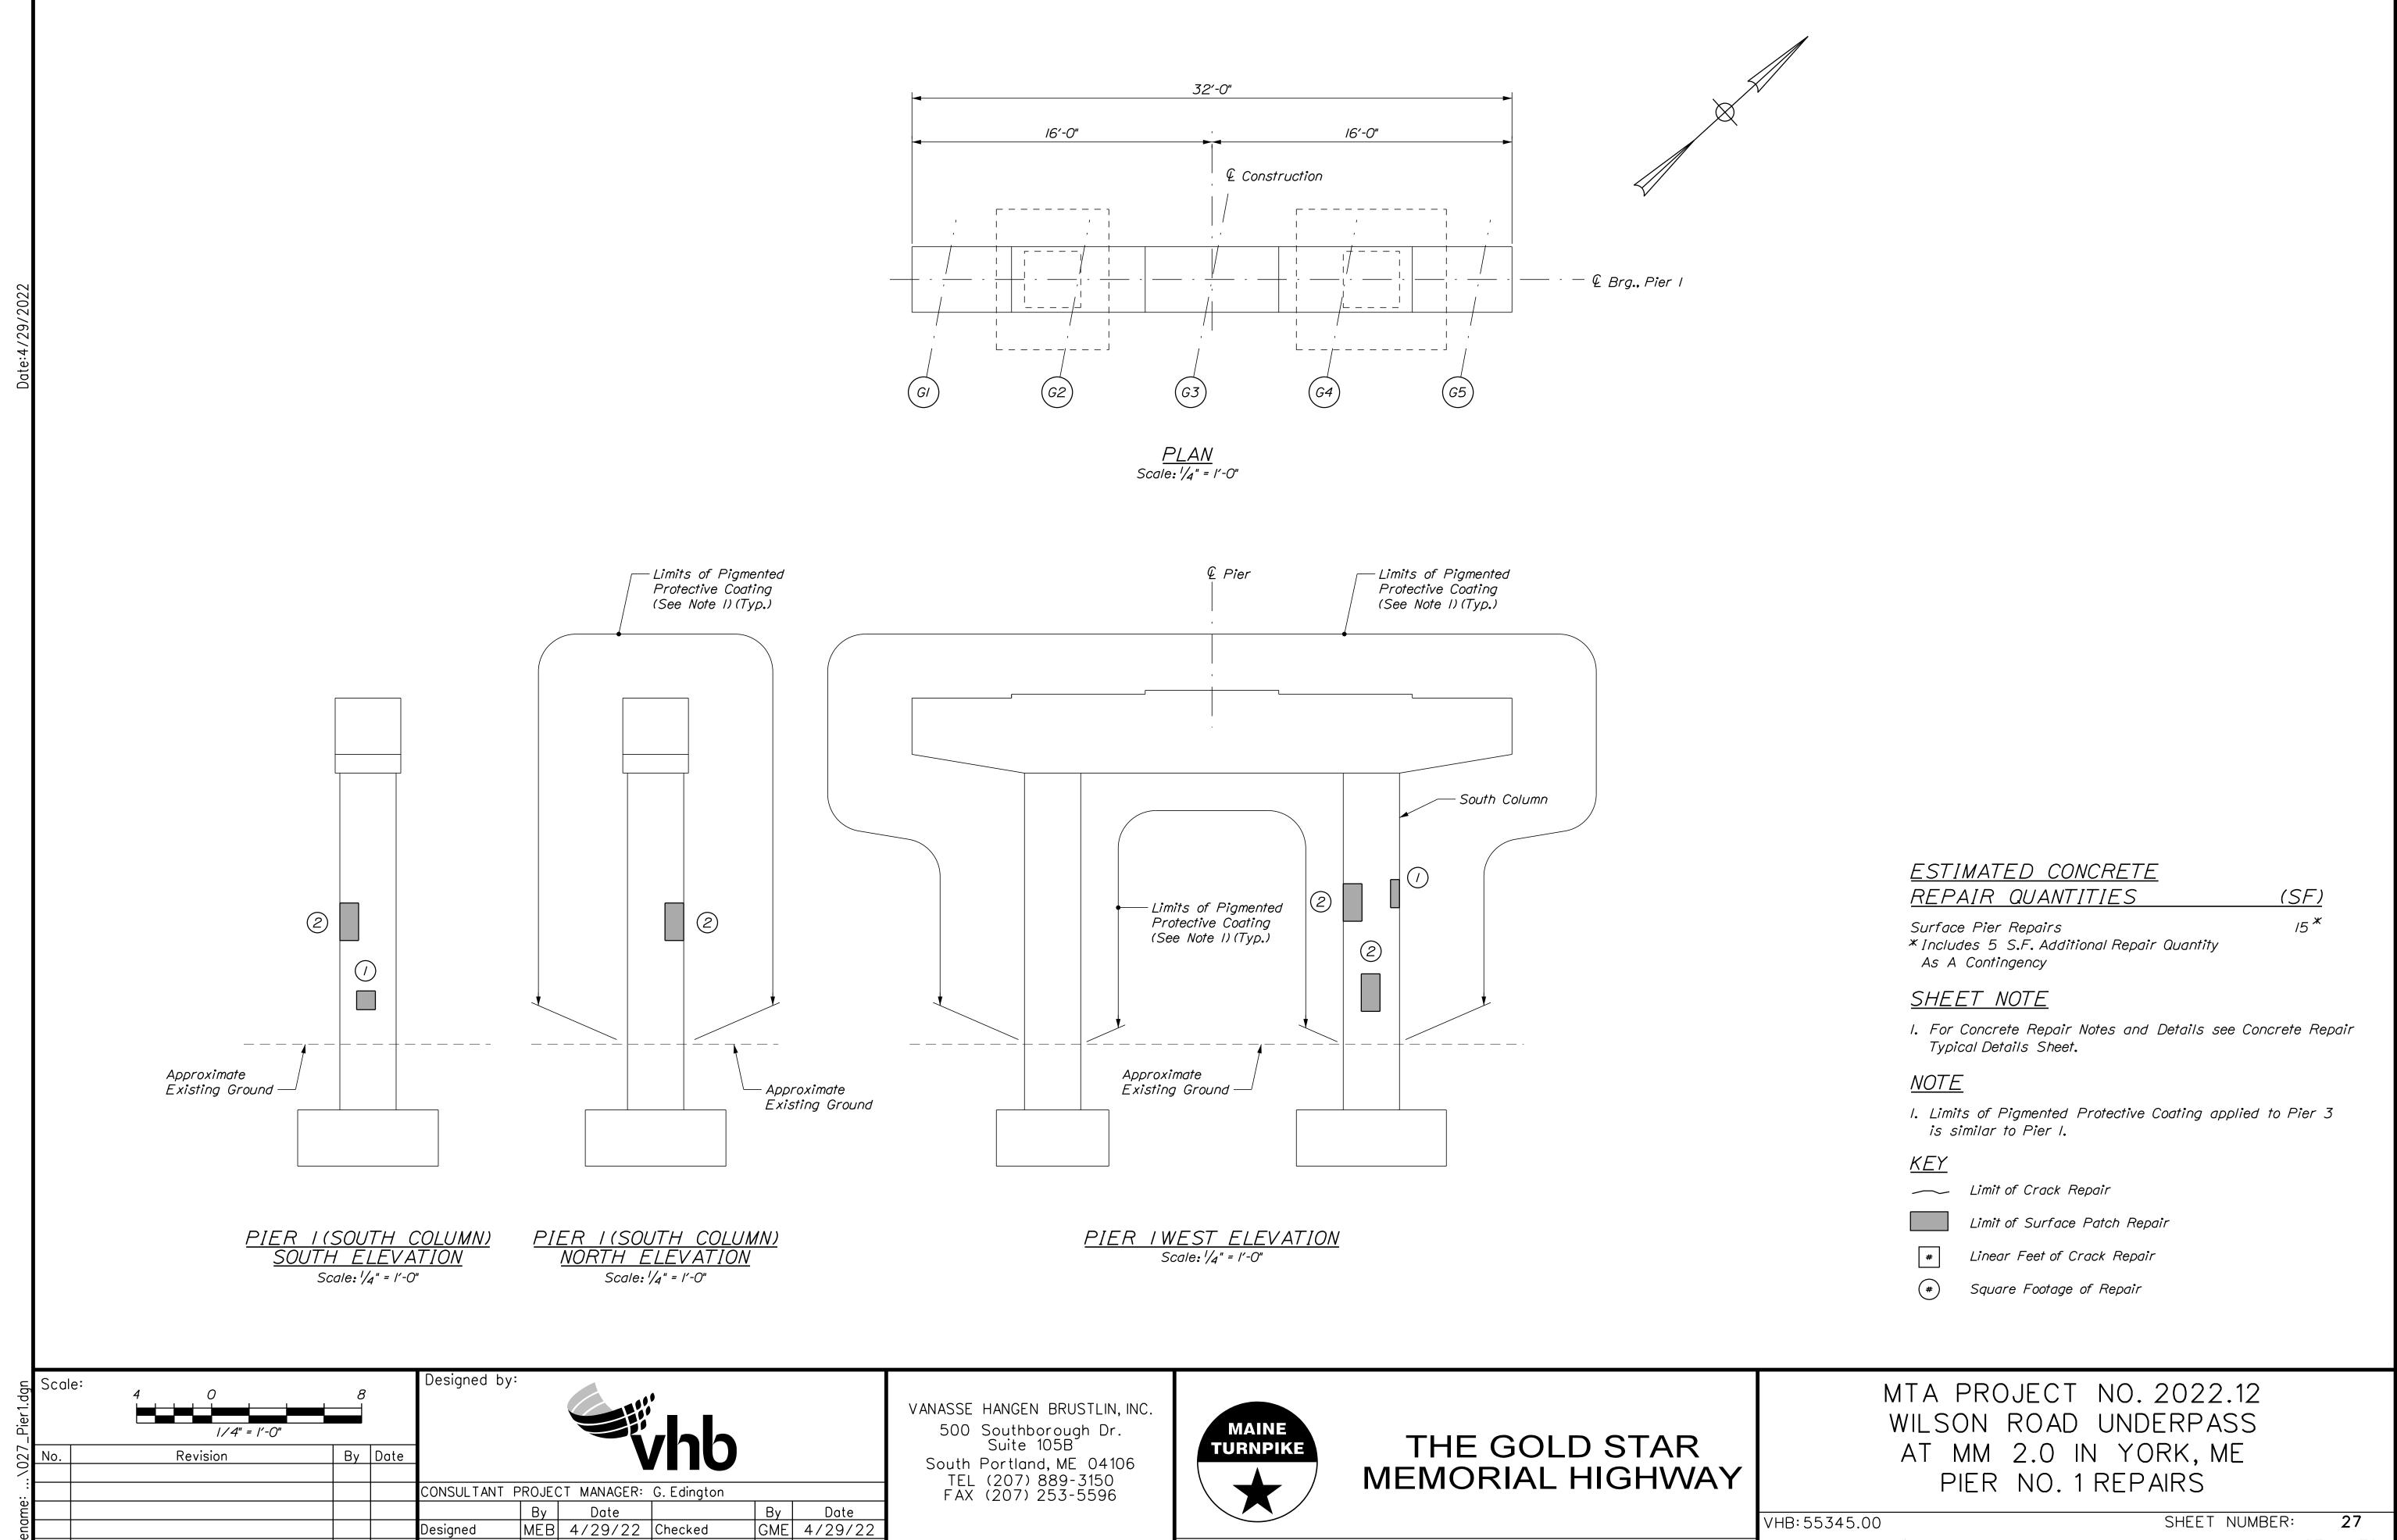


MTA PROJECT MANAGER: Kristi Van Ooyen, P.E.


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**27** OF **38** 

CONTRACT:2022.12

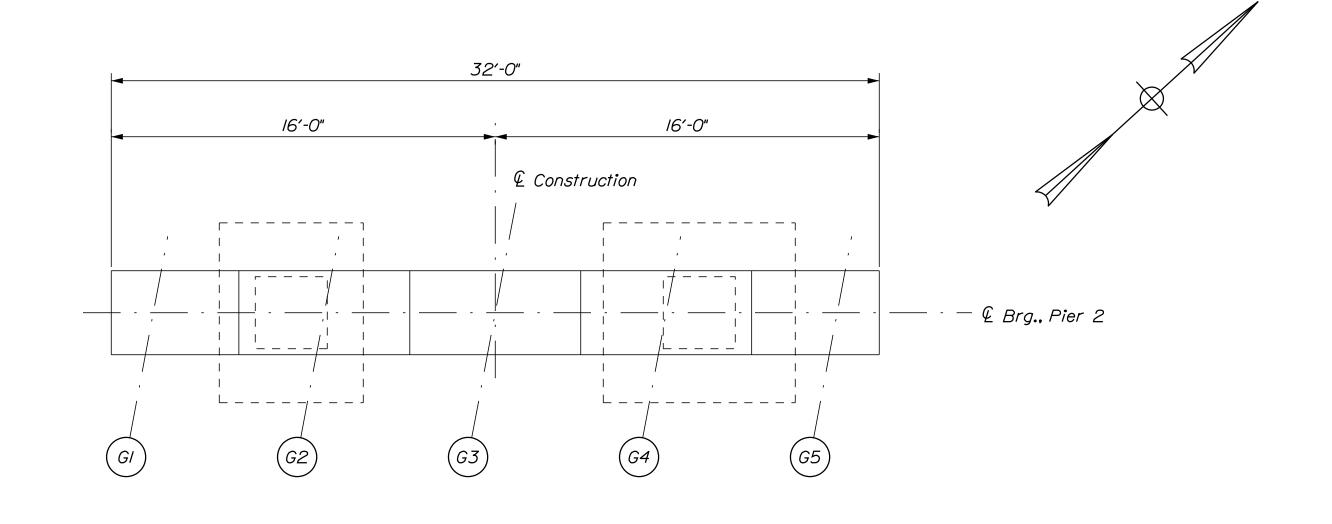

<u>PLAN</u> Scale: <sup>1</sup>/<sub>4</sub>" = 1'-0"

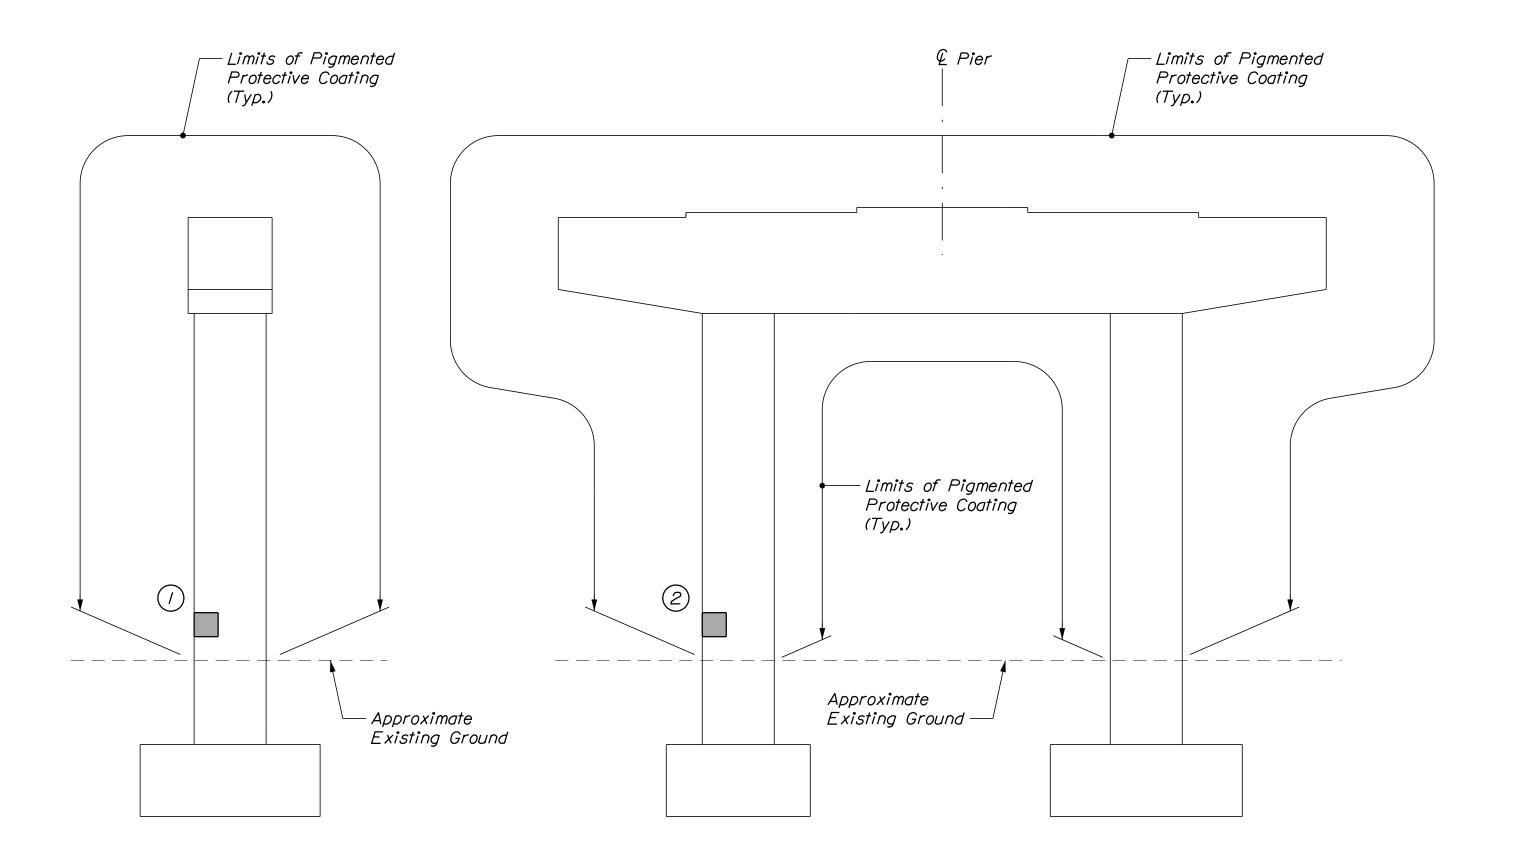

PIER 2 SOUTH ELEVATION

Scale: 1/4" = 1'-0"

PIER 2 WEST ELEVATION

Scale: 1/4" = 1'-0"

# ESTIMATED CONCRETE

REPAIR QUANTITIES

(SF)

Surface Pier Repairs
\* Includes 2 S.F. Additional Repair Quantity
As A Contingency

# SHEET NOTE

I. For Concrete Repair Notes and Details see Concrete Repair Typical Details Sheet.

# <u>KEY</u>

\_\_\_\_ Limit of Crack Repair

Limit of Surface Patch Repair

# Linear Feet of Crack Repair

#) Square Footage of Repair

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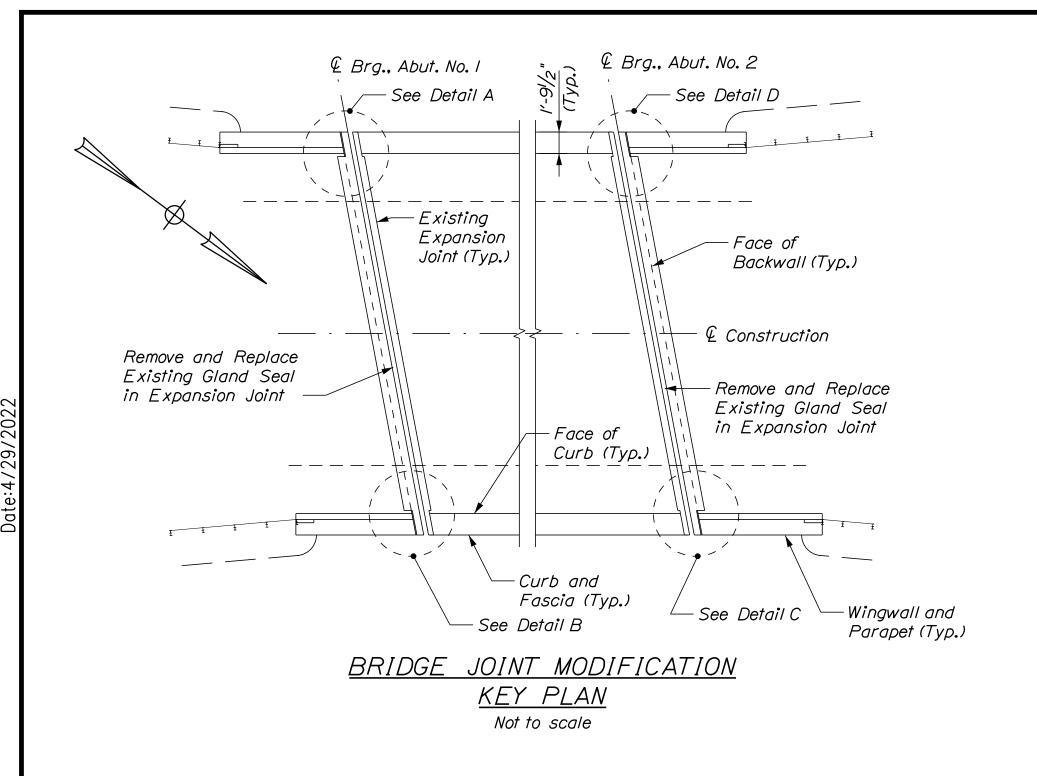


THE GOLD STAR
MEMORIAL HIGHWAY

MTA PROJECT NO. 2022.12
WILSON ROAD UNDERPASS
AT MM 2.0 IN YORK, ME
PIER NO. 2 REPAIRS


VHB: 55345.00 CONTRACT: 2022.12 SHEET NUMBER: 28

MTA PROJECT MANAGER: Kristi Van Ooyen, P.E.




## BRIDGE JOINT MODIFICATION NOTES:

- I. Replace the entire existing gland seal in the deck end expansion joints at both abutments. The existing gland seal is called out as a S-300 Watson Bowman Acme on the 1988 rehabilitation plans. Field investigation indicates that is the type of gland seal currently installed.
- 2. Install steel joint end cover plates as shown in the details on this sheet to seal holes at face of curb that are currently allowing roadway drainage onto fascia girder and bridge seat. Grind top of existing expansion joint angle and extrusion as required to provide a smooth surface for the cover plates to bear on. Dimensions of joint end cover plates shown in these plans are based on limited field measurements. The Contractor shall take sufficient field measurements to confirm the proposed dimensions of the plates. If adjustments to plate dimensions are required for proper fit up based on Contractor's field measurements, the Contractor shall submit plans annotated with the revised dimensions to the Resident prior to fabrication.
- 3. Prior to installation of joint end cover plates, place non-shrink concrete repair material to fill any voids in backwall or concrete deck end below or adjacent to the cover plates. Use foam backer rod or forms as necessary to contain the repair material.
- 4. After the joint end cover plates are installed, place elastomeric joint sealant along interface with face of curb and any other unwelded edges of the plates or adjacent openings to prevent water intrusion through joint.
- 5. At the locations shown in these plans where the steel extrusion in the curb has separated from the concrete, reweld the extrusion to the embedded steel plate or where there is insufficient remaining embedded steel plate due to corrosion seal the gap with elastomeric sealant.
- 6. See Bridge Joint Modifications Sheet 2 of 2 for sections and joint end cover plate details.
- 7. All labor, equipment, and material to complete the installation of the joint end cover plates shall be paid for under Item 530.2407, Bridge Joint Steel Modification.

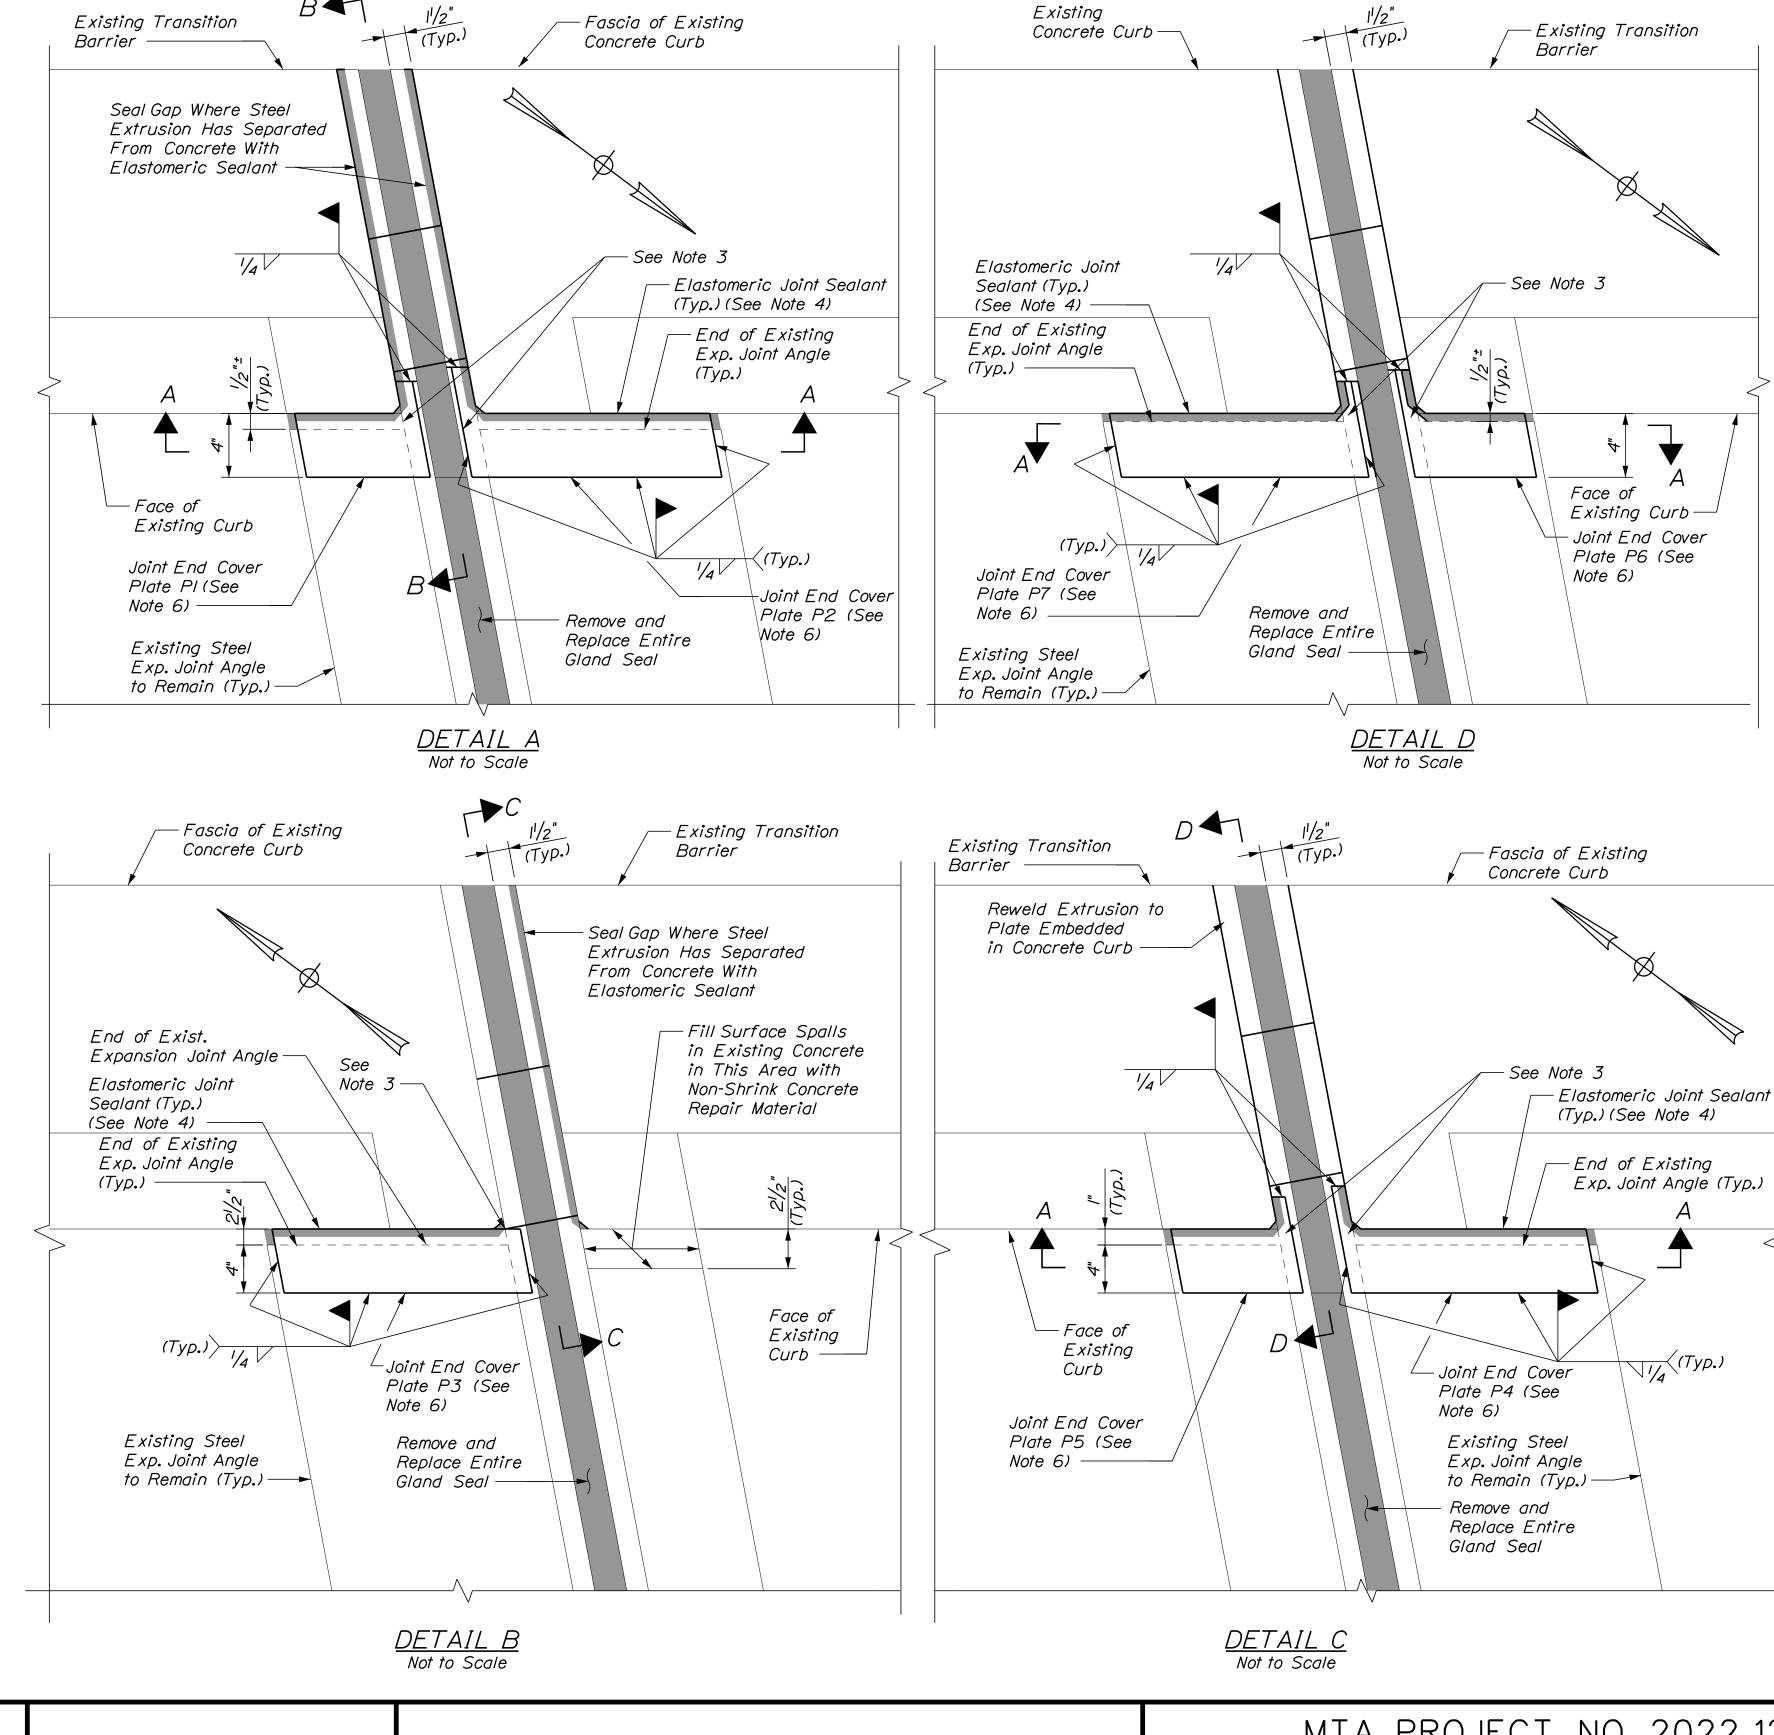

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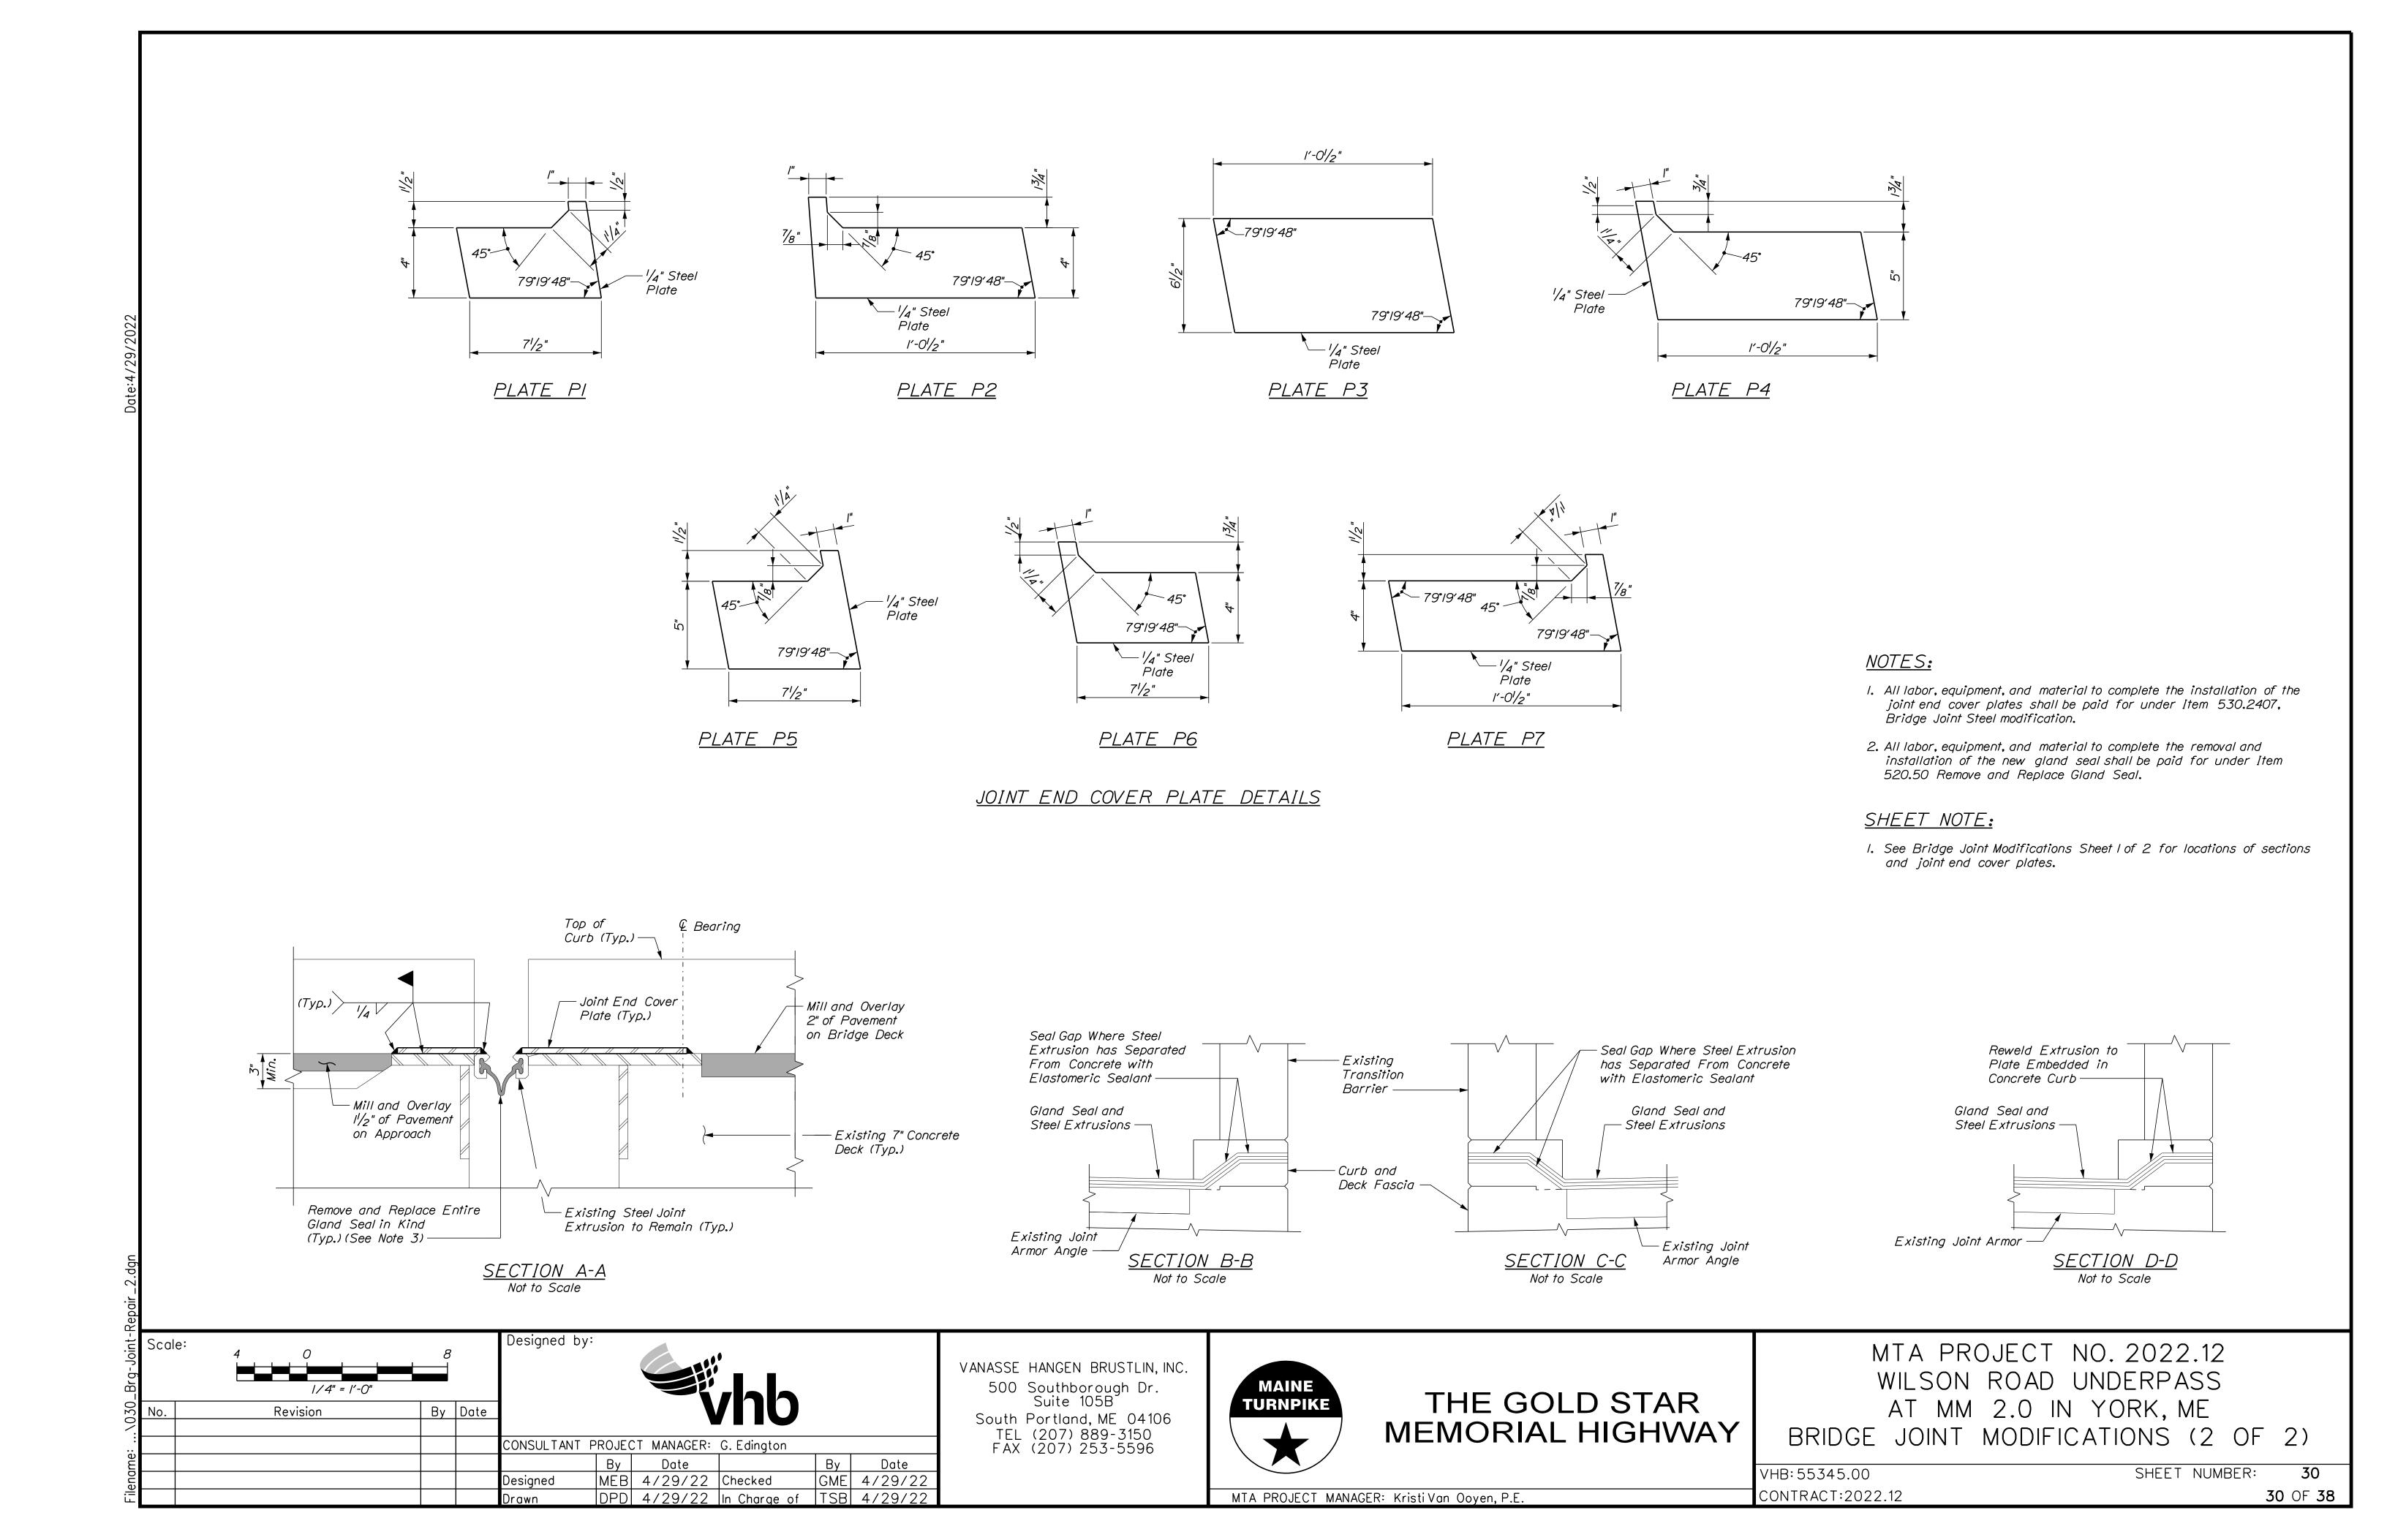


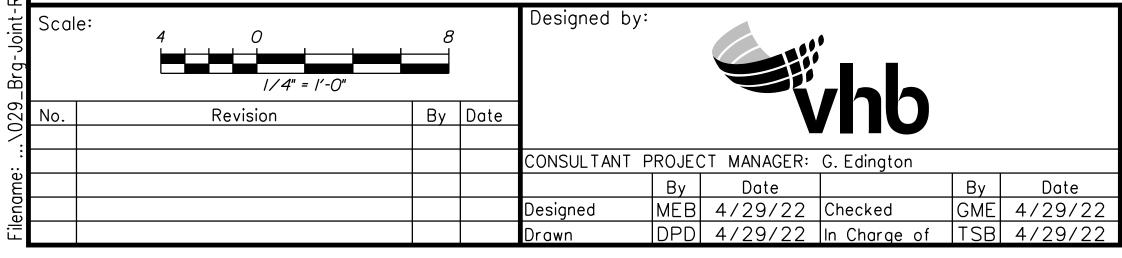
# THE GOLD STAR MEMORIAL HIGHWAY


MTA PROJECT NO. 2022.12 WILSON ROAD UNDERPASS AT MM 2.0 IN YORK, ME BRIDGE JOINT MODIFICATIONS (1 OF 2)

SHEET NUMBER: VHB: 55345.00


29 **29** OF **38** CONTRACT:2022.12 MTA PROJECT MANAGER: Kristi Van Ooven, P.E.




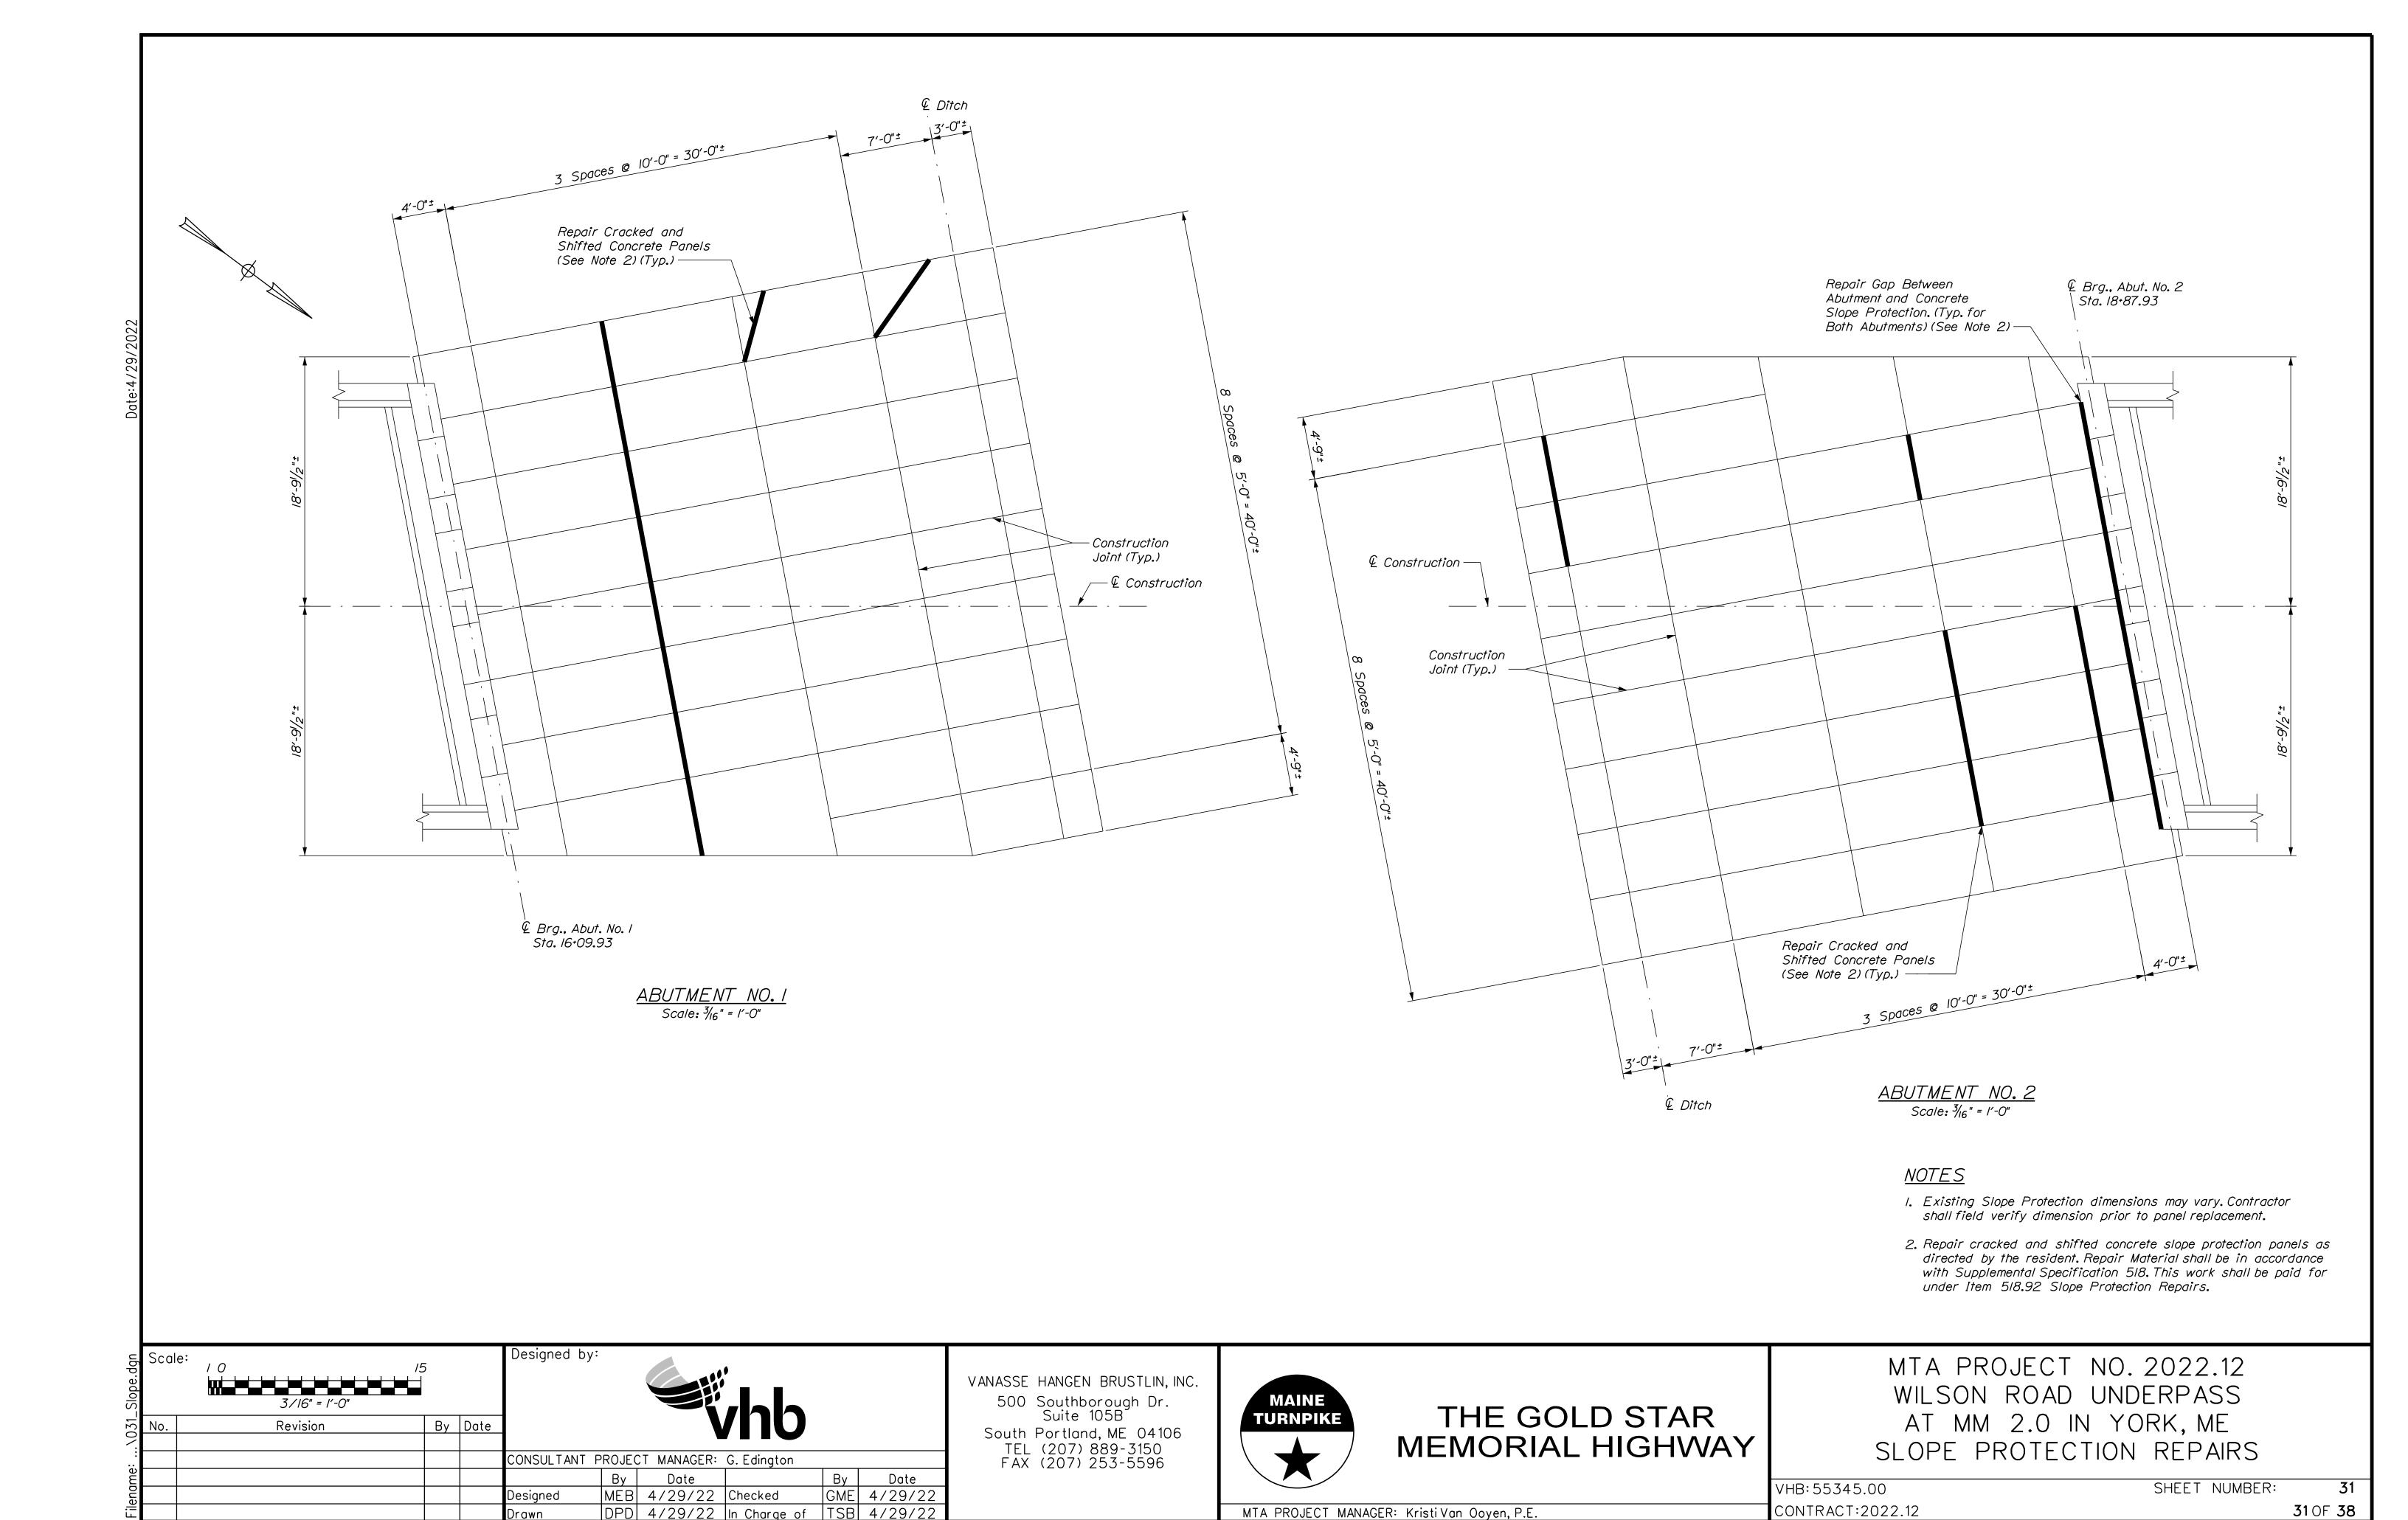

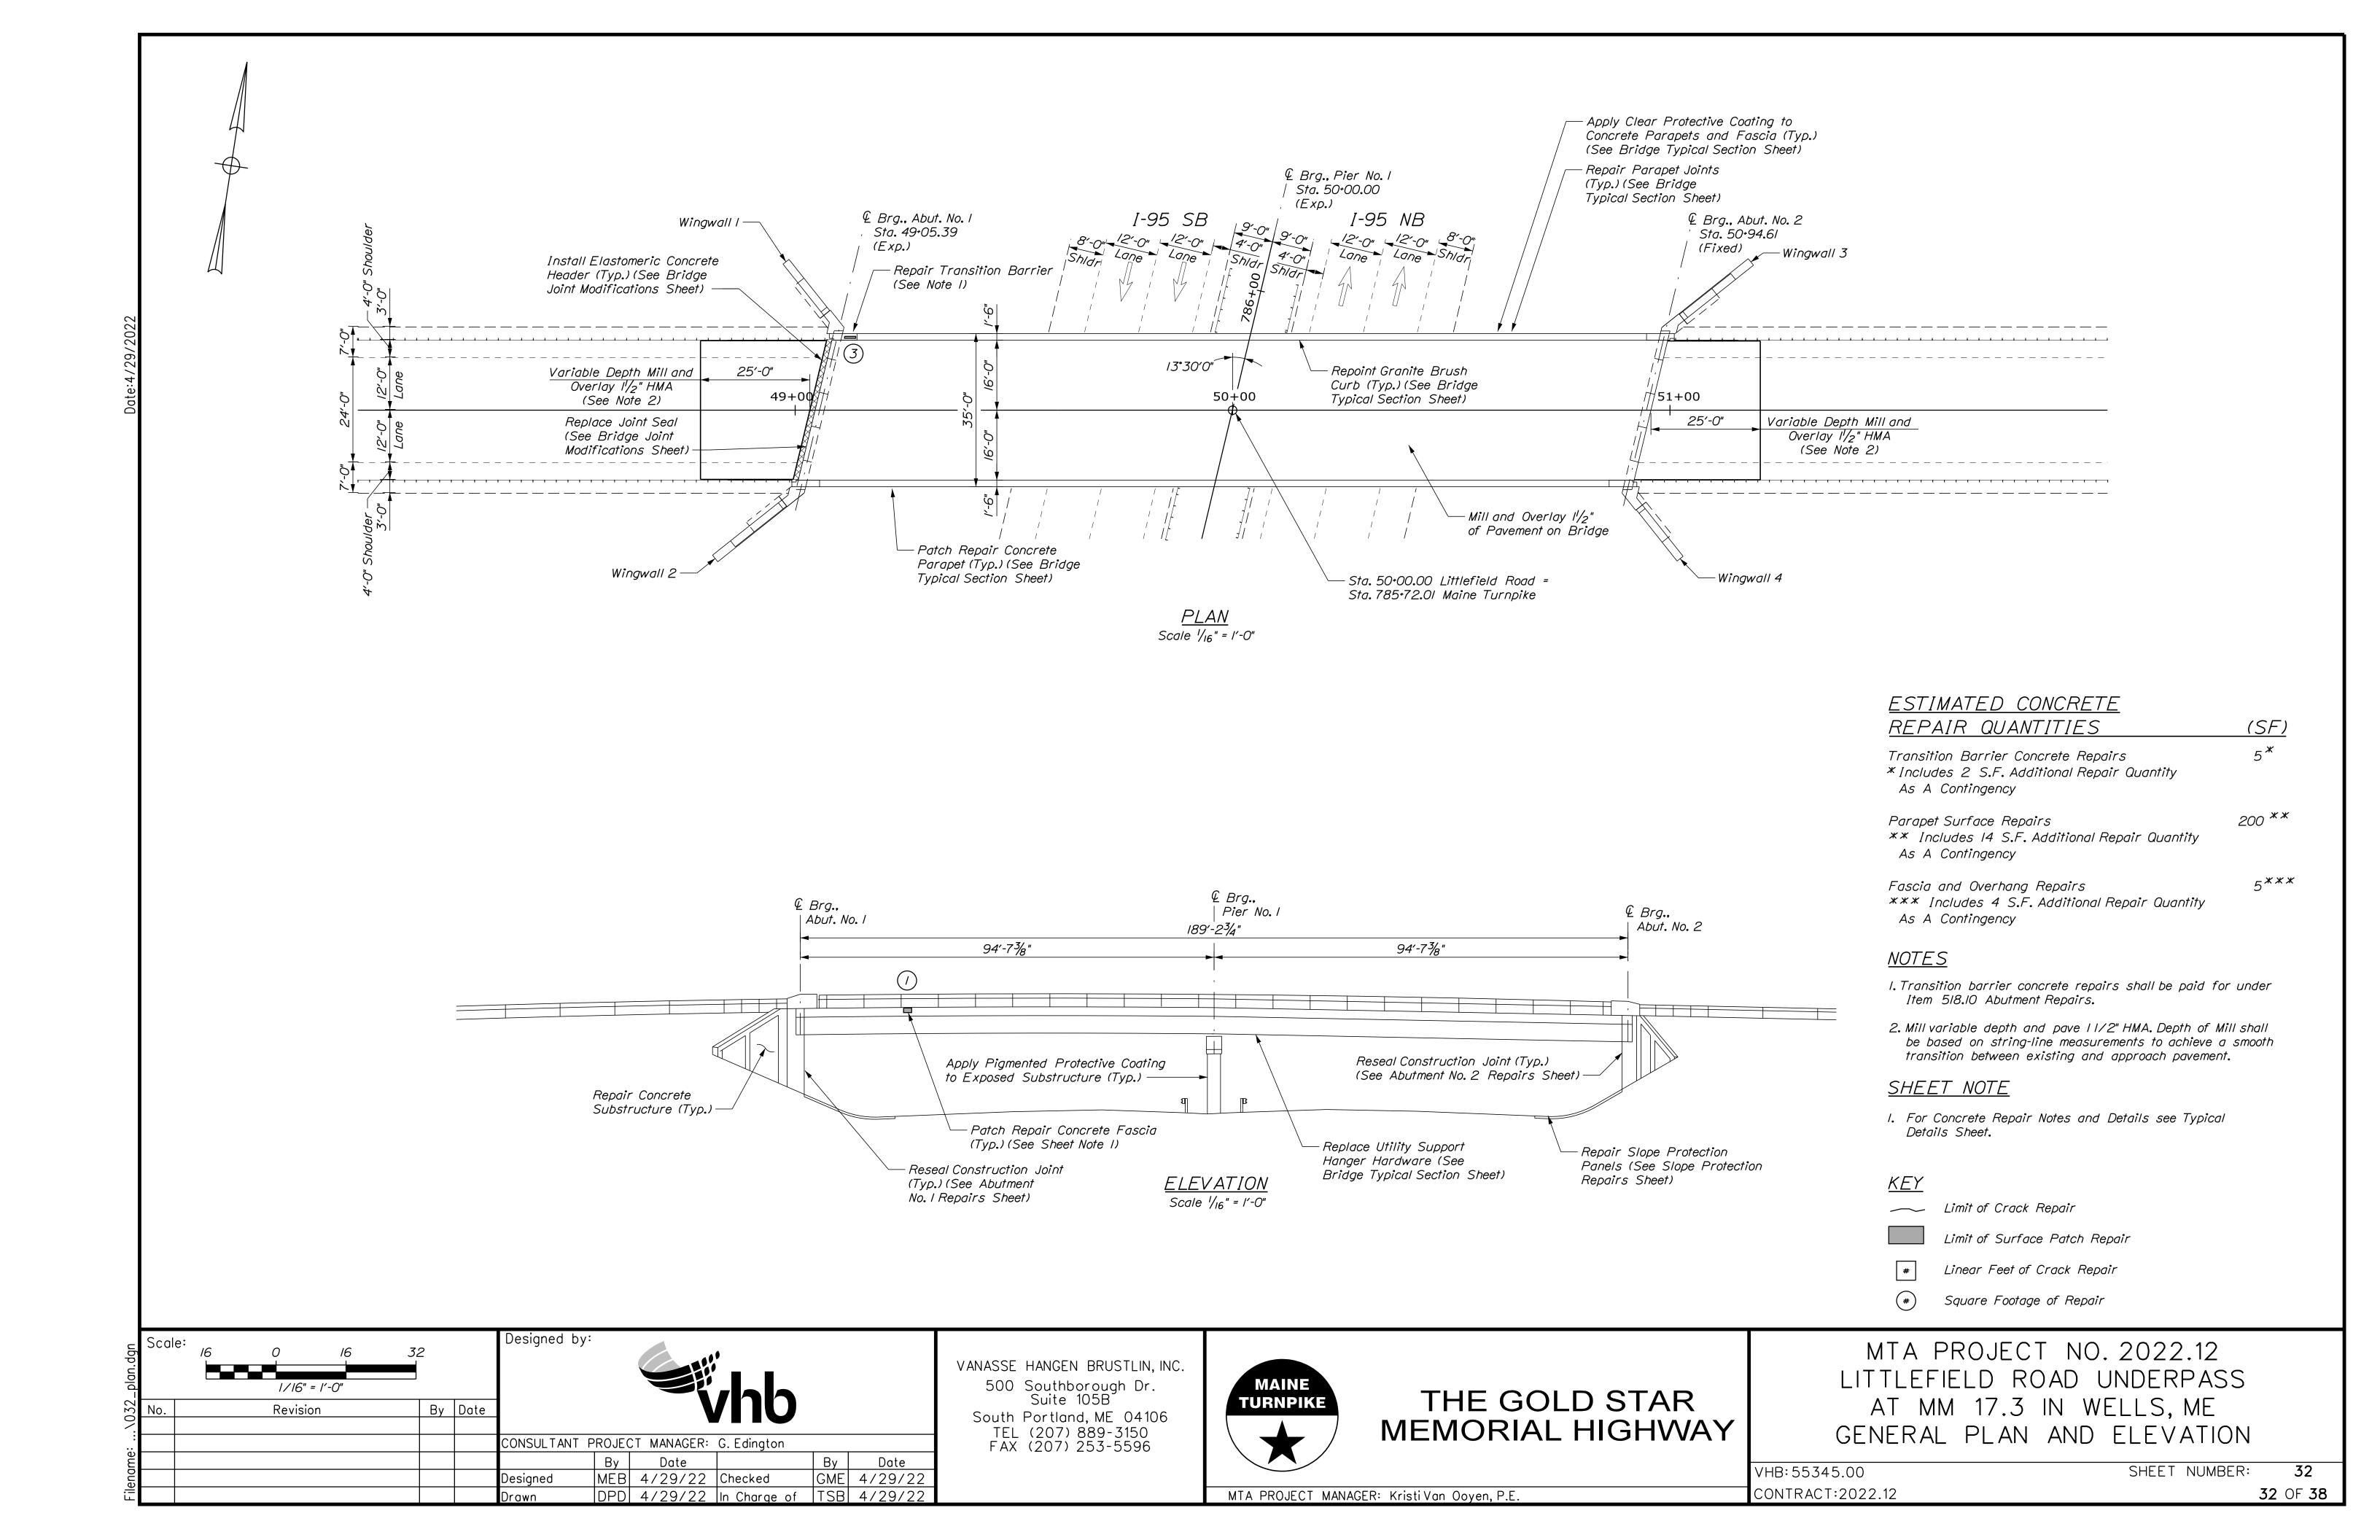

# Scale: 1/2" = 1'-0"

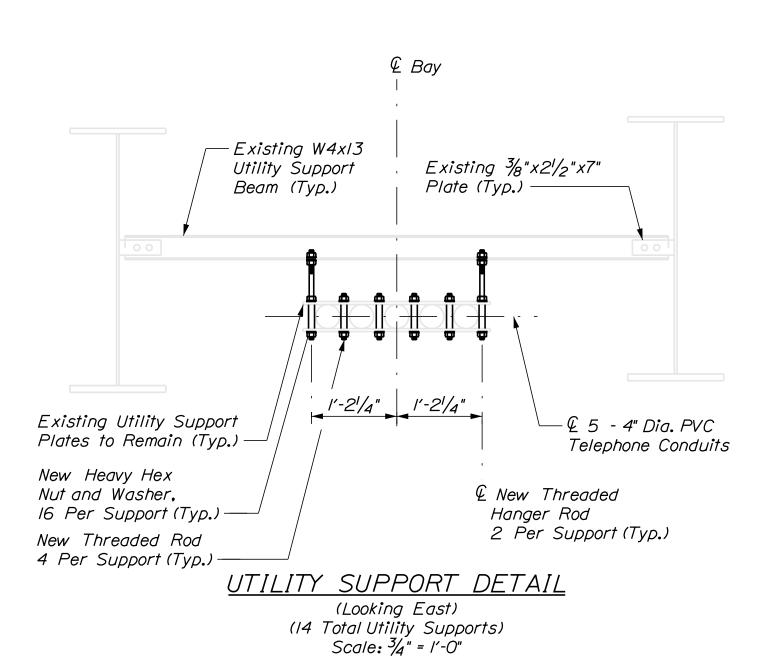

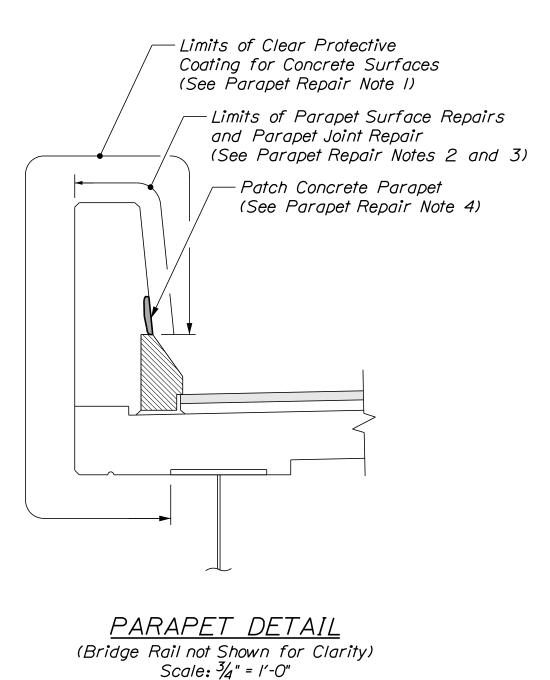

## UTILITY SUPPORT HANGER NOTES


- I. The utility support hardware shall be replaced at all utility support hangers. The existing composite support hardware shall be re-used. The conduit shall be temporarily supported at the location being replaced. The Contractor shall design and submit installation and temporary support plan at least three weeks prior to performing this work. The Contractor shall be fully responsible for replacing the existing composite square tube and pipe hardware if damaged during removal and re-installation.
- 2. Contractor shall field verify threaded rod lengths prior to rod and hardware procurement. The rod length and hardware depicted in the plan set is based on limited field measurements within the shoulder of each bridge location. Field cutting new threaded rod will not be permitted.
- 3. All labor, equipment, and materials necessary to repair the utility conduit hangers shall be paid for under Item 830.17, Utility Conduit Hanger System Hardware.

#### MATERIAL NOTE

I. All utility support hardware shall consist of  $\frac{3}{4}$ " dia. Grade A36 threaded rod,  $\frac{1}{4}$ " Grade A563 heavy hex locking nuts and associated washers. All hardware shall be hot dipped galvanized.

# PARAPET REPAIR NOTES

- I. Limits of clear protective coating shall be paid for under Item 515.202, Clear Protective Coating for Concrete Surfaces.
- 2. Prior to application of clear protective coating the Contractor shall fill all honeycomb voids with an approved nonshrink grout. All costs for this work shall be paid for under Item 518.94, Parapet Surface Repairs.
- 3. Repair parapet joints as directed by the Resident. Joint sealant shall be from MaineDOT Qualified Product List for Silicone and Polyurethane Joint Sealant. Work shall be paid for under Item 518.48 Reseal Joints.
- 4. Patch Repairs to concrete parapet shall be paid under Item 518.93 Parapet Repairs.
- 5. Joint Sealant shall be a material from the Maine DOT approved products list as approved by the resident. Joint Sealant shall be incidental to Item 518.391 Repair Granite Curb Joint and Bedding Mortar.

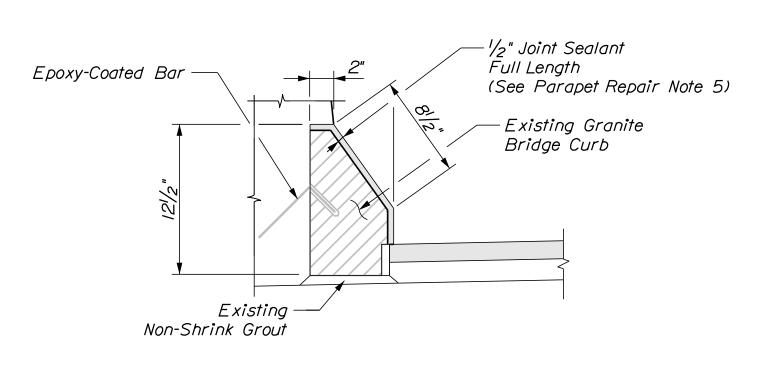

EXISTING GRANITE CURB DETAIL

1/2" = 1'-0"

				Designed b	y:		, , ,		
No.	Revision	Ву	Date						
				CONSULTANT	PROJEC	CT MANAGER:	G. Edington		
					Ву	Date		Ву	Date
				Designed	MÉB	4/29/22	Checked	GME	4/29/22
				Drawn	DPD	4/29/22	In Charge of	TSB	4/29/22

VANASSE HANGEN BRUSTLIN, INC.
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South Portland, ME 04106

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THE GOLD STAR
MEMORIAL HIGHWAY


MTA PROJECT NO. 2022.12 LITTLEFIELD ROAD UNDERPASS AT MM 17.3 IN WELLS, ME BRIDGE TYPICAL SECTION


VHB: 55345.00


CONTRACT:2022.12


SHEET NUMBER: 33


MTA PROJECT MANAGER: Kristi Van Ooyen, P.E.

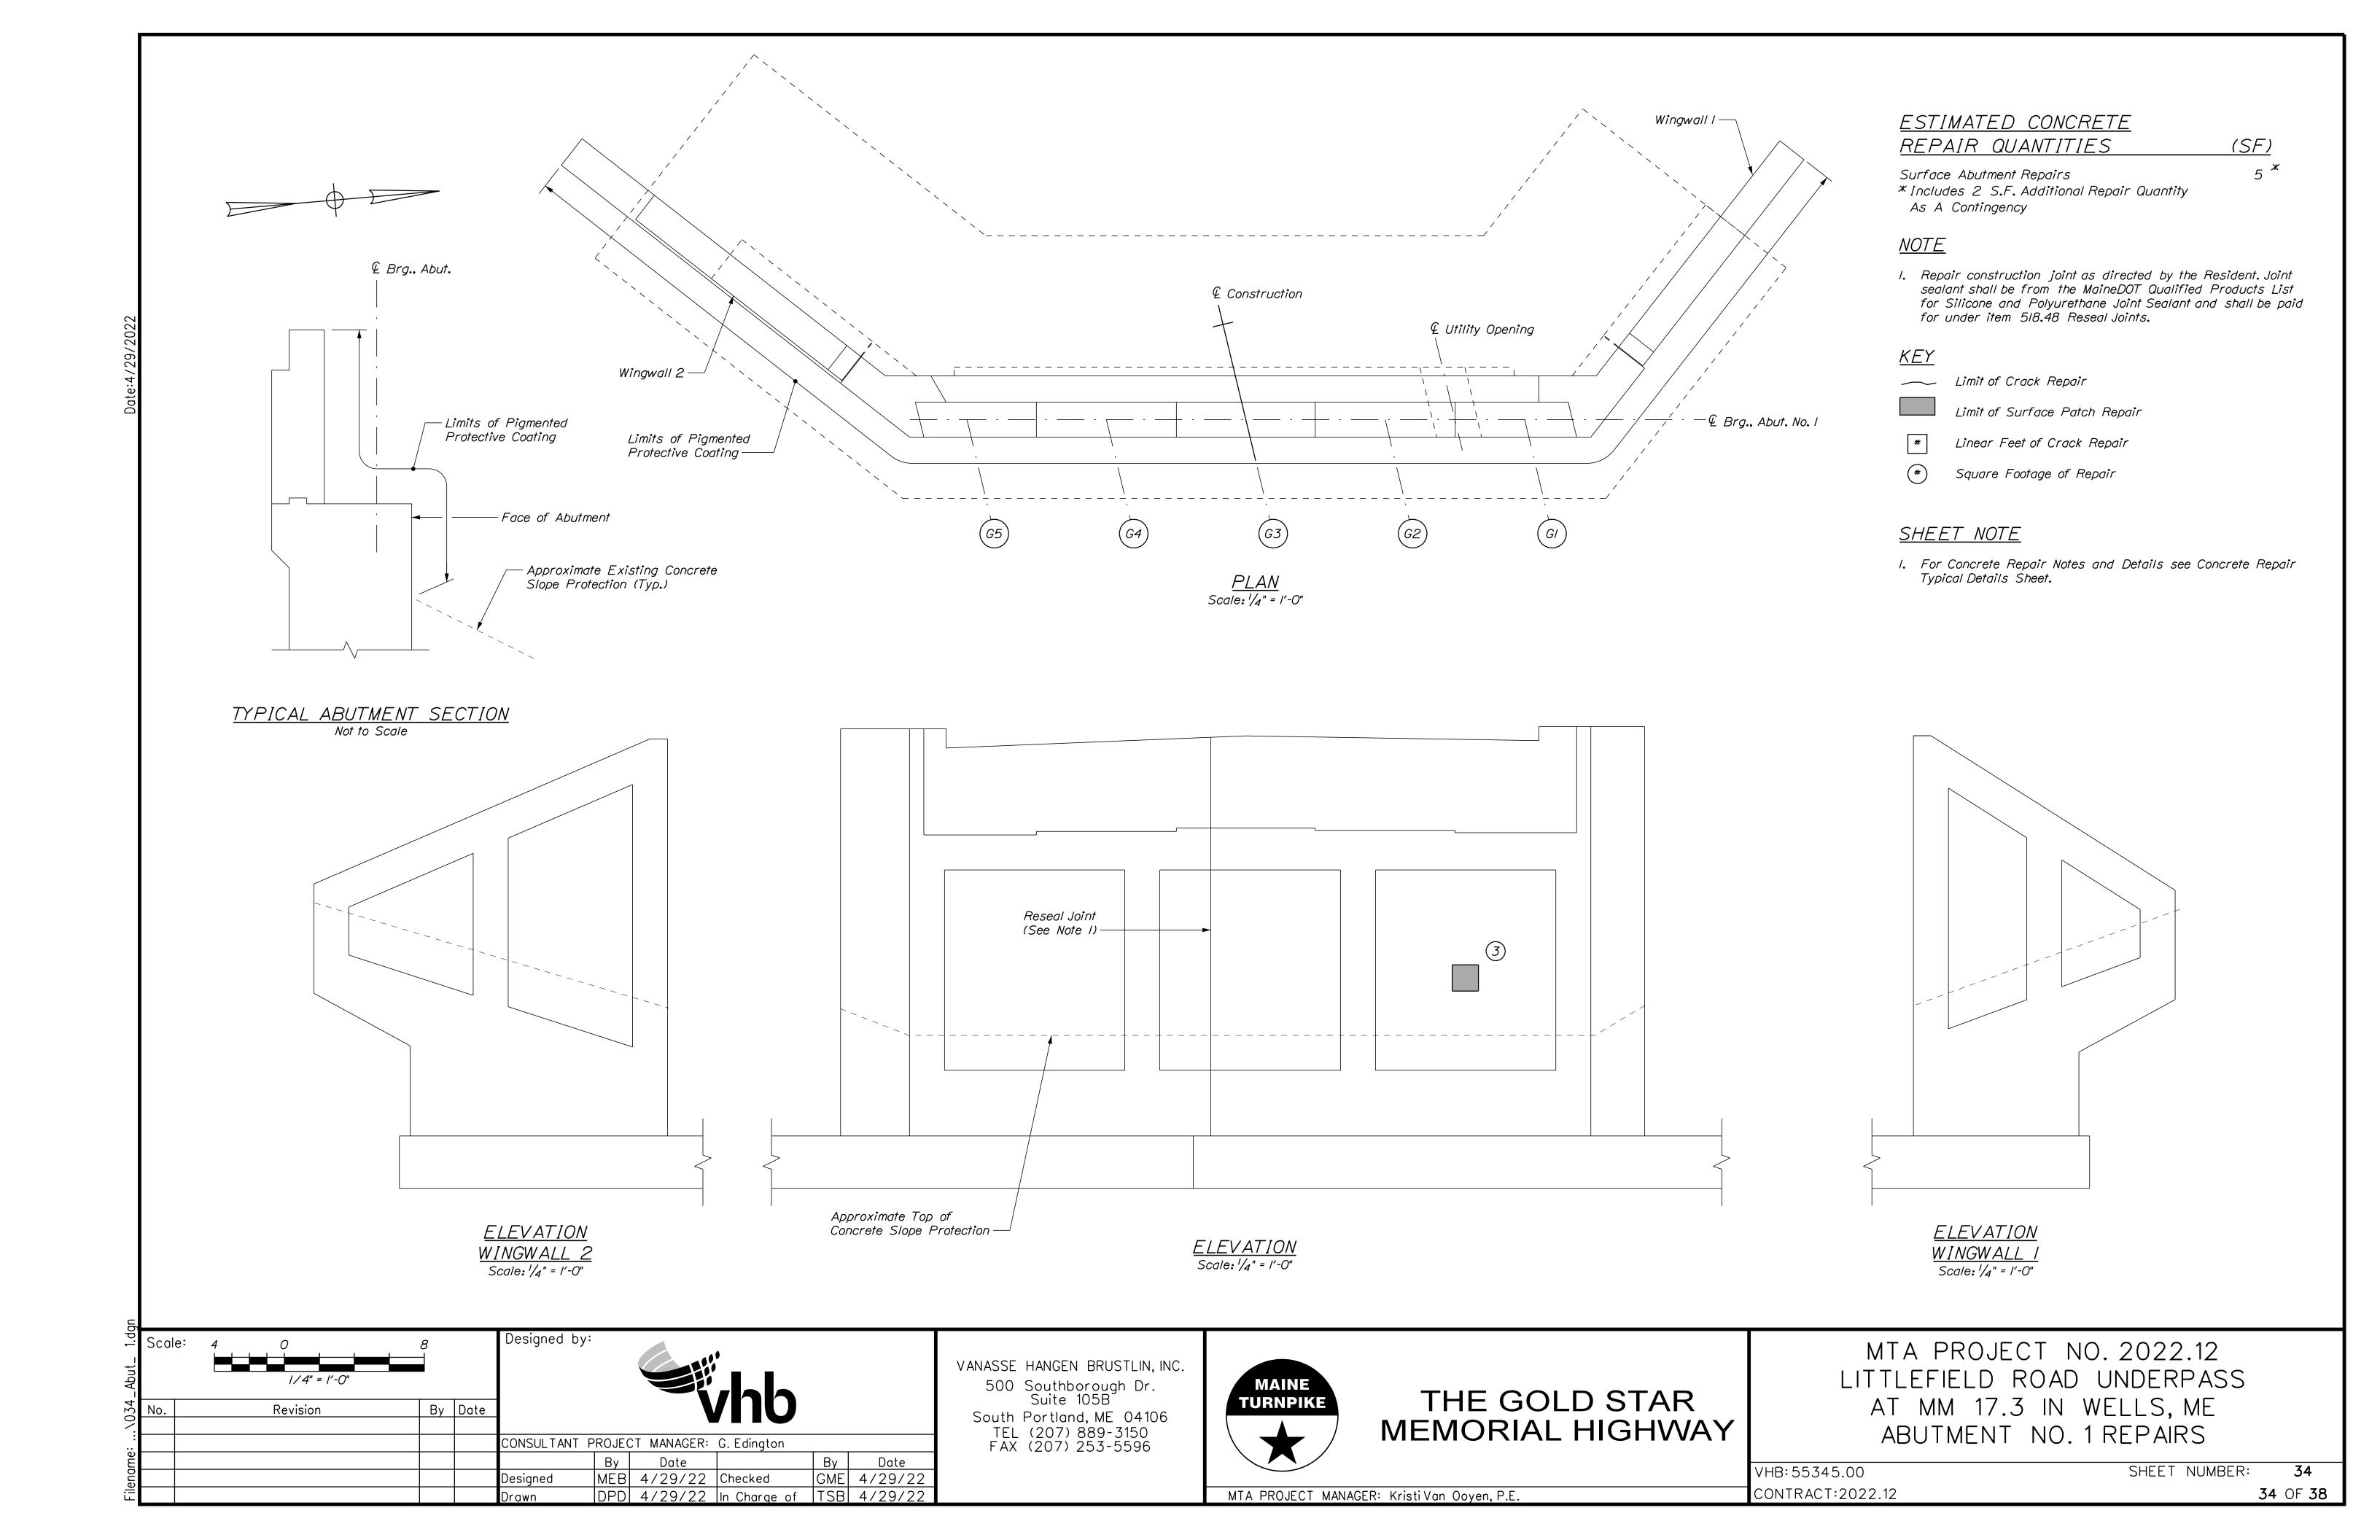

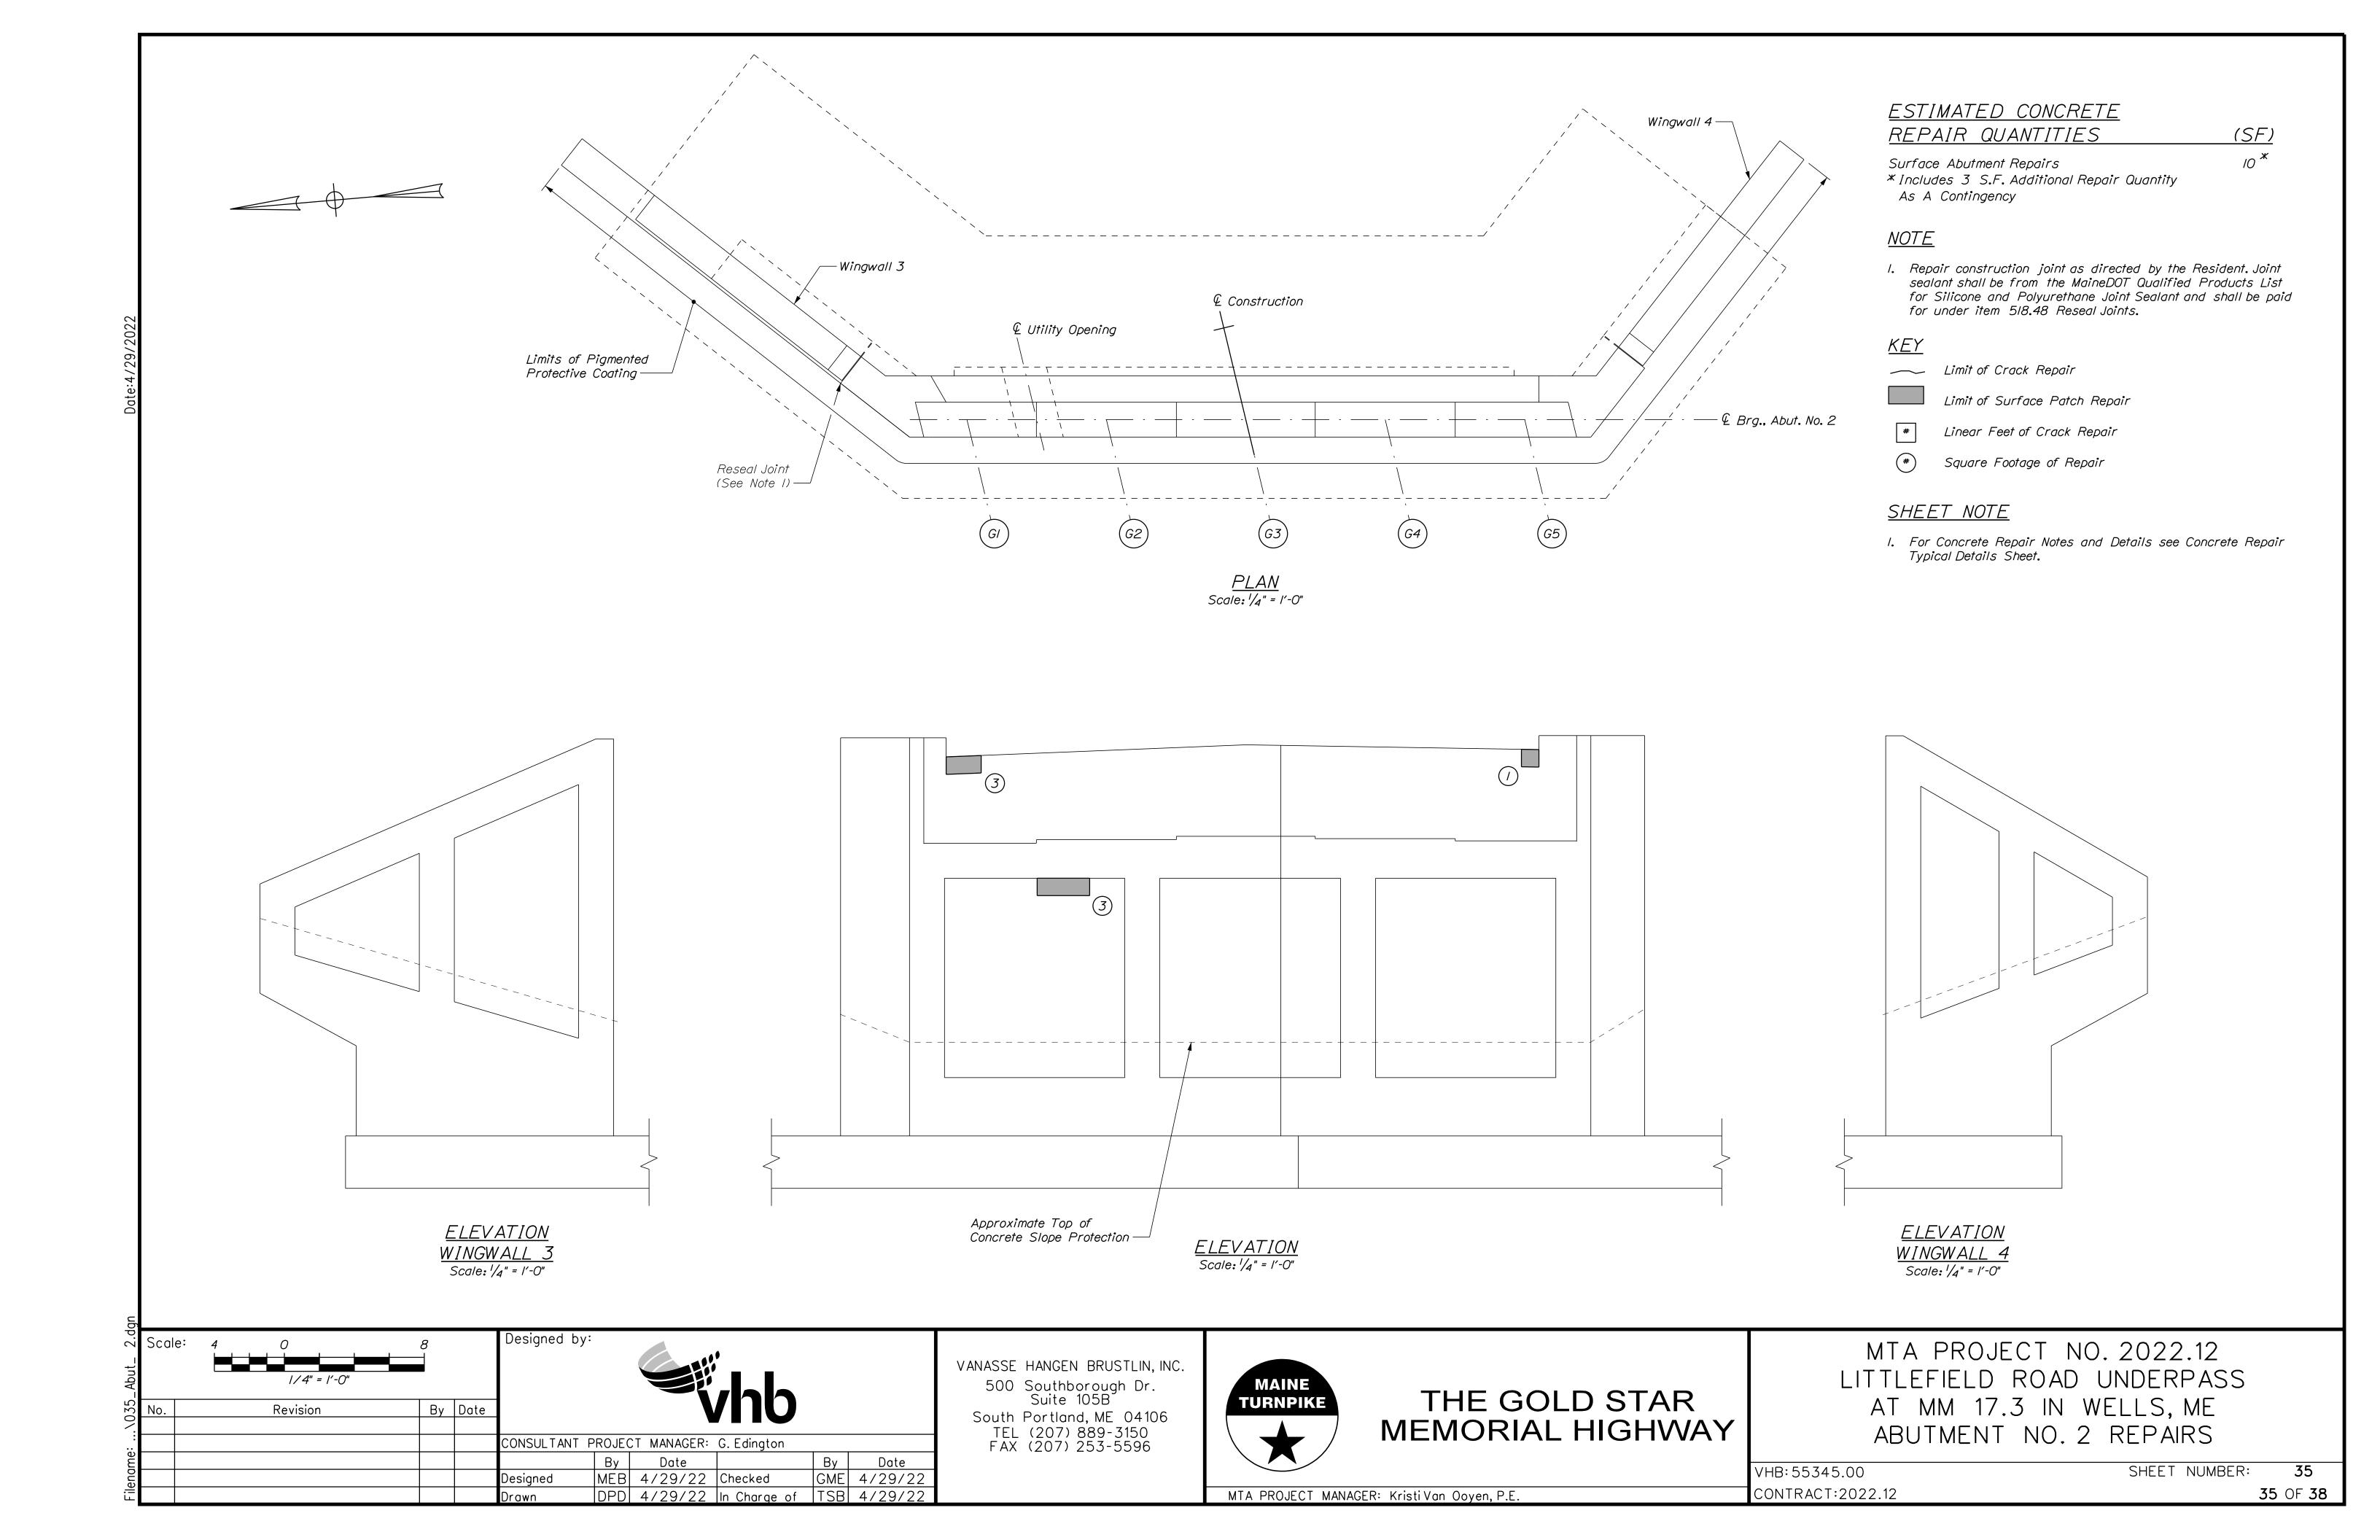

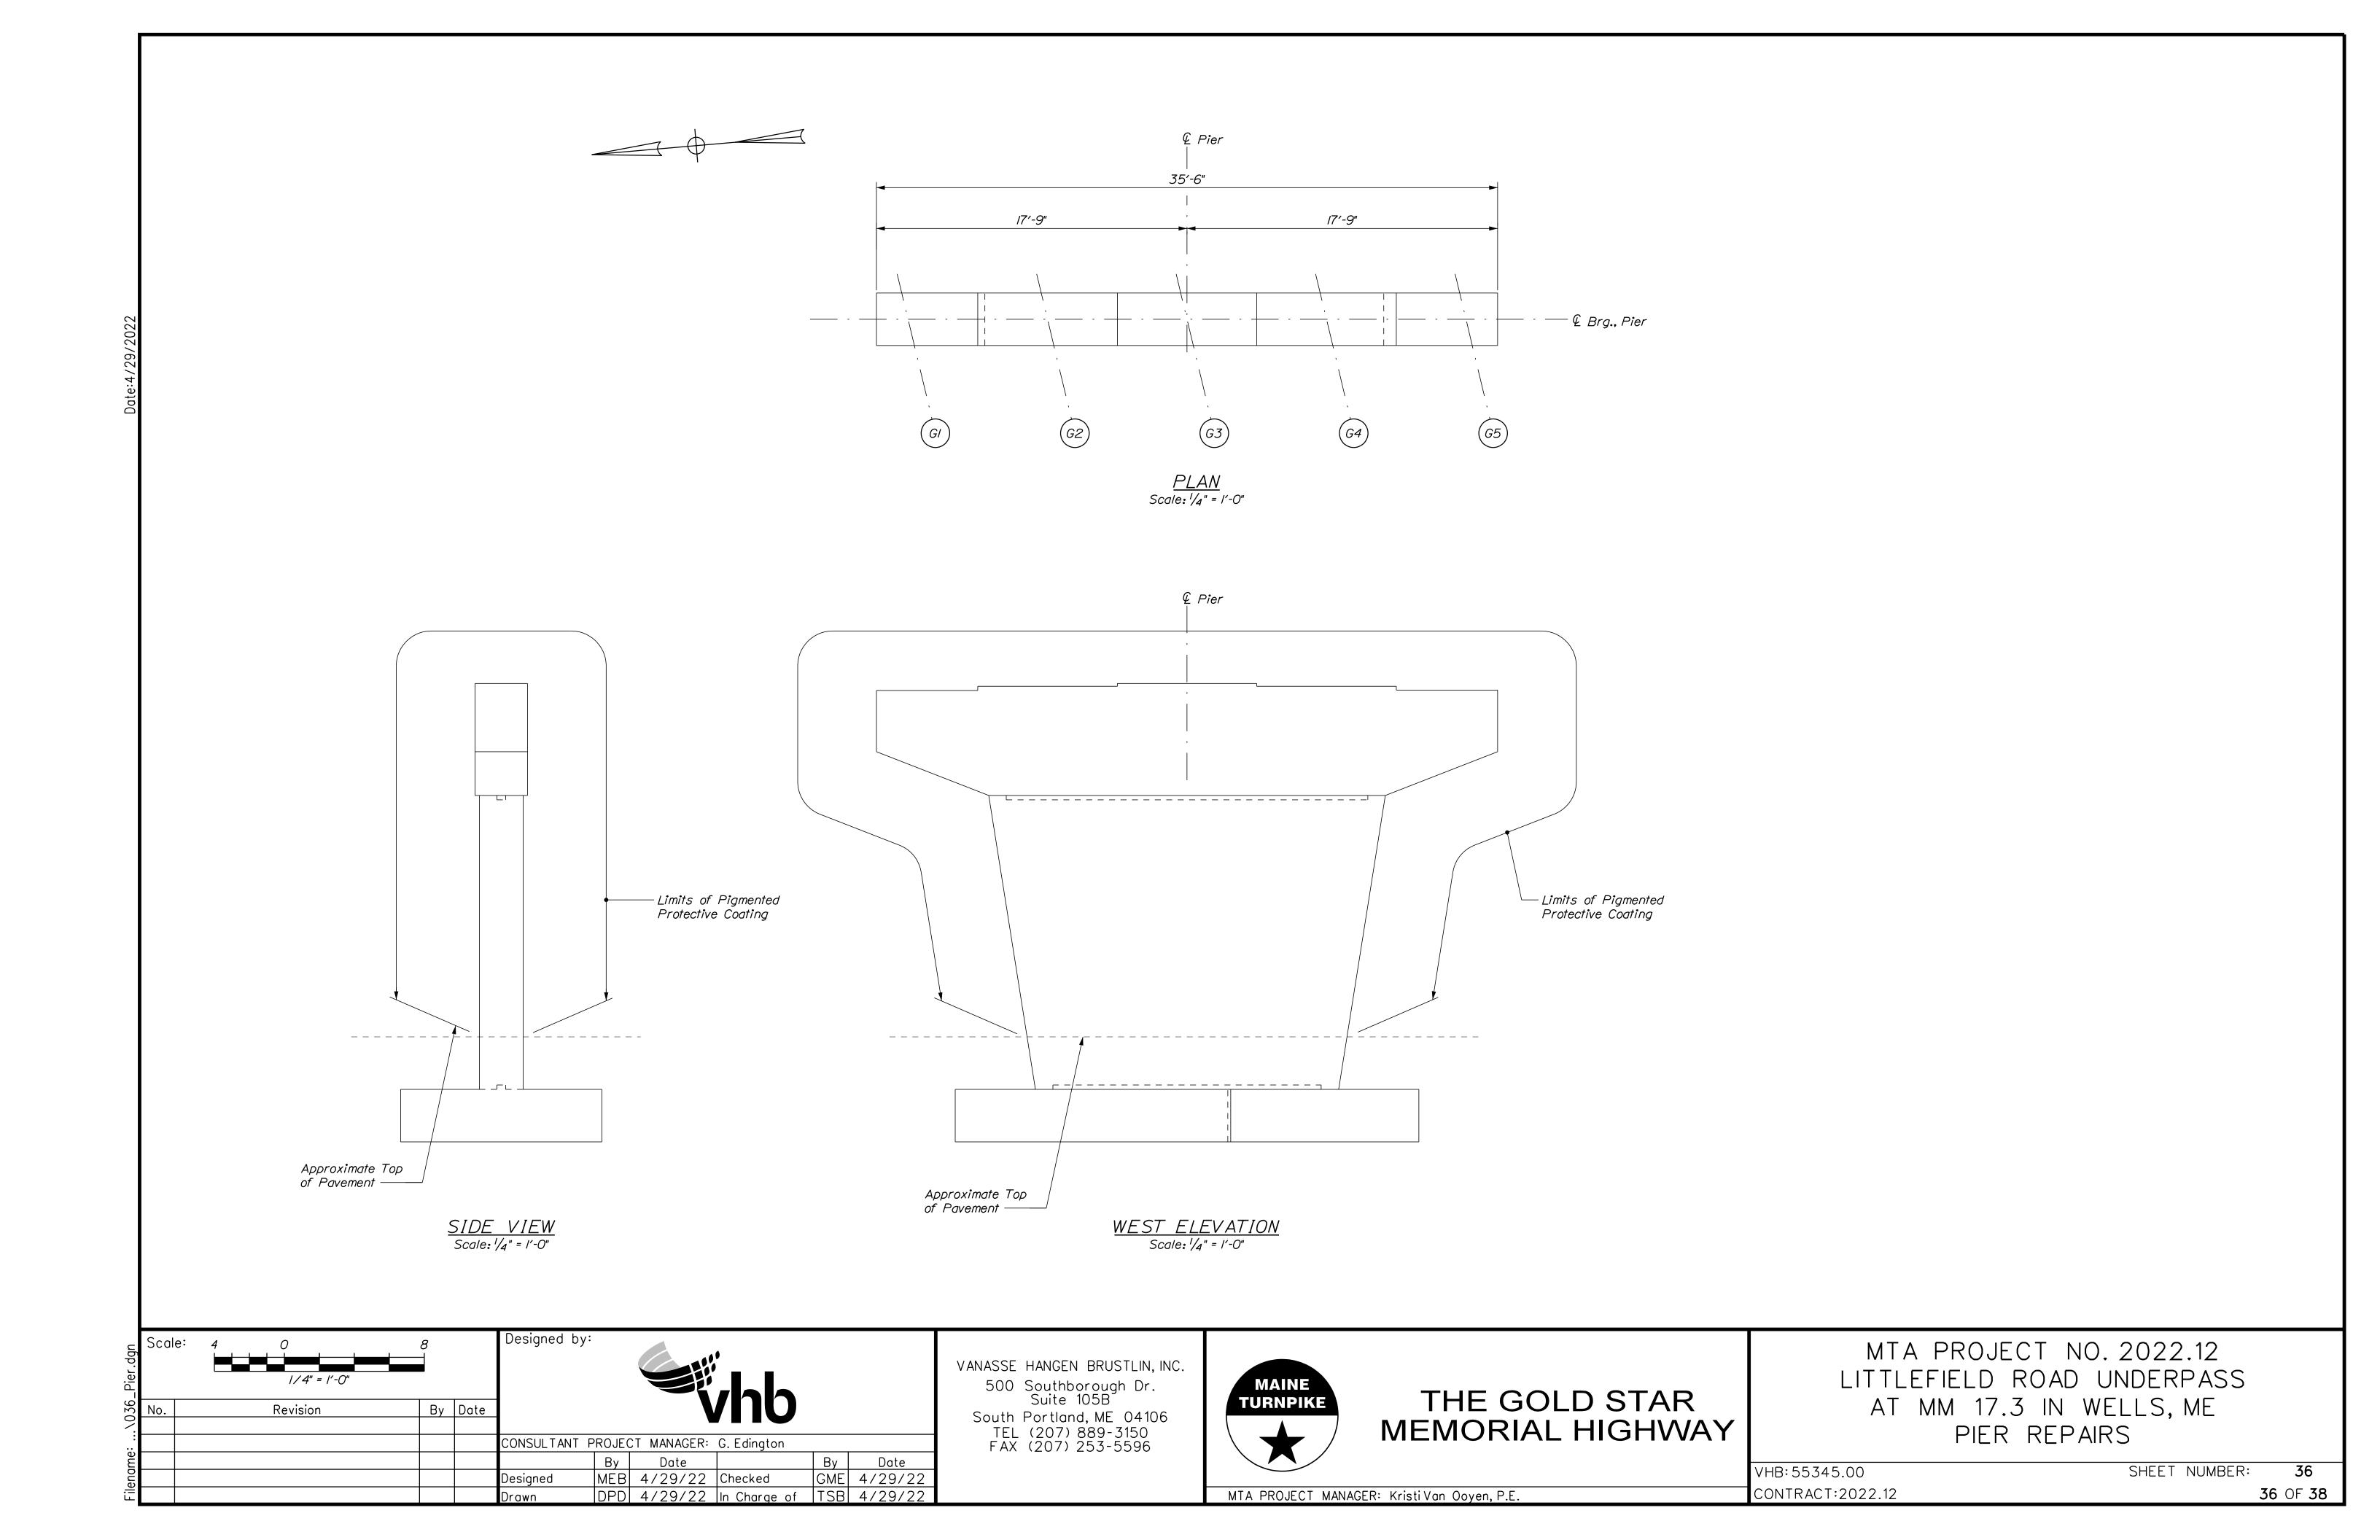

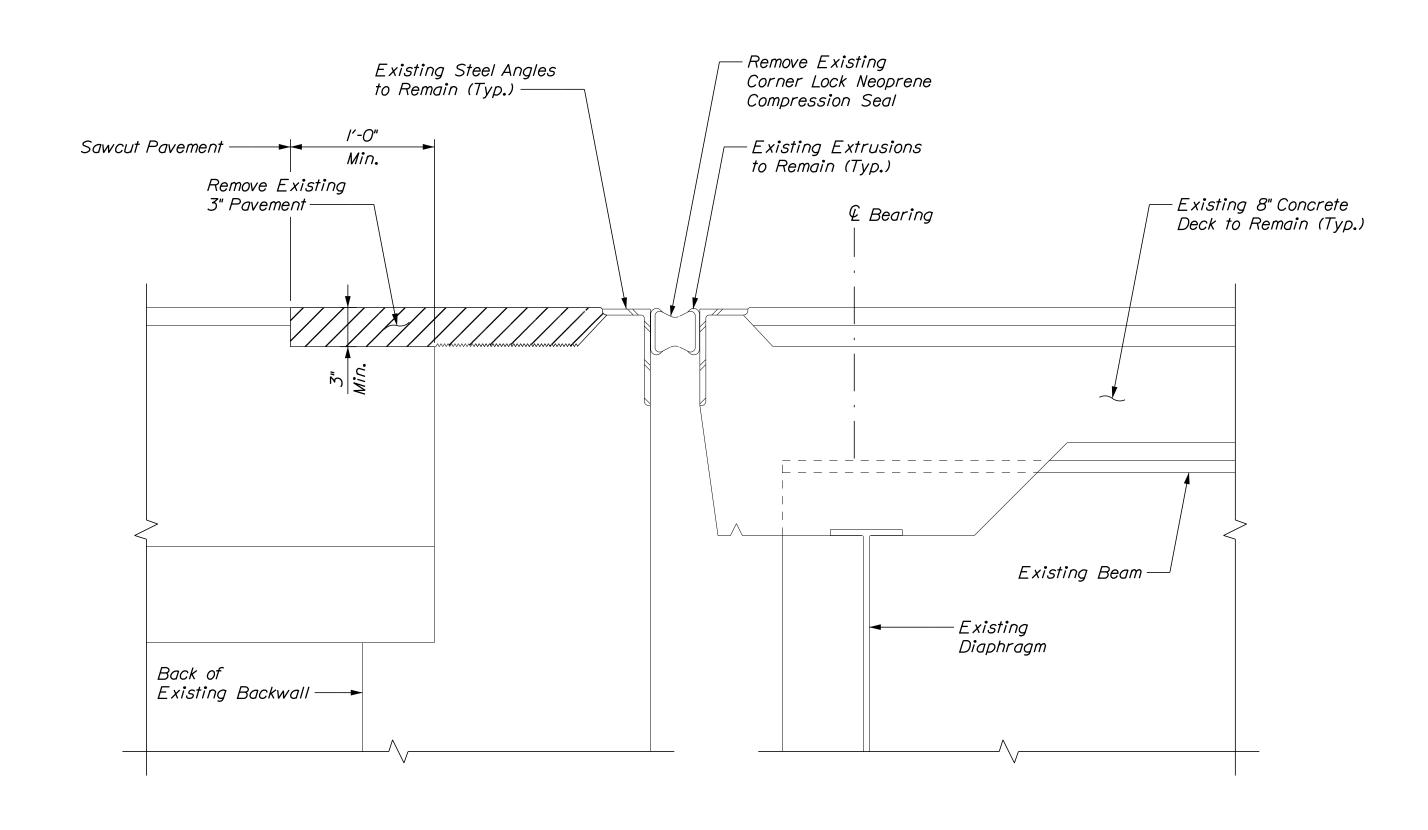

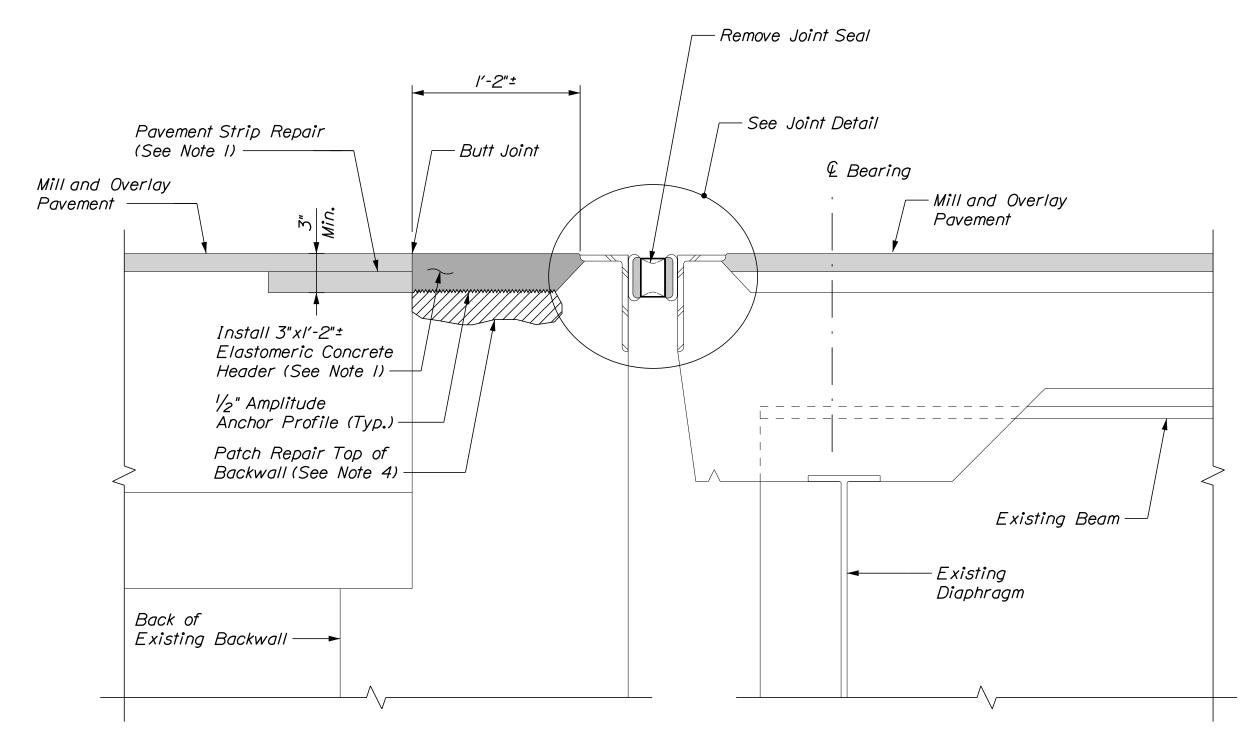


EXISTING EXPANSION JOINT SECTION

PROPOSED EXPANSION JOINT SECTION

SECTIONS AT EXPANSION JOINT

AT ABUTMENT I

Not to Scale

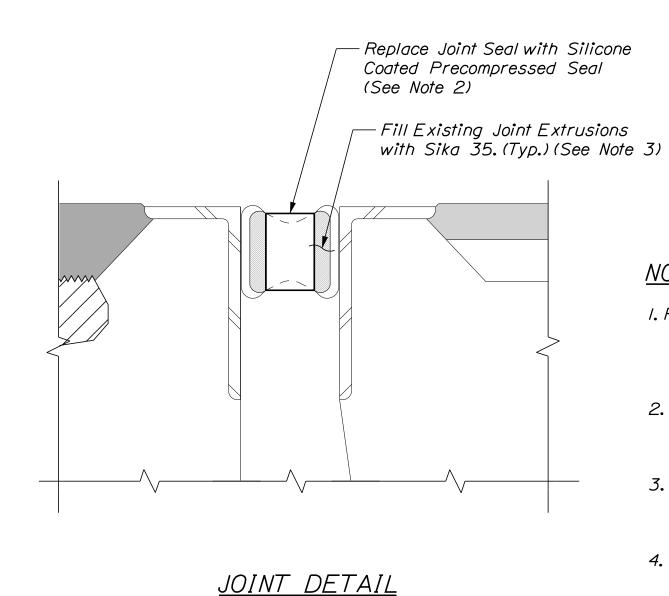


# <u>NOTES</u>

- I. Pavement Strip Repair shall be incidental to Item
  518.864, Elastomeric Concrete Header Repair.
  Elastomeric Concrete Header shall be paid under
  Item 518.864, Elastomeric Concrete Header Repair.
- 2. Silicone Coated and Pre-Compressed Seal shall be paid under Item 520.234, Expansion Device Silicone Coated and Pre-Compressed Seal.
- 3. Filling existing joint extrusions with Sika 35 shall be incidental to Item 520.234, Expansion Device Silicone Coated and Pre-Compressed Seal.
- 4. Prior to placing the elastomeric concrete header, the Contractor shall repair any areas of deteriorated concrete at the top of the backwall, as directed by the Resident. Repairs to the top of the backwall will be paid under Item 518.10, Abutment Repairs.

Scale:				Designed by:	;		, 		
No.	Revision	Ву	Date	- -			/no		
				CONSULTANT I	PROJE(	T MANAGER:	G. Edington		
					Ву	Date		Ву	Date
				Designed	MÉB	4/29/22	Checked	GME	4/29/2
				Drawn	DPD	4/29/22	In Charge of	TSB	4/29/2

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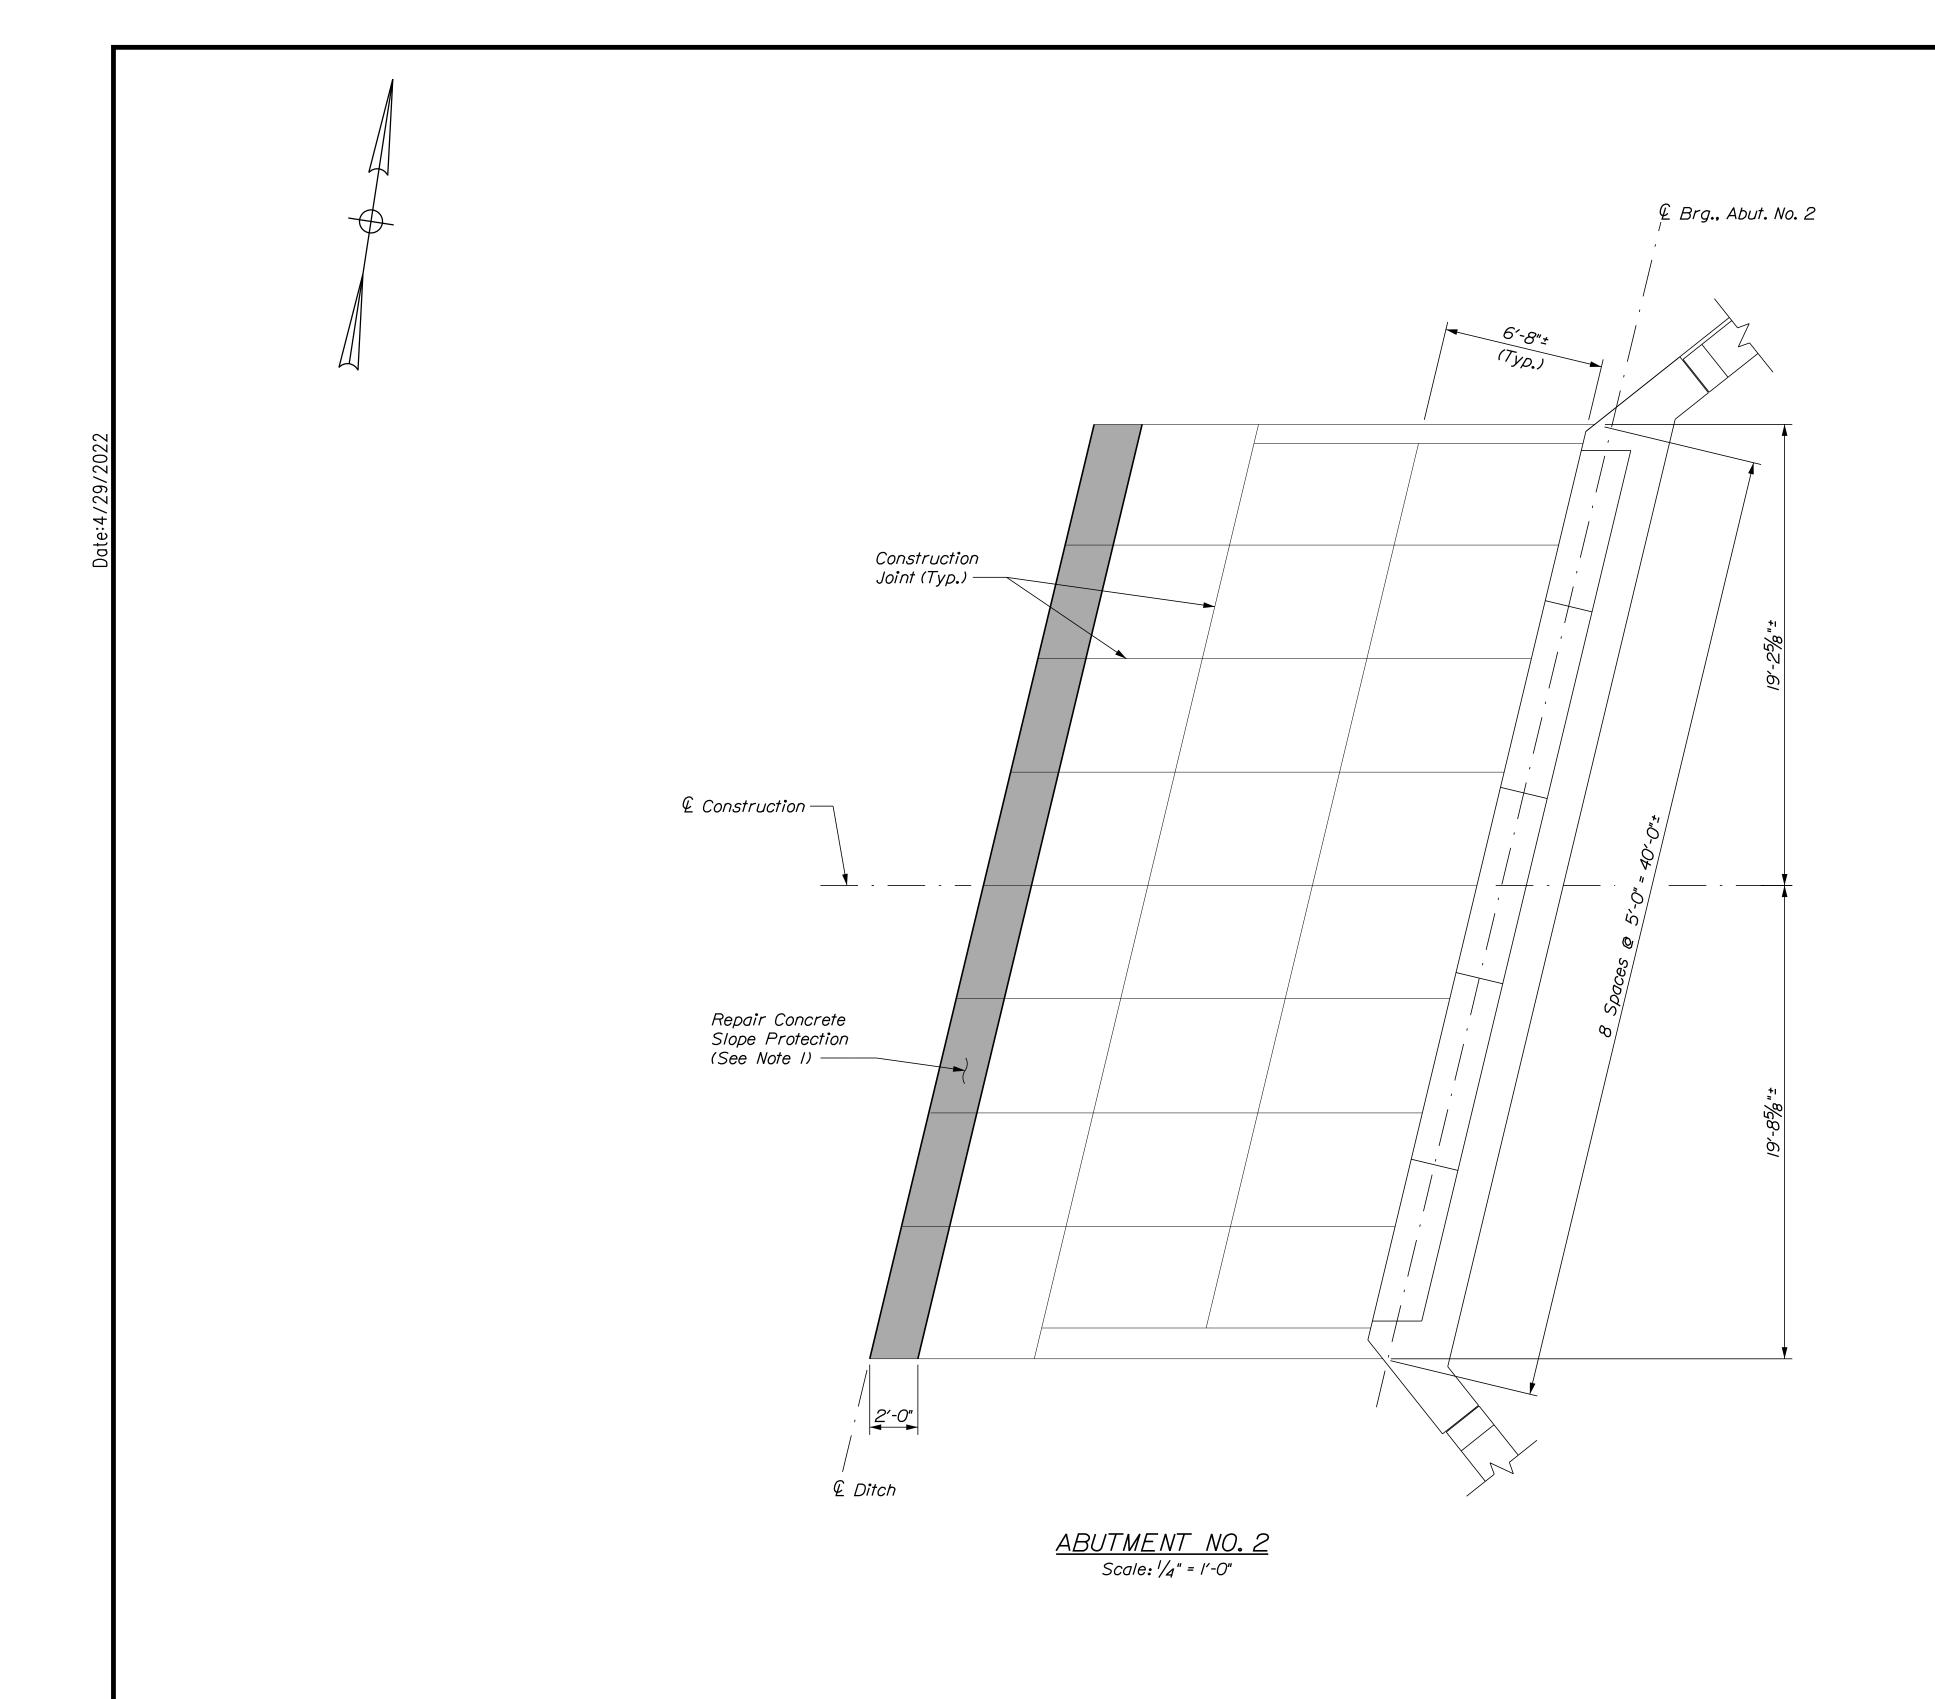


THE GOLD STAR
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MTA PROJECT NO. 2022.12 LITTLEFIELD ROAD UNDERPASS AT MM 17.3 IN WELLS, ME BRIDGE JOINT MODIFICATIONS

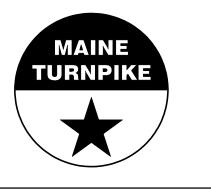VHB: 55345.00 CONTRACT: 2022.12

SHEET NUMBER: **37 37** OF **38** 



# <u>NOTE</u>

I. The bottom slope protection panel shall be sawcut 2'-0" from existing ground and replaced in-kind as directed by the Resident. Class A Concrete shall be used for replacing concrete slope protection. This work shall be paid for under Item 518.921 Slope Protection Concrete Repairs.

Scal	e: 4	8		Designed by:					
No.	Revision	Ву	Date						
:				CONSULTANT F	PROJEC	CT MANAGER:	G. Edington		
					Ву	Date		Ву	Date
5				Designed	MÉB	4/29/22	Checked	GME	4/29/22
-				Drawn	DPD	4/29/22	In Charge of	TSB	4/29/22

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MAINE
TURNPIKE

# THE GOLD STAR MEMORIAL HIGHWAY

MTA PROJECT NO. 2022.12 LITTLEFIELD ROAD UNDERPASS AT MM 17.3 IN WELLS, ME SLOPE PROTECTION REPAIRS

VHB: 55345.00 CONTRACT: 2022.12

SHEET NUMBER: **38 38** OF **38**